

2017.12.05

City of Kelowna

1435 Water Street Kelowna, BC V1Y 1J4

Attention: Emily Williamson

Dear Emily,



MQN Architects has been engaged to design a replacement home for 188 Beach Ave within the Abbott Street Heritage Conservation area. The proposed house for this property went through the Heritage Advisory Committee and Planning Department this fall and the City of Kelowna came back with recommendations for consideration. Subsequently MQN has worked with the client to redesign the project to align more closely with the goals of the city for this community.

The revised design for 188 Beach Avenue has been modified to create a more open and welcoming street frontage. This property is a corner lot adjacent to the existing public waterfront access at Beach Ave and McDougall Street. To address the corner location the configuration of the drive access and garage have been flipped from the previous configuration to open to the street corner. The proposed configuration focuses the front yard towards the street corner creating a similar configuration to the house on the south side of Beach Avenue. Through the reconfiguration, the design has been updated with an upper balcony over the front entrance which extends across the front façade to break down the scale of the house to the street.

To fit into the heritage character of this neighbourhood the new design has been strongly influenced by the form of the original house circa 1965. Archive photos for this property show that the original house dated from the 1920's. The original house was designed with a material scheme which provided a high waistline proportion blending arts and crafts styling of the times. In more recent times the house lost this original character through renovations which reclad it in clapboard siding with a single colour and buried the house front in a 1960s carport. The proposed house looks back to the original high waisted composition for inspiration. Following the early photographs, the façade has been treated to a high waist with two classic colours. The front entrance of the house is centrally located at the intersection of the main house and the garage wing. To elevate the prominence of the entrance a stone finish has been added providing a visual focal point leading into the house.

The redesigned house for 188 Beach Avenue retains character from the original house which meeting the needs of the client. This revised design has addressed concerns which had been raised about the previous iteration and creates a welcoming frontage with eyes on the street. We trust that this design is in character with the Abbot Street Heritage Conservation area and reinforces the unique appeal of this neighbourhood.

Yours truly


Brian Quiring Partner

MQN Architects



HUMER RESIDENCE

188 BEACH AVE, KELOWNA, BC LOT 1, DISTRICT LOT 14, OSOYOOS DIVISION OF YALE DISTRICT, PLAN 36323

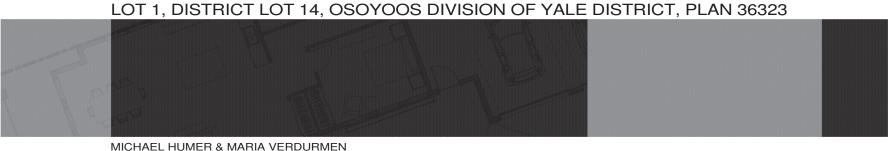

MQN ARCHITECTS

> HUMER RESIDENCE PROJECT: 16049i DATE: 2017/12/06 ISSUED FOR DEVELOPMENT

PERMIT - REVISION 1

ARCHITECTURAL MQN ARCHITECTS

#100 - 3313 32 AVENUE VERNON, BRITISH COLUMBIA V1T 2M7 P: 250-542-1199 F: 250-542-5236

ARCHITECTURAL DRAWING LIST

000 TITLE PAGE 003 EXTERIOR 3D VIEWS

A101 SITE PLAN A201 MAIN FLOOR A202 SECOND FLOOR PLAN

A203 FOUNDATION & ROOF PLAN A402 EXTERIOR ELEVATIONS COUTLAND DESIGN

206 - 1889 SPALL ROAD KELOWNA, BRITISH COLUMBIA V1Y 4R2

LANDSCAPE DRAWING LIST







ΕW




OKANAGAN LAKE VIEW

В

City of Kelowna


188 BEACH AVE, KELOWINA, BC LOT 1, DISTRICT LOT 14, OSOYOOS DIVISION OF YALE DISTRICT, PLAN 36323 HUMER RESIDENCE


EXTERIOR 3D VIEWS

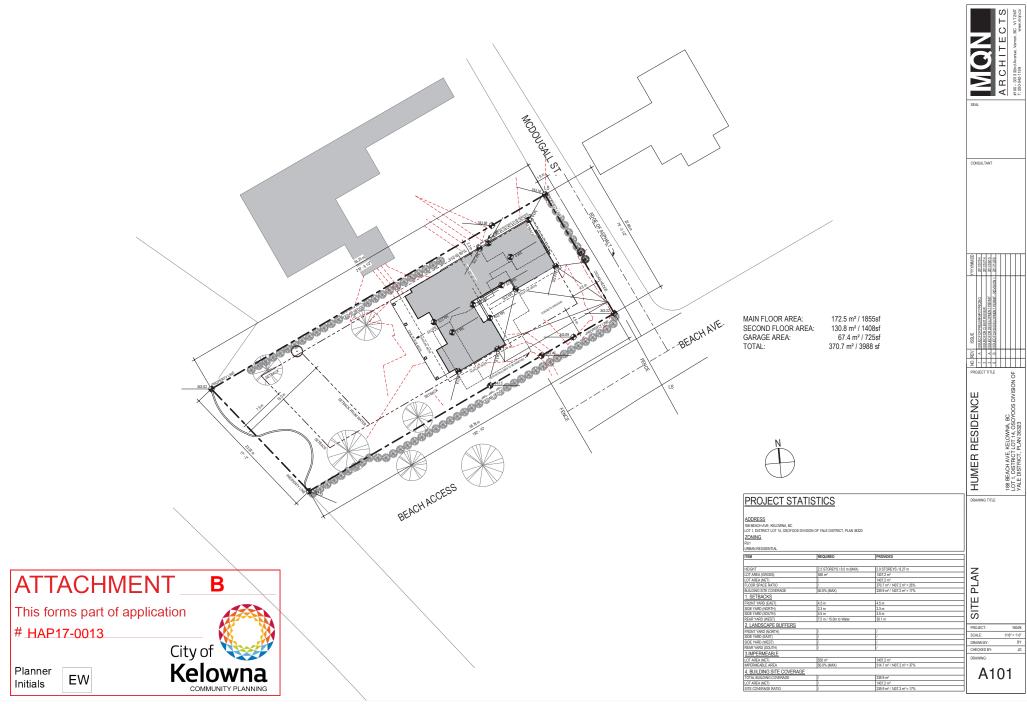


cthe 85/a6cedboaret bl 860 han

hir XI 040 Humar Plaside nos Cart al_NQVV-chiac bunt

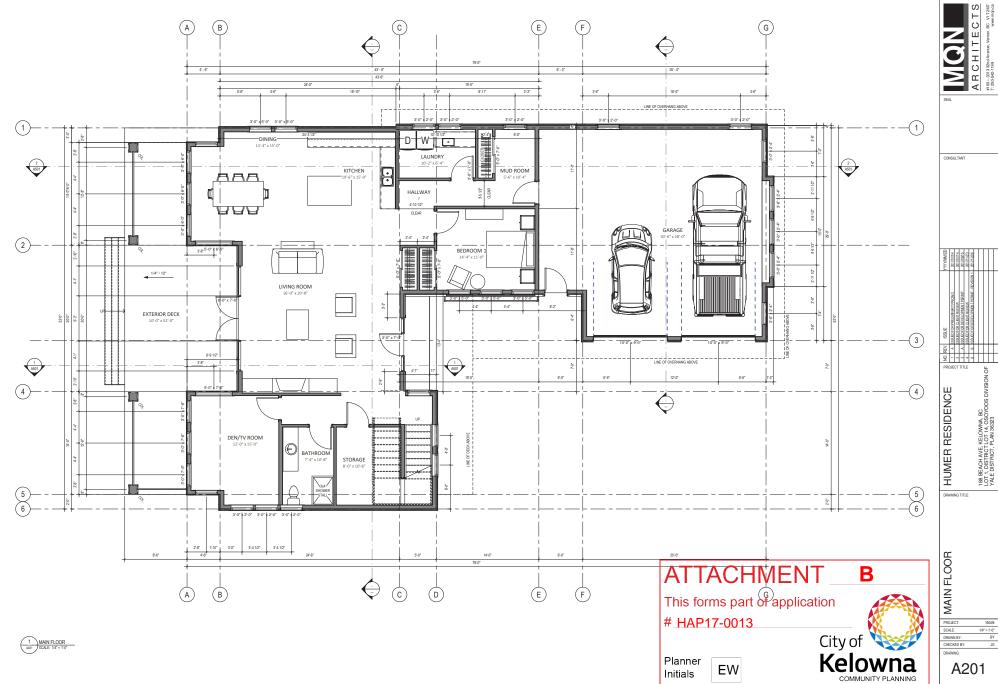


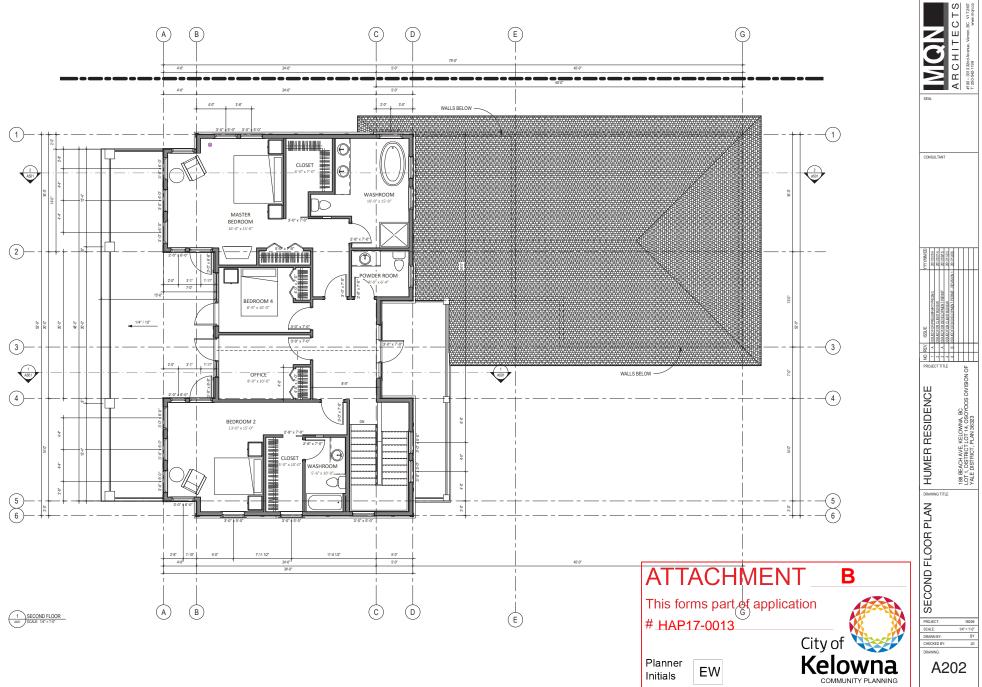


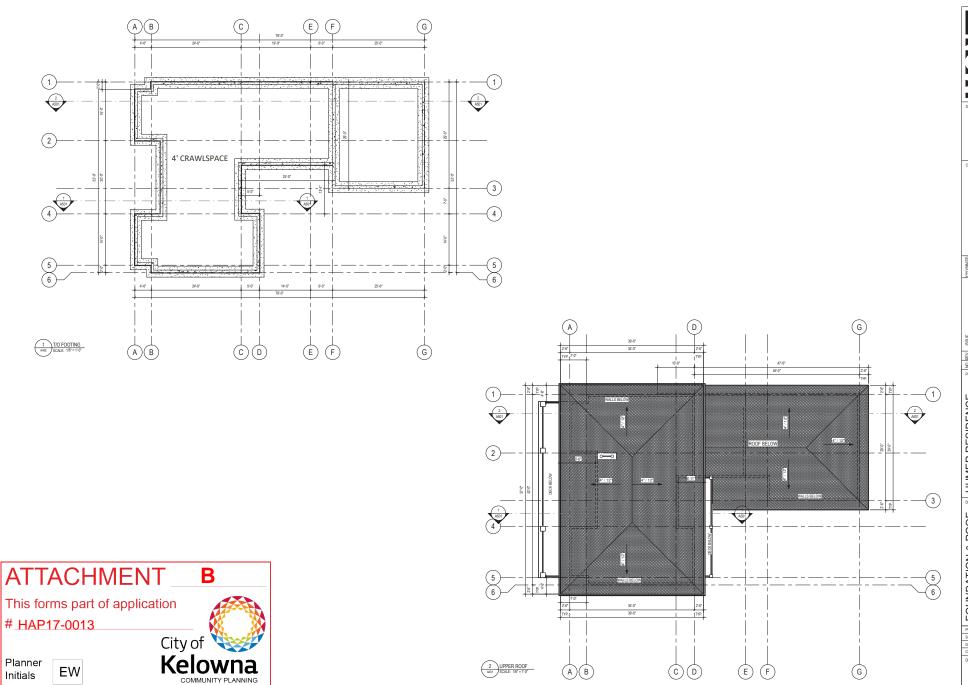



HUMER RESIDENCE

FOUNDATION & ROOF PLAN

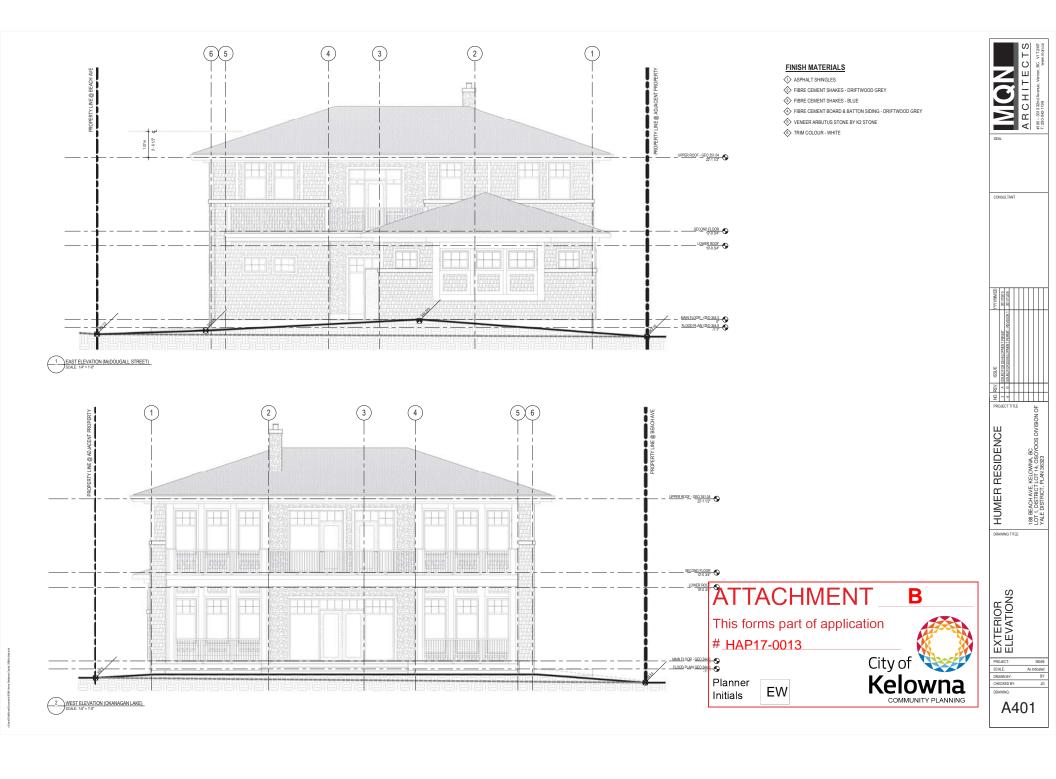

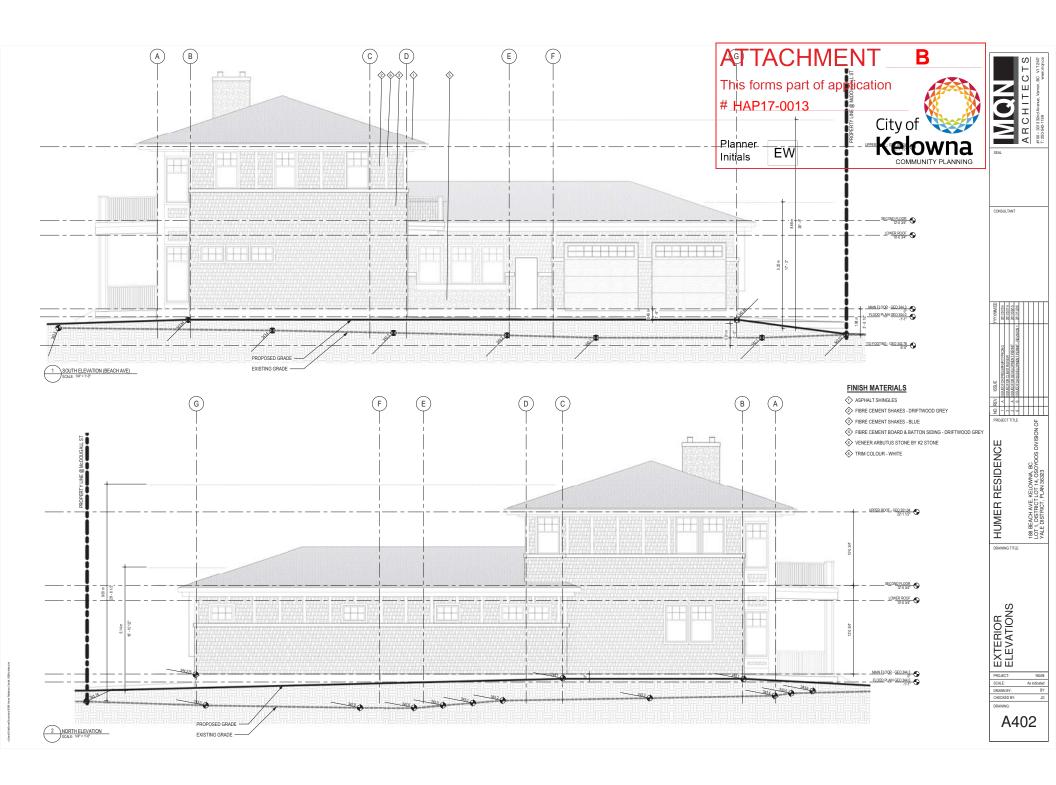

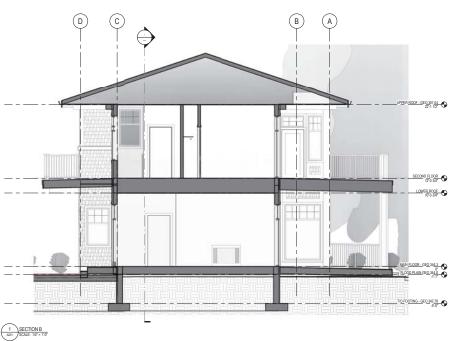

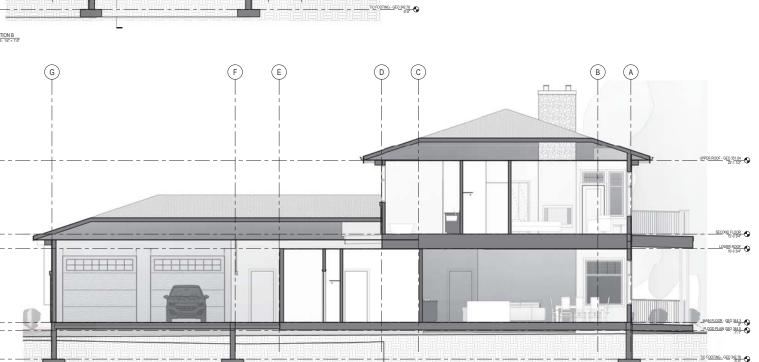

ATTACHMENT

This forms part of application # HAP17-0013



В

Planner Initials

EW

CONSULTANT

HUMER RESIDENCE

DRAWING TITLE

BUILDING SECTIONS

PROJECT: 16049i
SCALE: 1/4" = 1'-0"
DRAWN BY: BY
CHECKED BY: JG

A501

2 SECTION C SCALE: 1/4" = 1'-0"



HUMER RESIDENCE

188 BEACH AVE, KELOWNA, BC LOT 1, DISTRICT LOT 14, OSOYOOS DIVISION OF YALE DISTRICT, PLAN 36323



HUMER RESIDENCE PROJECT: 16049i DATE: 2017/08/15 ISSUED FOR DEVELOPMENT

MICHAEL HUMER & MARIA VERDURMEN

MQN ARCHITECTS

ARCHITECTURAL DRAWING LIST

ACCO TITLE PAGE
ACC ASSERBLES AND CONERAL NOTES
ACCO SESSIBLES AND CONERAL NOTES
ACCO SESSIBLES AND CONERAL NOTES
ACCO SECURITY OF ACCOUNTY OF ACCOUNTY
ACCOUNTY OF ACCOUNTY OF ACCOUNTY
ACCOUNTY OF ACCOUNTY
ACCOUNTY OF ACCOUNTY
ACCOUNTY OF ACCOUNTY
ACCOUNT

OUTLAND DESIGN

206 - 1889 SPALL ROAD KELOWNA, BRITISH COLUMBIA V1Y 4R2

LANDSCAPE DRAWING LIST

ATTACHMENT This forms part of application # HAP17-0013 City of Planner EW Initials











188 BEACH AVE, KELOWNA BC LOT 1, DISTRICT LOT 14, OSOYOOS DIVISION OF YALE DISTRICT, PLAN 36323 HUMER RESIDENCE


EXTERIOR 3D VIEWS

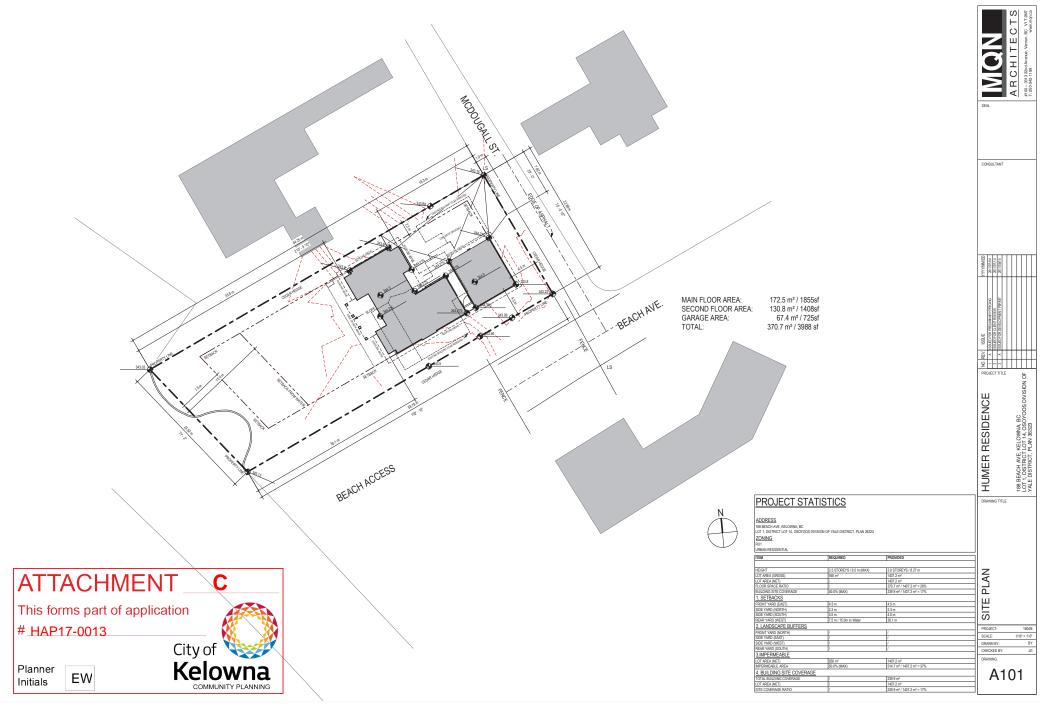


Harner Possid errox (7.0 Das ale gx(7.1 Cu rent Illickling (Dasking)) 67-45H unit (Diskler cunt

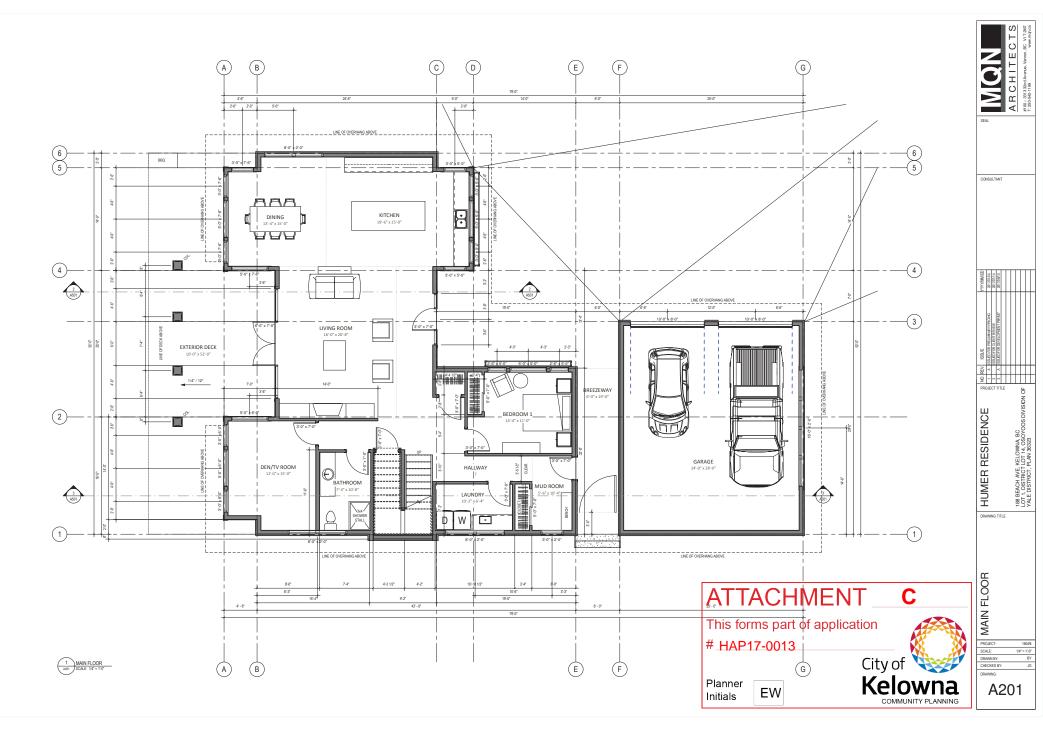


old ence (T.D. Das sub golf - 1.Ds ment fill other g.Dsa saingt 100 4614 same o'De sidner central

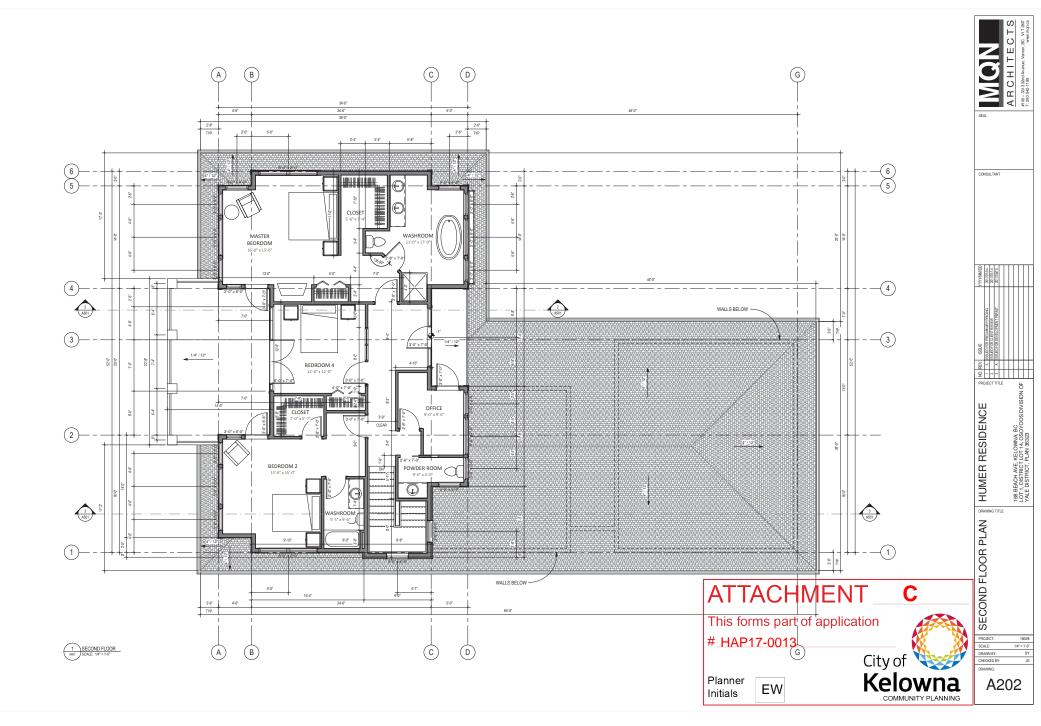

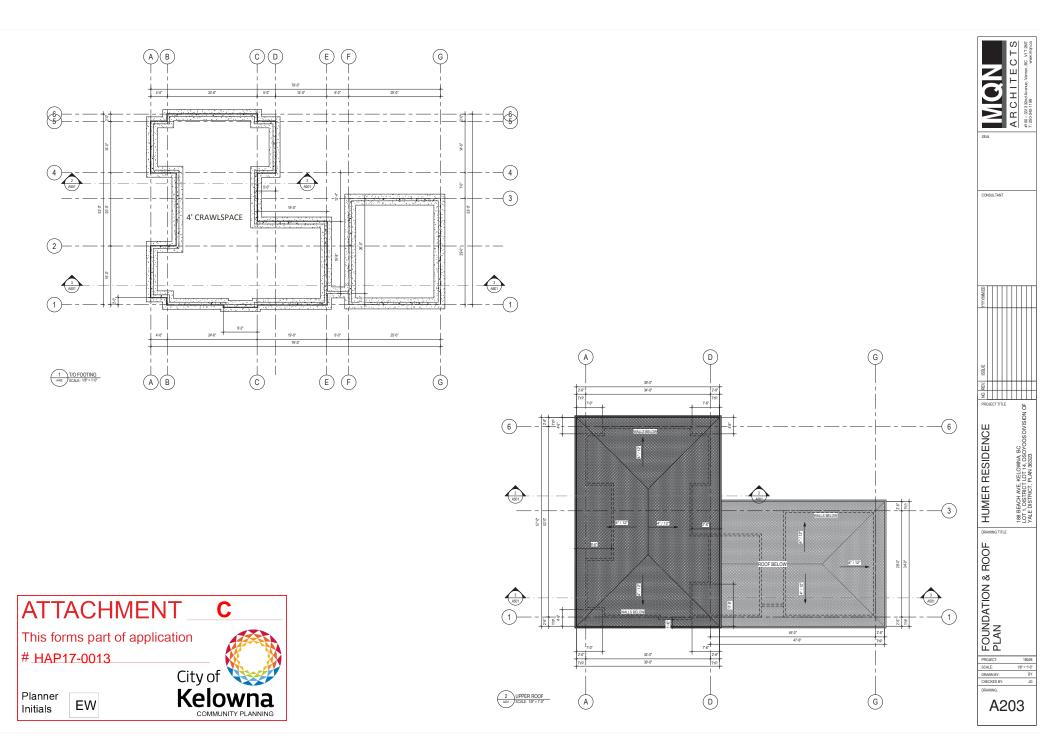

P1201 81 864 8 Human Planid enco V.D. Da ank guD. 1. Cu ment Illicidin g. Da aving 186 46 H uma c'Desiden cu nut

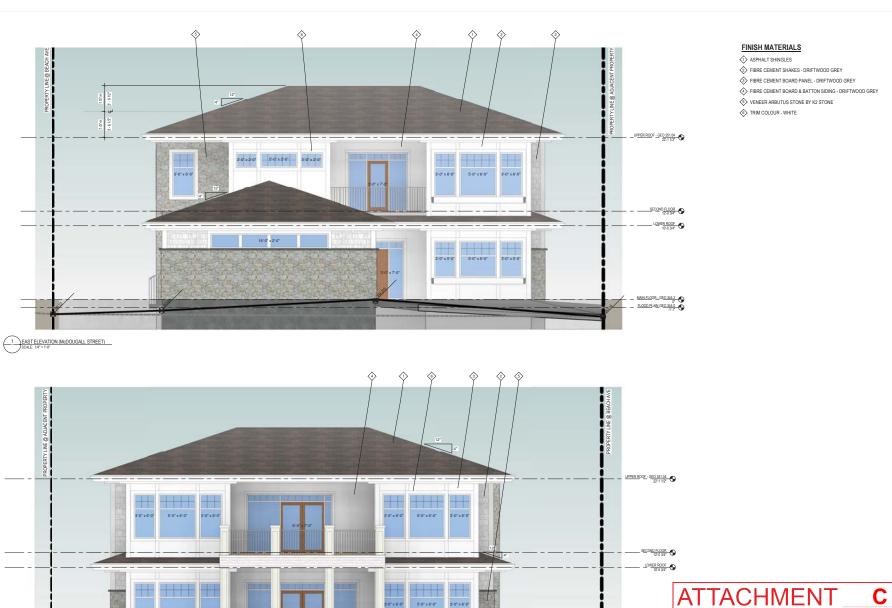

This forms part of application

Planner Initials





ARCHITECTS
#100-33133804 Avenue, Verron, BC VIT 380
T:250 542-1199

CONSULTANT

188 BEACH AVE, KELOWNA, BC LOT 1, DISTRICT LOT 14, OSOYOOS DIVISION OF YALE DISTRICT, PLAN 36323 HUMER RESIDENCE

DRAWING TITLE

EXTERIOR ELEVATIONS


SCALE:


A401

2 WEST ELEVATION (OKANAGAN LAKE)

3'-0" x 7'-6"

5'-0" x 7'-6"

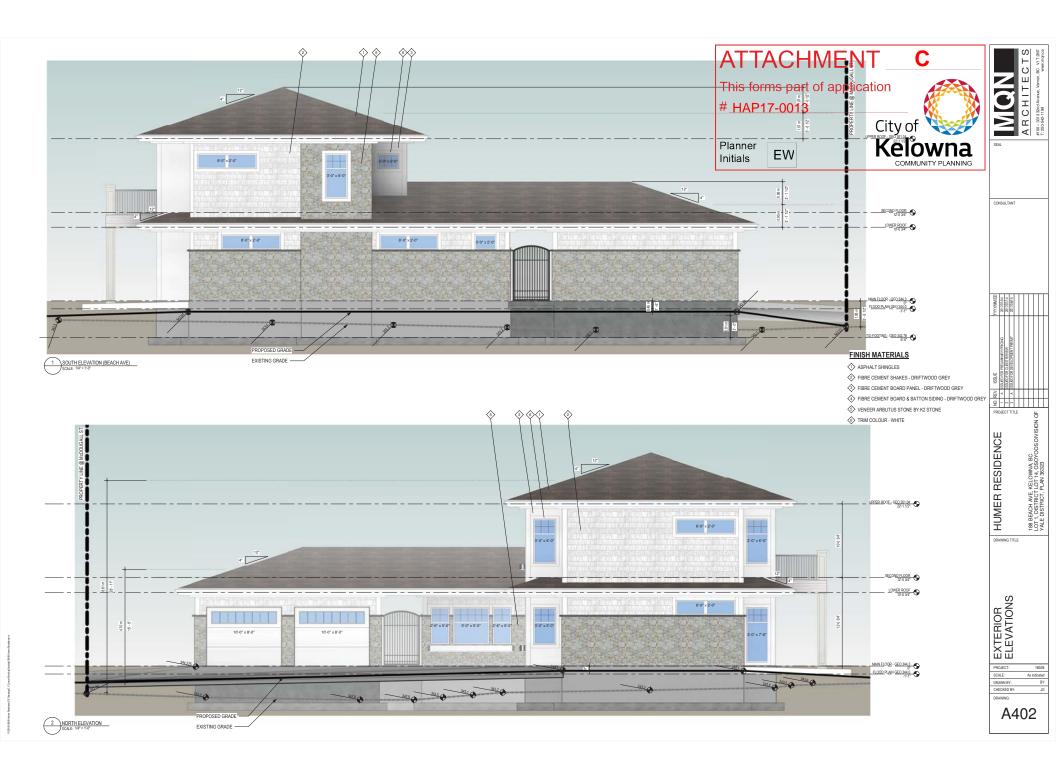

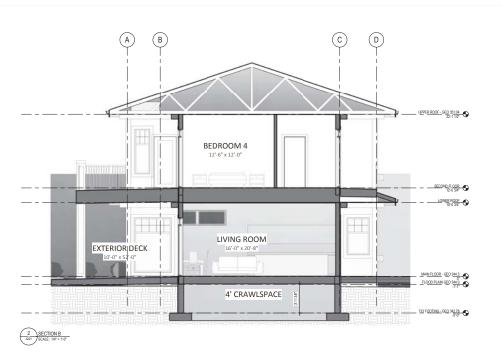



ARCHITECTS
11:205-50:1130
11:205-50:1130
11:205-50:1130

CONSULTANT

0 PEV 858E | WYYMMAD | 1 A SECTION PREJAMENT PROTECT | 2 MINER | 2


HUMER RESIDENCE

88 BEACH ANE, KELOMMA, BC
COT., DRINGTO, DRIVE ASSOCOS DIVISION OF
WELD SIGHTOT, PLAN, 85220

DRAWING TITLE

BUILDING SECTIONS

PROJECT: 16049i
SCALE: 1/4" = 1'-0"
DRAWN BY: BY
CHECKED BY: JG

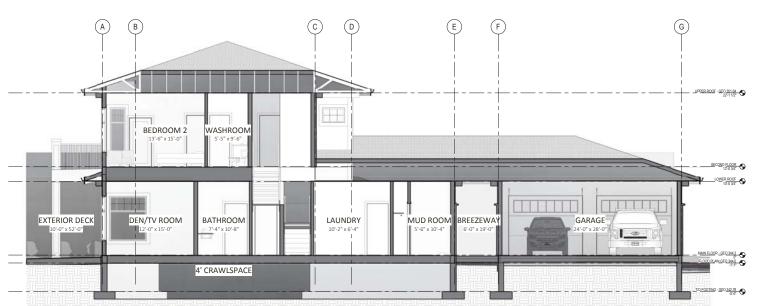



Beach Ave viewing towards Beach Access



Corner or Beach Ave & McDougall Street



McDougall Ave Facing North







Property viewed from beach



East View, from beach



Property viewed from beach



Taken from Beach Access, facing North East



View towards lake



North view from back yard







206 - 1889 Spall Road Kelowna, BC V1Y 4R2 T (250) 868-9270 www.outlanddesign.ca



HUMER RESIDENCE

Kelawna, BC

CONCEPTUAL LANDSCAPE PLAN

3 4		
5		
2		

PROJECT NO	17048	
DESIGN BY		
DRAWN BY	CS	
CHECKED BY	FB	
DATE	AUGUST 16, 2017	
SCAF	1-150	



ISSUED FOR REVIEW ONLY



NOTES

- 1 PLANT MATERIAL AND CONSTRUCTION METHODS SHALL MEET OR EXCEED B.C.L.N.A. STANDARDS
- 2. ALL SOFT LANDSCAPE AREAS SHALL BE WATERED BY A FULLY AUTOMATIC TIMED UNDERGROUND IRRIGATION SYSTEM.
- 3. TREE AND SHRUB BEDS TO BE DRESSED IN A MINIMUM 50 mm WOOD MULCH, DO NOT PLACE WEED MAT UNDERNEATH TREE AND SHRUB BEDS.
- 4 TREE AND SHRUR REDS TO RECEIVE A MINIMUM 300mm DEPTH TOPSOU PLACEMENT.
- 5. TURF AREAS FROM SOD SHALL BE NO. 1 GRADE GROWN FROM CERTIFIED SEED OF IMPROVED CLITHVAS RECISTERED FOR SALE IN B.C. AND SHALL BE TOLERANT OF DROUGHT CONDITIONS. A MINIMUM OF 150m DEPTH OF GROWNEN MEDIUM IS REQUIRED BENEATH TURF AREAS. TURF AREAS SHALL MEET EXISTING GRADES AND HARD SURFACES RUSH.

PLANT LIST

BOTANICAL NAME COMMON NAME QTY SIZE / SPACING & REMARKS

TREES
ACER PALMATUM 'GLOWING EMBERS'
CERCIDIPHYLLUM JAPONICUM
PRUNUS 'SNOW GOOSE'

SHRUBS, ORNAMENTAL GRASSES, PERENNIALS & VINES

SIRUBS, ORNAMENTAL GRASSES, PRENNALS & ACHIELA MOCHSINE' ALLOPECURUS PRATENSIS 'ALLERA VARIEGATA' BUJUSI 'CIREN CEM' GERANIMA X' "SYLISH' SPACH HOSTA FRANCH HANDO' LAVANDULA ANACURI CHANDO' LAVANDULA ANACURI CHANDO LAVANDULA ANACURI CHANDO LAVANDULA ANACURI CHANDO LAVANDULA ANACURI CHANDO LAVANDULA CHANDULA CHANDO LAVANDULA CHANDO LAVANDULA CHANDO LAVANDULA CHANDO LA MEKIENSIA PTEROCARPA
PENNISETUM ALOPECUROIDES
PHILADELPHUS 'SNOWBELLE'
PHILOX SUBULATA 'SNOW GUEEN'
RUDBECKIA FULGIDA 'GOLDSTURM'
SEDUM SPECTABILE 'AUTUMN FIRE'
SYRINGA MEYERI 'PALIBIN'

SYRINGA VULGARIS 'MADAME LEMOINE'

GLOWING EMBERS JAPANESE MAPLE KATSURA TREE SNOW GOOSE CHERRY

MOONSHINE YABROW
YELIOW FOXTAIL GRASS
GREEN GER BOXWOOD
SPLISH SPLASH GERANIUM
FRANCE HOSTIA
PRAVING HANDIS HOSTIA
HIDCOIE ENGUISH LAVENDAR
AGUAL SHASTA DAISY
KOBOLD GAYFEATHER
SWARF BULE FLAX
JAPANEES BULEBELIS
FOUNTAIN GRASS JAYANESE BILLIBELLS
FOUNTAIN GRASS
SNOWBELE MOCKORGANE
WHITE MOSS PHLOX
GOLDSTURM RUDBECKIA
AUTUMN FIRE STONECKOP
DWARF KOREAN UILAC
MADAME LEMOINE FRENCH LILAC

#01 CONT //0 AM O.C. SPACING #01 CONT //0 AM 27 #02 CONT./1.5M O.C. SPACING 12 #02 CONT./2.5M O.C. SPACING


ATTACHMENT

This forms part of application #_HAP17-0013

Planner Initials

EW



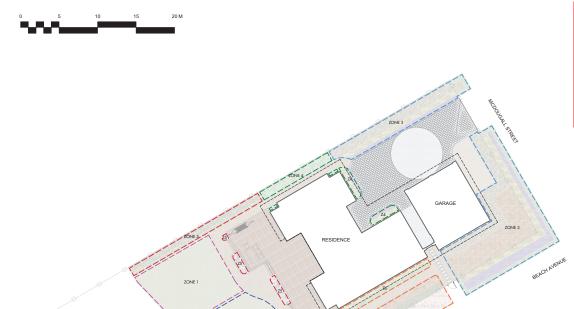

ZONE 2

ZONE 6

COVENANT AREA

WATER CONSERVATION CALCULATIONS LANDSCAPE MAXIMUM WATER BUDGET (WB) = 860 cu.m. / yea

*REFER ATTACHED IRRIGATION APPLICATION FOR DETAILED CALCULATIONS

ESTIMATED LANDSCAPE WATER USE (WU) = 587 cu.m. / year WATER BALANCE = 273 cu.m. / year

ATTACHMENT

This forms part of application

#_HAP17-0013

Planner ΕW Initials

IRRIGATION LEGEND

ZONE #1: LOW VOLUME POP-UP SPRAYHEADS FOR TURF AREA
TOTAL AREA: 92.5 sq.m.
MCROCOLIMATE: WEST EXPOSURE, PARTIALLY SHADED BY TREES
ESTIMATED ANNUAL WATER USE: 132 cu.m. ZONE #2: LOW VOLUME POP-UP SPRAYHEADS FOR TURF AREA TOTAL AREA: 94 sq.m.
MICROCIIWATE: WEST EXPOSURE, PARTIALITY SHADED BY TREES ESTIMATED ANNUAL WATER USE: 134 cu.m.

CSIMALED ANNUAL WAITER USE-112 GUM

ZONE RA: HIGH EFFICIENCY SUSUIFACE DRIP IRRIGATION FOR
MODERATE WATER USE FLANTING AREAS

TOTAL AREA: 28 sq. m.
MICROCLIMATE: NORTH EXPOSURE, PARTIALLY SHADED BY TREES AND
BUILDING

ESTIMATED ANNUAL WATER USE-16 cu.m.

COME 45: HIGH EFFICIENCY SUBSURFACE DRIP REIGATION FOR MODERATE WATER SEE FLANTING AREAS

☐ TOTAL AREA: 41.5 sq.m.

MICROCLIMATE: SOUTH EXPOSURE, PARTIALLY SHADED BY TREES AND HEDGE
ESTIMATED ANNUAL WATER USE: 23 cu.m.

ZONE 16: HIGH EFRICIENCY SUBSUREACE DRIP IRRIGATION FOR MODERATE WATER USE PRAINTING AREAS TOTAL MARKET 179; apr.

MICROCLIMATE: SOUTH EXPOSURE, PARTIALLY SHADED ESTIMATED ANNULA WATER USE: 99 co.m.

City of Kélowna



206 - 1889 Spall Road Kelowna, BC V1Y 4R2 T (250) 868-9270 www.outlanddesign.ca



HUMER RESIDENCE

Kelawna, BC

WATER CONSERVATION/ IRRIGATION PLAN

2	
3	
4	
5	
5	
_	

PROJECT NO	17048	
DESIGIN BY	CS	
DRAWN BY	CS	
CHECKED BY	FB	
DATE	AUGUST 16, 2017	
SCALE	1-150	



ISSUED FOR REVIEW ONLY

IRRIGATION NOTES

1. IRRIGATION PRODUCTS AND INSTALLATION METHODS SHALL MEET OR EXCEED THE REQUIREMENTS OF THE WATER USE REQULATION BYLAW NO. 10480 AND THE SUPPLEMENTARY SPECIFICATIONS IN THE CITY OF KELOWINA BYLAW 7900 (PART 6, SCHEDULE 5).

2. THE IRRIGATION SYSTEM SHALL MEET THE REQUIREMENTS, REGULATIONS, AND BYLAWS OF THE WATER PURVEYOR.

3. THE IRRIGATION SYSTEM SHALL BE EQUIPPED WITH AN APPROVED BACKFLOW PREVENTION DEVICE, WATER METER, AND SHUT OFF VALVE LOCATED OUTSIDE THE BUILDING ACCESSIBLE TO THE CITY.

4. AN APPROVED SMART CONTROLLER SHALL BE INSTALLED. THE IRRIGATION SCHEDULING TIMES SHALL UTILIZE A MAXIMUM ET VALUE OF 7" / MONTH (KELOWNA JLLY ET), TAKING INTO CONSIDERATION SOIL TYPE, SLOPE, AND MICROCLIMATE.

5. DRIP LINE AND EMITTERS SHALL INCORPORATE TECHNOLOGY TO LIMIT ROOT INTRUSION.

6. IRRIGATION SLEEVES SHALL BE INSTALLED TO ROUTE IRRIGATION LINES UNDER HARD SURFACES AND FEATURES.

8. A FLOW SENSOR AND MASTER VALVE SHALL BE CONNECTED TO THE CONTROLLER AND PROGRAMMED TO STOP FLOW TO THE SYSTEM IN CASE OF AN IRRIGATION WATER LEAK.

7 IRRIGATION PIPE SHALL RE SIZED TO ALLOW FOR A MAXIMUM FLOW OF 1.5m /SEC