

2017.09.12

City of Kelowna Heritage Advisory Committee 1435 Water Street Kelowna, BC V1Y 1J4

Attention: Heritage Advisory Committee

RE: 188 Beach Ave Residence



Dear Committee Members,

MQN Architects has been engaged to design a replacement home for 188 Beach Ave within the Abbott Street Heritage Conservation area. The existing home on this property has been deteriorating for many years and would require substantial upgrades which are not feasible. The owners of this property are looking to demolish the existing house and construct a new home at this location.

The current owners were drawn to this location by the heritage nature of the properties and the character of the neighbourhood. Their intention is to build a home which is complimentary to the heritage character of the surrounding neighbourhood, which will reinforce the goals of the conservation area. Through the design process, MQN Architects has reviewed the requirements of the City of Kelowna Abbott Street & Marshall Street Heritage Conservation Areas. Based on this document the existing house at 188 Beach Avenue was classified as a Vernacular Cottage (late). The properties surrounding this area provide a range of building styles including Tudor Revival, Arts & Crafts and Early Suburban. The varieties of different styles that have developed over time in this area provides a cohesive, varied, and interesting neighbourhood. The design of the new house for 188 Beach Avenue has been developed following the design features of the Late Vernacular Cottage style.

In keeping with the Heritage Conservation requirements, which identifies the late cottage vernacular style for this property, we believe that it is sympathetic to the neighbouring properties and is well suited to the scale and positioning of the proposed home. Having drawn inspiration from this style the design maintains the character of the neighbourhood. The home incorporates period features, materiality, scale and detailing and the hip roof and fenestration are comparable to similar character homes in the area and of the identified style.

The new home's roofline is lowered towards the street which reduces the visual mass of the home on the corner property. Normally locating a garage in front of the house would not be in keeping with the character of a historic neighbourhood, however in this case McDougall Street is more akin to a back alley. The waterfront houses front towards the lake, with McDougall Street providing access. The siting of the home has also been carefully considered in our decision to align the Beach Ave side of the home with the existing home's setback. The proposed home is larger than the existing house, however when reviewed in the context of this neighbourhood, the proposed home is consistent with the scale of the adjacent houses and is still in keeping with the max 2 storey massing of this period.



Building on the ideas of the Abbott Street & Marshall Street Heritage Conservation Areas, 188 Beach avenue has been designed acknowledging the intents and design guidelines. The proposed design is derived from the historical architectural styles present in the local neighbourhood and the design works to reinforce the diversity and character which make this area of Kelowna a character neighbourhood. Below is a depiction of the proposed home design and our compliance with the 'Abbot Street & Marshall Street Heritage Conservation Area' 'Development Guidelines' related to the Late Vernacular Cottage listed characteristics;

- ✓ Less fanciful feel to the architecture
- ✓ Flush gable verges
- ✓ Up to 2 storey massing
- ✓ Asymmetrical façade design
- ✓ Clustered vertical window sashes
- ✓ Minor decorative detailing (window muntins, railings)
- ✓ Hip roof forms
 (sim. to other builds in the area)
- ✓ Wood shakes
- ✓ Siding in driftwood grey
- ✓ Interlocking asphalt roof shingles





Thank you in advance for your time, efforts and consideration to assist us in building our clients dream home. If you require any further clarifications or details please don't hesitate to contact our office.

Yours truly,

Brian Quiring
Partner
MQN Architects



HUMER RESIDENCE

188 BEACH AVE, KELOWNA, BC LOT 1, DISTRICT LOT 14, OSOYOOS DIVISION OF YALE DISTRICT, PLAN 36323



HUMER RESIDENCE PROJECT: 16049i DATE: 2017/08/15 ISSUED FOR DEVELOPMENT

MICHAEL HUMER & MARIA VERDURMEN

MQN ARCHITECTS

ARCHITECTURAL DRAWING LIST

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OUTLAND DESIGN

206 - 1889 SPALL ROAD KELOWNA, BRITISH COLUMBIA V1Y 4R2

LANDSCAPE DRAWING LIST

ATTACHMENT This forms part of application # HAP17-0013 Planner EW Initials












188 BEACH AVE, KELOWNA, BC LOT 1, DISTRICT LOT 14, OSOYOOS DIVISION OF YALE DISTRICT, PLAN 36323 HUMER RESIDENCE

EXTERIOR 3D VIEWS


A003

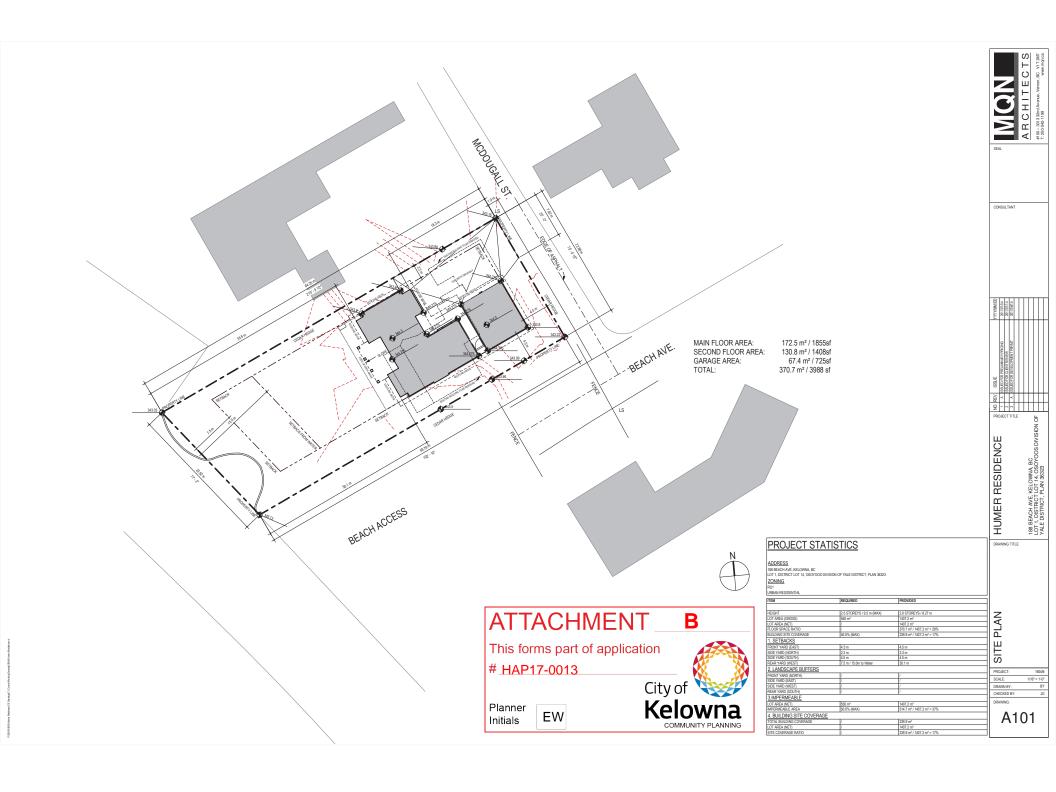

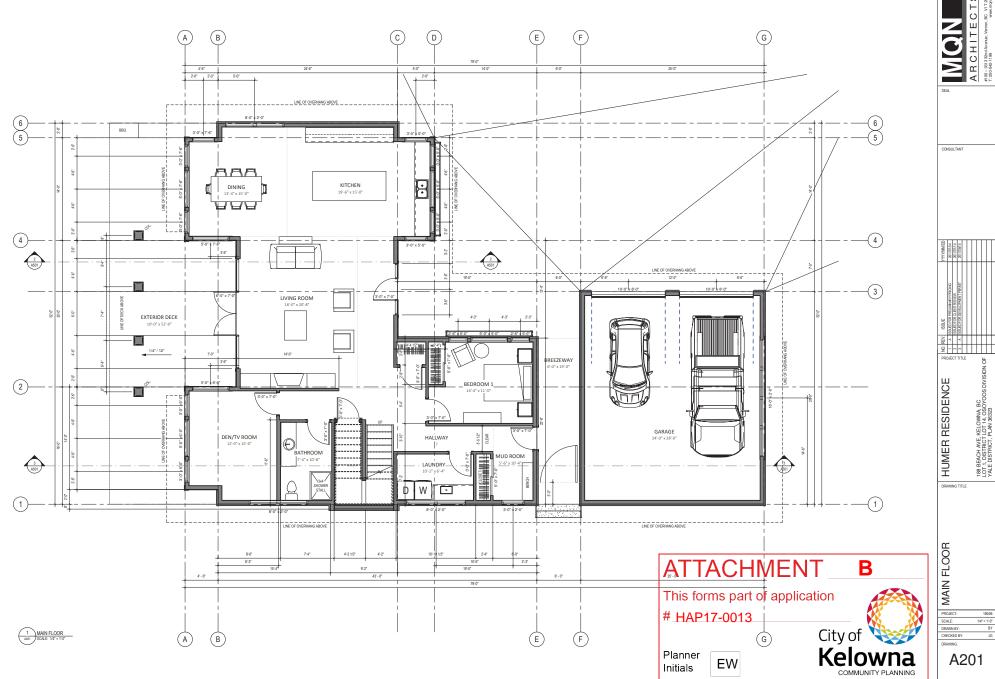

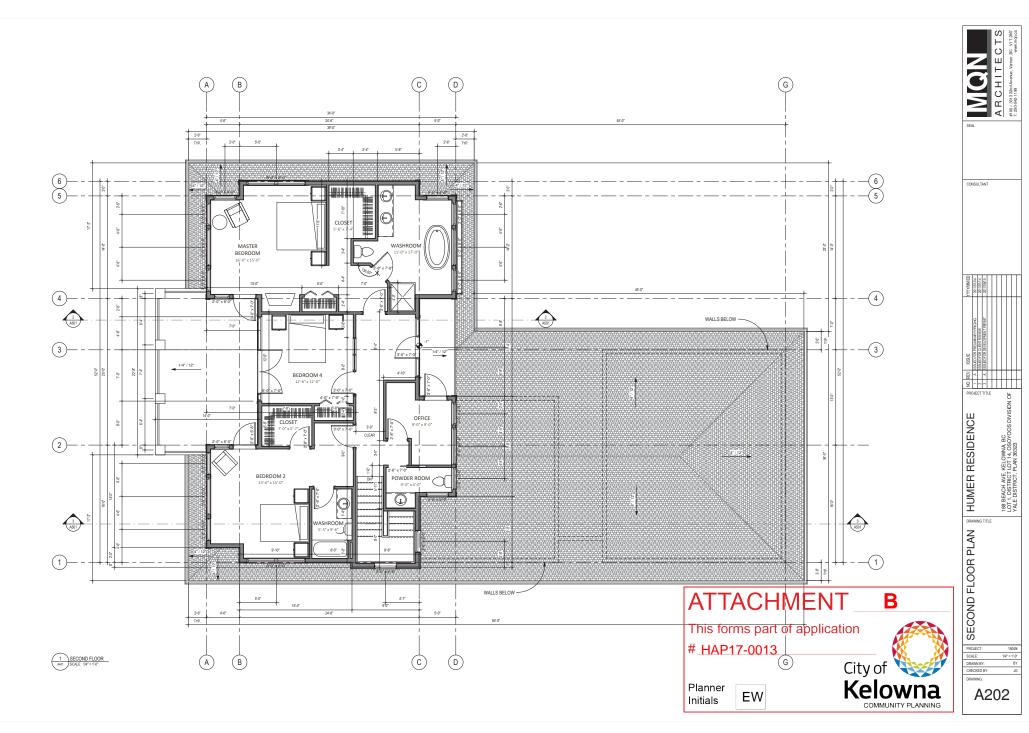

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Initials

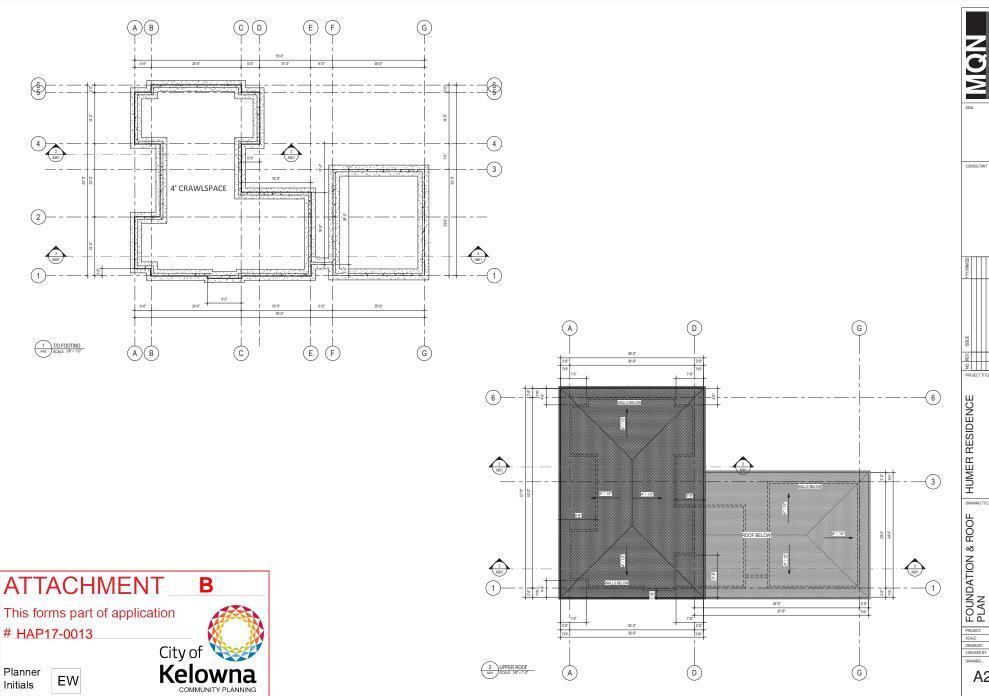A203



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6

FINISH MATERIALS

- (1) ASPHALT SHINGLES
- ♦ FIBRE CEMENT SHAKES DRIFTWOOD GREY
- ♦ FIBRE CEMENT BOARD PANEL DRIFTWOOD GREY
- ♦ FIBRE CEMENT BOARD & BATTON SIDING DRIFTWOOD GREY
- ♦ VENEER ARBUTUS STONE BY K2 STONE
- ♦ TRIM COLOUR WHITE



A401



ATTACHMENT

This forms part of application

Planner Initials


EW

City of Kelowna

B

2 WEST ELEVATION (OKANAGAN LAKE) SCALE: 1/4" = 1'-0"



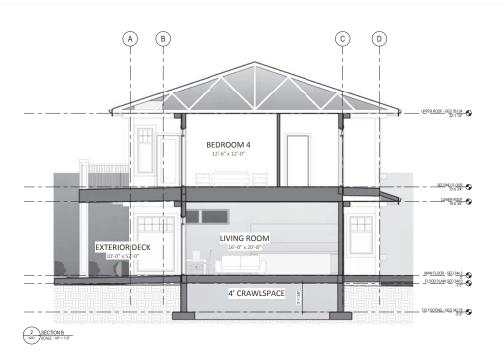




CONSULTANT 188 BEACH AVE, KELOWNA BC LOT 1, DISTRICT LOT 14, OSOYOOS DIVISION OF YALE DISTRICT, PLAN 36323 HUMER RESIDENCE **BUILDING SECTIONS**

PROJECT: SCALE: DRAWN BY: CHECKED BY:

A501

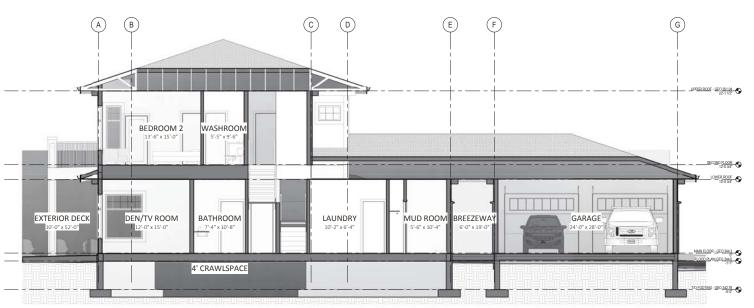

3 SECTION C A201 SCALE: 1/4" = 1'-0"



Beach Ave viewing towards Beach Access



Corner or Beach Ave & McDougall Street



McDougall Ave Facing North







Property viewed from beach



East View, from beach



Property viewed from beach





View towards lake



North view from back yard





Architecture & Interior Design





206 - 1889 Spall Road Kelowna, BC V1Y 4R2 T (250) 868-9270 www.outlanddesign.ca



HUMER RESIDENCE

Kelawna, BC

CONCEPTUAL LANDSCAPE PLAN

4		
5		
5		

PROJECT NO	17048
DESIGN BY	
DRAWN BY	CS
CHECKED BY	FB
DATE	AUGUST 16, 2017
SCALE	1:150



ISSUED FOR REVIEW ONLY



NOTES

- 1 PLANT MATERIAL AND CONSTRUCTION METHODS SHALL MEET OR EXCEED B.C.L.N.A. STANDARDS
- 2. ALL SOFT LANDSCAPE AREAS SHALL BE WATERED BY A FULLY AUTOMATIC TIMED UNDERGROUND IRRIGATION SYSTEM.
- 3. TREE AND SHRUB BEDS TO BE DRESSED IN A MINIMUM 50 mm WOOD MULCH, DO NOT PLACE WEED MAT UNDERNEATH TREE AND SHRUB BEDS.
- 4 TREE AND SHRUR REDS TO RECEIVE A MINIMUM 300mm DEPTH TOPSOU PLACEMENT
- 5. TURF AREAS FROM SOD SHALL BE NO. 1 GRADE GROWN FROM CERTIFIED SEED OF IMPROVED CLITHVAS RECISTERED FOR SALE IN B.C. AND SHALL BE TOLERANT OF DROUGHT CONDITIONS. A MINIMUM OF 150m DEPTH OF GROWNEN MEDIUM IS REQUIRED BENEATH TURF AREAS. TURF AREAS SHALL MEET EXISTING GRADES AND HARD SURFACES RUSH.

PLANT LIST

BOTANICAL NAME COMMON NAME QTY SIZE / SPACING & REMARKS

TREES ACER PALMATUM 'GLOWING EMBERS' CERCIDIPHYLLUM JAPONICUM PRUNUS 'SNOW GOOSE'

SREUIS, ORBANINAL GRASSES, PERENALS & VINES
ACHILLA MOONSHINE*
ALOPECURIS PRINSES VAUREA VAREGATA*
BUILS GERN CEM
BUILS GERN FEBRUM VAGUAL
BUILS GERN FEBRUM CEM
BUI MEKIENSIA PTEROCARPA
PENNISETUM ALOPECUROIDES
PHILADEIPHUS 'SNOWBELLE'
PHICOX SUBULATA 'SNOW QUEEN'
RUDBECKIA FULGIDA 'GOLDSTURM'
SEDUM SPECTABILE' AUTUMN FIRE'
SYRINGA MEYERI 'PALIBIN'

SYRINGA VULGARIS 'MADAME LEMOINE'

GLOWING EMBERS JAPANESE MAPLE KATSURA TREE SNOW GOOSE CHERRY

MOONSHINE YABROW
YELIOW FOXTAIL GRASS
GREEN GER BOXWOOD
SPLISH SPLASH GERANIUM
FRANCE HOSTIA
PRAVING HANDIS HOSTIA
HIDCOIE ENGUISH LAVENDAR
AGUAL SHASTA DAISY
KOBOLD GAYFEATHER
SWARF BULE FLAX
JAPANEES BULEBELIS
FOUNTAIN GRASS


JAYANESE BILLIBELLS
FOUNTAIN GRASS
SNOWBELE MOCKORGANE
WHITE MOSS PHLOX
GOLDSTURM RUDBECKIA
AUTUMN FIRE STONECKOP
DWARF KOREAN UILAC
MADAME LEMOINE FRENCH LILAC

SPACING NITIALS 27 #02 CONT./1.5M O.C. SP 12 #02 CONT./2.5M O.C. SP

ΕW





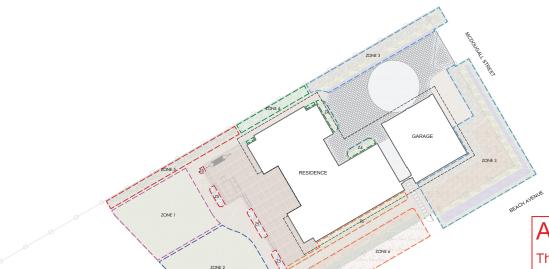

ZONE 6

WATER CONSERVATION CALCULATIONS

COVENANT AREA

LANDSCAPE MAXIMUM WATER BUDGET (WB) = 860 cu.m. / yea ESTIMATED LANDSCAPE WATER USE (WU) = 587 cu.m. / year WATER BALANCE = 273 cu.m. / year

*REFER ATTACHED IRRIGATION APPLICATION FOR DETAILED CALCULATIONS

IRRIGATION NOTES

1. IRRIGATION PRODUCTS AND INSTALLATION METHODS SHALL MEET OR EXCEED THE REQUIREMENTS OF THE WATER USE REQULATION BYLAW NO. 10480 AND THE SUPPLEMENTARY SPECIFICATIONS IN THE CITY OF KELOWINA BYLAW 7900 (PART 6, SCHEDULE 5).

2. THE IRRIGATION SYSTEM SHALL MEET THE REQUIREMENTS, REGULATIONS, AND BYLAWS OF THE WATER PURVEYOR.

3. THE IRRIGATION SYSTEM SHALL BE EQUIPPED WITH AN APPROVED BACKFLOW PREVENTION DEVICE, WATER METER, AND SHUT OFF VALVE LOCATED OUTSIDE THE BUILDING ACCESSIBLE TO THE CITY.

4. AN APPROVED SMART CONTROLLER SHALL BE INSTALLED. THE IRRIGATION SCHEDULING TIMES SHALL UTILIZE A MAXIMUM ET VALUE OF 7" / MONTH (KELOWINA JULY ET), TAKING INTO CONSIDERATION SOIL TYPE, SLOPE, AND MICROCLIMATE.

5. DRIP LINE AND EMITTERS SHALL INCORPORATE TECHNOLOGY TO LIMIT ROOT INTRUSION.

6. IRRIGATION SLEEVES SHALL BE INSTALLED TO ROUTE IRRIGATION LINES UNDER HARD SURFACES AND FEATURES.

7 IRRIGATION PIPE SHALL RE SIZED TO ALLOW FOR A MAXIMUM FLOW OF 1.5m /SEC

8. A FLOW SENSOR AND MASTER VALVE SHALL BE CONNECTED TO THE CONTROLLER AND PROGRAMMED TO STOP FLOW TO THE SYSTEM IN CASE OF AN IRRIGATION WATER LEAK.

ATTACHMENT

This forms part of application # HAP17-0013

Planner Initials

EW

City of Kelowna

IRRIGATION LEGEND

ZONE #1: LOW VOLUME POP-UP SPRAYHEADS FOR TURF AREA
TOTAL AREA: 92.5 sq.m.
MCROCOLIMATE: WEST EXPOSURE, PARTIALLY SHADED BY TREES
ESTIMATED ANNUAL WATER USE: 132 cu.m.

ZONE #2: LOW VOLUME POP-UP SPRAYHEADS FOR TURF AREA
TOTAL AREA: 94 sq.m.
MCROCILMATE: WEST EXPOSURE, PARTIALLY SHADED BY TREES
ESTIMATED ANNUAL WATER USE: 134 cu.m.

ZONE #3. HIGH SPECIENCY SUBSURFACE DRIP RRIGATION FOR MODERATE WATER USE RANTING AREAS

TOTAL AREA. 201-year.
MICROCLAMATE SOUTH PROSOURE, PARTIALLY SHADED BY TREES AND BUILDING.
ESTIMATED ANNUAL WATER USE: 112 cu m.

CSIMALED ANNUAL WAITER USE-112 GUM

ZONE RA: HIGH EFFICIENCY SUSUIFACE DRIP IRRIGATION FOR
MODERATE WATER USE FLANTING AREAS

TOTAL AREA: 28 sq. m.
MICROCLIMATE: NORTH EXPOSURE, PARTIALLY SHADED BY TREES AND
BUILDING

ESTIMATED ANNUAL WATER USE-16 cu.m.

COME 45: HIGH EFFICIENCY SUBSURFACE DRIP REIGATION FOR MODERATE WATER SEE FLANTING AREAS

☐ TOTAL AREA: 41.5 sq.m.

MICROCLIMATE: SOUTH EXPOSURE, PARTIALLY SHADED BY TREES AND HEDGE
ESTIMATED ANNUAL WATER USE: 23 cu.m.

ZONE 16: HIGH EFRICIENCY SUBSUREACE DRIP IRRIGATION FOR MODERATE WATER USE PRAINTING AREAS TOTAL MARKET 179; apr.

MICROCLIMATE: SOUTH EXPOSURE, PARTIALLY SHADED ESTIMATED ANNULA WATER USE: 99 co.m.

OUTLAND DESIGN LANDSCAPE ARCHITECTURE 206 - 1889 Spall Road Kelowna, BC V1Y 4R2 T (250) 868-9270 www.outlanddesign.ca



HUMER RESIDENCE

WATER CONSERVATION/ IRRIGATION PLAN

CS	
17048	
NO BY	



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