# DEVELOPMENT VARIANCE PERMIT



#### APPROVED ISSUANCE OF DEVELOPMENT VARIANCE PERMIT NO. DVP17-0148

**Issued To:** Angelo Kokonas

Site Address: 671 Ellis Street

**Legal Description:** Lot A District Lot 9 ODYD Plan EPP52340

**Zoning Classification:** RU6 – Two Dwelling Housing

Development Permit Area: N/A

#### **SCOPE OF APPROVAL**

This Permit applies to and only to those lands within the Municipality as described above, and any and all buildings, structures and other development thereon.

This Permit is issued subject to compliance with all of the Bylaws of the Municipality applicable thereto, except as specifically varied or supplemented by this Permit, noted in the Terms and Conditions below.

The issuance of a Permit limits the Permit Holder to be in strict compliance with regulations of the Zoning Bylaw and all other Bylaws unless specific Variances have been authorized by the Permit. No implied Variances from bylaw provisions shall be granted by virtue of drawing notations that are inconsistent with bylaw provisions and that may not have been identified as required Variances by the applicant or Municipal staff.

#### 1. TERMS AND CONDITIONS

THAT variances to the following sections of Zoning Bylaw No. 8000 be granted, as shown on Schedule "A":

## Section 13.6.6(a): RU6 - Two Dwelling Housing Development Regulations

To vary the required maximum site coverage from 40% permitted to 43.54% proposed;

## Section 13.6.6(b): RU6 - Two Dwelling Housing Development Regulations

To vary the required maximum lot coverage from 14% permitted to 15.18% proposed.

AND FURTHER THAT this Development Variance Permit is valid for two (2) years from the date of Council approval, with no opportunity to extend.

## 2. PERFORMANCE SECURITY

None required.

#### 3. DEVELOPMENT

ADDDOV/ALC

The land described herein shall be developed strictly in accordance with the terms and conditions and provisions of this Permit and any plans and specifications attached to this Permit that shall form a part hereof.

If the Permit Holder does not register the subdivision permitted by this Permit within two years of the date of this Permit, this Permit shall lapse.

This Permit IS NOT a Building Permit.

#### 4. APPLICANT'S AGREEMENT

I hereby declare that all of the above statements and the information contained in the material submitted in support of this Permit are to the best of my belief, true and correct in all respects. Upon issuance of the Permit for me by the Municipality, then in such case, I covenant and agree to save harmless and effectually indemnify the Municipality against:

- a) All actions and proceedings, costs, damages, expenses, claims, and demands whatsoever and by whomsoever brought, by reason of the Municipality granting to me the said Permit.
- b) All costs, expenses, claims that may be incurred by the Municipality if the construction by me of engineering or other types of works as called for by the Permit results in damages to any property owned in whole or in part by the Municipality or which the Municipality by duty or custom is obliged, directly or indirectly in any way or to any degree, to construct, repair, or maintain.

I further covenant and agree that should I be granted a Development Permit and/or Development Variance Permit, the Municipality may withhold the granting of any Occupancy Permit for the occupancy and / or use of any building or part thereof constructed upon the hereinbefore referred to land until all of the engineering works or other works called for by the Permit have been completed to the satisfaction of the Municipal Engineer and Divisional Director of Community Planning & Real Estate.

Should there be any change in ownership or legal description of the property, I undertake to notify the Community Planning Department immediately to avoid any unnecessary delay in processing the application.

5. AFFROVALS	
Issued and approved by Council on the day of	, 2017.
Ryan Smith, Community Planning Department Manager Community Planning & Real Estate	Date

The PERMIT HOLDER is the <u>CURRENT LAND OWNER</u>. Security shall be returned to the PERMIT HOLDER.

## CITY OF KELOWNA

# **MEMORANDUM**

Date:

July 06, 2017

File No.:

DVP17-0148

To:

Urban Planning Management (LK)

From:

Development Engineering Manager (JK)

Subject:

671 Ellis Street

Lot A, Plan EPP52340


The Development Engineering comments and requirements regarding this DVP application are as follows:


This development variance permits application to vary the maximum accessory building coverage from 14% to 15.18% and also to vary the maximum site coverage from 40% to 43.54% proposed to facilitate the development of an accessory building on the subject property, does not compromise any municipal services.

James Kay, P. Eng.


Development Engineering Manager

JΑ

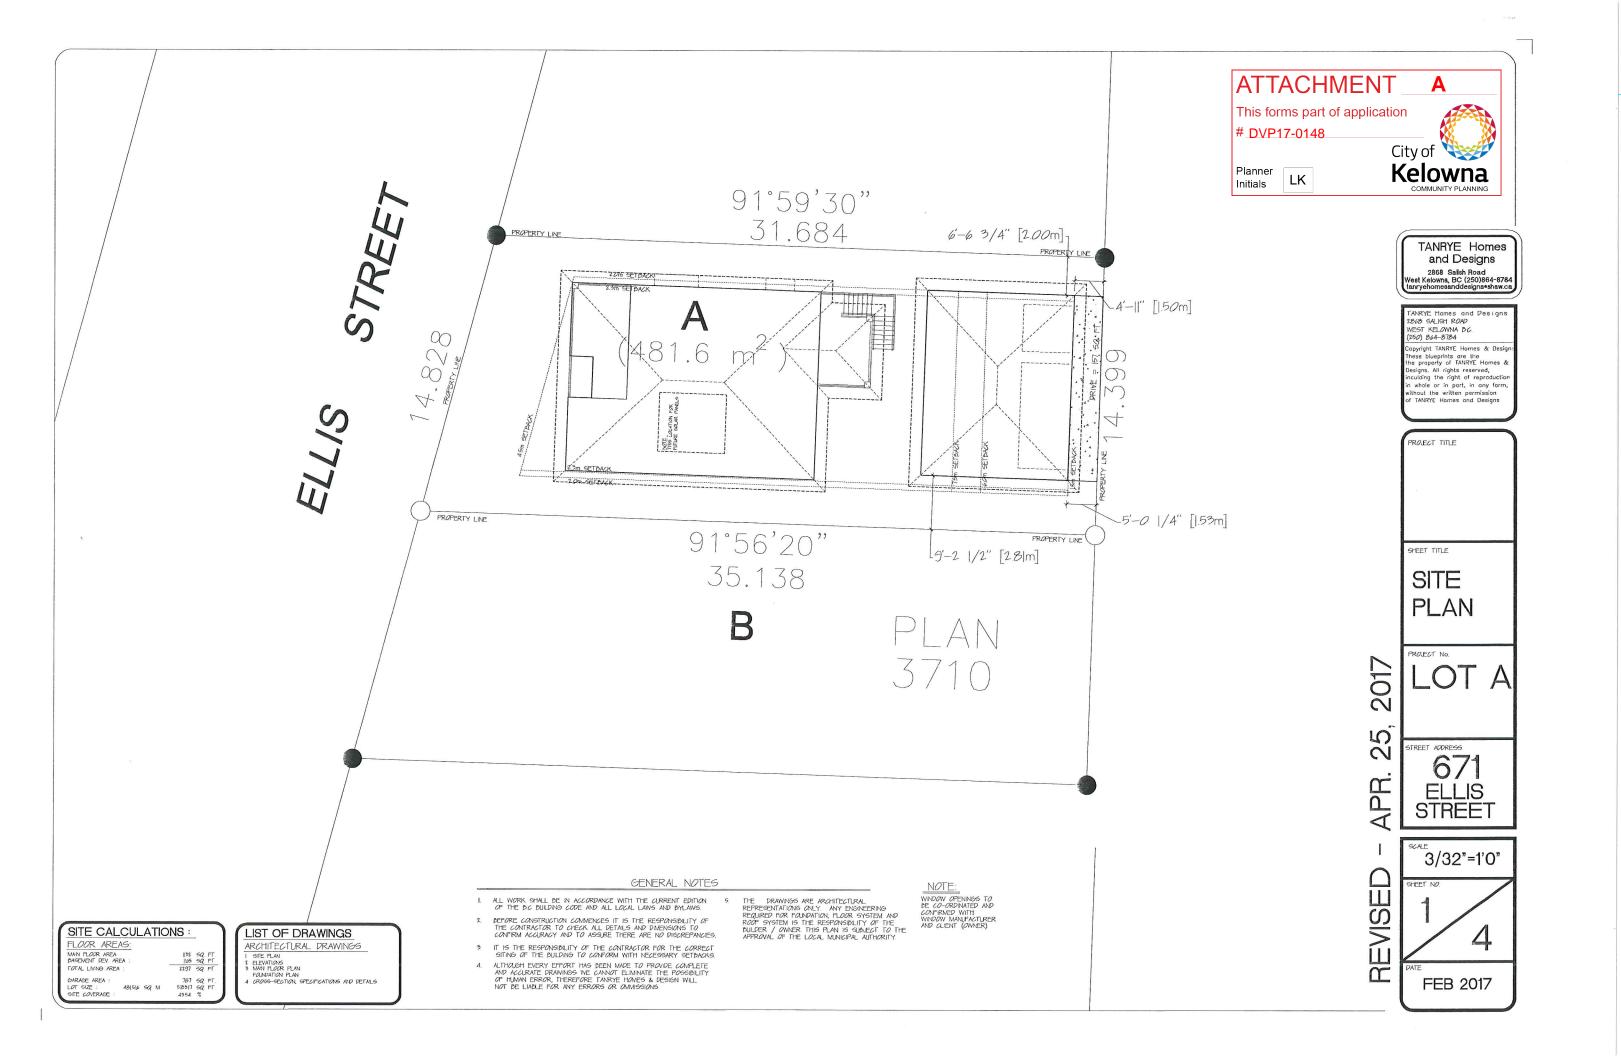

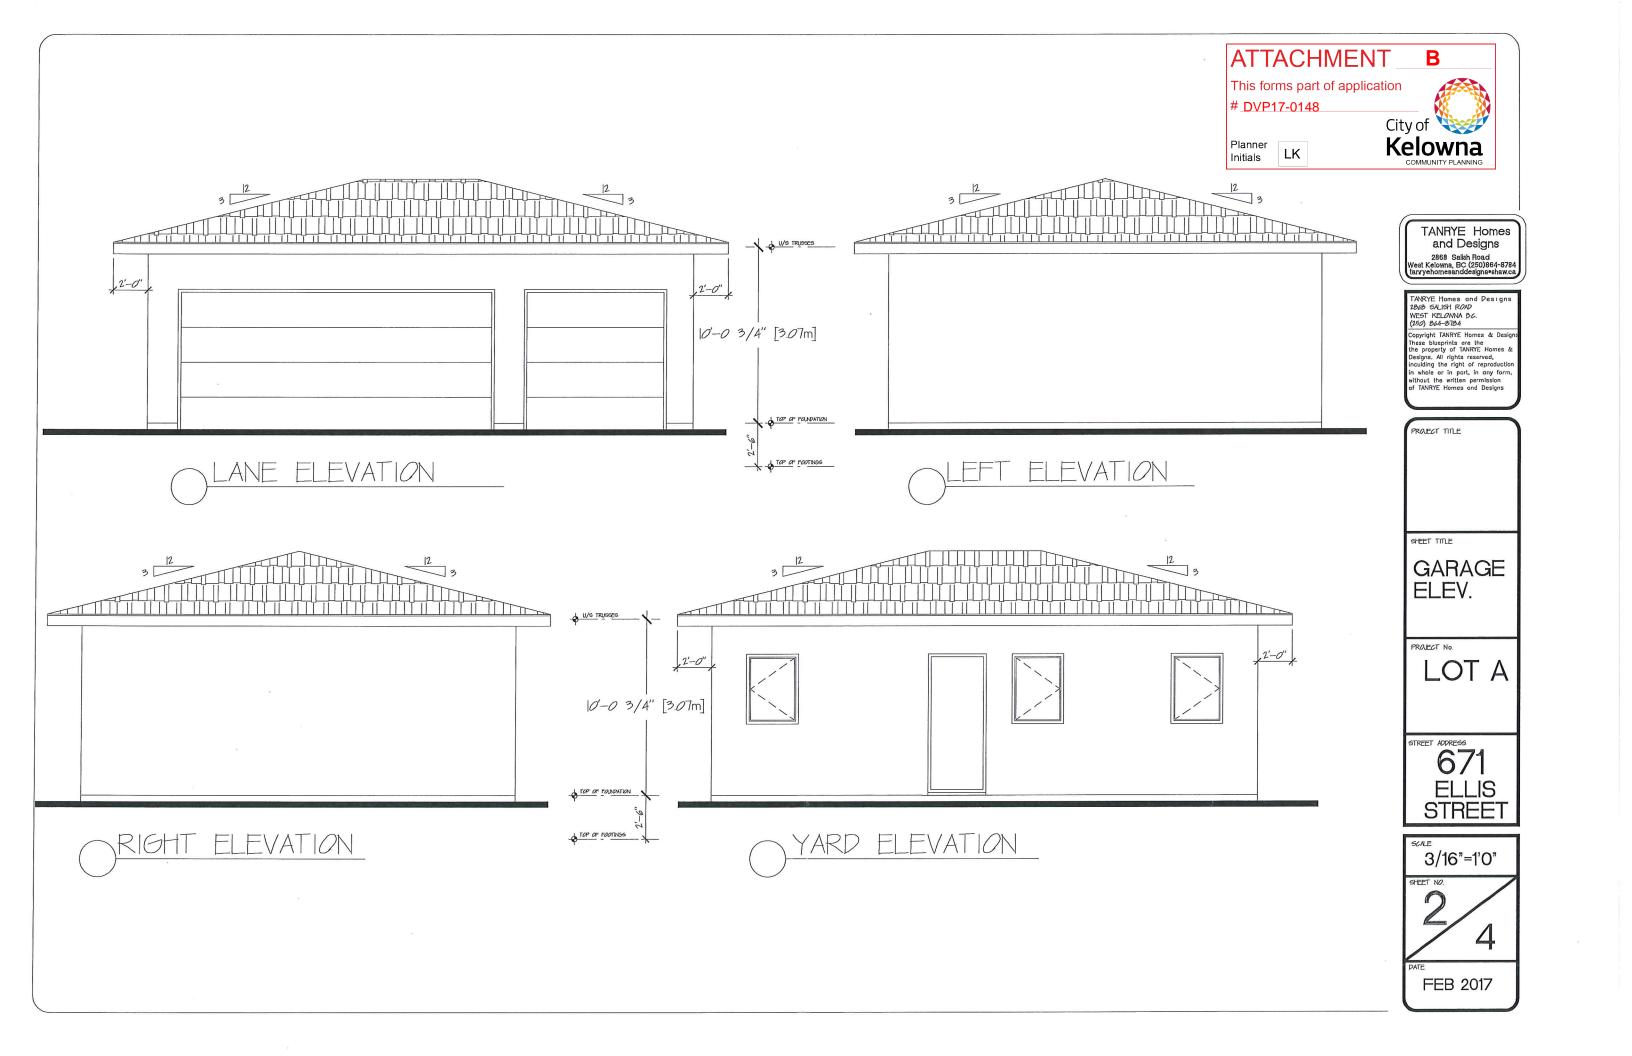



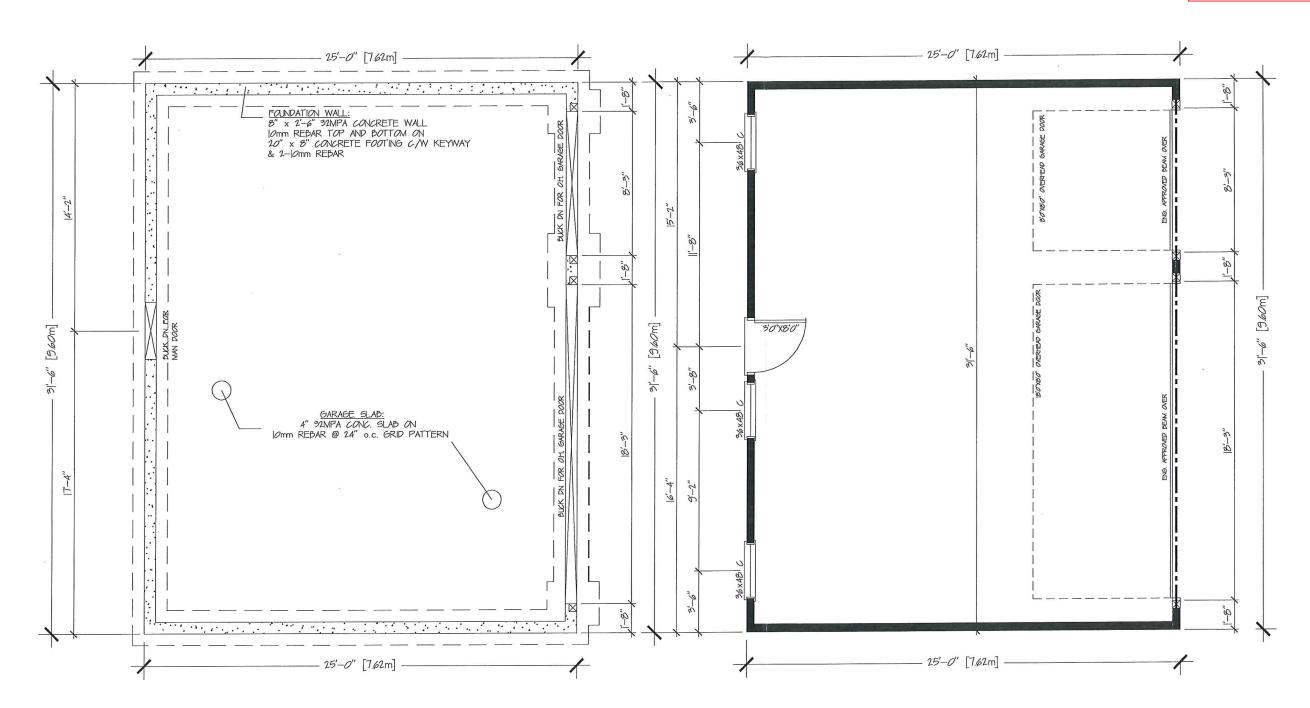

FOUNDATION PLAN

GARAGE PLAN 787. SQ. FT.

TANRYE Homes and Designs

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PROJECT TITLE

SHEET TITLE

GARAGE **PLAN** 

PROJECT No.

LOT A

STREET ADDRESS 671 STREET

3/16"=1'0"

SHEET NO.

FEB 2017

## GENERAL NOTES

- I. ALL WORK SHALL BE IN ACCORDANCE WITH THE CURRENT EDITION OF THE BC BUILDING CODE AND ALL LOCAL LAWS AND BYLAWS.
- ÞEFØRE CONSTRUCTION COMMENCES IT IS THE RESPONSIBILITY OF THE CONTRACTOR TO CHECK ALL DETAILS AND DIMENSIONS TO CONFIRM ACCURACY AND TO ASSURE THERE ARE NO DISCREPANCIES.

#### CONCRETE & FOOTINGS

ALL CONCRETE TO HAVE A MINIMUM COMPRESSIVE STRENGTH OF 2900 PSI ( $20\mathrm{mPo}$ ) AT 28 DAYS

CONCRETE FOOTING MUST BE PLACED ON UNDISTURBED OR COMPACTED SOIL TO AN ELEVATION BELOW FROST PENETRATION.

ALL FOOTINGS ARE TO HAVE TWO 10 mm REINFORCING BARS THE REINFORCING BARS ARE TO BE SITUATED SUCH THAT ONE BAR IS 3" (15mm)CLEAR OF THE SIDE AND BOTTOM OF THE FOOTING ON BOTH SIDES OF THE FOOTING.

ALL FOUNDATION WALL 24"(600mm) AND HIGHER SHOULD HAVE ONE HORIZONTAL JOmm REINFORCING BAR 3"(75mm) FROM THE TOP. CORNER REINFORCING TO BE LAPPED MINIMUM 24"(600mm)

#### CARPENTRY

FRAMING LUMBER SHALL BE NUMBER TWO OR BETTER, SPRUCE UNLESS OTHERWISE SPECIFIED ON PLAN. ALL BEAM AND LINTEL SIZES SHOWN ON THE DRAWINGS TO BE REVEIWED AND CONTRACTOR. ANY BEAMOR LINTEL SIZES PROVIDED BY TRUSS/FLOOR MANUFACTORER TAKE PRECEDENCE.

#### INSULATION / VENTILATION

MINIMUM INSULATION REQUIREMENTS :

ROOF/CEILING - R44 WALLS - 2x6 - R22

CELLING INSULATION MAY BE LOOSE FILL TYPE. WALL AND FLOOR INSULATION MUST BE BATT TYPE.

ALL ROOF SPACES SHALL BE VENTILATED WITH SOFFIT, ROOF OR GABLE VENTS OR A COMBINATION OF THESE, EQUALLY DISTRIBUTED BETWEEN THE TOP OF THE ROOF SPACE AND SOFFITS.

#### MISCELLANEOUS

CALK OVER AND AROUND ALL EXTERIOR OPENINGS SHALL BE NON-HARDING CALKING COMPOUND

FLASHING OVER ALL EXTERIOR OPENINGS

ALL SIDING TO BE MINIMUM OF 8" (200mm) ABOVE FINISHED GRADE

- A ROOF CONSTRUCTION:

  ASPHALT SHINGLES ON
  BUILDING PAPER ON
  7/16" OSD SHEATHING C/W H-CLIPS ON
  ENGINEERED TRUSSES AT 24" OC. C/W
  R44 INSULATION AND 6 MIL. POLY. V.B.
  1/2" CB GYPSUM BOARD
  PAINTED CEILINGS
- B EXTERIOR WALL CONSTRUCTION:

  CEMENT SIDING OVER
  PERMAX BUILDING PAPER ON
  3/8" OSB SHEATHING ON
  1X6 STANDARD STUDS AT 14" OC. c/W
  R20 FRICTION FIT INSULATION
  6 ML. POLY. VAPOUR BARRIER
  1/1" STANDARD SYPSUM BOARD
  PAINTED FINISH
- G) FOUNDATION CONSTRUCTION

  8" × 2'-6" CONCRETE FOOTING. REINF.

  FOOTING WITH 2-IOM HORIZONTAL
  (TYPICAL)
- M GARAGE FLOOR SLAB:

  3 1/2" CONCRETE SLAB ON
  6 MIL. POLY. VAPOUR BARRIER ON
  COMPACTED BASE
  9LOTE SLAB TOWARDS OVERHEAD DOOR
  BY 1/4" IN 12" FOR DRAINAGE.

