
KARMA GILL 9 LOT RV PARK 1160 McKENZIE ROAD KELOWNA, BC

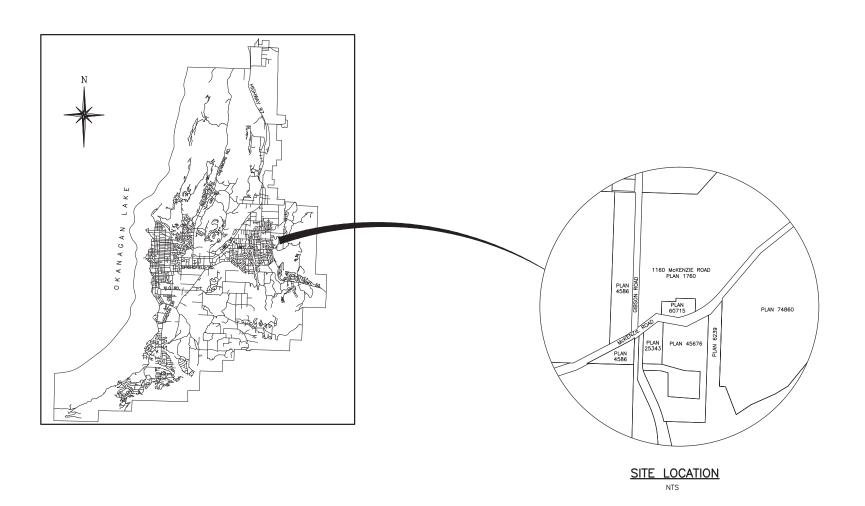



GENERAL NOTES


- CONSTRUCTION SHALL ONLY PROCEED WITH APPROVED ISSUED FOR CONSTRUCTION DRAWINGS. IT IS THE CONTRACTOR RESPONSIBILITY TO ASSURE THAT THEY ARE IN POSSESSION OF THE MOST RECENT SET OF DRAWINGS.
- THE CONTRACTOR SHALL BE RESPONSIBLE FOR LAYOUT FROM DIGITAL INFORMATION. ACCURACY FROM DIGITAL FILES IS NOT GUARANTEED. LAYOUT TO CONFORM TO DISTANCES AND OFFSETS AS SHOWN ON THE CONTRACT DRAWNIOS. CONTRACTOR TO CONFIRM THE ACCURACY OF THE LAYOUT PRIOR TO CONSTRUCTION.
- THE CONTRACTOR SHALL BE RESPONSIBLE FOR ALL NECESSARY PERMITS FOR CONSTRUCTION & ARRANGING FOR DISPOSAL OF GROUND WATER AS REQUIRED.
- THE CONTRACTOR SHALL COORDINATE ALL TESTING REQUIRED WI
- INITIAL TESTING COSTS TO BE BORN BY THE DEVELOPER WITH THE
- THE POSITION OF POLE LINES, CONDUITS, WATERMAINS, SEWERS, UNDERGROUND, ABOVEGROUND UTILITIES & STRUCTURES IS NOT NECESSARILY SHOWN ON THE CONTRACT DRAWINGS. WHERE SHOWN, THE ACCURACY OF THE POSITION OF SUCH UTILITIES AND STRUCTURES IS NOT GUARANTEED, BEFORE STARTING WORK, THE CONTRACTOR SHALL INFORM HIMSELF OF THE EXACT LOCATION OF SUCH UTILITIES AND STRUCTURES, AND SHALL ASSUME ALL LIABILITY FOR DAMAGE TO THEM.
- THE CONTRACTOR SHALL EXERCISE EXTREME CAUTION WHEN WORKING AROUND LEGAL PINS TO AVOID DISTURBANCE. IF THE CONTRACTOR IS UNABLE TO AVOID DISTURBANCE OF ANY PIN BECAUSE OF PHYSICAL CONSTRAINTS OF THE SITE, THE ENGINEER SHALL BE NOTIFIED PRIOR TO DISTURBING THE SURVEY PIN. ANY SURVEY PIN DISTURBED WITHOUT NOTIFYING THE ROINIEER, SHALL BECOME THE CONTRACTOR'S RESPONSIBILITY.
- ALL HYDRO AND COMMUNICATION INSTALLATION TO CONFORM TO INDIVIDUAL UTILITY COMPANY STANDARDS & CITY OF KELOWNA STANDARDS
- SEE UTILITY COMPANY DRAWINGS FOR DETAILED INSTALLATION PLANS. PRIOR TO STARTING SHALLOW UTILITY CONSTRUCTION THE CONTRACTOR MUST CONTRACT THE INDIVIDUAL UTILITY COMPANIES (FORTIS, TERASEN, TELUS & SHAW CABLE) TO ENSURE THEY ARE IN POSSESSION OF THE MOST RECENT DRAWINGS AND SECIFICATIONS AND ARRANGE FOR INSPECTIONS, ANY CHANGES TO THE WORK IN THE FIELD MUST BE APPROVED BY THE UTILITY COMPANIES AND RECORDED BY THE CONTRACTOR FOR AS BUILT INFORMATION.
- THE CONTRACTOR SHALL BE APPROVED BY THE CITY OF KELOWNA ENGINEERING DEPARTMENT.
- BEDDING MATERIAL AND PIPE COVER ON ALL PIPES TO BE CLEAN SAND OR 3/4" CRUSHED GRAVEL PER CITY SUPPLEMENTAL SPECIFICATIONS UNLESS OTHERWISE NOTED.
- BEDDING MATERIAL TO BE HAND TAMPED AROUND PIPES AND MACHINE TAMPED TO 95% M.P.D. FROM 300mm ABOVE PIPE TO SURFACE.
- SANITARY SEWER AND STORM SEWER MAINS TO BE VIDEO INSPECTED TO CITY OF KELOWNA STANDARDS.


- EXISTING EDGE OF PAYEMENT ELEVATIONS TO BE CONFIRMED IN THE FIELD PRIOR TO CONSTRUCTION TO ENSURE CROSSFALL OF BETWEE 1% — 3%.
- THE CONTRACTOR'S SURVEYOR SHALL PROVIDE ELEVATIONS OF TOP OF ASPHALT AT THE EDGE OF THE SAWCUT PRIOR TO POURING CURB AND GUTTER IN ORDER THAT CURB DESIGN GRADES MAY BE CHECKED BY THE ENGINEER.
- ALL CATCH BASIN GRATE ELEVATIONS TO BE SET A MIN. OF 30mm BELOW DESIGN GUTTER ELEVATION.
- WHERE PAVEMENT IS LEFT LOW FOR FUTURE OVERLAY CATCH BASIN GRATES TO BE SET 40mm BELOW DESIGN GUTTER ELEVATIONS.
- ALL SANITARY SEWER SERVICES AND ALL STORM SEWER
 CONNECTIONS TO HAVE 2X4 MARKERS AT INVERTS OF PIPES TO
 ABOVE GROUND SURFACE WITH MARKERS TO SHOW DEPTH TO
 INVEST.
- SANITARY AND STORM SEWER SERVICES TO BE INSTALLED AT 2% GRADE UNLESS OTHERWISE NOTED. RISER TYPE NOT APPROVED
- ALL WORK TO CONFORM TO THE LATEST EDITION OF M.M.C.D., CITY OF KELOWNA BYLAW #7900 AND APPLICABLE PLUMBING CODE UNLESS OTHERWISE NOTED ON DRAWING. WHERE DESCREPENCIES OCCUR THE CITY OF KELOWNA BYLAW SHALL GOVERN.
- STORM SEWER TO BE ULTRA RIB PVC (PERFORATED WHERE SHOWN)
- ALL STORM SEWER CATCH BASIN LEADS TO BE 200mm DIAMETER SDR 35 PVC.
- THE CONTRACTOR AND CONSULTANT ARE TO COMPLETE ALL TIE-INS AND DISCONNECTS FOR BMID WATER, CITY SEWER AND DRAINAGE SYSTEMS IN THE PRESENCE OF CITY/BMID PERSONNEL. THE CONTRACTOR IS TO COORDINATE THIS WITH THE UTILITY CONSTRUCTION SERVICE PERSON (250-470-0490) AT LEAST TWO (2) FULL WORKING DAYS PRIOR TO SCHEDULING, FOR WATER TIE-INS, PRIOR APPROVAL IS REQUIRED FROM BMID. PRIOR TO SCHEDULING, THE CONTRACTOR MUST OBTAIN A ROAD USAGE PERMIT AND A THIRD PARTY WORK ORDER FROM THE CITY YARD OFFICE.
- ALL NEW MANHOLES AND DRAINAGE DRYWELLS TO COME WITH FRAME AND COVER MEETING CITY OF KELOWNA STANDARD SS-S1b & CSA STANDARD A2754-M92. CONCRETE TOP TO HAVE 762mm OFDINIG, STELL FRAME TO HAVE 610mm OFDINIG ALL EXISTING MANHOLES AND DRAINAGE DRYWELLS ENCOUNTERED DURING THE COURSE OF CONSTRUCTION TO HAVE THE CONCRET TOP, AND THE STELL FRAME & COVER UPGRADED TO THAT STANDARD.
- ALL MANHOLE FRAMES AND COVERS INSTALLED IN HARD SURFACE APPLICATIONS TO BE ADJUSTABLE (TERMINAL CITY C44A OR EQUIVALENT).


DRAWING LIST		
DRAWING NO. DRAWING DESCRIPTION		
17002-00	COMPOSITE UTILITY PLAN	
17002-01	SITE GRADING PLAN	
17002-02	PLAN/PROFILE DRAWING	
17002-03	2-03 STORM WATER MANAGEMENT PLAN	
17002-04	TURNING MOVEMENTS	

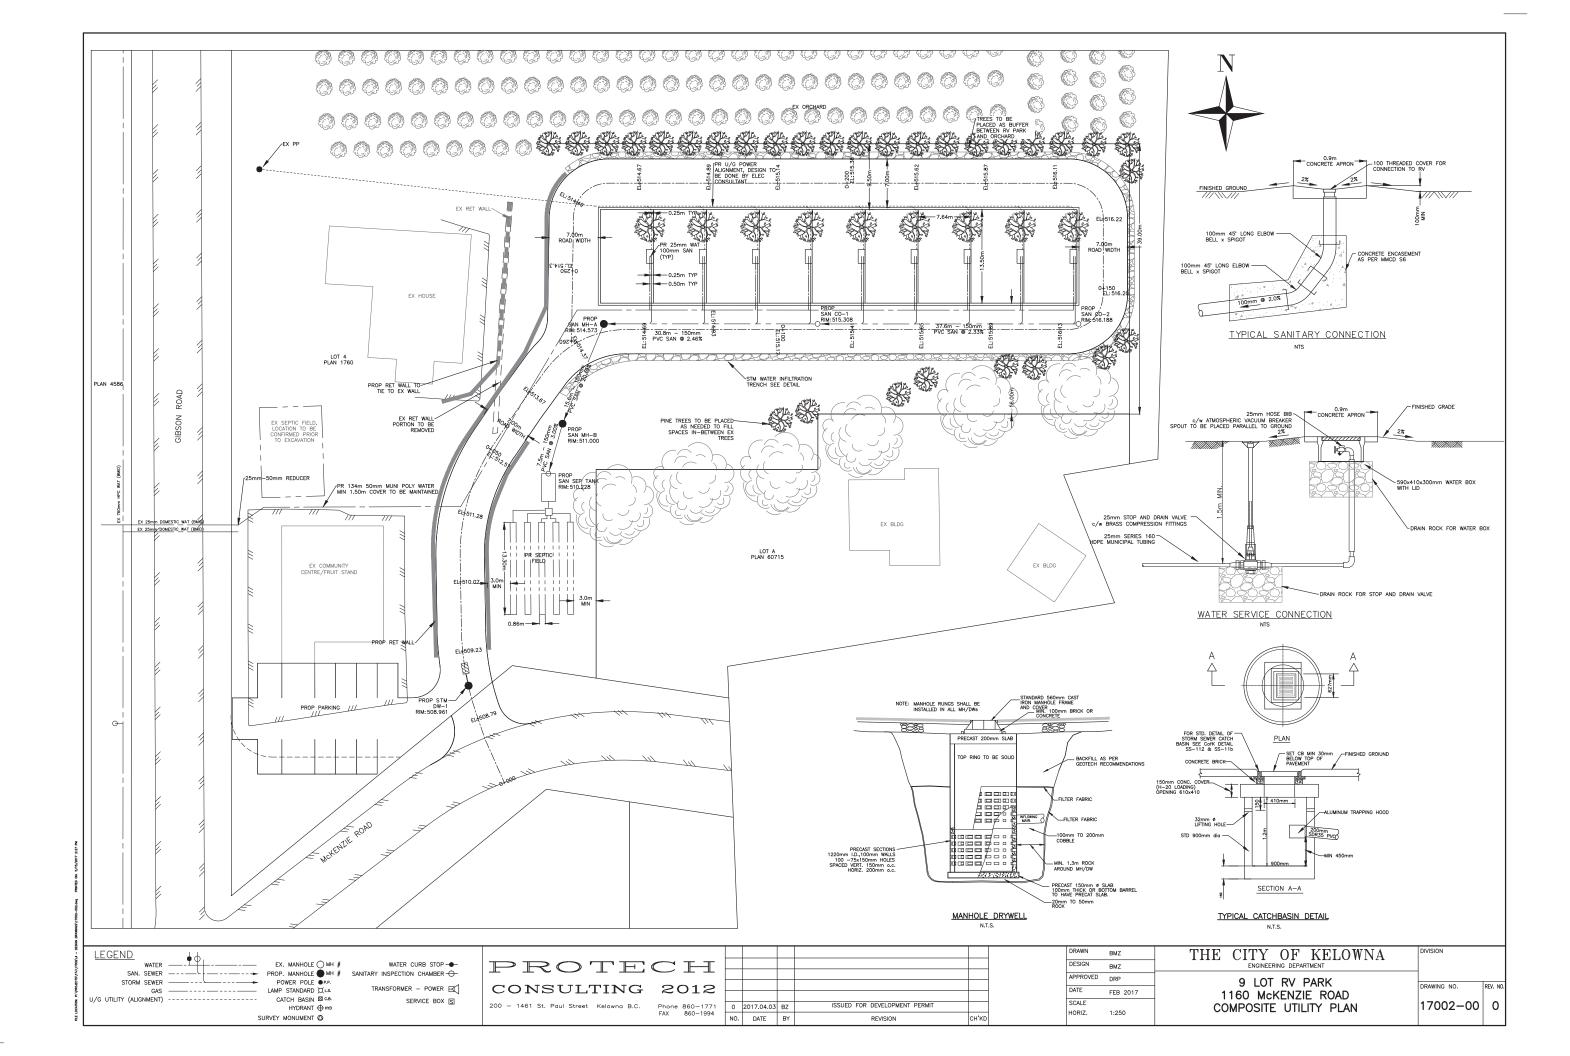


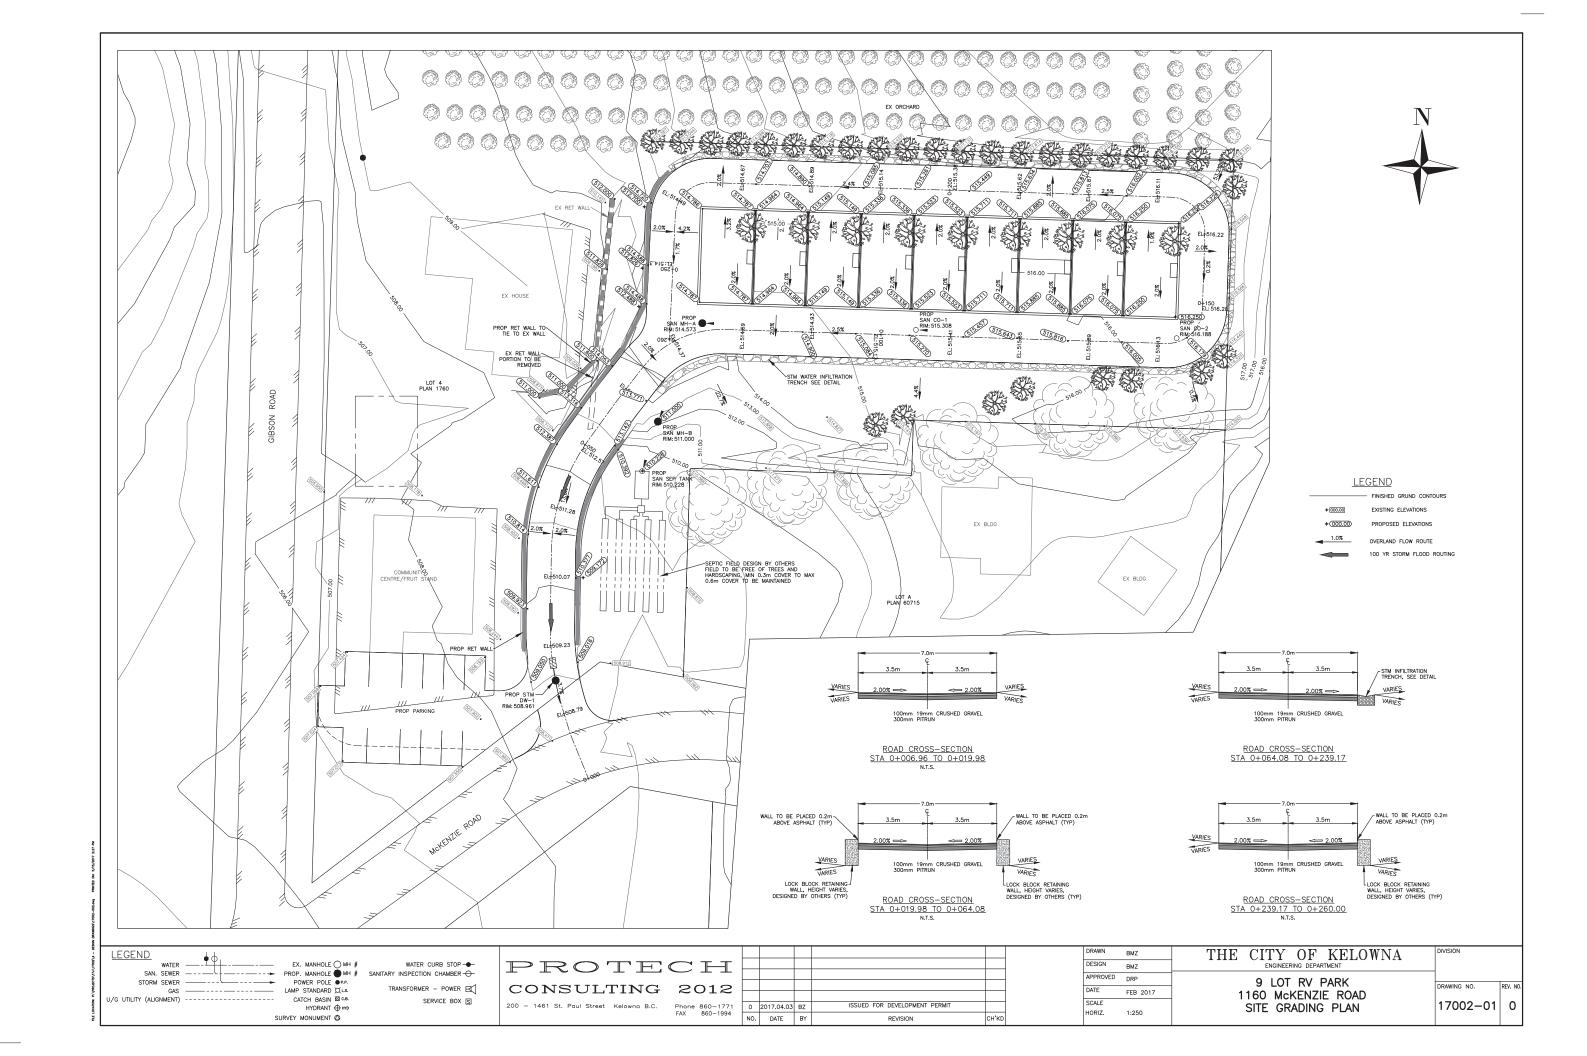


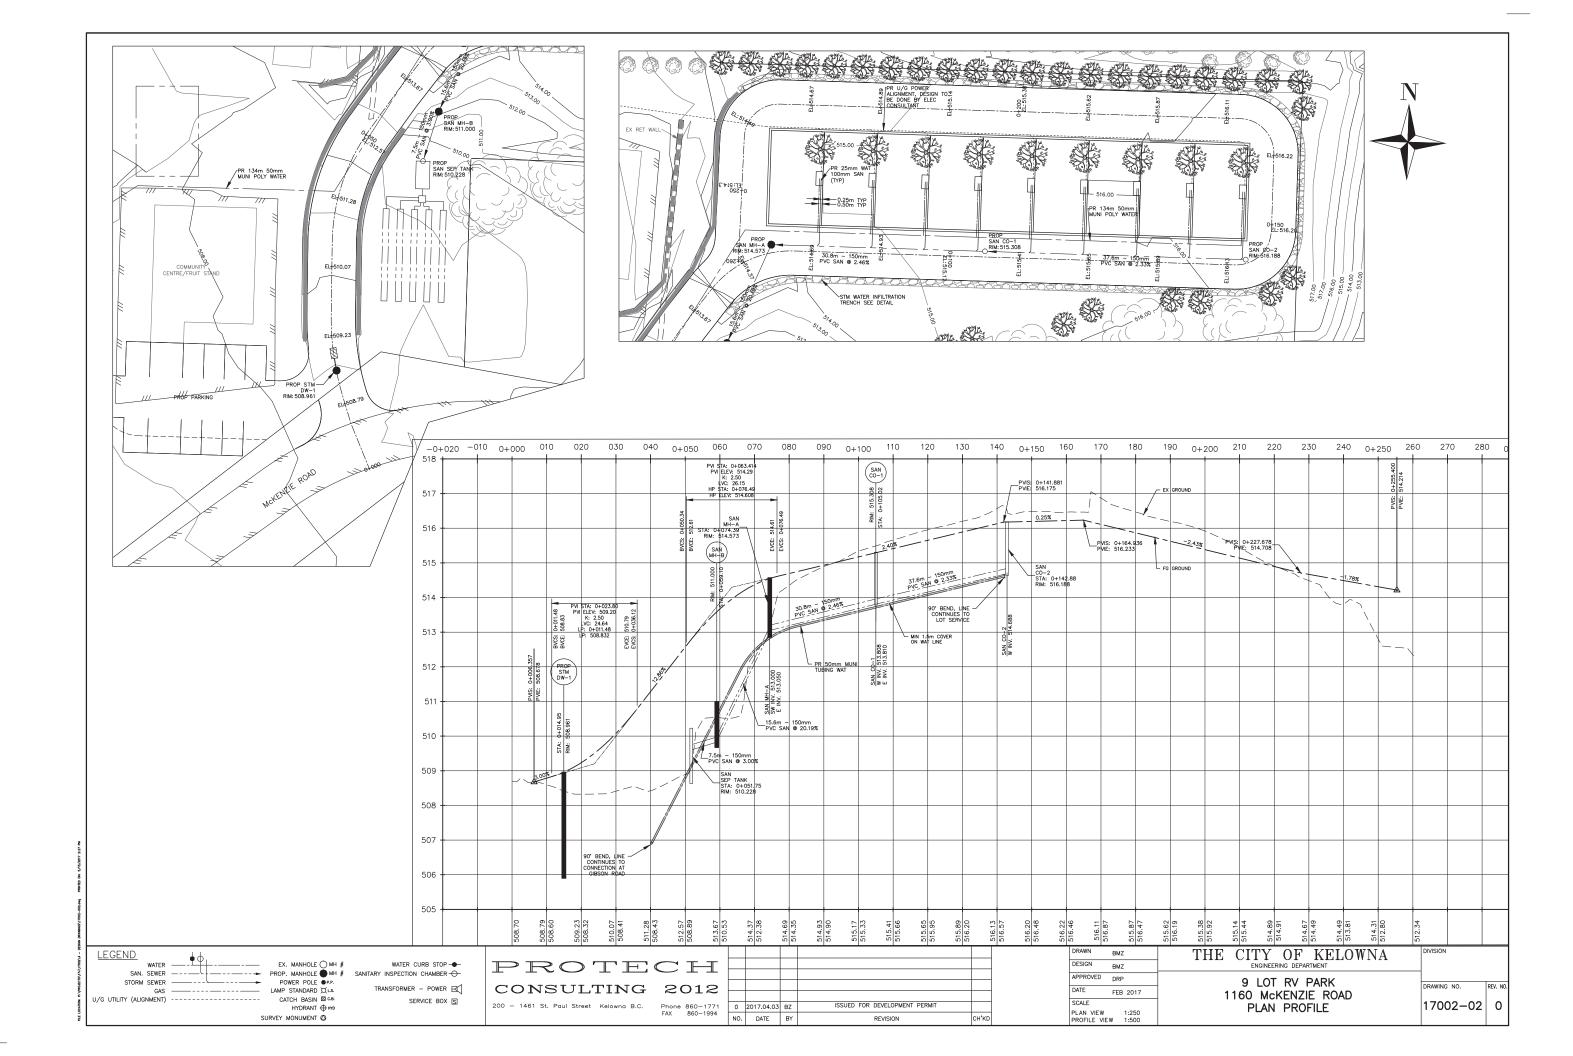

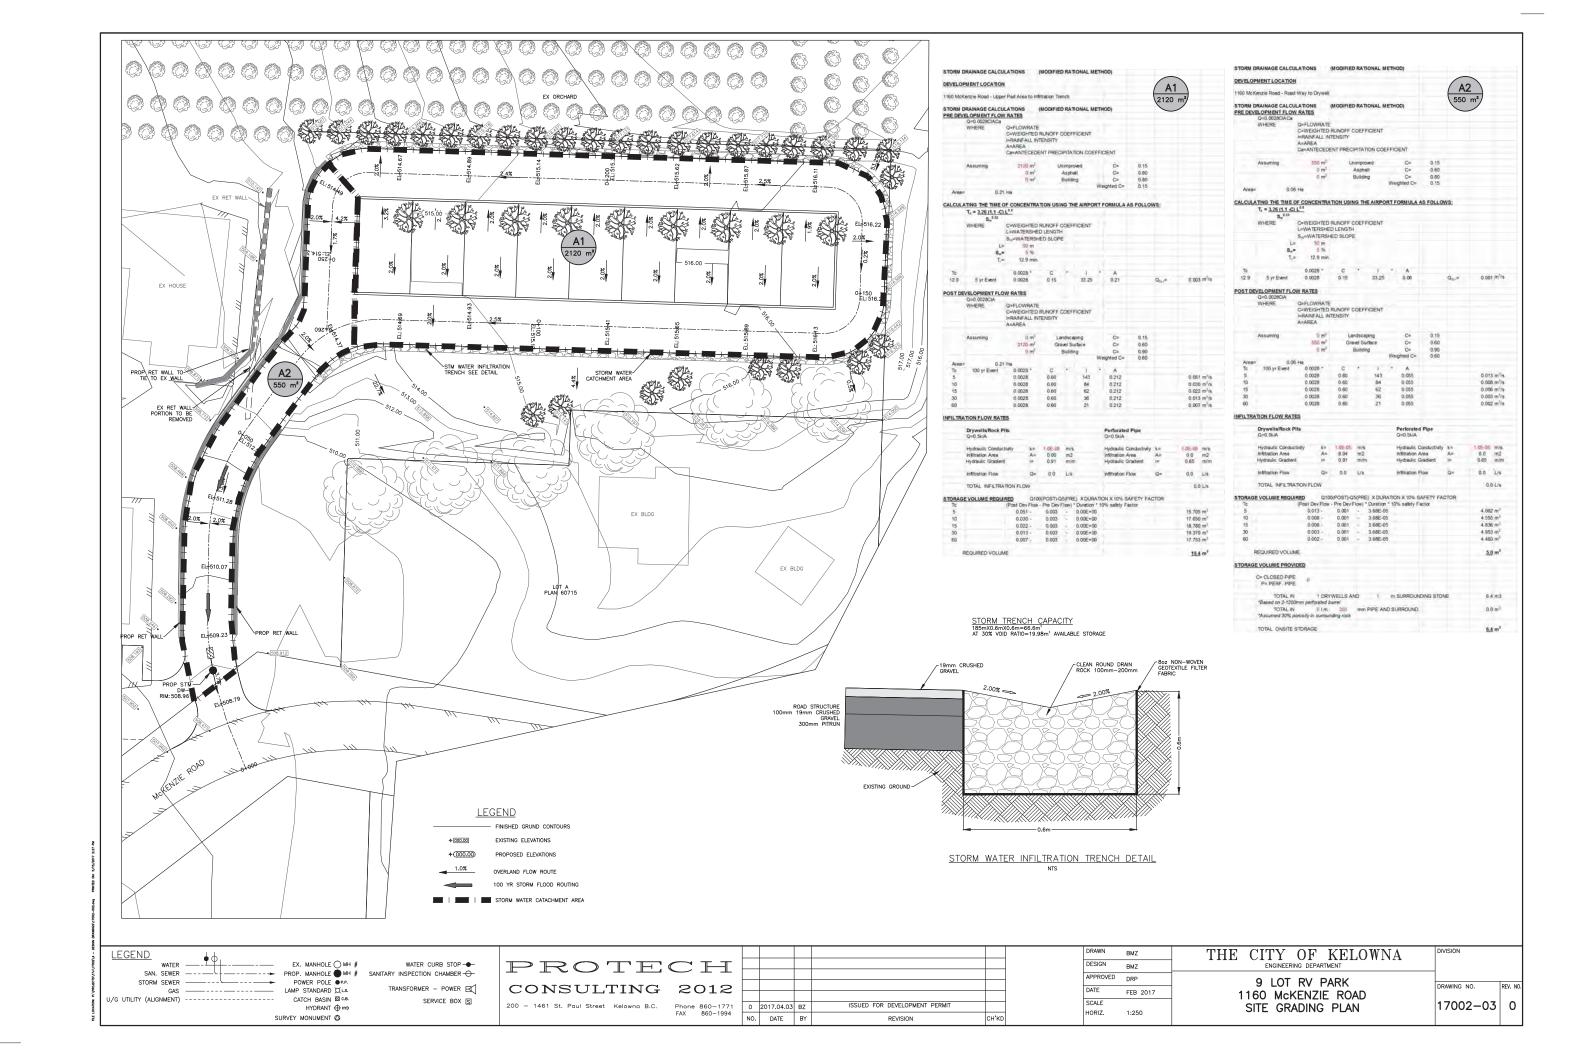

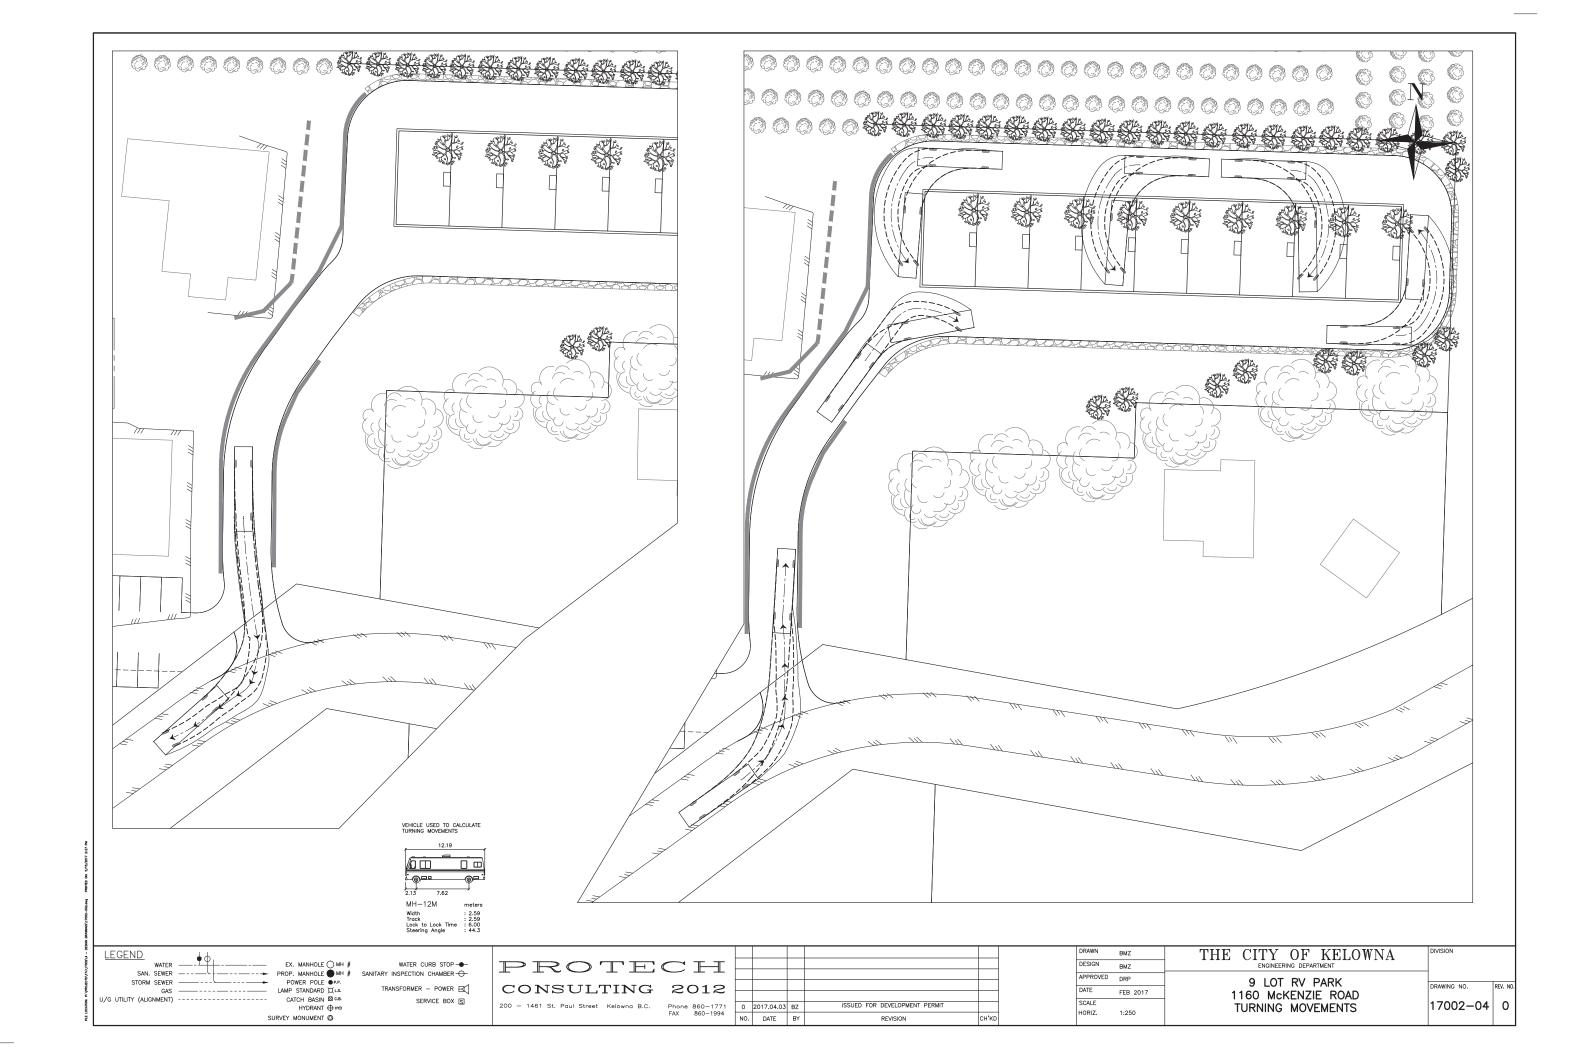

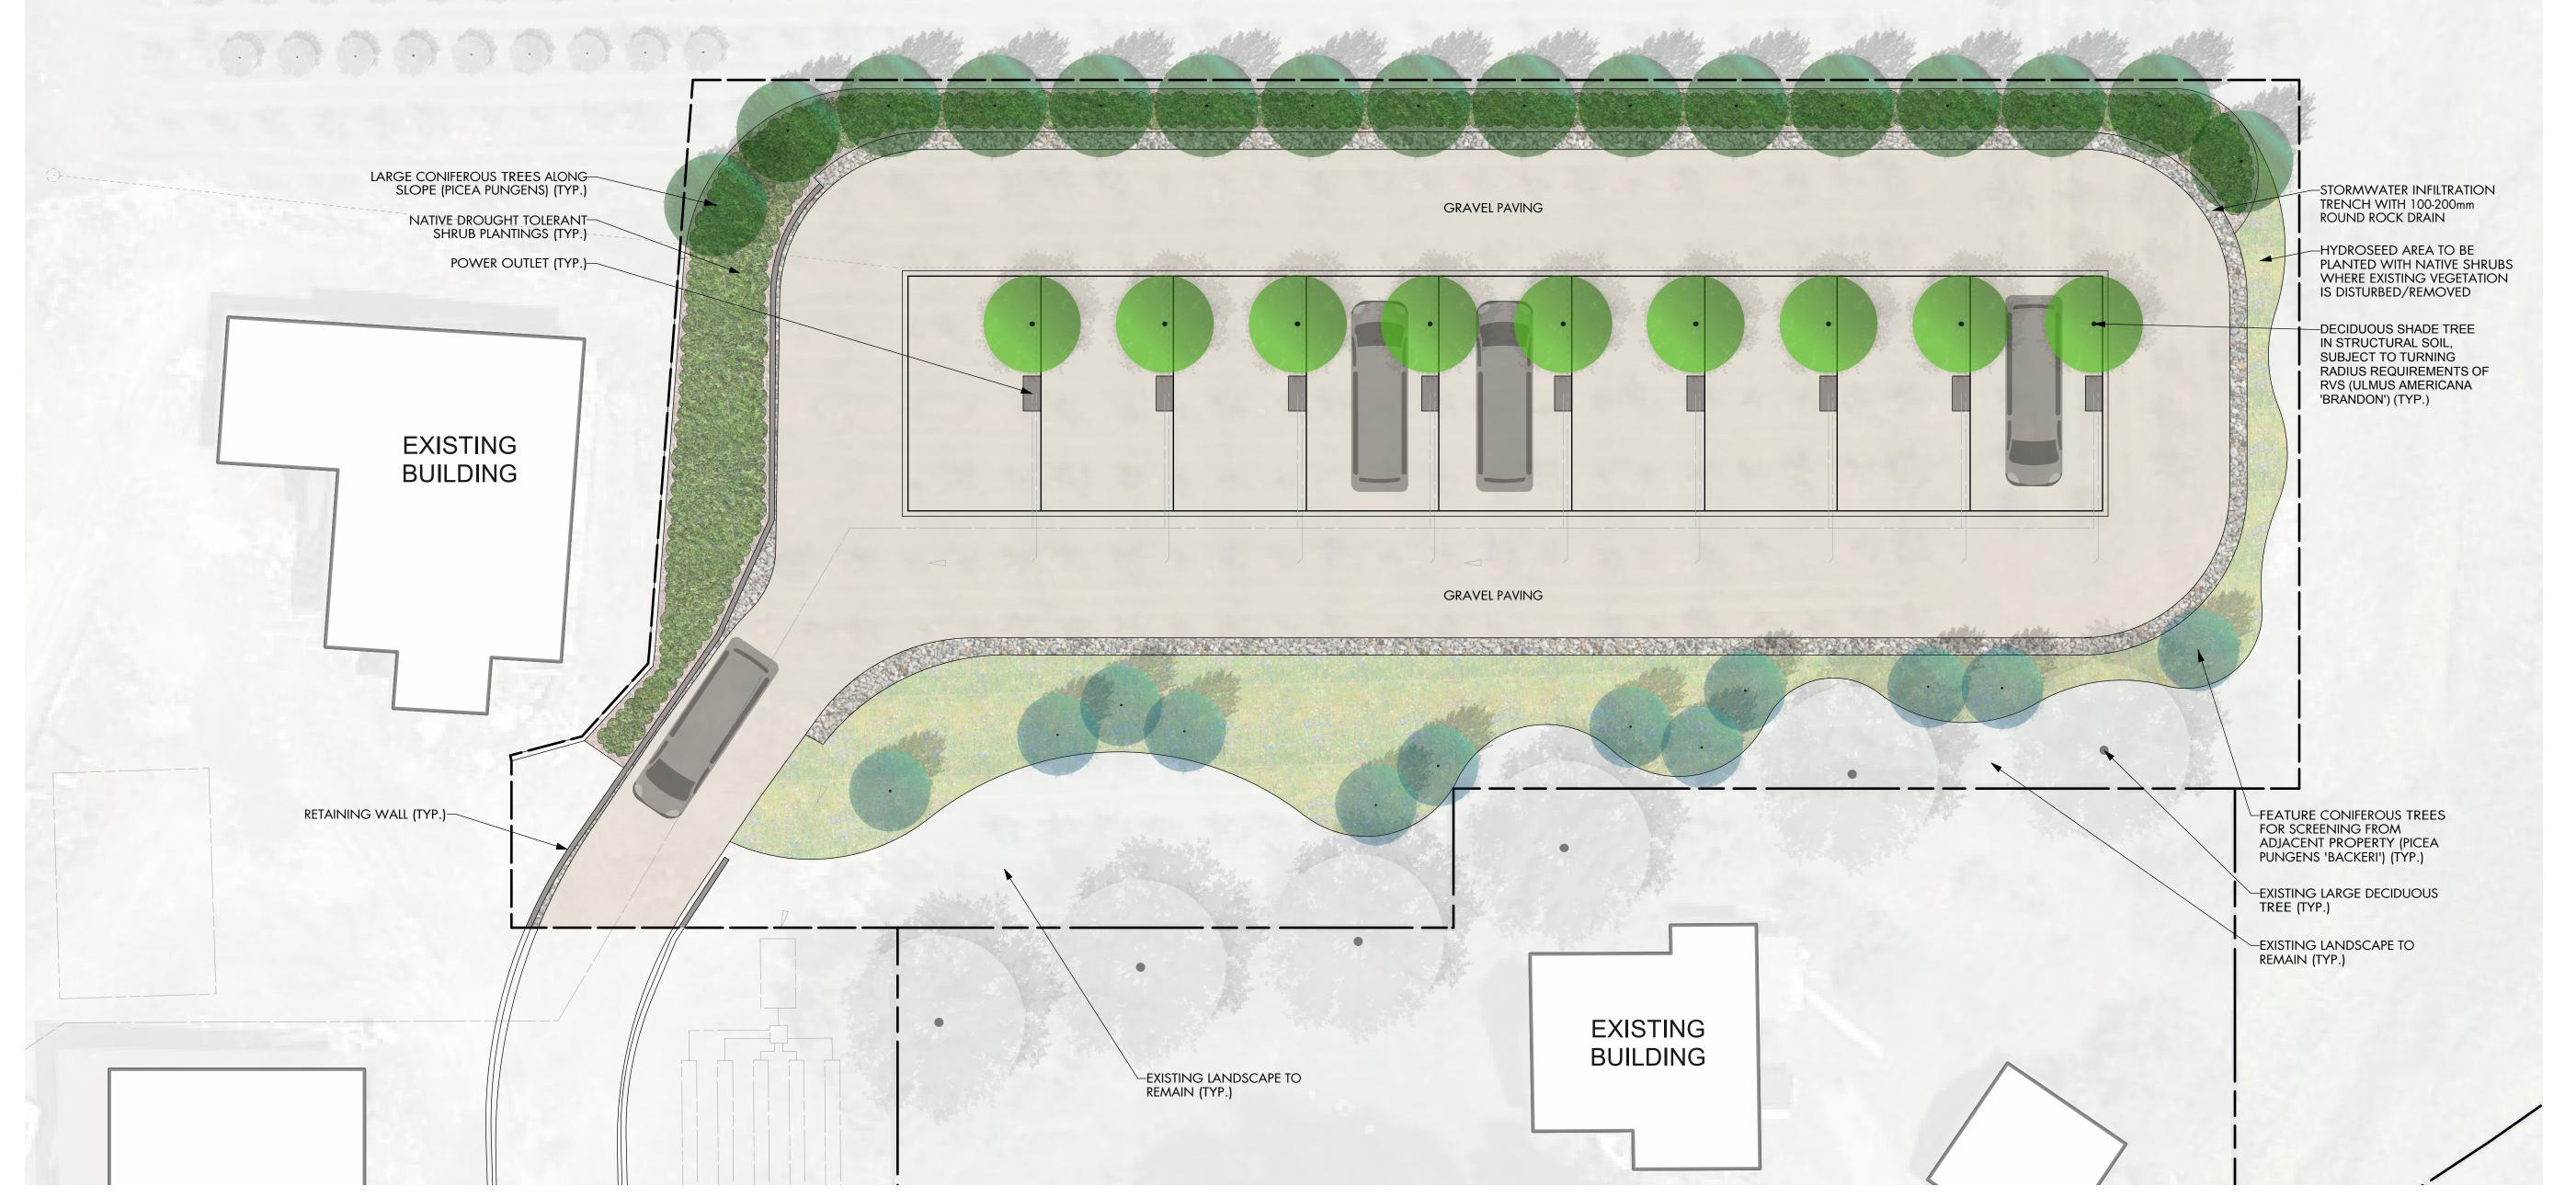

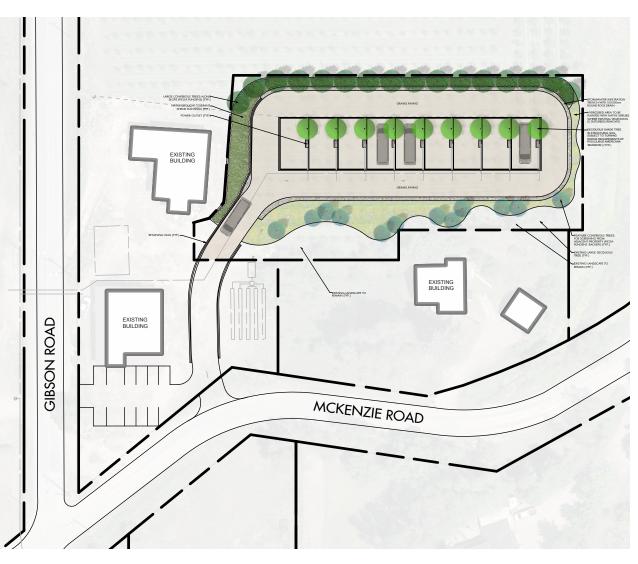

3. TREE AND SHRUB BEDS TO BE DRESSED IN A MINIMUM 50mm DOUGLAS RED FIR MULCH OR ROCK MULCH, AS SHOWN IN PLANS. DO NOT PLACE WEED MAT UNDERNEATH TREE AND SHRUB BEDS. 4. TREE AND SHRUB BEDS TO RECEIVE A MINIMUM 300mm DEPTH TOPSOIL PLACEMENT. 5. SEDIMENT AND EROSION CONTROL MEASURES, SUCH AS SILT FENCING. AM IST DE INISTALLED ALONG THE EAST HART OF WORK.

NOTES

OR EXCEED B.C.L.N.A. STANDARDS.

5. SEDIMENT AND EROSION CONTROL MEASURES, SUCH AS SILT FENCING, MUST BE INSTALLED ALONG THE EAST LIMIT OF WORK TO PREVENT FINE SEDIMENTS AND SUBSTANCES THROUGHOUT CONSTRUCTION FROM BEING RELEASED INTO SENSITIVE ENVIRONMENTS. THIS FENCING MUST REMAIN IN PLACE UNTIL DISTURBED AREAS HAVE BEEN RESTORED/REMEDIATED WITH SEEDING AND PLANTING.

1. PLANT MATERIAL AND CONSTRUCTION METHODS SHALL MEET

2. ALL SOFT LANDSCAPE AREAS SHALL BE WATERED BY A FULLY

AUTOMATIC TIMED UNDERGROUND IRRIGATION SYSTEM.

6. DRYLAND SEED AREAS DRYLAND SEED MIXTURE BLUE BUNCH WHEATGRASS ROUGH FESCUE IDAHO FESCUE PERENNIAL RYEGRASS SANDBERG BLUEGRASS JUNEGRASS	BY WEIGHT 41% 25% 15% 10% 5% 4%	BY SPECIES 23% 20% 19% 7% 13% 18%	
WILDFLOWER SEED MIXTURE SILKY LUPINE BALSAM ROOT BROWN EYED SUSAN COMMON YARROW	BY WEIGHT 30% 30% 35% 5%		

APPLICATION RATE:

SEED WILDFLOWER SEED MIXTURE 1 KG/HECTARE
DRYLAND SEED MIXTURE 125 KG/HECTARE
FERTILIZER 18-18-18-2, 50% SULPHUR COATED UREA 400 KG/HECTARE
MULCH CANFOR ECOFIBRE PLUS TAC 2,800 KG/HECTARE
TACKIFIER GUAR 3% OF MIX

THE PRECEDING SEED MIXTURE IS TO BE APPLIED TO THE DRYLAND SEED AREAS SHOWN ON THE DRAWINGS. SEED MIX TO BE CERTIFIED #1 GRADE BY AGRICULTURE CANADA. REFER MANUFACTURER'S SPECIFICATIONS FOR PRODUCT DELIVERY, STORAGE & PROTECTION.

PL	AN ⁻	T LI	ST
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BOTANICAL NAME	COMMON NAME	QTY	SIZE/SPACING & REMARKS
PICEA PUNGENS	COLORADO SPRUCE	16	2.0m HT.
PICEA PUNGENS 'BACKERI'	BAKERI SPRUCE	12	1.5m HT.
ULMUS AMERICANA 'BRANDON'	BRANDON ELM	9	6cm CAL.
SHRUBS			
CHRYSOTHAMNUS NAUSEOSUS	RABBIT BUSH	18	#01 CONT. /1.8M O.C. SPACING
CORNUS SERICEA	RED OSIER DOGWOOD	7	#01 CONT. /3.0M O.C. SPACING
MAHONIA AQUIFOLIUM	OREGON GRAPE HOLLY	18	#01 CONT. /1.5M O.C. SPACING
RIBES ALPINUM	ALPINE CURRANT	18	#01 CONT. /1.8M O.C. SPACING
ROSA WOODSII	WOOD'S ROSE	19	#01 CONT. /1.5M O.C. SPACING
SYMPHORICARPOS ALBUS	SNOWBERRY	18	#01 CONT. /1.5M O.C. SPACING
21WILHORICAKLO2 ATRO2	2IJO AAREKKA	18	#UT COINT. / T.OM O.C. SPACING



206 - 1889 Spall Road Kelowna, BC V1Y 4R2 T (250) 868-9270 www.outlanddesign.ca



PROJECT TITLE

1160 MCKENZIE ROAD RV PARK

Kelowna, BC

DRAWING TITLE

CONCEPTUAL LANDSCAPE PLAN

ISSUED FOR/REVISION		
1	17.05.15	Review
2		
3		
4		
5		

PROJECT NO	17-057
DESIGN BY	KG
DRAWN BY	KG
CHECKED BY	FB
DATE	MAY 15, 2017
SCALE	1:200

SEA



DRAWING NUMBER

L1/1

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KEY MAP SCALE: 1:5000











