

DEVELOPMENT PERMIT PRINTED LK DEVELOPMENT VARIANCE PERMIT

APPROVED ISSUANCE OF DEVELOPMENT PERMIT / DEVELOPMENT VARIANCE PERMIT NO. DP16-0297/DVP16-0298

Issued To: Suntec Holdings Corporation Inc. No. BC0995201

Site Address: 225 Rutland Road S

Legal Description: Lot A Section 23 Township 26 ODYD Plan KAP84050

Zoning Classification: C4 – Urban Centre Commercial

Development Permit Area: Revitalization

SCOPE OF APPROVAL

This Permit applies to and only to those lands within the Municipality as described above, and any and all buildings, structures and other development thereon.

This Permit is issued subject to compliance with all of the Bylaws of the Municipality applicable thereto, except as specifically varied or supplemented by this Permit, noted in the Terms and Conditions below.

The issuance of a Permit limits the Permit Holder to be in strict compliance with regulations of the Zoning Bylaw and all other Bylaws unless specific Variances have been authorized by the Permit. No implied Variances from bylaw provisions shall be granted by virtue of drawing notations that are inconsistent with bylaw provisions and that may not have been identified as required Variances by the applicant or Municipal staff.

1. TERMS AND CONDITIONS

THAT Development Permit No. DP16-0297 for Lot A Section 23 Township 26 ODYD Plan KAP84050, located at 225 Rutland Rd S, Kelowna, BC to allow the construction of a multiple dwelling housing be approved subject to the following:

- a) The dimensions and siting of the building to be constructed on the land be in accordance with Schedule "A";
- b) The exterior design and finish of the building to be constructed on the land be in accordance with Schedule "B";
- c) Landscaping to be provided on the land be in accordance with Schedule "C

d) The applicant be required to post with the City a Landscape Performance Security deposit in the form of a "Letter of Credit" in the amount of 125% of the estimated value of the landscaping, as determined by a Registered Landscape Architect;

AND THAT Council authorizes the issuance of Development Variance Permit No. DVP16-0298 for Lot A Section 23 Township 26 ODYD Plan KAP84050, located at 225 Rutland Rd S, Kelowna, BC;

AND THAT variances to the following sections of Zoning Bylaw No. 8000 be granted, as shown on Schedule "A":

Section 14.4.5(f): C4 - Urban Centre Commercial Development Regulations

To vary the required minimum side yard from 4.5 m permitted to 2.0 m proposed.

AND FURTHER THAT this Development Permit & Development Variance Permit is valid for two (2) years from the date of Council approval, with no opportunity to extend.

2. PERFORMANCE SECURITY

As a condition of the issuance of this Permit, Council is holding the security set out below to ensure that development is carried out in accordance with the terms and conditions of this Permit. Should any interest be earned upon the security, it shall accrue to the Permit Holder and be paid to the Permit Holder if the security is returned. The condition of the posting of the security is that should the Permit Holder fail to carry out the development hereby authorized, according to the terms and conditions of this Permit within the time provided, the Municipality may use the security to carry out the work by its servants, agents or contractors, and any surplus shall be paid over to the Permit Holder, or should the Permit Holder carry out the development permitted by this Permit within the time set out above, the security shall be returned to the Permit Holder. There is filed accordingly:

a)	Cash in the amount of \$OR		
b)	A Certified Cheque in the amount of \$	OR	
c)	An Irrevocable Letter of Credit in the amount of \$_		

Before any bond or security required under this Permit is reduced or released, the Developer will provide the City with a statutory declaration certifying that all labour, material, workers' compensation and other taxes and costs have been paid.

3. DEVELOPMENT

The land described herein shall be developed strictly in accordance with the terms and conditions and provisions of this Permit and any plans and specifications attached to this Permit that shall form a part hereof.

If the Permit Holder does not commence the development permitted by this Permit within two years of the date of this Permit, this Permit shall lapse.

This Permit IS NOT a Building Permit.

4. APPLICANT'S AGREEMENT

I hereby declare that all of the above statements and the information contained in the material submitted in support of this Permit are to the best of my belief, true and correct in all respects. Upon issuance of the Permit for me by the Municipality, then in such case, I covenant and agree to save harmless and effectually indemnify the Municipality against:

a) All actions and proceedings, costs, damages, expenses, claims, and demands whatsoever and by whomsoever brought, by reason of the Municipality granting to me the said Permit.

b) All costs, expenses, claims that may be incurred by the Municipality if the construction by me of engineering or other types of works as called for by the Permit results in damages to any property owned in whole or in part by the Municipality or which the Municipality by duty or custom is obliged, directly or indirectly in any way or to any degree, to construct, repair, or maintain.

I further covenant and agree that should I be granted a Development Permit and/or Development Variance Permit, the Municipality may withhold the granting of any Occupancy Permit for the occupancy and / or use of any building or part thereof constructed upon the hereinbefore referred to land until all of the engineering works or other works called for by the Permit have been completed to the satisfaction of the Municipal Engineer and Divisional Director of Community Planning & Real Estate.

Should there be any change in ownership or legal description of the property, I undertake to notify the Community Planning Department immediately to avoid any unnecessary delay in processing the application.

5. APPROVALS		
Issued and approved by Council on the day of	, 2017.	
Ryan Smith, Community Planning Department Manager Community Planning & Real Estate	Date	

The PERMIT HOLDER is the <u>CURRENT LAND OWNER</u>. Security shall be returned to the PERMIT HOLDER.

This forms part of application

DP16-0297 DVP16-0298

Planner Initials Li



B

CITY OF KELOWNA

MEMORANDUM

Date:

January 31, 2017

File No.:

DP16-0297

To:

Urban Planning Management (LK)

From:

Development Engineering Manager (SM)

Subject:

225 Rutland Road - Lot A, PLAN 84050

The Development Engineering Services comments and requirements regarding this Development Permit application for the construction of a 4 storey mixed use building with ground level commercial and 3 storeys of student housing residences mixed use development are as follows:

1. Subdivision

Provide easements as may be required.

2. Geotechnical Study.

A comprehensive Geotechnical Study is required, which is to be prepared by a Professional Engineer competent in the field of geotechnical engineering, the study is to address the following:

- Overall site suitability for development.
- Presence of ground water and/or springs.
- Presence of fill areas.
- Presence of swelling clays.
- Presence of sulphates.
- Potential site erosion.
- Provide specific requirements for footings and foundation construction.
- Provide specific construction design sections for roads and utilities over and above the City's current construction standards

Domestic water and fire protection.

a) This development is within the service area of the Rutland Waterworks District (RWD). The developer is required to make satisfactory arrangements with the RWD

b) Robson Road

The applicant is responsible to upgrade Robson Road to a paved urban collector standard (SS-R5). The construction consists of curb, gutter and sidewalk, fillet paving, storm drainage works, removal and/or relocation of utilities as may be required, etc. Provide an estimate for the cost of this work for bonding purposes.

8. Street lights.

Street lights must be installed on all fronting roads as determined by the Manager of Electrical Utilities. See attached standard for poles and LED lights.

9. <u>Design and Construction</u>.

- a) Design, construction supervision and inspection of all off-site civil works and site servicing must be performed by a Consulting Civil Engineer and all such work is subject to the approval of the City Engineer. Drawings must conform to City standards and requirements.
- b) Engineering drawing submissions are to be in accordance with the City's "Engineering Drawing Submission Requirements" Policy. Please note the number of sets and drawings required for submissions.
- c) Quality Control and Assurance Plans must be provided in accordance with the Subdivision, Development & Servicing Bylaw No. 7900 (refer to Part 5 and Schedule 3).
- d) A "Consulting Engineering Confirmation Letter" (City document 'C') must be completed prior to submission of any designs.
- e) Before any construction related to the requirements of this subdivision application commences, design drawings prepared by a professional engineer must be submitted to the City's Development Engineering Branch. The design drawings must first be "Issued for Construction" by the City Engineer. On examination of design drawings, it may be determined that rights-of-way are required for current or future needs.

10. Servicing Agreement for Works and Services.

a) A Servicing Agreement is required for all offsite works and services on City lands in accordance with the Subdivision, Development & Servicing Bylaw No. 7900. The applicant's Engineer, prior to preparation of Servicing Agreements, must provide adequate drawings and estimates for the required works. The Servicing Agreement must be in the form as described in Schedule 2 of the bylaw. b) Part 3, "Security for Works and Services", of the Bylaw, describes the Bonding and Insurance requirements of the Owner. The liability limit is not to be less than \$5,000,000 and the City is to be named on the insurance policy as an additional insured.

11. Access.

The access to the proposed development meets the City of Kelowna transportation network plan objectives with regard to the distance to the intersection.

12. DCC Credits.

None of the required improvements qualify for DCC credit consideration, as these upgradings are not identified in the current DCC schedules.

13. Bonding and Levies Summary.

- a) Performance Bonding will be secured based on 130% of the construction estimate provided by the applicant's civil engineering consultant.
- b) Administration and Inspection fee (3.5 % of construction costs).



ROBSON MEWS COMMERCIAL / STUDENT HOUSING DEVELOPMENT















- PROJECT LOCATION

- ROBSON RD. E





SITE CONTEXT - VIEW 2

SITE CONTEXT - VIEW 4



SITE CONTEXT - VIEW 3

SITE LOCATION NOT TO SCALE

ZONING SUMMARY

ZONING	C4	URBAN CEN	ITRE (COMMERCIAL
	MINIMUM	ACTUAL		
MINIMUM LOT WIDTH	13 m	51.43	3 m	
MINIMUM LOT DEPTH	30 m	35.68		
MINIMUM LOT AREA	460 sm	1767		
minimo m 2017 inc271	100 3111	1701	3111	
TOTAL GROSS FLOOR AREAS				
MAIN FLOOR		551.64	1 sm	
STUDENT RESIDENTIAL		2606.73	3 sm	
	TOTAL	3158.3	7 sm	_
BUILDING AREAS FOR F.A.R. CALCL	JLATIONS			
COMMERICAL		455.2	1 sm	
STUDENT HOUSING		2075.39	9 sm	
TOTAL		2530.6		_
BUILING COVERAGE AREA				
BUILDING AREA	11994.80 SF	1114.32	2 SM	
	MAXIMUM	ACTUAL		CALCULATED FAR BONUS: (22/31)x .2=1.442
FLOOR AREA RATIO (FAR)	1.300			1.442x1767= 2548 = 27,425 SF
MIXED-USE INCREASE	0.142			
TOTAL	1.442	1.432		.2 BONUS FOR ALL STALLS COVERED
CITE COVERA CE	LAAVILALILA	ACTIIAI		
SITE COVERAGE	MAXIMUM	ACTUAL		(444.4.7.0.147.0.7.)
BUILDING AREA/SITE AREA	75%	63.06%		(1114.32/1767)
SETBACKS	MINIMUM	ACTUAL		
FRONT (RUTLAND)	O m	0	m	RUTLAND ROAD
REAR YARD	6 m	2	m	*VARAINCE REQUIRED
FLANKING SIDE STREET	От	1.3	m	ROBSON ROAD
SIDE	От	0	m	ABUTTING COMMERCIAL
	MAXIMUM	ACTUAL		
BUILDING HEIGHT	4 stories/15m	4 stories/15	im Ma	ях.
ADDITIONAL REGULATIONS				
MINIMUM AREAS OF PRIVAT	E OPEN SPACE			
			-	dana
6 sq m / bachelor dwelling, 10 sa m / 1 bdrm dwellina	Cong. Housing bdr	m or group no	orrie d	arm
6 sq m / bachelor dwelling, 10 sq m / 1 bdrm dwelling 15 sq m / dwelling with +1 b,		m or group no	orrie d	ит

 315 sm
 3390.63 SF

 10 sm
 107.639 SF

 325 sm
 3498.27 SF
 366.788 sm

PROJECT ADDRESS

CIVIC ADDRESS: 205 - 225 RUTLAND ROAD SOUTH LEGAL DESCRIPTION: LOT 6 AND LOT 7, PLAN 10372, SECTION 22, TWP. 26

PARKING/LOADING SUMMARY

		GF	·A	(3LA			PARI	KING CAL	CULA1	10NS	STA	LLS
	-	Sq. Ft.	Sq. m	Sq. Ft.	Sq. m							Required	Provided
MMERCIAL - MAIN FLO	OR					l							
MMERCIAL BUILDING	I AREA SUM	IMARY											
Main Floor		4900	455.21										
TOTAL		4900	455.21			GFA	@	1.75	STALLS	per	100 sm =	8.0	9
Loading													
Commercial		4900	455.21			GFA	@	1	STALL		1900 sm =	0.2	
TOTAL		4900	455.21						TOTAL L	OADIN	IG	0.2	1
Bikes													
Class 1						GFA	@		STALLS		100 sm =	0.9	1
Class 2						GFA	@	0.6	STALLS	per	100 sm =	2.7	3
ARTMENT HOUSING													
JDENT HOUSING AREA SI	JMMARY- 4 ST												
Main Floor		0	0										
2nd net STUDENT SI		7399.9	687.45	7	SUITES		@	1	STALL	PER	SUITE	7.0	
COMMON/CI		1262.4	117.28	-	011175					n=n	0.115		
3rd net STUDENT SI		7399.9	687.45	7	SUITES		@	1	I STALL	PER	SUITE	7.0	
COMMON/CI		1262.4 7540.2	117.28	0	CUITEC		<i>a</i>	,	I CTALL	nn	CUITE	0.0	
4th STUDENT SI COMMON/CI		7540.2 1298.5	700.48 120.63	8	SUITES		@		I STALL	PEK	SUITE	8.0	
AREA - GROSS	TOTAL	26163	2430.6									22.0	22
AREA - NET (FOR FAR)		22340	2075.4										
				*REQUIRE 1	PER 7 PARKIN	IG STAL	LS TO	O BE I	OR VISIT	OR PA	RKING		
				CALCULATIO	N: 30 /7 = 5	VISITO	IR ST	ALLS.					
									L STALLS			30.0	
								TOTAI	L STALLS	PROV	DED		30
Loading			N/A										
Bikes													
Class 1						GFA	@	0.5	Stalls	per	100 sm =	12.2	
Class 2						GFA	@	0.1	Stalls	per	100 sm =	2.4	
							1				ALLS REQUIRED	13.1	14
							T01	AL CL	ASS 2 BI	KE ST	ALLS REQUIRED	5.2	6


UNIT AND COMMON AREA SUMMARY

408 EA	1115.2 SF 7540.2 SF 1298.5 SF 517.8 SF 9356.5 SF 22340 SF 4900 27240	103.6 sm 700.5 sm 120.6 sm 48.1 sm 869.2 sm 2075.4 sm 455.2 sm	UNIT AREA GROSS LEASEABLE
408	7540.2 SF 1298.5 SF 517.8 SF 9356.5 SF 22340 SF	700.5 sm 120.6 sm 48.1 sm 869.2 sm 2075.4 sm	
408	7540.2 SF 1298.5 SF 517.8 SF 9356.5 SF	700.5 sm 120.6 sm 48.1 sm 869.2 sm	LINIT APEA
	7540.2 SF 1298.5 SF 517.8 SF	700.5 sm 120.6 sm 48.1 sm	
	7540.2 SF 1298.5 SF	700.5 sm 120.6 sm	
	7540.2 SF	700.5 sm	
	7540.2 SF	700.5 sm	
	1115.2 SF	103.6 sm	
-11.77		0.10 0111	
	1053.6 SF	97.9 sm	
401	1027165	Q5 1 cm	
	9351.5 SF	868.8 sm	
	689.2 SF	64.0 sm	
	1262.4 SF	117.3 sm	
	7399.9 SF	687.5 sm	
307	1109.6 SF	103.1 sm	
305			
304	1034.4 SF	96.1 sm	
ვ∩1	10274 SF	954 am	
	9351.5 SF	868.8 sm	(NOT INCL. OUTDOOR P.O.S.)
P.O.S.			(MOT MOL OUTDOOR PO C.)
20.0			
DECKS		34.1 sm	
ECKS	910	84.5 sm	
- 014 -			
	1262.4 SF	117.3 sm	
	7399.9 SF	687.5 sm	
207	1109.6 SF	103.1 sm	
206	1053.6 SF	97.9 sm	
205	1035.5 SF	96.2 sm	
204	1034.4 SF	96.1 sm	
203	1112 SF	103.3 sm	
		95.4 sm	
201	1027.4 SF	95.4 sm	
	775 SF	72.0 sm	AT GRADE
	5938 SF	551.6 sm	(INCL. HOUSING STAIRS, BIKES STOR & LOBBY SPA
		96.4 sm	
	4900 SF	455.2 sm	
	2786 SF	258.8 sm	
	2114 SF	196.4 sm	
	204 205 206 207 ECKS PECKS P.O.S. 301 302 303 304 305 306	2786 SF 4900 SF 1038 SF 5938 SF 775 SF 201 1027.4 SF 202 1027.4 SF 203 1112 SF 204 1034.4 SF 205 1035.5 SF 206 1053.6 SF 207 1109.6 SF 7399.9 SF 1262.4 SF ECKS 910 DECKS 367 689.2 P.O.S. 1966.2 9351.5 SF 301 1027.4 SF 302 1027.4 SF 303 1112 SF 304 1034.4 SF 305 1035.5 SF 306 1053.6 SF 307 1109.6 SF 7399.9 SF 1262.4 SF 689.2 SF 307 1109.6 SF 7399.9 SF 1262.4 SF 401 1027.4 SF 402 4 SF 403 558.3 SF 404 688.4 SF 405 1034.4 SF 406 1035.5 SF	2786 9F 455.2 9m 4900 9F 455.2 9m 1038 9F 96.4 9m 5938 9F 551.6 9m 775 9F 72.0 9m 201 1027.4 9F 95.4 9m 202 1027.4 9F 96.1 9m 204 1034.4 9F 96.1 9m 207 1109.6 9F 103.3 9m 1262.4 9F 117.3 9m ECKS 910 84.5 9m 1262.4 9F 168.8 9m 301 1027.4 9F 95.4 9m 302 1027.4 9F 95.4 9m 303 1112 9F 103.3 9m 304 1034.4 9F 96.1 9m 305 1035.5 9F 96.2 9m 306 1053.6 9F 97.9 9m 307 1109.6 9F 103.3 9m 308.8 9m 401 1027.4 9F 95.4 9m 307 1109.6 9F 103.3 9m 308 1035.5 9F 96.2 9m 309 9F 687.5 9m 1262.4 9F 117.3 9m

21 units @ +1 bedroom= 1 unit @ 1 bedroom =

TOTAL PRIVATE OPEN SPACE



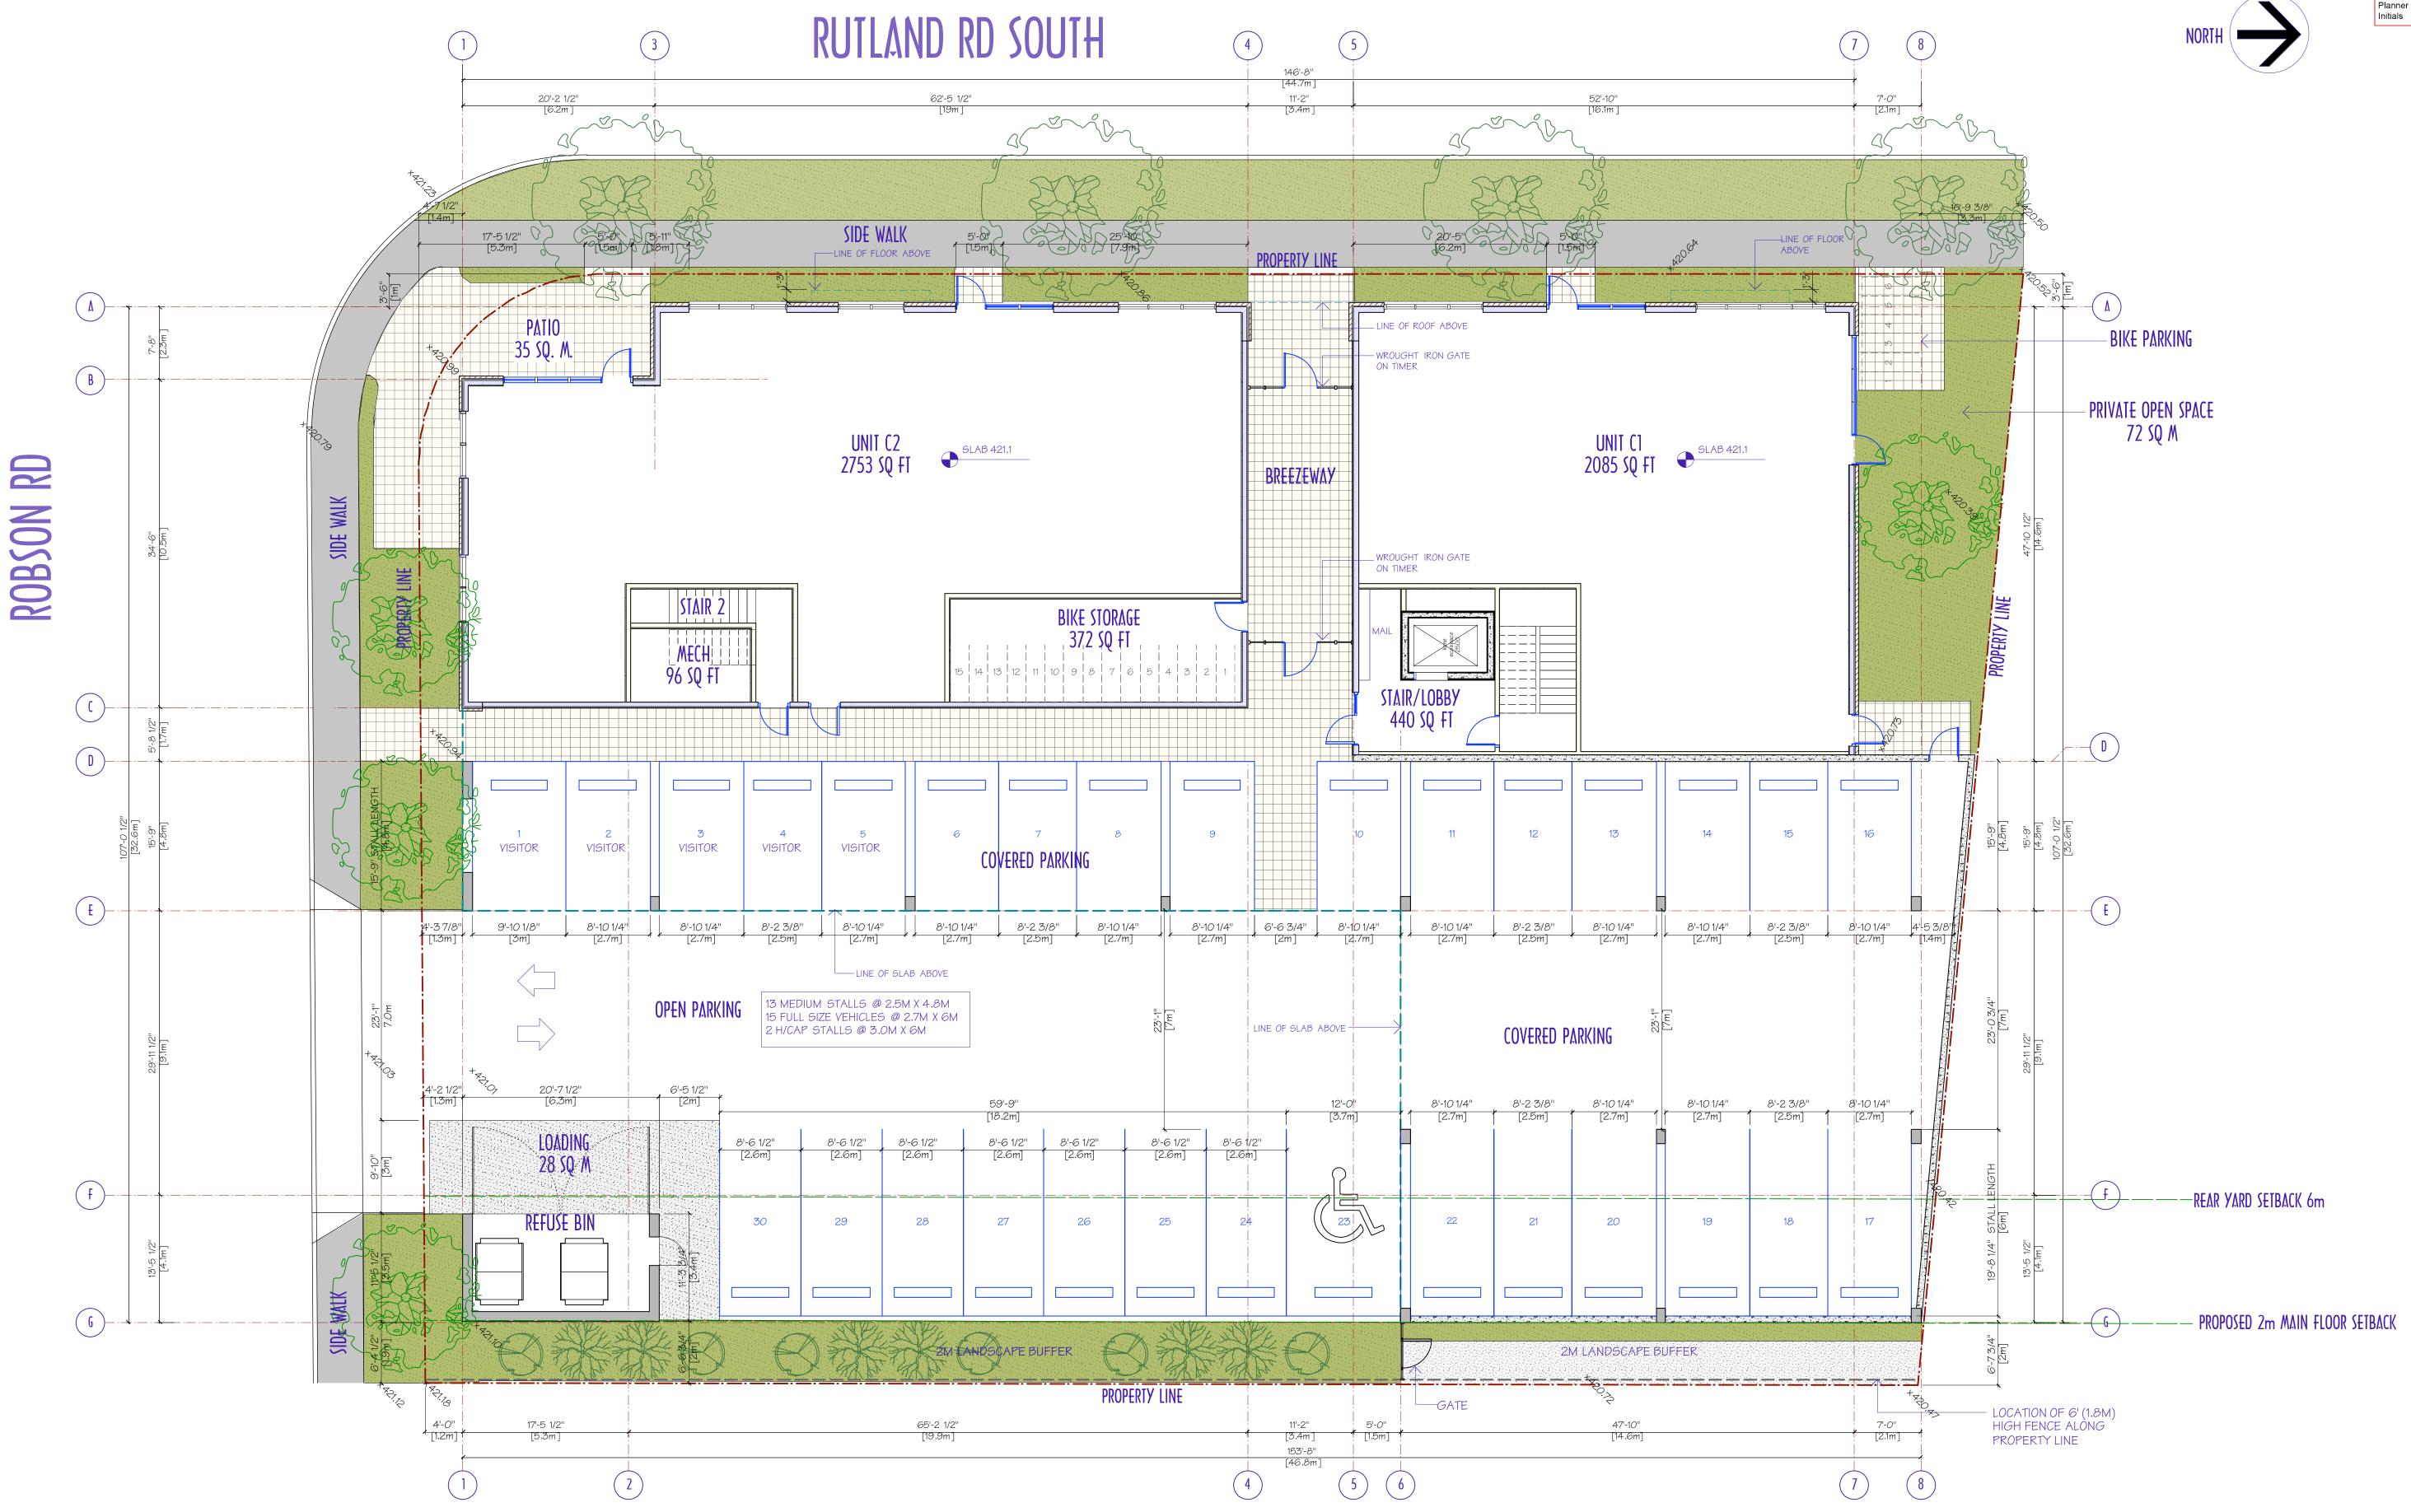




SITE PLAN





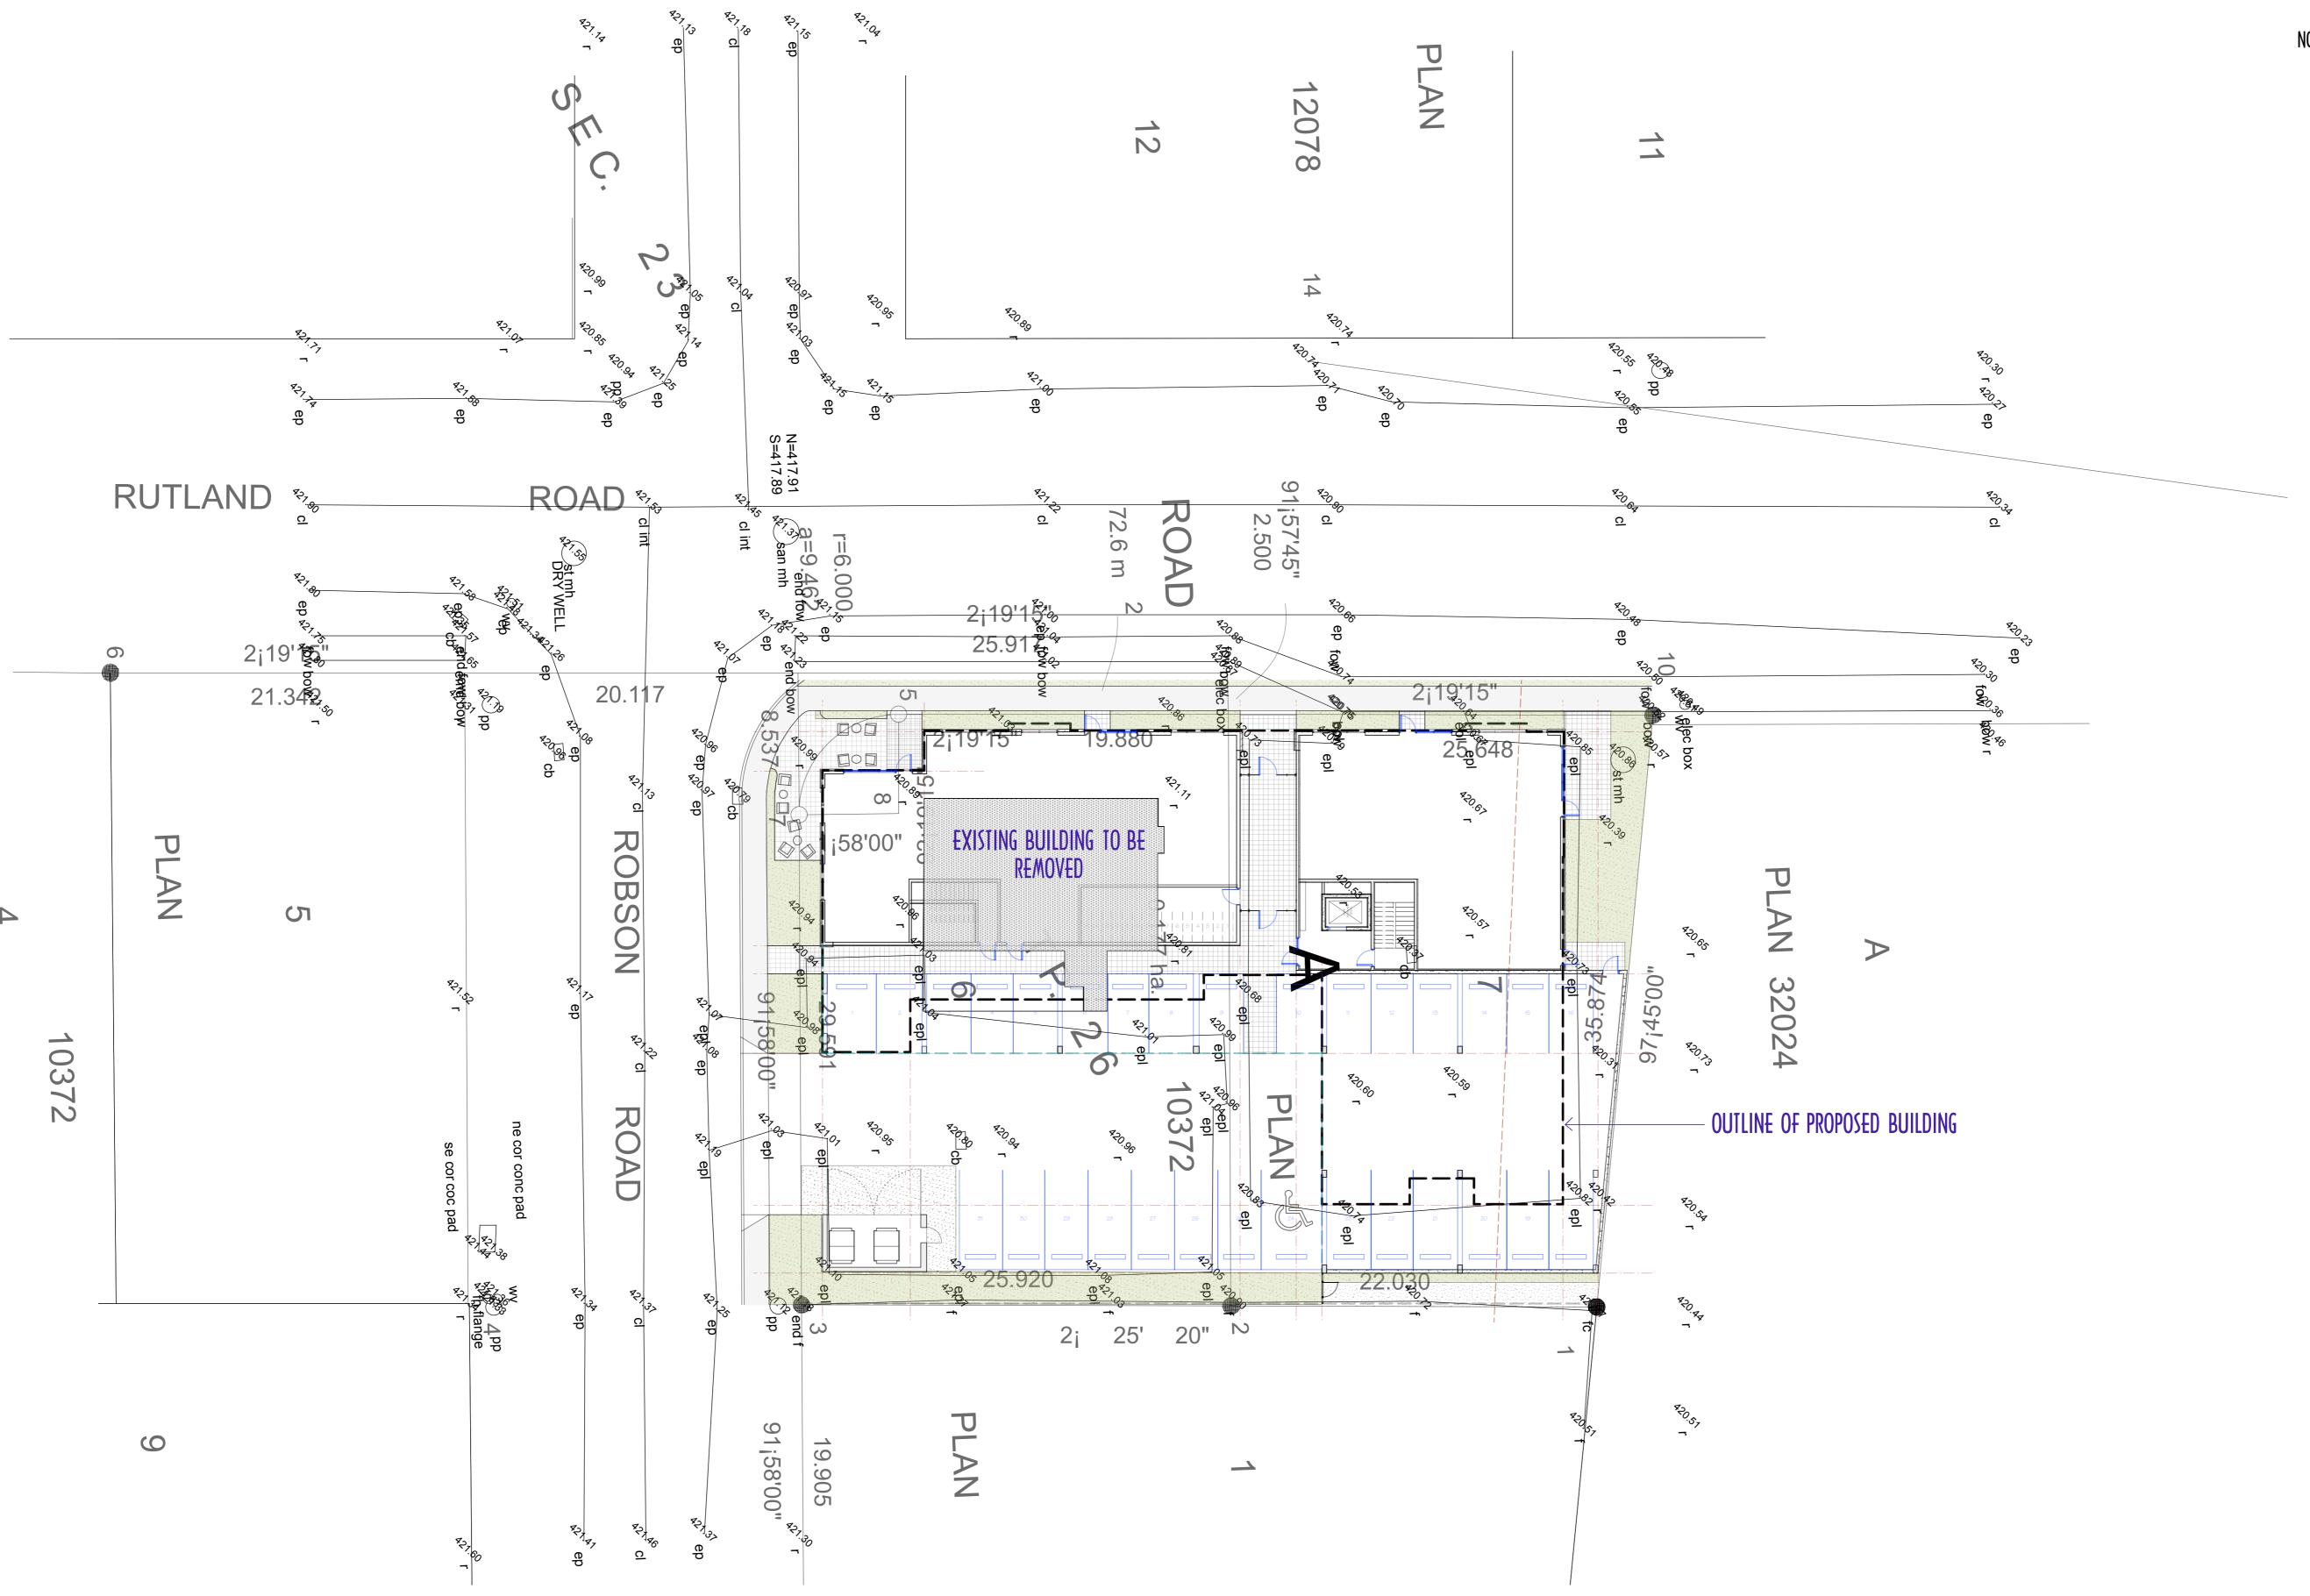

ROBSON MEWS


COMMERCIAL/STUDENT HOUSING



SURVEY PLAN





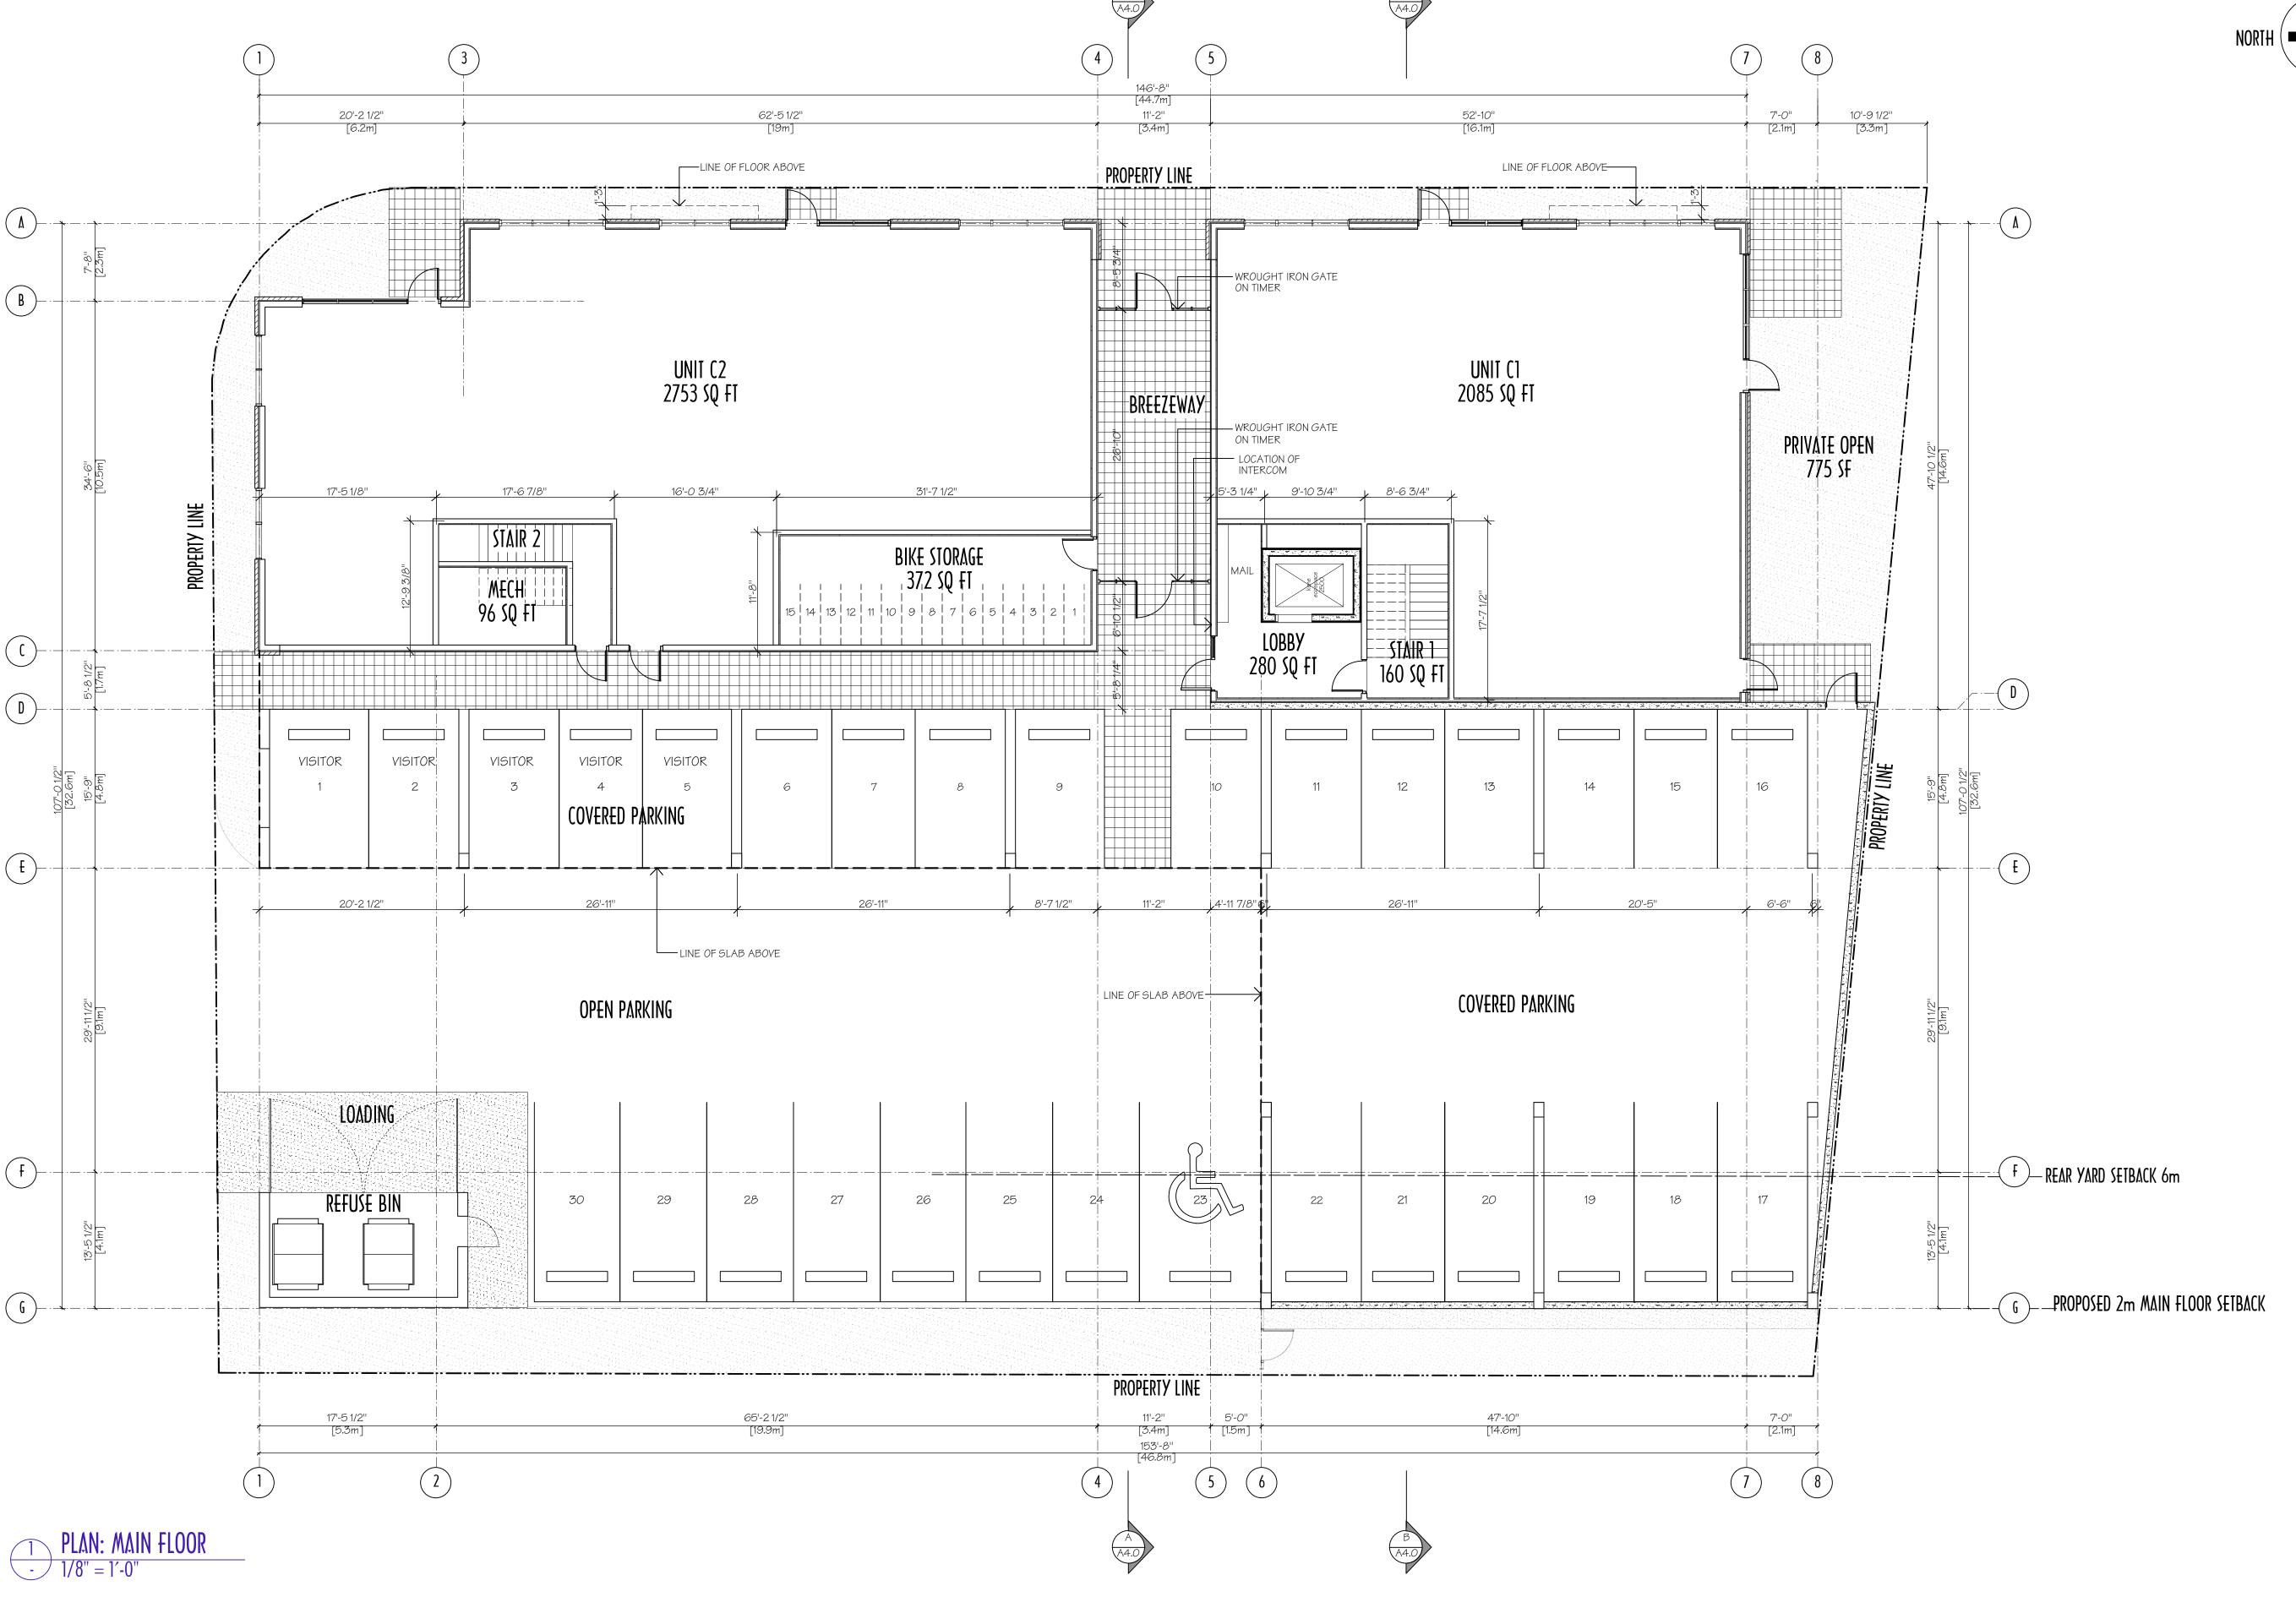




FLOOR PLAN: LEVEL I





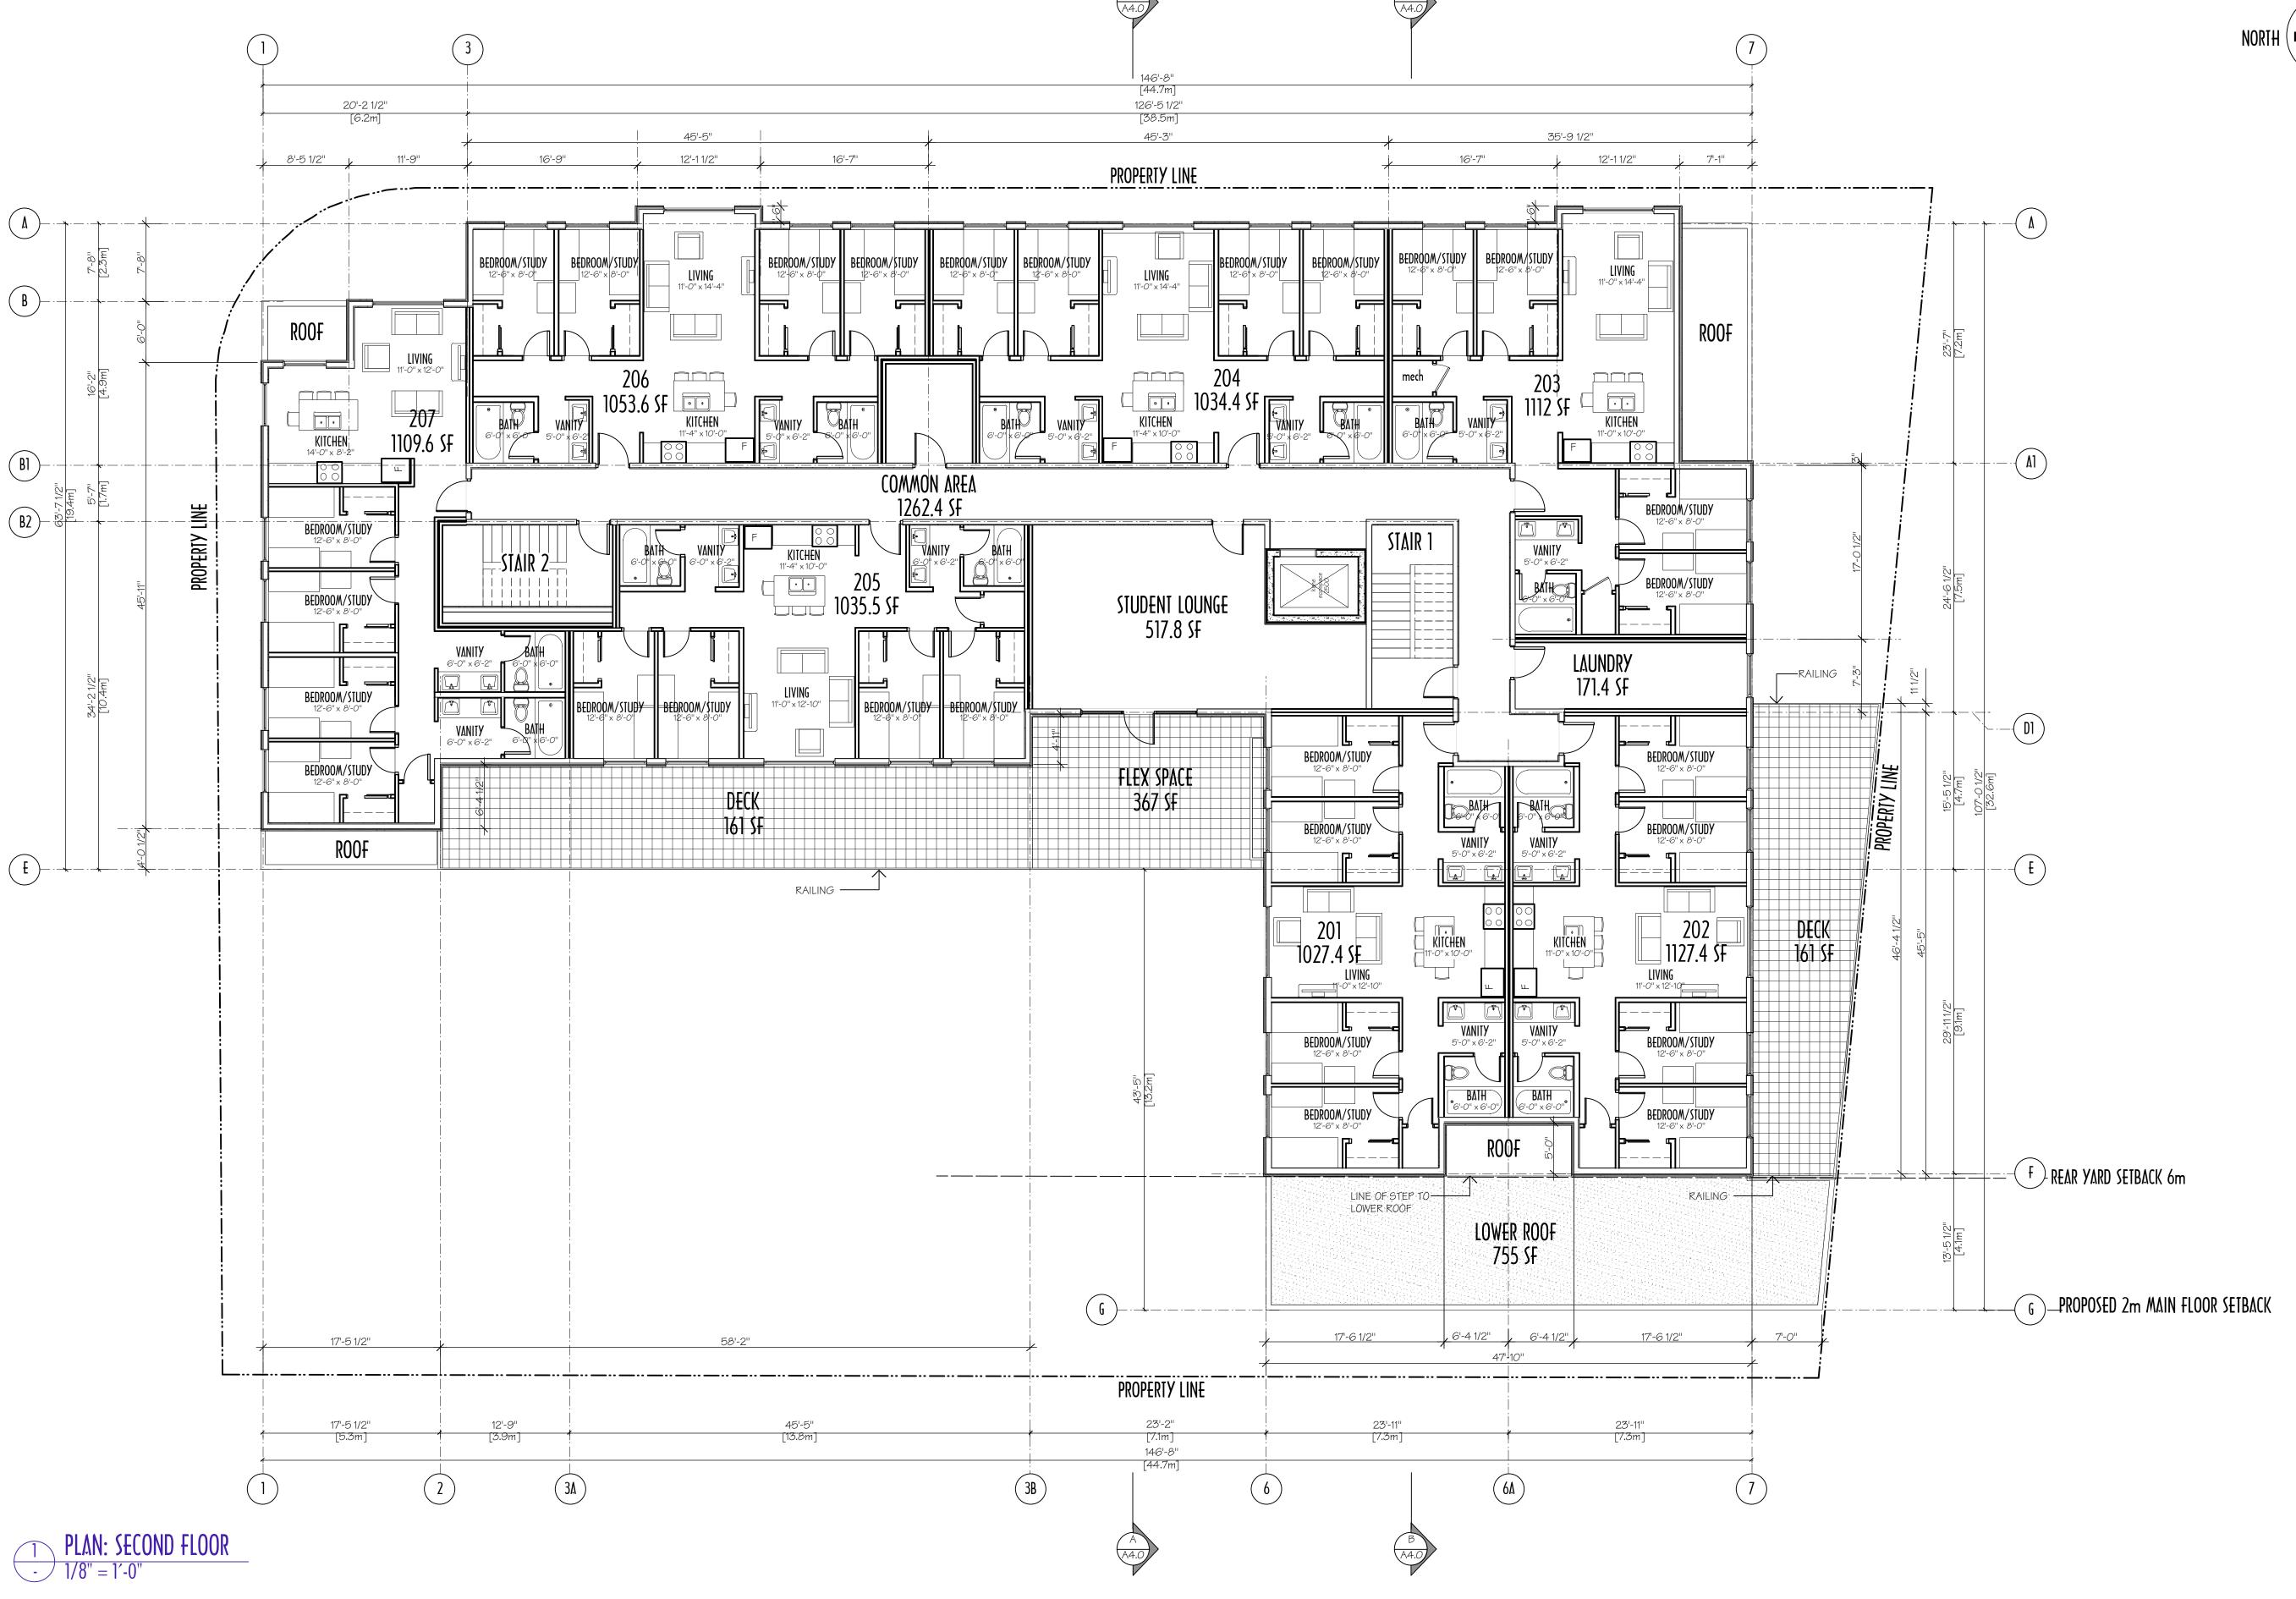




FLOOR PLAN: LEVEL 2






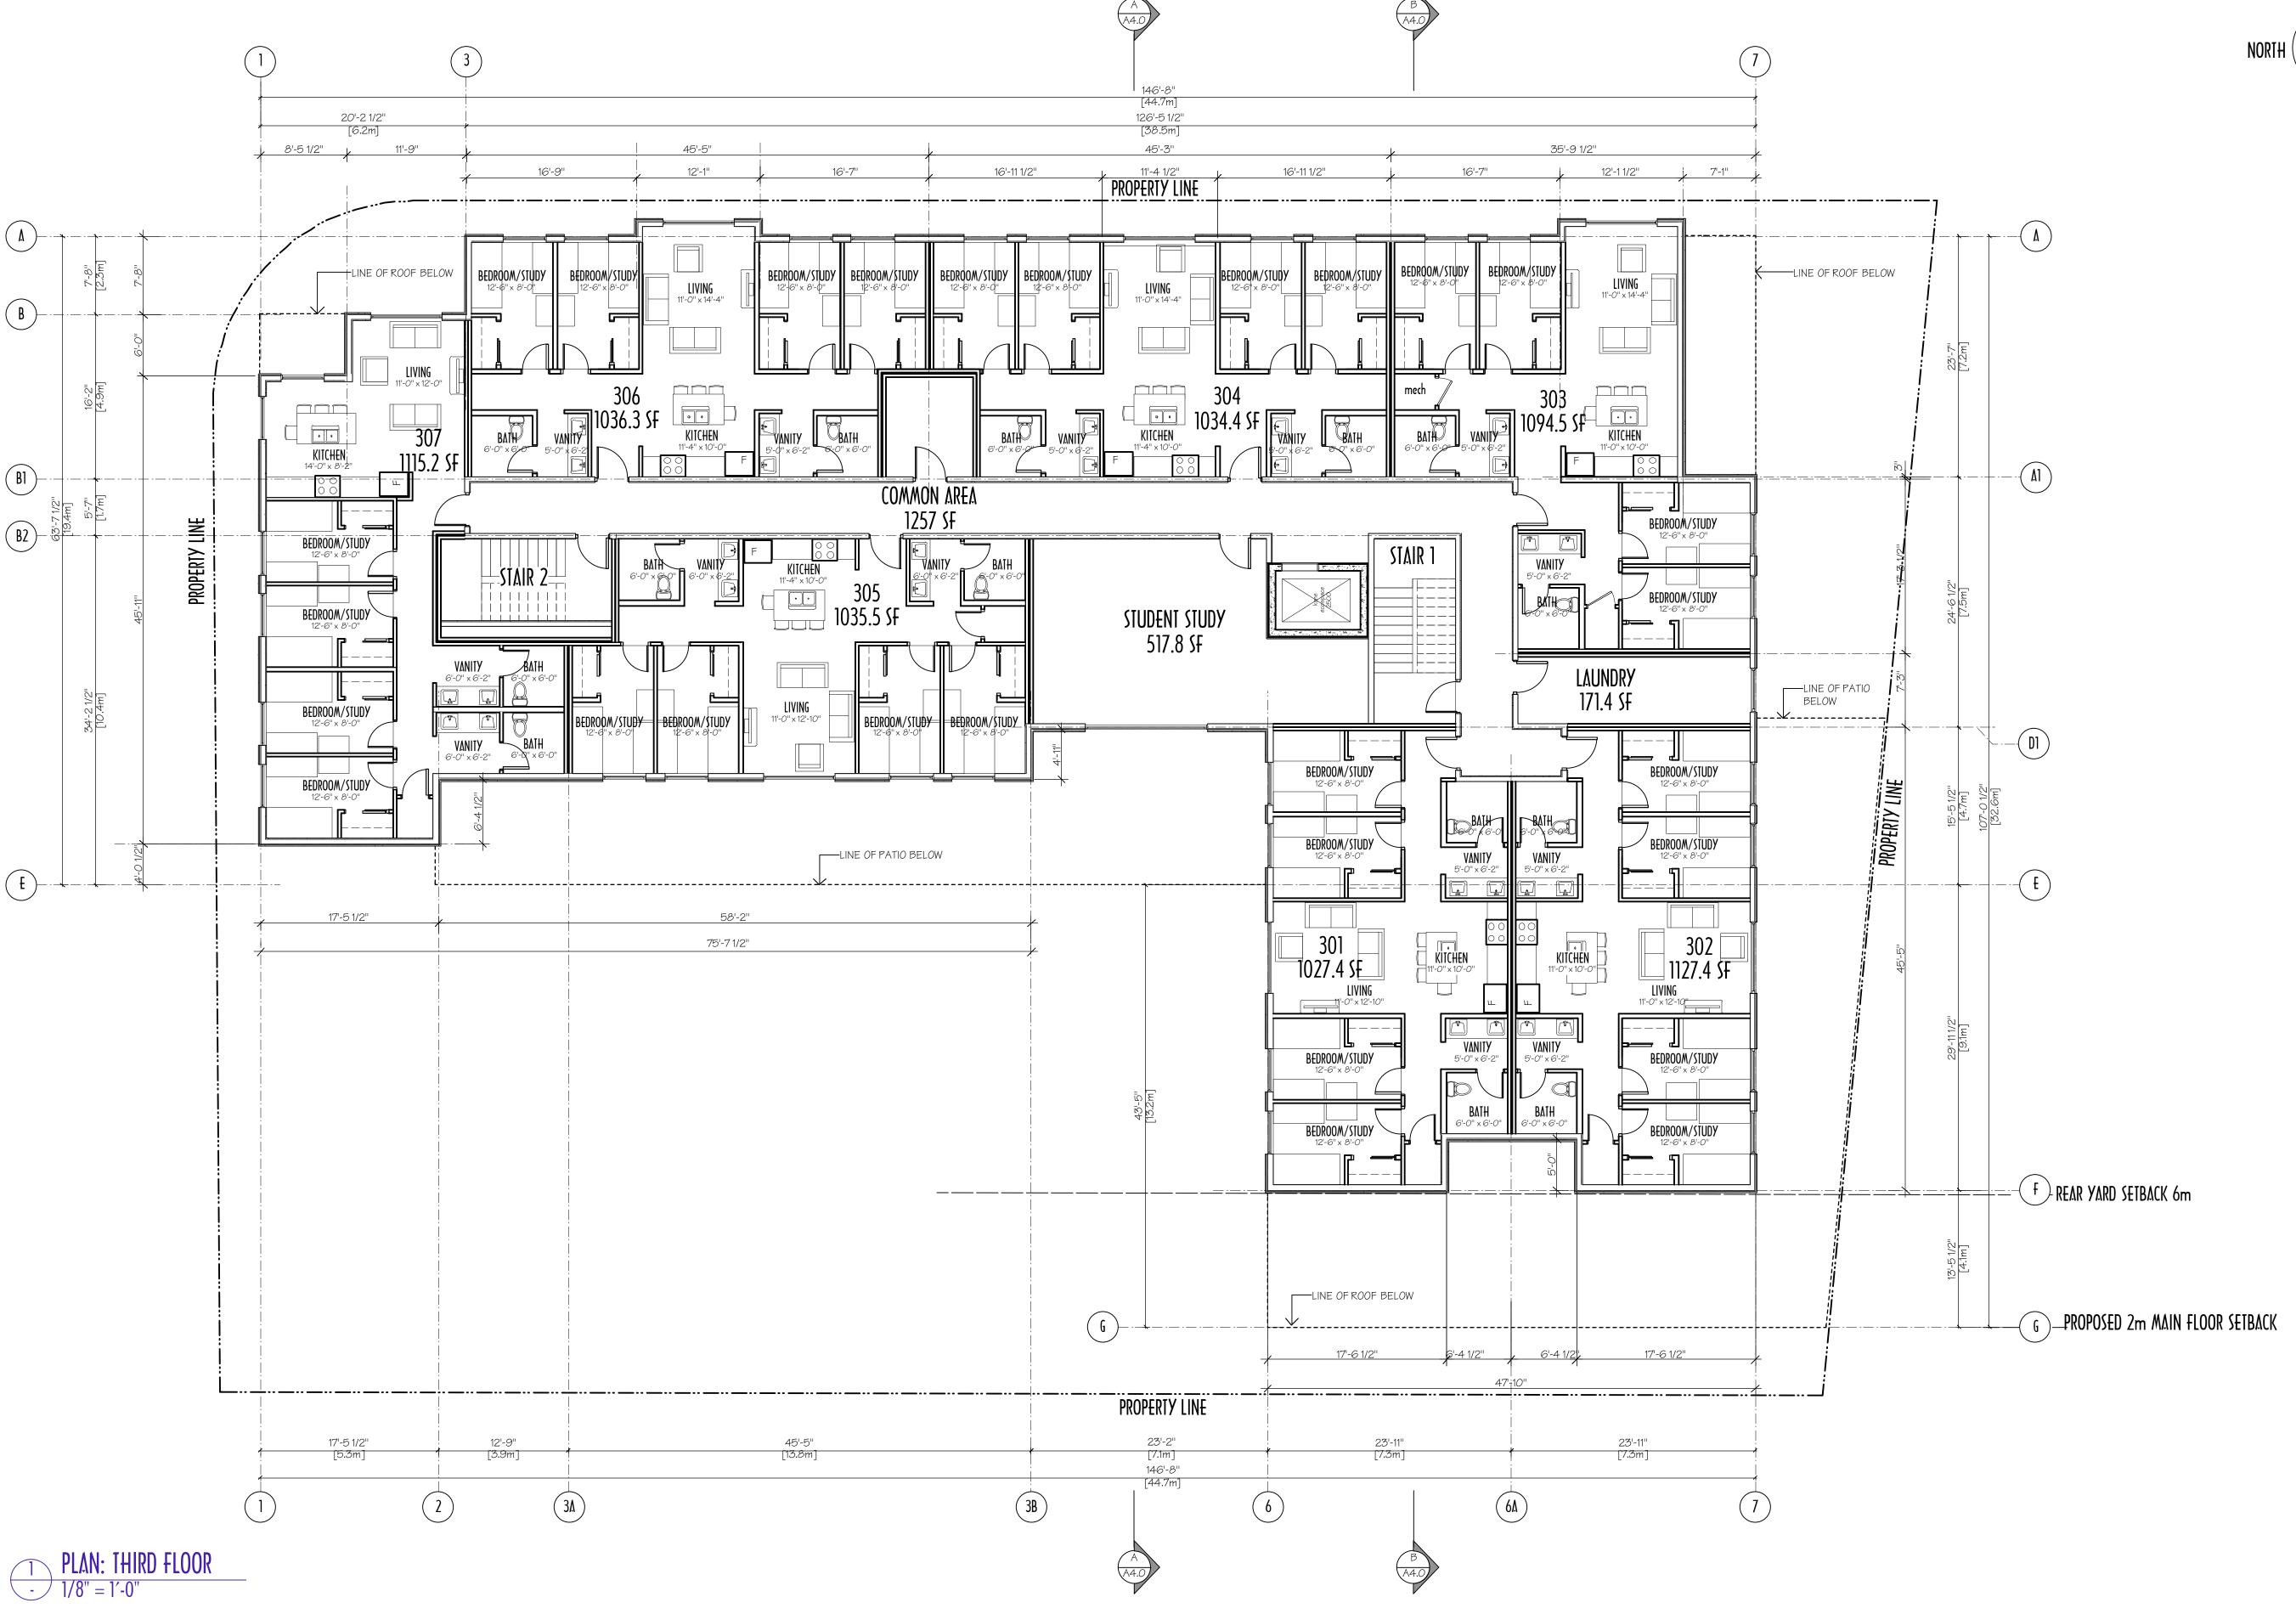







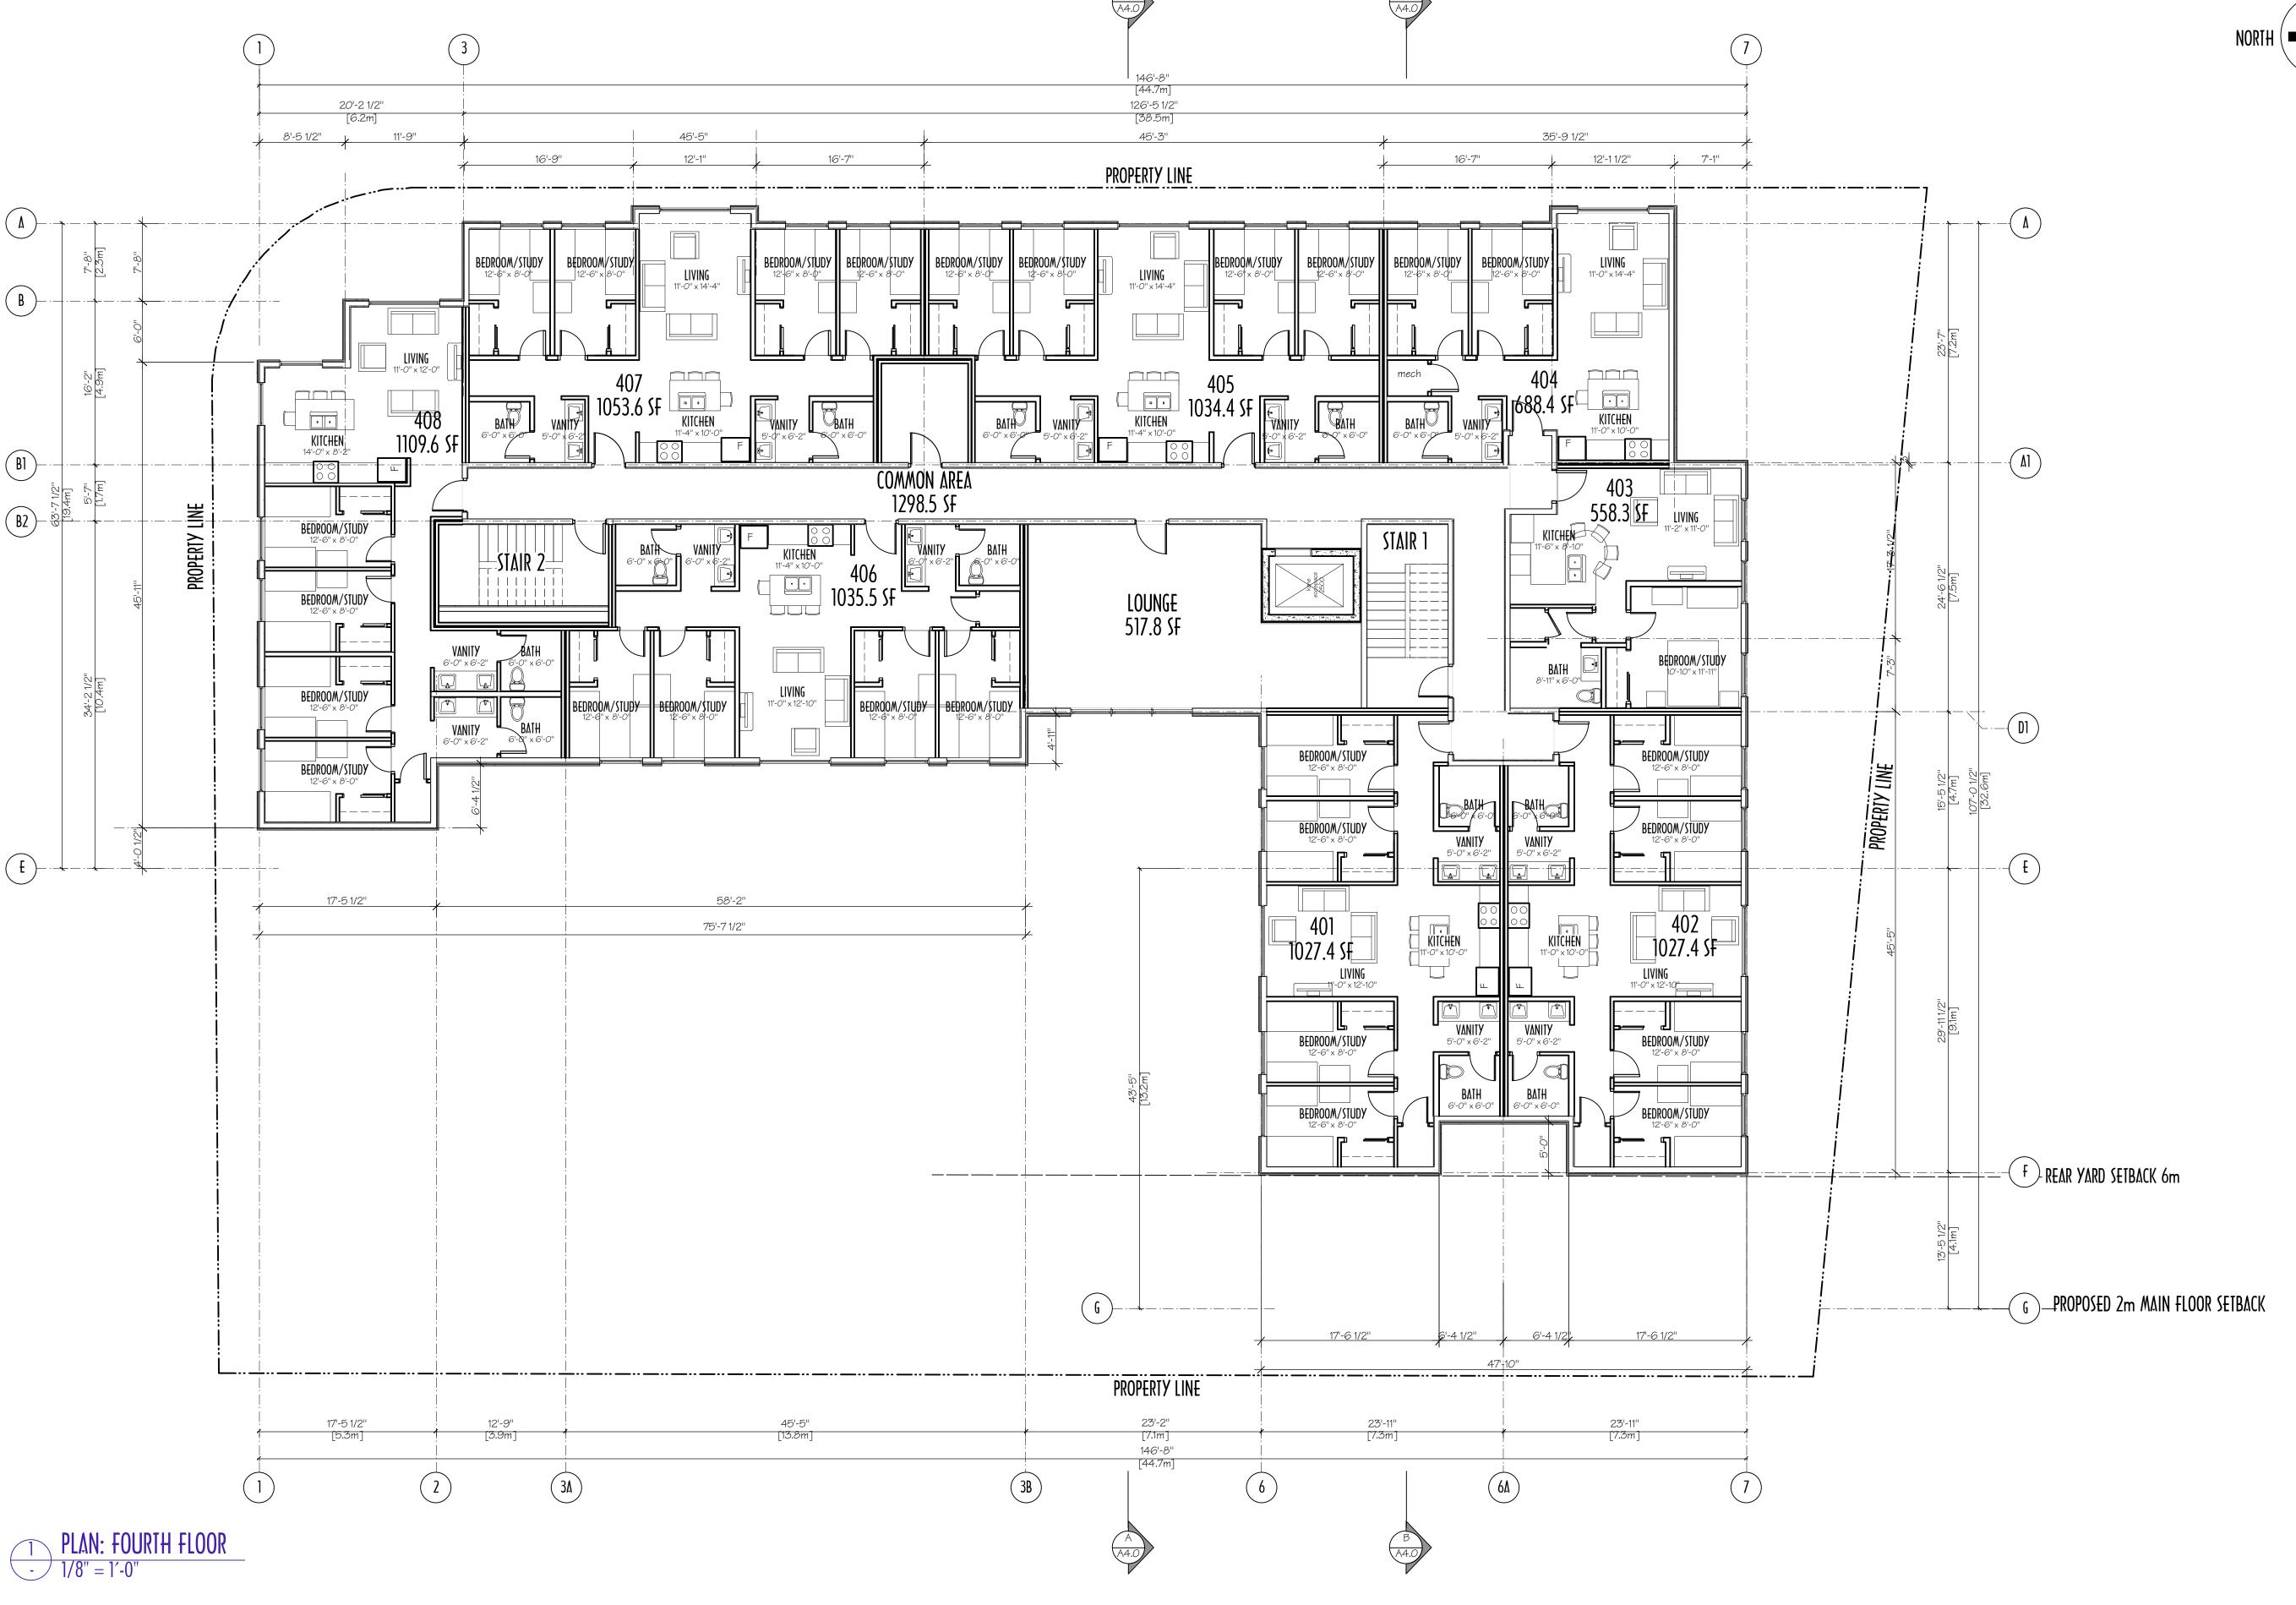




FLOOR PLAN: LEVEL 4





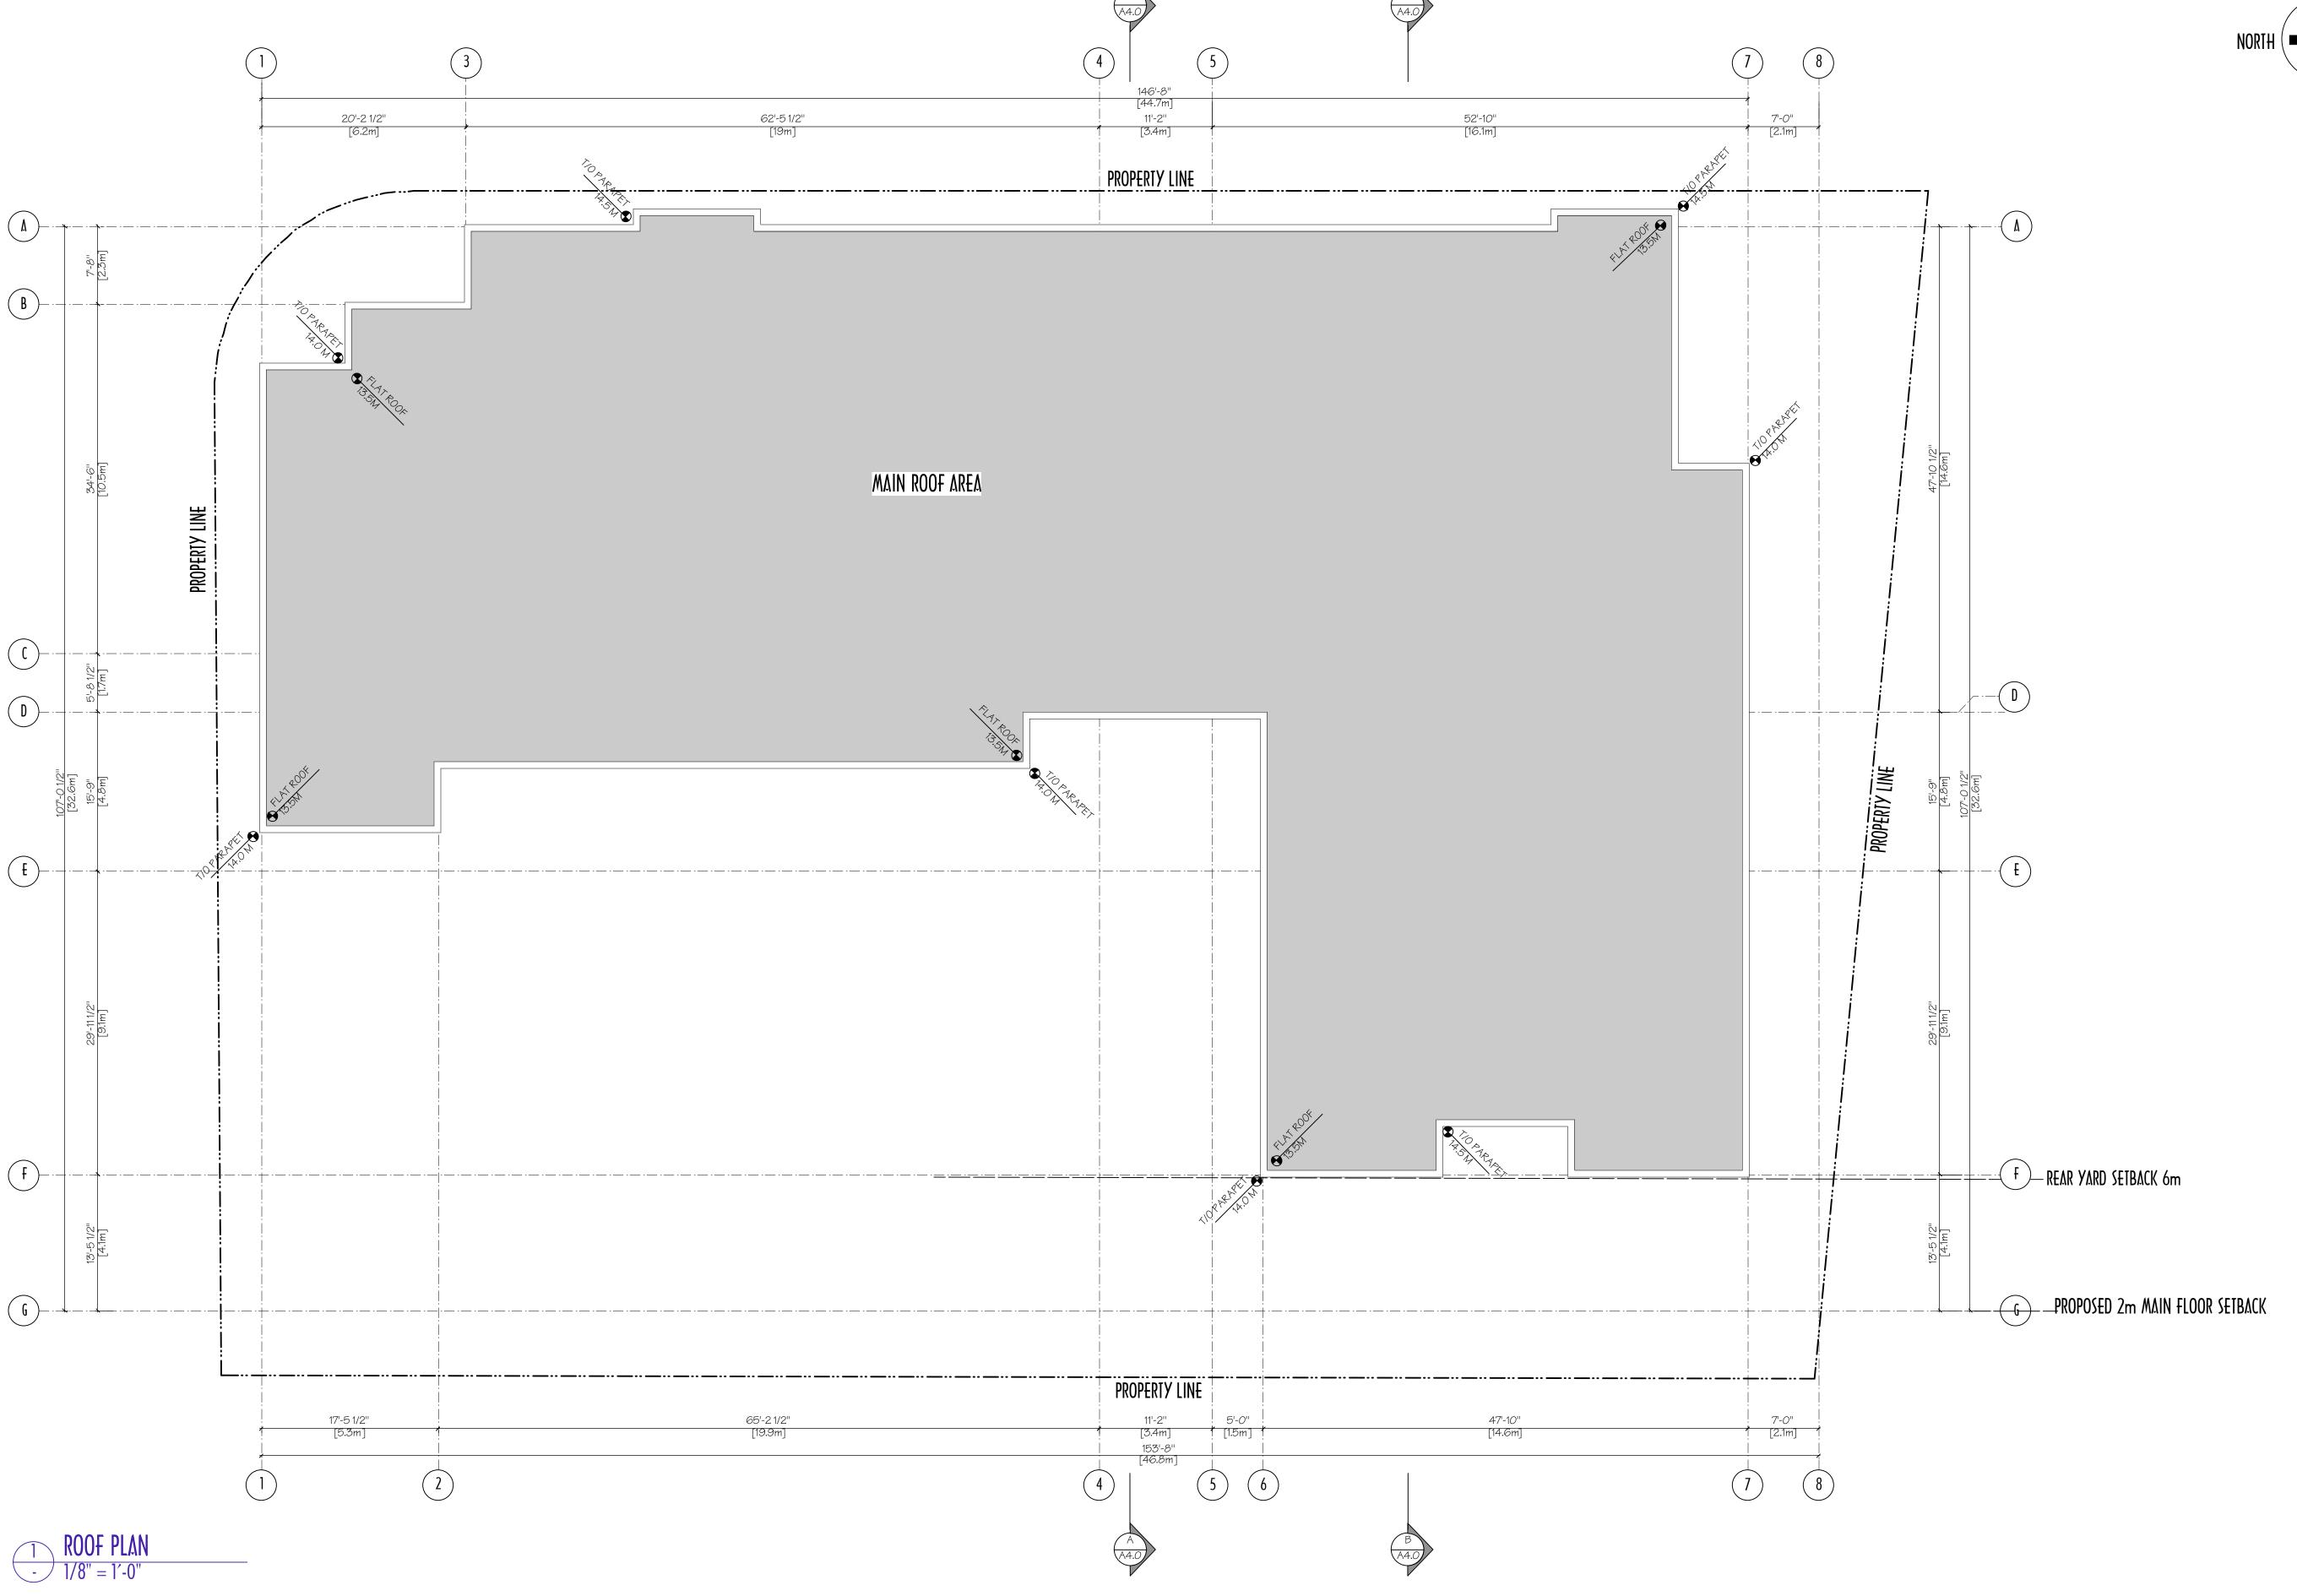




ROBSON MEWS COMMERCIAL/STUDENT HOUSING





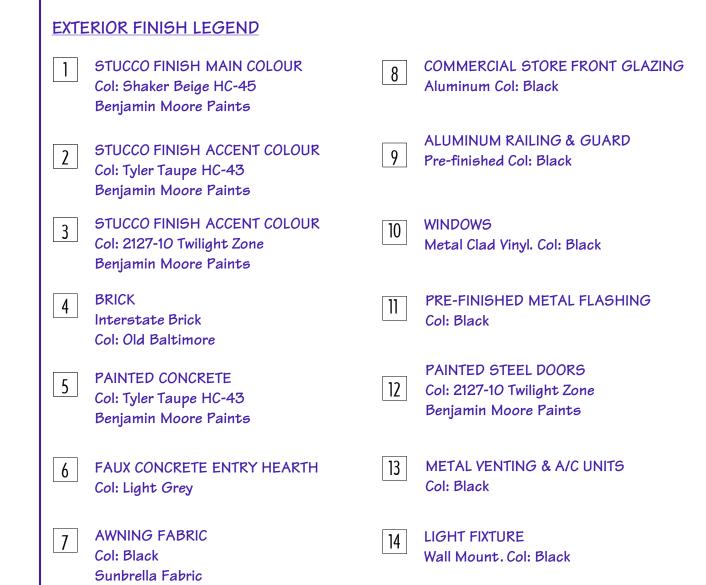





2 SOUTH ELEVATION - 1/8" = 1'-0"

SOUTH ELEVATION

- 1/8" = 1'-0"







EXTERIOR FINISH LEGEND

- STUCCO FINISH MAIN COLOUR
 Col: Shaker Beige HC-45
 Benjamin Moore Paints
- 8 COMMERCIAL STORE FRONT GLAZING Aluminum Col: Black

9 ALUMINUM RAILING & GUARD Pre-finished Col: Black

PRE-FINISHED METAL FLASHING

- STUCCO FINISH ACCENT COLOUR
 Col: Tyler Taupe HC-43
 Benjamin Moore Paints
 - OUR WINDOWS

Col: Black

- 3 STUCCO FINISH ACCENT COLOUR Col: 2127-10 Twilight Zone Benjamin Moore Paints
- WINDOWS

 Metal Clad Vinyl. Col: Black
- BRICK
 Interstate Brick
 Col: Old Baltimore
- PAINTED STEEL DOORS
 Col: 2127-10 Twilight Zone
- Col: Tyler Taupe HC-43
 Benjamin Moore Paints

PAINTED CONCRETE


METAL VENTING & A/C UNITS
Col: Black

Benjamin Moore Paints

- 6 FAUX CONCRETE ENTRY HEARTH
 Col: Light Grey
- LIGHT FIXTURE

 Wall Mount. Col: Black
- 7 AWNING FABRIC Col: Black Sunbrella Fabric

3 **EAST ELEVATION**- 1/8" = 1'-0"

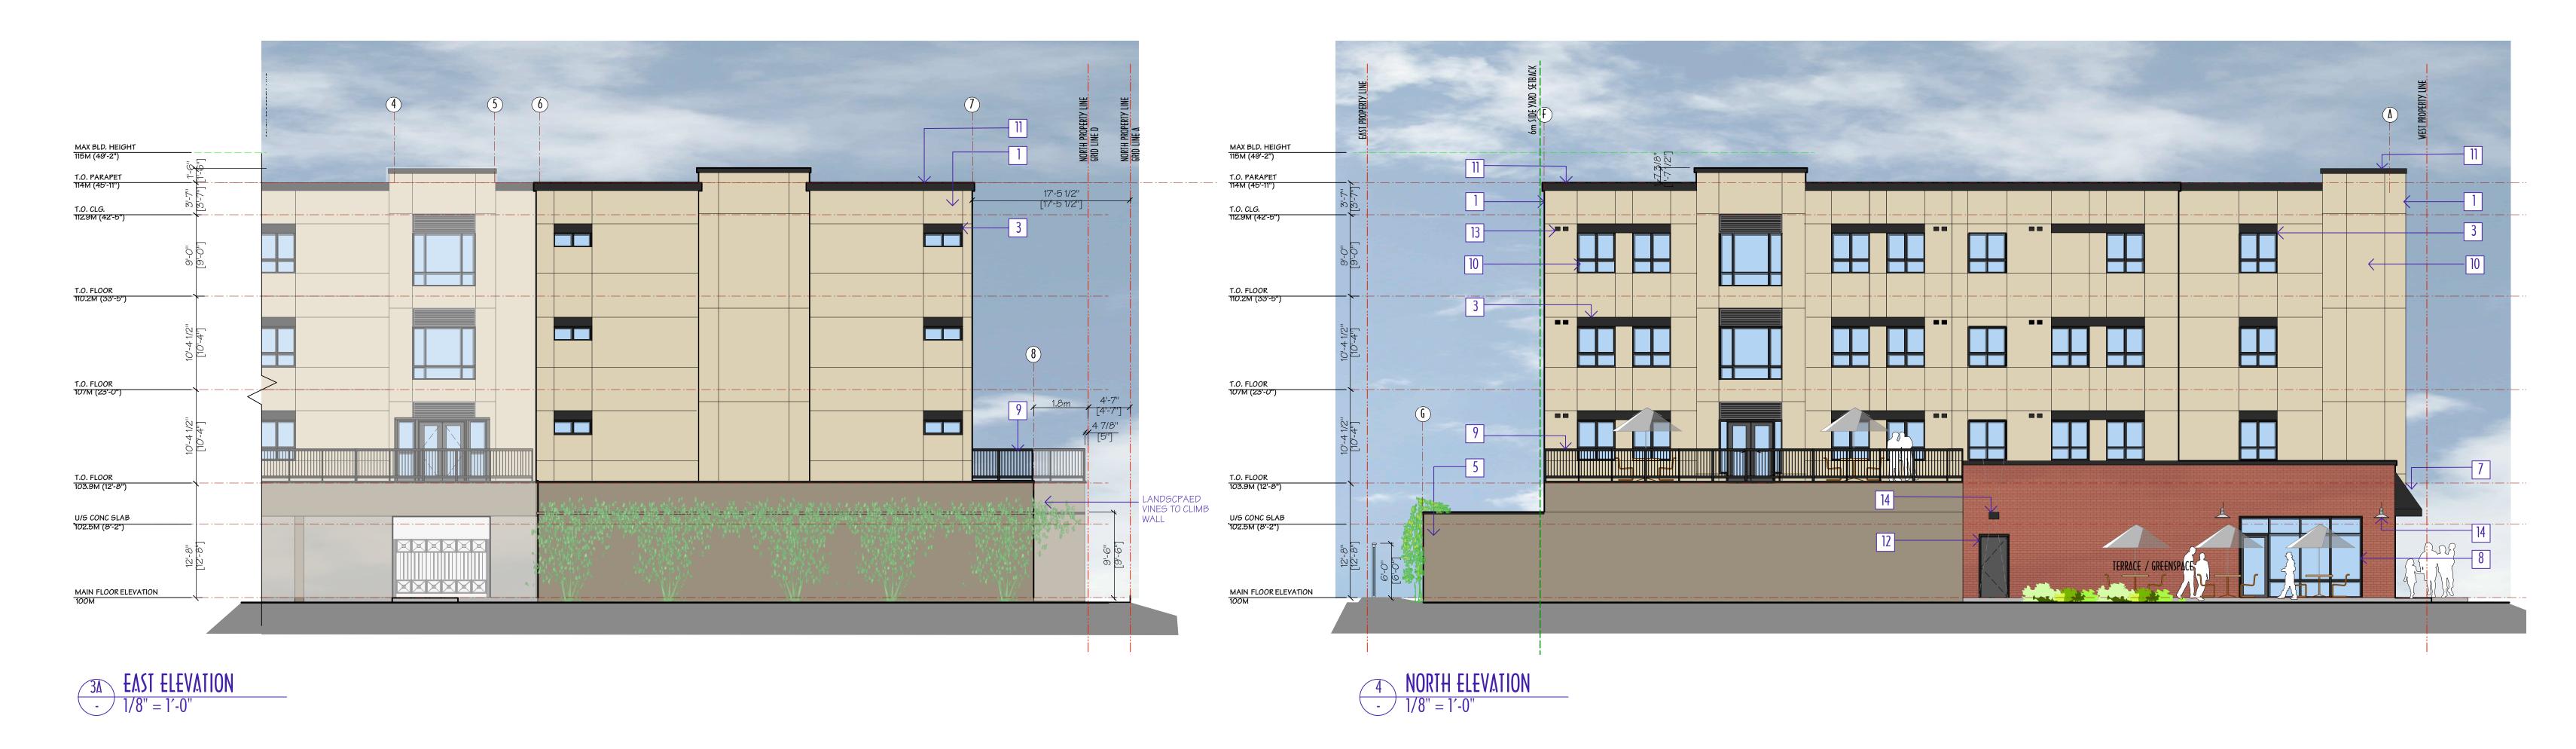





RUTLAND STREET ELEVATION


- 1/8" = 1'-0"



2 ROBSON STREET ELEVATION
- 1/8" = 1'-0"



STREET ELEVATIONS

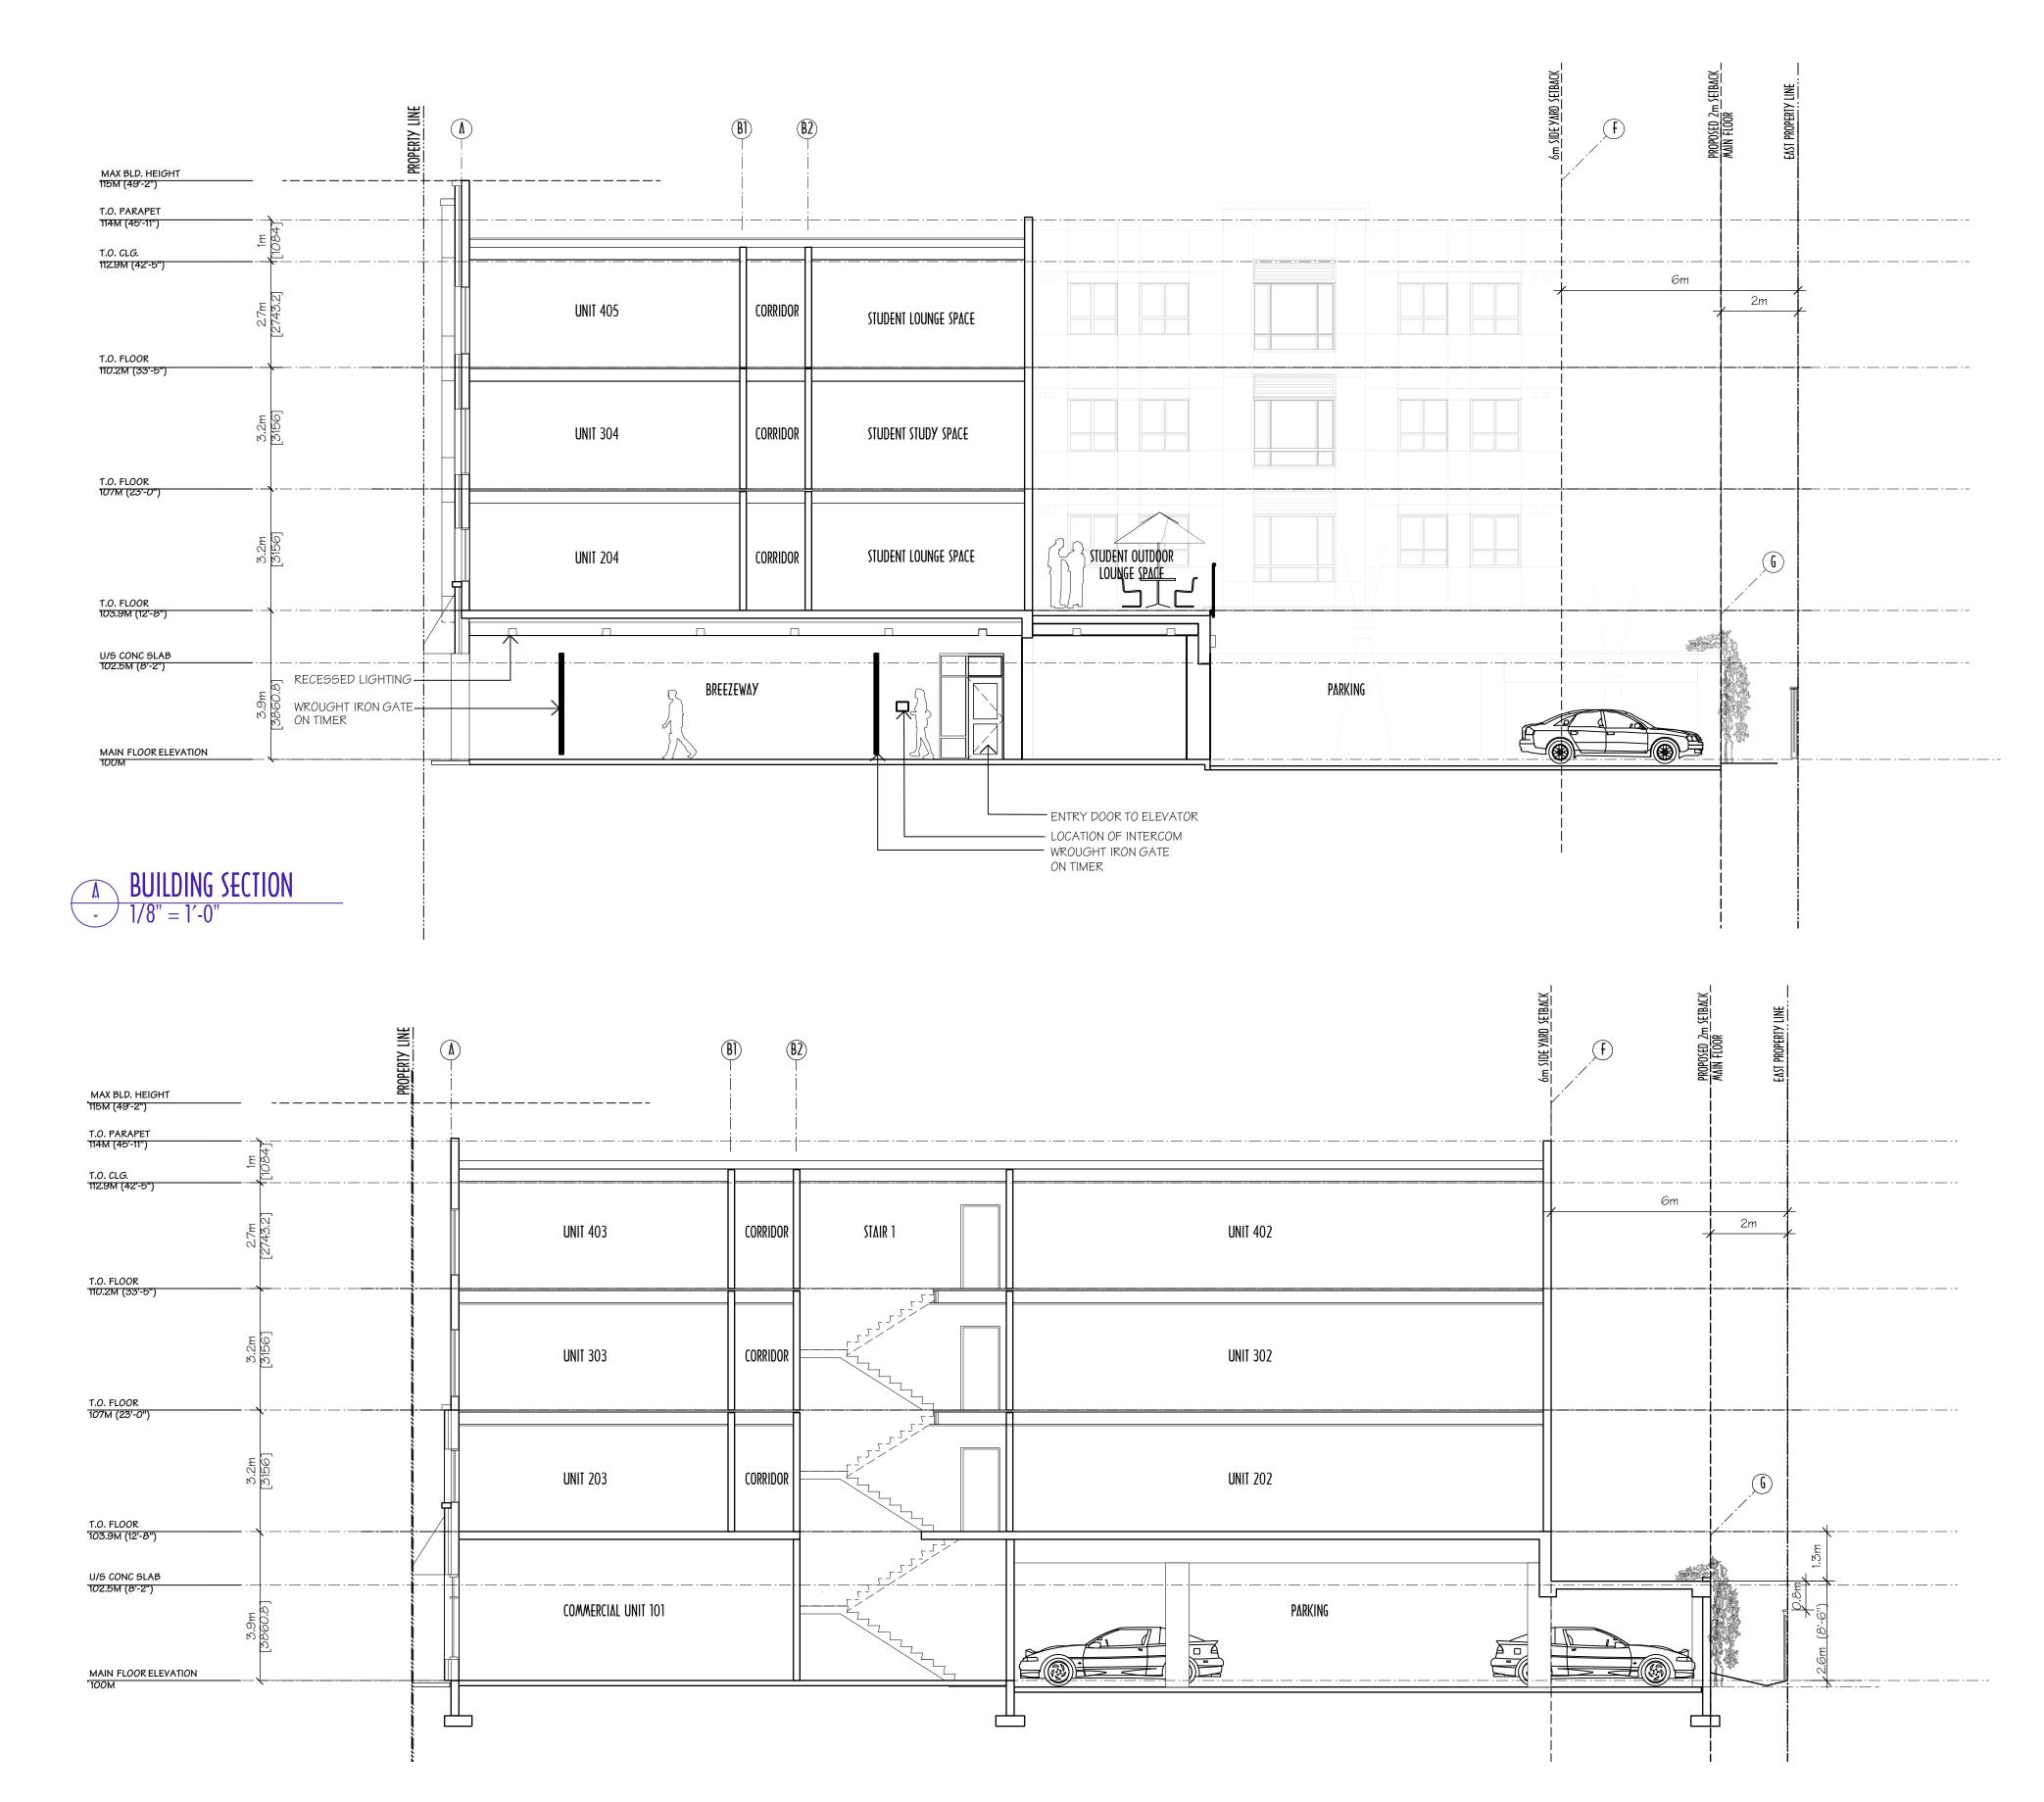

ROBSON MEWS

COMMERCIAL/STUDENT HOUSING

BUILDING SECTION

- 1/8" = 1'-0"





PLANT LIST

	BOTANICAL NAME	COMMON NAME	QTY	SIZE / SPACING & REMARKS
	TREES			
	ACER NEGUNDO 'SENSATION'	SENSATION BOXELDER	4	6cm CAL.
	CELTIS OCCIDENTALIS	HACKBERRY	3	6cm CAL.
	POPULUS TREMULA 'ERECTA'	SWEDISH COLUMNAR ASPEN	5	6cm CAL.
	SHRUBS, PERENNIALS & GROUNDC	OVERS		
	ACHILLEA MILLEFOLIUM	YARROW	52	#01 CONT. /0.5m O.C. SPACING
	BUDDLEIA X 'BLUE CHIP'	LO & BEHOLD BUTTERFLY BUSH	13	#01 CONT. /1.0m O.C. SPACING
	CORNUS STOLONIFERA 'FARROW	ARCTIC FIRE DOGWOOD	58	#01 CONT. /1.0m O.C. SPACING
	DESCHAMPSIA CAESPITOSA	TUFTED HAIR GRASS	52	#01 CONT. /0.5m O.C. SPACING
	HEDERA HELIX	ENGLISH IVY	9	#01 CONT. /1.8m O.C. SPACING
	NEPETA X FAASSENII 'WALKER'S LOW	' WALKER'S LOW CATMINT	72	#01 CONT. /0.5m O.C. SPACING
	Rudbeckia fulgida 'goldsturm'	GOLDSTURM CONEFLOWER	52	#01 CONT. /0.5m O.C. SPACING
	SPIRAEA 'SNOWHITE'	SNOWWHITE SPIREA	18	#01 CONT. /1.0m O.C. SPACING
- 1				

NOTES

- 1. PLANT MATERIAL AND CONSTRUCTION METHODS SHALL MEET OR EXCEED B.C.L.N.A. STANDARDS.
- 2. ALL SOFT LANDSCAPE AREAS SHALL BE WATERED BY A FULLY AUTOMATIC TIMED UNDERGROUND IRRIGATION SYSTEM.
- 3. TREE AND SHRUB BEDS TO BE DRESSED IN A MINIMUM 75mm WOOD
- MULCH. DO NOT PLACE WEED MAT UNDERNEATH TREE AND SHRUB BEDS.
- 4. TREE AND SHRUB BEDS TO RECEIVE A MINIMUM 300mm DEPTH TOPSOIL PLACEMENT.
- 5. TURF AREAS FROM SOD SHALL BE NO. 1 GRADE GROWN FROM CERTIFIED SEED OF IMPROVED CULTIVARS REGISTERED FOR SALE IN B.C. AND SHALL BE TOLERANT OF DROUGHT CONDITIONS. A MINIMUM OF 100mm DEPTH OF GROWING MEDIUM IS REQUIRED BENEATH TURF AREAS. TURF AREAS SHALL MEET EXISTING GRADES AND HARD SURFACES FLUSH.



206 - 1889 Spall Road Kelowna, BC V1Y 4R2 T (250) 868-9270 www.outlanddesign.ca

This forms part of application
DP16-0297 & DVP16-0298

City of

Planner Initials

LK



PROJECT TITLE

225 Rutland Road

Kelowna, BC

DRAWING TITLE

ISSUED FOR / REVISION

CONCEPTUAL LANDSCAPE PLAN

3	
4	
5	

PROJECT NO	13-042
DESIGN BY	KG
DRAVVN BY	SR
CHECKED BY	FB
DATE	NOV. 29, 2016
SCALE	1:125

SEVI




DRAWING NUMBER

L1/2

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ESTIMATED ANNUAL WATER USE: 37 cu.m.

UNWATERED PERVIOUS AREA: COBBLE MULCH

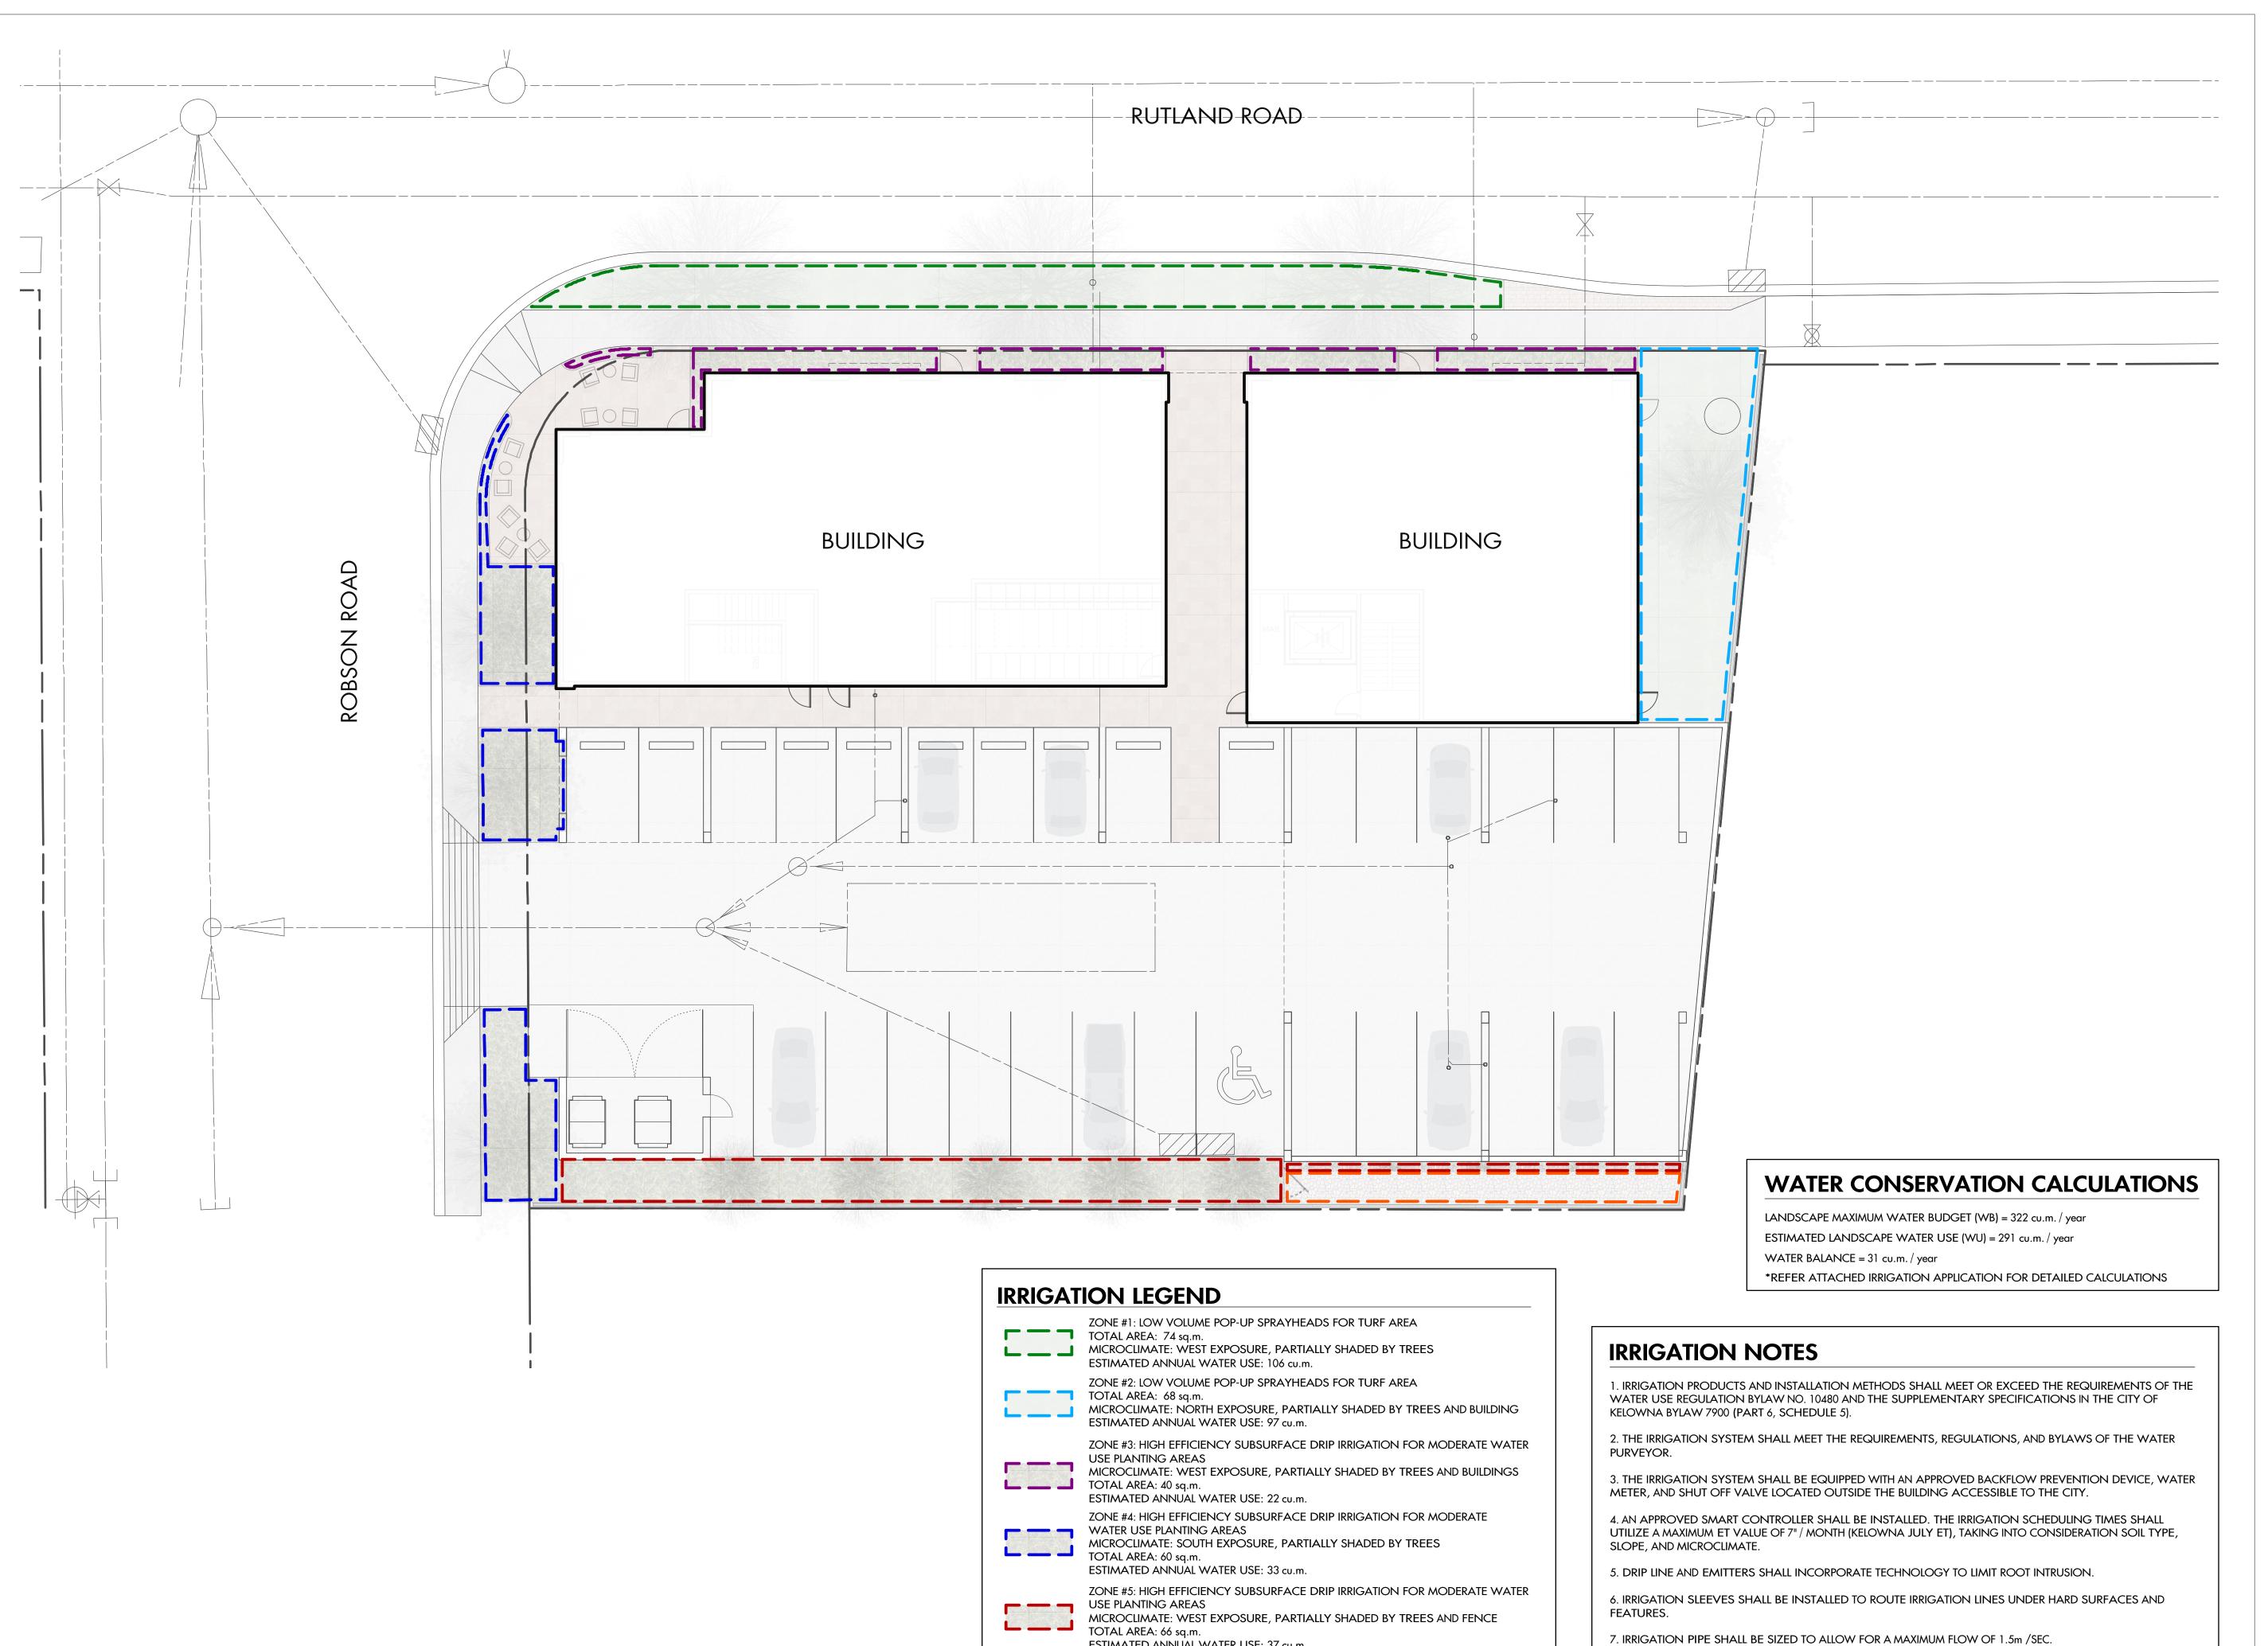TOTAL AREA: 22 sq.m.



206 - 1889 Spall Road Kelowna, BC V1Y 4R2 T (250) 868-9270 www.outlanddesign.ca





PROJECT TITLE 225 Rutland Road

Kelowna, BC

DRAWING TITLE

ISSUED FOR / REVISION

WATER CONSERVATION AND IRRIGATION PLAN

3	
4	
5	

PROJECT NO	13-042
DESIGN BY	SP
DRAWN BY	KG
CHECKED BY	FB
DATE	NOV. 29, 2016
SCALE	1:125



DRAWING NUMBER

8. A FLOW SENSOR AND MASTER VALVE SHALL BE CONNECTED TO THE CONTROLLER AND PROGRAMMED TO

STOP FLOW TO THE SYSTEM IN CASE OF AN IRRIGATION WATER LEAK.

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