Initials

CITY OF KELOWNA

MEMORANDUM

Date: File No.:

July 25, 2016 Z16-0042

To:

Community Planning (LK)

From:

Development Engineering Manager(PI)

Subject:

4377 Kensington Road

RU1 to RU6

The Development Engineering Department has the following comments and requirements associated with this rezoning application. The road and utility upgrading requirements outlined in this report will be a requirement of this development. The Development Engineering Technologist for this project is Sergio Sartori

1. **Domestic Water and Fire Protection**

This property is currently serviced with a 19mm diameter PVC water service. Two 19mm copper or 25mm poly water services are required to meet current by-law requirements. The water service requirements can be provided by the City at the owner's cost. The applicant will be required to sign a Third Party Work Order for the cost of the water service upgrades. For estimate inquiry's please contact Sergio Sartori, by email ssartori@kelowna.ca or phone, 250-469-8589.

The developer must obtain the necessary permits and have all existing utility services disconnected prior to removing or demolishing the existing structures. The City of Kelowna water meter contractor must salvage existing water meters, prior to building demolition. If water meters are not salvaged, the developer will be invoiced for the meters.

2. **Sanitary Sewer**

Our records indicate that this property is currently serviced with a 100mmdiameter sanitary sewer service. An inspection chamber (IC) complete with brooks box should be installed on the service at the owner's cost. Service upgrades can be provided by the City at the applicant's cost. The applicant will be required to sign a Third Party Work Order for the cost of the service upgrade. For estimate inquiry's please contact Sergio Sartori, by email ssartori@kelowna.ca or phone, 250-469-8589.

3. **Road Improvements**

(a) Kensington Rd has been upgraded to an urban standard along the full frontage of this proposed development therefore no further upgrades are required.

5. Development Permit and Site Related Issues

Direct the roof drains into on-site rock pits or splash pads.

6. <u>Electric Power and Telecommunication Services</u>

The electrical and telecommunication services to this building must be installed in an underground duct system, and the building must be connected by an underground service. It is the developer's responsibility to make a servicing application with the respective electric power, telephone and cable transmission companies to arrange for these services, which would be at the applicant's cost.

Purvez Irani, MS, P Eng<u>.</u>, PTOE Development Engineering Manager

SS

CITY OF KELOWNA

MEMORANDUM

Date:

July 25, 2016

File No.:

DVP16-0168

To:

Community Planning (LK)

From:

Development Engineer Manager (PI)

Subject:

4377 Kensington Road

The Development Engineering comments and requirements regarding this DVP application are as follows:

This development variance permit application to vary the required frontage from 18.0 m to 17.03 m. does not compromise any municipal services.

Purvez Iráni, MS, P Eng., PTOE Development Engineering Manager

SS

CITY OF KELOWNA

MEMORANDUM

Date:

July 26, 2016

File No.:

DP16-0169

To:

Community Planning (LK)

From:

Development Engineer Manager (PI)

Subject:

4377 Kensington Road


The Development Engineering comments and requirements regarding this Development Permit application are as follows:

1. General.

a) All the offsite infrastructure and services upgrades are addressed in the Rezoning Engineering Report under file Z16-0042.

Purvez Irani, MS, P Eng., PTOE Development Engineering Manager

SS

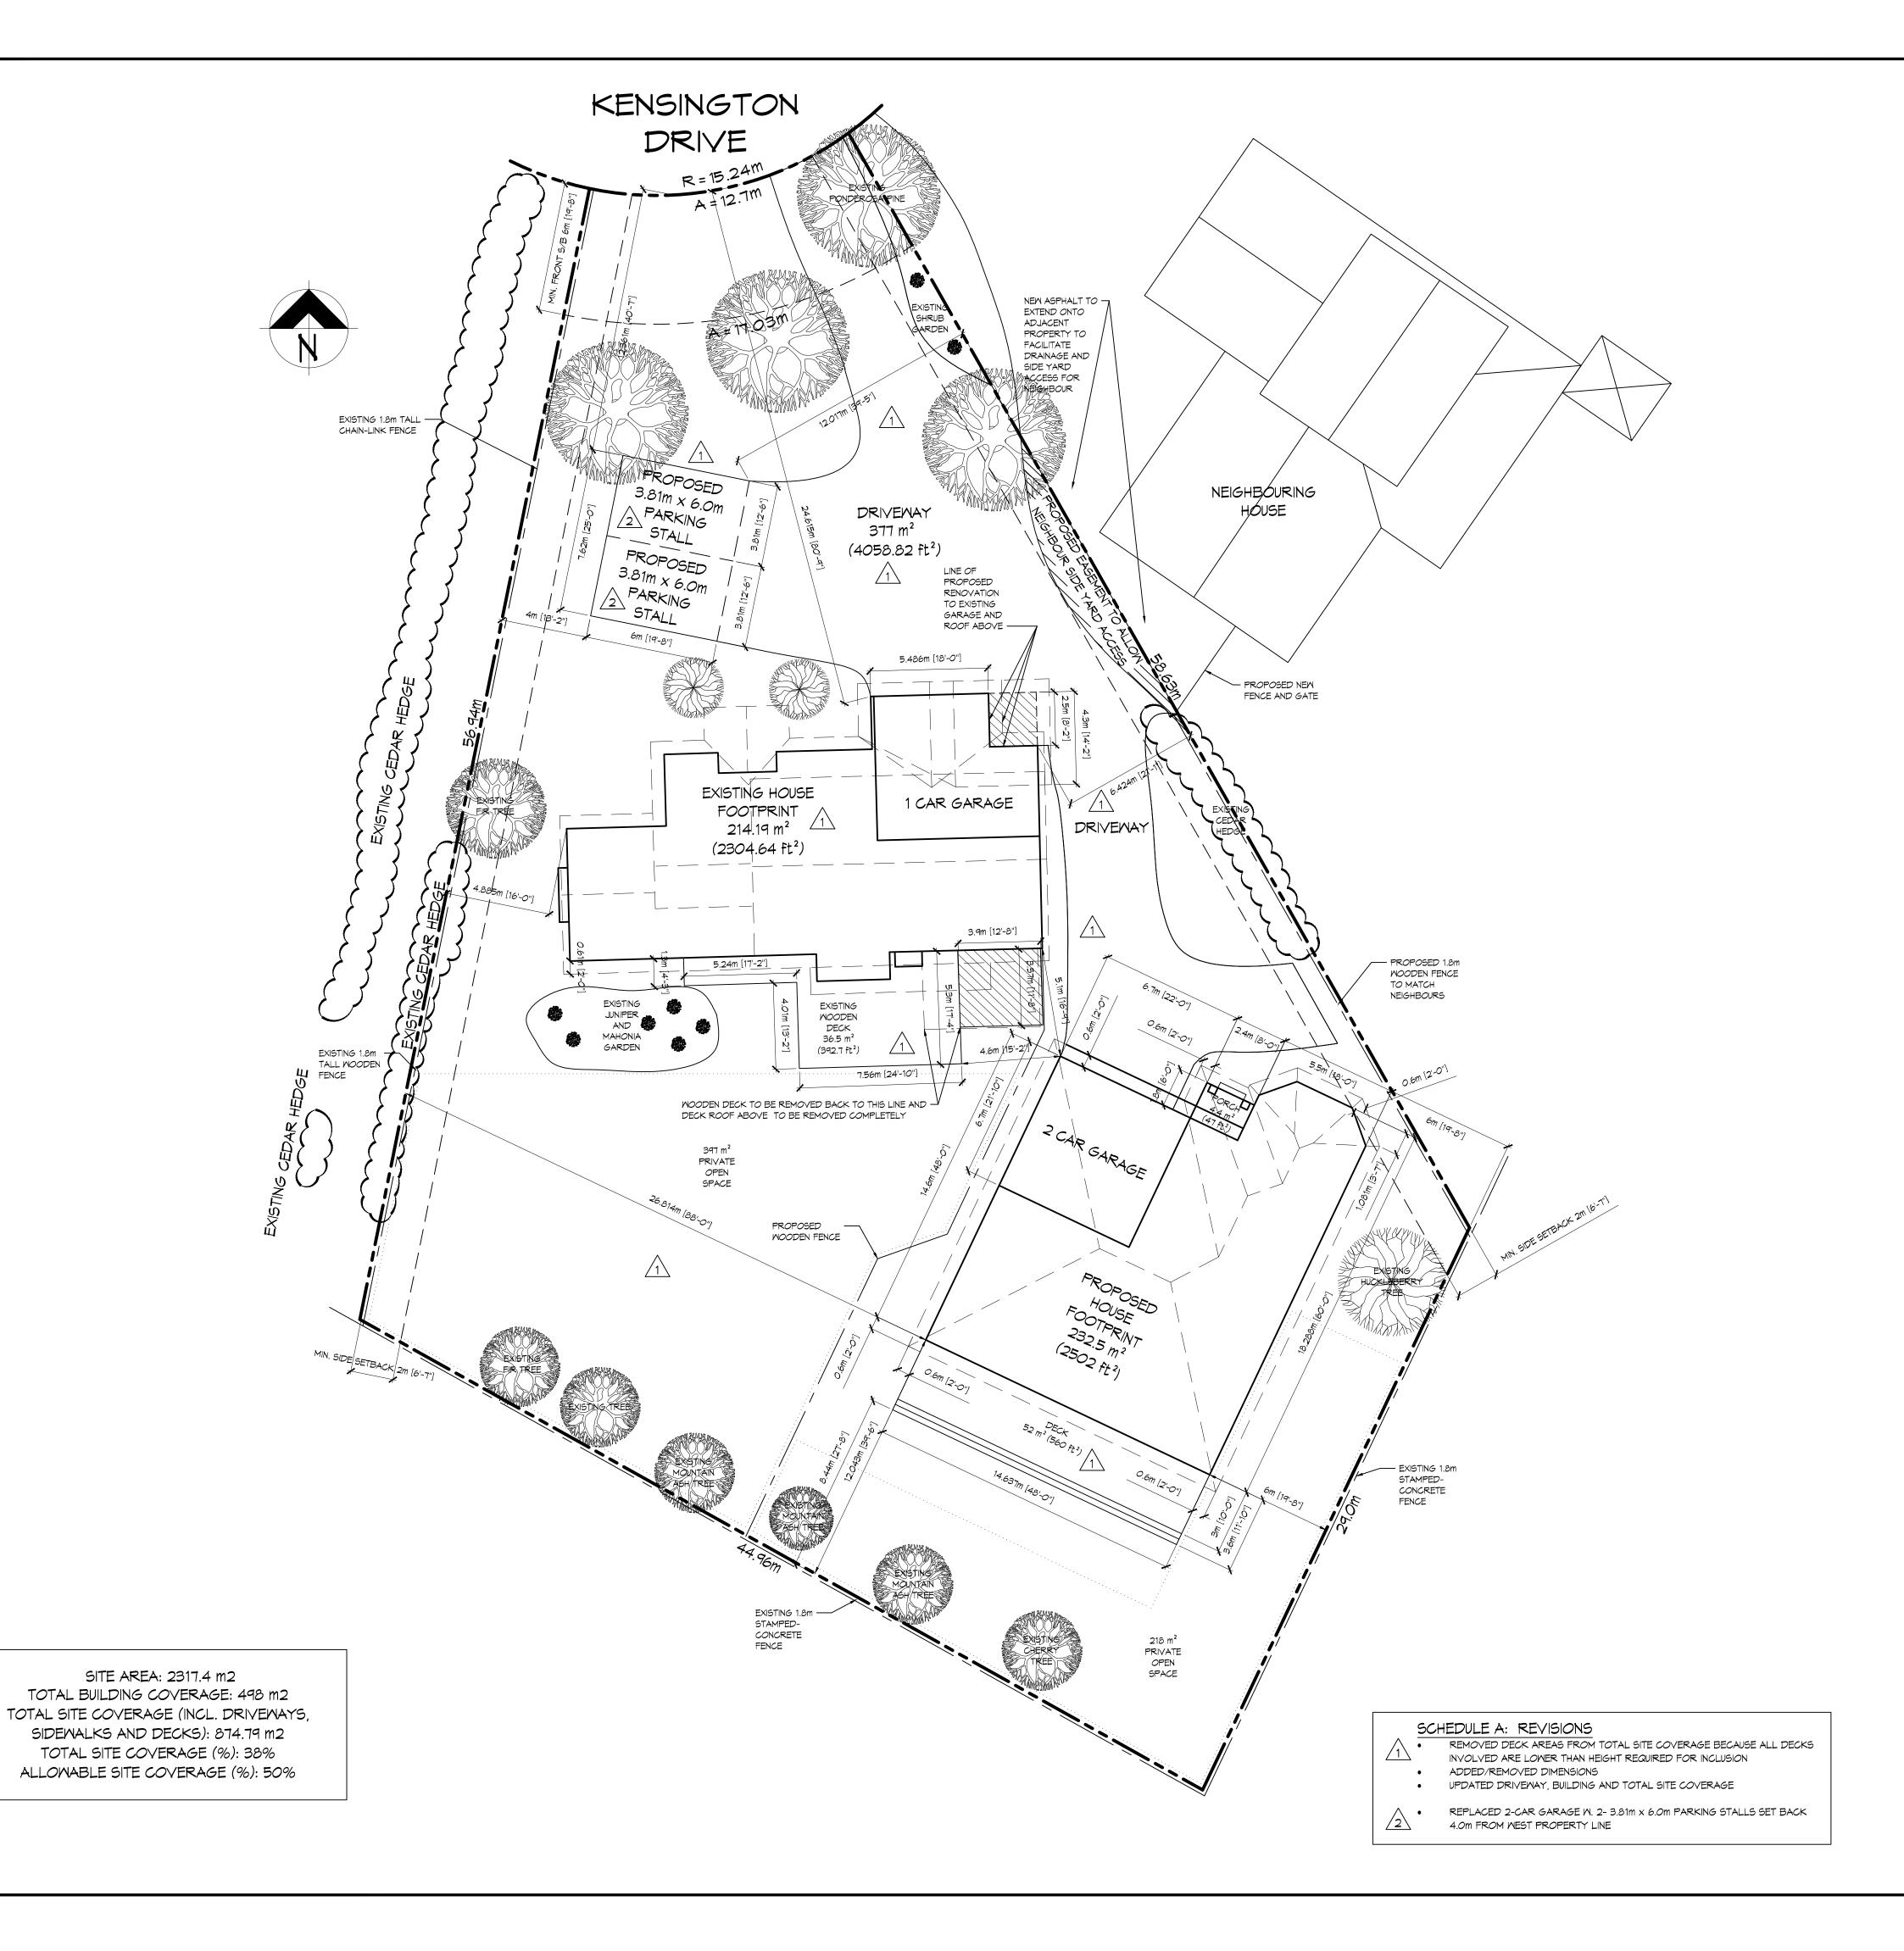

GENERAL NOTES

1. THESE PLANS HAVE BEEN DESIGNED AND DRAFTED IN ACCORDANCE WITH THE BRITISH COLUMBIA BUILDING CODE 2012 AND THE CANADIAN WOOD COUNCIL SPAN BOOK 2004 EDITION. ALL STRUCTURAL MEMBERS HAVE BEEN DESIGNED FOR A ROOF SNOW LOAD OF 2.5KPA. CONTRACTOR TO VERIFY LOCAL SNOW AND RAIN LOAD GUIDELINES PRIOR TO CONSTRUCTION.

2. IT IS THE RESPONSIBILITY OF THE BUILDING OWNER AND/OR BUILDER TO ENSURE CONSTRUCTION COMPLIES WITH APPLICABLE BUILDING CODES AND BYLAWS AND CONFORMS TO ACCEPTABLE BUILDING

3. ALL CONSTRUCTION, MATERIALS, AND EQUIPMENT SHALL BE INSTALLED IN ACCORDANCE WITH MANUFACTURER'S SPECIFICATIONS AND IN A TIMELY FASHION.

4. THE CONTRACTOR SHALL CHECK AND VERIFY ALL DIMENSIONS ON THE DRAWINGS AND ON THE BUILDING SITE BEFORE COMMENCING CONSTRUCTION.

5. IN THE EVENT OF A DISCREPANCY BETWEEN SCALED DIMENSIONS AND THOSE NOTED ON THE DRAWINGS, THE LATTER SHALL TAKE

6. LUMBER SPECIES AND GRADES TO BE AS FOLLOWS UNLESS NOTED

JOISTS, RAFTERS, STRINGERS, PLATES: DOUGLAS FIR #2 & BETTER. STUDS: D. FIR OR SPF STUD GRADE. POSTS, BEAMS AND LINTELS: #2 D. FIR OR BETTER. SILLS, SLEEPERS AND PLATES IN CONTACT WITH CONCRETE:

PRESSURE TREATED DOUGLAS FIR. FLOOR AND WALL SHEATHING TO BE MIN. 15.5MM U.N.O. ROOF SHEATHING TO BE MIN.12.5 U.N.O.

7. ALL LINTELS TO BE MINIMUM 2-38X235 UNLESS NOTED OTHERWISE, AND TO HAVE MINIMUM 35MM END BEARING.

8. SOLID BLOCKING REQUIRED BETWEEN JOISTS AND RAFTERS AT BEARING WALLS.

9.1 ROW OF CROSS BRIDGING SHALL BE PROVIDED MID-SPAN BETWEEN FLOOR JOISTS AT A SPACING NO GREATER THAN 2100MM AS PER BCBC 1998 9.23.9.4.

10. LEDGERS AND FOUNDATION SILL PLATES SHALL BE BOLTED TO CONCRETE FOUNDATION WITH 15.5MM DIAM. ANCHOR BOLTS @1220MM O/C UNLESS NOTED OTHERWISE.

11. NAILING SCHEDULE FOR FRAMING TO CONFORM TO NATIONAL STANDARDS.

12. ROOF VENTS SHALL BE PROVIDED TO A MINIMUM 1:300 OF THE INSULATED CEILING AREA. ROOF, GABLE AND/OR EAVE TYPE VENTS SHALL BE UNIFORMLY DISTRIBUTED ON OPPOSITE SIDES OF THE BUILDING AND AT TOP AND BOTTOM OF THE ATTIC SPACE. ALL VENTS SHALL BE DESIGNED TO PREVENT THE ENTRY OF INSECTS, SNOW, OR

13. MINIMUM 63MM CONTINUOUS AIRSPACE TO BE MAINTAINED TO ALLOW AIRFLOW FROM ROOF VENTS TO ATTIC SPACES.

14. CONTINUOUS ULTRA-VIOLET RESISTANT 6MM POLY VAPOUR BARRIER TO BE INSTALLED ON THE WARM SIDE OF INSULATION IN ALL EXTERIOR WALLS AND CEILINGS.

15. MINIMUM INSULATION REQUIREMENTS ARE AS FOLLOWS (CONTRACTOR TO VERIFY WITH LOCAL BUILDING CODES IF INSULATION SHOULD BE INCREASED OR DECREASED FROM THE FOLLOWING VALUES): ROOF JOISTS: R-32

ATTIC SPACES: R-40 FRAMED WALLS: R-20

SUSPENDED FRAMED FLOORS: R-28

SUSPENDED CONCRETE FLOORS: R-12 CONCRETE FOUNDATION WALLS: R-12 CONCRETE SLAB ON, GRADE: R-12

16. CRAWLSPACES, HEATED OR UNHEATED, SHALL BE NATURALLY VENTED TO A MINIMUM 1:500 OF THE FLOOR AREA. ALL VENTS SHALL BE UNIFORMLY DISTRIBUTED AND CONSTRUCTED TO PREVENT THE ENTRY OF INSECTS, SNOW OR RAIN.

17. ALL ATTIC AND CRAWL SPACES TO HAVE AN MINIMUM 500MM X 700MM ACCESS OPENING PROVIDED.

18. CONTRACTOR TO ENSURE PROPER INSTALLATION OF PLUMBING, HEATING, AND ELECTRICAL EQUIPMENT AND MATERIALS AS PER THE MANUFACTURER'S SPECIFICATIONS AND IN ACCORDANCE WITH THE

19. ALL STAIRS, LANDINGS, BALCONIES, AND PORCHES HIGHER THAN 600MM (OR 2 RISERS) ABOVE GROUND SHALL BE PROTECTED WITH GUARDS AT ALL OPEN SIDES. GUARDS SHALL BE DESIGNED TO PREVENT CLIMBING AND HAVE NO OPENING GREATER THAN 100MM. INTERIOR GUARD HEIGHT SHALL BE MINIMUM 900MM AND EXTERIOR GUARD HEIGHT SHALL BE MINIMUM 1070MM.

20. ALL WINDOWS SHALL BE DOUBLE GLAZED OR INSULATED GLASS. 21. BEDROOM EGRESS: PROVIDE MINIMUM NET CLEAR OPENING OF 0.32 METERS SQUARED AND NO DIMENSION LESS THAN 380MM. MAXIMUM HEIGHT OF WINDOW FROM SUBFLOOR TO FINISHED WINDOW SILL TO BE

22. ALL CERAMIC WALL TILE INSTALLED IN AREAS PRONE TO WATER AND/OR PHYSICAL IMPACT TO BE UNDERLAID WITH 12.7MM REINFORCED CONCRETE BACKER BOARD.

23. EXHAUST FANS, RANGE HOOD, AND CLOTHES DRYER TO VENT OUTSIDE VIA METAL DUCTS. EXHAUST VENTILATION RATE: BATHROOM - 25 L/S (50 CFM) KITCHEN - 40 L/S

24. SMOKE DETECTORS SHOULD BE CONNECTED TO THE RESIDENCE POWER SOURCE (110V).

25. CLIMATIC DATA FOR THE DESIGN OF BUILDINGS IN KELOWNA:

GROUND SNOW LOAD SR 0.1kPa HOURLY WIND PRESSURES 1/10 0.34kPa 1/30 0.43kPa

1/100 0.53kPa 600MM FROST DEPTH

26. SPECIFIED SNOW LOAD: (0.8 X 1.8KPA + 0.1 KPA) = 1.5KPA

LEGAL DESCRIPTION

4377 KENSINGTON DRIVE LOT 21, DL 167, PLAN 27559




CADD Services 1371 ORCHARD DRIVE.

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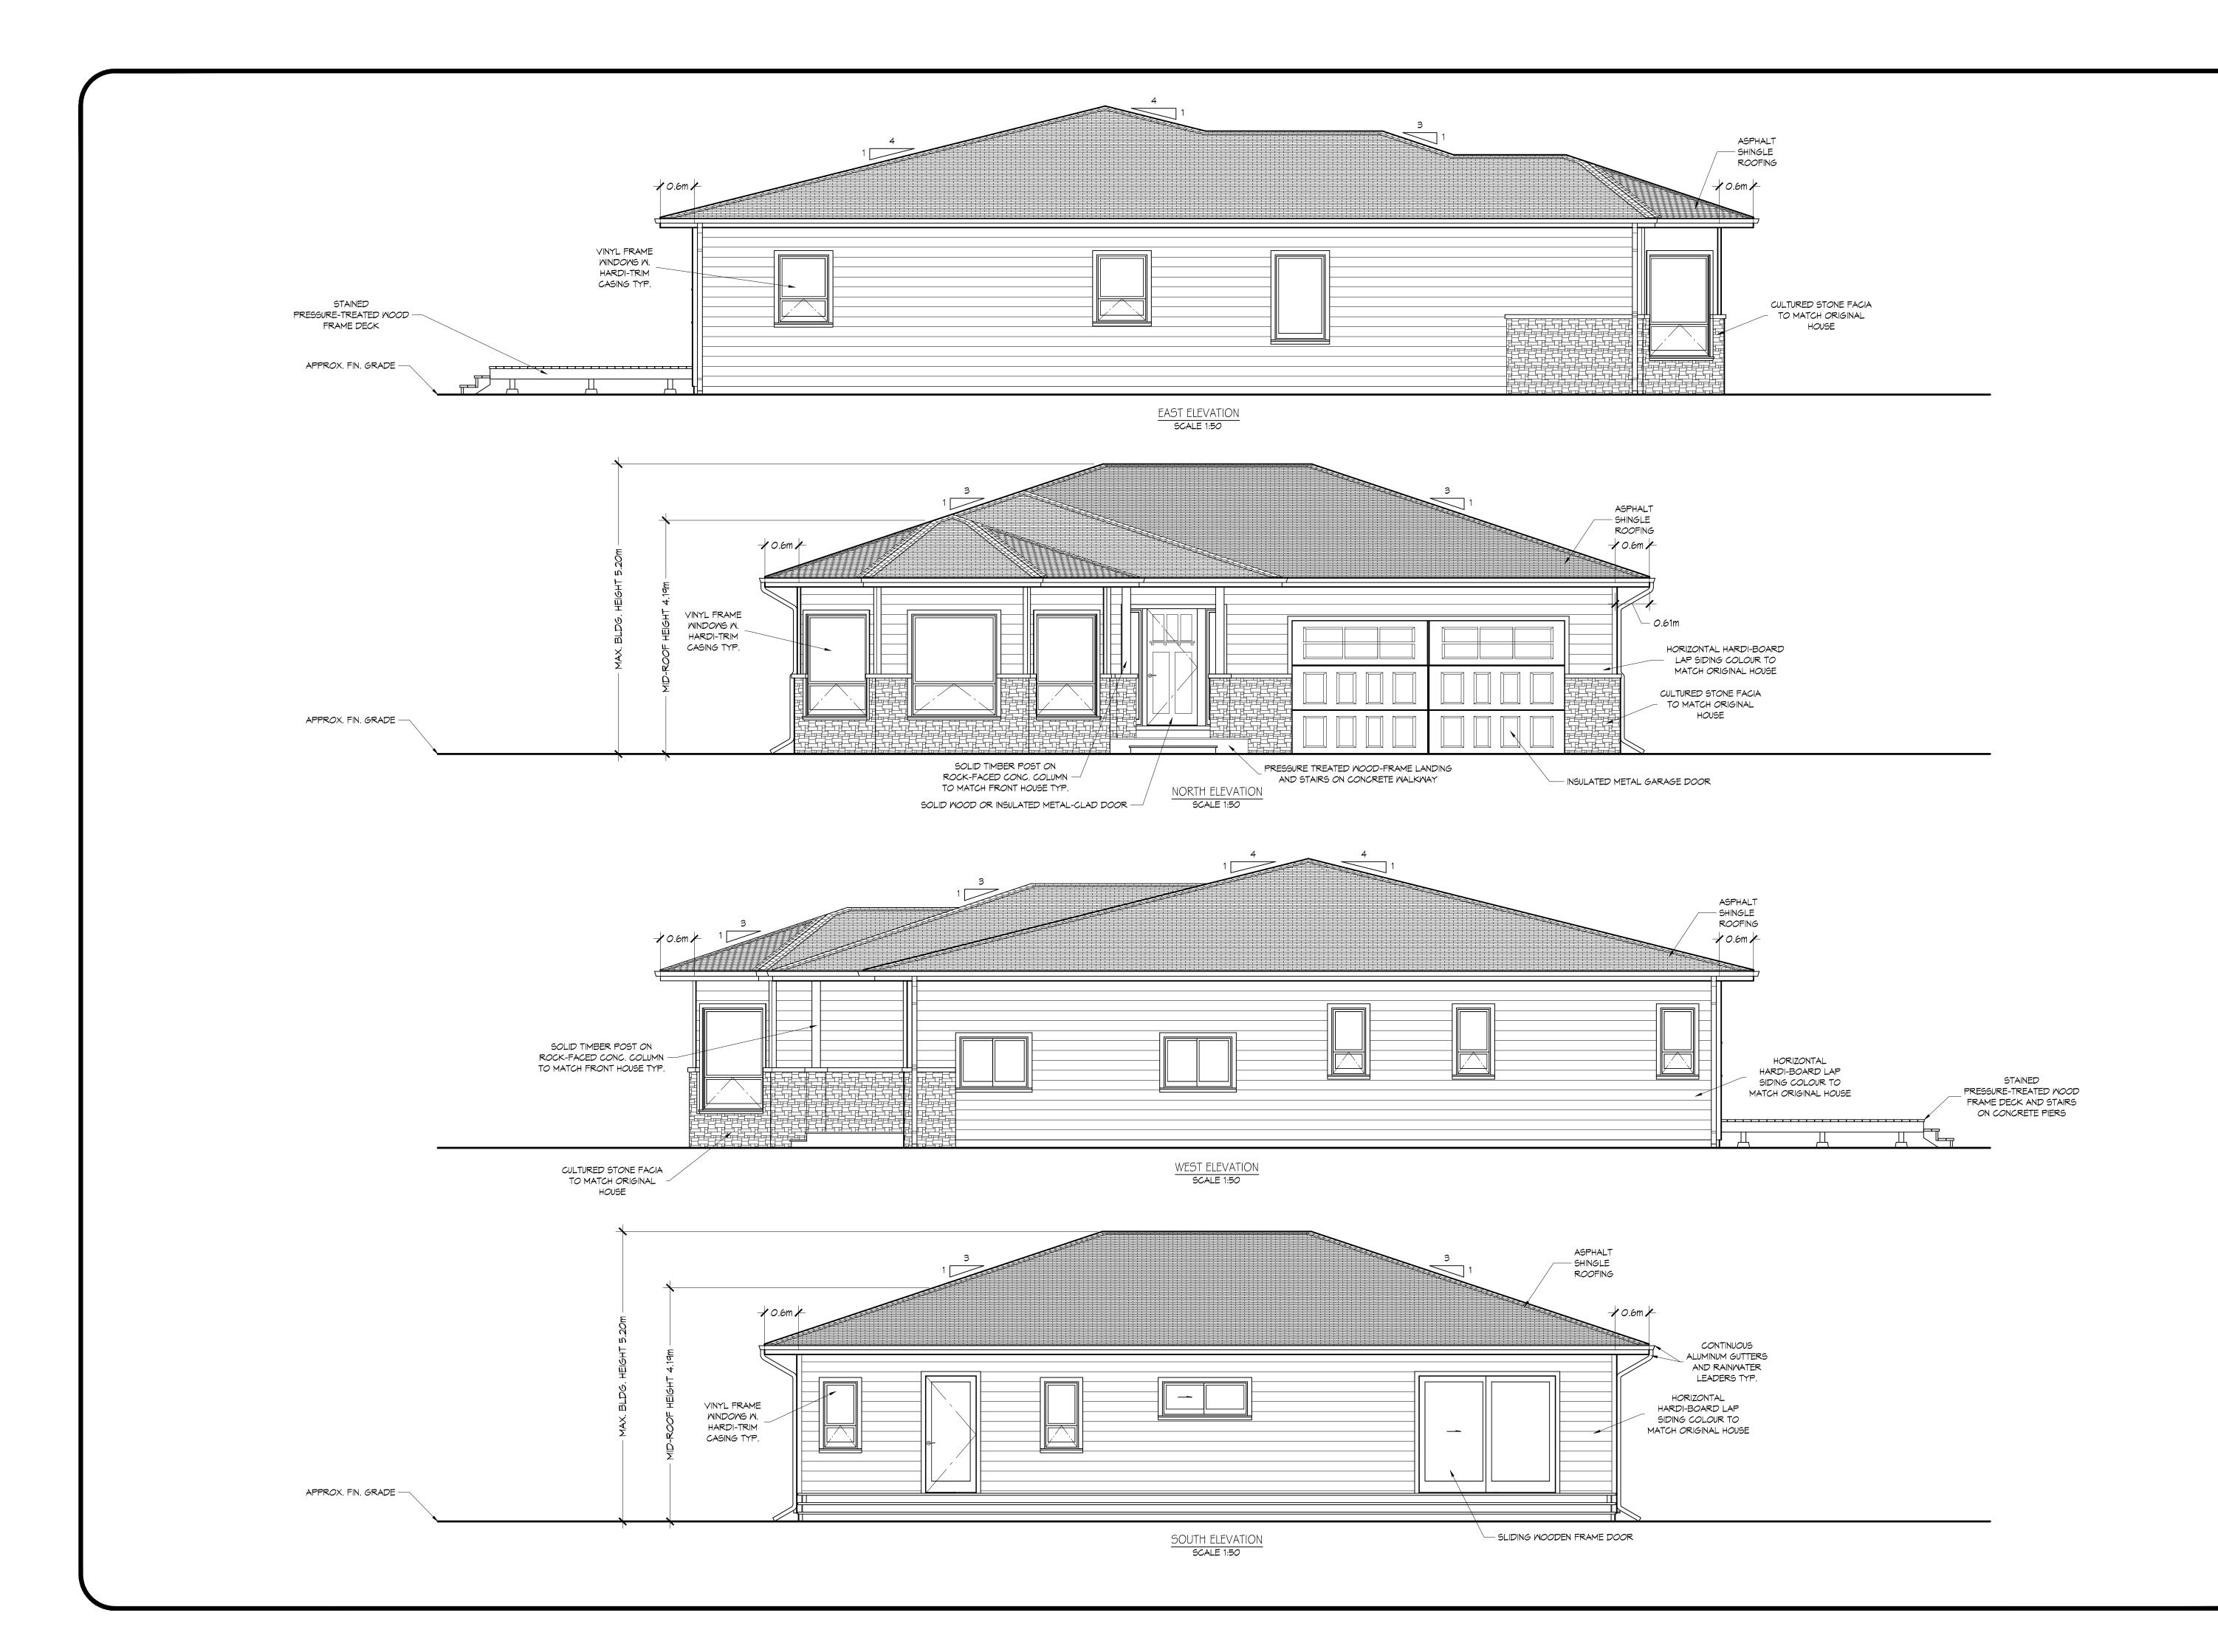
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CADD

Services

1371 ORCHARD DRIVE,
KELOWNA, B.C. VIY 3V1

	PH. (778) 215-0967	
No.	REVISIONS	DATE

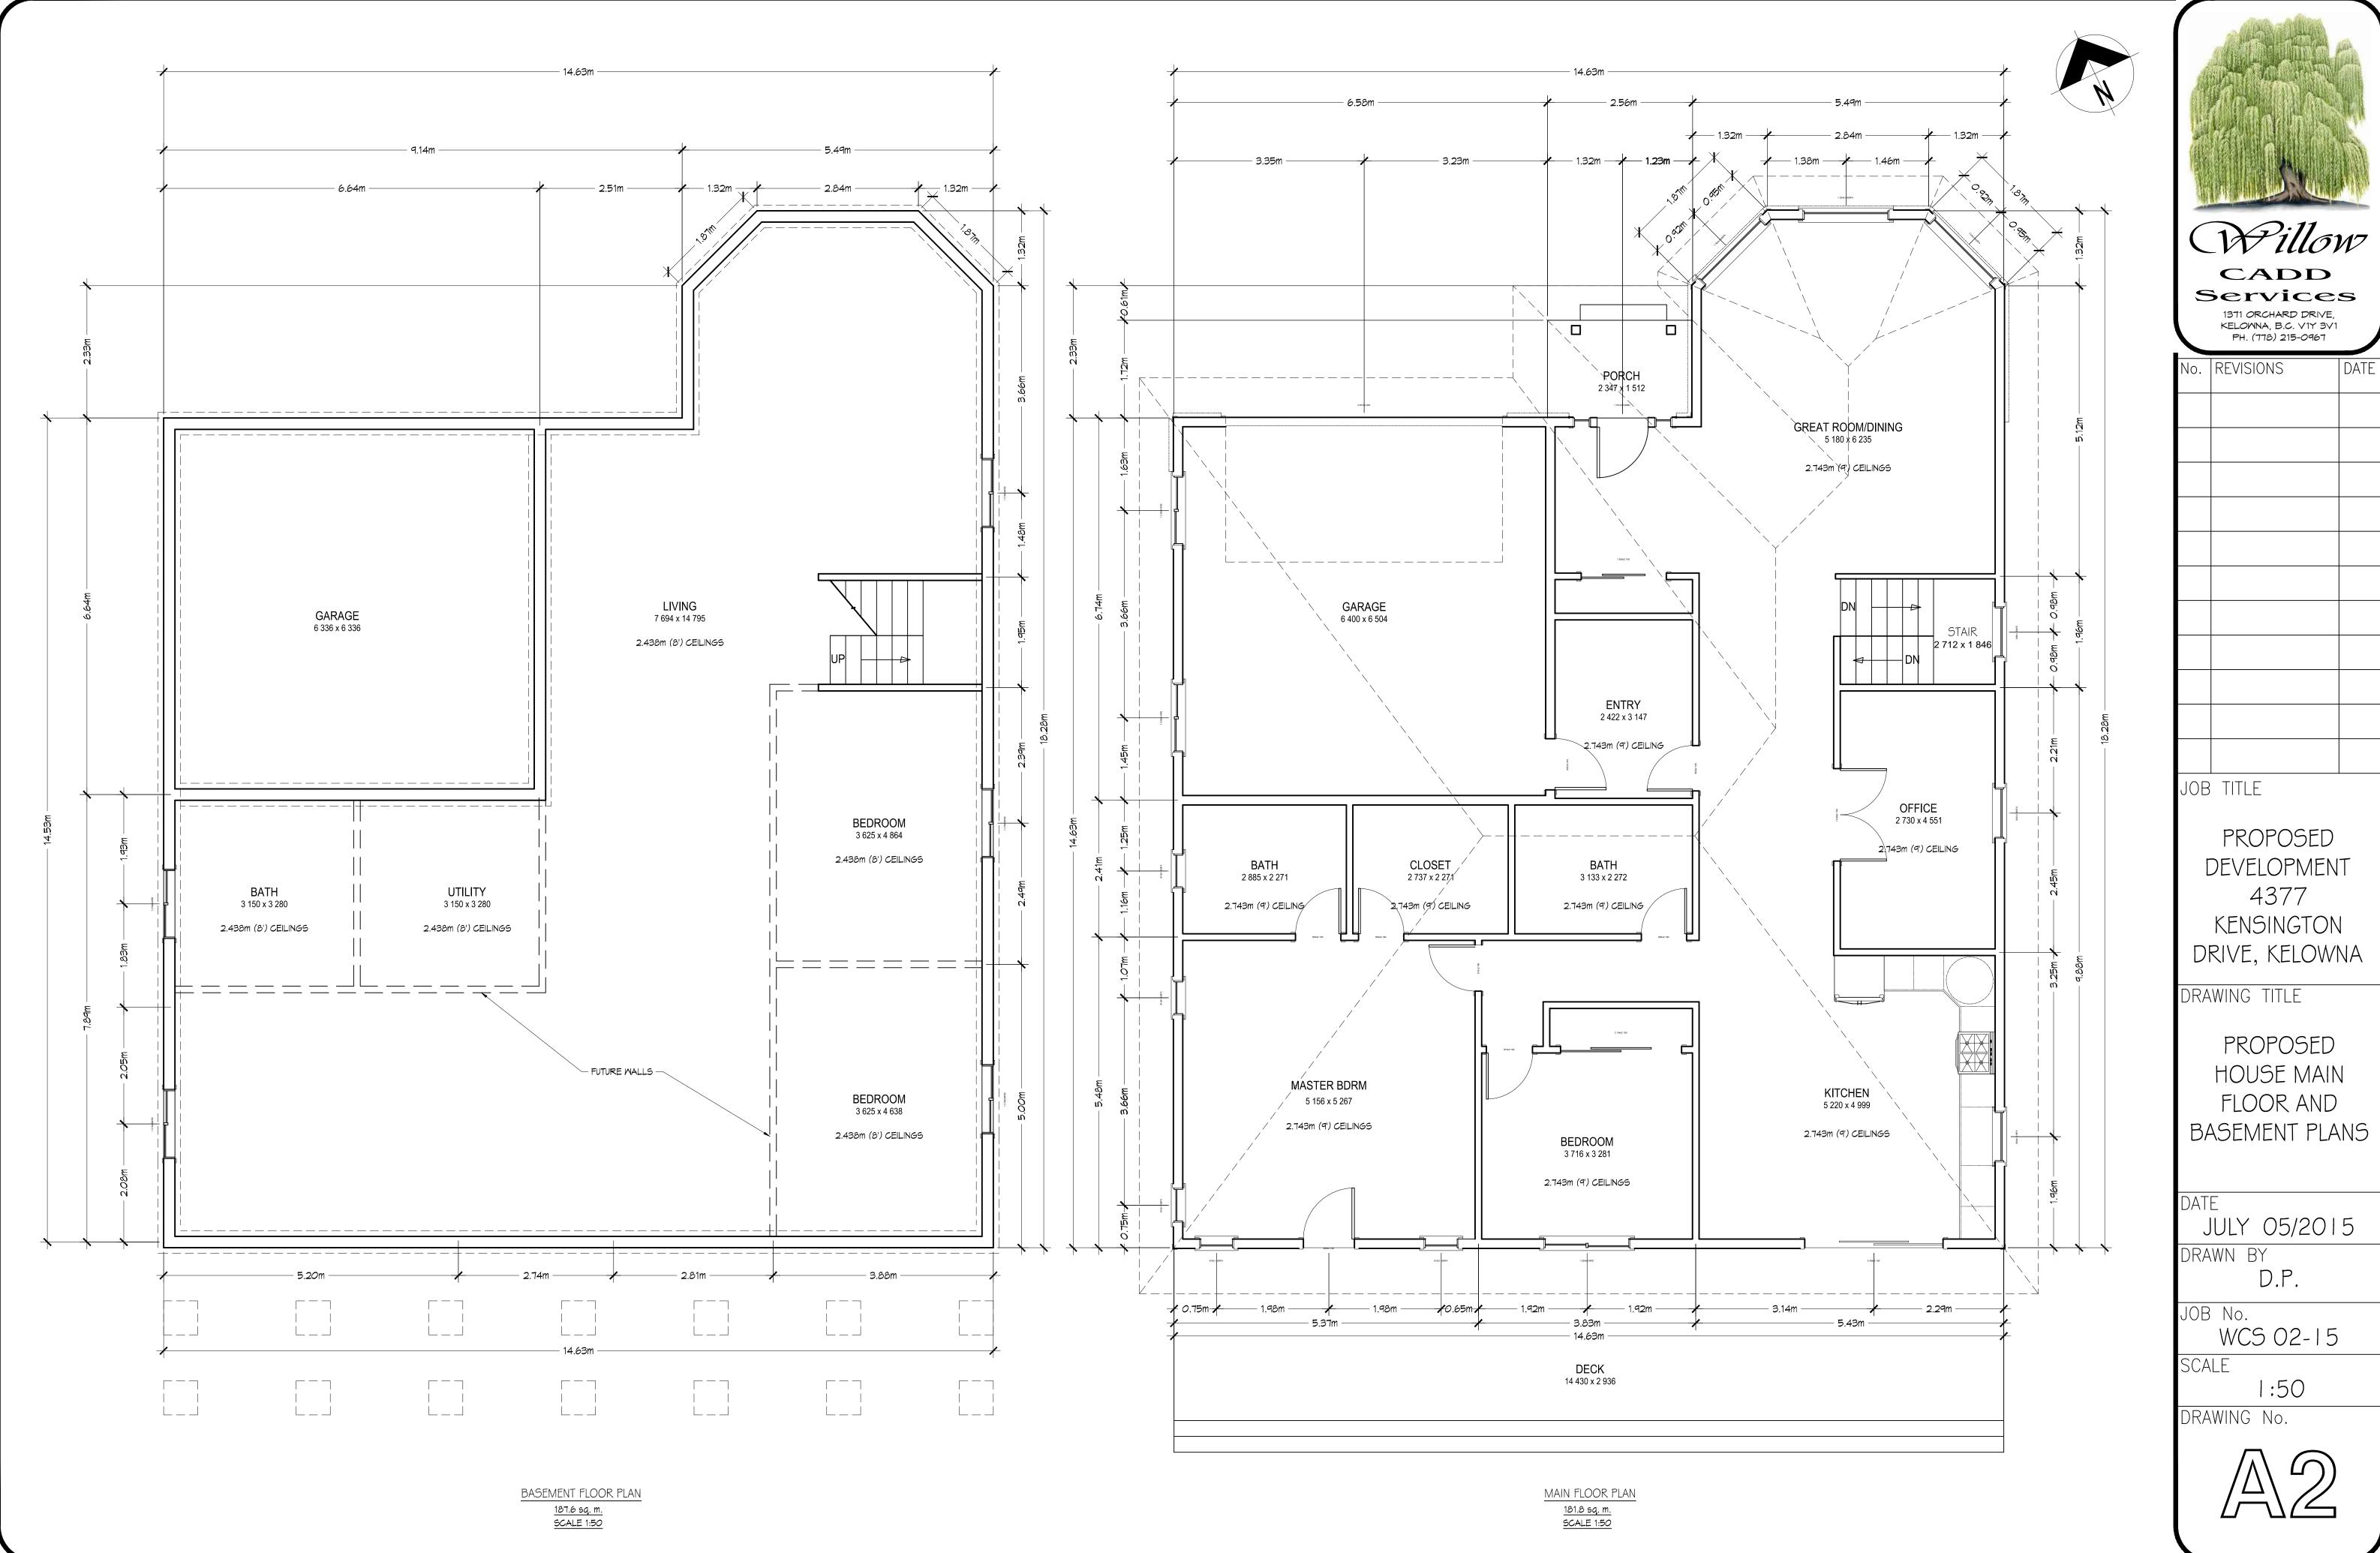JOB TITLE

PROPOSED
DEVELOPMENT
4377
KENSINGTON
DRIVE, KELOWNA

DRAWING TITLE

PROPOSED HOUSE ELEVATIONS

DATE
MARCH 18/2015


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Services

1371 ORCHARD DRIVE,
KELOWNA, B.C. V1Y 3V1

	PH. (778) 215-0967	
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JOB TITL

PROPOSED
DEVELOPMENT
4377
KENSINGTON
DRIVE, KELOWNA

DRAWING TITLE

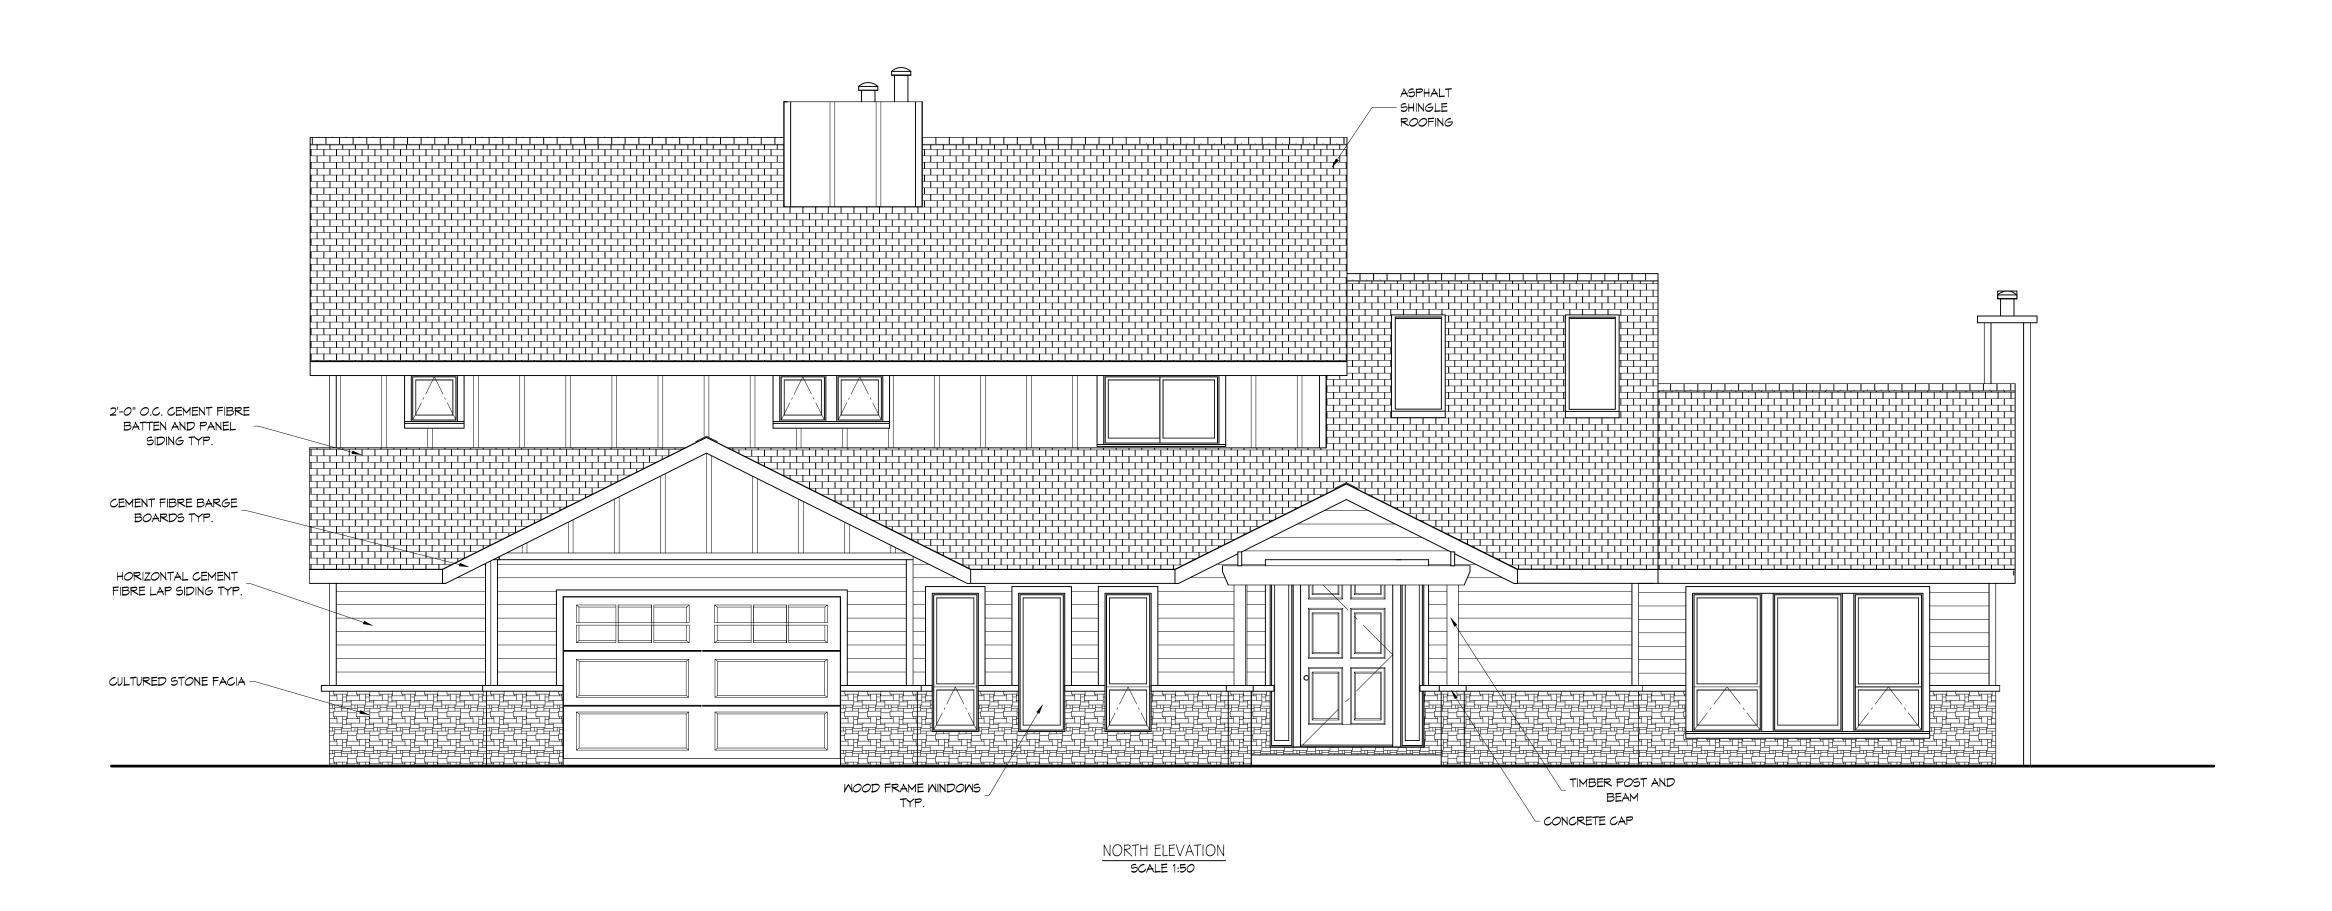EXISTING HOUSE NORTH AND SOUTH ELEVATIONS

DATE II

JULY 5/2015

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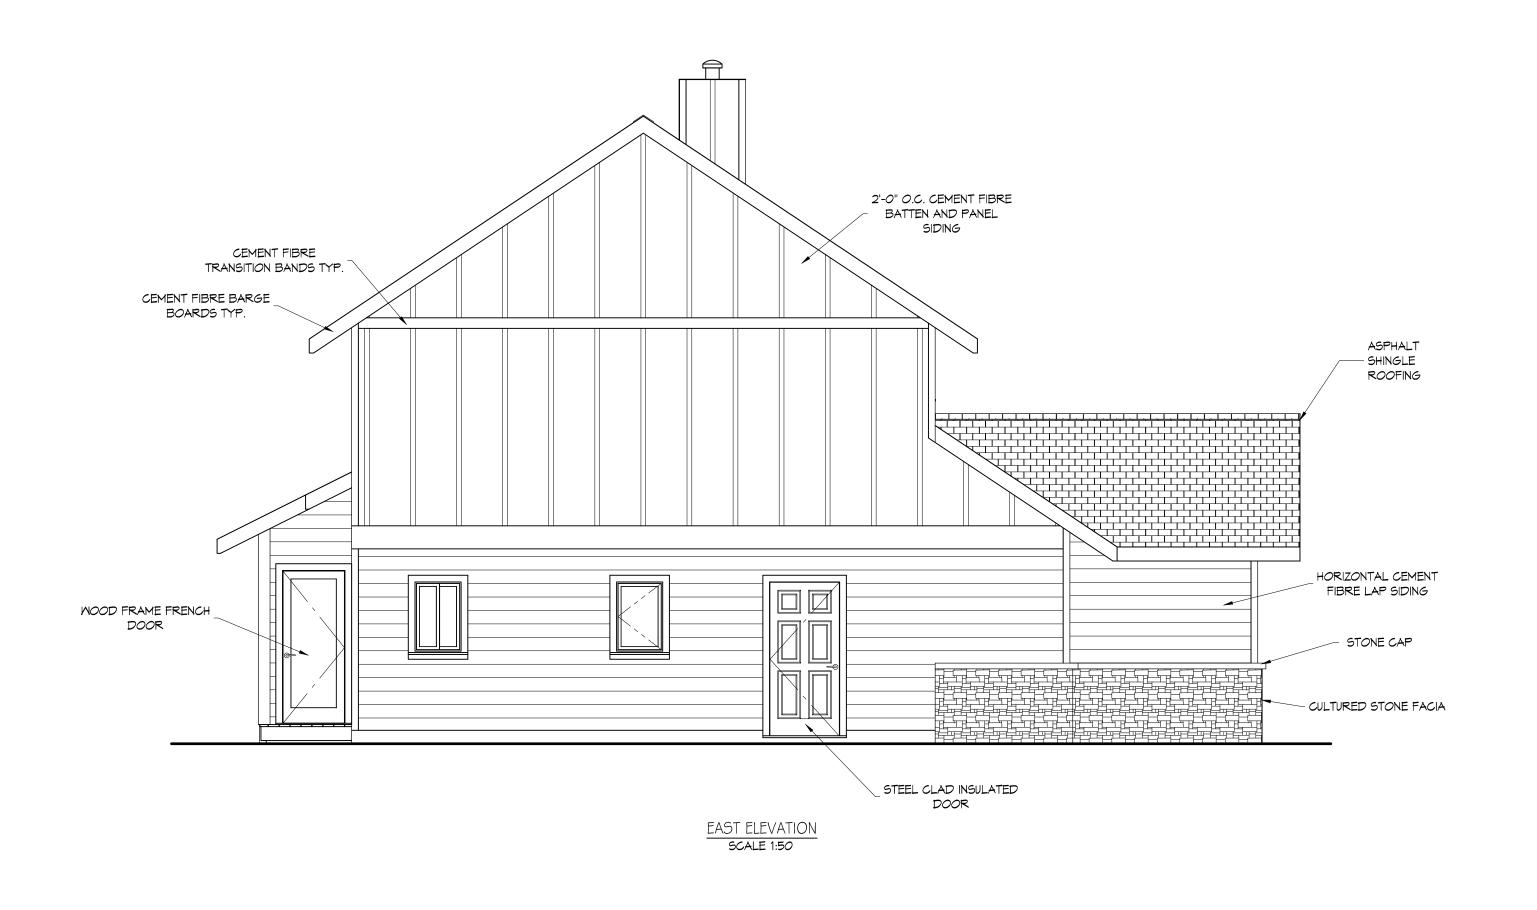
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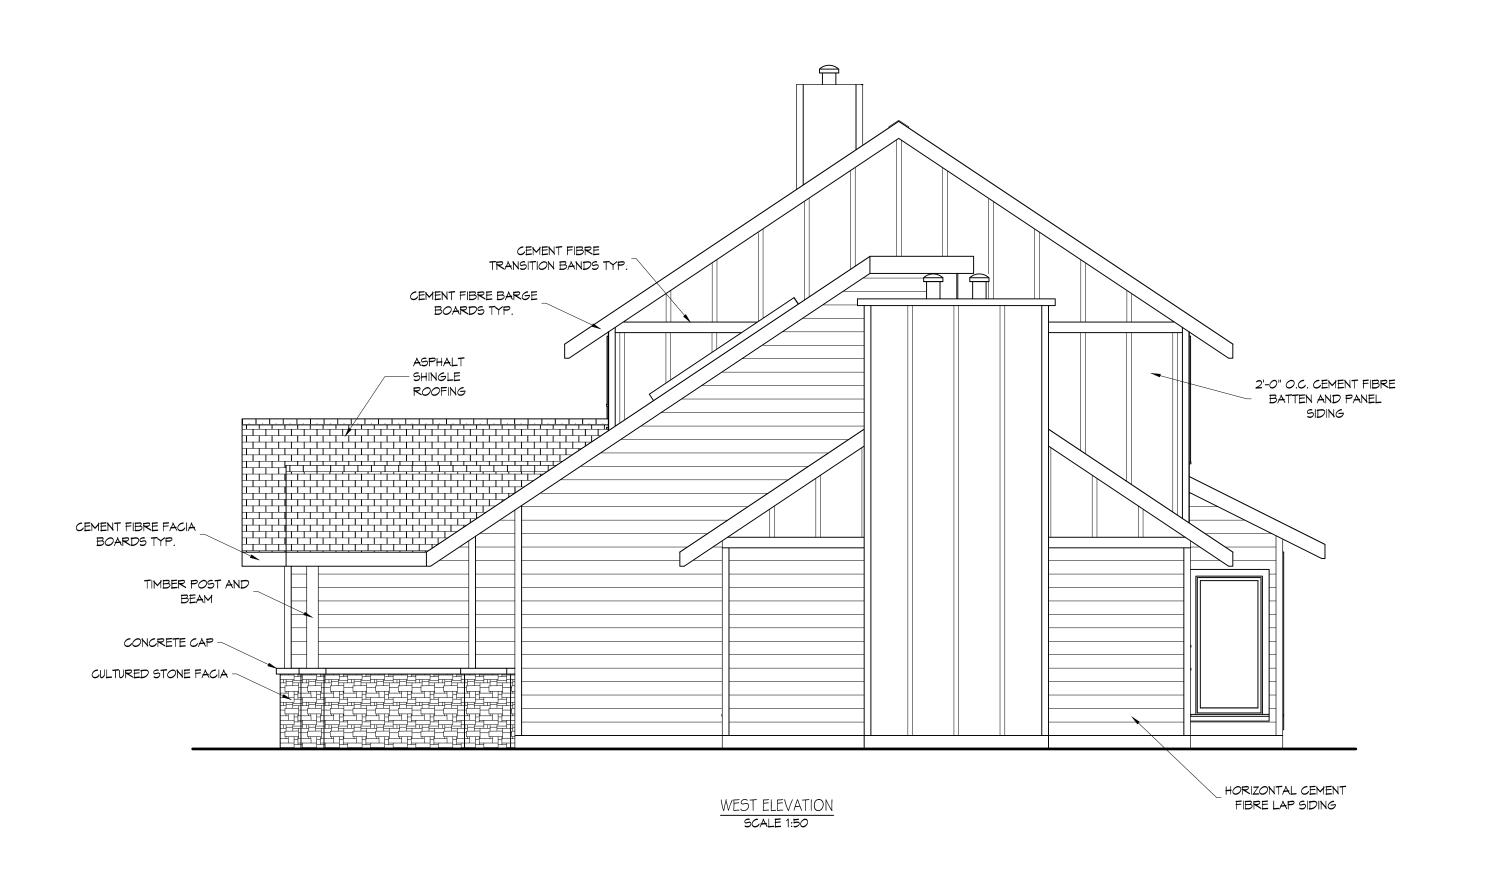
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Services

1371 ORCHARD DRIVE,

KELOWNA, B.C. V1Y 3V1

PH. (778) 215-0967

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PROPOSED
DEVELOPMENT
4377
KENSINGTON
DRIVE, KELOWNA

DRAWING TITLE

EXISTING HOUSE EAST AND WEST ELEVATIONS

DATE
JULY 5/2015

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D.P.

JOB No.
WCS 02-15

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BRITISH COLUMBIA LAND SURVEYOR'S SITE PLAN SHOWING EXISTING HOUSE ON LOT 21, DISTRICT LOT 167, ODYD, PLAN 27559.

PID: 004-795-130 CIVIC ADDRESS: 4377 Kensington Drive CLIENT: Lupul


Lot dimensions shown are derived from Land Title Office records.

Scale 1:500 Metric. Distances shown are in metres and decimals thereof.

This plan is based upon a field survey completed on March 31, 2016.

Denotes Iron Post found

NF Denotes nothing found

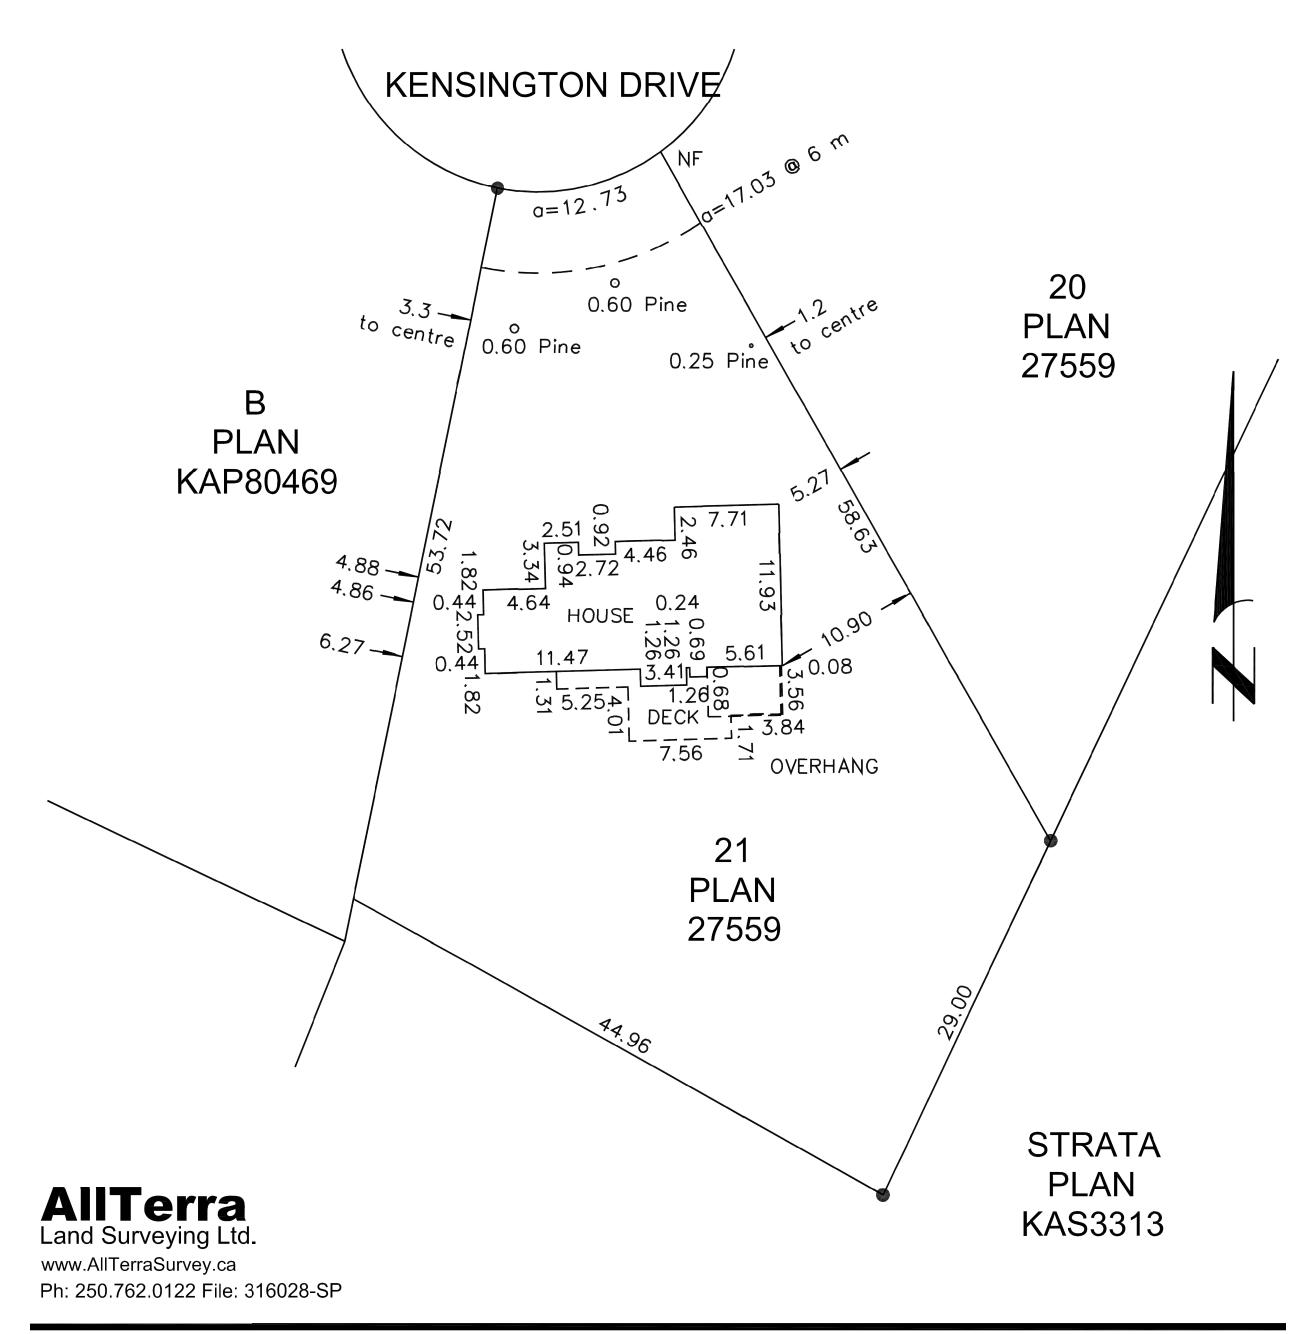







BALDERSTON LANDSCAPE ARCHITECTURE LTD. 716 LAWSON AVENUE, SUITE A KELOWNA, BC V1Y 6S8 t: 1.250.860.2974

e: elizabeth@blastudio.ca

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SURVEY INFORMATION
PREPARED BY: AllTerra Land Surveying Ltd.
COORDINATE SYSTEM:
COMPILATION DATE: 2016/04/06

SEAL

NO.	DATE	ISSUE/REVISION	AP
1	2016.07.25	DEVELOPMENT PERMIT	GL

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4377 KENSINGTON DRIVE

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EXISTING CONDITIONS




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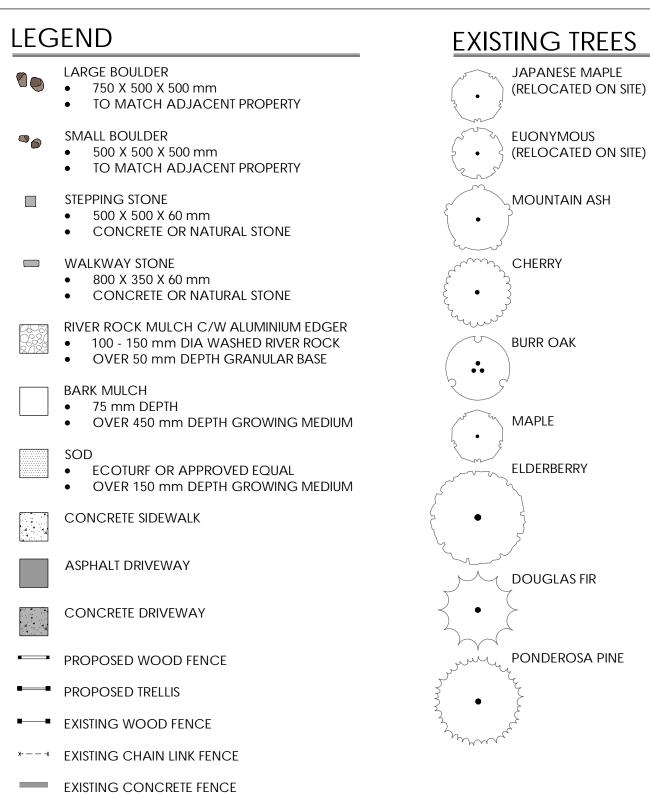
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1 of 4





FROM ADJACENT DEVELOPMENT

DIRECTION OF SURFACE DRAINAGE

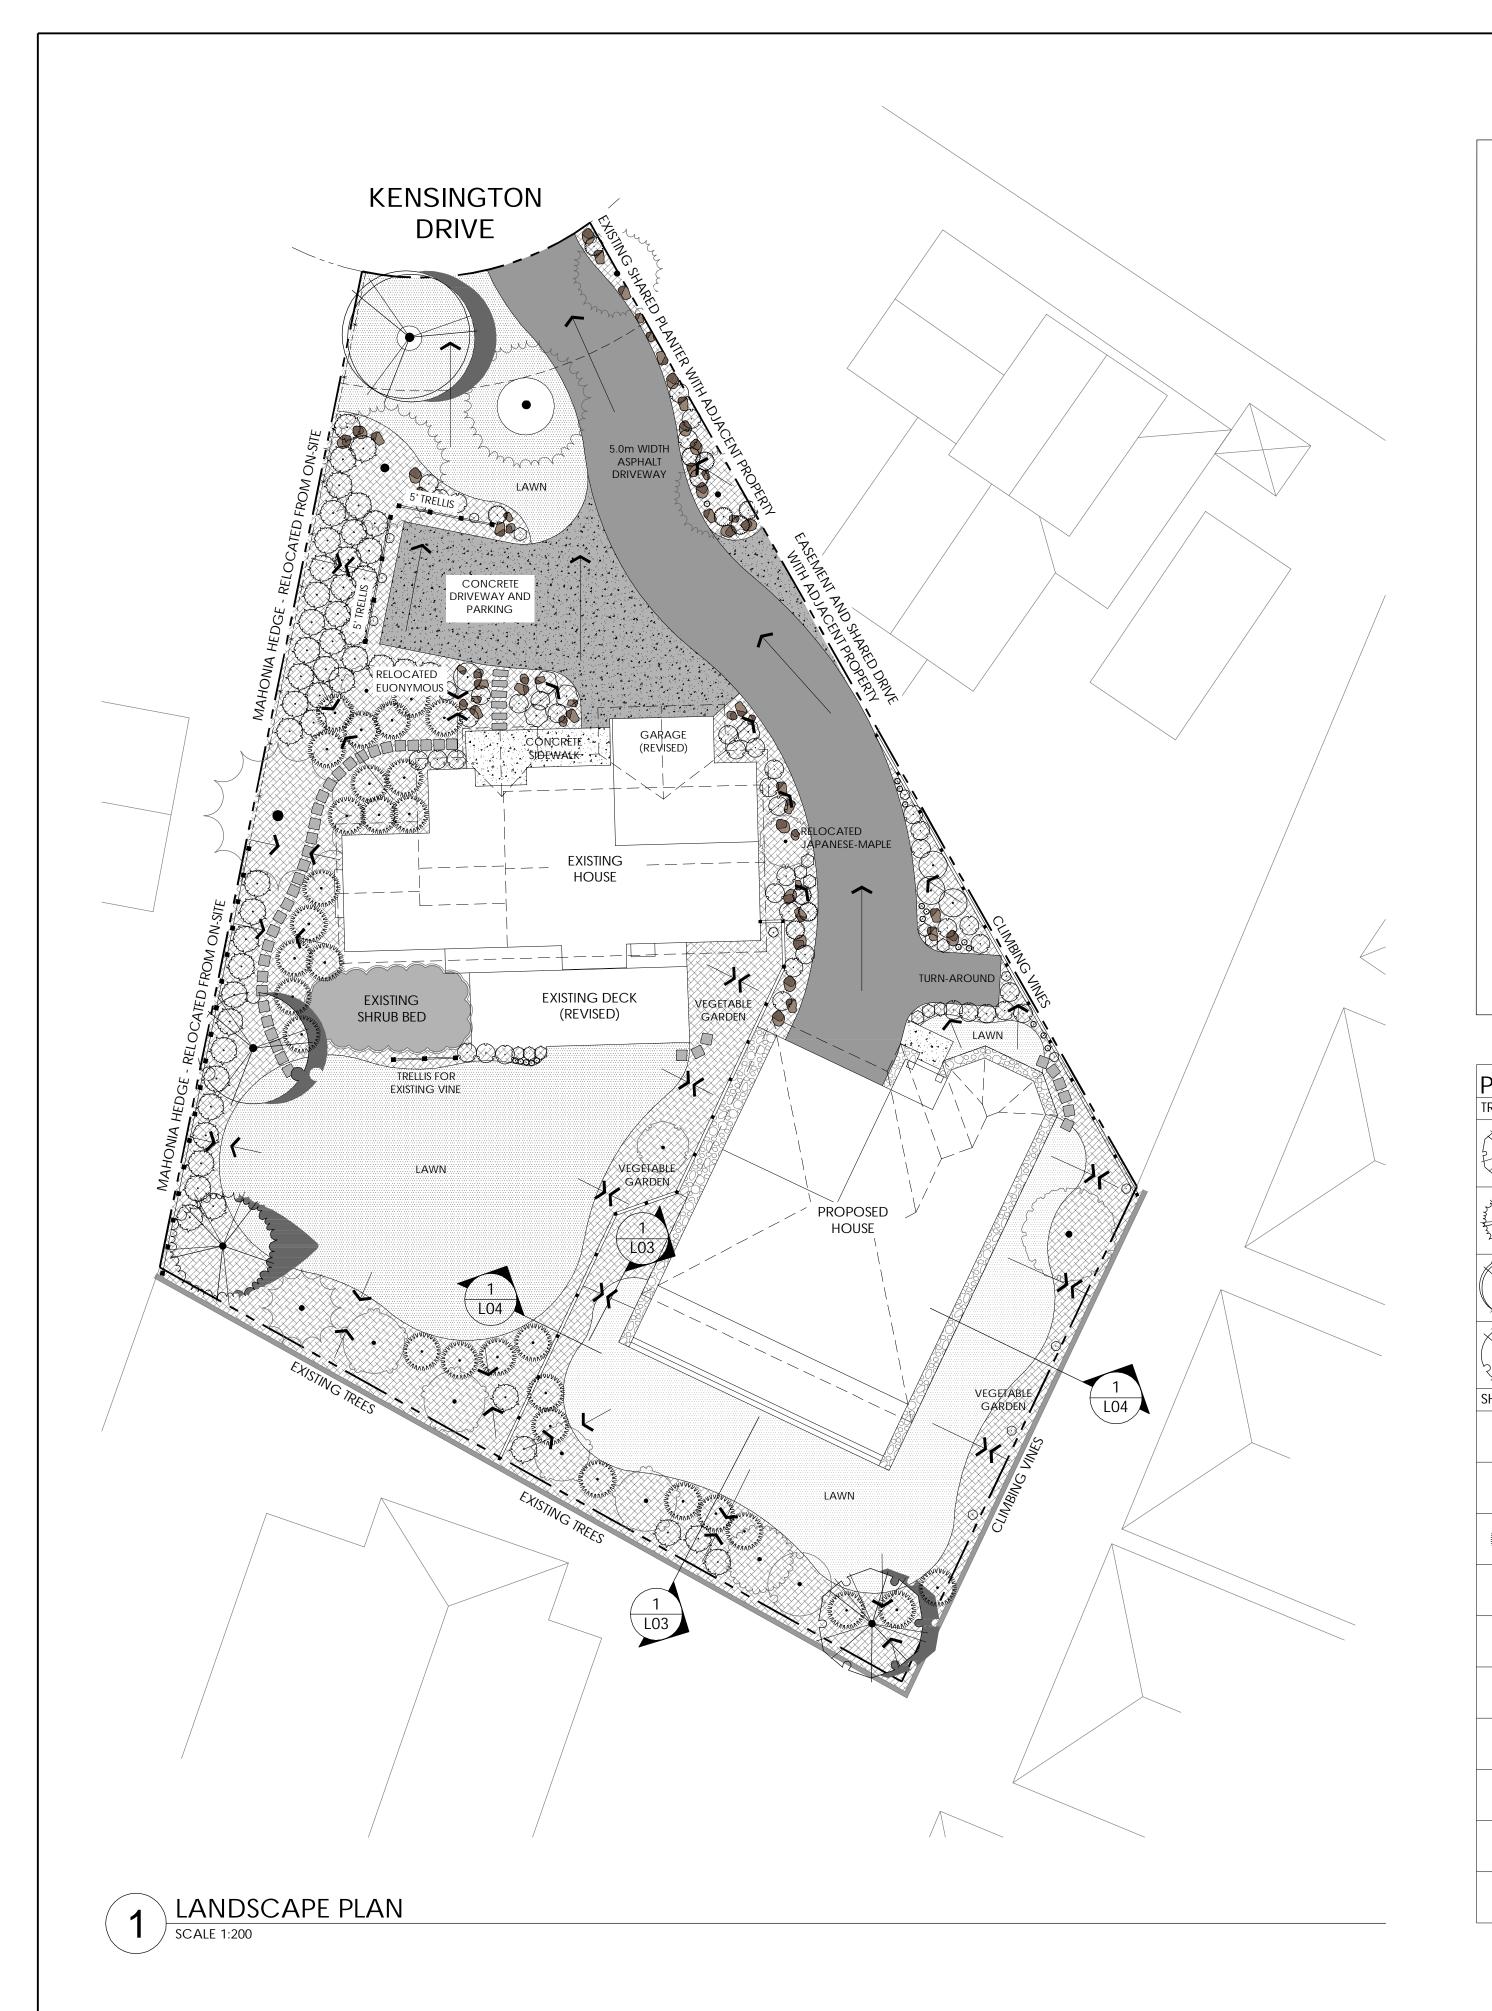• MIN. 2 % - MAX 30 % LANDSCAPE SURFACES

PLANTING NOTES:

- 1. KELOWNA PLANT HARDINESS ZONE 6a
- 2. ALL PLANTS IN PLANT LIST ARE LOW TO MODERATE WATER USE
- 3. ALL PLANT MATERIAL SHOWN AT 3/4 MATURE PLANT WIDTH
- 4. TREES AND SHRUBS TO BE PLANTED AS PER CITY OF KELOWNA STANDARD TREE AND SHRUB PLANTING DETAILS

NOTES:

- SEE BUILDING PLANS FOR DIMENSIONED SITE LAYOUT PLAN AND FENCE DETAILS TIMED IRRIGATION WILL BE PROVIDED FOR EACH SEPARATE STRATA LOT TO COVER THE PLANTING ON THAT LOT
- SITE LIGHTING WILL CONSIST OF FRONT AND BACK PORCH LIGHTS ON EACH UNIT AND LIGHTS ON THE GARAGE ENTRIES; A PHOTO SENSITIVE LIGHT WILL BE LOCATED ON THE SIDE OF THE WEST HOUSE GARAGE NEXT TO THE DRIVEWAY

EES	QTY	BOTANICAL NAME / COMMON NAME	CONT	CAL	SIZE	REMARKS	VERY LOW	LOW	MEDIUM
	1	ACER X FREEMANII `JEFFSRED` / AUTUMN BLAZE MAPLE	B@B	60 MM					X
7	1	PINUS PONDEROSA / PONDEROSA PINE	B@B		3.0M HT			X	
	1	QUERCUS MACDANIELLI `CLEMONS` TM / HERITAGE OAK	B@B	60 MM					X
	1	QUERCUS MACROCARPA / BURR OAK	B@B	60 MM			Х		
RUBS	QTY	BOTANICAL NAME / COMMON NAME	CONT			REMARKS	VERY LOW	LOW	MEDIUM
(·)	39	CALAMAGROSTIS X ACUTIFLORA `KARL FOERSTER` / FEATHER REED GRASS	#2 CONT				Х	X	X
\odot	4	EUONYMUS ALATUS `COMPACTUS` / COMPACT BURNING BUSH	#3 CONT						X
NANANA NA	30	JUNIPERUS SABINA / SAVIN JUNIPER				RELOCATED FROM ON-SITE		X	X
\bigcirc	10	LAVANDULA ANGUSTIFOLIA 'HIDCOTE BLUE' / HIDCOTE BLUE LAVENDER				RELOCATED FROM ON-SITE		X	
\bigcirc	41	MAHONIA AQUIFOLIUM / OREGON GRAPE				RELOCATED FROM ON-SITE		X	
\odot	8	PARTHENOCISSUS QUINQUEFOLIA / VIRGINA CREEPER	#1 CONT						X
()	11	PENNISETUM ALOPECUROIDES / FOUNTAIN GRASS	#2 CONT				X		
Exercise Services	13	PEROVSKIA ATRIPLICIFOLIA `LITTLE SPIRE` TM / LITTLE SPIRE RUSSIAN SAGE	#2 CONT					X	
$\overline{\cdot}$	4	ROSA X `NEARLY WILD` / NEARLY WILD ROSE	#3 CONT					X	
\odot	3	WISTERIA MACROSTACHYA `BLUE MOON` / WISTERIA	#1 CONT					X	X
			1		1		1	1	1



BALDERSTON LANDSCAPE ARCHITECTURE LTD. 716 LAWSON AVENUE, SUITE A KELOWNA, BC V1Y 6S8 t: 1.250.860.2974

e: elizabeth@blastudio.ca

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SURVEY INFORMATION PREPARED BY: AllTerra Land Surveying Ltd.
COORDINATE SYSTEM: COMPILATION DATE: 2016/04/06

NO.	DATE	ISSUE/REVISION	APP
1	2016.07.20	DEVELOPMENT PERMIT	GL
2	2016.07.25	DEVELOPMENT PERMIT	GL

PROJECT/CLIENT

4377 KENSINGTON DRIVE

LUPUL PROPERTIES LTD.

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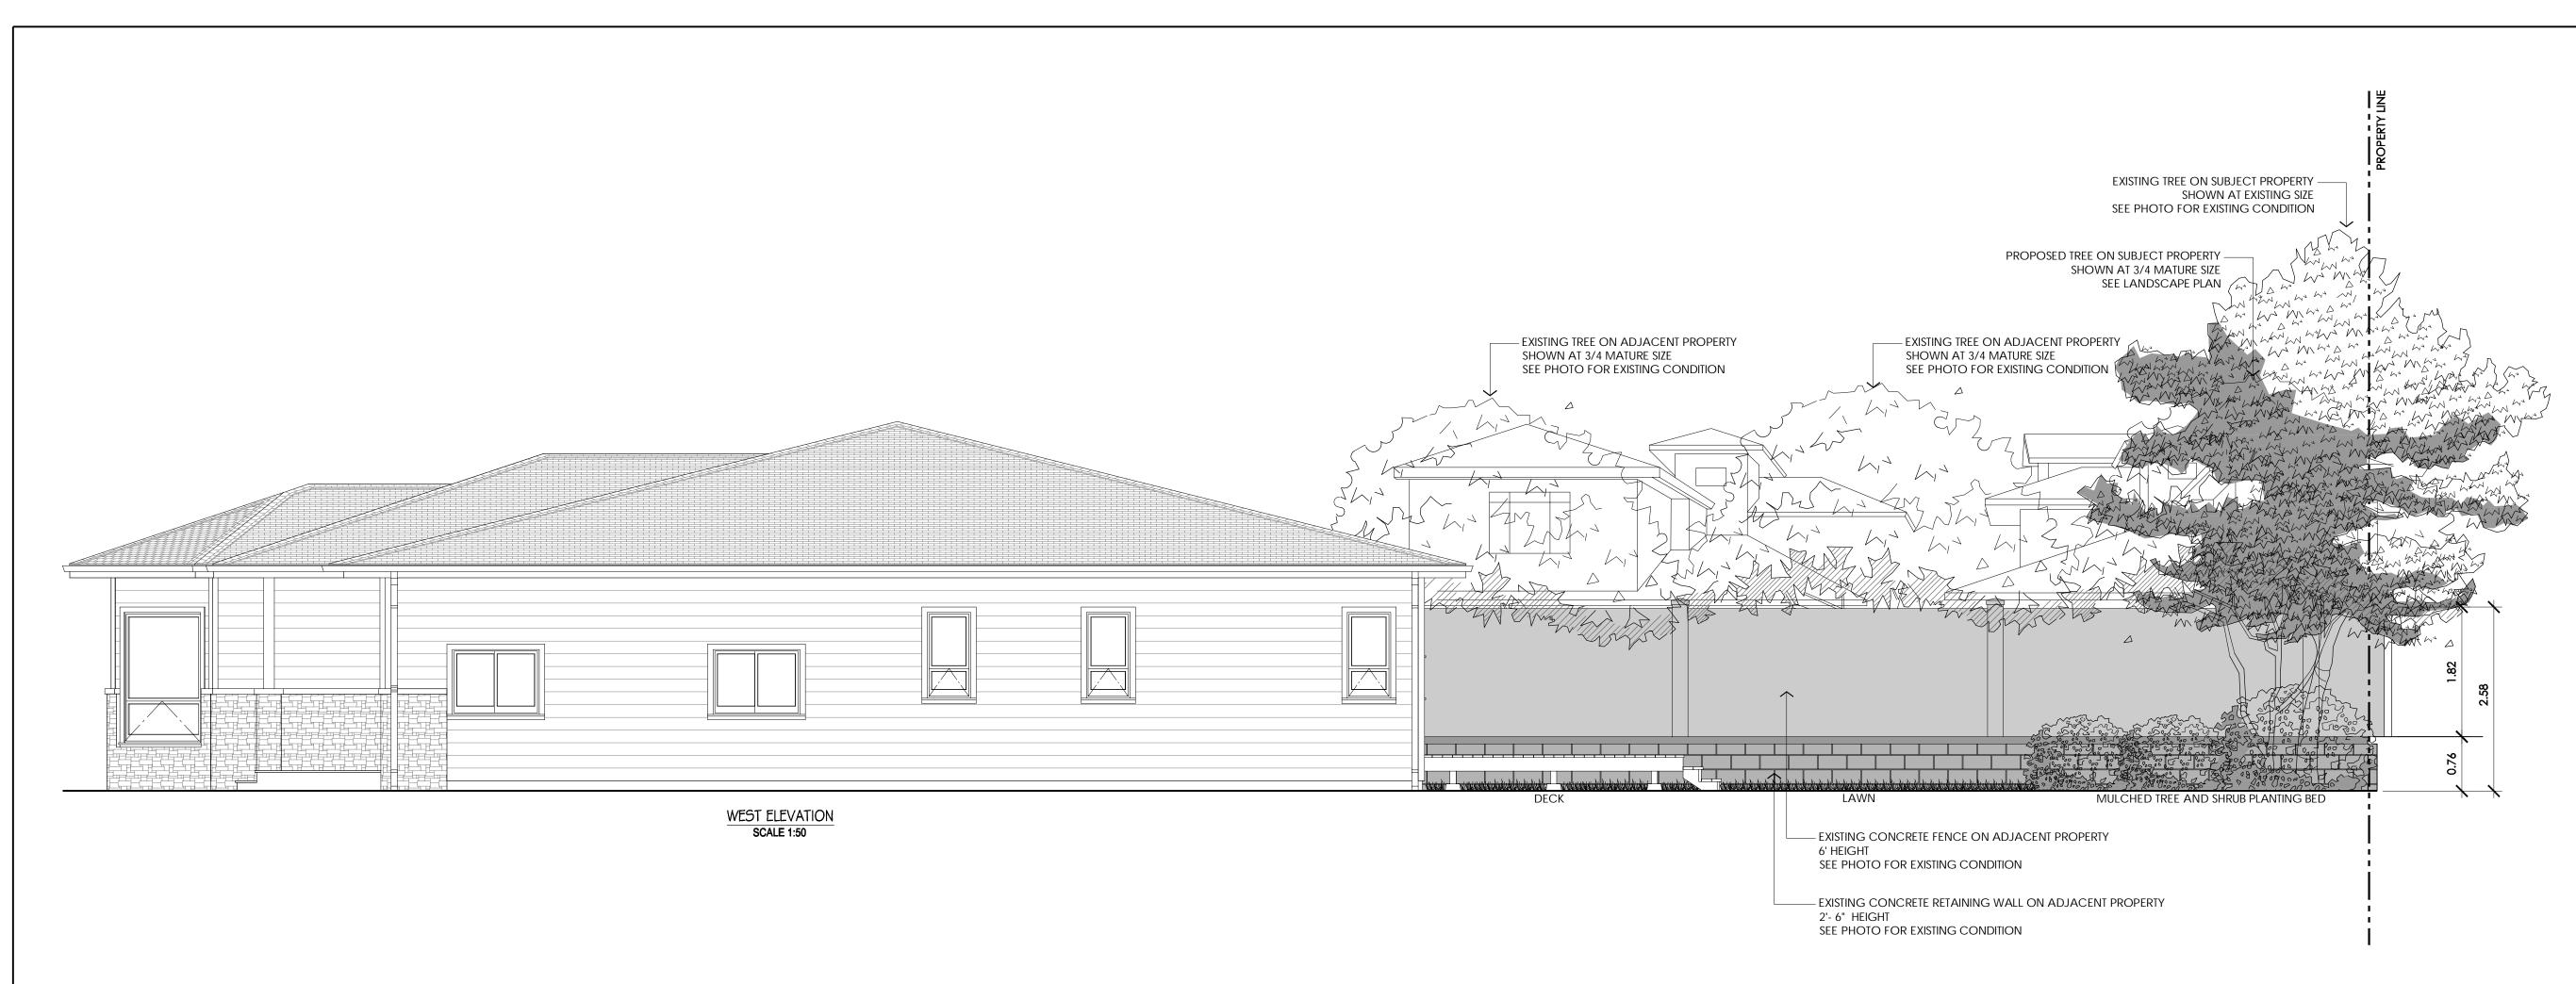
LANDSCAPE PLAN



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DATE:	2016.06.0
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APPROVED BY:	GARY LUP
DATE:	2016.06.
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SHEET NO.

2 of 4



SECTION - WEST ELEVATION

P-BL-PRO-KENS-329333-02



PHOTO - EXISTING CONDITIONS - WEST ELEVATION

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Landscape Architecture

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KELOWNA, BC V1Y 6S8 t: 1.250.860.2974

ATTENTION

HAVE A CONTRACT.

e: elizabeth@blastudio.ca

SURVEY INFORMATION
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4377 KENSINGTON DRIVE

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LANDSCAPE SECTION


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SECTION - SOUTH ELEVATION

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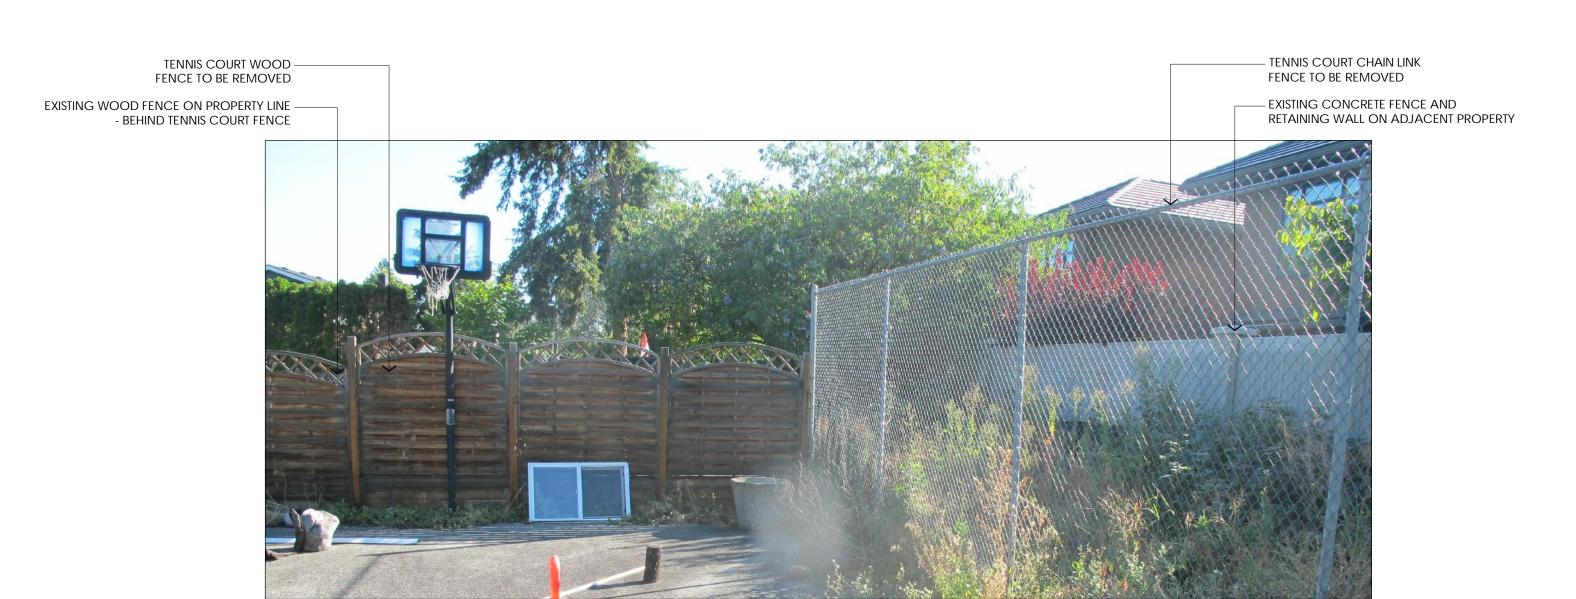


PHOTO - EXISTING CONDITIONS - SOUTH ELEVATION

P-BL-PRO-KENS-329333-05

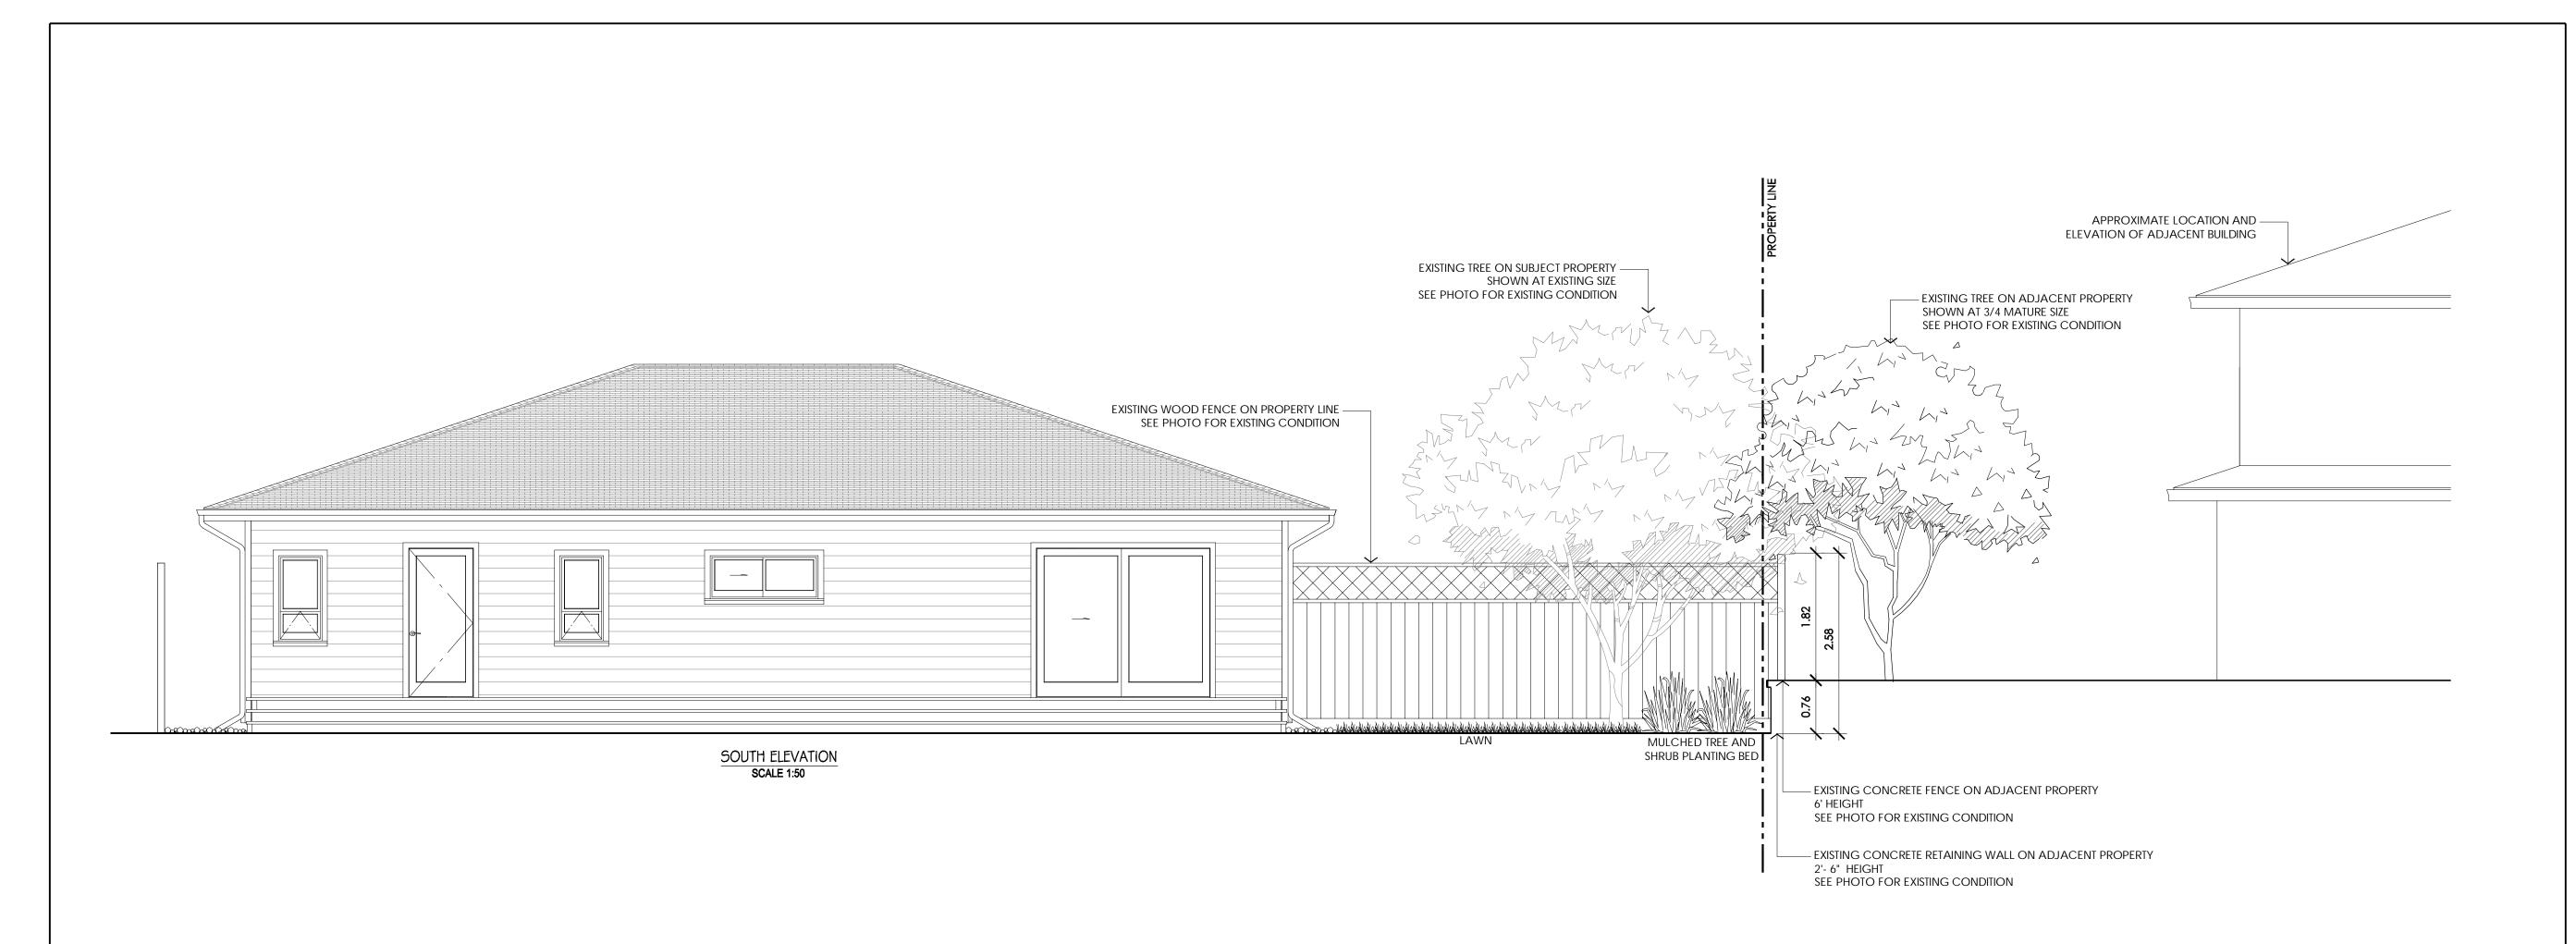

BALDERSTON LANDSCAPE ARCHITECTURE LTD.
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KELOWNA, BC V1Y 6S8
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PREPARED BY: AllTerra Land Surveying Ltd.
COORDINATE SYSTEM:
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4377 KENSINGTON DRIVE

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LANDSCAPE SECTION



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	APPROVED BY:	GARY LUPU	
	DATE:	2016.07.2	
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	PROJECT NO:	0012.0001.0	

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SHEET NO. REVISION NO. 4 of 4

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