

# Development Permit

## DP25-0095



This permit relates to land in the City of Kelowna municipally known as

**459 Osprey Ave**

and legally known as

**Lot A District Lot 14 ODYD Plan EPP120981**

and permits the land to be used for the following development:

**Apartment Housing**

The present owner and any subsequent owner of the above described land must comply with any attached terms and conditions.

**Date of Council Approval:**      **May 26<sup>th</sup>, 2025**

Development Permit Area:      Form and Character

Existing Zone:      UC5r – Pandosy Urban Centre Rental Only

Future Land Use Designation:      UC – Urban Centre

**This Development Permit is valid for two (2) years from the date of approval, with no opportunity to extend.**

### **This is NOT a Building Permit.**

In addition to your Development Permit, a Building Permit may be required prior to any work commencing. For further information, contact the City of Kelowna, Development Services Branch.

### **NOTICE**

This permit does not relieve the owner or the owner's authorized agent from full compliance with the requirements of any federal, provincial or other municipal legislation, or the terms and conditions of any easement, covenant, building scheme or agreement affecting the building or land.

Owner:      1347431 BC Ltd., Inc. No. BC1347431

Applicant:      Curtis Tarapaski

\_\_\_\_\_  
Nola Kilmartin  
Development Planning Department Manager  
Planning & Development Services

\_\_\_\_\_  
Date of Issuance

<b>ATTACHMENT</b>		<b>A</b>
This forms part of application		
# DP25-0095		
Planner Initials	<b>TC</b>	
		<b>City of Kelowna</b> DEVELOPMENT PLANNING

## 1. SCOPE OF APPROVAL

This Development Permit applies to and only to those lands within the Municipality as described above, and any and all buildings, structures and other development thereon.

This Development Permit is issued subject to compliance with all of the Bylaws of the Municipality applicable thereto, except as specifically varied or supplemented by this permit, noted in the Terms and Conditions below.

The issuance of a permit limits the permit holder to be in strict compliance with regulations of the Zoning Bylaw and all other Bylaws unless specific variances have been authorized by the Development Permit. No implied variances from bylaw provisions shall be granted by virtue of drawing notations that are inconsistent with bylaw provisions and that may not have been identified as required Variances by the applicant or Municipal staff.

## 2. CONDITIONS OF APPROVAL

THAT Council authorizes the issuance of Development Permit No. DP25-0095 for Lot A District Lot 14 ODYD Plan EPP120981 located at 459 Osprey Avenue, Kelowna, BC, subject to the following:

- a) The dimensions and siting of the building to be constructed on the land be in accordance with Schedule "A";
- b) The exterior design and finish of the building to be constructed on the land be in accordance with Schedule "B";
- c) Landscaping to be provided on the land be in accordance with Schedule "C";
- d) The applicant be required to post with the City a Landscape Performance Security deposit in the amount of 125% of the estimated value of the Landscape Plan, as determined by a Registered Landscape Architect;

## 3. PERFORMANCE SECURITY

As a condition of the issuance of this Permit, Council is holding the security set out below to ensure that development is carried out in accordance with the terms and conditions of this Permit. Should any interest be earned upon the security, it shall accrue to the Developer and be paid to the Developer or his or her designate if the security is returned. The condition of the posting of the security is that should the Developer fail to carry out the development hereby authorized, according to the terms and conditions of this Permit within the time provided, the Municipality may use enter into an agreement with the property owner of the day to have the work carried out, and any surplus shall be paid over to the property owner of the day. Should the Developer carry out the development as per the conditions of this permit, the security shall be returned to the Developer or his or her designate following proof of Substantial Compliance as defined in Bylaw No. 12310. There is filed accordingly:

- a) An Irrevocable Letter of Credit **OR** certified cheque **OR** a Surety Bond in the amount of **\$109,300.00**

Before any bond or security required under this Permit is reduced or released, the Developer will provide the City with a statutory declaration certifying that all labour, material, workers' compensation and other taxes and costs have been paid.


## 4. INDEMNIFICATION

Upon commencement of the works authorized by this Permit the Developer covenants and agrees to save harmless and effectually indemnify the Municipality against:


- a) All actions and proceedings, costs, damages, expenses, claims, and demands whatsoever and by whomsoever brought, by reason of the Municipality said Permit.

All costs, expenses, claims that may be incurred by the Municipality where the construction, engineering or other types of works as called for by the Permit results in damages to any property owned in whole or in part by the Municipality or which the Municipality by duty or custom is obliged, directly or indirectly in any way or to any degree, to construct, repair, or maintain.

**The PERMIT HOLDER is the CURRENT LAND OWNER.  
Security shall ONLY be returned to the signatory of the  
Landscape Agreement or their designates.**

<b>ATTACHMENT</b>		<b>A</b>
This forms part of application		
# DP25-0095		
Planner Initials	TC	 City of <b>Kelowna</b> DEVELOPMENT PLANNING



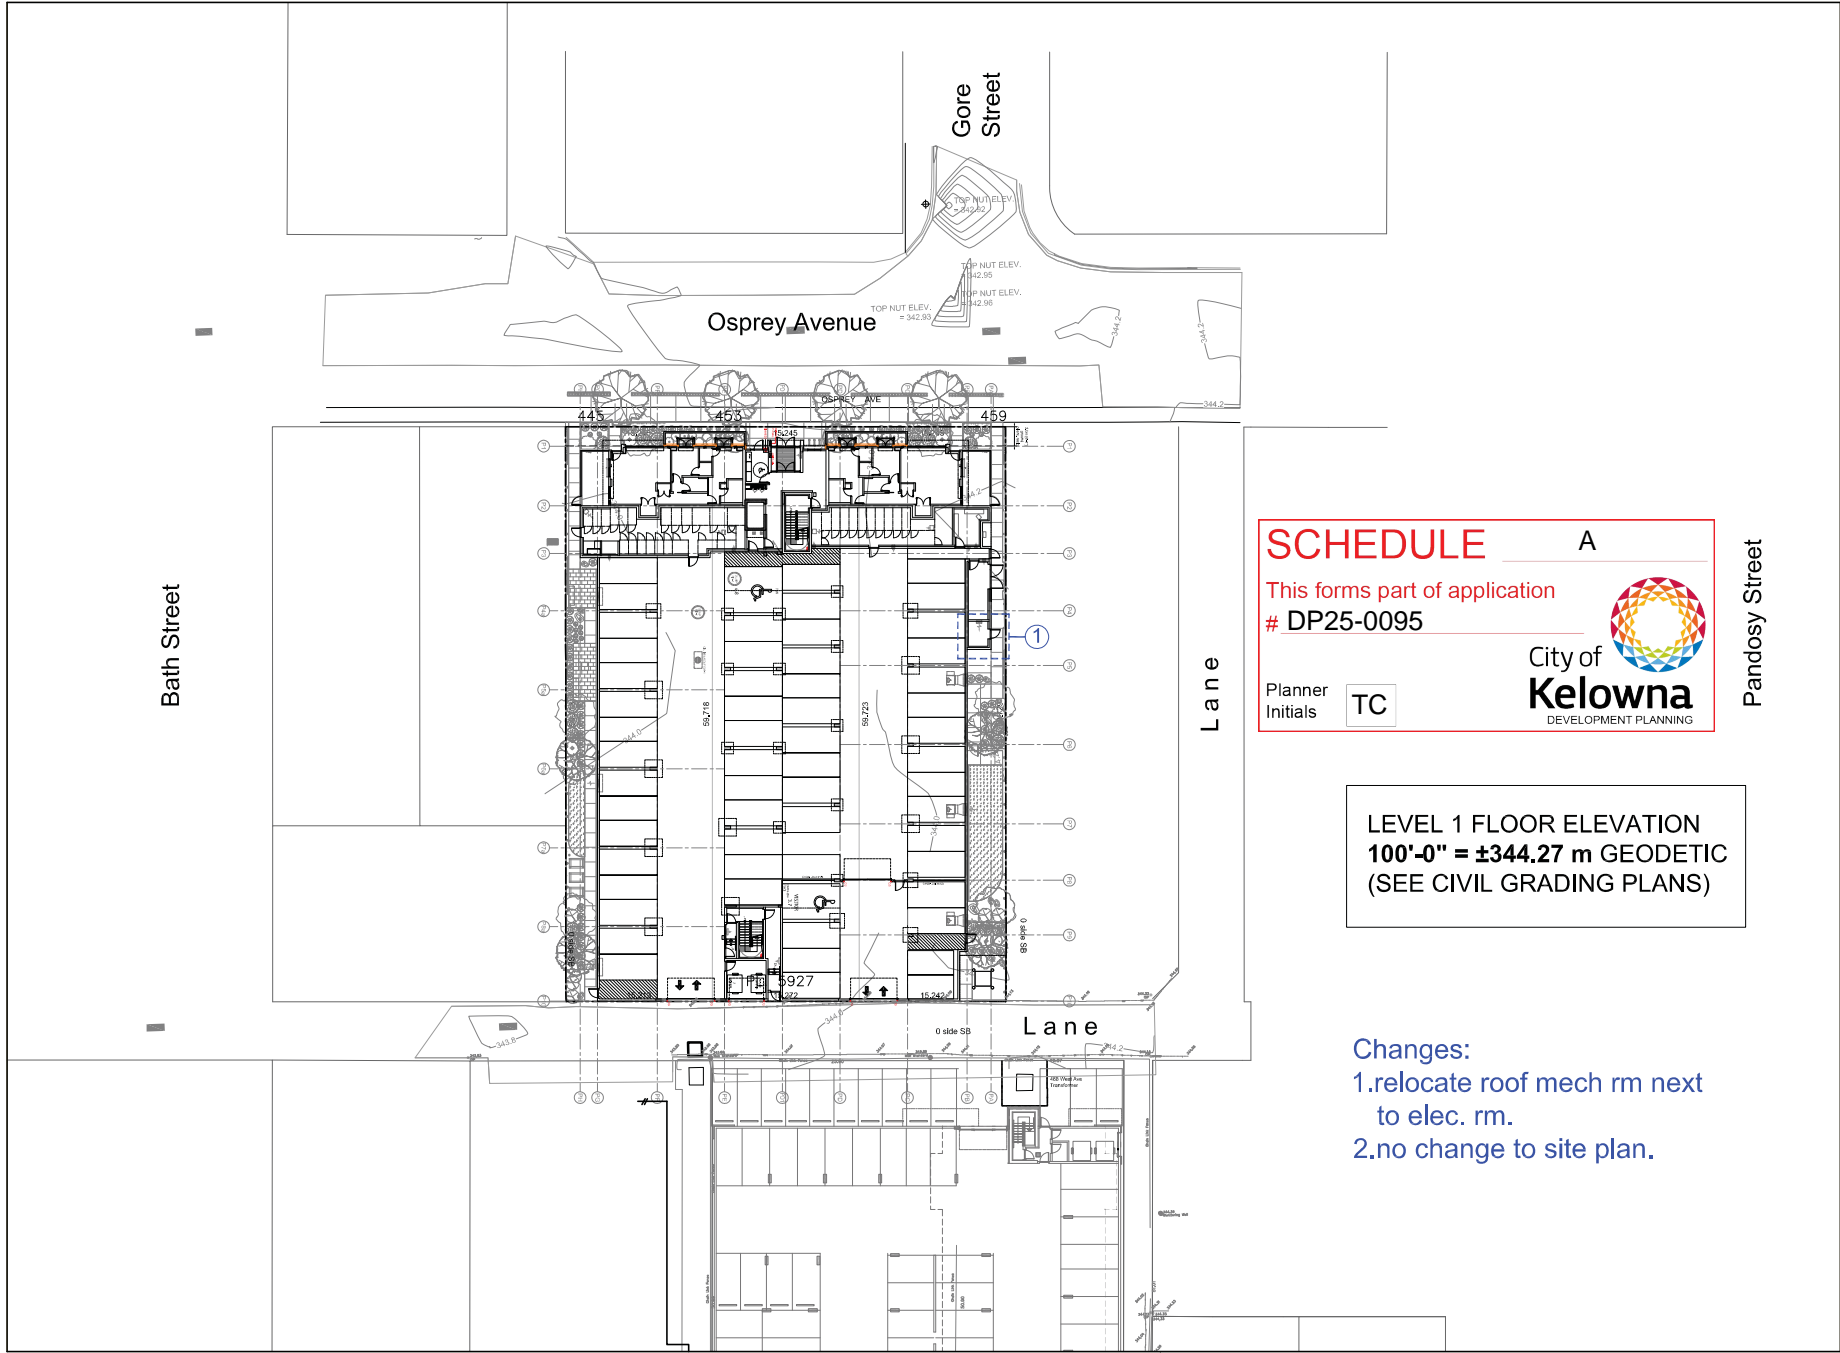

233 BERNARD AVENUE  
KELOWNA, B.C.  
V1Y 6N2  
TEL: 250.767.3006  
EMAIL: info@shaw.ca



2024-07-12  
Amend  
DP



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No.	Date	Revisions
01	2022-09-27	Issued DP
02	2022-12-15	Issued revised DP
03	2023-01-21	80% progress
04	2023-09-28	80% progress
05	2023-09-28	Issued DP
06	2023-09-28	100%
07	2023-09-28	Revised DP
08	2024-07-12	Amend DP

Project Title  
OSPREY AVE RENTAL  
WITH PARKADE

453 OSPREY AVENUE KELOWNA  
PLAN 64P5927 LOT 3 BL 1A

Drawing Number

A2.01


DRAWINGS ARE NOT TO BE SCALE.  
ALL DIMENSIONS SHALL BE PROVIDED ON JOB.

Drawing Title  
SITE PLAN

scale: 1" = 10'-0"

Date	2024-07-12
Job No.	mm 23-1910
Scale	AS SHOWN
Drawn	MM
Checked	MM



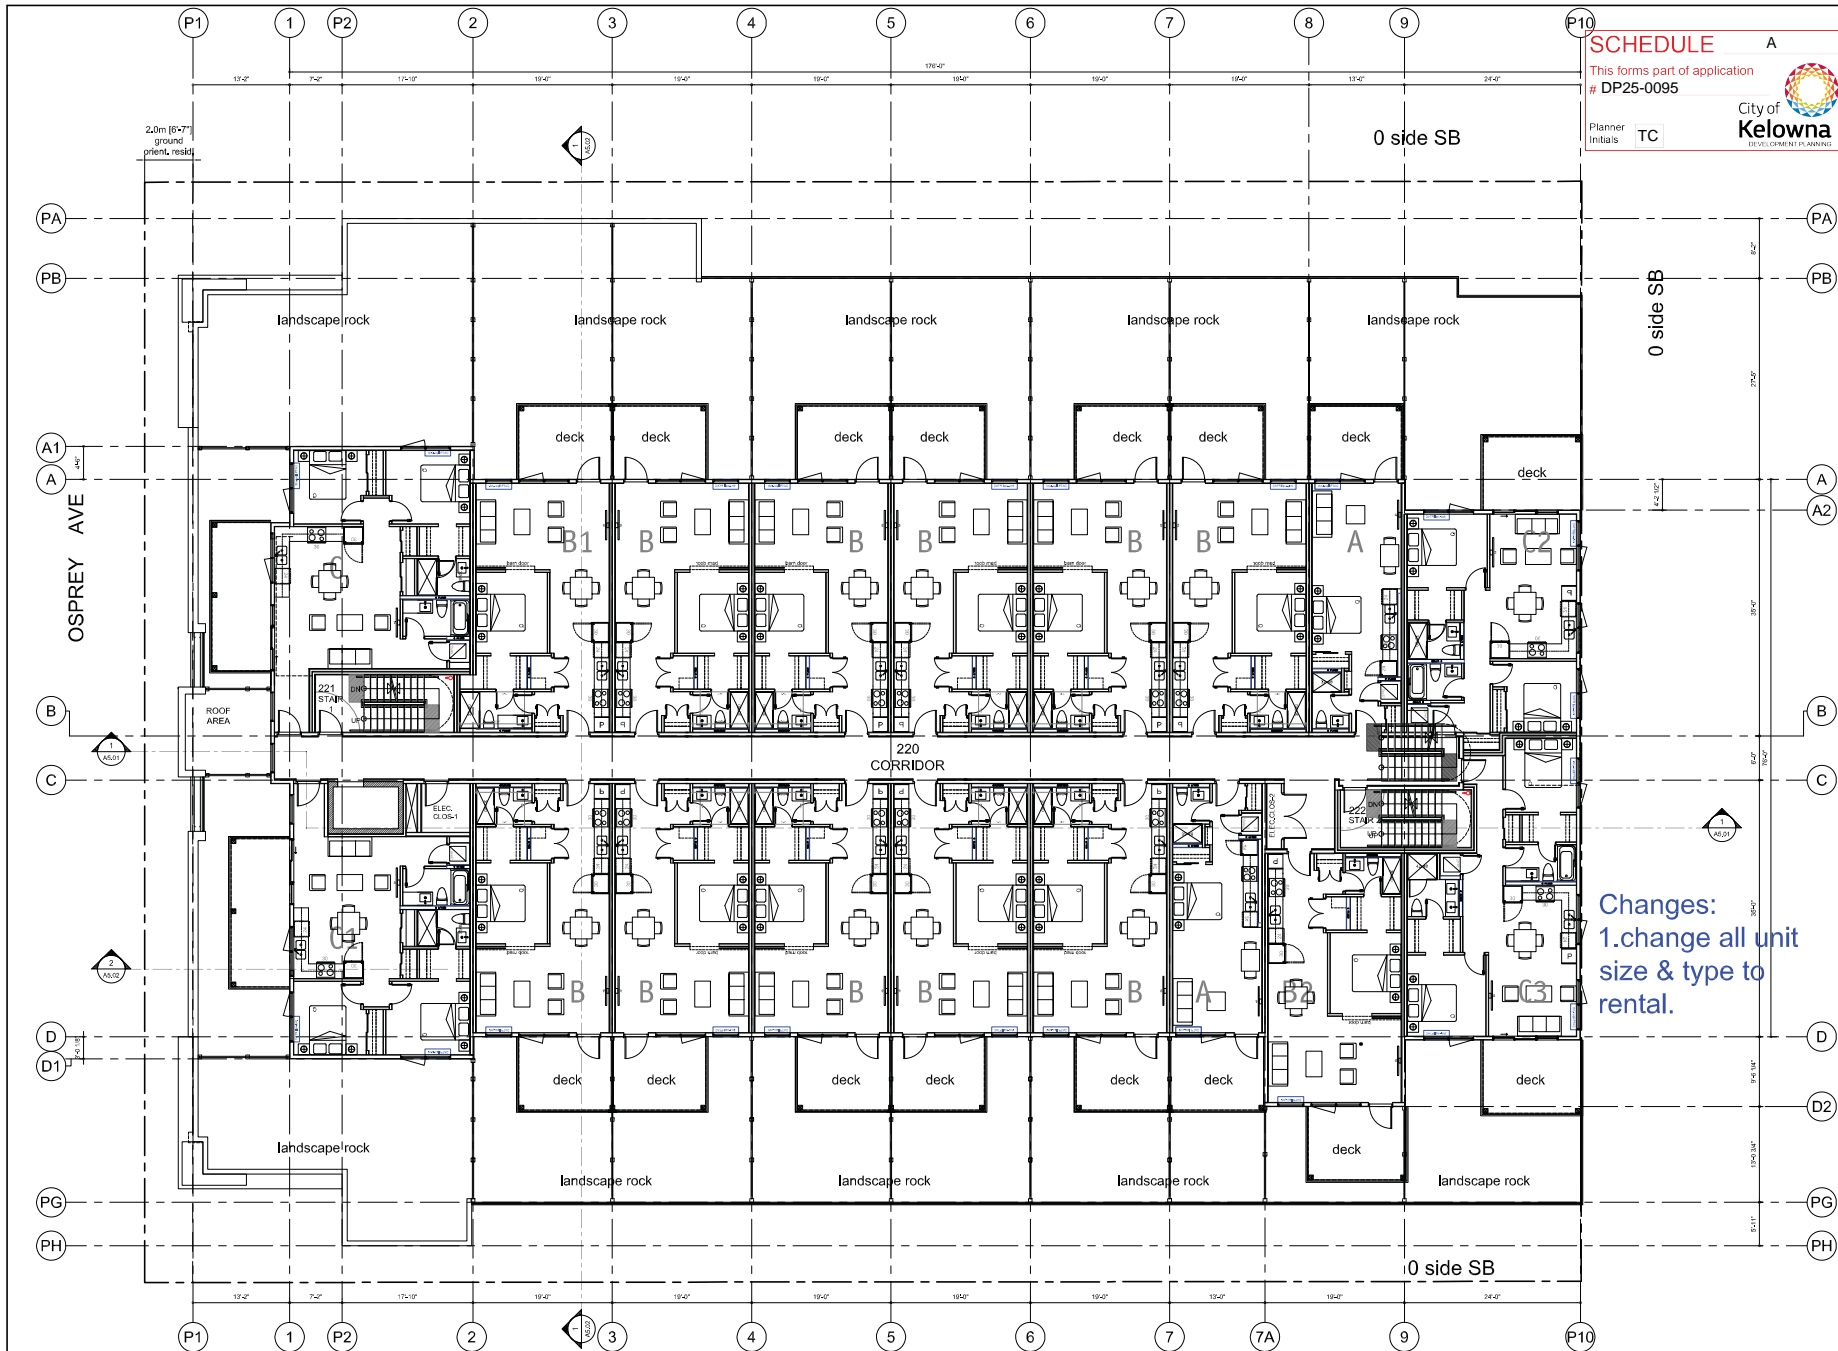

## SCHEDULE A

This forms part of application  
# DP25-0095

Planner Initials TC



233 BERNARD AVENUE  
KELOWNA, B.C.  
V1Y 6N2  
TEL: 250.762.3006  
EMAIL: kelowna@kelowna.ca



2024-07-12  
Amend  
DP



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No.	Date	Revisions
01	2022-05-27	Issued DP
02	2022-12-15	Issued revised DP
03	2023-01-21	20% progress
04	2023-02-08	60% progress
05	2023-03-01	Issued DP
06	2023-05-07	75%
07	2023-07-14	Revised DP
08	2024-07-12	Amend DP

Project Title  
OSPREY AVE RENTAL  
WITH PARKADE

453 OSPREY AVENUE KELOWNA  
PLAN 64P597.107.10-14

Drawing Number

**A3.02**

DRAWINGS ARE NOT TO BE SCALED.  
ALL DIMENSIONS SHALL BE PRECISED ON JOB

Drawing Title  
LEVEL 2

scale: 1/8"=1'-0"

Date	2024-07-12
Job No.	mm 23-1910
Scale	AS SHOWN
Drawn	MM
Checked	JM





233 BERNARD AVENUE  
KELOWNA, B.C.  
V1Y 6N2  
TEL: 250.762.3006  
EMAIL: kelowna@shaw.ca



2024-07-12  
Amend  
DP



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No.	Date	Revision
01	2022-09-21	Issued DP
02	2022-12-15	Issued revised DP
03	2023-01-21	20% progress
04	2023-02-08	60% progress
05	2023-03-13	Issued DP
06	2023-05-07	75%
07	2023-07-14	Revised DP
08	2024-07-12	Amend DP

Project Title  
OSPREY AVE RENTAL  
WITH PARKADE

453 OSPREY AVENUE, KELOWNA  
PLAN 64P597 (07 & 1A)

Drawing Number

**A3.03**

DRAWINGS ARE NOT TO BE SCALED.  
ALL DIMENSIONS SHALL BE VERIFIED ON JOB.

Drawing Title  
**LEVEL 3**

scale: 1/8"=1'-0"

Date	2024-07-12
Job No.	new P1-1949
Scale	AS SHOWN
Drawn	AM
Checked	JM



**SCHEDULE A**

This forms part of application  
# DP25-0095

Planner Initials **TC**

**City of Kelowna**  
DEVELOPMENT PLANNING

233 BERNARD AVENUE  
KELOWNA, B.C.  
V1Y 6N2  
TEL: 250.762.3006  
EMAIL: kelowna@city.ca

**MEIKLEJOHN ARCHITECTS INC.**

**BOUDREAU**  
CONSULTANTS LTD.

2024-07-12  
**Amend DP**

TRUE NORTH

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03	2023-01-21	20% progress
04	2023-02-28	60% progress
05	2023-03-13	Issued BP
06	2023-05-07	75%
07	2023-07-14	Revised DP
08	2024-07-12	Amend DP

Project Title  
**OSPREY AVE RENTAL WITH PARKADE**

453 OSPREY AVENUE KELOWNA  
PLAN 64P5977 (07.12.24)

Drawing Number  
**A3.04**


DRAWINGS ARE NOT TO BE RECALCULATED.  
ALL DIMENSIONS SHALL BE VERIFIED ON JOB.

Drawing Title  
**LEVEL 4**

scale: 1/8"=1'-0"

Date	2024-07-12
Job No.	mm 23-1910
Scale	AS SHOWN
Drawn	MM
Checked	MM



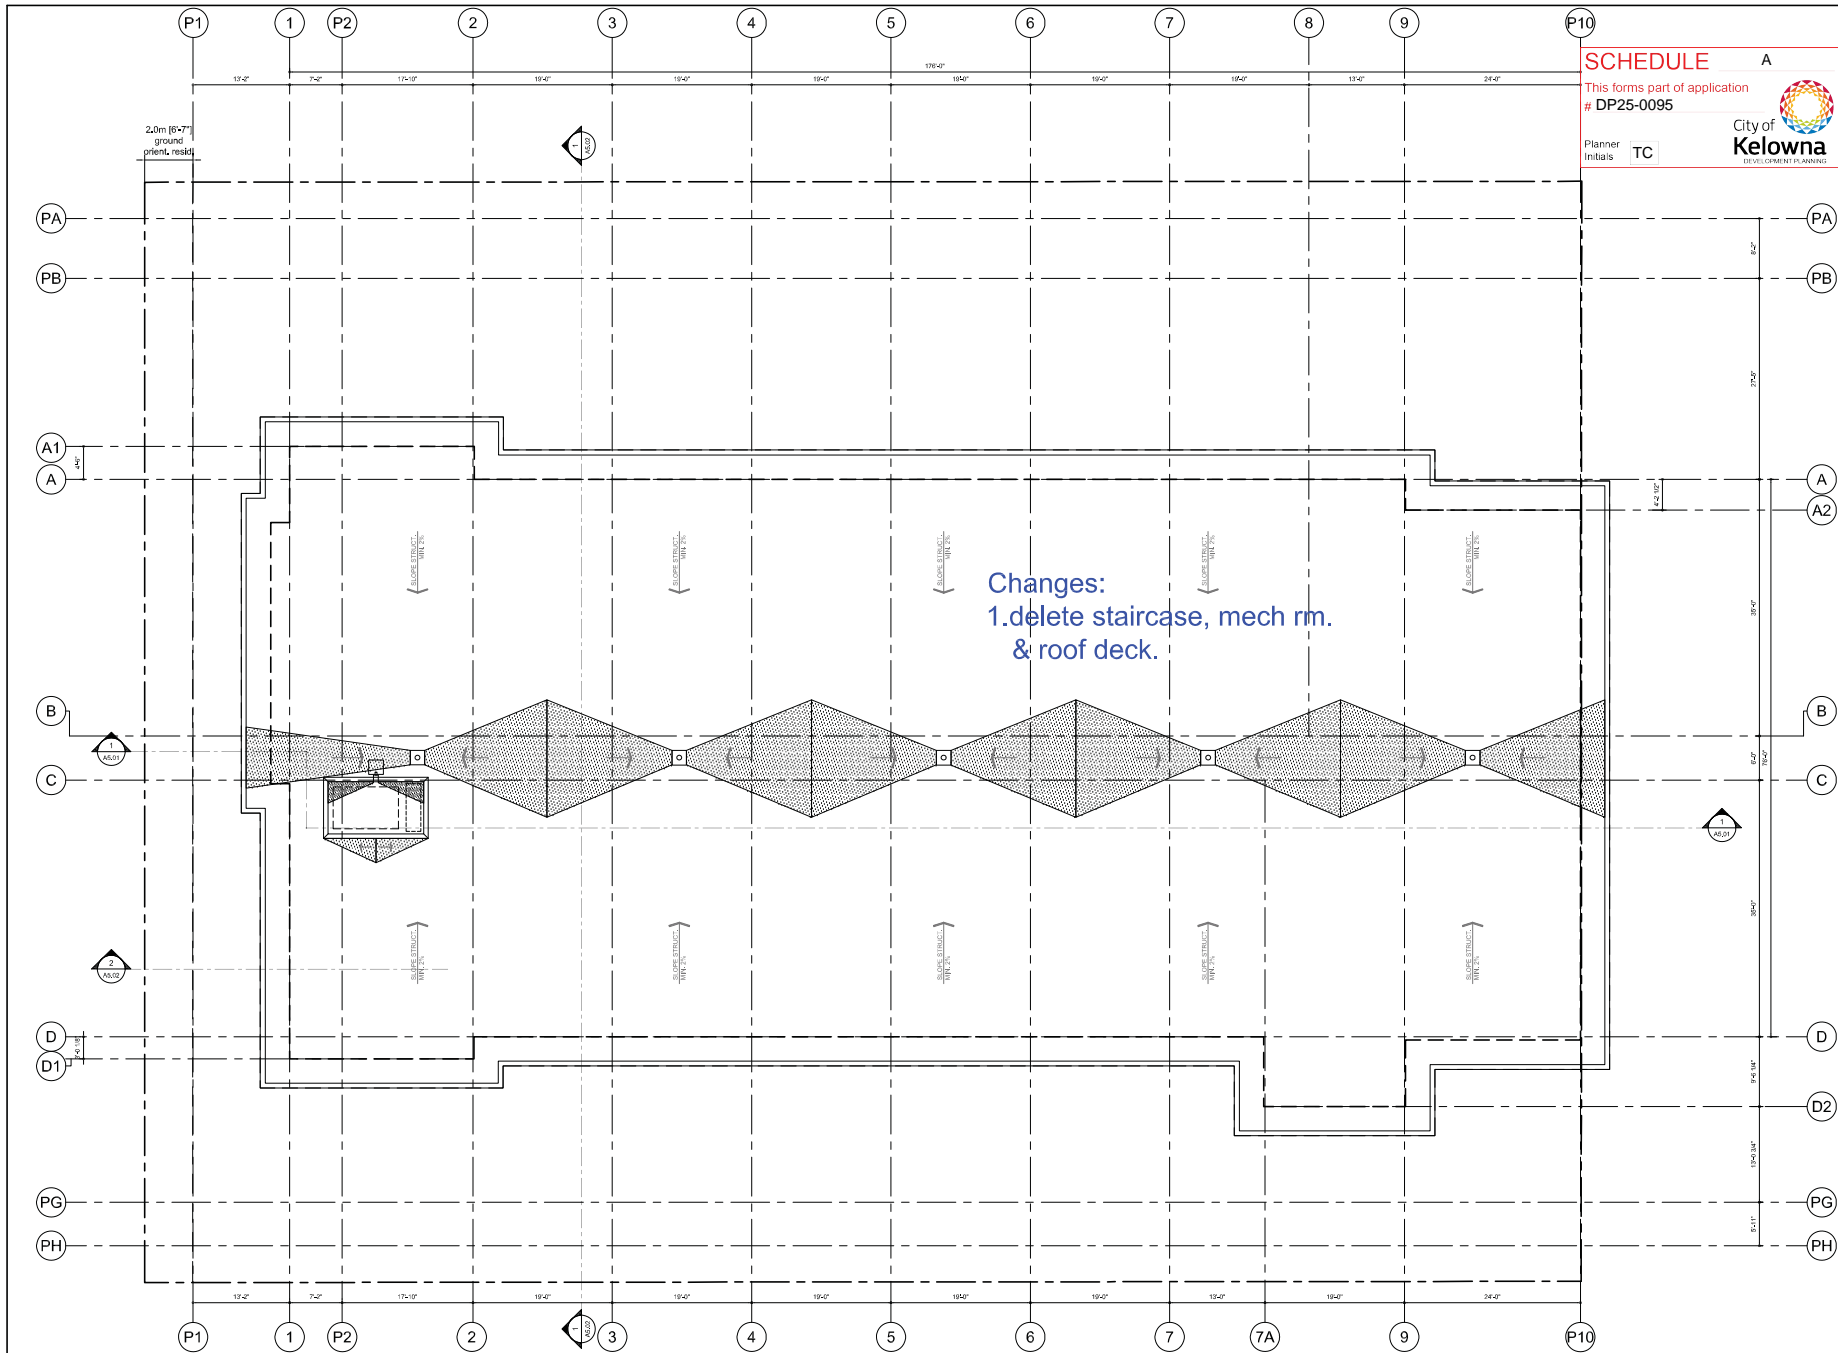

**SCHEDULE A**

This forms part of application  
# DP25-0095

Planner Initials TC

City of Kelowna  
DEVELOPMENT PLANNING

233 BERNARD AVENUE  
KELOWNA, B.C.  
V1Y 6N2  
TEL: 250.762.3004  
BNA@kelowna.ca



2024-07-12  
Amend  
DP



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No.	Date	Revisions
01	2022-09-27	Issued DP
02	2022-12-15	Issued revised DP
03	2023-01-21	80% progress
04	2023-08-28	80% progress
05	2023-09-01	Issued DP
06	2023-09-01	DEC
07	2023-09-14	Revised DEC
08	2024-07-12	Amend DP

Project Title  
**OSPREY AVE RENTAL  
WITH PARKADE**

453 OSPREY AVENUE KELOWNA  
PLAN 64P597.1 DT 18-14

Drawing Number

**A3.05**

DRAWINGS ARE NOT TO BE SCALED.  
ALL DIMENSIONS SHALL BE REFERENCED ON JOB.

Drawing Title  
**ROOF PLAN**

scale: 1/8"=1'-0"

Date	2024-07-12
Job No.	mm 23-1910
Scale	AS SHOWN
Drawn	MM
Checked	MM

# SCHEDULE


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This forms part of application  
# DP25-0095


Planner  
Initials TC



Changes:  
1.update window, door,  
balcony to match  
floor plan.  
2.delete staircase & mech rm.

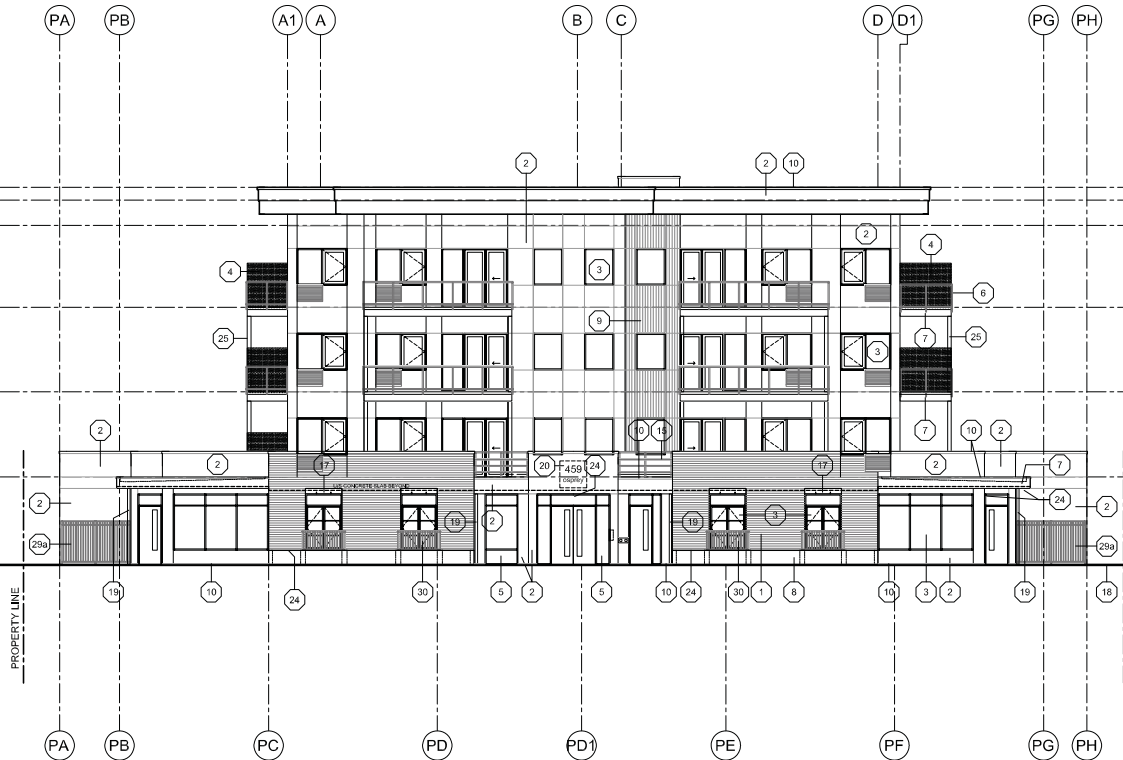

<b>ELEVATION KEY NOTE:</b> ALL COLOURS TO BE CHOSEN BY ARCHITECT FROM APPROVED PRODUCT MANUF.'S STANDARD LINE OF COLOURS. (SEE COLOUR ELEVATIONS)			
1 BRICK VENEER	7 HARDIE PANEL CLADDING @ ROOF / DECK FASCIA'S	14 PAINTED CEMENT FACED INSUL. (SEE SECTION DETAILS)	23 PREFINISHED METAL LOUVERED GRILLES (SEE MECH.)
2 STUCCO FINISH WITH REVEALS	7a HARDIE TRIM (SEE SECTION DETAILS)	15 ALUM / GLASS WITH HORIZ. RAILING COLOUR: BLACK	24 LIGHT FIXTURE (SEE ELEC.)
3 VINYL WINDOW & DOOR COLOUR: BLACK & WHITE (SEE COLOR ELEVATIONS)	8 EXPOSED CONCRETE C/W CLEAR SEALER FINISH	16 PREFINISHED METAL SCUPPER	25 CEMENTITIOUS PANEL OVER COLUMNS
4 ALUM OBSCURE GLASS PRIVACY SCREEN 6'-0" HT	8a CONCRETE REVEALS	17 PRE-CAST CONCRETE LINTEL C/W WEEP HOLES (SEE DETAILS)	26 PREFINISHED METAL EMERGENCY OVERFLOW SCUPPER COLOURS TO MATCH EXIST. FINISHES - SEE COLOUR ELEVATIONS
5 ALUM STOREFRONT WINDOW & DOOR COLOUR: GREY	9 VERTICAL WOOD GRAIN METAL PANEL	18 FINISHED GRADE (SEE CIVIL)	27 PREFINISHED RAIN WATER LEADER (SEE MECH.)
6 ALUM / GLASS RAILING COLOUR: BLACK	10 PREFINISHED SHEET STEEL FLASHING	19 PAINTED STEEL PIPE RAIN WATER LEADER	28 PAINTED STEEL PROTECTION ANGLE / CORNER GUARD
	11 PAINTED METAL DOOR	20 SIGNAGE	29 PAINTED STEEL GATE (SEE LANDSCAPE)
	12 PAINTED METAL OH DOOR	21 NOT USED	29a PAINTED STEEL FENCE (SEE LANDSCAPE)
	13 NOT USED	22 PREFINISHED MECH. WALL CAP VENTS COLOUR TO MATCH CLADDING (SEE MECH. FOR SIZES)	30 ALUM VERTICAL PICKETS SCREEN C/W CONCRETE POST (SEE DETAILS)

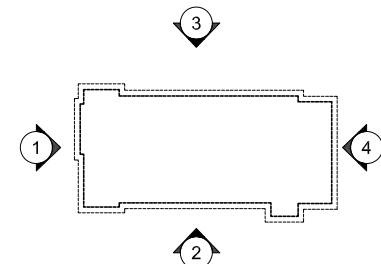

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V1Y 6N2  
TEL 250.767.3004  
EMAIL: info@meikjohn.ca



2024-07-12  
Amend  
DP

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No.	Date	Revisions
01	2022-09-27	Issued DP
02	2022-12-15	Issued Revised DP
03	2023-01-01	20% progress
04	2023-02-28	60% progress
05	2023-03-31	Issued DP
06	2023-06-01	75%
07	2023-07-14	Revised DP
08	2024-07-12	Amend DP

Project Title  
OSPREY AVE RENTAL  
WITH PARKADE

453 OSPREY AVENUE KELLOWNA  
PLAN 04P597 (07.08.24)

Drawing Number

A4.01

DRAWINGS ARE NOT TO BE SCALED.  
ALL DIMENSIONS SHALL BE VERIFIED ON JOB.

Drawing Title  
BUILDING ELEVATION  
1

scale: 1/8"=1'-0"

Date	2024-07-12
Job No.	mm 23-1390
Scale	AS SHOWN
Drawn	JA
Checked	JM

**m+m**  
MEKLEJOHN ARCHITECTS INC.

2024-07-12  
Amend  
DP

No.	Date	Revision
01	2023-09-27	Issued BP
02	2023-12-15	Issued revised BP
03	2024-01-31	30% progress
04	2023-02-28	60% progress
05	2023-03-31	Issued BP
06	2023-06-07	IPC
07	2023-07-14	Reissued IPC
08	2024-07-12	Amend BP


A4.02

scale: 1/8"=1'-0"

Date	2024-07-12
Job No.	mem 21-1940
Scale	AS SHOWN
Drawn	SM
Checked	JM

Changes:


- 1.update window, door, balcony to match floor plan.
- 2.delete staircase & mech rm.

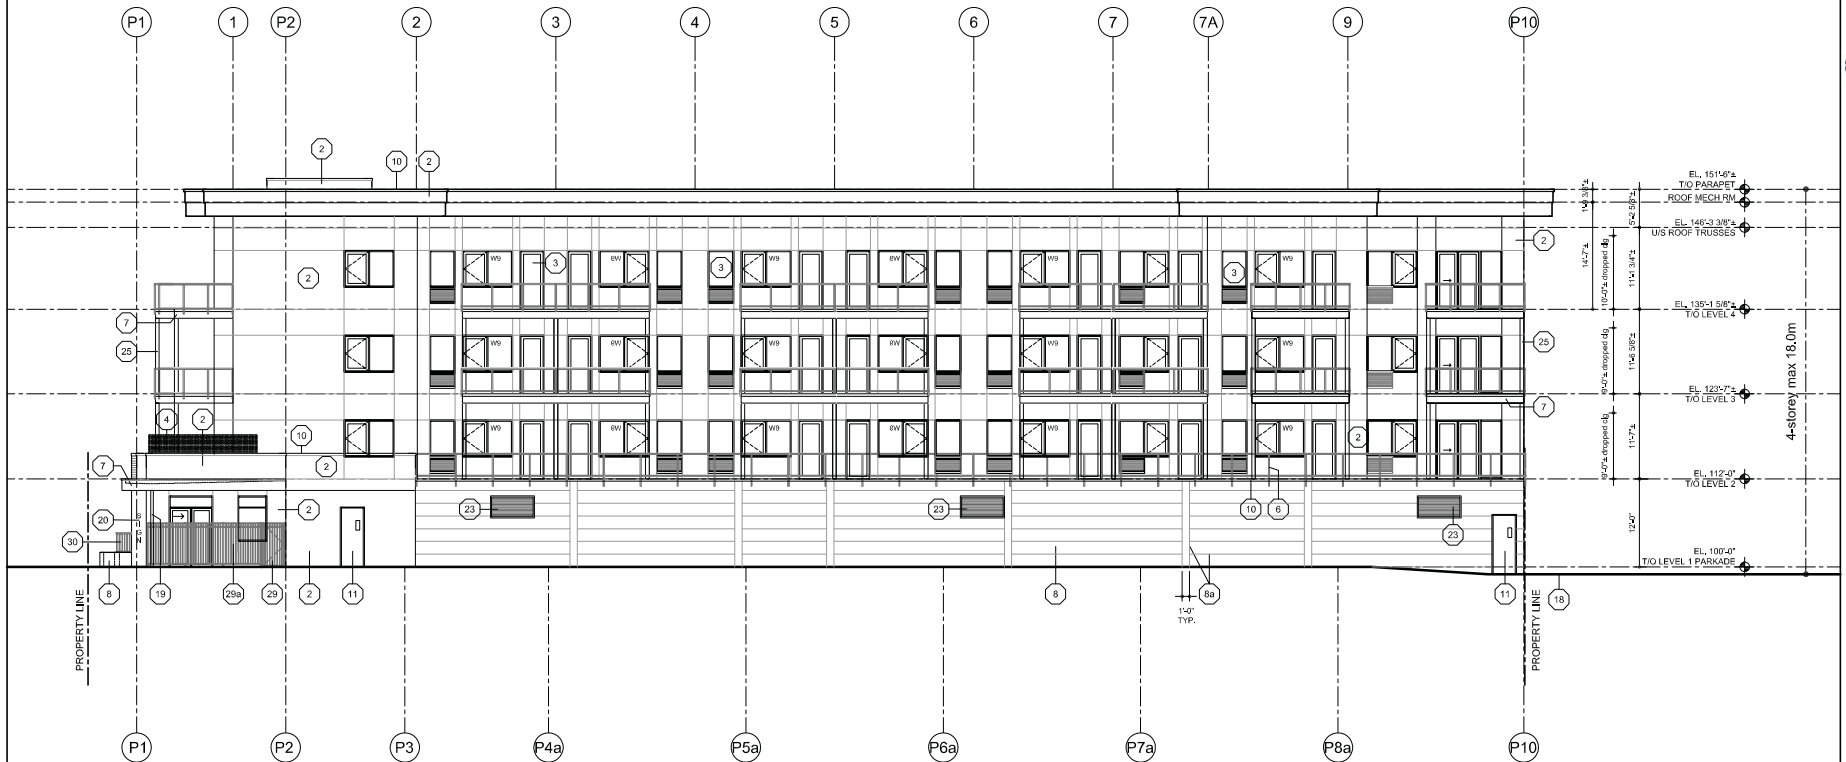

This forms part of application  
# DP25-0095

Planner Initials TC

City of Kelowna  
DEVELOPMENT PLANNING

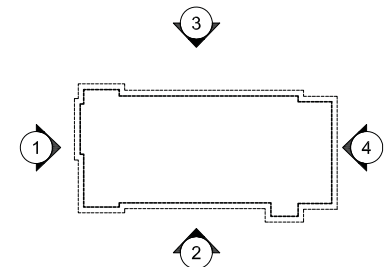

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No.	Date	Revision
01	2022-09-21	Issued DP
02	2022-12-15	Issued revised DP
03	2023-01-11	20% progress
04	2023-02-08	60% progress
05	2023-03-23	Issued BP
06	2023-06-01	25%
07	2023-07-14	Revised BCL
08	2024-07-12	Amend DP

Project Name  
**OSPREY AVE RENTAL  
WITH PARKADE**

453 OSPREY AVENUE KELOWNA  
PLAN 64P5627 (01) 10-14  
Drawing Number

**A4.03**



DRAWINGS ARE NOT TO BE SCALED.  
ALL DIMENSIONS SHALL BE VERIFIED ON JOB.

Drawing Title  
**BUILDING ELEVATION  
3**

scale: 1/8"=1'-0"

Date	2024-07-12
Job No.	main 21-1940
Scale	AS SHOWN
Drawn	JA
Checked	JM

Changes:  
1.update window, door,  
balcony to match  
floor plan.  
2.delete staircase & mech rm.

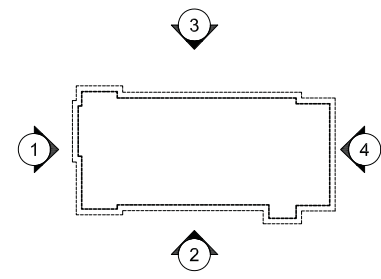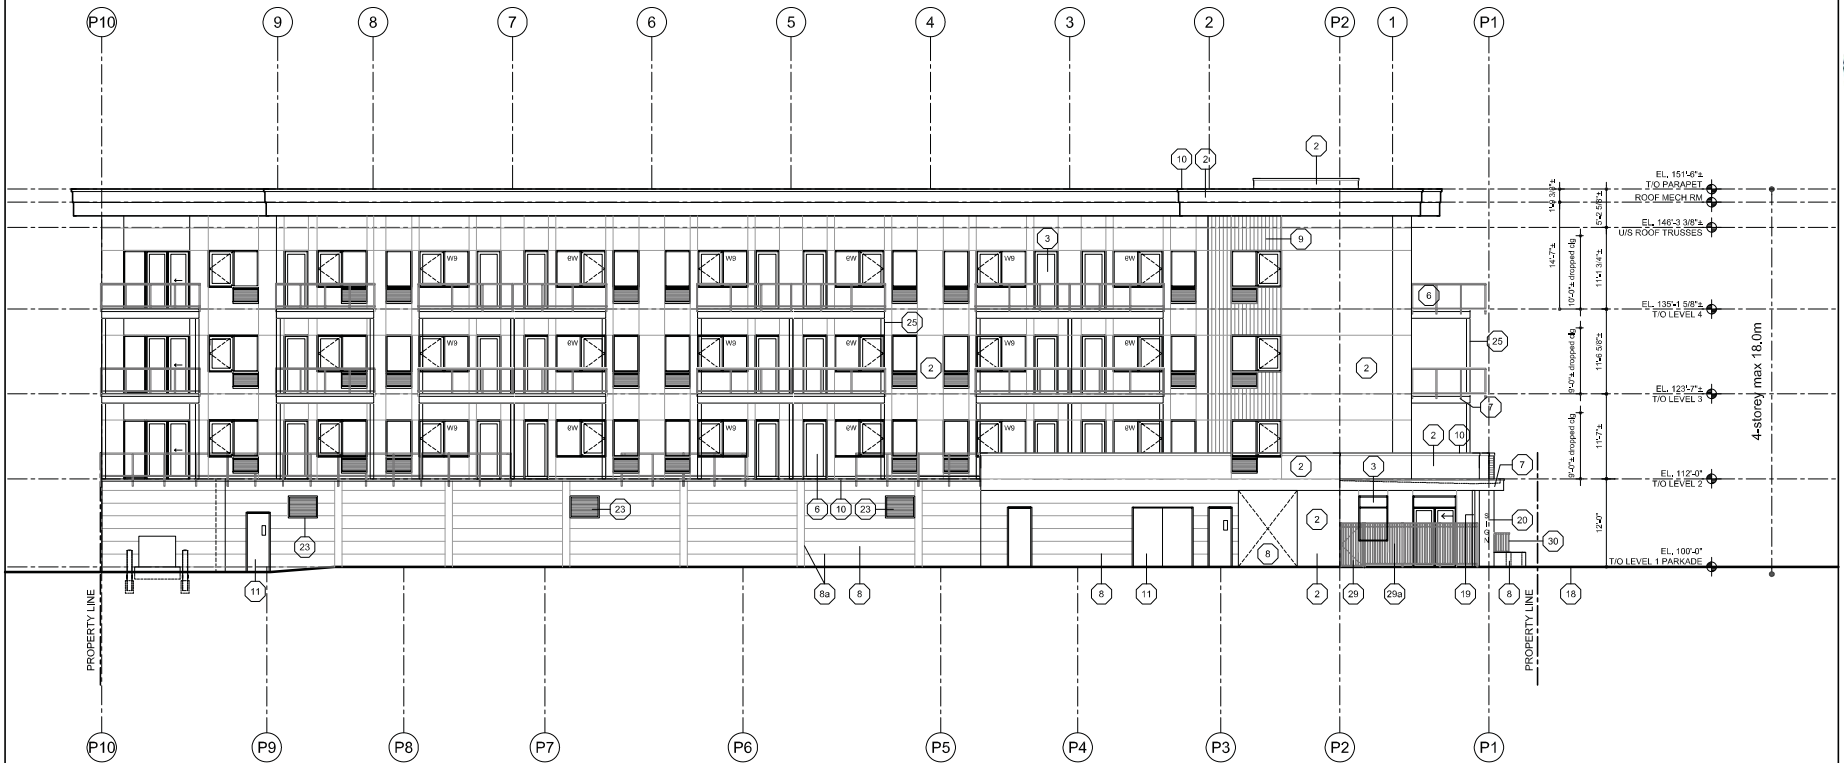

**SCHEDULE**

This forms part of application  
# DP25-0095

Planner Initials **TC**

**B**



**City of  
Kelowna**  
DEVELOPMENT PLANNING

2024-07-12  
**Amend  
DP**

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No.	Date	Revisions
01	2022-09-27	Issued DP
02	2022-12-15	Issued revised DP
03	2023-01-31	80% progress
04	2023-02-28	80% progress
05	2023-03-31	Issued DP
06	2023-06-01	100%
07	2023-07-14	Revised DP
08	2024-07-12	Amend DP

Project Title  
**OSPREY AVE RENTAL  
WITH PARKADE**

453 OSPREY AVENUE KELOWNA  
PLAN 64P5977 - LOT 3 OR 1A

Drawing Number

**A4.04**


DRAWINGS ARE NOT TO BE SCALED.  
ALL DIMENSIONS SHALL BE VERIFIED ON JOB.

Drawing Title  
**BUILDING ELEVATION  
4**

scale: 1/8"=1'-0"

Date	2024-07-12
Job No.	1901-01-1910
Scale	AS SHOWN
Drawn	JAN
Checked	JAN

- Changes:
- 1.update window, door, balcony to match floor plan.
  - 2.delete staircase & mech rm.

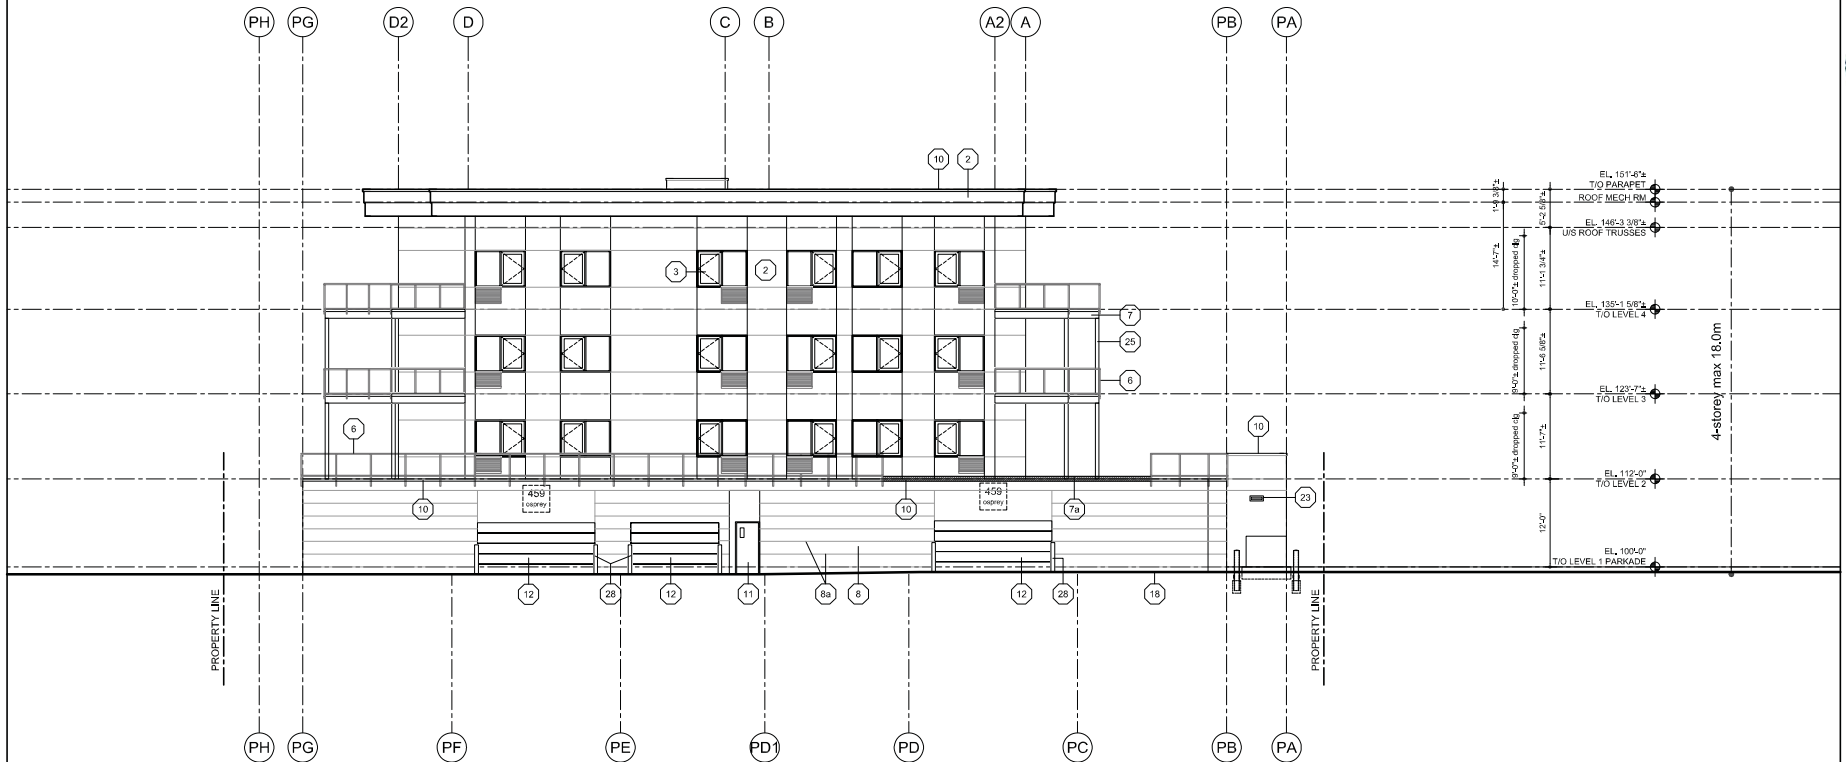

**SCHEDULE**


**B**

This forms part of application  
# DP25-0095

Planner  
Initials

TC

City of  
**Kelowna**  
DEVELOPMENT PLANNING

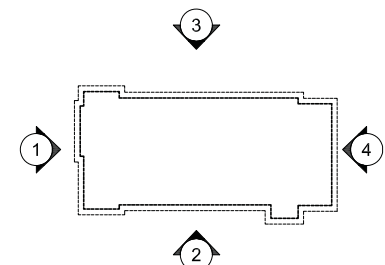

No.	Date	Revision
01	2022-05-27	Issued DP
02	2022-12-15	Issued Revised DP
03	2023-01-21	80% progress
04	2023-02-08	60% progress
05	2023-03-13	Issued DP
06	2023-05-07	85%
07	2023-07-14	Revised DP
08	2024-07-12	Amend DP

Project Title  
**OSPREY AVE RENTAL  
WITH PARKADE**

453 OSPREY AVENUE KELOWNA  
PLAN G4P5927.107.3 DR. 1A

Drawing Number

**A5.01**


DRAWINGS ARE NOT TO BE REPRODUCED OR COPIED IN ANY FORM OR BY ANY MEANS, ELECTRONIC OR MECHANICAL, WITHOUT THE WRITTEN PERMISSION OF MEIKLEJOHN ARCHITECTS INC.

Drawing Title  
**BUILDING SECTION**

scale: 1/8"=1'-0"

Date	2024-07-12
Job No.	mei-21-010
Scale	AS SHOWN
Drawn	BA
Checked	BA

Changes:  
1.update window, door,  
balcony to match  
floor plan.  
2.delete staircase & mech rm.

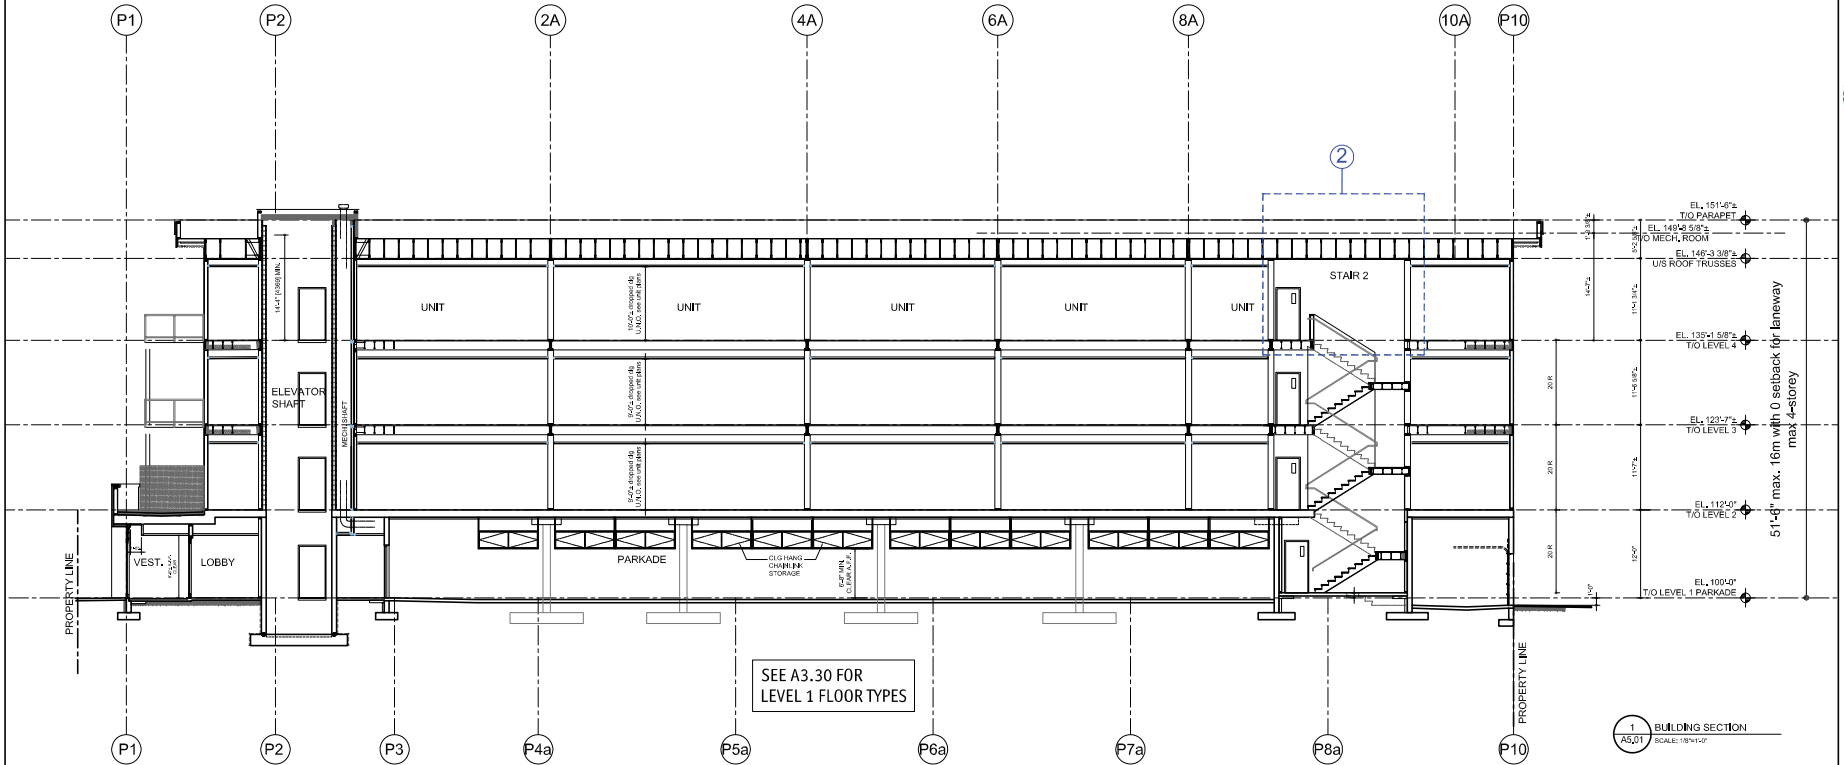

SCHEDULE

B

This forms part of application  
# DP25-0095


Planner  
Initials

TC

City of  
Kelowna

DEVELOPMENT PLANNING



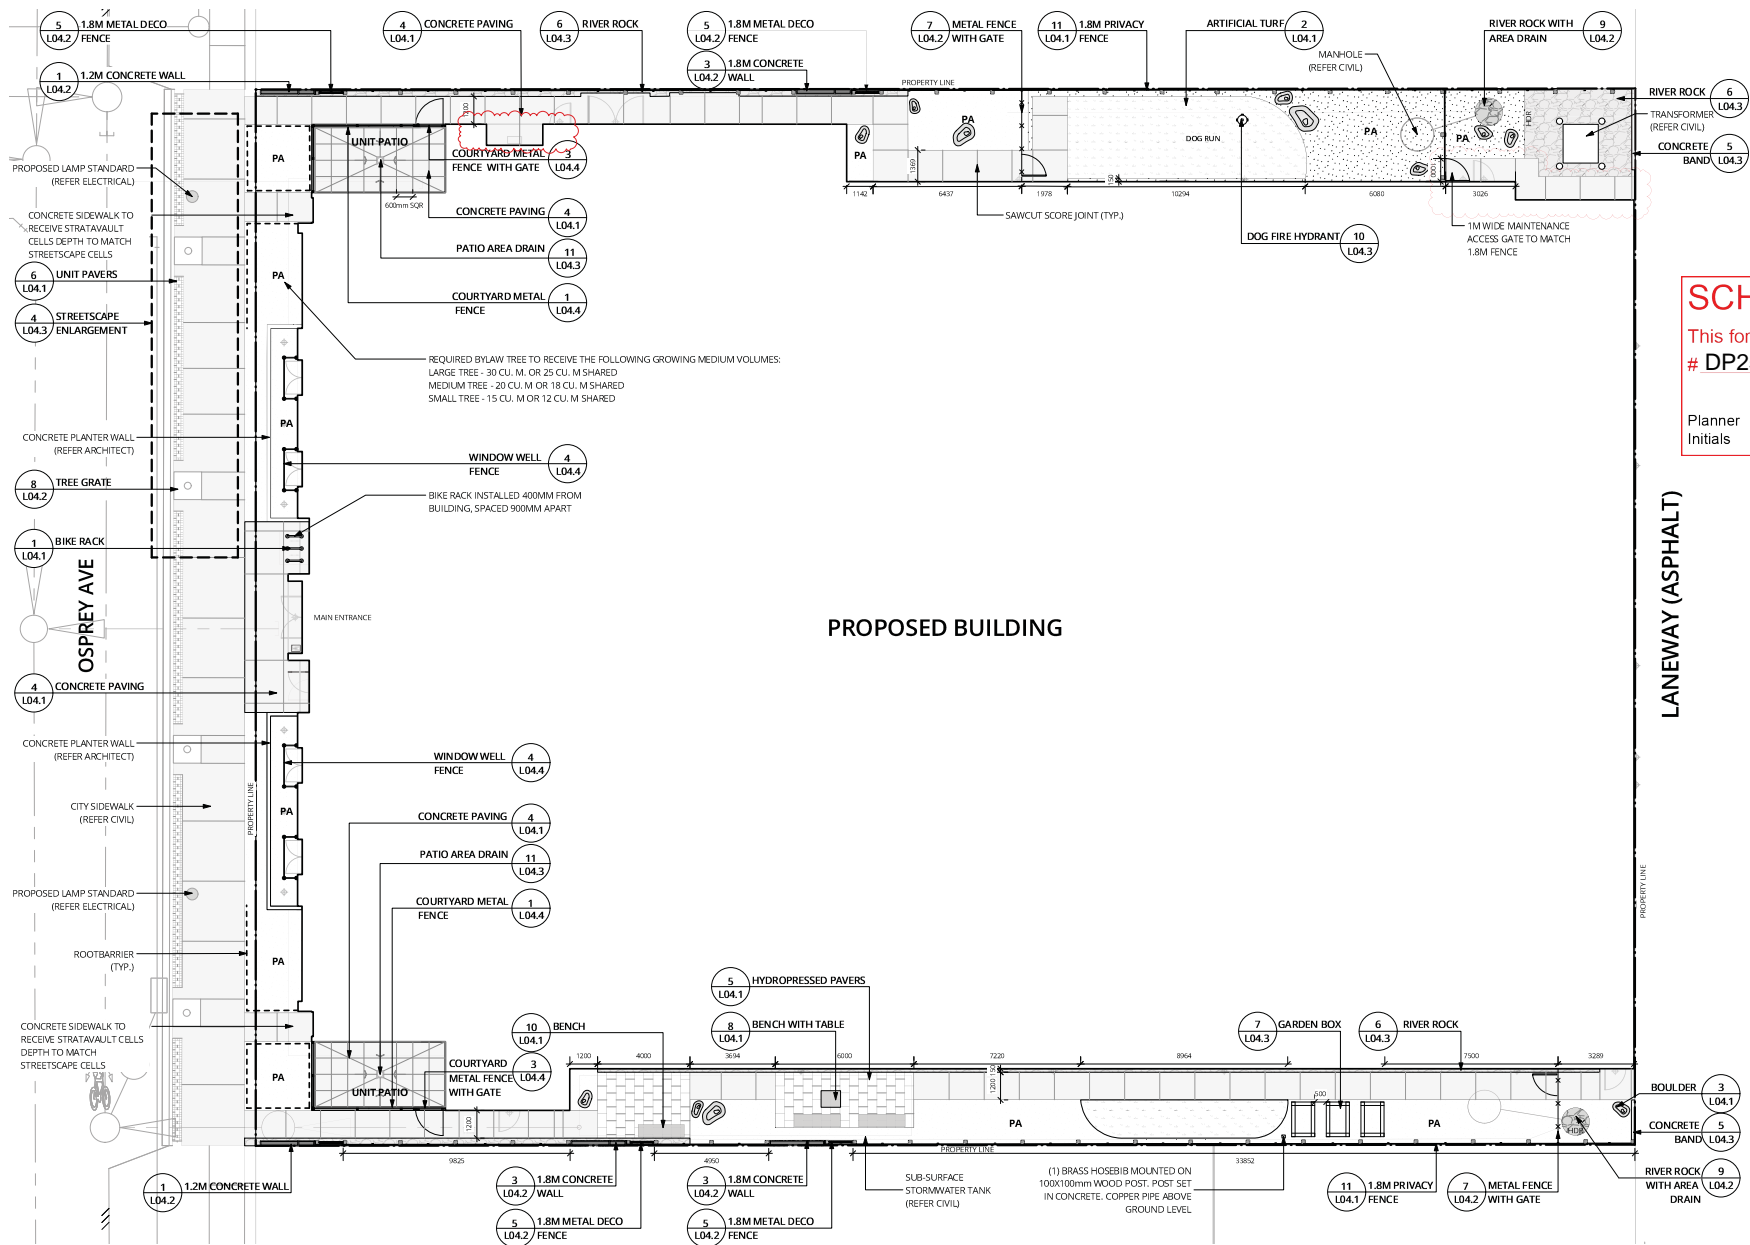

ISSUED FOR:		
NO.	DESCRIPTION	DATE
1	ISSUED FOR BUILDING PERMIT	2024-08-30
2	ISSUED FOR CONSTRUCTION	2024-09-14
3	ISSUED FOR CONSTRUCTION	2025-06-07



**NOTES:**

ALL PLANT MATERIAL SUPPLIED AND PLACED BY THE CONTRACTOR MUST BE CERTIFIED TO BE FREE OF SUDDEN OAK DEATH (PHYTOPHTHORA CANCELLANUS), SCAB (ECYDIPETIS BLIGHT), AND ANTHRAKNOSIS. IF THE CONTRACTOR IS A MEMBER OF THE CANADIAN FOOD INSPECTION AGENCY (CFIA) OR CANADIAN LANDSCAPE STANDARDS, THE CONTRACTOR SHALL PROVIDE A 1 (ONE) YEAR REPLACEMENT GUARANTEE ON ALL PLANT MATERIAL TO THE OWNER UNTIL THE DATE OF SUBSTANTIAL PERFORMANCE.

PLANT MATERIAL TO BE LAID OUT FOR REVIEW BY LANDSCAPE ARCHITECT PRIOR TO INSTALLATION. REFER GENERAL NOTES FOR MULCH REQUIREMENTS.

THE QUANTITIES SHOWN ON THE LABELS ARE NOT TO BE CONSTRUED AS THE COMPLETE AND ACCURATE LIMITS OF THE CONTRACT. FURNISH AND INSTALL ALL PLANTS SHOWN SCHEMATICALLY ON THE DRAWINGS.

GROWING MEDIUM SHALL BE PLACED AT 150mm MIN. DEPTH IN ALL TURF AREAS & 300mm MIN. DEPTH IN ALL PLANTING AREAS UNLESS OTHERWISE SHOWN ON THE DRAWINGS. THE CONTRACTOR IS TO STOCKPILE TOPSOIL MATERIAL ON SITE.

City of Kelowna

PROJECT # : 22030      DATE : 2022-03-14

## FORM & CHARACTER - DEVELOPMENT PERMIT GUIDELINES

Consideration has been given to the following guidelines as identified in Chapter 18 of the City of Kelowna 2040 Official Community Plan:

<b>RATE PROPOSALS COMPLIANCE TO PERTINENT GUIDELINE</b> <i>(1 is least complying &amp; 5 is highly complying)</i>	<b>N/A</b>	<b>1</b>	<b>2</b>	<b>3</b>	<b>4</b>	<b>5</b>
<b>CHAPTER 4.0: LOW &amp; MID-RISE RESIDENTIAL &amp; MIXED USE</b>						
<b>4.1 Guidelines</b>						
<b>4.1.1 Relationship to the Street</b>						
Lobby area and main building entrance is clearly visible from the fronting street and sidewalk.						✓
Wherever possible, blank walls at grade are not encouraged.					✓	
Enclosed parking garages are located away from street frontages or public open space.						✓
Ground oriented units with entries or glazing have been provided to avoid the blank/dead frontage along the street.						✓
When unavoidable, blank walls have been screened with landscaping or have been incorporated with a patio/café or special materials have been provided to make them visually interesting.						✓
<b>Residential and Mixed-use Buildings</b>						
Residential buildings at the ground floor have a set back between 3-5m from the property line to create a semi-private entry or transition zone to individual units and to allow for an elevated front entryway or raised patio.			✓			
A maximum 1.2m desired height (e.g., 5-6 steps) for front entryways has been provided. Where the water table requires this to be higher, in these cases, larger patio has been provided and parking has been screened with ramps, stairs, and landscaping.						✓
Ground floor units accessible from the fronting street or public open spaces have been provided with individual entrances.						✓
Buildings are sited and oriented so that windows and balconies are overlooking public streets, parks, walkways, and shared amenity spaces while minimizing views into private residences.						✓
<b>4.1.2 Scale and Massing</b>						
Proposed residential building façade has a length of 60m (40m length is preferred).						✓
Buildings over 40m in length are incorporating significant horizontal and vertical breaks in façade.	✓					
Proposed residential building has a maximum width of 24m.						✓
<b>4.1.3 Site Planning</b>						
On sloping sites, building floor levels are following the natural grade and avoiding the blank wall situation.	✓					

<b>RATE PROPOSALS COMPLIANCE TO PERTINENT GUIDELINE</b> <i>(1 is least complying &amp; 5 is highly complying)</i>	<b>N/A</b>	<b>1</b>	<b>2</b>	<b>3</b>	<b>4</b>	<b>5</b>
Building sides that are interfacing with streets, mid-block connections, and other open spaces (building fronts) are positively framing and activating streets and open spaces and supporting pedestrian activity.						✓
Larger buildings are broken up with mid-block connections which have public accessibility wherever possible.	✓					
Ground floors adjacent to mid block connections have entrances and windows facing the mid block connection.						✓
<b>4.1.4 Site Servicing, Access, and Parking</b>						
Vehicular access is provided from the lane.						✓
Where there is no lane, and where the re-introduction of a lane is difficult or not possible, access is provided from the street, provided: <ul style="list-style-type: none"> <li>• Access is from a secondary street, where possible, or from the long face of the block;</li> <li>• Impacts on pedestrians and the streetscape is minimized; and,</li> <li>• There is no more than one curb cut per property.</li> </ul>	✓					
When parking cannot be located underground due to the high water table and is to be provided above ground, screen the parking structure from public view as follows: <ul style="list-style-type: none"> <li>• On portions of the building that front a retail or main street, line the above ground parking with active retail frontage;</li> <li>• On portions of the building that front onto non-retail streets, line the above ground parking with an active residential frontage, such as ground oriented townhouse units;</li> <li>• When active frontages are not able to be accommodated, screen parking structures by using architectural or landscaped screening elements;</li> <li>• On corner sites, screen the parking structure from public view on both fronting streets using the appropriate strategy listed above.</li> </ul>						✓
Buildings with ground floor residential may integrate half-storey underground parking to a maximum of 1.2m above grade, with the following considerations: <ul style="list-style-type: none"> <li>• Semi-private spaces should be located above to soften the edge and be at a comfortable distance from street activity; and</li> <li>• Where conditions such as the high water table do not allow for this condition, up to 2m is permitted, provided that entryways, stairs, landscaped terraces, and patios are integrated and that blank walls and barriers to accessibility are minimized.</li> </ul>						✓
<b>4.1.5 Publicly Accessible and Private Open Spaces</b>						
Publicly accessible private spaces (e.g., private courtyards accessible and available to the public) have been integrated with public open areas to create seamless, contiguous spaces.	✓					

<b>RATE PROPOSALS COMPLIANCE TO PERTINENT GUIDELINE</b> <i>(1 is least complying &amp; 5 is highly complying)</i>	<b>N/A</b>	<b>1</b>	<b>2</b>	<b>3</b>	<b>4</b>	<b>5</b>
Semi-private open spaces have been located to maximize sunlight penetration, minimize noise disruptions, and minimize 'overlook' from adjacent units.					✓	
Outdoor Amenity Areas: design plazas and parks to: <ul style="list-style-type: none"> <li>Contain 'three edges' (e.g., building frontage on three sides) where possible and be sized to accommodate a variety of activities;</li> <li>Be animated with active uses at the ground level; and,</li> <li>Be located in sunny, south facing areas.</li> </ul>						✓
Mid-block connections design includes active frontages, seating, and landscaping.				✓		
<b>Rooftop Amenity Spaces</b>						
Shared rooftop amenity spaces (such as outdoor recreation space and rooftop gardens on the top of a parkade) are designed to be accessible to residents and to ensure a balance of amenity and privacy by: <ul style="list-style-type: none"> <li>Limiting sight lines from overlooking residential units to outdoor amenity space areas through the use of pergolas or covered areas where privacy is desired; and</li> <li>Controlling sight lines from the outdoor amenity space into adjacent or nearby residential units.</li> </ul>						✓
Reduce the heat island effect by including plants or designing a green roof, with the following considerations: <ul style="list-style-type: none"> <li>Secure trees and tall shrubs to the roof deck; and</li> <li>Ensure soil depths and types are appropriate for proposed plants and ensure drainage is accommodated.</li> </ul>					✓	
<b>4.1.6 Building Articulation, Features &amp; Materials</b>						
Articulate building facades into intervals that are a maximum of 15m wide for mixed-use buildings and 20m wide for residential buildings. Strategies for articulating buildings should consider the potential impacts on energy performance (see 2.2.1), and include: <ul style="list-style-type: none"> <li>Façade Modulation – stepping back or extending forward a portion of the façade to create a series of intervals in the facade;</li> <li>Repeating window patterns at intervals that correspond to extensions and step backs (articulation) in the building facade;</li> <li>Providing a porch, patio, deck, or covered entry for each interval;</li> <li>Providing a bay window or balcony for each interval, while balancing the significant potential for heat loss through thermal bridge connections which could impact energy performance;</li> <li>Changing the roof line by alternating dormers, stepped roofs, gables, or other roof elements to reinforce the modulation or articulation interval;</li> <li>Changing the materials with the change in building plane; and</li> <li>Provide a lighting fixture, trellis, tree, or other landscape feature within each interval.</li> </ul>						✓

<b>RATE PROPOSALS COMPLIANCE TO PERTINENT GUIDELINE</b> (1 is least complying & 5 is highly complying)	<b>N/A</b>	<b>1</b>	<b>2</b>	<b>3</b>	<b>4</b>	<b>5</b>
Break up the building mass by incorporating elements that define a building's base, middle and top.					✓	
Use an integrated, consistent range of materials and colors and provide variety by, for example, using accent colors.						✓
Articulate the facade using design elements that are inherent to the building as opposed to being decorative. For example, create depth in building facades by recessing window frames or partially recessing balconies to allow shadows to add detail and variety as a byproduct of massing.					✓	
<b>Weather Protection</b>						
Provide weather protection (e.g. awnings, canopies, overhangs, etc.) along all commercial streets and plazas (See Figure 42), with particular attention to the following locations: <ul style="list-style-type: none"> <li>• Primary building entrances,</li> <li>• Adjacent to bus zones and street corners where people wait for traffic lights;</li> <li>• Over store fronts and display windows; and</li> <li>• Any other areas where significant waiting or browsing by people occurs.</li> </ul>				✓		
<b>Signage</b>						
Provides attractive signage on commercial buildings that identifies uses and shops clearly but which is scaled to the pedestrian rather than the motorist. Some exceptions can be made for buildings located on highways and/or major arterials in alignment with the City's Sign Bylaw.						✓
Avoid the following types of signage: <ul style="list-style-type: none"> <li>• Internally lit plastic box signs;</li> <li>• Pylon (stand alone) signs; and</li> <li>• Rooftop signs.</li> </ul>						✓
Uniquely branded or colored signs are encouraged to help establish a special character to different neighbourhoods.					✓	

ATTACHMENT
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This forms part of application  
# DP25-0095

Planner  
Initials

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