## Development Permit DP23-0008





This permit relates to land in the City of Kelowna municipally known as

815 - 865 Clement Ave

and legally known as

Lot A Section 30 Township 26 ODYD Plan EPP124219

and permits the land to be used for the following development:

**Apartment Housing** 

The present owner and any subsequent owner of the above described land must comply with any attached terms and conditions.

Date of Council Approval: July 22, 2024

Development Permit Area: Form & Character

Existing Zone: MF<sub>3</sub>r – Apartment Housing Rental Only

Future Land Use Designation: C-NHD – Core Area Neighbourhood

This Development Permit is valid for two (2) years from the date of approval, with no opportunity to extend.

### This is NOT a Building Permit.

In addition to your Development Permit, a Building Permit may be required prior to any work commencing. For further information, contact the City of Kelowna, Development Services Branch.

### **NOTICE**

This permit does not relieve the owner or the owner's authorized agent from full compliance with the requirements of any federal, provincial or other municipal legislation, or the terms and conditions of any easement, covenant, building scheme or agreement affecting the building or land.

Owner: ASI Vivo GP Inc., Inc. No. A0126515
Applicant: Arlington Street Investments Inc.

Nola Kilmartin
Development Planning Department Manager
Planning & Development Services

Date of Issuance



#### 1. SCOPE OF APPROVAL

This Development Permit applies to and only to those lands within the Municipality as described above, and any and all buildings, structures and other development thereon.

This Development Permit is issued subject to compliance with all of the Bylaws of the Municipality applicable thereto, except as specifically varied or supplemented by this permit, noted in the Terms and Conditions below.

The issuance of a permit limits the permit holder to be in strict compliance with regulations of the Zoning Bylaw and all other Bylaws unless specific variances have been authorized by the Development Permit. No implied variances from bylaw provisions shall be granted by virtue of drawing notations that are inconsistent with bylaw provisions and that may not have been identified as required Variances by the applicant or Municipal staff.

#### 2. CONDITIONS OF APPROVAL

THAT Council authorizes the issuance of Development Permit No. DP23-0008 for Lot A Section 30 Township 26 ODYD Plan EPP124219 located at 815 – 865 Clement Ave, Kelowna, BC, subject to the following:

- a) The dimensions and siting of the building to be constructed on the land be in accordance with Schedule "A";
- b) The exterior design and finish of the building to be constructed on the land be in accordance with Schedule "B";
- c) Landscaping to be provided on the land be in accordance with Schedule "C";
- d) The applicant be required to post with the City a Landscape Performance Security deposit in the amount of 125% of the estimated value of the Landscape Plan, as determined by a Registered Landscape Architect;
- e) The applicant be required to make a payment into the Public Amenity & Streetscape Capital Reserve Fund as established by Bylaw No. 12386 in accordance with Table 6.8.a. in Zoning Bylaw No. 12375;

AND FURTHER THAT this Development Permit is valid for two (2) years from the date of Manager approval, with no opportunity to extend.

#### 3. PERFORMANCE SECURITY

As a condition of the issuance of this Permit, Council is holding the security set out below to ensure that development is carried out in accordance with the terms and conditions of this Permit. Should any interest be earned upon the security, it shall accrue to the Developer and be paid to the Developer or his or her designate if the security is returned. The condition of the posting of the security is that should the Developer fail to carry out the development hereby authorized, according to the terms and conditions of this Permit within the time provided, the Municipality may use enter into an agreement with the property owner of the day to have the work carried out, and any surplus shall be paid over to the property owner of the day. Should the Developer carry out the development as per the conditions of this permit, the security shall be returned to the Developer or his or her designate following proof of Substantial Compliance as defined in Bylaw No. 12310. There is filed accordingly:

a) An Irrevocable Letter of Credit OR certified cheque OR a Surety Bond in the amount of \$224,000.00

Before any bond or security required under this Permit is reduced or released, the Developer will provide the City with a statutory declaration certifying that all labour, material, workers' compensation and other taxes and costs have been paid.

#### 4. PUBLIC AMENITY & STREETSCAPE CAPITAL RESERVE FUND

Public Amenity & Streetscape Capital Reserve Fund Payment in the amount of \$93,376.72 required for 4577.29 m² lot area as part of the proposed development.

#### 5. INDEMNIFICATION


Upon commencement of the works authorized by this Permit the Developer covenants and agrees to save harmless and effectually indemnify the Municipality against:

a) All actions and proceedings, costs, damages, expenses, claims, and demands whatsoever and by whomsoever brought, by reason of the Municipality said Permit.

All costs, expenses, claims that may be incurred by the Municipality where the construction, engineering or other types of works as called for by the Permit results in damages to any property owned in whole or in part by the Municipality or which the Municipality by duty or custom is obliged, directly or indirectly in any way or to any degree, to construct, repair, or maintain.

The PERMIT HOLDER is the <u>CURRENT LAND OWNER</u>. Security shall <u>ONLY</u> be returned to the signatory of the Landscape Agreement or their designates.



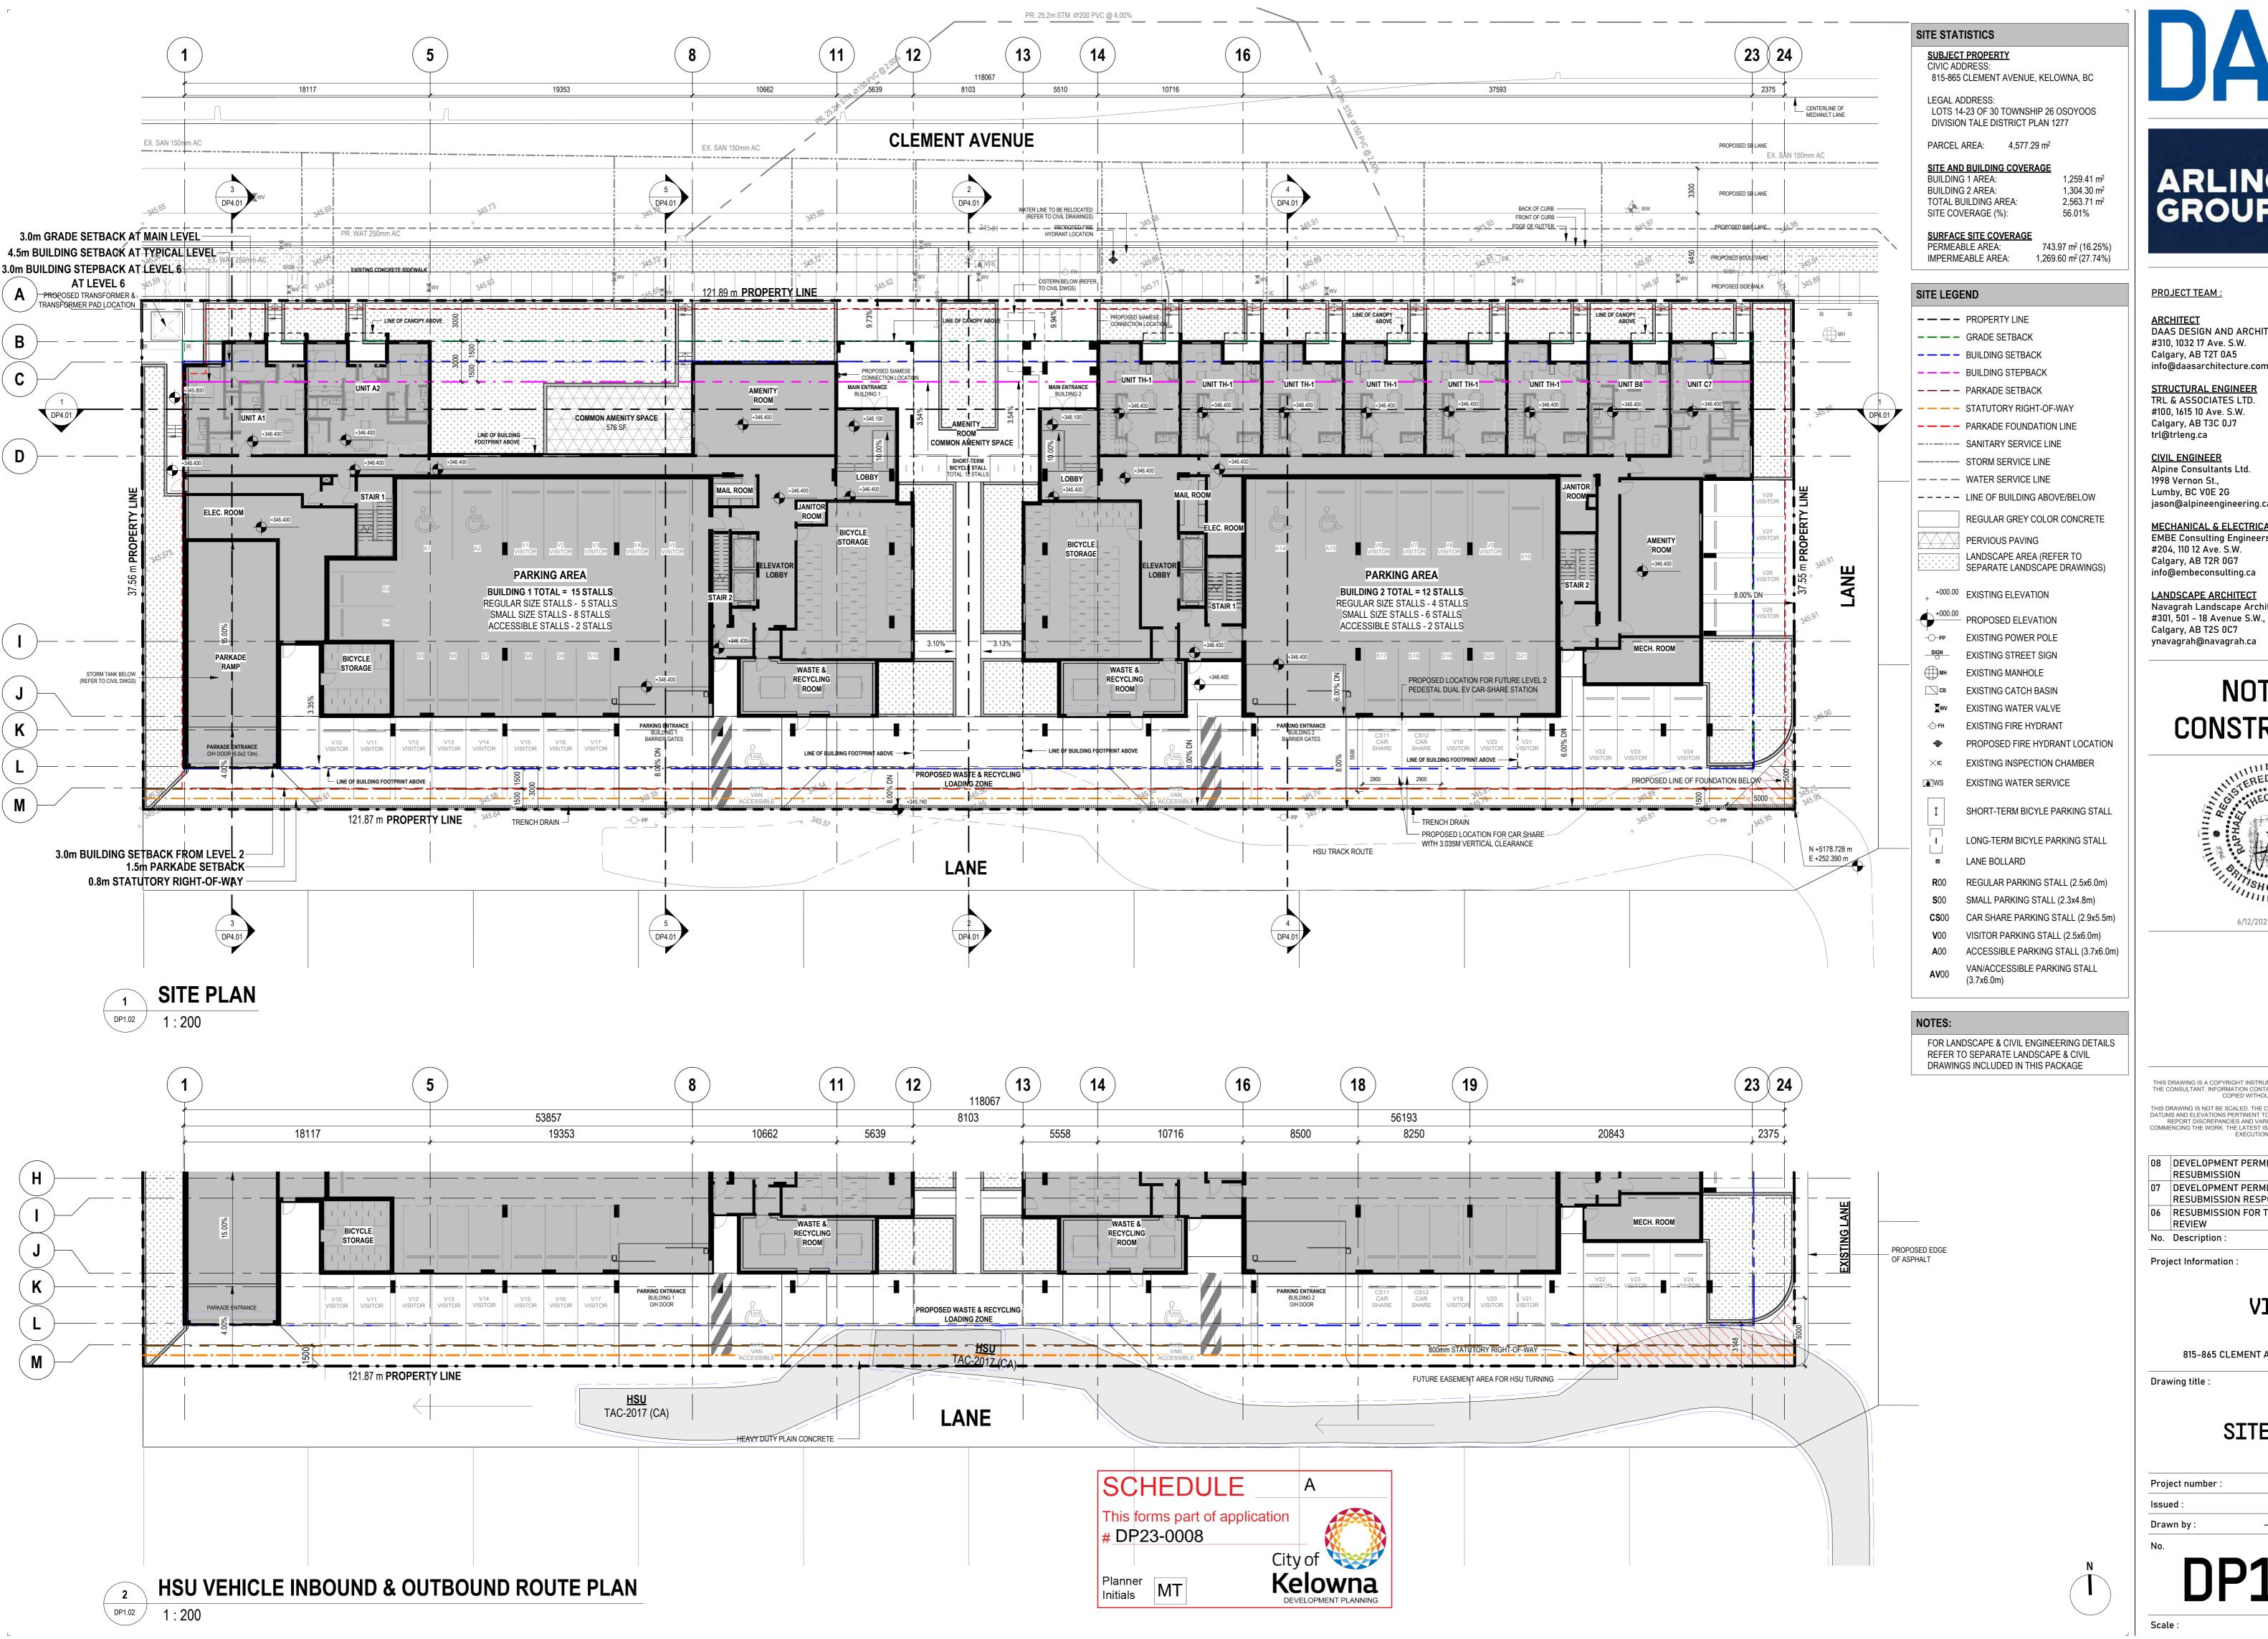

DAAS DESIGN AND ARCHITECTURE STUDIO INC. #310, 1032 17 Ave. S.W. Calgary, AB T2T 0A5

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LANDSCAPE ARCHITECT Navagrah Landscape Architecture #301, 501 - 18 Avenue S.W., Calgary, AB T2S 0C7 ynavagrah@navagrah.ca

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80	DEVELOPMENT PERMIT RESUBMISSION	JUNE 12, 2024
07	DEVELOPMENT PERMIT	MAY 16, 2024
0,	RESUBMISSION RESPONSE	117 10, 2024
06	RESUBMISSION FOR TECHNICAL REVIEW	FEBRUARY 22, 2024
No.	Description :	Date :

VIVO

815-865 CLEMENT AVENUE, KELOWNA, BC


SITE PLAN

Project number :			23-014
Issued :		JU	NE 12, 2024
Drawn by :	-	Checked by :	TS, RN

PARKADE LEVEL 1 FLOOR PLAN

DP2.01



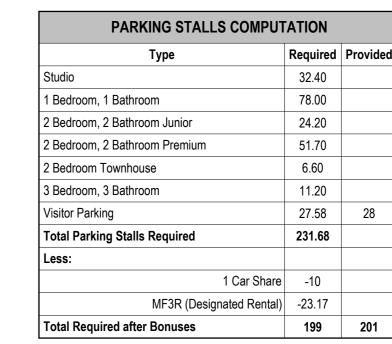

PARKING STALL SIZE DISTRIBUTION				
Туре	Required	Provided		
Accessible Parking Stall-Regular (3.7x6.0m)	6*	6**		
Van Accessible Parking Stall (4.8x6.0m)	2*	2**		
Regular Size Parking Stalls-min.50% (2.5x6.0m)	100.50	101		
Small Size Parking Stalls-max.50% (2.3x4.8m)	100.50	100		
Total Parking Stalls	199	201		

### NOTES:

provided.

VEHICLE PARKING STALLS

Unless otherwise stated all parking stalls reflects Kelowna Bylaw

Regular Vehicle Parking Stall (2.5x6.0m) Small Vehicle Parking Stall (2.3x4.8m) Accessible Vehicle Parking Stall (3.7x6.0m)

\* The number of van-accessible parking spaces is included in the minimum required accessible parking spaces. \*\* 2 Van-accessible parking included in 6 Accessible Parking stalls

**BICYCLE PARKING STALLS** Bike Stalls reflects Kelowna Bylaw Standards & Regulations.





PROJECT TEAM:

ARCHITECT

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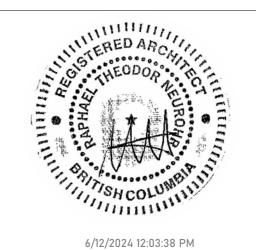
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No.	Description :	Date :

VIVO

815-865 CLEMENT AVENUE, KELOWNA, BC

Drawing title :

Project Information:

### PARKADE FLOOR PLANS

Project number :			23-014
Issued :		JUI	NE 12, 2024
Drawn by :	-	Checked by:	TS, RN

3176

PROPOSED

TRANSFORMER

В

 $\left( \mathbf{G} \right) \frac{\mathcal{E}}{\mathcal{E}}$ 

6754

2257

LINE OF CANOPY ABOVE

2938

2306

CONCRETE SIDEWALK

**EXIT CORRIDOR** 

ELEC. ROOM

12454

3335

+346.400

4775

9885

PARKADE RAMP

RAMP WIDTH

**STORM TANK** BELOW PARKADE ENTRANCE RAMP (REFER TO CIVIL DWGS)

PARKADE ENTRANCE

O/H DOOR<sub>1</sub>(6.5x2.13m)

DP4.01

6754

3054

**BUILDING 1 - LEVEL 1 FLOOR PLAN** 

1 DP2.02

+345.390

4775

LINE OF CANOPY ABOVE

1054

3037

6039

53771

2764

2764

1616

1148

3824

8879

UNIT A2

720 SF

+346.400

2569

2231

**BICYCLE** 

STORAGE

TOTAL STALLS: 20 STALLS

- LINE OF BUILDING ABOVE

3824

+346.400

1828

1995

5512

121.89 m PROPERTY LINE

3.0m GRADE SETBACK AT MAIN LEVEL

3.0m BUILDING STEPBACK AT LEVEL 6

LANDSCAPE AREA

3700

2700

3700

2500

V12 VISITOR

2764

2300

VISITOR

1.5m PARKADE SETBACK

1.87 m. PROPERTY LINE

5512

2500

VISITOR

4.5m BUILDING SETBACK AT TYPICAL LEVEL

8250

19353

8250

LINE OF BUILDING ABOVE

2500

VISITOR

PARKING AREA

4487 SF PARKING AREA (BUILDING 1) TOTAL = 15 STALLS REGULAR SIZE STALLS - 5 STALLS SMALL SIZE STALLS - 8 STALLS

ACCESSIBLE STALLS - 2 STALLS

PROPOSED MECHANICAL

VISITOR

2300

2700

VISITOR

S10

2500

VISITOR

This forms part of application

#DP23-0008

Planner Initials MT

3.0m GRADE SETBACK AT MAIN LEVEL

8250

53771

2700

VISITOR

VISITOR

DRIVE AISLE

+346.400

PARKING ENTRANCE

BUILDING 1

BARRIER GATES

5591

5591

5591

COMMON AMENITY SPACE

(PERVIOUS PAVING)

564 SF

1286

3433

LANDSCAPE AREA

10326

AMENITY ROOM

+346.400

**ELEVATOR** 

LOBBY

2639

+346.400

JANITOR ROO

RECYCLING

ROOM

422 SF

9936

5944

3227

MAIL ROOM

2927

VAN

-ACCESSIBLE

10

3433

1286

Kelowna

5944

5944

5639

5607

LINE OF CANOPY ABOVE —

MAIN ENTRANCE

**BUILDING 1** 

BICYCLE STALL

TOTAL: 6 STALLS

2613

BICYCLE

STORAGE

TOTAL STALLS: **54 STALLS** 

1800

**- 8400** -

LINE OF BUILDING ABOVE —

5639

PROPOSED WASTE & RECYCLING

LOBBY

302 SF

+346.400

2871

2768



PROJECT TEAM:

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**KEY PLAN** CLEMENT AVENUE

\_\_\_\_\_\_ **BUILDING 2** 

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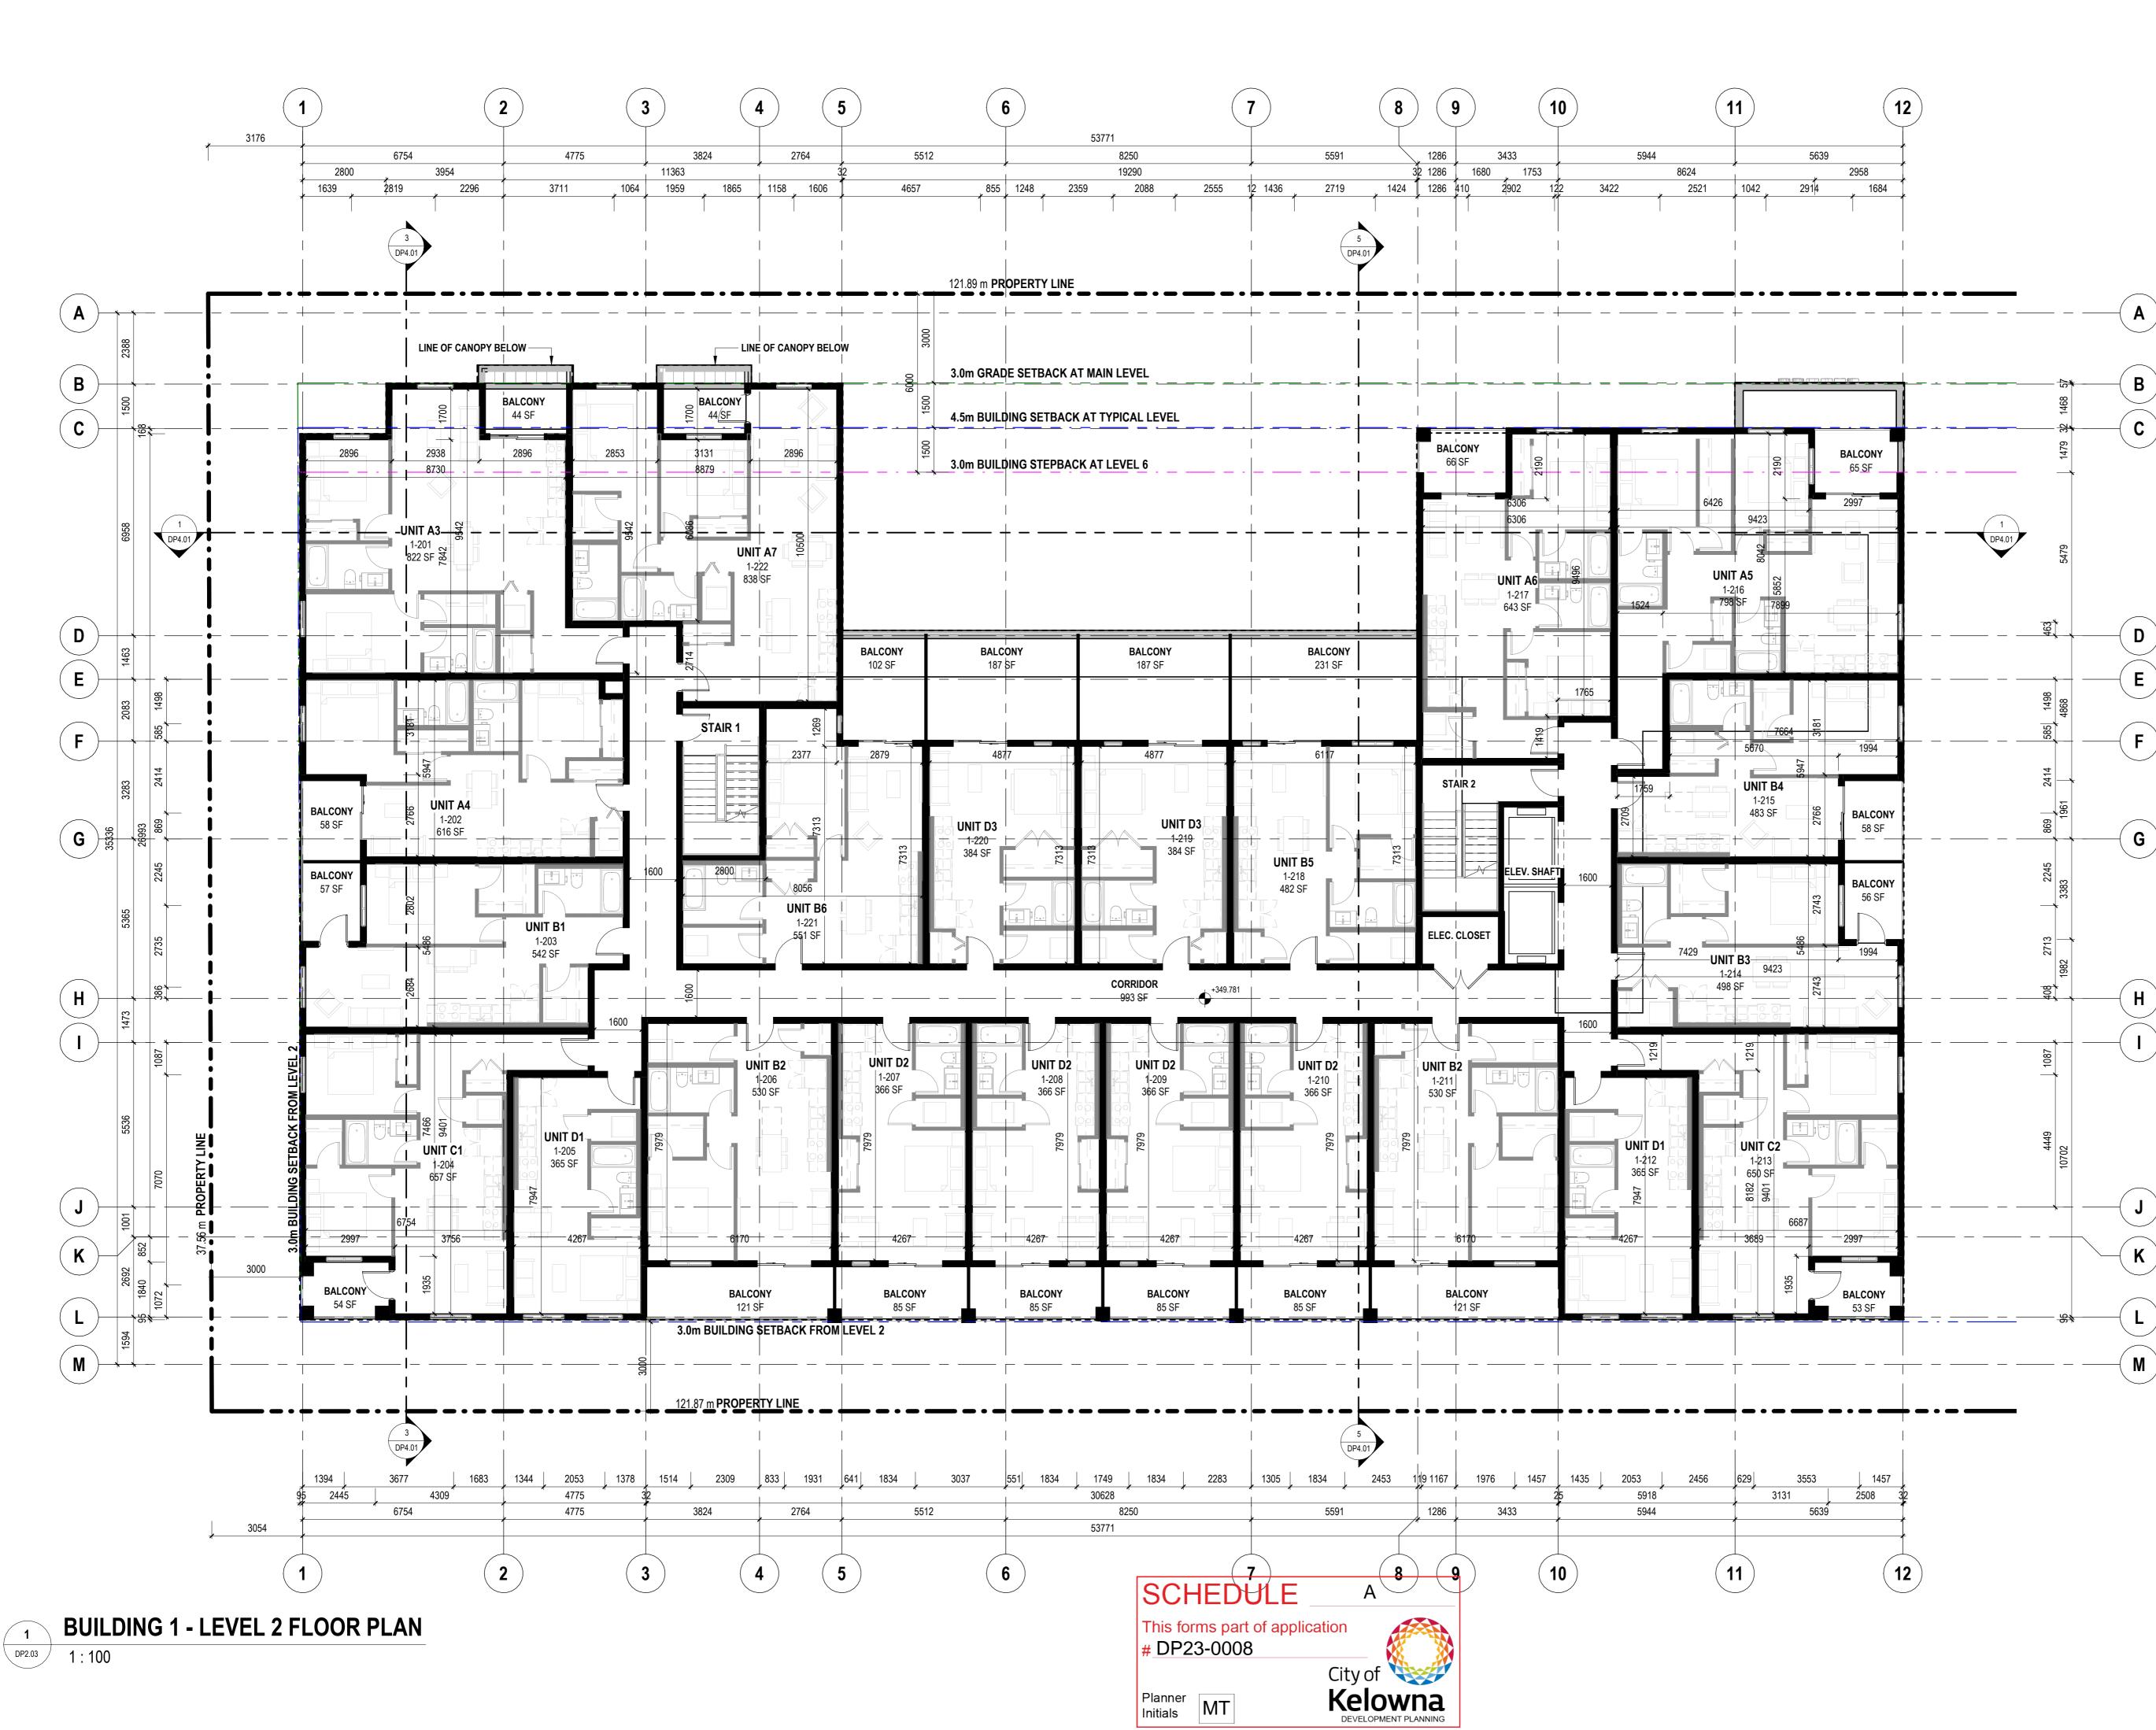
VIVO

815-865 CLEMENT AVENUE, KELOWNA, BC

Drawing title :

### BUILDING 1 - LEVEL 1 **FLOOR PLAN**

23-014 Project number JUNE 12, 2024 - Checked by: TS, RN





ARCHITECT
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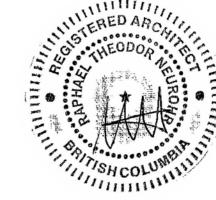
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**KEY PLAN** CLEMENT AVENUE



**BUILDING 2** 

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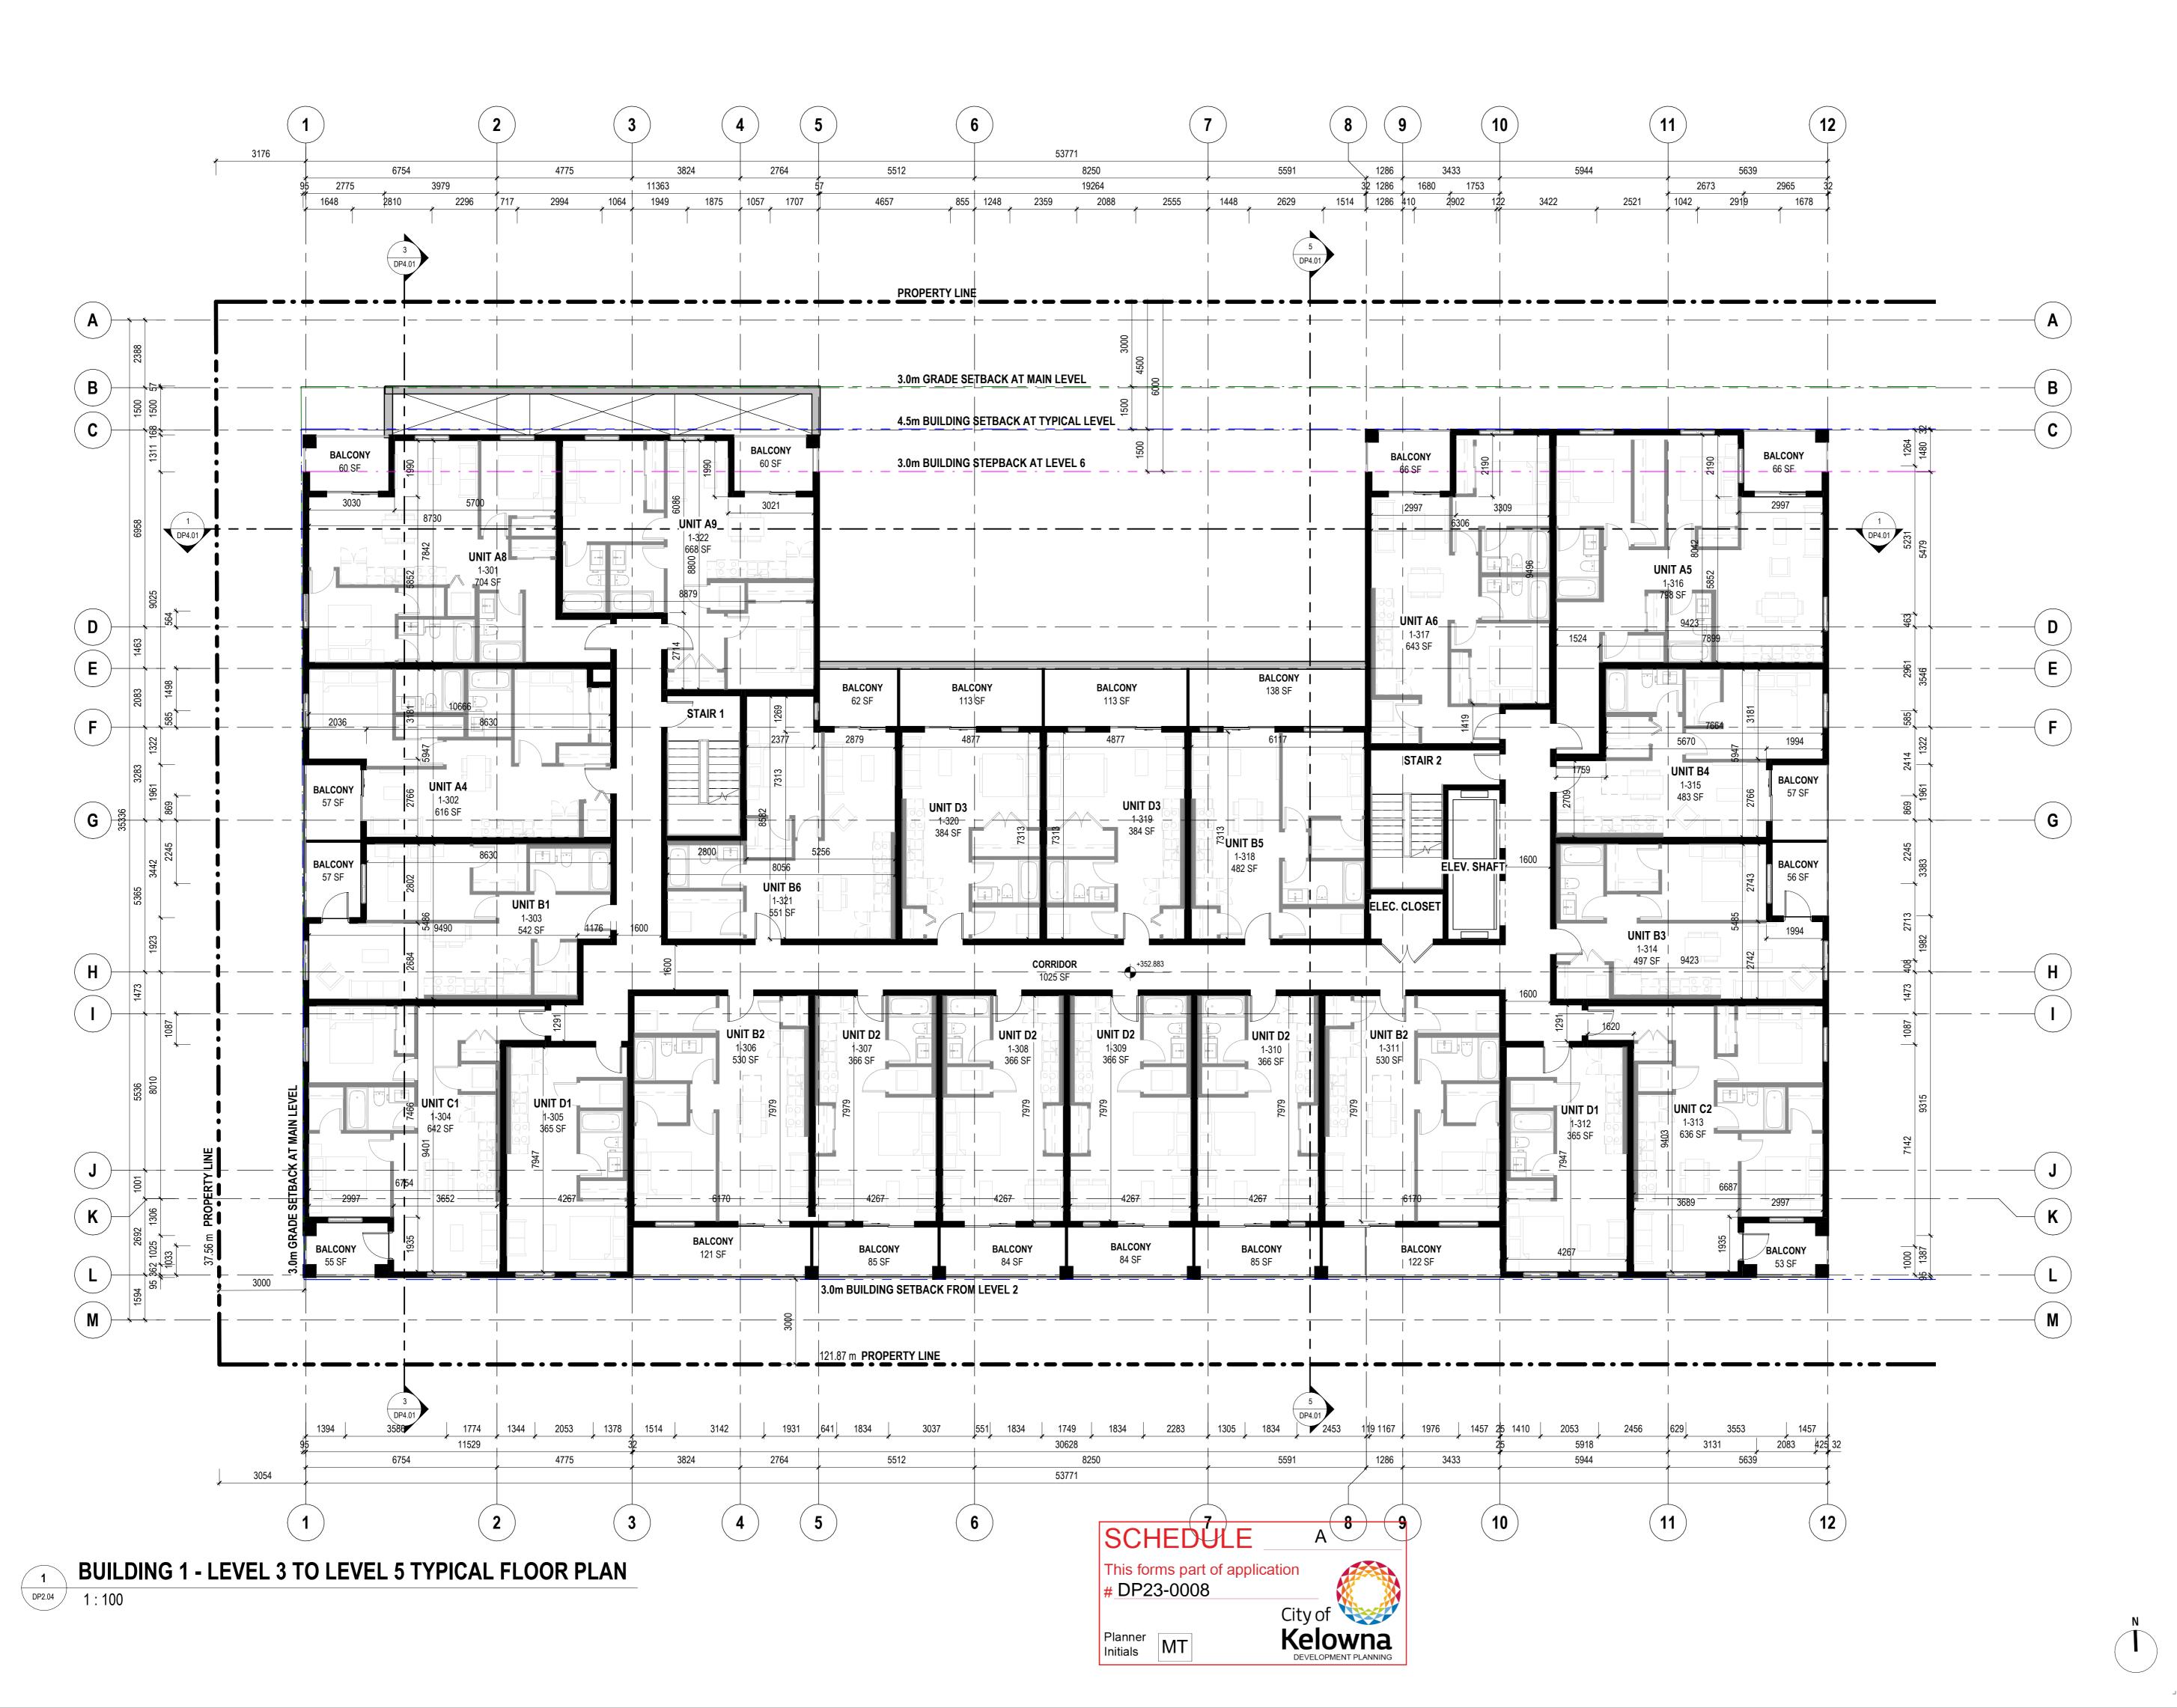
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No.	Description :	Date :

VIVO

815-865 CLEMENT AVENUE, KELOWNA, BC

BUILDING 1 - LEVEL 2 **FLOOR PLAN** 

23-014 JUNE 12, 2024 - Checked by: TS, RN





PROJECT TEAM:

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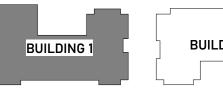
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CLEMENT AVENUE



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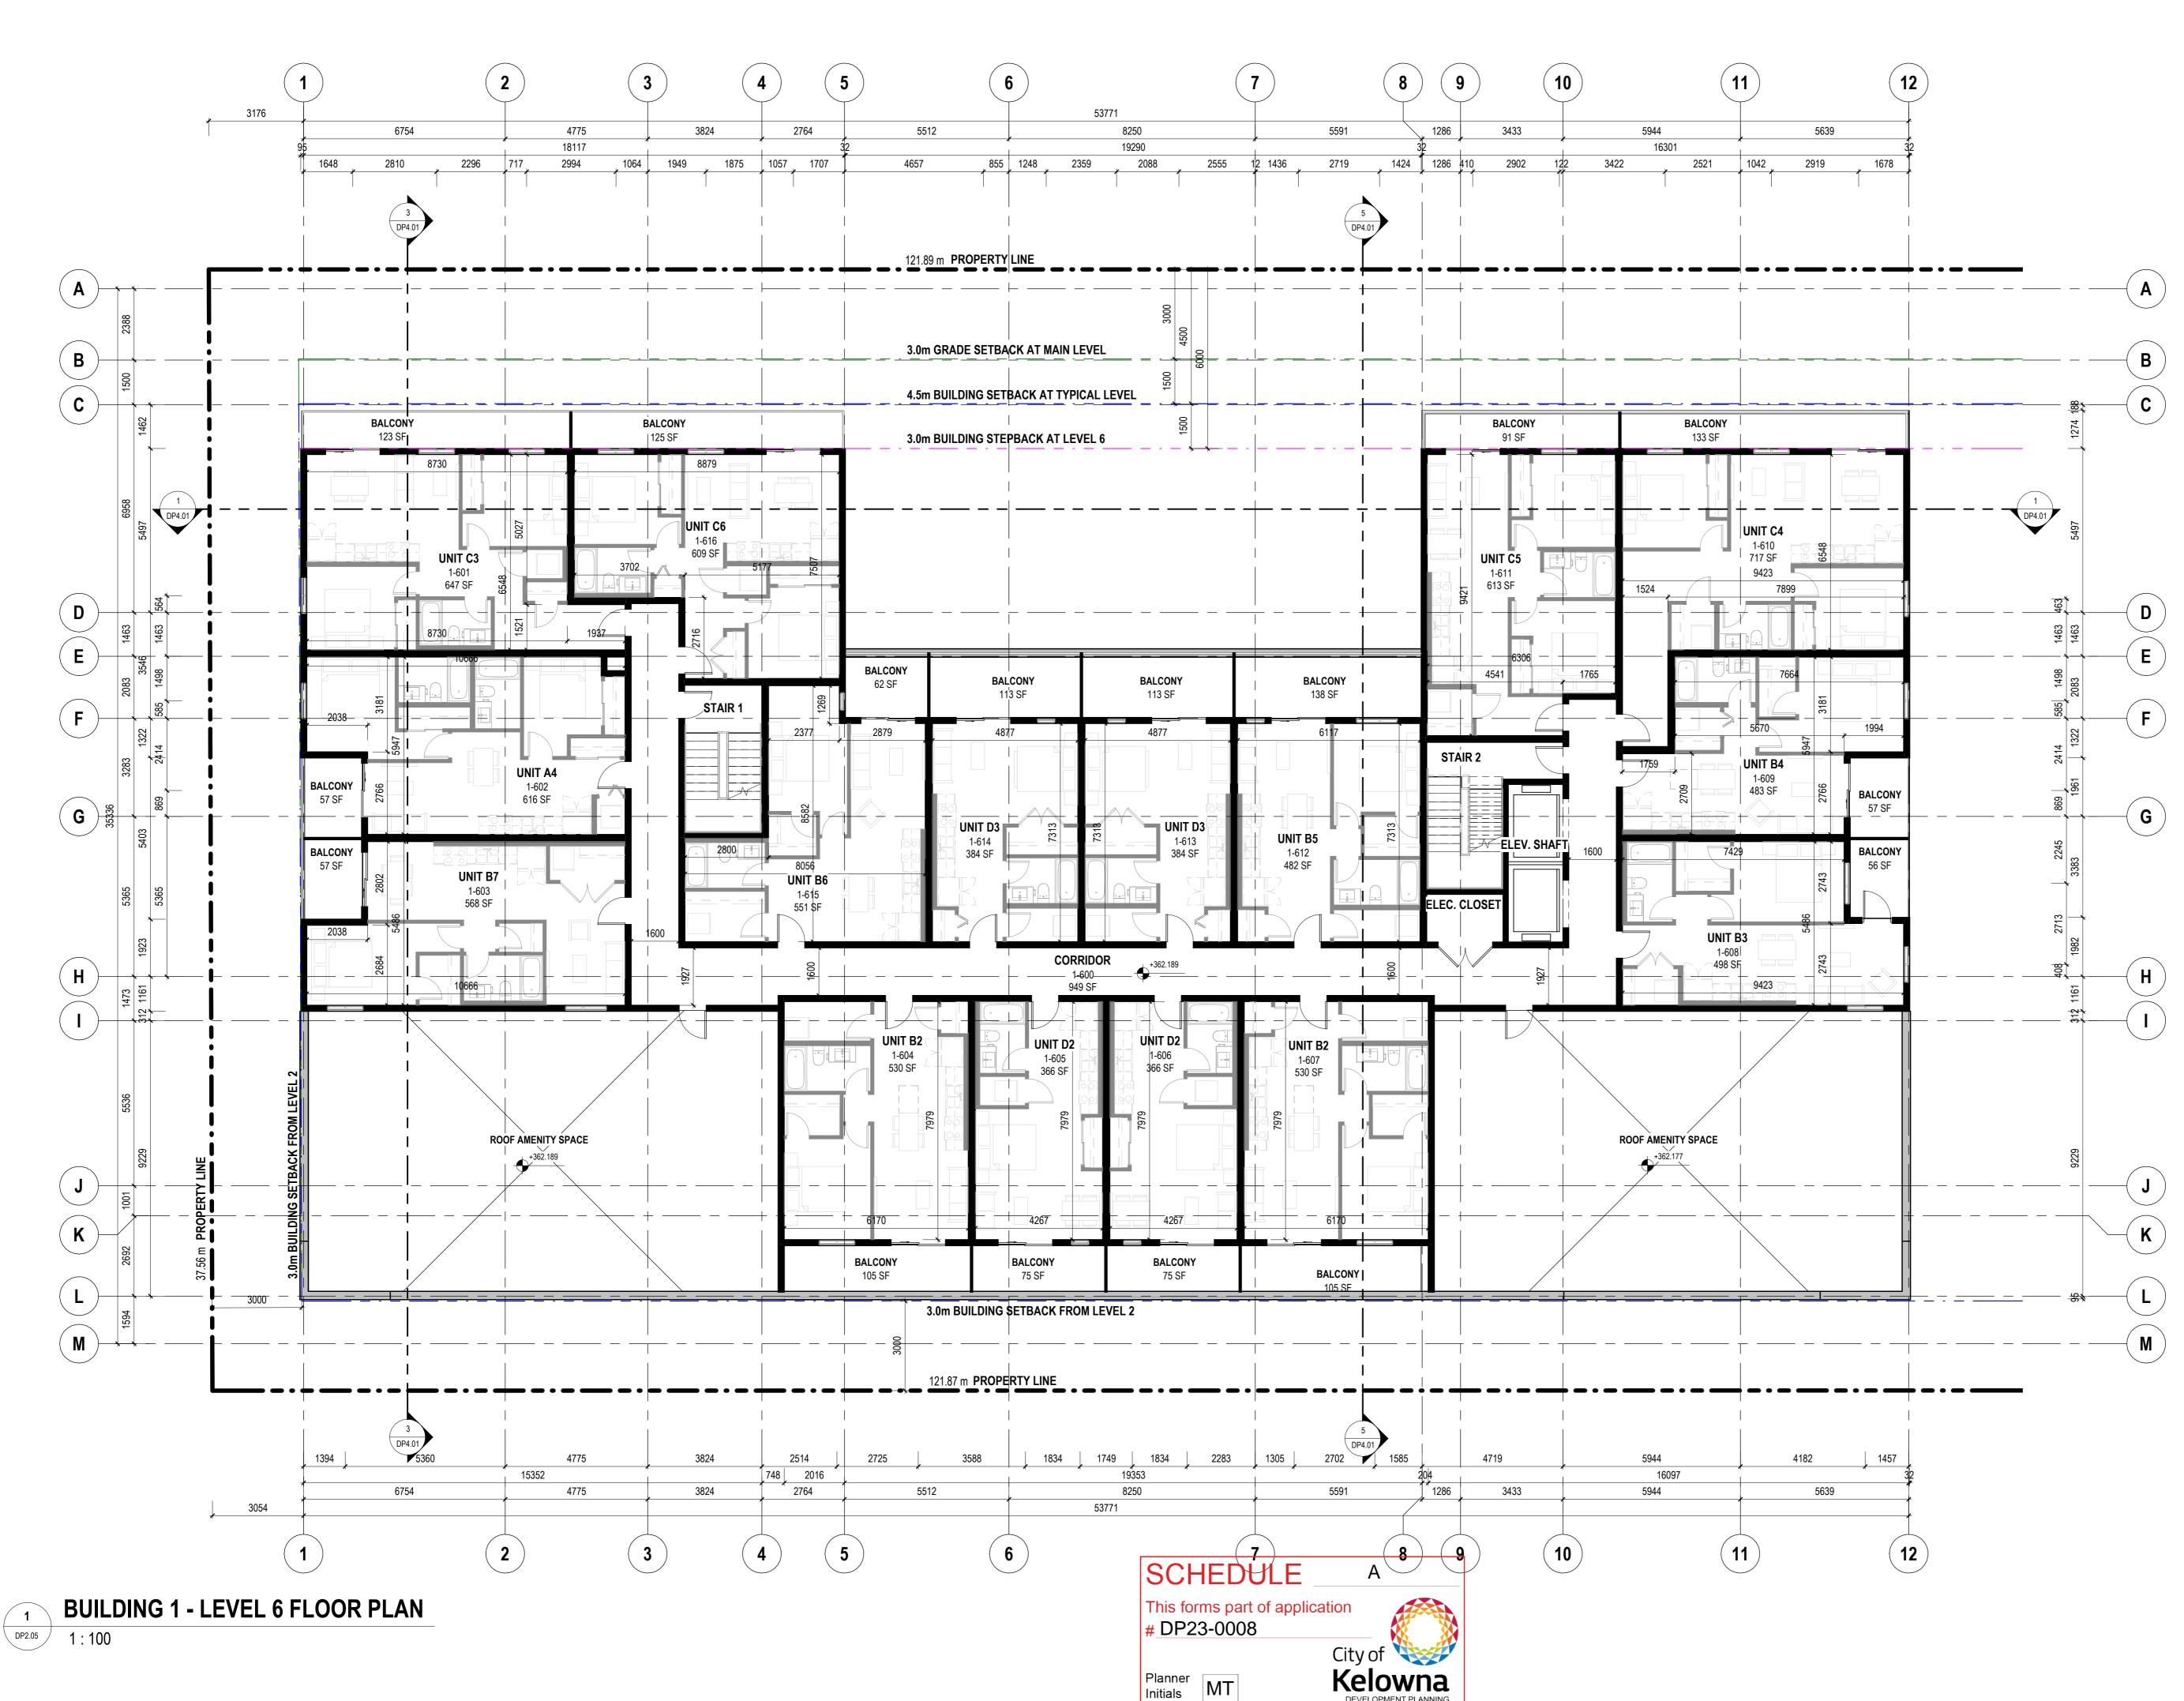
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06	RESUBMISSION FOR TECHNICAL REVIEW	FEBRUARY 22, 2024
No.	Description :	Date :

815-865 CLEMENT AVENUE, KELOWNA, BC

Drawing title :

**BUILDING 1 - TYPICAL FLOOR PLAN** 

Project number JUNE 12, 2024 Issued : - Checked by: TS, RN Drawn by:





PROJECT TEAM:

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**KEY PLAN** CLEMENT AVENUE



**BUILDING 2** 

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	REVIEW	2024
No.	Description :	Date :

VIVO

815-865 CLEMENT AVENUE, KELOWNA, BC

Drawing title :

BUILDING 1 – LEVEL 6 **FLOOR PLAN** 

23-014 Project number JUNE 12, 2024 - Checked by: TS, RN Drawn by:



PROJECT TEAM:

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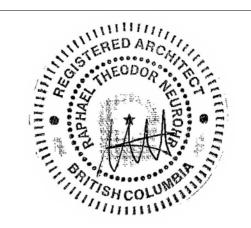
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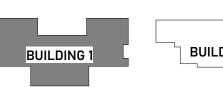
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	REVIEW	2024
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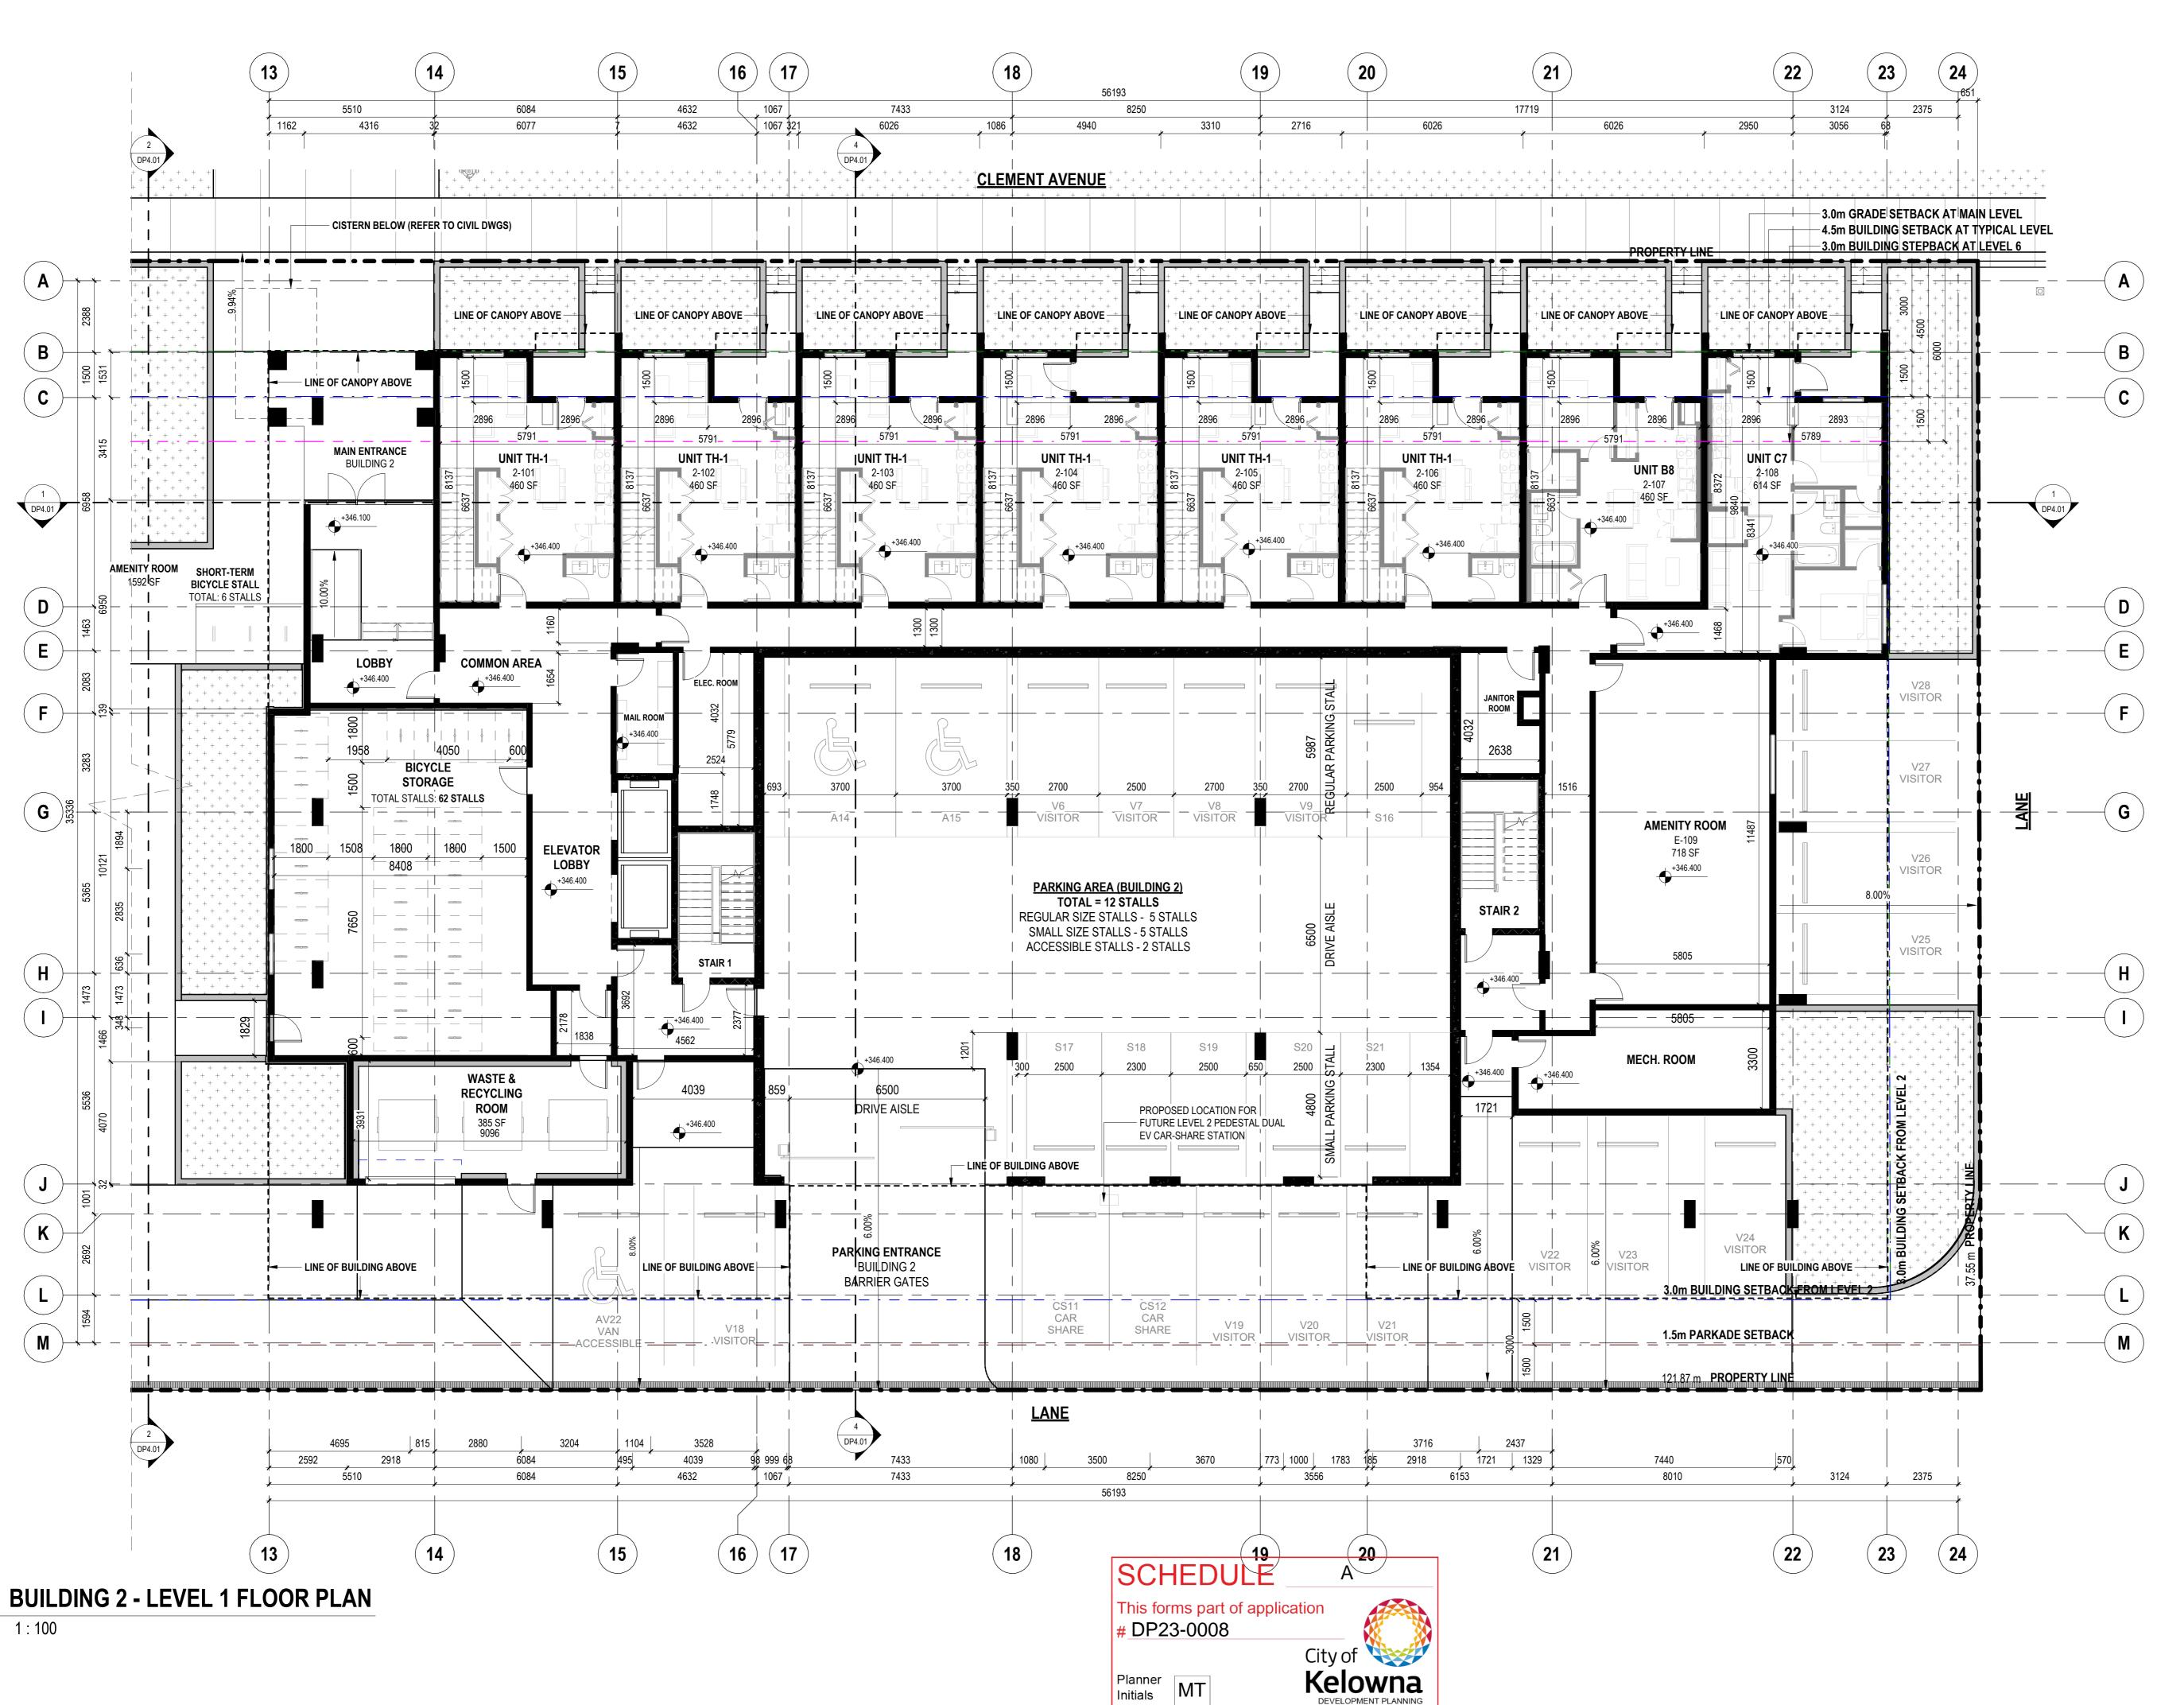
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Drawing title :

Project Information:

BUILDING 1 - ROOF PLAN

Project number :		23-014	
Issued :		JUL	NE 12, 2024
Drawn by :	-	Checked by:	TS, RN



1 DP2.07



# ARLINGTON ST GROUP

DAAS DESIGN AND ARCHITECTURE STUDIO INC.

Navagrah Landscape Architecture

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**KEY PLAN** CLEMENT AVENUE

BUILDING 2

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815-865 CLEMENT AVENUE, KELOWNA, BC

**BUILDING 2 - LEVEL 1 FLOOR PLAN** 

23-014 JUNE 12, 2024 - Checked by: TS, RN



**PROJECT TEAM:** 

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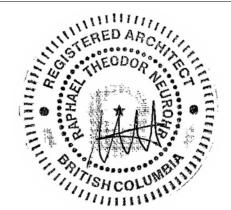
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LANDSCAPE ARCHITECT

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Calgary, AB T2S 0C7
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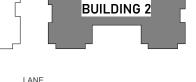
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KEY PLAN
CLEMENT AVENUE





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80	DEVELOPMENT PERMIT	JUNE 12, 2024
	RESUBMISSION	
07	DEVELOPMENT PERMIT	MAY 16, 2024
	RESUBMISSION RESPONSE	
06	RESUBMISSION FOR TECHNICAL REVIEW	FEBRUARY 22, 2024
No.	Description :	Date :

VIVO

815-865 CLEMENT AVENUE, KELOWNA, BC

Drawing title :

Project Information:

### BUILDING 2 - LEVEL 2 FLOOR PLAN

 Project number :
 23-014

 Issued :
 JUNE 12, 2024

 Drawn by :
 - Checked by :
 TS, RN

DP2.08

ale:

Initials



# ARLINGTON ST GROUP

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info@daasarchitecture.com

trl@trleng.ca <u>CIVIL ENGINEER</u> Alpine Consultants Ltd.


1998 Vernon St., Lumby, BC V0E 2G jason@alpineengineering.ca

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**KEY PLAN** CLEMENT AVENUE





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80	DEVELOPMENT PERMIT	JUNE 12, 2024
	RESUBMISSION	
07	DEVELOPMENT PERMIT	MAY 16, 2024
	RESUBMISSION RESPONSE	
06	RESUBMISSION FOR TECHNICAL	FEBRUARY 22,
	REVIEW	2024
No.	Description :	Date :

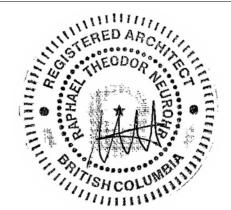VIVO

815-865 CLEMENT AVENUE, KELOWNA, BC

Drawing title :

BUILDING 2 - TYPICAL **FLOOR PLAN** 

23-014 Project number JUNE 12, 2024 Issued : - Checked by: TS, RN Drawn by



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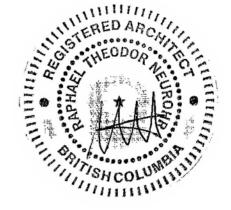
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KEY PLAN
CLEMENT AVENUE





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06	RESUBMISSION FOR TECHNICAL REVIEW	FEBRUARY 22, 2024
No.	Description :	Date :

VIVO

815-865 CLEMENT AVENUE, KELOWNA, BC

Drawing title :

Project Information :

### BUILDING 2 – LEVEL 6 FLOOR PLAN

Project number: 23-014

Issued: JUNE 12, 2024

Drawn by: - Checked by: TS, RN

DP2.10

cale :

4 12:04:10 PM



PROJECT TEAM:

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DAAS DESIGN AND ARCHITECTURE STUDIO INC.
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KEY PLAN
CLEMENT AVENUE

BUILDING 2

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80	DEVELOPMENT PERMIT	JUNE 12, 202
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07	DEVELOPMENT PERMIT	MAY 16, 2024
	RESUBMISSION RESPONSE	
06	RESUBMISSION FOR TECHNICAL	FEBRUARY 2
	REVIEW	2024
No.	Description :	Date :

VIVO

815-865 CLEMENT AVENUE, KELOWNA, BC

Drawing title :

Project Information:

**BUILDING 2 - ROOF PLAN** 

 Project number :
 23-014

 Issued :
 JUNE 12, 2024

 Drawn by :
 - Checked by : TS, RN

DP2.11


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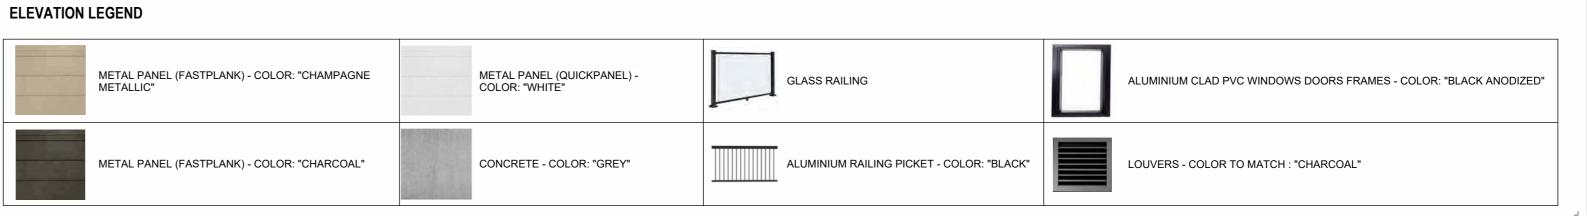


# NORTH ELEVATION (STREET) 1: 200







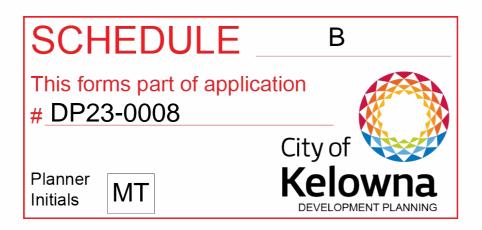

# DAAS



PROJECT TEAM:

ARCHITECT
DAAS DESIGN AND ARCHITECTURE STUDIO INC.
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1998 Vernon St

1998 Vernon St., Lumby, BC V0E 2G jason@alpineengineering.ca


MECHANICAL & ELECTRICAL ENGINEER EMBE Consulting Engineers Inc.

#204, 110 12 Ave. S.W. Calgary, AB T2R 0G7 info@embeconsulting.ca


LANDSCAPE ARCHITECT

Navagrah Landscape Architecture #301, 501 - 18 Avenue S.W., Calgary, AB T2S 0C7 ynavagrah@navagrah.ca

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	RESUBMISSION RESPONSE	
06	RESUBMISSION FOR TECHNICAL	FEBRUARY 22,
	REVIEW	2024
No.	Description :	Date :
l		

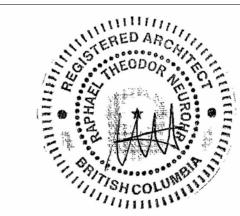Project Information :

VIVO

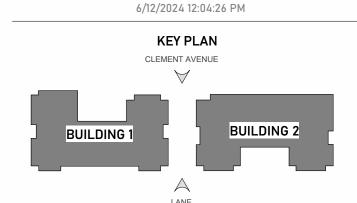815-865 CLEMENT AVENUE, KELOWNA, BC

Drawing title :

Scale:

# COMPOSITION ELEVATIONS

Project number :	23-014
Issued :	JUNE 12, 2024
Drawn by :	- Checked by : TS, RN
No.	
	10.01

DP3.01

As indicated





PROJECT TEAM:

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Calgary, AB T3C 0J7 trl@trleng.ca <u>CIVIL ENGINEER</u> Alpine Consultants Ltd.


1998 Vernon St., Lumby, BC V0E 2G jason@alpineengineering.ca

MECHANICAL & ELECTRICAL ENGINEER EMBE Consulting Engineers Inc. #204, 110 12 Ave. S.W.


Calgary, AB T2R 0G7 info@embeconsulting.ca

<u>LANDSCAPE ARCHITECT</u>
Navagrah Landscape Architecture #301, 501 - 18 Avenue S.W., Calgary, AB T2S 0C7 ynavagrah@navagrah.ca

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06	RESUBMISSION FOR TECHNICAL	FEBRUARY 22,
	REVIEW	2024
No.	Description :	Date :

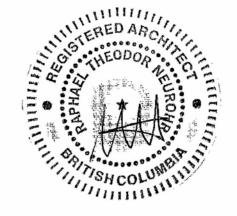VIVO

815-865 CLEMENT AVENUE, KELOWNA, BC

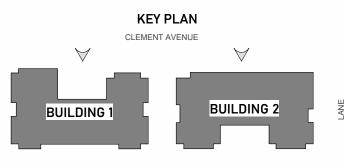Drawing title :

### NORTH ELEVATION

Issued :		JUI	NE 12, 2024
Drawn by :	-	Checked by:	TS, RN

DP3.02






ARCHITECT
DAAS DESIGN AND ARCHITECTURE STUDIO INC.

MECHANICAL & ELECTRICAL ENGINEER EMBE Consulting Engineers Inc. #204, 110 12 Ave. S.W.

Calgary, AB T2R 0G7 info@embeconsulting.ca


<u>LANDSCAPE ARCHITECT</u>
Navagrah Landscape Architecture
#301, 501 - 18 Avenue S.W.,

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**KEY PLAN** CLEMENT AVENUE

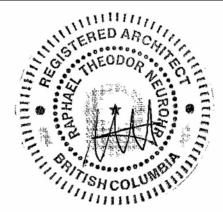

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	RESUBMISSION	
07	DEVELOPMENT PERMIT	MAY 16, 2024
	RESUBMISSION RESPONSE	
06	RESUBMISSION FOR TECHNICAL	FEBRUARY 22,
	REVIEW	2024
No.	Description :	Date :

VIVO

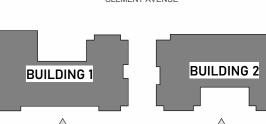815-865 CLEMENT AVENUE, KELOWNA, BC

### SOUTH ELEVATIONS

Project number :			23-014
Issued :		JUL	NE 12, 2024
Drawn by :	-	Checked by:	TS, RN

DP3.03





PROJECT TEAM:

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Calgary, AB T3C 0J7 trl@trleng.ca

<u>CIVIL ENGINEER</u> Alpine Consultants Ltd. 1998 Vernon St., Lumby, BC V0E 2G

Calgary, AB T2R 0G7 info@embeconsulting.ca

Calgary, AB T2S 0C7 ynavagrah@navagrah.ca

<u>LANDSCAPE ARCHITECT</u>
Navagrah Landscape Architecture
#301, 501 - 18 Avenue S.W.,


jason@alpineengineering.ca MECHANICAL & ELECTRICAL ENGINEER EMBE Consulting Engineers Inc. #204, 110 12 Ave. S.W.

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06	RESUBMISSION FOR TECHNICAL	FEBRUARY 22,
	REVIEW	2024
No.	Description :	Date :

VIVO

815-865 CLEMENT AVENUE, KELOWNA, BC

Drawing title :

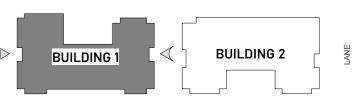Project Information:

BUILDING 1 - EAST & **WEST ELEVATION** 

23-014 Project number JUNE 12, 2024 - Checked by: TS, RN Drawn by :

DP3.04

### **ELEVATION LEGEND**

- WALL FINISH METAL PANEL (QUICKPANEL) COLOR: "CHAMPAGNE METALLIC"
- WALL FINISH METAL PANEL (QUICKPANEL)
  COLOR: "CHARCOAL"
- WALL FINISH METAL PANEL (FASTPLANK) COLOR: "CHAMPAGNE METALLIC"
- WALL FINISH METAL PANEL (FASTPLANK) COLOR: "CHARCOAL"
- WALL FINISH METAL PANEL (FASTPLANK) COLOR: "WHITE"
- 6 METAL CAP FLASHING COLOR: TO MATCH MATERIAL
- (7) WALL FINISH CONCRETE COLOR: "GREY"
- 8 ALUMINIUM CLAD PVC WINDOWS FRAMES COLOR: "BLACK ANODIZED"
- 9 SLIDING DOOR BALCONY GLAZED COLOR: "BLACK ANODIZED"
- ENTRANCE DOOR GLAZED COLOR: "BLACK ANODIZED"
- (11) BALCONY SWING DOOR GLAZED
- (12) METAL DOOR COLOR: "CHARCOAL"
- (13) O/H METAL DOOR COLOR "DARK GREY"
- (14) GLASS RAILING
- (15) ALUMINIUM RAILING PICKET COLOR: "BLACK"
- (16) FROSTED GLASS BALCONY PARTITION WALL
- (17) BUILDING SIGNAGE
- MECHANICAL LOUVER COLOR TO MATCH "CHARCOAL"

SCHEDULE This forms part of application # DP23-0008 City of

Kelowna DEVELOPMENT PLANNING



PROJECT TEAM:

ARCHITECT
DAAS DESIGN AND ARCHITECTURE STUDIO INC. #310, 1032 17 Ave. S.W. Calgary, AB T2T 0A5

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### Calgary, AB T3C 0J7 trl@trleng.ca

info@daasarchitecture.com

<u>CIVIL ENGINEER</u> Alpine Consultants Ltd.

### 1998 Vernon St.,


Lumby, BC V0E 2G jason@alpineengineering.ca

## MECHANICAL & ELECTRICAL ENGINEER EMBE Consulting Engineers Inc. #204, 110 12 Ave. S.W.

Calgary, AB T2R 0G7 info@embeconsulting.ca


### LANDSCAPE ARCHITECT Navagrah Landscape Architecture #301, 501 - 18 Avenue S.W., Calgary, AB T2S 0C7 ynavagrah@navagrah.ca

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**KEY PLAN** 

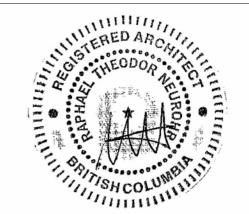

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80	DEVELOPMENT PERMIT RESUBMISSION	JUNE 12, 2024
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06	RESUBMISSION FOR TECHNICAL REVIEW	FEBRUARY 22, 2024
No.	Description :	Date :

Project Information:
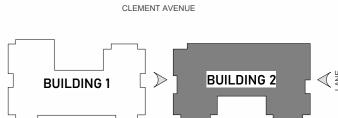
### VIVO


815-865 CLEMENT AVENUE, KELOWNA, BC

Drawing title :

### BUILDING 2 - EAST & **WEST ELEVATION**

23-014 Project number JUNE 12, 2024 - Checked by: TS, RN Drawn by :

DP3.05

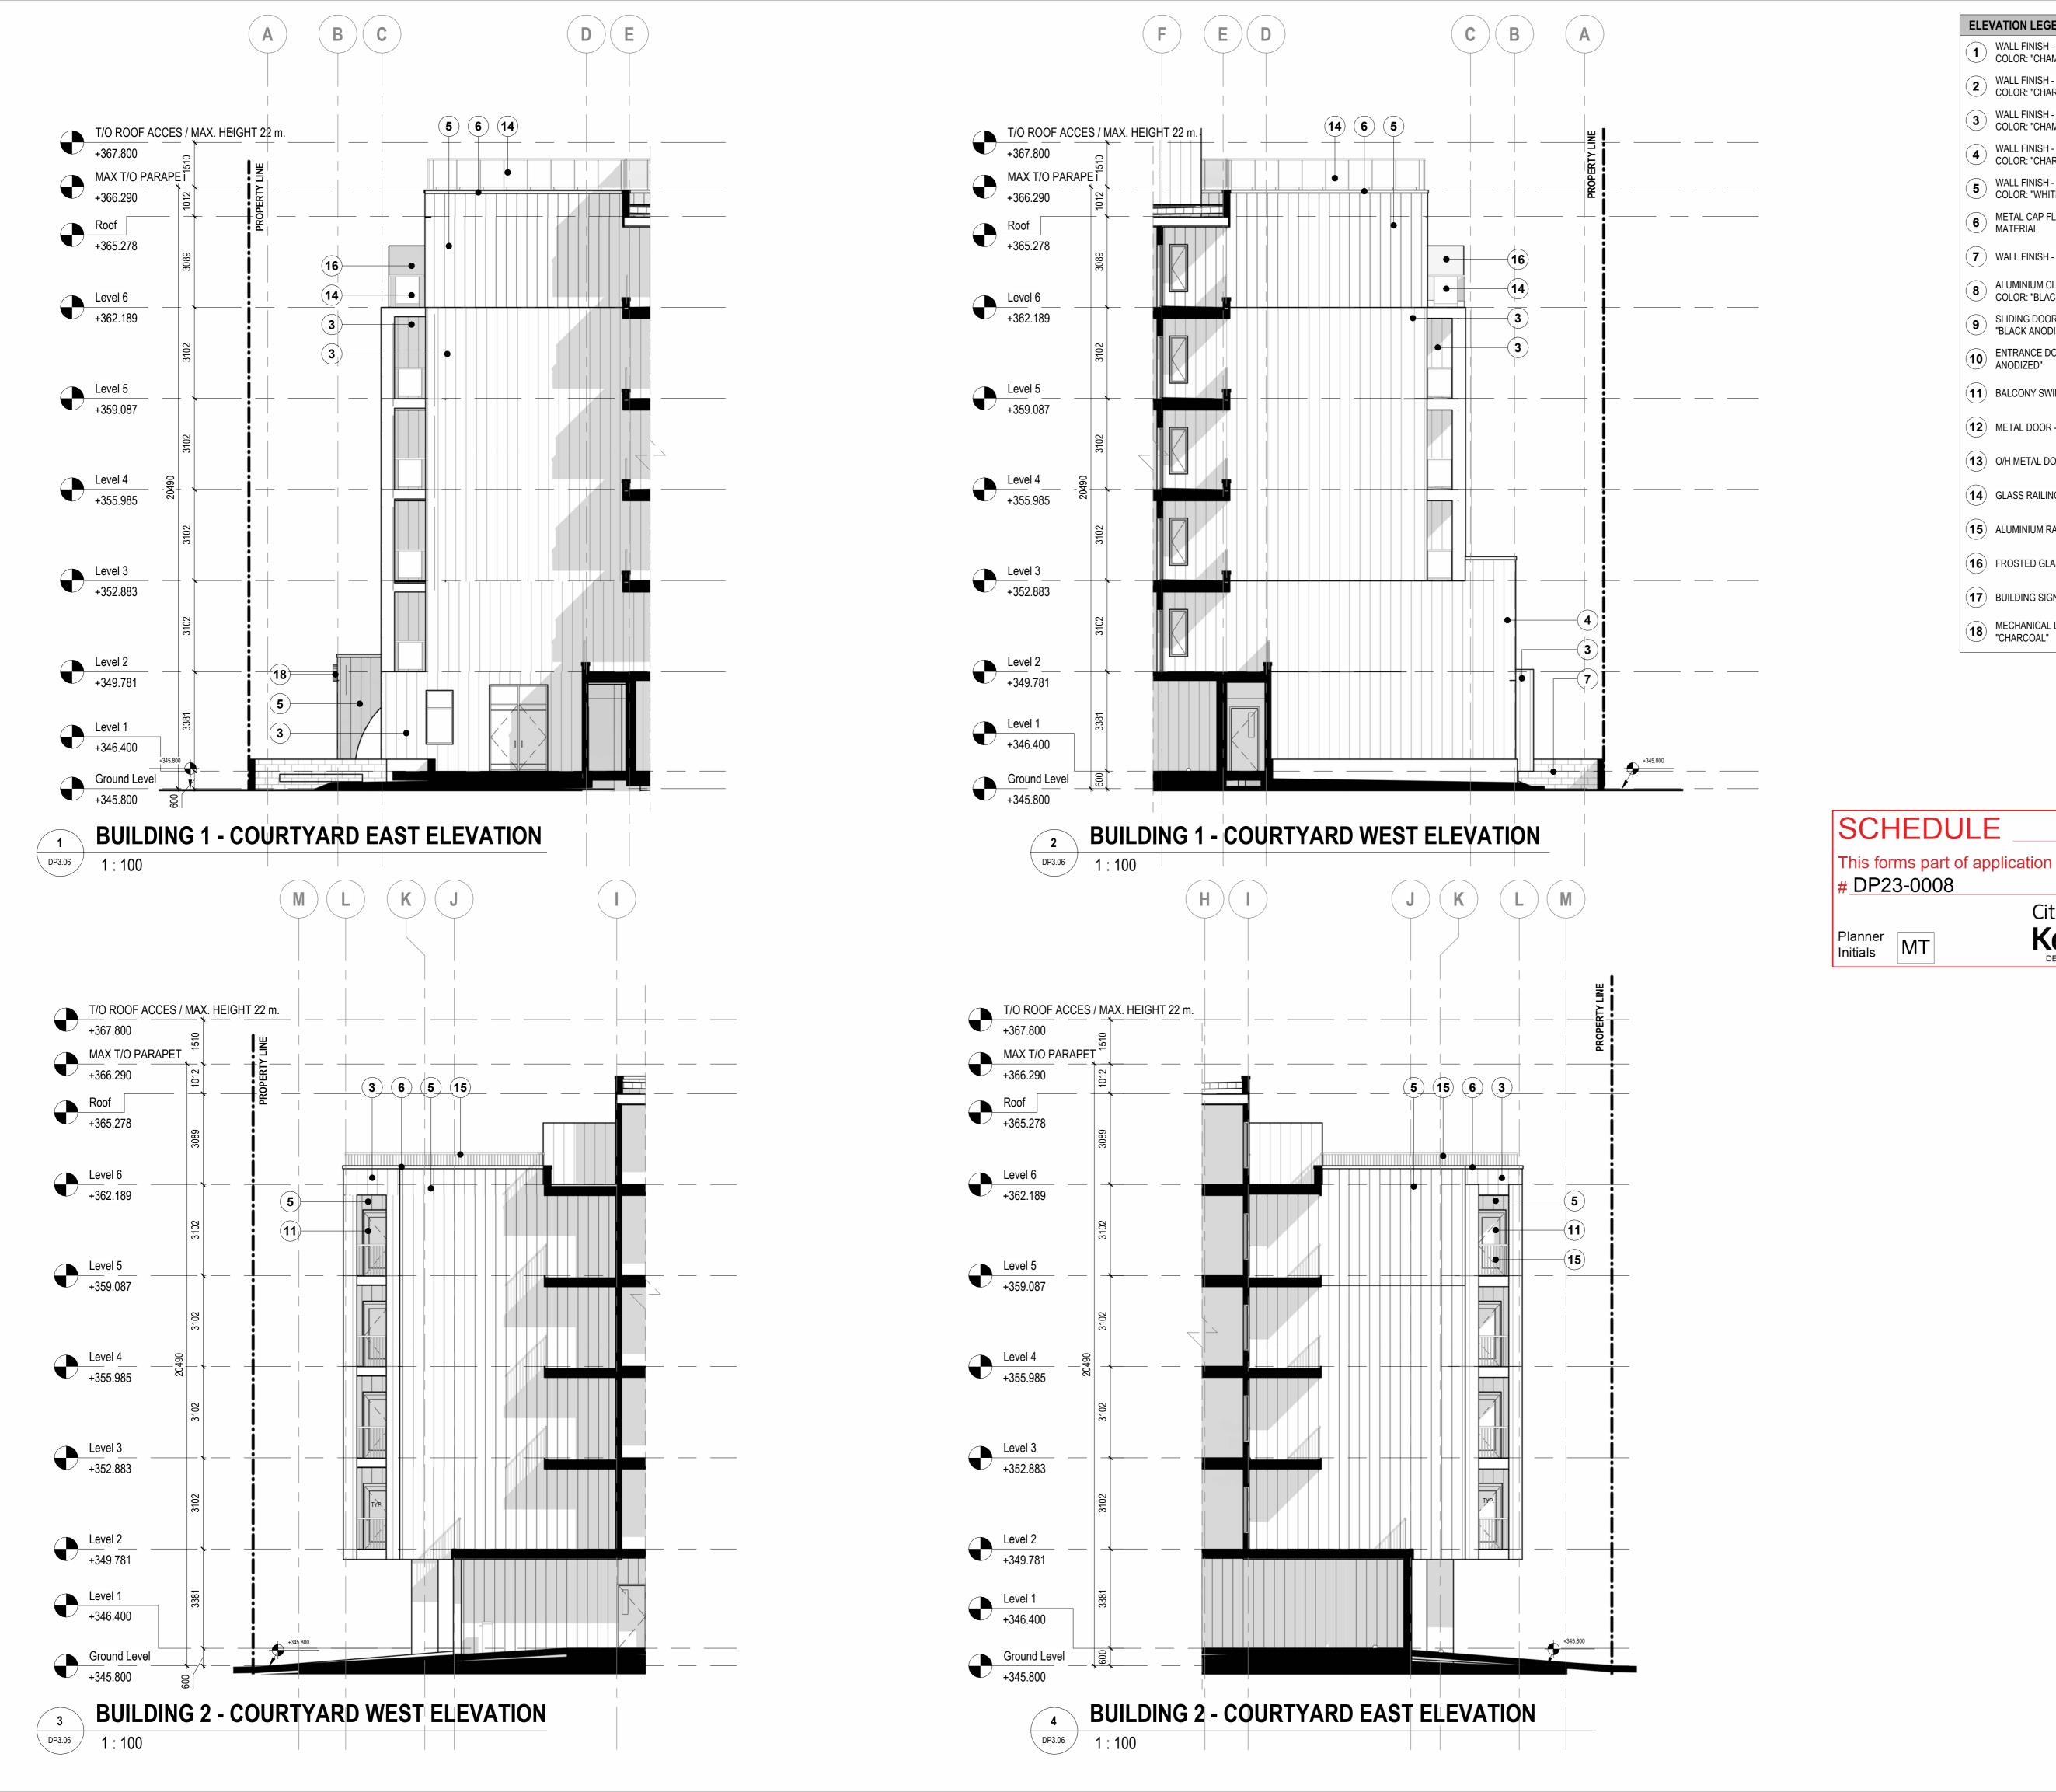

### **ELEVATION LEGEND**

- WALL FINISH METAL PANEL (QUICKPANEL)
  COLOR: "CHAMPAGNE METALLIC"
- WALL FINISH METAL PANEL (QUICKPANEL)
  COLOR: "CHARCOAL"
- WALL FINISH METAL PANEL (FASTPLANK) COLOR: "CHAMPAGNE METALLIC"
- WALL FINISH METAL PANEL (FASTPLANK) COLOR: "CHARCOAL"
- WALL FINISH METAL PANEL (FASTPLANK) COLOR: "WHITE"
- 6 METAL CAP FLASHING COLOR: TO MATCH MATERIAL

(7) WALL FINISH - CONCRETE - COLOR: "GREY"

- 8 ALUMINIUM CLAD PVC WINDOWS FRAMES COLOR: "BLACK ANODIZED"
- 9 SLIDING DOOR BALCONY GLAZED COLOR: "BLACK ANODIZED"
- ENTRANCE DOOR GLAZED COLOR: "BLACK ANODIZED"
- (11) BALCONY SWING DOOR GLAZED
- (12) METAL DOOR COLOR: "CHARCOAL"
- (13) O/H METAL DOOR COLOR "DARK GREY"
- (14) GLASS RAILING
- (15) ALUMINIUM RAILING PICKET COLOR: "BLACK"
- (16) FROSTED GLASS BALCONY PARTITION WALL
- (17) BUILDING SIGNAGE
- MECHANICAL LOUVER COLOR TO MATCH "CHARCOAL"

City of

Kelowna DEVELOPMENT PLANNING

CONSTRUCTION

PROJECT TEAM:

#310, 1032 17 Ave. S.W.

info@daasarchitecture.com

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jason@alpineengineering.ca

Calgary, AB T2R 0G7 info@embeconsulting.ca

Calgary, AB T2S 0C7 ynavagrah@navagrah.ca


<u>LANDSCAPE ARCHITECT</u>
Navagrah Landscape Architecture
#301, 501 - 18 Avenue S.W.,

MECHANICAL & ELECTRICAL ENGINEER
EMBE Consulting Engineers Inc.
#204, 110 12 Ave. S.W.

1998 Vernon St.,

Lumby, BC V0E 2G

Calgary, AB T2T 0A5

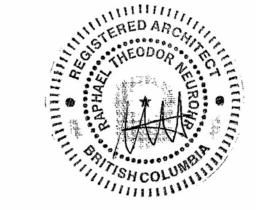

**NOT FOR** 

ARLINGTON ST GROUP

ARCHITECT
DAAS DESIGN AND ARCHITECTURE STUDIO INC.

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**KEY PLAN** CLEMENT AVENUE



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	REVIEW	2024
No.	Description :	Date :

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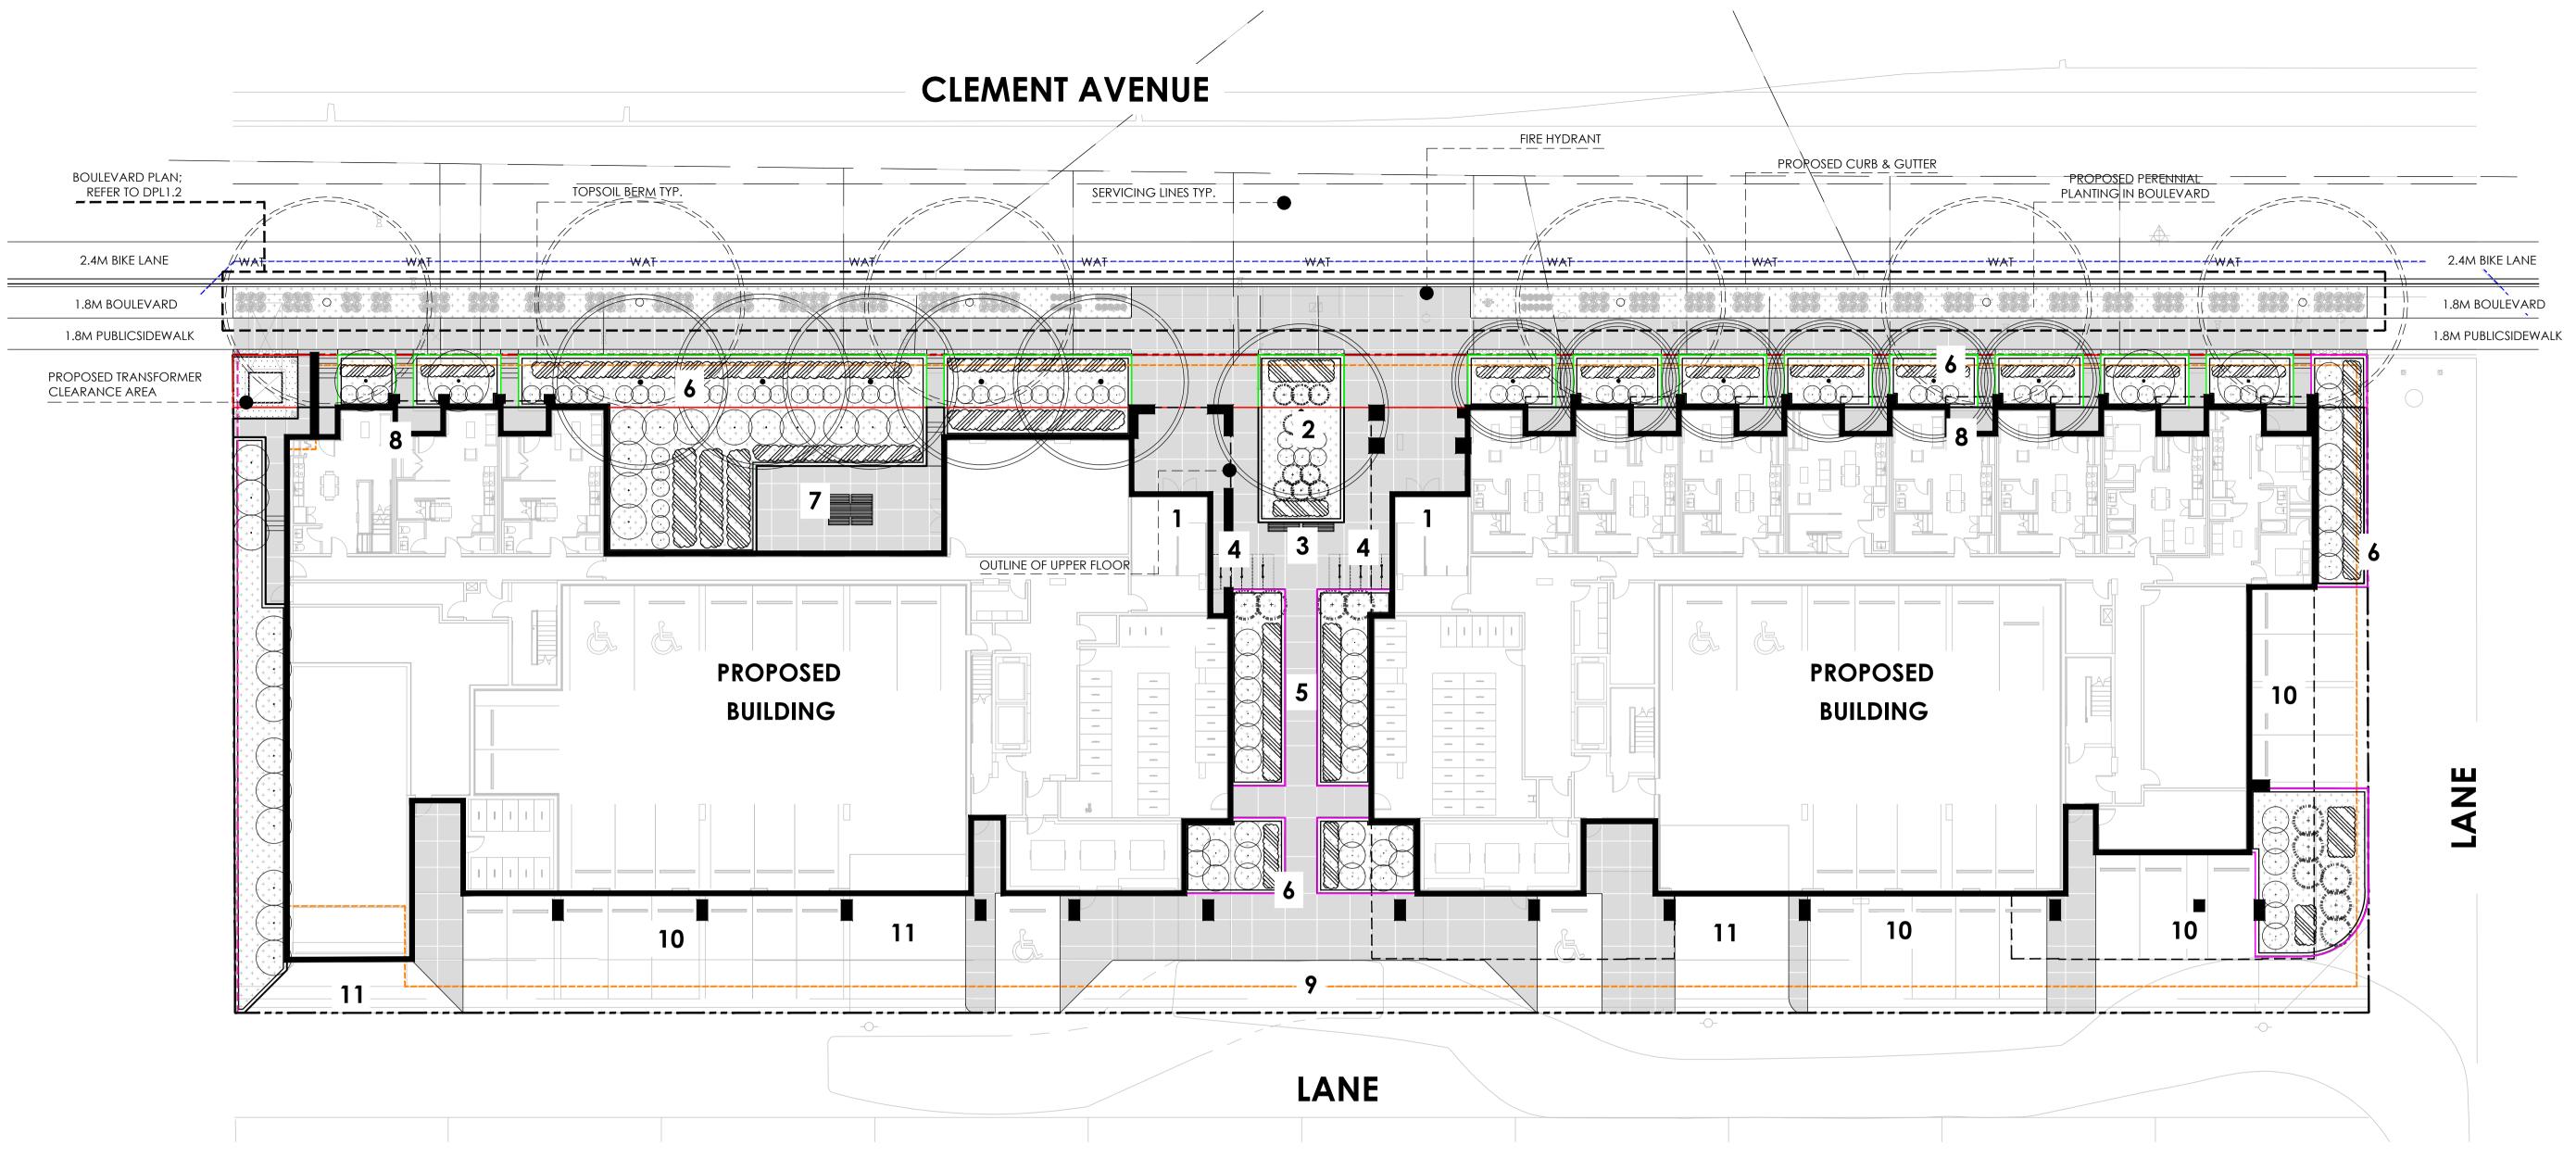
815-865 CLEMENT AVENUE, KELOWNA, BC

Drawing title :

COURTYARD ELEVATIONS

23-014 Project number JUNE 12, 2024 - Checked by: TS, RN Drawn by

DP3.06



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- 1. THIS DRAWING HAS BEEN PREPARED FOR DEVELOPMENT PERMIT PURPOSES ONLY. IT IS NOT TO BE USED FOR CONSTRUCTION PURPOSES.

  2. ALL PLANT MATERIAL TO CONFORM TO THE CANADIAN NURSERY
- TRADES ASSOCIATION STANDARDS.

  3. ALL PLANT MATERIAL SIZES SHOWN ARE MINIMUM SIZES.
- 4. DO NOT SCALE DRAWINGS.
  5. ALL PLANTING BEDS TO HAVE A MINIMUM OF 75MM DEPTH
- CHARCOAL MULCH UNLESS OTHERWISE NOTED.

  6. ALL SOFT SURFACE LANDSCAPE AREAS TO BE IRRIGATED WITH
- UNDERGROUND IRRIGATION SYSTEM
- 7. ALL DIMENSIONS ARE IN MILLIMETERS UNLESS OTHERWISE NOTED.
- 1. MAIN ENTRY
- 2. CENTRAL PLANTING BED WITH FEATURE TREE
- 3. CENTRAL PLAZA WITH SEATING
- 4. BIKE PARKING
- 5. MEWS
- 6. PLANTER TYP.
- 7. PRIVATE GATHERING SPACE WITH PICNIC TABLE
- 8. PRIVATE PATIO TYP.
- 9. LOADING ZONE
- 10. PARKING AREA
- 11. PARKADE ENTRANCE

### **LEGEND**

REGULAR GREY COLOR CONCRETE

PLANTING BED WITH CHARCOAL MULCH
INSTALLED TO 75MM DEPTH

20MM RUNDLE ROCK INSTALLED TO 75MM DEPTH WITH LANDSCAPE FILTER FABRIC

SOD

FRONT SETBACK AREA

PROPERTY LINE

PARKADE EXTENTS

----- EXISTING UNDERGROUND WATER LINE TO BE RELOCATED.
THE NEW RELOCATED WATERLINE TO MAINTAIN THE
REQUIRED SEPARATION FROM BOULEVARD TREES

TYPE 1 PLANTER: HEIGHT VARIES

TYPE 2 PLANTER: 450MM ABOVE GROUND; 300MM BELOW GROUND

REFER TO DPL6 FOR PLANTING PLAN DETAILS

LARGE DECIDUOUS TREES

BOULEVARD TREES;

MEDIUM DECIDUOUS TREES

SMALL DECIDUOUS TREES

DECIDUOUS SHRUBS

### LANDSCAPE ANALYSIS

SITE AREA: 4,577.29 SQ.M.

GROUNDFLOOR

PROVIDED LANDSCAPED AREA (FRONT SETBACK) = 365.69 SQ.M.
REQUIRED SOIL-BASED LANDSCAPING (FRONT SETBACK) = 75% = 274.26 SQ.M.
PROVIDED SOIL-BASED LANDSCAPING (FRONT SETBACK) = 305.90 SQ.M. OR 83.65%

PROVIDED LANDSCAPE

TOTAL NUMBER OF REQUIRED TREES BASED ON 1TREE /10L.M. = 12.19~12 MIN 50% OF LARGE TREES = 6 MAX 25% OF SMALL TREES = 3

TOTAL NUMBER OF REQUIRED TREES BASED ON 1/55 SQ.M. = 6.65 ~7 MIN 50% OF LARGE TREES = 3.5~4 MAX 25% OF SMALL TREES = 1.75~2

TOTAL TREES PROVIDED = 16

LARGE DECIDUOUS TREES PROVIDED = 06 (OF REQUIRED)

LARGE DECIDUOUS TREES TO HAVE MIN. 50MM CALLIPER

MEDIUM DECIDUOUS TREES PROVIDED = 06

MEDIUM DECIDUOUS TREES TO HAVE MIN. 50MM CALLIPER

SMALL DECIDUOUS TREES PROVIDED = 04

SMALL DECIDUOUS TREES TO HAVE MIN. 30MM CALLIPER

TOTAL SHRUBS PROVIDED = 155

SCHEDULE C

This forms part of application
# DP23-0008

City of

Planner Initials

MT

Kelowna






**ISSUED FOR** 221017 COORD 221018 COORD 221116 REDLINE 230508 **REVIEW** 230512 REVIEW 230525 COORD 230526 DP RESUBMISSION 230601 REVISED DP 230802 REVISED DP 240118 240514 REVISED DP COORD 240617

SCALE 1:200
DATE 240514
DRAWN BY CP/JY
CHECKED BY YN

DP GROUND FLOOR FLOOR PILAYOUT PLAN HE POCATION: N: AVOID PLAN HE POCATION:

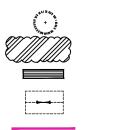


CONIFEROUS SHRUBS

PERENNIALS BENCH

CLASS 2 BIKE STALLS TOTAL QUANTITY: 12

1800 MM HT. LANDSCAPE FENCE

PICNIC TABLE

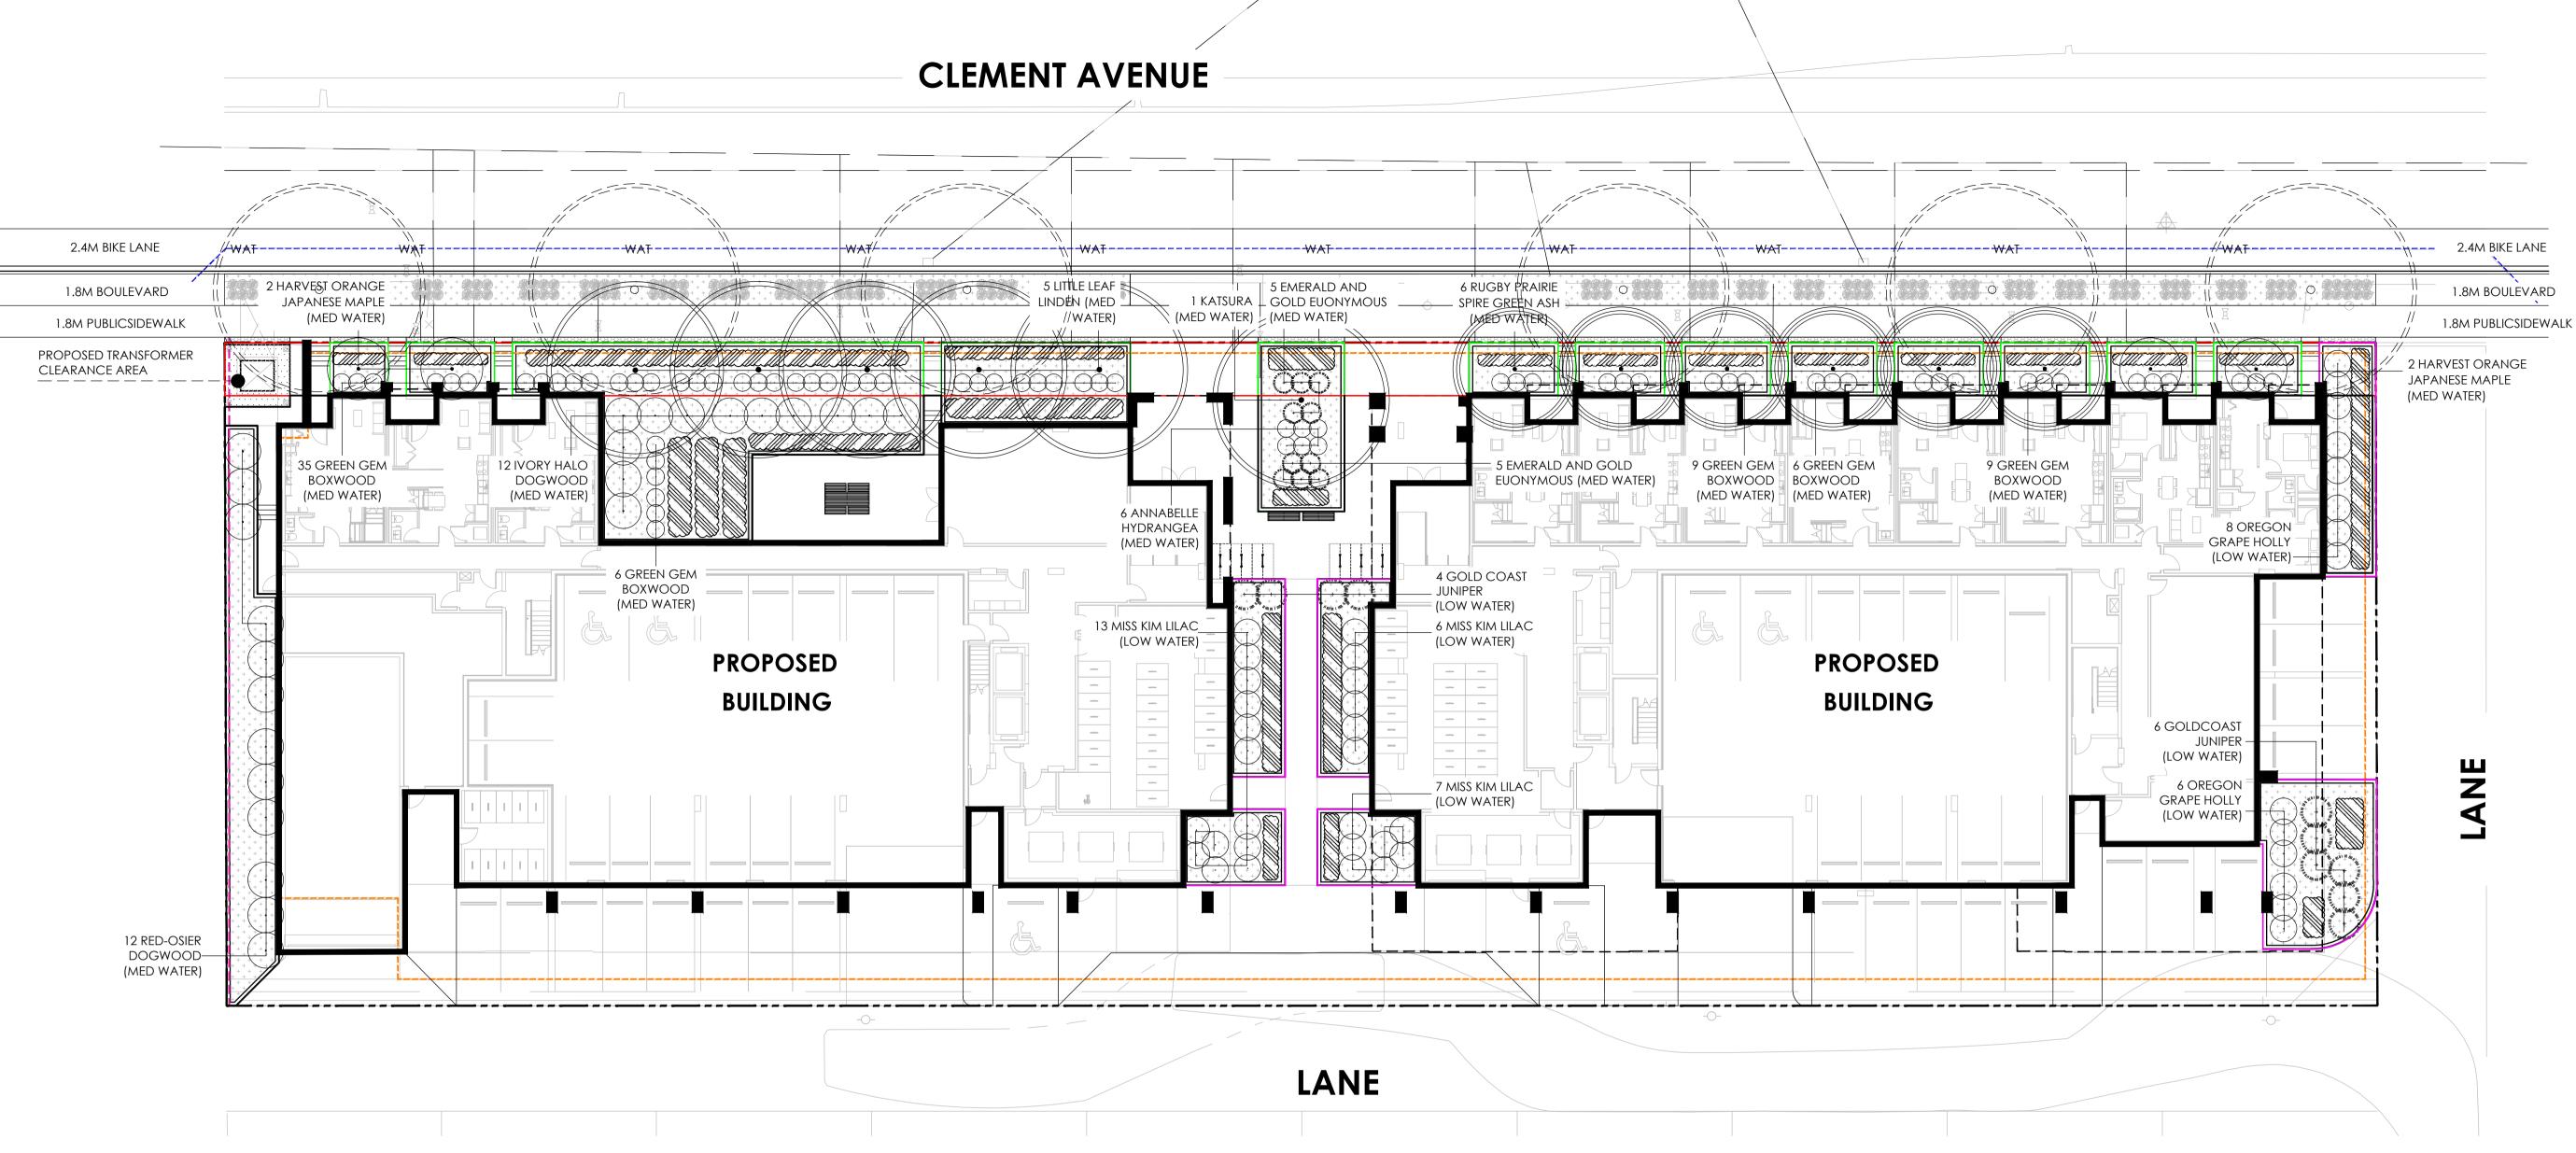

PLANTING SCHEDULE (ENTIRE SITE) **LEGEND** 

+ T + T + T + T + T + T + T + T + T + T	PLANTING BED WITH CHARCOAL MULCH INSTALLED TO 75MM DEPTH
	20MM RUNDLE ROCK INSTALLED TO 75MM DEPTH WITH LANDSCAPE FILTER FABRIC
	SOD
	FRONT SETBACK AREA
	PROPERTY LINE
	PARKADE EXTENTS
	EXISTING UNDERGROUND WATER LINE TO BE RELOCATED. THE NEW RELOCATED WATERLINE TO MAINTAIN THE REQUIRED SEPARATION FROM BOULEVARD TREES
	TYPE 1 PLANTER: HEIGHT VARIES
	TYPE 2 PLANTER: 450MM ABOVE GROUND; 300MM BELOW GROUND

BOULEVARD TREES;

LARGE DECIDUOUS TREES

MEDIUM DECIDUOUS TREES

SMALL DECIDUOUS TREES

DECIDUOUS SHRUBS

CONIFEROUS SHRUBS

PERENNIALS

BENCH


REFER TO DPL6 FOR PLANTING PLAN DETAILS

OCATED. THE ES		

common name	botanical name	size at planting	quantity	water usage	typical spacing
large deciduous trees <b>(TOTAL: 06)</b> LITTLE LEAF LINDEN KATSURA	TILIA CORDATA CERCIDIPHULLUM JAPONICUM	50MM CAL. 50MM CAL.	05 01	MEDIUM MEDIUM	
medium deciduous trees (TOTAL: 06) RUGBY PRAIRIE SPIRE GREEN ASH	FRAXINUS PENNSYLVANICA 'RUGBY'	50MM CAL.	06	MEDIUM	
small deciduous trees <b>(TOTAL: 04)</b> HARVEST ORANGE JAPANESE MAPLE	ACER PALMATUM 'HARVEST ORANGE'	30MM CAL.	04	MEDIUM	
common name	latin name	size/ spread	quantity	water usage	typical spacing
deciduous shrubs (TOTAL: 135) GREEN GEM BOXWOOD IVORY HALO DOGWOOD MISS KIM LILAC ANNABELLE HYDRANGEA RED-OSIER DOGWOOD OREGON GRAPE HOLLY	BUXUS 'GREEN GEM' CORNUS ALBA 'BAIHALO' SYRINGA PATULA 'MISS KIM' HYDRANGEA ARBORESCENS 'ANNABELLE' CORNUS SERICEA MAHONIA AQUIFOLIUM	600MM HT. 600MM HT. 600MM HT. 600MM HT. 600MM HT.	65 12 26 06 12 14	MEDIUM MEDIUM LOW MEDIUM MEDIUM LOW	900MM 800MM 1200MM 900MM 2000MM
coniferous shrubs <b>(TOTAL: 20)</b> EMERALD AND GOLD EUONYMOUS GOLD COAST JUNIPER	EUINYMUS FORTUNEI 'EMERALD 'N' GOLD' JUNIPERUS CHINENSIS 'GOLD COAST'	600mm Spread 600mm Spread	10 10	MEDIUM LOW	1000MM 1500MM

SCHEDULE This forms part of application # DP23-0008 Kelowna DEVELOPMENT PLANNING Planner Initials MT



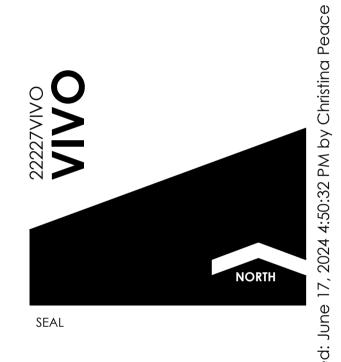

SUED FOR OORD OORD EDLINE EVIEW EVIEW OORD PRESUBMISSION EVISED DP EVISED DP EVISED DP	DATE 221017 221018 221116 230508 230512 230525 230526 230601 230802 240118 240514 240617	ALE THE DRAWING.	ELANDSCAPE ARCHITECT, THIS DRAWING IS THE

1:200 240514 DRAWN BY CP/JY CHECKED BY YN

DATE

GROUND 2 FLOOR \( \frac{5}{2} \) PLANTING S PLAN <sup>⊕</sup>

CLASS 2 BIKE STALLS TOTAL QUANTITY: 12 1800 MM HT. LANDSCAPE FENCE

PICNIC TABLE

### **CLEMENT AVENUE**



### LANE

LOUNGING CHAIR WITH UMBRELLA

MOVEABLE WOOD PLANTER;

REFER TO DETAIL #5 L7.3

STRING TWINKLE LIGHTS


REFER TO DETAIL #1 L7.0

TRELLIS FRAME;

### **NOTES**

- 1. INSTALL BACKFLOW PREVENTION DEVICES TO MEET CITY OF KELOWNA STANDARDS TO ISOLATE THE OUTDOOR IRRIGATION SYSTEM FROM THE POTABLE WATER SYSTEM.
- 2. PROVIDE ADEQUATE TOPSOIL OR GROWING MEDIUM OF DEPTH AND QUALITY TO MEET THE BC LANDSCAPE STANDARD, PUBLISHED BY THE BC SOCIETY OF LANDSCAPE ARCHITECTS AND THE BC LANDSCAPE AND NURSERY ASSOCIATION. MINIMUM TOPSOIL DEPTHS ARE 300MM FOR SHRUBS AND 600MM FOR TREES FOR PLANTINGS AT GRADE. FOR PLANTING OVER STRUCTURE 300MM FOR GROUNDCOVER, 600MM FOR SHRUBS, AND 1200MM FOR TREES IS TO BE PROVIDED.
- 3. PROVIDE A SEPARATE IRRIGATION VALVE FOR EACH IRRIGATED HYDROZONE. 4. USE DRIP IRRIGATION.
- ENSURE MATCHED PRECIPITATION RATES WITHIN ALL IRRIGATION CIRCUITS.
- 6. DESIGN AND INSTALL PIPE AND HEAD LAYOUT SO FLOW VELOCITY DOES NOT EXCEED 1.5 M/S, AND TO MINIMIZE ELEVATION CHANGE OR PRESSURE VARIATION IN
- CIRCUITS. PROVIDE CHECK VALVES TO STOP LOW HEAD DRAINAGE. 7. ENSURE IRRIGATION MAINLINES ARE LEAK FREE USING LEAK TESTS.
- 8. ENSURE IRRIGATION ZONES ARE OPERATING AT THE MANUFACTURER'S OPTIMUM PRESSURE RANGE. USE PRESSURE REGULATING VALVES WHERE NECESSARY.
- 9. INSTALL AND APPROPRIATELY PROGRAM A SMART CONTROLLER. A SMART CONTROLLER IS DEFINED AS A CONTROLLER CAPABLE OF RECEIVING SENSOR DATA SUCH AS A RAIN SENSOR OR SOIL MOISTURE SENSOR OR WEATHER STATION DATA.
- 10. INSTALL AN IRRIGATION SYSTEM ISOLATION VALVE LOCATED OUTSIDE THE BUILDING IN A LOCATION ACCESSIBLE TO THE CITY THAT WHEN CLOSED SHALL STOP THE SUPPLY OF WATER FROM THE POTABLE WATER SUPPLY TO THE OUTDOOR IRRIGATION SYSTEM AND SHALL BE CAPABLE OF BEING CLOSED AND LOCKED OFF BY THE CITY.

### **LEGEND**

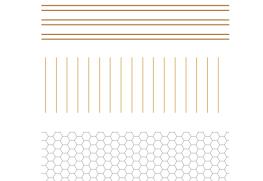

TREX COMPOSITE DECK BOARDS PRODUCT: TREX TRANSCEND LINEAGE COLOR: JASPER

TREX COMPOSITE DECK BOARDS PRODUCT: TREX TRANSCEND LINEAGE COLOR: CARMEL

PLANTING BED WITH ROCK MULCH

PERENNIALS

BENCH



BBQ (PROVIDE GAS CONNECTION FOR BBQ)

PICNIC TABLE; REFER TO DETAIL #3 L7.3 (TOTAL QUANTITY: 07)

### **ROOFTOP ENTRANCE**

- **PATHWAY**
- LOUNGING SPACE WITH LOUNGING **CHAIRS AND UMBRELLAS**
- PERENNIAL PLANTING WITHIN PLANTER TYP.

SCHEDULE

# DP23-0008

Planner Initials

This forms part of application

- **OUTDOOR GATHERING SPACE WITH BBQ** AND PICNIC TABLES
- 6. OUTLOOK AREA WITH BENCHES






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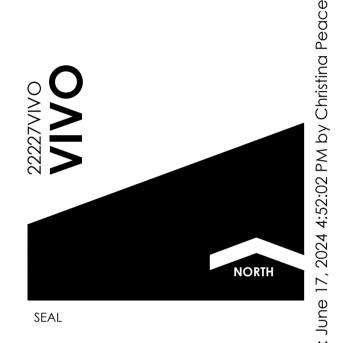
EAST BUILDING 6 FLOOR C ROOFTOP PLAN ⊞

CHECKED BY YN

### **CLEMENT AVENUE**





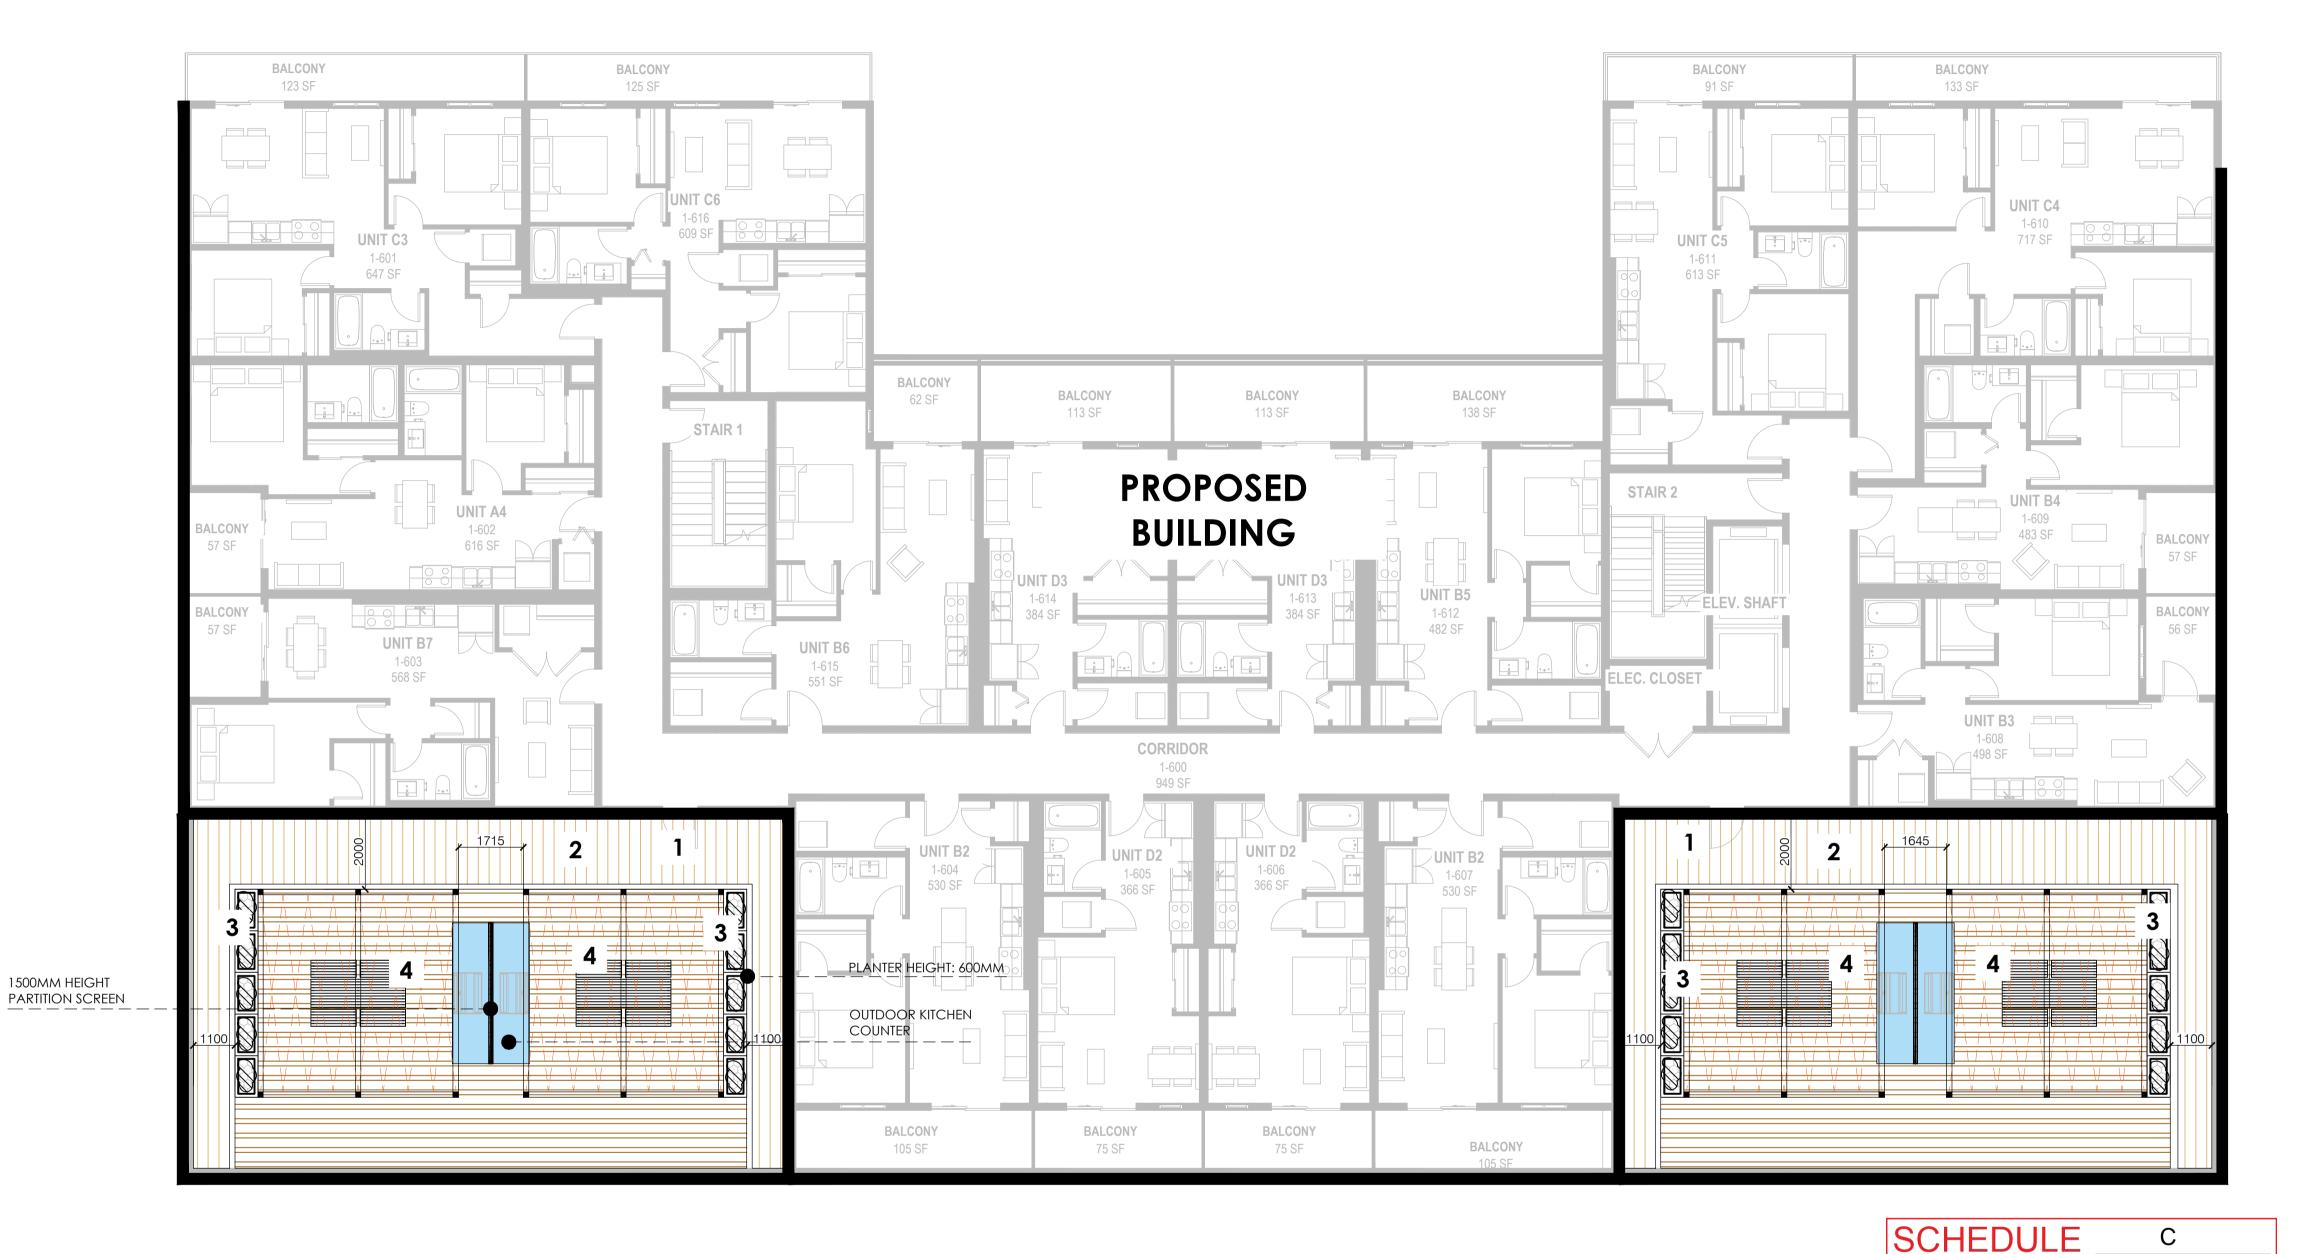

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REDLINE **REVIEW** REVIEW COORD DP RESUBMISSION 230601 230802 240118 240514 240617 REVISED DP REVISED DP REVISED DP COORD

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**SCALE** DATE 240514 DRAWN BY CP/JY CHECKED BY YN

WEST BUILDING 6 FLOOR C ROOFTOP PLAN

LANE

### **LEGEND**

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**NOTES** 

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TREX COMPOSITE DECK BOARDS PRODUCT: TREX TRANSCEND LINEAGE COLOR: JASPER

FOR BBQ)



MOVEABLE WOOD PLANTER; REFER TO DETAIL #5 L7.3 STRING TWINKLE LIGHTS



TRELLIS FRAME; REFER TO DETAIL #1 L7.0

**PATHWAY** 

**ROOFTOP ENTRANCE** 

- PERENNIAL PLANTING WITHIN PLANTER TYP.

This forms part of application

# DP23-0008


Planner

Initials

**OUTDOOR GATHERING SPACE WITH BBQ AND PICNIC TABLES** 





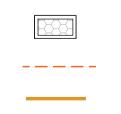




PLANTING BED WITH ROCK MULCH

PICNIC TABLE; REFER TO DETAIL #3 L7.3 (TOTAL QUANTITY: 07)






### **CLEMENT AVENUE**

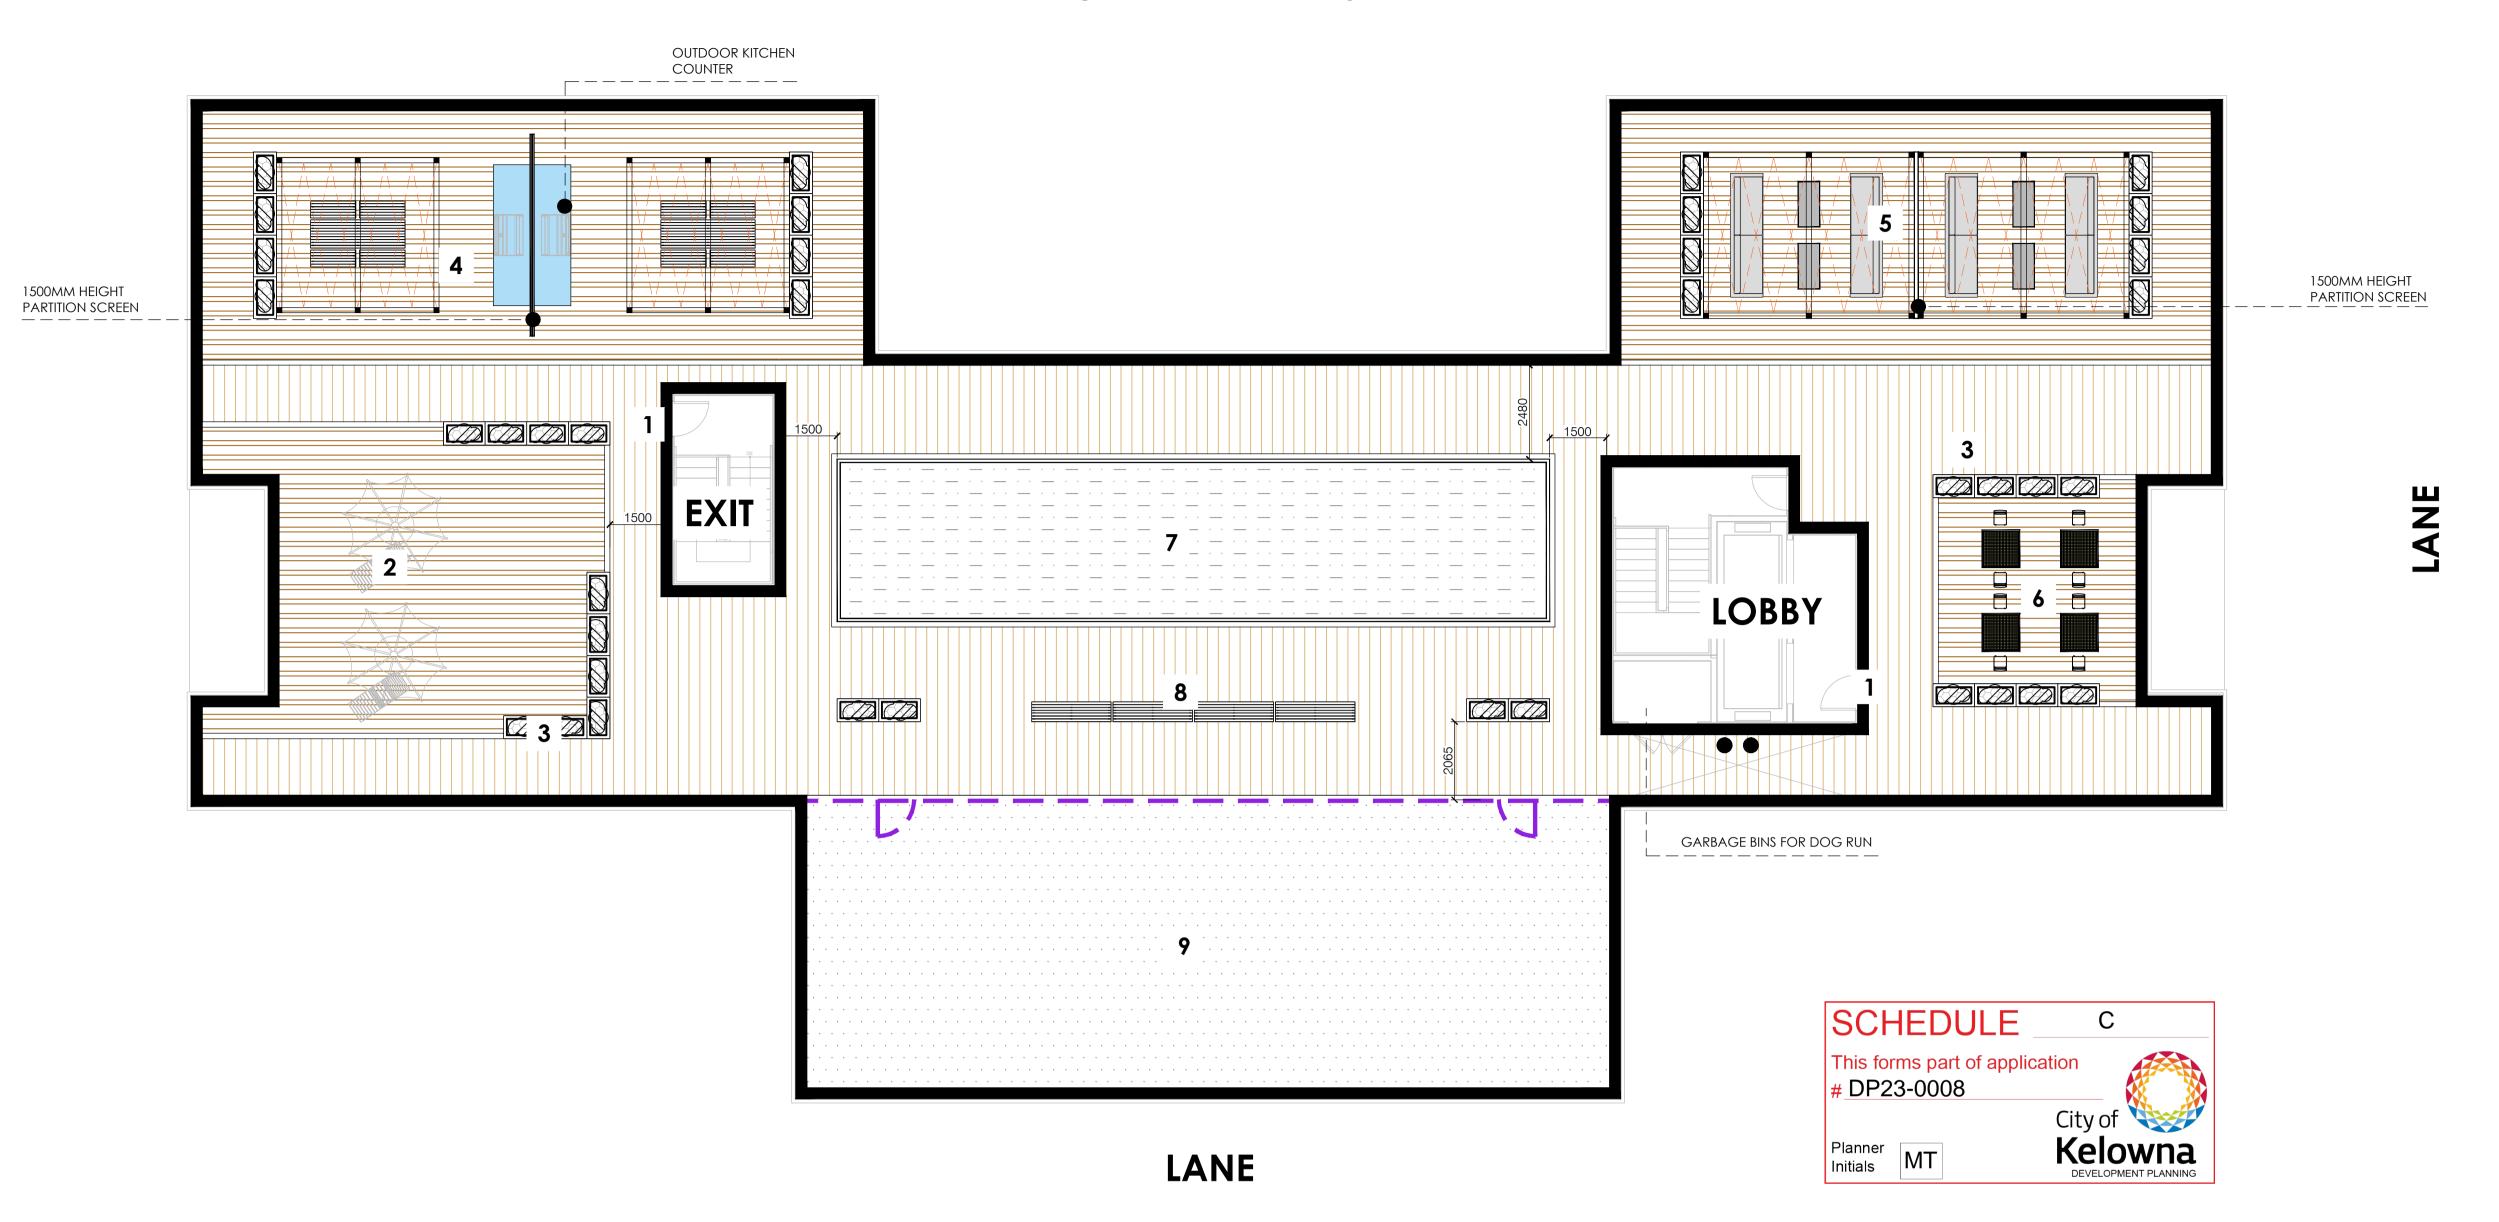



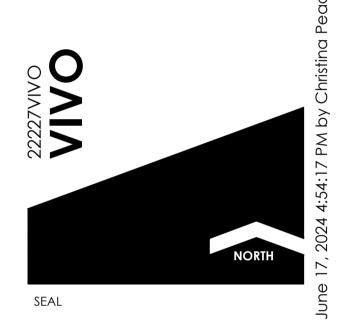

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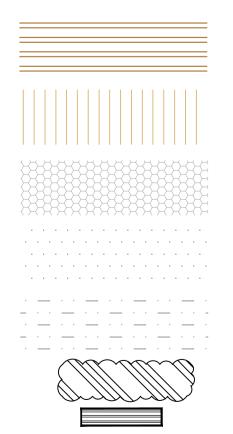
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### **LEGEND**



TREX COMPOSITE DECK BOARDS PRODUCT: TREX TRANSCEND LINEAGE COLOR: JASPER

TREX COMPOSITE DECK BOARDS PRODUCT: TREX TRANSCEND LINEAGE COLOR: CARMEL

PLANTING BED WITH ROCK MULCH

ARTIFICIAL TURF FOR DOG RUN


BOCCE COURT SURFACE

PERENNIALS BENCH


BBQ (PROVIDE GAS CONNECTION FOR BBQ)

PICNIC TABLE; REFER TO DETAIL #3 L7.3 (TOTAL QUANTITY: 07)

LOUNGING CHAIR WITH UMBRELLA

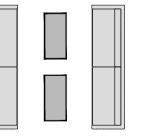

REMOVABLE SOFAS AND TABLES

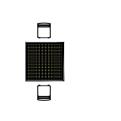

CHESS/ POKER PLAY TABLE AND CHAIRS

MOVEABLE WOOD PLANTER; REFER TO DETAIL #5 L7.3

STRING TWINKLE LIGHTS TRELLIS FRAME;

REFER TO DETAIL #1 L7.1

DOG RUN AREA FENCE AND GATE

- **ROOFTOP ENTRANCE**
- LOUNGING SPACE WITH LOUNGING CHAIRS AND UMBRELLAS
- 3. PERENNIAL PLANTING WITHIN PLANTER TYP.
- OUTDOOR GATHERING SPACE WITH BBQ AND PICNIC TABLES
- 5. OUTLOOK AREA WITH REMOVABLE SOFAS **AND TABLES**

6. ACTIVE SPACE - CHESS/ POKER GAME

- **TABLE** 7. ACTIVE SPACE - BOCCE COURT
- DOUBLE SIDE LINEAR BENCH
- 9. FENCED DOG RUN AREA

SCALE DATE DRAWN BY

COORD

COORD

**REDLINE** 

REVIEW

REVIEW

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REVISED DP

REVISED DP

REVISED DP COORD

DP RESUBMISSION

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NOT FOR CONSTRUCTION



#### FORM & CHARACTER - DEVELOPMENT PERMIT GUIDELINES

Chapter 2 - The Design Foundations: apply to all projects and provide the overarching principles for supporting creativity, innovation and design excellence in Kelowna.

- Facilitate Active Mobility
- Use Placemaking to Strengthen Neighbourhood Identity
- Create Lively and Attractive Streets & Public Spaces
- Design Buildings to the Human Scale
- Strive for Design Excellence

The General Residential and Mixed Use Guidelines: provide the key guidelines that all residential and mixed use projects should strive to achieve to support the Design Foundations.

 The General Guidelines are supplement by typology-specific guidelines (e.g., Townhouses & Infill on page 18-19, High-Rise Residential and Mixed-Use on page 18-42), which provide additional guidance about form and character.

## Chapter 2 - Design Foundations Apply To All Projects Page 18-8

Section 2.1 - General Residential and Mixed Use Design Guidelines
Page 18-9

Section 2.2 - Achieving High Performance Page 18-17

Chapter 3
Townhouses & Infill

Page 18-19

Chapter 4 Low & Mid-Rise Residential & Mixed Use

Page 18-34

Chapter 5 High-Rise Residential & Mixed Use

Page 18-42

<sup>\*</sup>Note: Refer to the Design Foundations and the Guidelines associated with the specific building typology.



Consideration has been given to the following guidelines as identified in Chapter 18 of the City of Kelowna 2040 Official Community Plan:

	SECTION 2.0: GENERAL RESIDENTIAL AND MIX	KED US	SE.				
	TE PROPOSALS COMPLIANCE TO PERTINENT GUIDELINE	N/A	1	2	3	4	5
	s least complying & 5 is highly complying)						
	General residential & mixed use guidelines	1	1		1		1
	1 Relationship to the Street	N/A	1	2	3	4	5
a.	Orient primary building facades and entries to the fronting street					✓	
	or open space to create street edge definition and activity.						
b.	On corner sites, orient building facades and entries to both	✓					
	fronting streets.						
C.	Minimize the distance between the building and the sidewalk to					✓	
	create street definition and a sense of enclosure.						
d.	Locate and design windows, balconies, and street-level uses to						✓
	create active frontages and 'eyes on the street', with additional						
	glazing and articulation on primary building facades.						
e.	Ensure main building entries are clearly visible with direct sight						<b>√</b>
	lines from the fronting street.						
f.	Avoid blank, windowless walls along streets or other public open						<b>√</b>
	spaces.						
g.	Avoid the use of roll down panels and/or window bars on retail and	<b>√</b>					
	commercial frontages that face streets or other public open						
	spaces.						
h.	In general, establish a street wall along public street frontages to						<b>√</b>
	create a building height to street width ration of 1:2, with a						
	minimum ration of 11:3 and a maximum ration of 1:1.75.						
•	Wider streets (e.g. transit corridors) can support greater streetwall						
	heights compared to narrower streets (e.g. local streets);						
•	The street wall does not include upper storeys that are setback						
	from the primary frontage; and						
•	A 1:1 building height to street width ration is appropriate for a lane						
	of mid-block connection condition provided the street wall height						
	is no greater than 3 storeys.						
2.1	2 Scale and Massing	N/A	1	2	3	4	5
a.	Provide a transition in building height from taller to shorter					1	
	buildings both within and adjacent to the site with consideration						
	for future land use direction.						
b.	Break up the perceived mass of large buildings by incorporating						<b>√</b>
	visual breaks in facades.						
C.	Step back the upper storeys of buildings and arrange the massing						<b>√</b>
	and siting of buildings to:						
•	Minimize the shadowing on adjacent buildings as well as public						
	and open spaces such as sidewalks, plazas, and courtyards; and						
•	Allow for sunlight onto outdoor spaces of the majority of ground						
	floor units during the winter solstice.						
	cg are mines colonies	1	1	1	1	1	1



2.1	.3 Site Planning	N/A	1	2	3	4	5
a.		✓					
	opportunities, such as oddly shaped lots, location at prominent						
	intersections, framing of important open spaces, corner lots, sites						
	with buildings that terminate a street end view, and views of						
	natural features.						
b.	Use Crime Prevention through Environmental Design (CPTED)					✓	
	principles to better ensure public safety through the use of						
	appropriate lighting, visible entrances, opportunities for natural						
	surveillance, and clear sight lines for pedestrians.						
c.	Limit the maximum grades on development sites to 30% (3:1)	<b>√</b>					
d.	Design buildings for 'up-slope' and 'down-slope' conditions	1					
	relative to the street by using strategies such as:	ľ					
•	Stepping buildings along the slope, and locating building						
	entrances at each step and away from parking access where						
	possible;						
•	Incorporating terracing to create usable open spaces around the						
	building						
_	<b>5</b>						
•	Using the slope for under-building parking and to screen service						
	and utility areas;						
•	Design buildings to access key views; and						
•	Minimizing large retaining walls (retaining walls higher than 1 m						
	should be stepped and landscaped).						_
e.	Design internal circulation patterns (street, sidewalks, pathways)						<b>✓</b>
	to be integrated with and connected to the existing and planned						
	future public street, bicycle, and/or pedestrian network.						
f.	Incorporate easy-to-maintain traffic calming features, such as on-	✓					
	street parking bays and curb extensions, textured materials, and						
	crosswalks.						
g.	Apply universal accessibility principles to primary building entries,						✓
	sidewalks, plazas, mid-block connections, lanes, and courtyards						
	through appropriate selection of materials, stairs, and ramps as						
	necessary, and the provision of wayfinding and lighting elements.						
2.1	.4 Site Servicing, Access, and Parking	N/A	1	2	3	4	5
a.	Locate off-street parking and other 'back-of-house' uses (such as						✓
	loading, garbage collection, utilities, and parking access) away						
	from public view.						
b.	Ensure utility areas are clearly identified at the development						<b>√</b>
	permit stage and are located to not unnecessarily impact public or						
	common open spaces.						
C.	Avoid locating off-street parking between the front façade of a						<b>√</b>
	building and the fronting public street.						
d.	In general, accommodate off-street parking in one of the					<b>√</b>	
	following ways, in order of preference:						
•	Underground (where the high water table allows)						
•	Parking in a half-storey (where it is able to be accommodated to						
•	not negatively impact the street frontage);						
	not negatively impact the street nontage);		<u> </u>				



	DEVELOR MENT I DAMINO						
•	Garages or at-grade parking integrated into the building (located						
	at the rear of the building); and						
•	Surface parking at the rear, with access from the lane or						
	secondary street wherever possible.						
e.	Design parking areas to maximize rainwater infiltration through	✓					
	the use of permeable materials such as paving blocks, permeable						
<u> </u>	concrete, or driveway planting strips.	,					
f.	In cases where publicly visible parking is unavoidable, screen using	✓					
	strategies such as:						
•	Landscaping;						
•	Trellises;						
•	Grillwork with climbing vines; or						
•	Other attractive screening with some visual permeability.					_	
g.	Provide bicycle parking at accessible locations on site, including:					<b>√</b>	
•	Covered short-term parking in highly visible locations, such as						
	near primary building entrances; and						
•	Secure long-term parking within the building or vehicular parking						
_	area.						_
h.	Provide clear lines of site at access points to parking, site						✓
:	servicing, and utility areas to enable casual surveillance and safety.				,		
i.	Consolidate driveway and laneway access points to minimize curb				<b>√</b>		
	cuts and impacts on the pedestrian realm or common open						
-	spaces.			-			,
j.	Minimize negative impacts of parking ramps and entrances						<b>√</b>
	through treatments such as enclosure, screening, high quality finishes, sensitive lighting and landscaping.						
~ -	.5 Streetscapes, Landscapes, and Public Realm Design	N/A	1	2			_
a.	Site buildings to protect mature trees, significant vegetation, and	IN/A  √			3	4	5
a.	ecological features.	V					
b.	Locate underground parkades, infrastructure, and other services				<b>√</b>		
J.	to maximize soil volumes for in-ground plantings.				•		
C.	Site trees, shrubs, and other landscaping appropriately to						./
C.	maintain sight lines and circulation.						•
d.	Design attractive, engaging, and functional on-site open spaces						<b>√</b>
<u> </u>	with high quality, durable, and contemporary materials, colors,						*
	lighting, furniture, and signage.						
e.	יני נייודיי וני ני	1	1	1	1	+	1
1	Ensure site planning and design achieves favourable microclimate						✓
							<b>√</b>
•	outcomes through strategies such as:						✓
•	outcomes through strategies such as: Locating outdoor spaces where they will receive ample sunlight						<b>√</b>
•	outcomes through strategies such as: Locating outdoor spaces where they will receive ample sunlight throughout the year;						<b>✓</b>
	outcomes through strategies such as: Locating outdoor spaces where they will receive ample sunlight throughout the year; Using materials and colors that minimize heat absorption;						<b>✓</b>
•	outcomes through strategies such as: Locating outdoor spaces where they will receive ample sunlight throughout the year; Using materials and colors that minimize heat absorption; Planting both evergreen and deciduous trees to provide a balance						<b>√</b>
•	outcomes through strategies such as: Locating outdoor spaces where they will receive ample sunlight throughout the year; Using materials and colors that minimize heat absorption; Planting both evergreen and deciduous trees to provide a balance of shading in the summer and solar access in the winter; and						<b>√</b>
•	outcomes through strategies such as: Locating outdoor spaces where they will receive ample sunlight throughout the year; Using materials and colors that minimize heat absorption; Planting both evergreen and deciduous trees to provide a balance of shading in the summer and solar access in the winter; and Using building mass, trees and planting to buffer wind.						✓ ✓
•	outcomes through strategies such as: Locating outdoor spaces where they will receive ample sunlight throughout the year; Using materials and colors that minimize heat absorption; Planting both evergreen and deciduous trees to provide a balance of shading in the summer and solar access in the winter; and						



	DEVELOPMENT FLOWNING						
g.	Plant native and/or drought tolerant trees and plants suitable for the local climate.						<b>\</b>
h.	Select trees for long-term durability, climate and soil suitability,						<b>√</b>
11.	and compatibility with the site's specific urban conditions.						•
i.	Design sites and landscapes to maintain the pre-development						<b>√</b>
	flows through capture, infiltration, and filtration strategies, such						
	as the use of rain gardens and permeable surfacing.						
j.	Design sites to minimize water use for irrigation by using						✓
	strategies such as:						
•	Designing planting areas and tree pits to passively capture						
	rainwater and stormwater run-off; and						
•	Using recycled water irrigation systems.						_
k.	Create multi-functional landscape elements wherever possible,						<b>√</b>
	such as planting areas that also capture and filter stormwater or						
_	landscape features that users can interact with.	,					
I.	Select materials and furnishings that reduce maintenance requirements and use materials and site furnishings that are	✓					
	sustainably sourced, re-purposed or 100% recycled.						
m	Use exterior lighting to complement the building and landscape						<b>√</b>
111.	design, while:						•
•	Minimizing light trespass onto adjacent properties;						
•	Using full cut-off lighting fixtures to minimize light pollution; and						
•	Maintaining lighting levels necessary for safety and visibility.						
n.	Employ on-site wayfinding strategies that create attractive and	<b>√</b>					
	appropriate signage for pedestrians, cyclists, and motorists using						
	a 'family' of similar elements.						
2.1	.6 Building Articulation, Features and Materials	N/A	1	2	3	4	5
a.	Express a unified architectural concept that incorporates variation						✓
	in façade treatments. Strategies for achieving this include:						
•	Articulating facades by stepping back or extending forward a						
	portion of the façade to create a series of intervals or breaks;						
•	Repeating window patterns on each step-back and extension						
	interval;						
	Providing a porch, patio, or deck, covered entry, balcony and/or bay window for each interval; and						
	Changing the roof line by alternating dormers, stepped roofs,						
	gables, or other roof elements to reinforce each interval.						
b.	Incorporate a range of architectural features and details into						<b>√</b>
	building facades to create visual interest, especially when						
	approached by pedestrians. Include architectural features such as:						
1	approderica by pedestrians. Inclode dienitectoral reactives socii as.					I	1
	bay windows and balconies; corner feature accents, such as turrets						
	bay windows and balconies; corner feature accents, such as turrets or cupolas; variations in roof height, shape and detailing; building						
	bay windows and balconies; corner feature accents, such as turrets						
	bay windows and balconies; corner feature accents, such as turrets or cupolas; variations in roof height, shape and detailing; building entries; and canopies and overhangs.						
	bay windows and balconies; corner feature accents, such as turrets or cupolas; variations in roof height, shape and detailing; building						
	bay windows and balconies; corner feature accents, such as turrets or cupolas; variations in roof height, shape and detailing; building entries; and canopies and overhangs.  Include architectural details such as: Masonry such as tiles, brick,						



	ornamental features and art work; architectural lighting; grills and railings; substantial trim details and moldings / cornices; and trellises, pergolas, and arbors.				
C.	Design buildings to ensure that adjacent residential properties have sufficient visual privacy (e.g. by locating windows to minimize overlook and direct sight lines into adjacent units), as well as protection from light trespass and noise.			✓	
d.	Design buildings such that their form and architectural character reflect the buildings internal function and use.				<b>√</b>
e.	Incorporate substantial, natural building materials such as masonry, stone, and wood into building facades.			✓	
f.	Provide weather protection such as awnings and canopies at primary building entries.				<b>√</b>
g.	Place weather protection to reflect the building's architecture.			<b>√</b>	
h.	Limit signage in number, location, and size to reduce visual clutter and make individual signs easier to see.				<b>√</b>
i.	Provide visible signage identifying building addresses at all entrances.				✓

	SECTION 4.0: LOW & MID-RISE RESIDENTIAL MIXED USE								
RA	TE PROPOSALS COMPLIANCE TO PERTINENT GUIDELINE	N/A	1	2	3	4	5		
(1	is least complying & 5 is highly complying)								
4.3	Low & mid-rise residential & mixed use guidelines								
4.:	1.1 Relationship to the Street	N/A	1	2	3	4	5		
i.	Ensure lobbies and main building entries are clearly visible from						✓		
	the fronting street.								
j.	Avoid blank walls at grade wherever possible by:						✓		
•	Locating enclosed parking garages away from street frontages or								
	public open spaces;								
•	Using ground-oriented units or glazing to avoid creating dead								
	frontages; and								
•	When unavoidable, screen blank walls with landscaping or								
	incorporate a patio café or special materials to make them more								
	visually interesting.								
Re	sidential & Mixed Use Buildings								
k.	Set back residential buildings on the ground floor between 3-5 m						✓		
	from the property line to create a semi-private entry or transition								
	zone to individual units and to allow for an elevated front								
	entryway or raised patio.								
•	A maximum 1.2 m height (e.g. 5-6 steps) is desired for front								
	entryways.								
•	Exceptions can be made in cases where the water table requires								
	this to be higher. In these cases, provide a larger patio and screen								
	parking with ramps, stairs and landscaping.								



I.	Incorporate individual entrances to ground floor units accessible						
	from the fronting street or public open spaces.						,
m.	Site and orient buildings so that windows and balconies overlook						<b>√</b>
	public streets, parks, walkways, and shared amenity spaces while						
, ,	minimizing views into private residences.	N/A	_	_			_
_	2 Scale and Massing	IN/A	1	2	3	4	5
a.	Residential building facades should have a maximum length of 60 m. A length of 40 m is preferred.						<b>√</b>
b.	Residential buildings should have a maximum width of 24 m.						<b>√</b>
о. С.	Buildings over 40 m in length should incorporate a significant						<b>√</b>
С.	horizontal and vertical break in the façade.						<b>V</b>
d.	For commercial facades, incorporate a significant break at	,					
u.	intervals of approximately 35 m.	<b>√</b>					
, 1	.3 Site Planning	N/A	1	2		,	_
<b>4.1</b>	On sloping sites, floor levels should step to follow natural grade	+	_		3	4	5
a.	and avoid the creation of blank walls.	<b>√</b>					
b.	Site buildings to be parallel to the street and to have a distinct					✓	
	front-to-back orientation to public street and open spaces and to						
	rear yards, parking, and/or interior court yards:						
•	Building sides that interface with streets, mid-block connections						
	and other open spaces and should positively frame and activate						
	streets and open spaces and support pedestrian activity; and						
•	Building sides that are located away from open spaces (building						
	backs) should be designed for private/shared outdoor spaces and						
	vehicle access.						
C.	Break up large buildings with mid-block connections which should						✓
	be publicly-accessible wherever possible.						
d.	Ground floors adjacent to mid-block connections should have				✓		
	entrances and windows facing the mid-block connection.						
	.4 Site Servicing, Access and Parking	N/A	1	2	3	4	5
a.	Vehicular access should be from the lane. Where there is no lane,						✓
	and where the re-introduction of a lane is difficult or not possible,						
	access may be provided from the street, provided:						
•	Access is from a secondary street, where possible, or from the						
	long face of the block;						
•	Impacts on pedestrians and the streetscape is minimised; and						
•	There is no more than one curb cut per property.						_
b.	Above grade structure parking should only be provided in						<b>√</b>
	instances where the site or high water table does not allow for						
	other parking forms and should be screened from public view with						
	active retail uses, active residential uses, architectural or						
	landscaped screening elements.	,		1	1		
C.	Buildings with ground floor residential may integrate half-storey	<b>√</b>					
	underground parking to a maximum of 1.2 m above grade, with						
	the following considerations:						



				,			
•	Semi-private spaces should be located above to soften the edge						
	and be at a comfortable distance from street activity; and						
•	Where conditions such as the high water table do not allow for this						
	condition, up to 2 m is permitted, provided that entryways, stairs,						
	landscaped terraces, and patios are integrated and that blank						
	walls and barriers to accessibility are minimized.						
4.1	.5 Publicly-Accessible and Private Open Spaces	N/A	1	2	3	4	5
a.	Integrate publicly accessible private spaces (e.g. private					<b>√</b>	
	courtyards accessible and available to the public) with public open						
	areas to create seamless, contiguous spaces.						
b.	Locate semi-private open spaces to maximize sunlight						<b>√</b>
	penetration, minimize noise disruptions, and minimize 'overlook'						
	from adjacent units.						
Ου	tdoor amenity areas						
c.	Design plazas and urban parks to:	<b>√</b>					
•	Contain 'three edges' (e.g. building frontage on three sides) where	ľ					
	possible and be sized to accommodate a variety of activites;						
•	Be animated with active uses at the ground level; and						
	Be located in sunny, south facing areas.						
d.	Design internal courtyards to:	1					
	Provide amenities such as play areas, barbecues, and outdoor	•					
•	seating where appropriate.						
	•						
•	Provide a balance of hardscape and softscape areas to meet the						
	specific needs of surrounding residents and/or users.				,		
e.	Design mid-block connections to include active frontages, seating				<b>√</b>		
Po	and landscaping. oftop Amenity Spaces						
f.	Design shared rooftop amenity spaces (such as outdoor recreation					,	1
'·	space and rooftop gardens on the top of a parkade) to be					<b>~</b>	
	accessible to residents and to ensure a balance of amenity and						
	privacy by:						
•	Limiting sight lines from overlooking residential units to outdoor						
	amenity space areas through the use of pergolas or covered areas						
	where privacy is desired; and						
•	Controlling sight lines from the outdoor amenity space into						
	adjacent or nearby residential units by using fencing, landscaping,						
	or architectural screening.			1		<u> </u>	
g.	Reduce the heat island affect by including plants or designing a	<b>√</b>					
	green roof, with the following considerations:						
•	Secure trees and tall shrubs to the roof deck; and						
•	Ensure soil depths and types are appropriate for proposed plants						
	and ensure drainage is accommodated.						
4.1	.6 Building Articulation, Features, and Materials	N/A	1	2	3	4	5
a.	Articulate building facades into intervals that are a maximum of 15						✓
	m wide for mixed-use buildings and 20 m wide for residential						
	buildings. Strategies for articulating buildings should consider the						
	potential impacts on energy performance and include:						



	DESCENT INCAST PARTIES					
•	Façade Modulation – stepping back or extending forward a					
	portion of the façade to create a series of intervals in the façade;					
•	Repeating window pattern intervals that correspond to extensions					
	and step backs (articulation) in the building façade;					
•	Providing a porch, patio, deck, or covered entry for each interval;					
•	Providing a bay window or balcony for each interval, while					
	balancing the significant potential for heat loss through thermal					
	bridge connections which could impact energy performance;					
•	Changing the roof line by alternating dormers, stepped roofs,					
•	gables, or other roof elements to reinforce the modulation or					
_	articulation interval;					
•	Changing the materials with the change in building plane; and					
•	Provide a lighting fixture, trellis, tree or other landscape feature					
	within each interval.					
b.	Break up the building mass by incorporating elements that define					✓
	a building's base, middle and top.					
c.	Use an integrated, consistent range of materials and colors and					✓
	provide variety, by for example, using accent colors.					
d.	Articulate the façade using design elements that are inherent to					✓
	the buildings as opposed to being decorative. For example, create					
	depth in building facades by recessing window frames or partially					
	recessing balconies to allow shadows to add detail and variety as a					
	byproduct of massing.					
e.	Incorporate distinct architectural treatments for corner sites and	<b>√</b>				
	highly visible buildings such as varying the roofline, articulating	•				
	the façade, adding pedestrian space, increasing the number and					
	size of windows, and adding awnings or canopies.					
f.	Provide weather protection (e.g. awnings, canopies, overhangs,					<b>√</b>
'-	etc.) along all commercial streets and plazas with particular					•
	attention to the following locations:					
•	Primary building entrances;,					
•	Adjacent to bus zones and street corners where people wait for					
	traffic lights;					
•	Over store fronts and display windows; and					
•	Any other areas where significant waiting or browsing by people					
	occurs.					
g.	Architecturally-integrate awnings, canopies, and overhangs to the					✓
	building and incorporate architectural design features of buildings					
L	from which they are supported.		L			
h.	Place and locate awnings and canopies to reflect the building's					✓
	architecture and fenestration pattern.					
i.	Place awnings and canopies to balance weather protection with				$\neg \uparrow$	<b>√</b>
	daylight penetration. Avoid continuous opaque canopies that run					
	the full length of facades.					
j.	Provide attractive signage on commercial buildings that identifies	<b>√</b>			-+	
٦.	uses and shops clearly but which is scaled to the pedestrian rather	<b>V</b>				
	oses and shops clearly but which is scaled to the pedestrial lattler	1	1	1		
	than the motorist. Some exceptions can be made for buildings					




	located on highways and/or major arterials in alignment with the City's Sign Bylaw.				
k.	Avoid the following types of signage:	✓			
•	Internally lit plastic box signs;				
•	Pylon (stand alone) signs; and				
•	Rooftop signs.				
I.	Uniquely branded or colored signs are encouraged to help	✓			
	establish a special character to different neighbourhoods.				







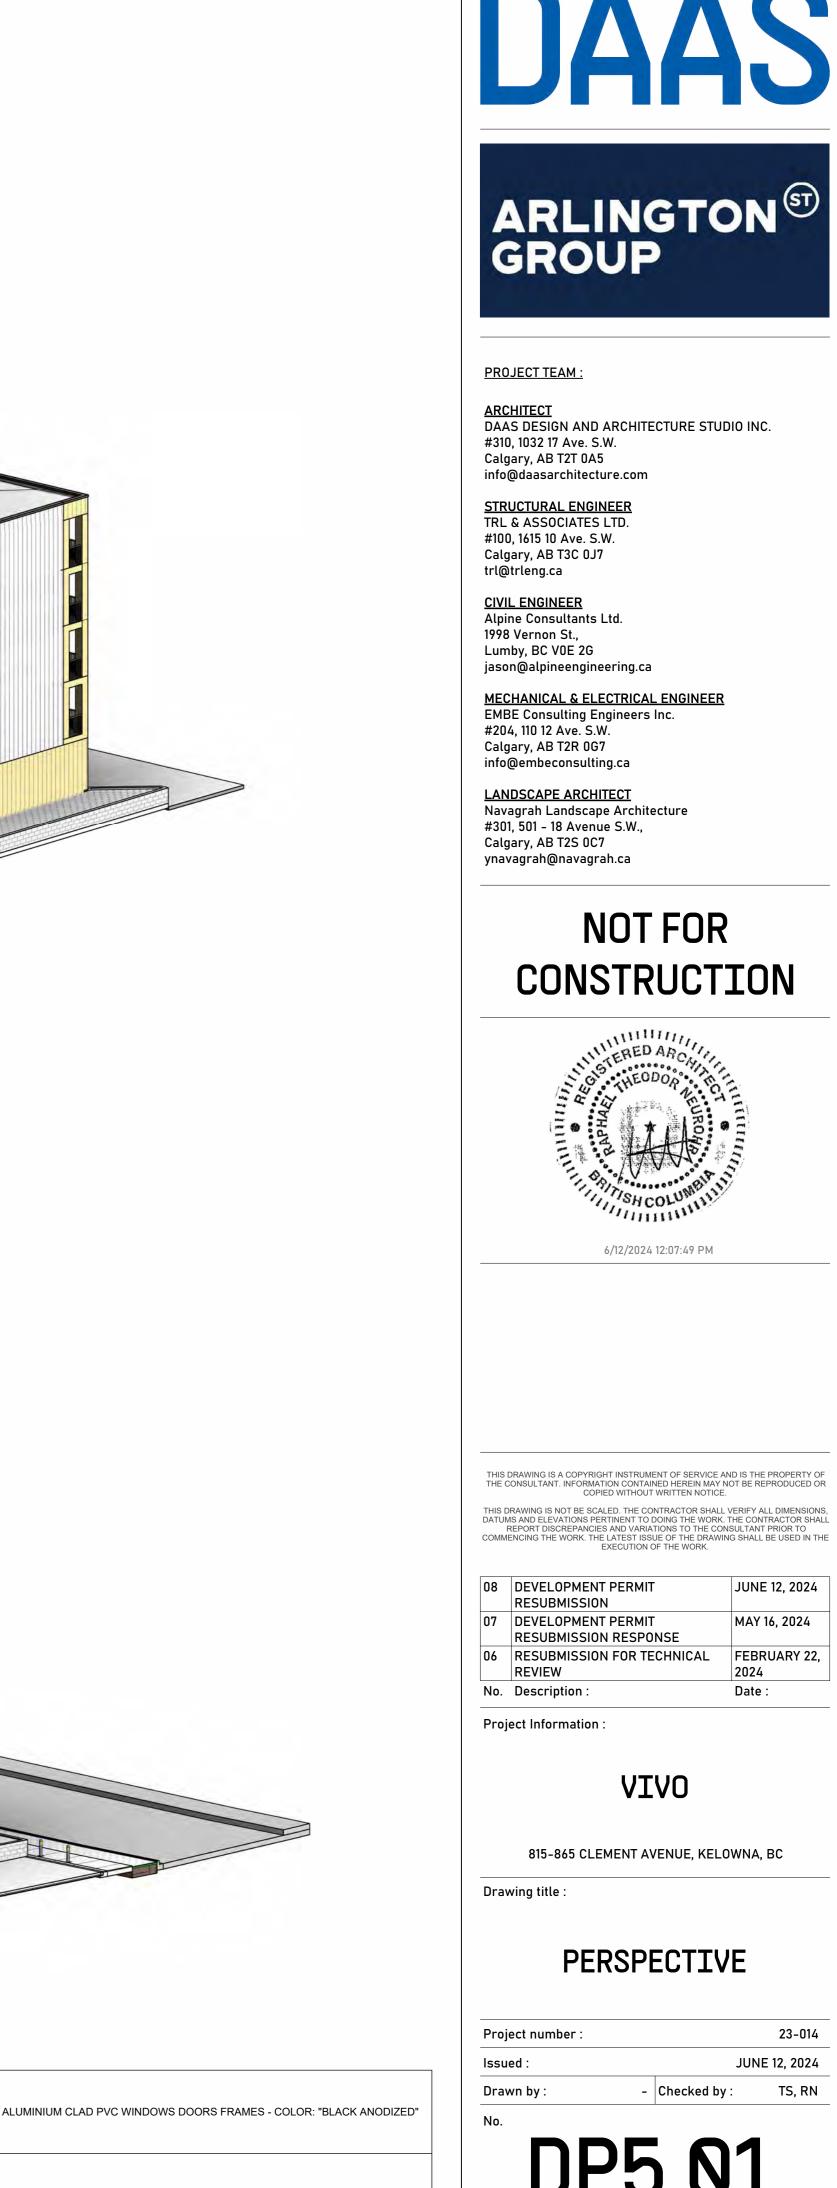





PERSPECTIVE - SOUTHEAST

ATTACHMENT C

# DP23-0008

Planner Initials MT

**ELEVATION LEGEND** METAL PANEL (FASTPLANK) - COLOR: "CHAMPAGNE METAL PANEL (QUICKPANEL) -GLASS RAILING COLOR: "WHITE"

ALUMINIUM RAILING PICKET - COLOR: "BLACK" METAL PANEL (FASTPLANK) - COLOR: "CHARCOAL" CONCRETE - COLOR: "GREY"

LOUVERS - COLOR TO MATCH: "CHARCOAL"

Scale :

ARLINGTON ST GROUP


ARCHITECT
DAAS DESIGN AND ARCHITECTURE STUDIO INC.

#310, 1032 17 Ave. S.W. Calgary, AB T2T 0A5 info@daasarchitecture.com

jason@alpineengineering.ca

Calgary, AB T2S 0C7 ynavagrah@navagrah.ca

# NOT FOR CONSTRUCTION

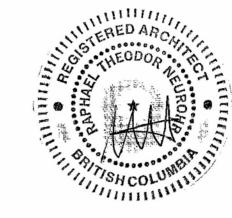

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08	DEVELOPMENT PERMIT	JUNE 12, 2024
	RESUBMISSION	
07	DEVELOPMENT PERMIT	MAY 16, 2024
	RESUBMISSION RESPONSE	
06	RESUBMISSION FOR TECHNICAL	FEBRUARY 22,
	REVIEW	2024
No.	Description :	Date :
	·	

VIVO

815-865 CLEMENT AVENUE, KELOWNA, BC

PERSPECTIVE


Project number :			23-0
Issued :		JUL	NE 12, 202
Drawn by :	_	Checked by :	TS, R

DP5.01





**PERSPECTIVE - NORTHWEST** 

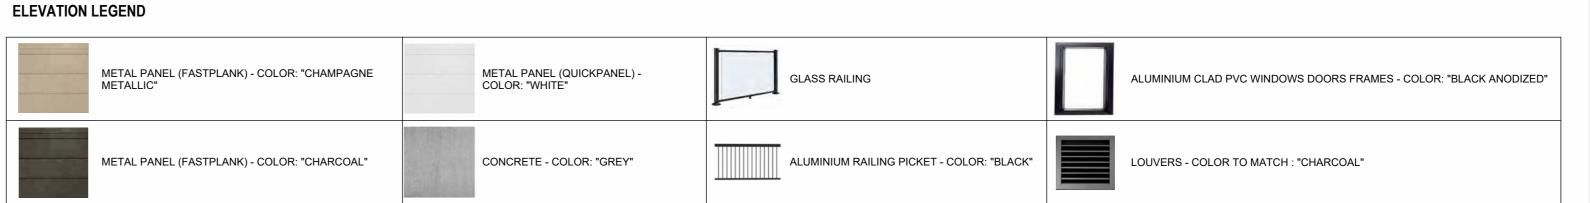





PROJECT TEAM:

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STRUCTURAL ENGINEER
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<u>CIVIL ENGINEER</u> Alpine Consultants Ltd. . 1998 Vernon St., Lumby, BC V0E 2G jason@alpineengineering.ca


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THIS DRAWING IS NOT BE SCALED. THE CONTRACTOR SHALL VERIFY ALL DIMENSIONS, DATUMS AND ELEVATIONS PERTINENT TO DOING THE WORK. THE CONTRACTOR SHALL REPORT DISCREPANCIES AND VARIATIONS TO THE CONSULTANT PRIOR TO COMMENCING THE WORK. THE LATEST ISSUE OF THE DRAWING SHALL BE USED IN THE EXECUTION OF THE WORK.

80	DEVELOPMENT PERMIT	JUNE 12, 2024
	RESUBMISSION	
07	DEVELOPMENT PERMIT	MAY 16, 2024
	RESUBMISSION RESPONSE	
06	RESUBMISSION FOR TECHNICAL	FEBRUARY 22
	REVIEW	2024
No.	Description :	Date :

VIVO

815-865 CLEMENT AVENUE, KELOWNA, BC

Drawing title :

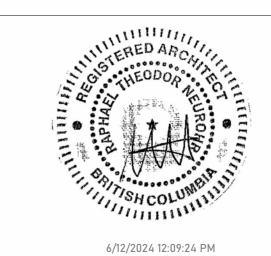Scale :

PERSPECTIVE

Project number :		23-01
Issued :	JU	NE 12, 202
Drawn by :	- Checked by:	TS, R

DP5.02

<b>ATTACHMEN</b>	VT D
This forms part of appli	cation
# DP23-0008	🗱 💥
	City of
Planner Initials MT	Kelowna DEVELOPMENT PLANNING

#### **CO-OPERATIVE CARSHARING AGREEMENT** Mav

2024

THIS AGREEMENT made the 16th	day of,	2024
BETWEEN:		
MODO CO-OPERATIVE 200 - 470 Granville Street Vancouver, BC V6C 1V5	("Modo")	
AND:		
<b>ASI VIVO GP INC.</b> 400 1550 5 <sup>th</sup> Street SW Calgary AB, T2R 1K3		
	("Developer")	

#### WHEREAS:

A. Developer is the registered owner of those certain lands located 815-856 Clement Avenue in Kelowna and legally described as follows:

#### Legal lot description: LOTS 14-23 OF 30 TOWNSHIP 26 OSOYOOS **DIVISION TALE DISTRICT PLAN 1277**

(the "Lands");

- B. Developer intends to construct or to cause to be constructed a rental residential development (the "Development") on the Lands;
- C. It is intended that Development will include 202 rental units (collectively the "Rental Units", and each a "Rental Unit");
- D. Modo is a member-owned co-operative that facilitates carsharing for individuals and businesses as an alternative to privately-owned automobiles:
- E. As a condition of approving the Development, the City of Kelowna (the "Municipality") requires Developer to provide two (2) co-operative vehicles (each a "Shared Vehicle" and, collectively, the "Shared Vehicles") in connection with the Development and to be available as part of a service to share the use of the Shared Vehicles (the "Carsharing Program");



- F. In addition, the Municipality requires Developer to designate two (2) parking spaces at the Development for the exclusive use of the Shared Vehicles (the "Shared Vehicle Parking Spaces" as set out in Schedule A hereto) and free-of-charge to Modo;
- G. Modo will deliver the Shared Vehicles to the Shared Vehicle Parking Spaces and will make the Shared Vehicles available for use in accordance with the terms of this Agreement;
- H. Modo will, at its cost, operate, maintain, repair and insure the Shared Vehicles and administer the service to share the Shared Vehicles (collectively, the "Services");
- Developer and Modo intend that the Shared Vehicles will be available for use by all members of Modo (collectively, the "Modo Members" and each a "Modo Member"), including the Residents who become Modo Members; and
- J. Developer and Modo wish to set out in this Agreement the terms and conditions of the Carsharing Program as it pertains to the Development.

**NOW THEREFORE** in consideration of the sum of Ten (\$10.00) Dollars now paid by each party to the other (the receipt and sufficiency of which is hereby acknowledged) and in consideration of the mutual promises and covenants contained herein, the parties agree as follows:

#### **ARTICLE 1 - DEFINITIONS**

- 1.1 Definitions. In this Agreement, the following terms have the following meanings:
  - (a) "Agreement" means this agreement, any schedules attached hereto which are referred to in this agreement, and every properly executed instrument which by its terms amends, modifies, supplements, or extends this agreement;
  - (b) "Arbitrator" has the meaning set out in section 14.1(d);
  - (c) "Carsharing Program" has the meaning set out in Recital E:
  - (d) "Commencement Date" means the date on which the Occupancy Permit is issued by the Municipality;
  - (e) "Contract Fees" means collectively the Project Fee (as defined below) and the Phased Shared Vehicle Project Fee (as defined below), and "Contract Fee" means any one of them;
  - (f) "Developer" means the party defined as Developer on the first page of this Agreement and any of its heirs, executors, administrators, successors, assigns, subsidiaries or nominees who may assume Developer's right, title or interest in the Development and/or this



Agreement from Developer named herein, and expressly includes any person which may manage or operate the Development for Developer from time to time;

- (g) "Development" has the meaning set out in Recital B;
- (h) "Driving Credits" has the meaning set out in section 7.2;
- (i) "Estimated Occupancy Date" has the meaning set out in section 3.5:
- (j) "EV Stations" means two (2) electric vehicle charging stations (which specifications are defined in Schedule B) to be provided, installed, maintained and replaced by Developer, at Developer's sole cost, to be used for the sole purpose of charging the Shared Vehicles, and to be located adjacent to the Shared Vehicle Parking Spaces;
- (k) "Lands" has the meaning set out in Recital A;
- (I) "Marketing Program" has the meaning set out in section 7.2:
- (m) "Mediator" means a member in good standing of the Arbitrators Association of British Columbia or Mediate BC:
- (n) "Membership Holder" means the Rental Owner;
- (0) "Membership Shares" means membership shares in Modo:
- (p) "Modo Members" has the meaning set out in Recital I:
- (q) "Municipality" has the meaning set out in Recital E;
- (r) "Occupancy Permit" means the first occupancy permit issued by the Municipality in respect of the Development;
- (s) "Partnership Membership" means the Membership Holder membership in Modo by way of ownership of the Subject Shares;
- (t) "Partner User" means a Resident (as defined below) of the Development who benefits from Modo membership privileges by way of the Partnership Membership;
- (u) "Phased Shared Vehicle Project Fee" has the meaning set out in section 2.4;
- (v) "Phased Shared Vehicle Purchase Notice" has the meaning set out in section 2.4;
- (w) "Project Fee" has the meaning set out in section 2.1;



- (x) Rental Owner" means the registered owner of the Rental Units;
- (y) "Rental Units" has the meaning set out in Recital C;
- (z) "Residents" means collectively, the tenants of the Rental Units and "Resident" means any one of them;
- (aa) "Rules" has the meaning set out in section 5.4(a);
- (bb) "Services" has the meaning set out in Recital H;
- (cc) "Shared Vehicles" has the meaning set out in Recital E;
- (dd) "Shared Vehicle Deployment Sequence" has the meaning set out in section 2.4;
- (ee) "Shared Vehicle Minimum Term" means the term of three (3) years for each Shared Vehicle, commencing from the later of the Commencement Date or the first date that the applicable Shared Vehicle is made available for use by Modo Members at a Shared Vehicle Parking Space;
- (ff) "Shared Vehicle Parking Space" has the meaning set out in Recital G;
- (gg) "Subject Shares" has the meaning set out in section 2.1(b);
- (hh) "Sustainable Usage Levels" means the level of use of the Modo vehicles by Modo Members that remains cost-effective to meet Modo's usage goals; and,
- (ii) "Term" means the term of this Agreement as described in section 9.1.

#### **ARTICLE 2 - PROJECT FEE**

- 2.1 At least sixty (60) days prior to Estimated Occupancy Date, Developer will pay to Modo the aggregate sum of \$32,000.00 plus GST (the "**Project Fee**"), representing the following:
  - (a) \$1,000.00 for the purchase of one hundred (100) Membership Shares (the "Subject Shares"); and
  - (b) the Project Fee minus \$1,000.00 to be used by Modo toward the ownership costs of one (1) Shared Vehicle.
- 2.2 Upon payment of the Project Fee, Modo will issue the Subject Shares to Developer and will issue a receipt to Developer confirming payment of the Project Fee to Modo.



- 2.3 Developer agrees that Modo will not be under any obligation whatsoever to provide the Services or issue the Subject Shares if Modo has not received full payment of the Project Fee from Developer by the required deadline set out in section 2.1 of this Agreement.
- 2.4 When the terms for the provision of each of the second of the Shared Vehicles have been satisfied pursuant to the provisions in the applicable row of the deployment sequence of the Shared Vehicles (the "Shared Vehicle Deployment Sequence") as set out in Schedule C hereto, Modo will provide written notice (the "Phased Shared Vehicle Purchase Notice") to Developer, and, within 30 days, Developer will pay to Modo the sum of \$32,000.00 plus GST (the "Phased Shared Vehicle Project Fee") to be used by Modo toward the ownership costs of such additional Shared Vehicle.
- 2.5 Upon payment of a Phased Shared Vehicle Project Fee, Modo will issue a receipt to Developer confirming payment of such Phased Shared Vehicle Project Fee to Modo.
- 2.6 If the Occupancy Permit is issued later than in the year 2026, the Contract Fees will increase by 4% for each year thereafter, on January 1<sup>st</sup> of such year and until the Occupancy Permit is issued, including the year the Occupancy Permit is issued.

#### ARTICLE 3 - BENEFITS AND OBLIGATIONS OF DEVELOPER

- 3.1 Developer agrees to designate the Shared Vehicle Parking Spaces for the exclusive use of Modo as set out in Schedule A hereto, in compliance with the standards set out in Schedule B and free-of-charge to Modo from the Commencement Date and throughout the Term.
- 3.2 Developer agrees that throughout the Term, subject to section 11.5, the Shared Vehicle Parking Spaces will be accessible to and exclusively useable by Modo Members on a 24 hours a day, 7 days a week basis.
- 3.3 Developer permits Modo to directly authorize removal of unauthorized vehicles parked in the Shared Vehicle Parking Spaces through the towing company contracted by Developer, or a towing company of Modo's choice in the event there is not a designated contractor or if that contractor is unavailable. Any unauthorized vehicle parked in the Shared Vehicle Parking Spaces may be removed by Modo at the vehicle owner's risk and expense.
- 3.4 aDeveloper agrees that from the Commencement Date and throughout the Term, the EV Stations will be operational and designated for the exclusive use of Modo.
- 3.5 At least sixty (60) days prior to the date Developer anticipates that the Occupancy Permit will be issued, Developer will provide written notice to Modo of such estimated date (the "Estimated Occupancy Date").



- 3.6 Promptly upon issuance of the Occupancy Permit, Developer will further provide Modo with written notice of the Commencement Date.
- 3.7 Upon completion of Developer's obligations under section 2.1 and assumption of this Agreement by the Membership Holder pursuant to section 4.1, Developer will cause the Subject Shares, which together form the Partnership Membership, to be transferred to and registered in the name of the Membership Holder and the Membership Holder will hold the Subject Shares on behalf of and for the benefit of the Residents, subject to section 5.4.
- 3.8 Developer warrants that it will cause its subsidiaries and any party which may manage or operate the Development from time to time to comply with the terms of this Agreement and will cause any of its successors or permitted assigns to enter into an assumption agreement, provided that, upon such assumption, Developer will be released of its obligations hereunder to the extent its obligations are so assumed.

#### **ARTICLE 4 - ASSUMPTION BY MEMBERSHIP HOLDER**

- 4.1 Once Developer is in a position to do so (as determined by Developer in its sole discretion), Developer will:
  - (a) assign the Developer's interest in and to this Agreement to the Rental Owner;
  - (b) cause the Rental Owner to assume: (i) Developer's covenants and obligations under this Agreement as it relates to the Development; and (ii) any other covenants and obligations under this Agreement as it relates to the Development which are expressly identified as covenants or obligations of the Rental Owner or the Membership Holder; and
  - transfer an undivided interest in and to the Subject Shares to the Rental Owner concurrently with such assumption, and Modo hereby consents to such transfer.
- 4.2 Effective upon the assumption of this Agreement by the Membership Holder pursuant to section 4.1, Developer and its nominees, subsidiaries and other affiliates will have no further obligations or liabilities whatsoever hereunder, except that Developer (and not the Membership Holder) will continue to be liable for Developer's obligations under section 2.4.

#### ARTICLE 5 - BENEFITS AND OBLIGATIONS OF THE MEMBERSHIP HOLDER

5.1 The parties agree that, following the transfer described in section 4.1, the Subject Shares will be registered in the name of the Membership Holder. The Membership Holder will be the legal owner of all the Subject Shares, and their beneficial interest will vest in the Residents in accordance with this Agreement.



- The Subject Shares, and the benefit of the Partnership Membership, will not be allocated or divided in any manner as between the Residents, and there will be no limit on the number of Residents of any given Rental Unit that may apply to be Partner Users at any given time (subject to the overall limit on the number of Partner Users set out in section 6.1).
- 5.3 The parties agree that the Residents will not automatically become Modo Members and must apply to join Modo and meet Modo's membership requirements in order to be eligible to use the Shared Vehicles and participate in the Carsharing Program.
- 5.4 The Membership Holder agrees that, upon assuming this Agreement, it will:
  - (a) use reasonable commercial efforts to make available to the Residents the rules set out in Schedule D hereto (the "Rules"); and
  - (b) at all times retain joint ownership of the Subject Shares.
- 5.5 Every six (6) months during the Term (commencing within six (6) months after the Commencement Date), Modo will provide the Rental Owner in writing with the name of each Partner User.
- Within thirty (30) days after receipt of the information, referred to in section 5.5, the Membership Holder will confirm to Modo in writing which Partner Users have, to the best of the applicable Membership Holder's knowledge, ceased to be Residents, and Modo will cancel such Partner Users' benefits of the Partnership Membership and such former Residents will cease to be Partner Users.
- 5.7 The Rental Owner agrees to pay for the electricity withdrawn from the EV Stations when due and Modo will reimburse the Rental Owner in accordance with section 6.15.

#### ARTICLE 6 - BENEFITS AND OBLIGATIONS OF MODO

- Modo agrees that the Partnership Membership will allow up to a maximum number of Residents to be Partner Users at any given time, such maximum number to be equal to the Contract Fees paid hereunder at such given time divided by \$500, rounded down to the closest whole number. For greater certainty, once the foregoing number of Partner Users has been reached, no other Resident may become a Partner User unless an existing Partner User ceases to be a Partner User.
- Any number of Residents of any given Rental Unit may apply to Modo to become Partner Users, and each such Resident who becomes a Partner User will count as a separate Partner User for the purposes of the limit set out in section 6.1.



- 6.3 Modo covenants and agrees that the Partnership Membership will grant Partner Users the benefit of usage of Modo vehicles at the same usage rates as shareholders of Modo but without voting rights.
- Modo will use the Contract Fees, less the amount required to purchase the Subject Shares, toward the ownership costs of two (2) new four-wheeled automobiles with electric motorization, provided that Modo may temporarily use four-wheeled automobiles with internal combustion engines as the Shared Vehicles if Modo is unable to procure and deliver new four-wheeled automobiles with electric motorization within the time period set out in the Shared Vehicle Deployment Sequence. In the event that Modo is temporarily using four-wheeled automobiles with internal combustion engines as the Shared Vehicles, Modo will use reasonable commercial efforts to replace such automobiles with new four-wheeled automobiles with electric motorization as soon as possible after the Commencement Date at no additional cost to Developer or the Membership Holder.
- 6.5 Forthwith upon the purchase of each Shared Vehicle, Modo will provide Developer with a copy of such Shared Vehicle's registration evidencing that such Shared Vehicle is registered in the name of Modo together with proof of insurance.
- 6.6 Modo will deliver the Shared Vehicles to the Shared Vehicle Parking Spaces and will make the Shared Vehicles available for use by Modo Members in accordance with the terms of this Agreement and pursuant to the Shared Vehicle Deployment Sequence.
- In the event that the Occupancy Permit is not issued within thirty (30) days after the Estimated Occupancy Date, Modo reserves the right to park the Shared Vehicles at another location suitable for its use within the Carsharing Program and make them available for use by Modo Members, provided always that Modo will deliver the Shared Vehicles to the Shared Vehicle Parking Spaces by no later than the date(s) set out in the Shared Vehicle Deployment Sequence.
- 6.8 Modo agrees to provide the Shared Vehicles for the use of Modo Members and to cause the Shared Vehicles to be parked in the Shared Vehicle Parking Spaces at all times when not in use by a Modo Member and when not being repaired or serviced.
- 6.9 Modo will be the sole provider of the Carsharing Program in respect of the Shared Vehicles during the Term.
- 6.10 The parties agree that Modo will not be responsible for any costs related to the use of and access to the Shared Vehicle Parking Spaces during the Term, including, without limitation, the maintenance of the Shared Vehicle Parking Spaces.

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- 6.11 Notwithstanding the foregoing, Modo must promptly and at its own expense clean up any oil or other substance which spills or leaks from a Shared Vehicle into or onto any part of the Development, failing which Developer may clean up such spill or leak, and Modo will, forthwith on demand reimburse Developer for the cost thereof.
- 6.12 Modo will at its sole expense provide Developer with appropriate signage for the Shared Vehicle Parking Spaces.
- 6.13 Modo will be solely responsible for providing and paying for the Services, including but not limited to the operation, administration, maintenance, repair, replacement and insurance costs in respect of the Shared Vehicles and the Carsharing Program in a prudent manner. If a Shared Vehicle is damaged beyond repair during the Shared Vehicle Minimum Term for such Shared Vehicle, then Modo will promptly replace such Shared Vehicle with a vehicle of at least equivalent value and function and such replacement vehicle will constitute the Shared Vehicle for all purposes hereunder.
- 6.14 The parties agree that Developer and the Membership Holder will not be responsible for any costs associated with the Shared Vehicles, the EV Stations, the Carsharing Program or the Services, including, without limitation, any applicable taxes or delivery fees in respect of the purchase of the Shared Vehicles or any user or membership fees of any of the Residents, other than the payment of the Contract Fees and the maintenance, use of and access to the Shared Vehicle Parking Spaces and EV Stations.
- 6.15 Modo will reimburse the Rental Owner the amount paid by the Rental Owner for the electricity withdrawn from the EV Stations, based on data logs and reports from the EV Stations. The reimbursement will be made in arrears on a yearly basis, starting on the Commencement Date or such other date as may be agreed upon by the Rental Owner and Modo.
- 6.16 Modo reserves the right to temporarily relocate some or all of the Shared Vehicles from the Shared Vehicle Parking Spaces if some or all of the Shared Vehicle Parking Spaces cannot be used as contemplated in section 3.1 or 3.2 and for a duration greater than twenty-four (24) consecutive hours, provided that once the Shared Vehicle Parking Spaces are available for use as contemplated in sections 3.1 and 3.2, Modo will promptly return the Shared Vehicles back to the Shared Vehicle Parking Spaces.
- 6.17 Modo reserves the right to temporarily relocate some or all of the Shared Vehicles from the Shared Vehicle Parking Spaces if some or all of the EV Stations cannot be used as contemplated in section 3.4 for a duration greater than twenty-four (24) consecutive hours, provided that once the EV Stations are available for use as contemplated in section 3.4, Modo will promptly return the Shared Vehicles back to the Shared Vehicle Parking Spaces.



- 6.18 Modo will provide orientation to all Residents wishing to participate in the Carsharing Program.
- 6.19 Modo will provide Developer with marketing materials to promote participation in the Services to Residents and prospective residents of the Development.
- 6.20 Modo confirms and agrees that, in accordance with Modo's membership documentation, each Resident will be individually responsible for any and all actions, causes of action, costs or claims of whatsoever type or nature levied or made by Modo or by any other person as a result of or in connection with such Resident's participation in the Services or otherwise arising from the Subject Shares of, or membership in, Modo held by the Membership Holder or its affiliates, subsidiaries, successors or assigns.
- 6.21 Modo represents and warrants that there are no other obligations associated with the holding of the Subject Shares by the Membership Holder beyond those which are contemplated in this Agreement, in the Rules, or at law.

#### **ARTICLE 7 - MARKETING AND ASSESSMENT**

- 7.1 Modo acknowledges that the Rental Units will be occupied by Residents that will change over time.
- 7.2 Modo will establish a marketing program (the "Marketing Program") where Modo will, within fifteen (15) days following the Commencement Date, credit \$100 of driving credits ("Driving Credits") to the Modo account of each Resident who becomes a Modo Member for the first time, which Driving Credits will only be applied to fees for usage of Modo vehicles, for the duration of the Term.
- 7.3 Throughout the duration of the leasing and occupancy phases of the Development, Developer agrees to communicate the benefits of the Carsharing Program to prospective residents and Residents. This will be done through Developer's existing communications channels such as email, website, collateral, leasing agents and property managers, with the intent to raise awareness and usage of the Services, and with the information and materials in support provided by Modo, including:
  - (a) a short description of Modo, the Services, the Driving Credits and the Partnership Membership on the Development's website (if applicable):
  - (b) to the extent permitted by law, a direct email or mail to the Residents shortly after such Residents have moved into the Development, with a link to a dedicated "welcome" page on Modo's website;
  - (c) to the extent permitted by law, a follow up direct email or mail to the Residents six (6) months after first occupation of the Development, with a link to a dedicated "welcome" page on Modo's website; and

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 a small notice (sticker or poster) in a prominent location (i.e. elevator, community room), providing a short description of the Services, the Driving Credits and the Partnership Membership,

and the Membership Holder consents and agrees to the foregoing and will take such steps as reasonably required to assist Developer in carrying out the foregoing obligations.

- 7.4 From the date of this Agreement until the termination of this Agreement,
  Developer and Modo will allow use of each other's graphics in advertising and
  promotional activities conducted by either party. Such use of graphics must be in
  a manner whereby the graphics remain in their original form and each party will
  use the most recent version of the other party's graphics (as approved by each
  party in writing).
- 7.5 Developer and Modo will only use each other's wordmarks, logos or trade names pursuant to section 7.4 solely in connection with activities relating to the Development. Any other use must receive the prior written approval of each party (by mail or electronic mail).
- 7.6 The Membership Holder will permit Modo to assess, not more than once a year, the impacts of its Services by facilitating the administration of assessment measures including, but not limited to (and to the extent permitted by law), the distribution of emails, surveys and questionnaires for the Residents relative to the Services, provided that the Residents, in their sole discretion, may elect not to participate in any such assessment measures.

#### **ARTICLE 8 - SECURITY INTEREST**

- 8.1 Subject to receipt of the applicable Contract Fees for the applicable Shared Vehicle or Shared Vehicles, Modo agrees to grant to Developer a security interest in such Shared Vehicle or Shared Vehicles and to execute and deliver to Developer a security agreement in substantially the form attached as Schedule E hereto.
- 8.2 Modo acknowledges and agrees that Developer may register a security interest in each Shared Vehicle for a term equal to the Shared Vehicle Minimum Term for such Shared Vehicle in the British Columbia Personal Property Registry.

#### **ARTICLE 9 - NO FIXED TERM**

9.1 The term (the "Term") will commence on the date this Agreement is executed by the parties. This Agreement will not have a fixed term and will continue in full force and effect until terminated in accordance with the terms hereof provided that Modo agrees to provide the Services in respect of each Shared Vehicle for a minimum term equal to the Shared Vehicle Minimum Term for such Shared Vehicle.



#### **ARTICLE 10 - MUTUAL REPRESENTATIONS**

- 10.1 Each party represents and warrants to the other that:
  - (a) it is an entity duly organized and validly existing under the laws of its jurisdiction of organization or incorporation;
  - (b) it has the requisite power and authority to enter into this Agreement and to carry out its obligations under this Agreement; and
  - (c) such party's obligations under this Agreement constitute legal, valid and binding obligations, enforceable against such party in accordance with the terms herein.

#### ARTICLE 11 - TERMINATION AND AMENDMENT

- 11.1 Developer and Modo agree that, if after execution of this Agreement, Developer does not receive approval for a development permit, a building permit or any other permit necessary to construct and complete the Development from the Municipality then Developer will give notice of same and thereafter this Agreement will terminate and both parties will be relieved of their obligations herein, except as expressly set out herein.
- 11.2 No amendment, addition, deletion or other modification to this Agreement will be effective unless in writing and signed by each party.
- 11.3 During a Shared Vehicle Minimum Term, this Agreement may not be amended or terminated without the prior written consent of the Municipality.
- 11.4 Notwithstanding sections 11.2 and 11.3, Modo reserves the right to make reasonable amendments to the rules governing the Membership Shares and ownership of the Subject Shares as set out in Schedule D, so long as such changes apply equally to all Residents. Upon any amendments, Modo will immediately notify the Membership Holder, following which the Membership Holder will notify the Residents of such amendments.
- 11.5 Developer and Modo agree that, if the usage of a Shared Vehicle falls below Sustainable Usage Levels, and only after the Shared Vehicle Minimum Term of such Shared Vehicle has expired, Modo may exercise its right, in its sole discretion, to: (i) replace such Shared Vehicle with any vehicle of Modo's choice, or (ii) relocate such Shared Vehicle from the Shared Vehicle Parking Spaces, in each case so as to ensure that the terms of the Agreement are not oppressive to Modo or its members.
- 11.6 In the event of relocation of all Shared Vehicles pursuant to section 11.5, then the Shared Vehicle Parking Spaces will no longer need to be made available to Modo and sections 3.1 to 3.4, 5.7, 6.8, 6.9, 6.12 and 6.15 will cease to apply, and Modo will not be obligated hereunder to provide the Services or make the Shared

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Vehicles available for use of Residents, but, for greater certainty, the Partnership Membership will continue in effect. For the avoidance of doubt, in the event of a replacement of a Shared Vehicle pursuant to section 11.5, this section 11.6 will not apply.

- 11.7 If the Development is destroyed and not rebuilt in a form substantially similar to the original buildings, either of the parties may terminate this Agreement and in such case Modo will cancel the Subject Shares held by the Membership Holder, and the Membership Holder will not be entitled to a refund of the purchase price paid for the Subject Shares or any part thereof.
- 11.8 Either party will have the right to terminate this Agreement forthwith on the dissolution, winding up or bankruptcy of the other party.

#### **ARTICLE 12 - SUBSEQUENT TRANSFERS OF RENTAL UNITS**

12.1 If at any time following the assumptions and transfer referred to in section 4.1, the Rental Owner subsequently transfers its interest in the Rental Units to a transferee, then the Rental Owner will cause such transferee to execute an assumption agreement which provides that such transferee agrees to be bound by the terms and conditions of this Agreement and assumes all of the obligations of Developer and the Membership Holder under this Agreement, and the Rental Owner will transfer the Rental Owner's interest in the Subject Shares to such transferee, and the transferring Rental Owner will not be liable for any obligations or liabilities arising hereunder from and after the date of such transfer.

#### **ARTICLE 13 - DEFAULT**

13.1 A party claiming default under the terms of this Agreement must provide the defaulting party with written notice of the default. If the defaulting party fails to correct the default within thirty (30) days of receipt of such written notice, the party claiming default may deliver notice of dispute in accordance with section 14.1(a) and proceed with the dispute resolution procedures provided for in ARTICLE 14 -.

#### **ARTICLE 14 - DISPUTE RESOLUTION**

- 14.1 If a dispute arises between the parties in connection with this Agreement, then Developer and Modo agree to use the following procedure to resolve the dispute:
  - (a) the party initiating the dispute will send a notice of dispute in writing to the other party which notice will contain the particulars of the matter in dispute and the relevant provisions of this Agreement and the responding party will send a notice of reply in writing to the other party to the dispute within ten (10) days after receipt of the notice of dispute, setting out particulars of its response and any relevant provisions of the Agreement;

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- (b) if the dispute remains unresolved for thirty (30) days after a notice of dispute has been issued as per section 14.1(a)., or if a default is not cured within thirty (30) days after either party notifies the other of such default, the parties will agree upon and appoint a Mediator for the purpose of mediating such dispute. The appointment of the Mediator will be carried out in accordance with the terms and conditions of an agreement to be entered into between the parties and the Mediator which will set out the terms of reference for the engagement of the Mediator. The Mediator will conduct a non-binding mediation of the dispute according to the rules and procedures as determined by the Mediator. If the parties fail or neglect to agree upon a Mediator within ten (10) days following the end of the relevant 30-day period referred above, the dispute will be resolved by an Arbitrator (as defined below) in accordance with section 14.1(d). No individual with any direct or indirect interest in the subject matter of this Agreement or any direct or indirect interest in the parties to this Agreement may be appointed as a Mediator;
- (c) if the dispute has not been resolved within ten (10) days after the Mediator has been appointed under section 14.1(b), or within such further period agreed to by the parties, the Mediator will terminate the mediated negotiations by giving notice in writing to both parties;
- (d) except for claims for injunctive relief, all claims and disputes between the parties to this Agreement arising out of or relating to this Agreement which are not resolved by the Mediator in accordance with section 14.1, will be decided by final and binding arbitration before a single arbitrator (the "Arbitrator") in accordance with the Arbitration Act (British Columbia). The parties will agree upon the Arbitrator within fifteen (15) days of the Mediator terminating the mediated negotiations. Failing such agreement between the parties, such Arbitrator will be finally chosen by reference to a Judge of the Supreme Court of British Columbia. The Arbitrator will not have any direct or indirect interest in the subject matter of the Development or any direct or indirect interest in either party of subsidiaries of the parties to this Agreement. No arbitration arising out of or relating to this Agreement will include, by consolidation or joinder or in any other manner, an additional person not a party to this Agreement, except by written consent containing specific reference to this Agreement and signed by each party and any other person sought to be joined. This provision will be specifically enforceable in any Court of competent jurisdiction;
- (e) the parties covenant and agree that the Arbitrator appointed hereunder will have the power to, among other things, specifically declare that a party to this Agreement is in default of the terms of the Agreement and, in appropriate circumstances, declare that the Agreement is terminated and award damages for breach of contract or otherwise;



- (f) an award or order rendered by the Arbitrator will be final and binding upon the parties, and judgment may be entered upon it in accordance with applicable law in any Court having jurisdiction within the Province of British Columbia;
- (g) unless otherwise agreed in writing by the parties, the parties will continue to meet their obligations under this Agreement while the mediation and arbitration processes are continuing; and
- (h) the parties will each bear their own costs in connection with the foregoing and all costs of any mediation or arbitration (including the cost of the Mediator and the Arbitrator) will be shared equally by the parties.
- 14.2 The dispute resolution provisions of section 14.1 will survive termination of this Agreement in respect of any dispute resolution process that is commenced under section 14.1 prior to the date of termination.

#### **ARTICLE 15 - NOTICES**

- 15.1 Notices under this Agreement will be given in writing by personal delivery or by email to the following addresses or electronic mail addresses set out below:
  - (a) Developer:
    - ASI Vivo GP Inc., 400 1550 5th Street SW, Calgary, AB, T2R 1K3
    - Email: ralph.bennetsen@arlingtonstreet.ca
  - (b) Modo
    - 200 470 Granville Street, Vancouver, BC, V6C 1V5
    - Email: info@Modo.coop
- 15.2 All notices will be deemed to have been delivered on the date of delivery, if delivered, and on the next business day following, if emailed.
- 15.3 Addresses for notices may be amended by written notice from one party to the other.

#### **ARTICLE 16 - ASSIGNMENT**

16.1 Neither party will transfer or assign this Agreement to any other party without the prior written consent of the parties to this Agreement, which consent will not be unreasonably withheld. Notwithstanding the foregoing, Developer may assign this Agreement to the Rental Owner without Modo's prior consent but on notice to Modo, which notice will include the contact information of the parties to which the Agreement is being assigned.



#### **ARTICLE 17 - INDEMNITY**

17.1 Each party agrees to indemnify and save harmless the other party from and against all losses, costs, damages, suits, actions, causes of action, claims or demands in any way resulting from, connected with or arising out of the first party's breach of its obligations under this Agreement. This section 17.1 will survive the termination of the Agreement.

#### **ARTICLE 18 - GENERAL**

- 18.1 Nothing in this Agreement nor the acts of the parties will be construed, implied or deemed to create an agency, partnership or joint venture relationship between the parties. Neither party has the right or authority to, and will not, assume or create any obligation of any nature whatsoever on behalf of the other party or bind the other party in any respect whatsoever.
- This Agreement constitutes the entire agreement between the parties with respect to the subject-matter hereof and cancels and supersedes any prior understandings and agreements between the parties with respect thereto. There are no representations, warranties, terms, conditions, undertakings or collateral agreements, express, implied or statutory, between the parties other than as expressly set forth in this Agreement.
- 18.3 Any provision of this Agreement that is or becomes unenforceable will be unenforceable to the extent of such unenforceability without invalidating the remaining provisions hereof.
- 18.4 Any waiver or consent will be effective only in the instance and for the purpose for which it is given. No failure or delay on the part of either party in exercising any right, power or privilege under this Agreement will constitute a waiver thereof nor will any single or partial exercise of any right, power or privilege preclude any other or further exercise thereof or the exercise thereof or the exercise of any other right, power or privilege.
- 18.5 This Agreement will enure to the benefit of and be binding upon the parties and their heirs, executors, administrators, personal representatives, respective successors and permitted assigns.
- 18.6 The parties will at all times do, execute, acknowledge and deliver such acts, deeds, agreements and other instruments as may be reasonably necessary or desirable to give full force and effect to the terms of this Agreement.
- 18.7 This Agreement will be governed by and construed in accordance with the laws of the Province of British Columbia, and the federal laws of Canada applicable therein and each party irrevocably attorns to the exclusive jurisdiction of the courts of the Province of British Columbia.



This Agreement may be executed in any number of counterparts, each of which 18.8 will be deemed to be an original and all of which taken together will be deemed to constitute one and the same instrument. Delivery of an executed counterpart of this Agreement by facsimile or electronic means will be equally effective as delivery of a manually executed counterpart thereof.

IN WITNESS WHEREOF the parties have executed this Agreement as of the date first written above.

FRANK LOVARDELLI

By Modo:

MODO CO-OPERATIVE, by its authorized signatory

DocuSigned by: By: Name: Patrick Nangle Title: CEO

By Developer:

ASI VIVO GP INC, by its authorized signatory

By:


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# SCHEDULE A SHARED VEHICLE PARKING SPACES

[Parking drawings inserted on subsequent page]





## SCHEDULE B CONSTRUCTION STANDARDS FOR SHARED VEHICLE PARKING SPACE

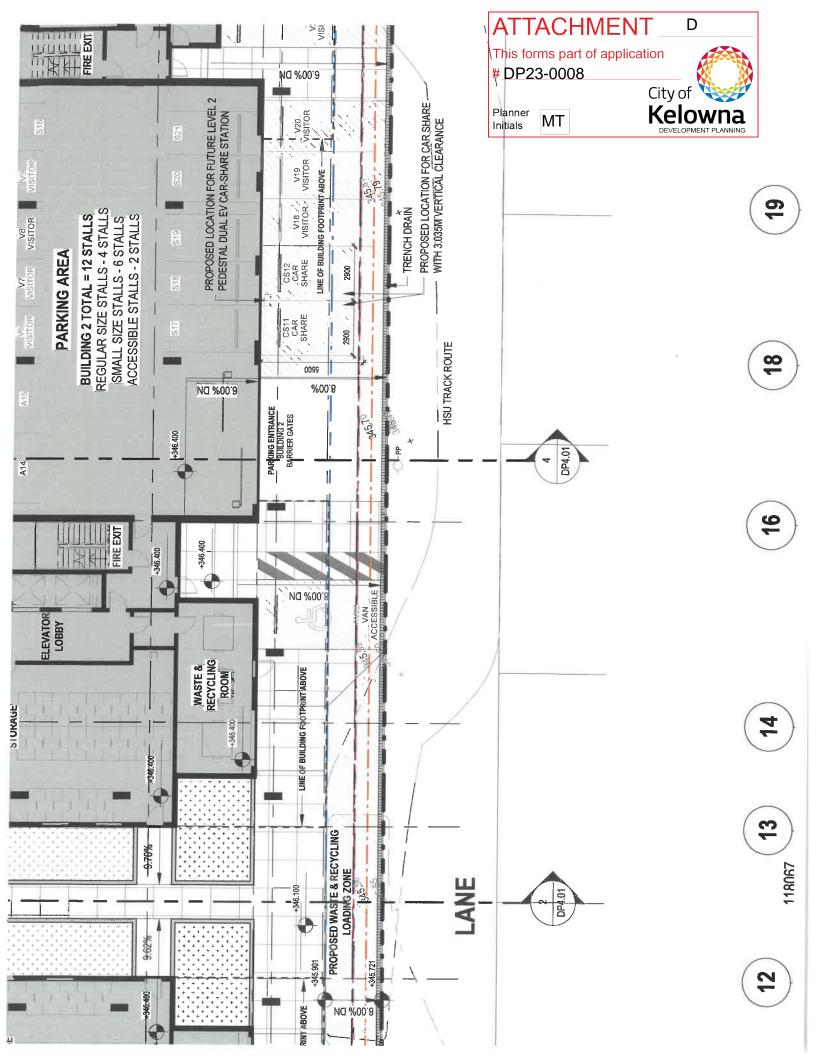The Shared Vehicle Parking Space shall be constructed to the satisfaction of the General Manager of Engineering Services and the Chief Building Official of the municipality where the Shared Vehicle Parking Space is being constructed, and in accordance with the following specifications and requirements:

#### 1. General

The Shared Vehicle Parking Space shall be constructed, finished and designated in accordance with applicable municipal building permits, by-laws, policies and guidelines, including the municipal standards as required by the Parking By-law and Building By-law applying to the property upon which the Shared Vehicle Parking Space is being constructed.

#### 2. Dimensions

The Shared Vehicle Parking Space dimensions shall be standardized:

- The minimum height shall be 2.0 meters.
- The minimum width shall be 2.9 meters.
- The minimum length shall be 5.5 meters.

Tandem parking shall not be permitted. Perpendicular and angle parking shall be preferred.

Where one side of a Shared Vehicle Parking Space abuts any portion of a fence or structure, there shall be a horizontal clearance of at least 30 centimetres between such side of the Shared Vehicle Parking Space and the said fence or structure.

#### 3. Location

It is preferred to locate the Shared Vehicle Parking Space at either street level or lane level. If locating the Shared Vehicle Parking Space at street level or lane level is not feasible, the Shared Vehicle Parking Space shall be located at the parking level of the parkade closest to the street level, second only in selection to the siting of disability parking spaces.

If the Shared Vehicle Parking Space is located underground or above ground, the location of the Shared Vehicle Parking Space will be chosen to ensure the greatest possible visibility of the space and most convenient access to the building, second only in selection to the siting of disability parking spaces.

When several Shared Vehicle Parking Spaces are provided, the spaces shall be located next to each other or in close proximity.



#### 4. Access

Permitted users of the Shared Vehicle to be parked on the Shared Vehicle Parking Space must have the ability to access the Shared Vehicle Parking Space 24 hours a day, 7 days a week.

The procedure for permitted users to self-access the Shared Vehicle Parking Space by foot when the Shared Vehicle Parking Space is located in a gated parkade shall consist in typing a code on a keypad or swiping a key fob on a fob reader. The procedure shall be simple and consistent to prevent access disruption.

In the event that a keypad is being used to provide access to the Shared Vehicle Parking Space, it should be possible to change the code of the keypad over time.

The procedure for permitted users to depart from and return to the parkade with a Shared Vehicle when the Shared Vehicle Parking Space for the Shared Vehicle is located in a gated parkade shall consist in typing a code on a keypad or swiping a key fob on a fob reader or using a remote control. The procedure shall not require for the permitted users to step out of the Shared Vehicle to perform the procedure.

In the event that remote controls are being used for permitted users to depart from and return to the parkade with a Shared Vehicle, Modo shall be provided with one more remote control than the number of Shared Vehicles to be parked in the parkade.

The location of the Shared Vehicle Parking Space and procedure to access the Shared Vehicle Parking Space in a gated parkade shall be designed to mitigate potential security concerns from users of the parkade.

#### 5. Maneuverability

The location of the Shared Vehicle Parking Space will be chosen to ensure the Shared Vehicle can be parked in the Shared Vehicle Parking Space driving forward with an angle of approach between 0° and 90°.

An angle of approach to park the Shared Vehicle in the Shared Vehicle Parking Space between 90° and 180° or the need to park the Shared Vehicle in reverse shall not be permitted.

The location of the Shared Vehicle Parking Space shall not require a maneuver more complex than a three-point turn to drive the Shared Vehicle out of the Shared Vehicle Parking Space.

If the Shared Vehicle Parking Space is located in a parkade with an entry/exit ramp, the location of the Shared Vehicle Parking Space shall not require for the Shared Vehicle to be driven in reverse to exit the parkade.



#### 6. Signage

The Shared Vehicle Parking Space shall be clearly designated with signage and pavement markings.

Clear, visible and legible signs shall be placed directing users of the Shared Vehicle to the location of the Shared Vehicle Parking Space, indicating which parking space is the Shared Vehicle Parking Space and marking it as being reserved for the exclusive purpose of parking a Shared Vehicle.

A symbol (similar to that approved for a disability space) shall be stamped/painted on the Shared Vehicle Parking Space.

#### 7. Lighting

The Shared Vehicle Parking Stall shall be illuminated to the satisfaction of the General Manager of Engineering Services of the municipality where the Shared Vehicle Parking Space is being constructed with:

- average illumination levels of 11 Lux with a uniformity ratio (average level to minimum level) of 3:1;
- luminaires situated in such a way so as not to directly throw light onto streets, lanes, or adjacent properties; and
- a photocell or equivalent switch that will activate the lighting system when ambient light levels are 11 Lux or less.

#### 8. Connectivity

Sufficient 3G and/or 4G LTE cellular network reception signal of the cellular network used for the operation of the Shared Vehicle shall be supplied at the Shared Vehicle Parking Space to ensure the reliable operation of the Shared Vehicle service, with:

- a Received Signal Strength Indicator (RSSI) for 3G cellular network superior to -86 dBm; and
- a Reference Signal Received Power (RSRP) for 4G LTE cellular network superior to -106 dBm.

#### 9. Electric Vehicle charging infrastructure

The Vehicle Parking Space must be provided with an EV Station (as defined below).

EV Station means a 40 amp (minimum), 208-volt, single phase Level 2 electric vehicle charging level (as defined by SAE International's J1772 standard) charging outlet capable of charging an electric vehicle and includes all wiring, electrical transformer and other electrical equipment necessary to supply the required electricity for such outlet, and mechanical ventilation modifications, all of which is to be provided, installed,

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maintained and replaced by Developer, at Developer's sole cost and to be used for the sole purpose of supplying electricity to the Shared Vehicle Parking Space.

The EV Station must feature:

- a RFID card reader to enable/disable power distribution, which card reader must be set-up to only enable and disable power distribution when presented with the RFID card(s) used by Modo; and
- b. networking/telematic functionalities which permit remote set-up of the EV Station, monitor of its status and collection of utilization data.

Modo must be granted administrator credentials for the EV Station to monitor it through its EV charging management software/web portal.



## SCHEDULE C SHARED VEHICLE DEPLOYMENT SEQUENCE

Shared Vehicle	Commenceme nt of Shared Vehicle deployment	Conditions for deployment of the Shared Vehicle
Shared Vehicle #1	Within seven (7) days after the Commencement Date.	<ul> <li>The Project Fee has been paid to Modo at least 60 days prior to the Estimated Occupancy Date as per section 2.1 of this Agreement;</li> <li>The Shared Vehicle Parking Spaces are available for use by Modo as contemplated in sections 3.1 and 3.2 of this Agreement; and</li> <li>One (1) EV Station (or more) is available for use by Modo as contemplated in section 3.4 this Agreement.</li> </ul>
Shared Vehicle #2	Within 60 days after all conditions set out in the column titled "Conditions for deployment of the Shared Vehicle" for Shared Vehicle #2 are met or	<ul> <li>Aggregate utilization of all Modo vehicles located within one (1) kilometre radius of the Development is equal or superior to the 40th percentile of Modo's vehicle fleet overall during an entire fiscal quarter;</li> <li>The Shared Vehicle Parking Spaces are available for use by Modo as contemplated in sections 3.1 and 3.2 of this Agreement;</li> <li>The Phased Shared Vehicle Project Fee has been paid to Modo as per section 2.4 of this Agreement for purchase of Shared Vehicle #2;</li> </ul>
	earlier if deemed appropriate by Modo.	<ul> <li>Shared Vehicle #1 is available to Modo Members as part of the Carsharing Program; and</li> <li>The EV Stations are available for use by Modo as contemplated in section 3.4 of this Agreement.</li> </ul>

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## SCHEDULE D PARTNERSHIP MEMBERSHIP RULES

The following terms have the following meanings:

	· ·		
(a)	"Development" means the rental residential development known as Vivo located atin Kelowna, British Columbia;		
(b)	"Membership Holder" means the registered owner of the Development;		
(c)	"Modo" means Modo Co-operative;		
(d)	"Residents" means, collectively, residents of the Development, and each such resident is referred to herein as a "Resident"; and		
(e)	"Strata Corporation" means the strata corporation for the Strata Development.		

- 2. The Membership Holder has entered into, or has assumed an agreement (the "Cooperative Carsharing Agreement") with Modo pursuant to which Modo granted to the Membership Holder a Modo partnership membership ( the "Membership") by issuing to the Membership Holder a certain number of membership shares in Modo (the "Modo Shares") for the benefit of Residents, as set out in the Co-operative Carsharing Agreement, so Residents can benefit from Modo membership privileges without the need to themselves pay Modo membership fees.
- 3. The Membership Holder will be the legal owner of the Modo Shares, and a certain number of Residents, as further set out in the Co-operative Carsharing Agreement, may, on a continuing basis, enjoy the benefits of the Membership subject to meeting Modo's eligibility requirements as set out on Modo's website from time to time and as set out herein (the "Membership Eligibility Criteria").
- 4. Residents who are granted the rights and benefits of the Membership from time to time (the "Partner Users" and, each a "Partner User") will benefit from the same price plan for usage of Modo vehicles as other member shareholders of Modo but, for clarity, will not have any voting rights in respect of the Membership or Modo.
- 5. Any Resident may apply to become a Partner User, provided that membership privileges will be granted to applying and eligible Residents on a first-come, first-served basis.
- 6. In order for a Resident to become a Partner User, the Resident must submit to Modo, an application including (but not limited) to the following:
  - (a) the applicant Resident, if the holder of a driver's licence issued in British Columbia, Canada, must prove current residency at the Development by



providing Modo with a copy of its current driver's records indicating their address within the Development;

- (b) the applicant Resident, if the holder of a driver's licence issued outside of British Columbia, Canada, must prove current residency at the Development by providing Modo with a copy of a bill indicating the name of the Resident and the Resident's address within the Development; and
- (c) the applicant Resident, must provide contact information and such other information regarding the Resident as may be reasonably required by Modo for the purposes of determining if the Resident qualifies for the Membership Eligibility Criteria.
- 7. Each Partner User will be responsible for and will save the Membership Holder harmless from any and all liabilities incurred by the Membership Holder and any and all actions, causes of action, costs or claims of whatsoever type or nature levied or made against the Membership Holder by Modo or by any other person, to the extent resulting from such Partner User's participation in the Membership and except to the extent resulting from the negligence or willful misconduct of the Membership Holder.
- 8. A Resident may only be a Partner User and may only exercise the rights and benefits of the Membership while such Resident meets the Membership Eligibility Criteria.
- 9. If at any time Resident who is a Partner User ceases to meet the Membership Eligibility Criteria, then the Resident will cease to be a Partner User and may only reapply to be a Partner User when the Resident again meets the Membership Eligibility Criteria.
- 10. Except as otherwise provided in these rules, a Partner User may only enjoy and exercise the benefits of the Membership while the Partner User is a Resident, and the benefits that a Partner User enjoys under the Membership may not under any circumstances be assigned, transferred or sold by the Partner User to any person.
- 11. If a Partner User does not book a Modo vehicle at least once during a period of twelve (12) consecutive months, Modo may cancel such Partner User's participation in the Membership.
- 12. The Modo Shares remain at all times in the name of the Membership Holder.
- 13. Partner Users may only make use of Modo vehicles in accordance with the policies and rules of Modo.
- 14. These rules will have no further force or effect upon termination of the Co-operative Carsharing Agreement.

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#### SCHEDULE E SECURITY AGREEMENT

MODO CO-OPERATIVE 200 - 470 Granville Street Vancouver, BC V6C IV5	
	(the "Grantor")
IN FAVOUR OF:	
	(the "Secured Party")
WHEREAS:  A. The Secured Party has fivehicle(.s):	nanced the acquisition by the Grantor of the following
Make/Model: Vehicle Identification	Number:
Make/Model: Vehicle Identification	Number:
(the "Shared Vehicle	s"); and

B. The Grantor has agreed to deliver this Agreement to create security over the interest it has in the Shared Vehicles for the benefit of the Secured Party.

**NOW THEREFORE THIS AGREEMENT WITNESSES** that in consideration of the premises and the covenants and agreements herein contained the Grantor and the Secured Party hereby agree as follows:

- 1. **Security Interest in the Shared Vehicles.** As security for the performance by the Grantor of its obligations set forth in the Co-operative Carsharing Agreement attached hereto (the "Co-op Car Agreement"), the Grantor grants to the Secured Party a security interest (the "Security Interest") in all of its present and future right, title and interest in and to the Shared Vehicles.
- 2. Grant of Security Interest in Proceeds of Collateral. The Grantor also grants the Secured Party a security interest in the proceeds derived directly or indirectly from any dealing with the Shared Vehicles, including but not limited to, accounts receivable, bills of exchange, insurance proceeds, chattel paper, intangibles, motor vehicles, and all other after acquired property constituting proceeds. The Grantor acknowledges that the Security



Interest hereby created attaches upon the execution of this Security Agreement, that the value has been given and that the Grantor has rights in the Shared Vehicles.

- 3. **Use and Location of the Shared Vehicles.** The Grantor will not self, lease or otherwise dispose of the Shared Vehicles without the prior written consent of the Secured Party and the Grantor will keep the Shared Vehicles in good condition, reasonable wear and tear excepted.
- 4. **No Liens on Shared Vehicles.** The Grantor will not permit any lien, charge, encumbrance or security interest (each, a "Lien") to attach to the Shared Vehicles which ranks prior to or equal with or could in any event rank prior to the equal with the rank of the Security Interest. The Grantor will not enter into any agreement with any person which would obtain prior or equal rank for any Lien over the rank of the 'Security Interest'.
- 5. **Name of Grantor.** The Grantor covenants not to change its name without giving fifteen (15) days' prior written notice to the Secured Party (so as to enable the Secured Party to amend its registration in respect of this Agreement and protect its rights hereunder).
- 6. **Default.** It will be a "Default" under this Agreement if:
  - (a) the Grantor breaches or fails to perform any of the terms, conditions, obligations or covenants to be observed and performed by the Grantor under the Co-op Car Agreement, and persists in such failure or breach after thirty (30) days' notice by the Secured Party requiring that the Grantor remedy such failure or breach.
  - (b) the Grantor commits an act of bankruptcy or becomes insolvent or files a proposal or a notice of intention to file a proposal,
  - (c) an assignment for the benefit of creditors under applicable bankruptcy or similar legislation is made or a petition is filed,
  - (d) an order is made, a resolution is passed, or any other step is taken for the bankruptcy, liquidation, dissolution or winding-up of the Grantor or for any arrangement or composition of its debts, or
  - (e) a receiver, receiver and manager or receiver-manager of the Grantor is appointed.
- 7. **Remedies.** The Security Interest is immediately enforceable, upon the occurrence of a Default, and the Secured Party, at its option, may exercise at any time following such Default any or all of the rights, remedies, privileges and powers available to it under this Agreement, the Personal Property Security Act (British Columbia) or any other applicable legislation. All rights, remedies, privileges and powers of the Secured Party hereunder are cumulative and no such right, remedy, privilege or power is exhaustive but is in addition to each other right, remedy, privilege and power of the Secured Party hereunder or under any other agreement, instrument or document now or hereafter existing at law or in equity or by statute.
- 8. **Costs of Enforcement.** The Grantor will be responsible for payment of all costs, charges and expenses (including legal costs on a solicitor and own client basis) of the Secured Party of and incidental to any proceeding taken to enforce the remedies of this Agreement.

Title:



- Loss, Injury or Destruction. The loss, injury or destruction of the Shared Vehicle will not operate in any manner to release the Grantor from its obligations to the Secured Party under the Co-op Car Agreement.
- 10. **Term**. The Security Interest granted hereunder will terminate and be of no further force and effect as of the expiry of the Shared Vehicle Minimum Term (as defined in the Co-Op Car Agreement) for the Shared Vehicles.
- Amendment. This Agreement may be altered or amended only by an agreement in writing signed by the parties hereto.
- 12. **Binding Effect.** This Agreement will enure to the benefit of and be binding upon the heirs, executors, administrators, legal and personal representatives, successors and permitted assigns of the parties, as applicable.
- 13. **Governing Law.** This Agreement is governed by and will be construed in accordance with the laws of the Province of British Columbia and the laws of Canada applicable therein.
- 14. **Counterparts.** This Agreement may be executed in any number of counterparts, each of which will be deemed to be an original and all of which taken together will he deemed to constitute one and the same instrument.
- 15. **Execution by Electronic Means**. This Agreement may be executed by the Grantors and transmitted by facsimile or other electronic means, and when it is executed and transmitted this Agreement will be for all purposes as effective as if the Grantor had delivered an executed original Agreement.

	TNESS WHEREOF the Grantor has executed this Agreement on the day of
MOD	O CO-OPERATIVE, by its authorized signatory
Ву:	Name: