# Development Permit DP23-0084





This permit relates to land in the City of Kelowna municipally known as

Sutherland Ave 1280

and legally known as

Lot A District Lot 137 Osoyoos Division Yale District Plan EPP129507

and permits the land to be used for the following development:

**Apartment Housing** 

The present owner and any subsequent owner of the above described land must comply with any attached terms and conditions.

<u>Date of Council Approval:</u> September 25, 2023

Development Permit Area: Form & Character

Existing Zone: UC2 – Capri-Landmark Urban Centre

Future Land Use Designation: UC – Urban Centre

This Development Permit is valid for two (2) years from the date of approval, with no opportunity to extend.

#### This is NOT a Building Permit.

In addition to your Development Permit, a Building Permit may be required prior to any work commencing. For further information, contact the City of Kelowna, Development Services Branch.

#### NOTICE

This permit does not relieve the owner or the owner's authorized agent from full compliance with the requirements of any federal, provincial or other municipal legislation, or the terms and conditions of any easement, covenant, building scheme or agreement affecting the building or land.

Owner: COLLINSON RISE DEVELOPMENT INC, INC.NO. BC1359070

Applicant: Millennial Developments

\_\_\_\_\_\_\_

Jocelyn Black Urban Planning Manager Planning & Development Services Date of Issuance



#### 1. SCOPE OF APPROVAL

This Development Permit applies to and only to those lands within the Municipality as described above, and any and all buildings, structures and other development thereon.

This Development Permit is issued subject to compliance with all of the Bylaws of the Municipality applicable thereto, except as specifically varied or supplemented by this permit, noted in the Terms and Conditions below.

The issuance of a permit limits the permit holder to be in strict compliance with regulations of the Zoning Bylaw and all other Bylaws unless specific variances have been authorized by the Development Permit. No implied variances from bylaw provisions shall be granted by virtue of drawing notations that are inconsistent with bylaw provisions and that may not have been identified as required Variances by the applicant or Municipal staff.

#### 2. CONDITIONS OF APPROVAL

THAT Council authorizes the issuance of Development Permit No. DP23-0084 for Lot A District Lot 137 Osoyoos Division Yale District Plan EPP129507 located at Sutherland Ave 1280, Kelowna, BC, subject to the following:

- a) The dimensions and siting of the building to be constructed on the land be in accordance with Schedule "A";
- b) The exterior design and finish of the building to be constructed on the land be in accordance with Schedule "B";
- c) Landscaping to be provided on the land be in accordance with Schedule "C";
- d) The applicant be required to post with the City a Landscape Performance Security deposit in the amount of 125% of the estimated value of the Landscape Plan, as determined by a Registered Landscape Architect;

AND THAT the applicant be required to make a payment into Housing Opportunities Reserve Fund as established by Bylaw No. 8593 in accordance with Table 6.8.b. in Zoning Bylaw No. 12375; prior to the issuance of any building permits;

AND THAT the applicant be required to enter into a Car-Share Agreement for a minimum of two years from the date of Building Occupancy as set out in Attachment D attached to the Report from the Development Planning Department September 25, 2023;

AND FURTHER THAT this Development Permit is valid for two (2) years from the date of Manager approval, with no opportunity to extend.

#### 3. PERFORMANCE SECURITY

As a condition of the issuance of this Permit, Council is holding the security set out below to ensure that development is carried out in accordance with the terms and conditions of this Permit. Should any interest be earned upon the security, it shall accrue to the Developer and be paid to the Developer or his or her designate if the security is returned. The condition of the posting of the security is that should the Developer fail to carry out the development hereby authorized, according to the terms and conditions of this Permit within the time provided, the Municipality may use enter into an agreement with the property owner of the day to have the work carried out, and any surplus shall be paid over to the property owner of the day. Should the Developer carry out the development as per the conditions of this permit, the security shall be returned to the Developer or his or her designate following proof of Substantial Compliance as defined in Bylaw No. 12310. There is filed accordingly:

a) An Irrevocable Letter of Credit OR certified cheque OR a Surety Bond in the amount of \$333,850.00

Before any bond or security required under this Permit is reduced or released, the Developer will provide the City with a statutory declaration certifying that all labour, material, workers' compensation and other taxes and costs have been paid.

#### 4. PARKING CASH-IN-LIEU BYLAW

Parking Cash-in-Lieu in the amount of **\$112,173.00** required for three (3) stalls as part of the proposed development within the Capri-Landmark Urban Centre.

#### 5. HOUSING OPPORTUNITIES RESERVE FUND

Housing Opportunities Reserve Fund Payment in the amount of **\$480,000** required for 2% of <u>the total number</u> of dwelling units authorized by the building permit in accordance with Table 6.8.b in Zoning Bylaw No. 12375.

# ATTACHMENT A This forms part of application # DP23-0084 City of Planner Initials KB CELOPMENT PLANNING

#### 6. INDEMNIFICATION

Upon commencement of the works authorized by this Permit the Developer covenants and agrees to save harmless and effectually indemnify the Municipality against:

a) All actions and proceedings, costs, damages, expenses, claims, and demands whatsoever and by whomsoever brought, by reason of the Municipality said Permit.

All costs, expenses, claims that may be incurred by the Municipality where the construction, engineering or other types of works as called for by the Permit results in damages to any property owned in whole or in part by the Municipality or which the Municipality by duty or custom is obliged, directly or indirectly in any way or to any degree, to construct, repair, or maintain.

The PERMIT HOLDER is the <u>CURRENT LAND OWNER</u>. Security shall <u>ONLY</u> be returned to the signatory of the Landscape Agreement or their designates.

# SUTHERLAND & PRIDHAM AVENUE, KELOWNA BC

# SCHEDULE A This forms part of application # DP23-0084 City of Planner Initials KB

## PROPERTY DESCRIPTION

CIVIC: 1266, 1276, 1288 SUTHERLAND AVENUE & 1267, 1277, 1289 PRIDHAM AVENUE, KELOWNA BC

LEGAL: LOTS 5, 6, 7, 13, 14, AND 15 BLOCK 3; DL 137 ODYD PLAN 9625

#### **ZONING CALCULATIONS:**

CURRENT: UC2 (RESIDENTIAL)

SITE INFORMATION:

GROSS SITE AREA= 56,223 SF (5,223m<sup>2</sup>)

<u>ALLOWED/REQUIRED</u> <u>PROPOSED</u>

2,697m<sup>2</sup> (29,034 SF)

306

16 (8 PER ENTRANCE)

65-170 SF/UNIT (SEE TABLE ON A-003)

90-308 SF/UNIT (SEE TABLE ON A-003)

90-488 SF/UNIT (SEE TABLE ON A-003)

 ALLOWABLE SITE COVERAGE =
 85% (47,790 SF)
 77% (43,074 SF)

 ALLOWABLE SITE COVERAGE + HARDSCAPING =
 90% (50,601 SF)
 87% (48,872 SF)

 F.A.R. + BONUS DENSITY =
 1.8 + 0.25 (115,257 SF)
 1.9 (104,028 SF)

HEIGHT= 22.0m (6 STOREYS) 21.6m (6 STOREYS)

YARD SETBACKS:

 FRONT YARD=
 2.0m
 2.05m/2.04m

 GARAGE FROM STREET=
 6.0m
 13.47m

 SIDE YARD=
 0.0m
 0.61m/3.46m

 FRONT YARD ABOVE 16.0m (4TH FLOOR) =
 3.0m
 3.1m/6.4m

 SIDE YARD ABOVE 16.0m (4TH FLOOR) =
 4.0m
 7.02m/5.81m

PRIVATE & COMMON AMENITY SPACE:

 $COMMON = 240 UNITS \times 4.0 m^2 / UNIT = 960 m^2 (10,333 SF)$ 

PRIVATE: BACHELOR UNITS = 7.5m<sup>2</sup>/UNIT (81 SF)

PRIVATE: 1-BEDROOM UNITS = 15.0m<sup>2</sup>/UNIT (162 SF)

PRIVATE: UNITS WITH MORE THAN 1-BEDROOM = 25.0m<sup>2</sup>/UNIT (269 SF)

\*ADDITIONAL COMMON AMENITY SPACE HAS BEEN PROVIDED WHERE PRIVATE AMENITY SPACE IS REDUCED

PARKING CALCULATIONS:

MICRO / BACHELOR UNITS (0-BEDROOM) = 153 UNITS  $\times$  0.8 = 122.4 1 BEDROOM UNITS = 40 UNITS  $\times$  0.9 = 36 2+ BEDROOM UNITS = 47 UNITS  $\times$  1.0 = 47

VISITOR PARIKING =

BASE REDUCTION FOR 1 CAR-SHARE =

BASE REDUCTION FOR LONG TERM BICYCLE BONUS =

TOTAL PARKING =229 + 1 CAR-SHARE225 + 1 CAR-SHAREACCESSIBLE PARKING =6 (2 VAN ACCESSIBLE)6 (2 VAN ACCESSIBLE)

BONUS LONG-TERM BICYCLE STORAGE:

<u>UNIT TYPE</u>

BACHELOR & 1-BEDROOM = 1.25 x 193 UNITS = 241
2-BEDROOM = 1.5 x 36 UNITS = 54
3-BEDROOM = 2 x 5 UNITS = 10
TOWNHOMES = N/A

TOTAL = 305 (ROUNDED)


SHORT-TERM BICYCLE STORAGE:

6 PER ENTRANCE = 12 TOWNHOUSES = 4 TOTAL = 16

PARKING SCHEDULE

PARKING SCHEDULE						
TYPE						
ACCESSIBLE - 90 deg						
125 REGULAR - 90 deg						
95 SMALL - 90 deg						
2 VAN ACCESSIBLE - 90 deg						

Grand total: 226

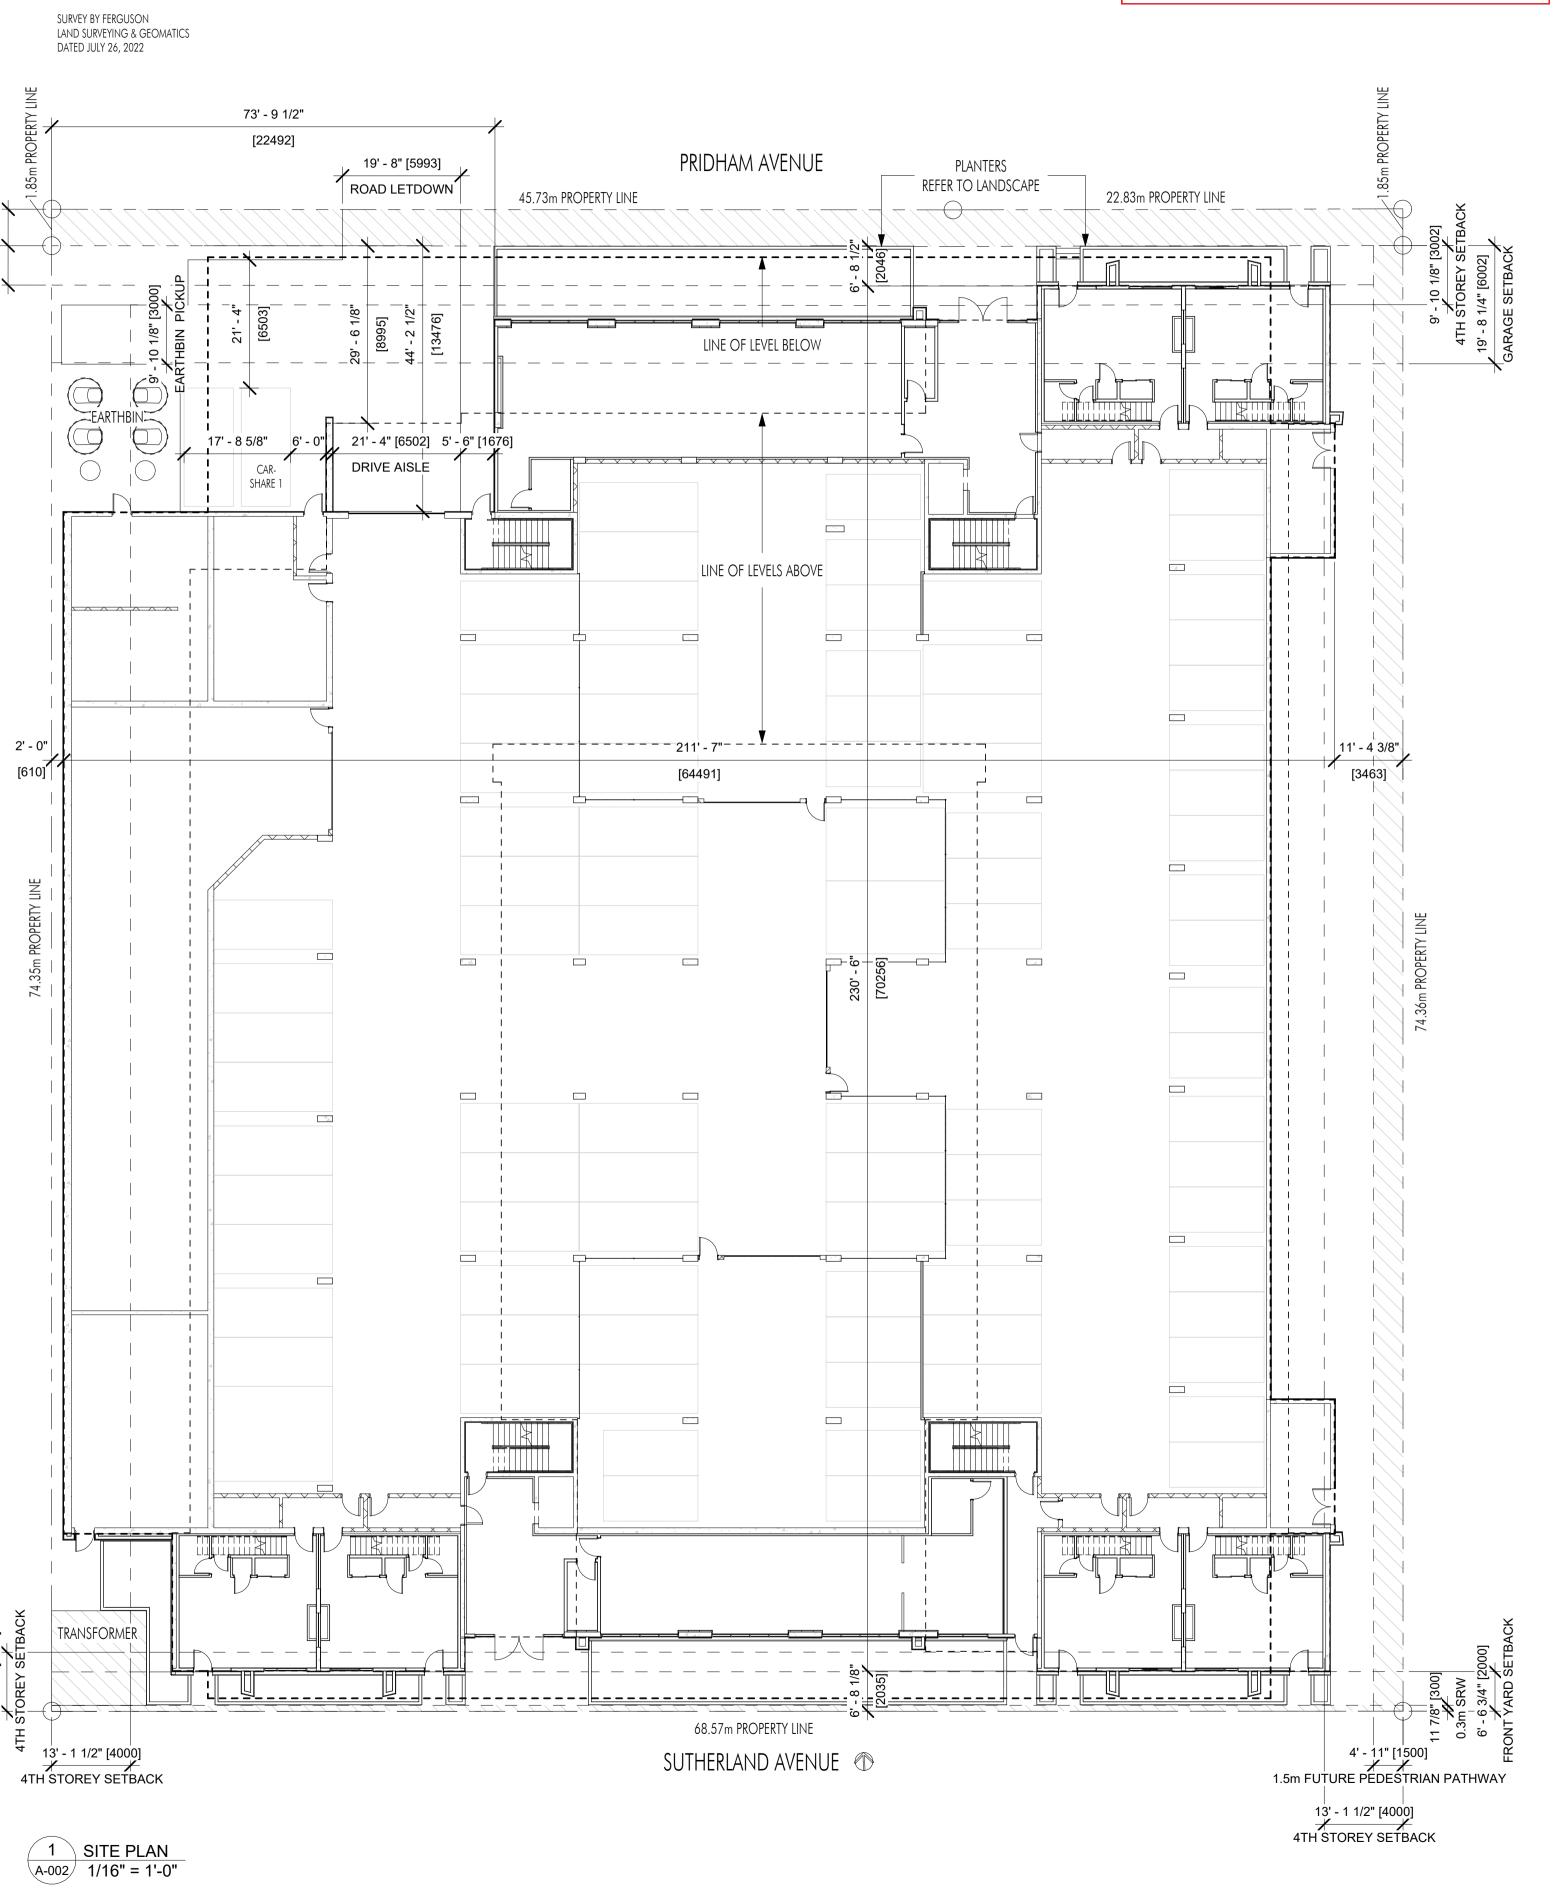

ADDENDUM NO.5

205-1626 Richter Street,
Kelowna, BC V1Y 2M3
www.limearchitecture.com

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**Revision No., Date** and Description 12.09.22 SCHEMATICS 01.06.23 SCHEMATICS 02.08.23 SCHEMATICS 02.17.23 FOR COORDINATION 02.25.23 FOR DP 03.06.23 FOR DP 03.17.21 FOR DP 04.14.23 ADDENDUM NO.2 05.03.23 25% BP REVIEW 05.31.23 50% BP REVIEW 07.07.23 75% BP REVIEW 07.14.23 ADDENDUM NO.4 08.10.23 100% BP REVIEW 09.01.23 100% BP 09.07.23 100% BP 09.12.23 ADDENDUM NO.5

Plot Date
09.12.23
PROJECT

DRAWING TITLE

PROJECT INFORMATION

Drawing No.

	UNIT CALCUL	ATIONS	
UNIT	# OF BEDROOMS	UNIT AREA	PRIVATE AMENITY SPACE
101 - ENTRY		529 SF	
101 - SECOND	2	475 SF	0 SF
102 - ENTRY 102 - SECOND	2	529 SF 475 SF	0 SF
102 - SECOND 103 - ENTRY	2	529 SF	0.5F
103 - ENTRY	2	475 SF	0 SF
104 - ENTRY		529 SF	0 01
104 - SECOND	2	475 SF	0 SF
105 - ENTRY	_	529 SF	
105 - SECOND	2	475 SF	0 SF
106 - ENTRY		529 SF	
106 - SECOND	2	475 SF	0 SF
201	1	530 SF	128 SF
202	2	631 SF	226 SF
203	0	307 SF	74 SF
204	0	307 SF	74 SF
205	0	307 SF	171 SF
206	0	307 SF	171 SF
207	0	307 SF	74 SF
208	0	307 SF	74 SF
209	0	307 SF	171 SF
210	0	307 SF	171 SF
211	0	307 SF	74 SF
212	0	307 SF	74 SF
213	0	307 SF	171 SF
214	0	307 SF	171 SF
215	0	307 SF	74 SF
216	3	921 SF	466 SF
217	1	536 SF	110 SF
218	0	307 SF	90 SF
219	0	307 SF	94 SF
220	0	307 SF	94 SF
221	0	307 SF	92 SF
222	0	428 SF	98 SF
223	0	307 SF	92 SF
224	0	307 SF	90 SF
225	2	854 SF	130 SF
226	2	706 SF	169 SF
227	0	396 SF	95 SF
228	0	307 SF	118 SF
229	0	307 SF	74 SF
230	0	307 SF	118 SF
231	0	307 SF	74 SF
232	0	307 SF	118 SF
233	0	307 SF	74 SF
234	0	307 SF	118 SF
235	0	307 SF	74 SF
236	0	307 SF	118 SF
237	0	307 SF	74 SF
238	0	307 SF	118 SF
239	0	307 SF	74 SF
240	1	581 SF	156 SF
240 241	2	663 SF	160 SF
24 i 242	1	487 SF	310 SF
242 301	2	652 SF	95 SF
302	1	508 SF	106 SF
303	1	530 SF	128 SF
304	2	631 SF	88 SF
305	0	307 SF	74 SF
306	0	307 SF	74 SF
307	0	307 SF	67 SF
308	0	307 SF 307 SF	67 SF
308 309	0	307 SF 307 SF	74 SF
310	0	307 SF 307 SF	74 SF
311	0	307 SF	67 SF
312	0	307 SF 307 SF	67 SF
313	0	307 SF	74 SF
314	0	307 SF 307 SF	74 SF
314 315		307 SF	67 SF
	0		74 SF
316	0	307 SF	
317	1	436 SF	96 SF
318	3	921 SF	376 SF
319	1	535 SF	110 SF
320	0	307 SF	74 SF
321	1	593 SF	152 SF
322	0	307 SF	68 SF
323	0	307 SF	68 SF
324	2	710 SF	140 SF
325	0	307 SF	65 SF
326	0	307 SF	65 SF
327	1	496 SF	98 SF
328	0	307 SF	74 SF

	UNIT CALCUL	.ATIONS	
	# OF	UNIT	PRIVATE
UNIT	BEDROOMS	AREA	AMENITY SPACE
329	2	833 SF	384 SF
330	2	715 SF	110 SF
331 332	0	706 SF 396 SF	169 SF 95 SF
333	1	436 SF	96 SF
334	0	307 SF	74 SF
335	0	307 SF	67 SF
336	0	307 SF	74 SF
337	0	307 SF	67 SF
338	0	307 SF	74 SF
339	0	307 SF	67 SF
340	0	307 SF	74 SF
341	0	307 SF	67 SF
342	0	307 SF	74 SF
343	0	307 SF	67 SF
344	0	307 SF	74 SF
345	1	434 SF	104 SF
346	1	581 SF	88 SF
347	2	694 SF	161 SF
348	2	742 SF	143 SF
546 101	2	652 SF	95 SF
401 402	1	508 SF	95 SF 98 SF
		508 SF 530 SF	
103 104	1	631 SF	116 SF 88 SF
	2		
105 106	0	307 SF	67 SF
406 107	0	307 SF	67 SF
107 108	0	307 SF	67 SF
408 400	0	307 SF	67 SF
409 410	0	307 SF	67 SF
410 411	0	307 SF	67 SF
411	0	307 SF	67 SF
412	0	307 SF	67 SF
413	0	307 SF	67 SF
414 445	0	307 SF	67 SF
<del>1</del> 15	0	307 SF	67 SF
416	0	307 SF	67 SF
417	1	436 SF	96 SF
418	3	921 SF	282 SF
419	1	535 SF	110 SF
420	0	307 SF	74 SF
421	1	593 SF	152 SF
422	0	307 SF	68 SF
423	0	307 SF	68 SF
424	2	710 SF	140 SF
425	0	307 SF	65 SF
426	0	307 SF	65 SF
427	1	496 SF	130 SF
428	0	307 SF	74 SF
429	2	833 SF	273 SF
430	2	715 SF	100 SF
431	2	706 SF	154 SF
132	0	396 SF	86 SF
433	1	436 SF	96 SF
434	0	307 SF	67 SF
435	0	307 SF	67 SF
436	0	307 SF	67 SF
437	0	307 SF	67 SF
438	0	307 SF	67 SF
439	0	307 SF	67 SF
140	0	307 SF	67 SF
441	0	307 SF	67 SF
442	0	307 SF	67 SF
443	0	307 SF	67 SF
144	0	307 SF	67 SF
445	1	434 SF	95 SF
146	1	581 SF	88 SF
447	2	694 SF	148 SF
148	2	742 SF	143 SF
501	2	652 SF	95 SF
502	1	508 SF	98 SF
503	1	530 SF	116 SF
504	2	631 SF	88 SF
505	0	307 SF	67 SF
506	0	307 SF	67 SF
507	0	307 SF	67 SF
508	0	307 SF	67 SF
509	0	307 SF	67 SF
510	0	307 SF	67 SF
511	0	307 SF	67 SF
512	0	307 SF	67 SF
512	10	307 66	67 CE
513 514	0	307 SF 307 SF	67 SF 67 SF

UNIT	# OF BEDROOMS	UNIT AREA	PRIVATE AMENITY SPACI
515	0	307 SF	67 SF
516	0	307 SF	67 SF
517	1	436 SF	96 SF
518	3	921 SF	282 SF
	1		110 SF
519		535 SF	
520	0	307 SF	74 SF
521	1	593 SF	152 SF
522	0	307 SF	68 SF
523	0	307 SF	68 SF
524	2	710 SF	140 SF
525	0	307 SF	65 SF
526	0	307 SF	65 SF
527	1	496 SF	130 SF
528	0	307 SF	74 SF
529	2	833 SF	273 SF
530	2	715 SF	100 SF
531	2	706 SF	154 SF
532	0	396 SF	86 SF
533	1	436 SF	96 SF
534	0	307 SF	67 SF
535	0	307 SF	67 SF
536	0	307 SF	67 SF
537	0	307 SF	67 SF
538	0	307 SF	67 SF
539	0	307 SF	67 SF
540	0	307 SF	67 SF
541	0	307 SF	67 SF
542	0	307 SF	67 SF
543	0	307 SF	67 SF
544	0	307 SF	67 SF
545	1	434 SF	95 SF
546	1	581 SF	88 SF
547	2	694 SF	148 SF
548	2	742 SF	143 SF
601	2	652 SF	95 SF
602	1	508 SF	98 SF
603	1	530 SF	116 SF
604	2	631 SF	88 SF
605	0	307 SF	67 SF
606	0	307 SF	67 SF
607	0	307 SF	67 SF
608	0	307 SF	67 SF
609	0	307 SF	67 SF
610	0	307 SF	67 SF
611	0	307 SF	67 SF
612	0	307 SF	67 SF
613	0	307 SF	67 SF
614	0	307 SF	67 SF
615	0	307 SF	67 SF
616	0	307 SF	67 SF
617	1	436 SF	96 SF
618	3	921 SF	282 SF
619	1	535 SF	110 SF
620	0	307 SF	74 SF
621	1	593 SF	152 SF
622	0	307 SF	68 SF
		307 SF	
623	0		68 SF
624	2	710 SF	140 SF
625	0	307 SF	65 SF
626	0	307 SF	65 SF
627	1	496 SF	130 SF
628	0	307 SF	74 SF
629	2	833 SF	273 SF
630	2	715 SF	100 SF
631	2	706 SF	154 SF
632		396 SF	86 SF
	0		
633	1	436 SF	96 SF
634	0	307 SF	67 SF
635	0	307 SF	67 SF
636	0	307 SF	67 SF
637	0	307 SF	67 SF
638	0	307 SF	67 SF
639	0	307 SF	67 SF
640	0	307 SF	67 SF
641	0	307 SF	67 SF
642	0	307 SF	67 SF
643	0	307 SF	67 SF
644	0	307 SF	67 SF
645	1	434 SF	95 SF
	1	581 SF	88 SF
646			
646 647	2	694 SF	148 SF

104028 SF

UN	T COUNT	
UNIT TYPES	# of BEDROOMS	# OF UNITS
1-BED	1	35
1-BED + DEN	1	5
2-BED	2	31
2-BED + DEN	2	5
3-BED	3	5
MICRO	0	147
STUDIO	0	6
TOWNHOUSE	2	6
Grand total: 240		240

UNIT CO	TAUC	
UNIT TYPES	# of BEDROOMS	# OF UNITS
1-BED	1	35
1-BED + DEN	1	5
2-BED	2	31
2-BED + DEN	2	5
3-BED	3	5
MICRO	0	147
STUDIO	0	6
TOWNHOUSE	2	6
Grand total: 240		240



Planner Initials KB



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# **Revision No., Date**


and Description 03.06.23 FOR DP 03.17.21 FOR DP 05.03.23 25% BP REVIEW 05.31.23 50% BP REVIEW 07.07.23 75% BP REVIEW 07.14.23 ADDENDUM NO.4


07.14.23

PROJECT Revo (Collinson Rise) DRAWING TITLE

PROJECT

INFORMATION

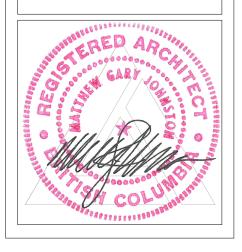

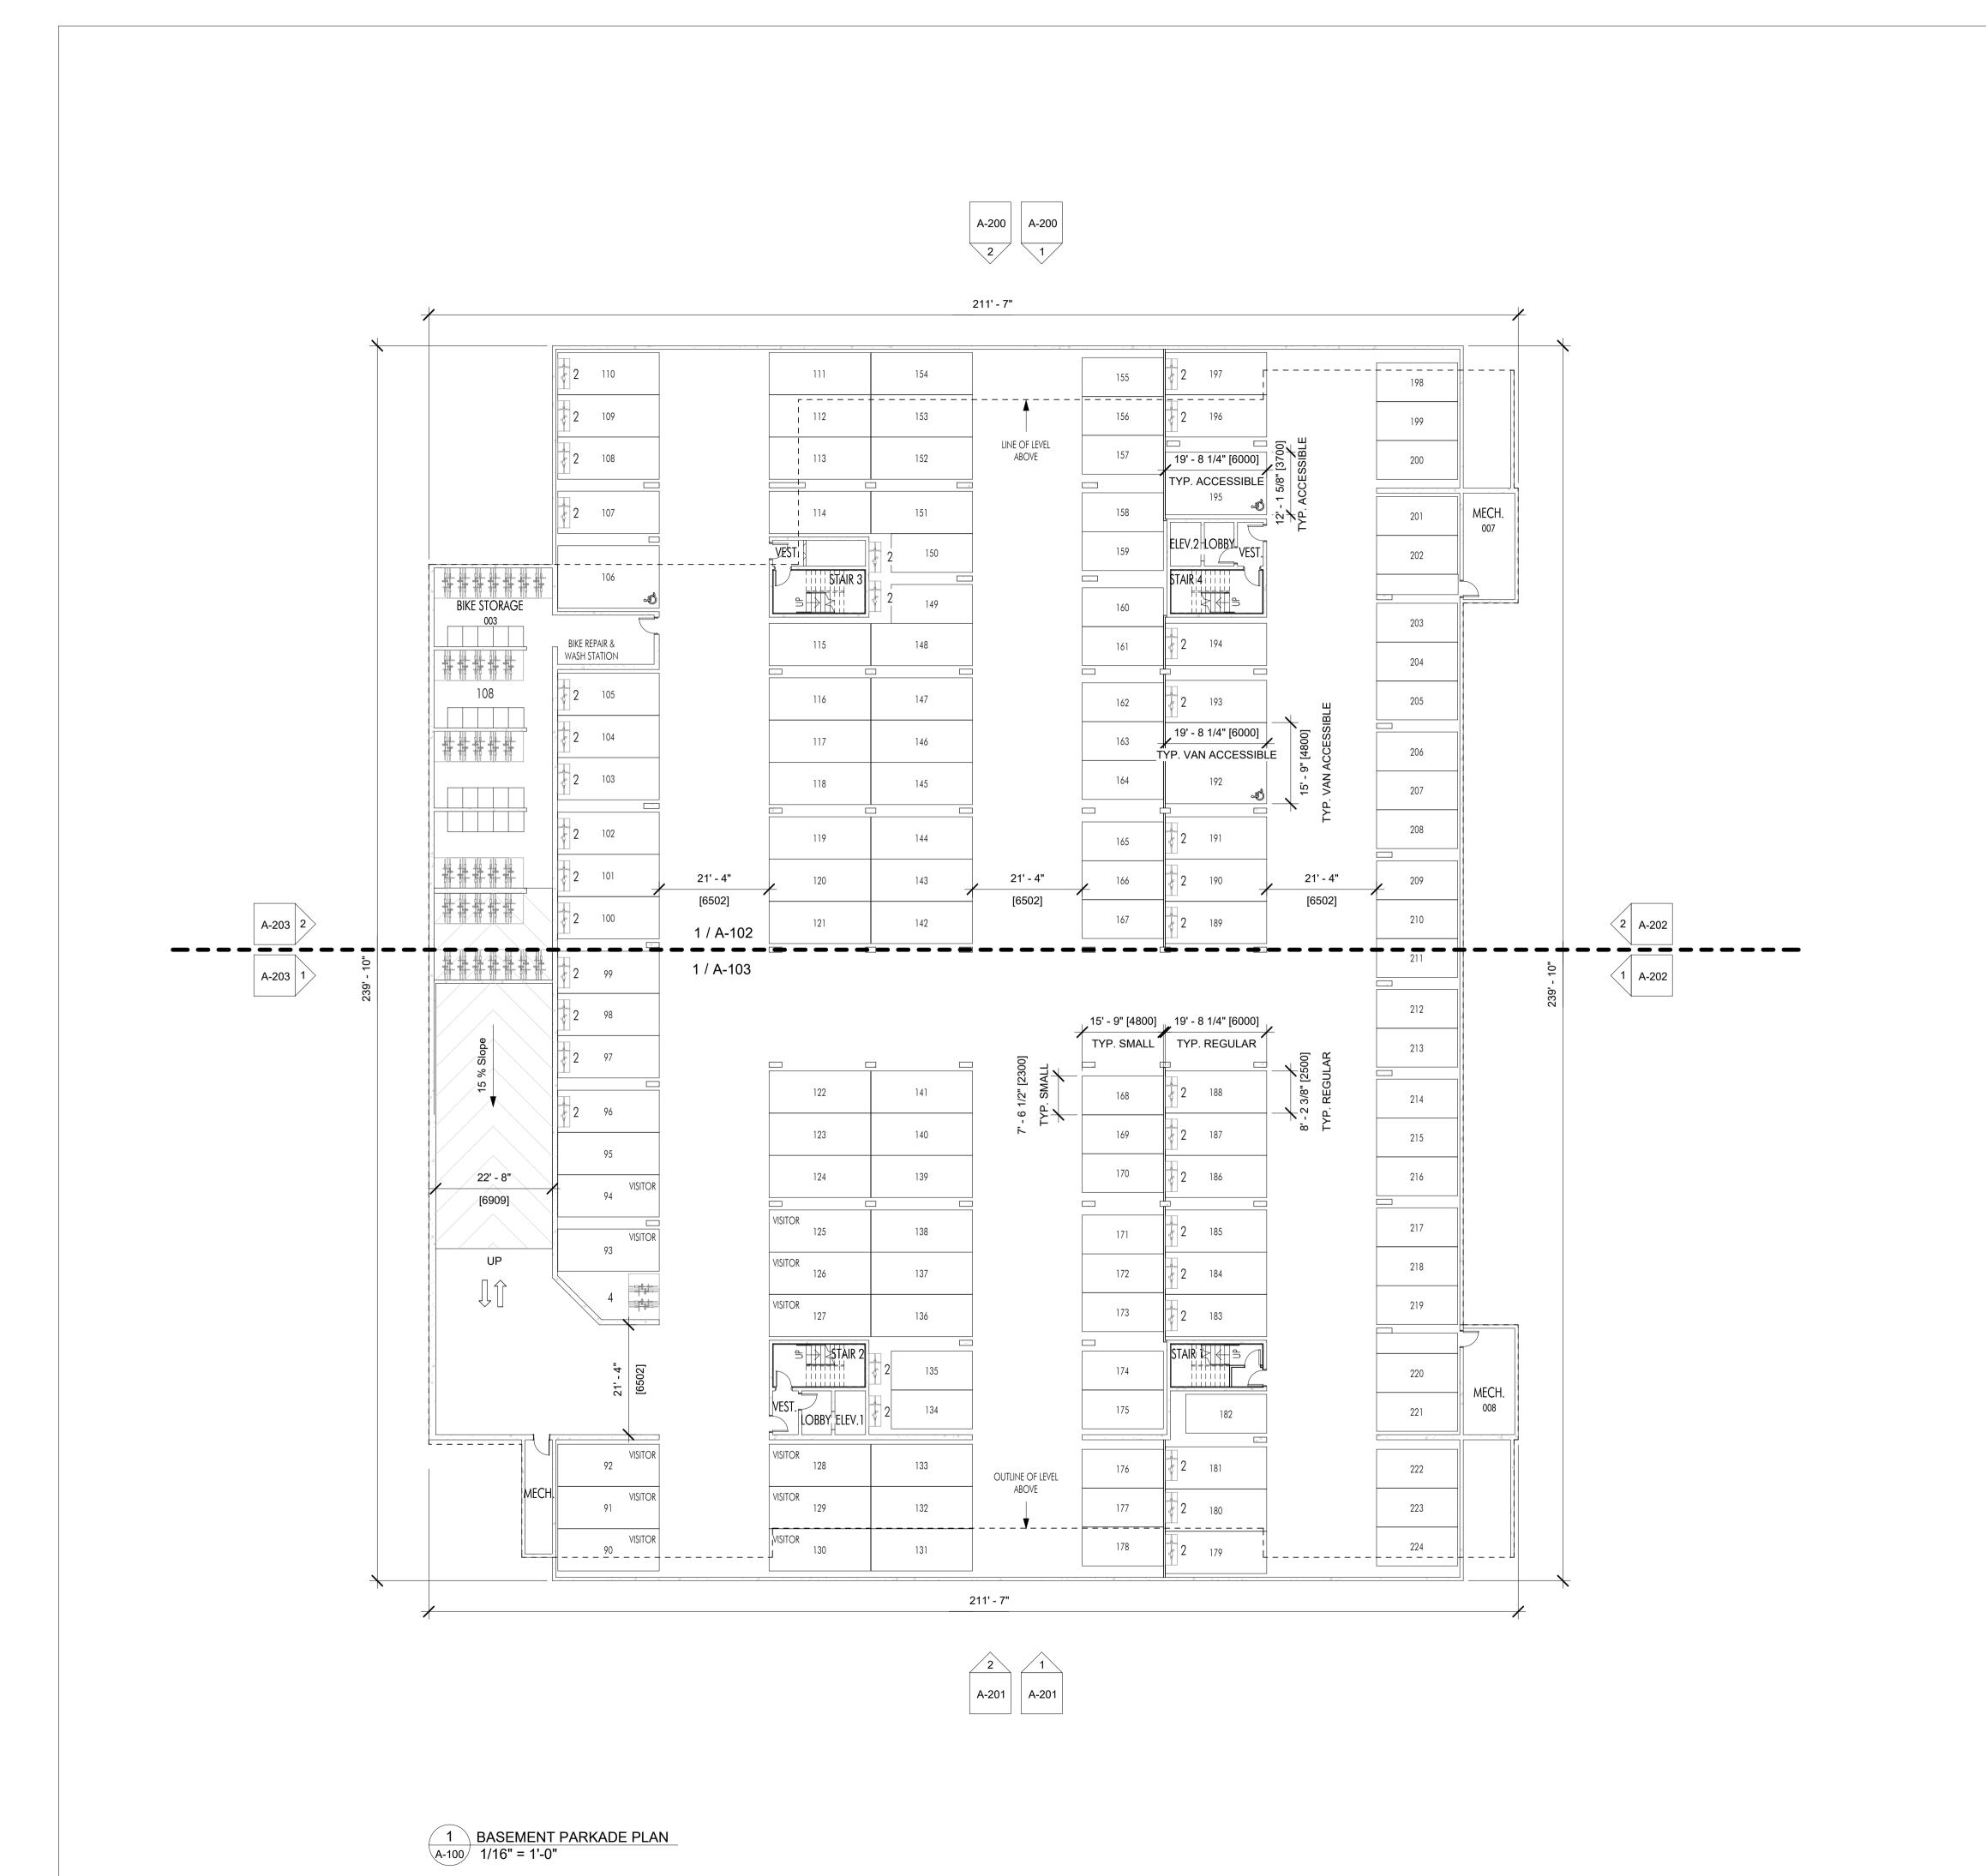



This forms part of application # DP23-0084

Planner Initials

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#### **Revision No., Date** and Description

12.09.22 SCHEMATICS 01.06.23 SCHEMATICS 02.17.23 FOR COORDINATION 02.25.23 FOR DP 03.06.23 FOR DP 03.17.21 FOR DP 04.14.23 ADDENDUM NO.2 04.25.23 ADDENDUM NO.3 05.03.23 25% BP REVIEW 05.31.23 50% BP REVIEW 06.26.23 FOR COORDINATION


07.07.23 75% BP REVIEW 07.14.23 ADDENDUM NO.4

Plot Date 07.14.23


**PROJECT** Revo (Collinson Rise)

DRAWING TITLE

BASEMENT PARKADE PLAN

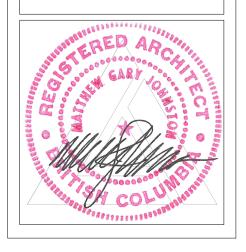



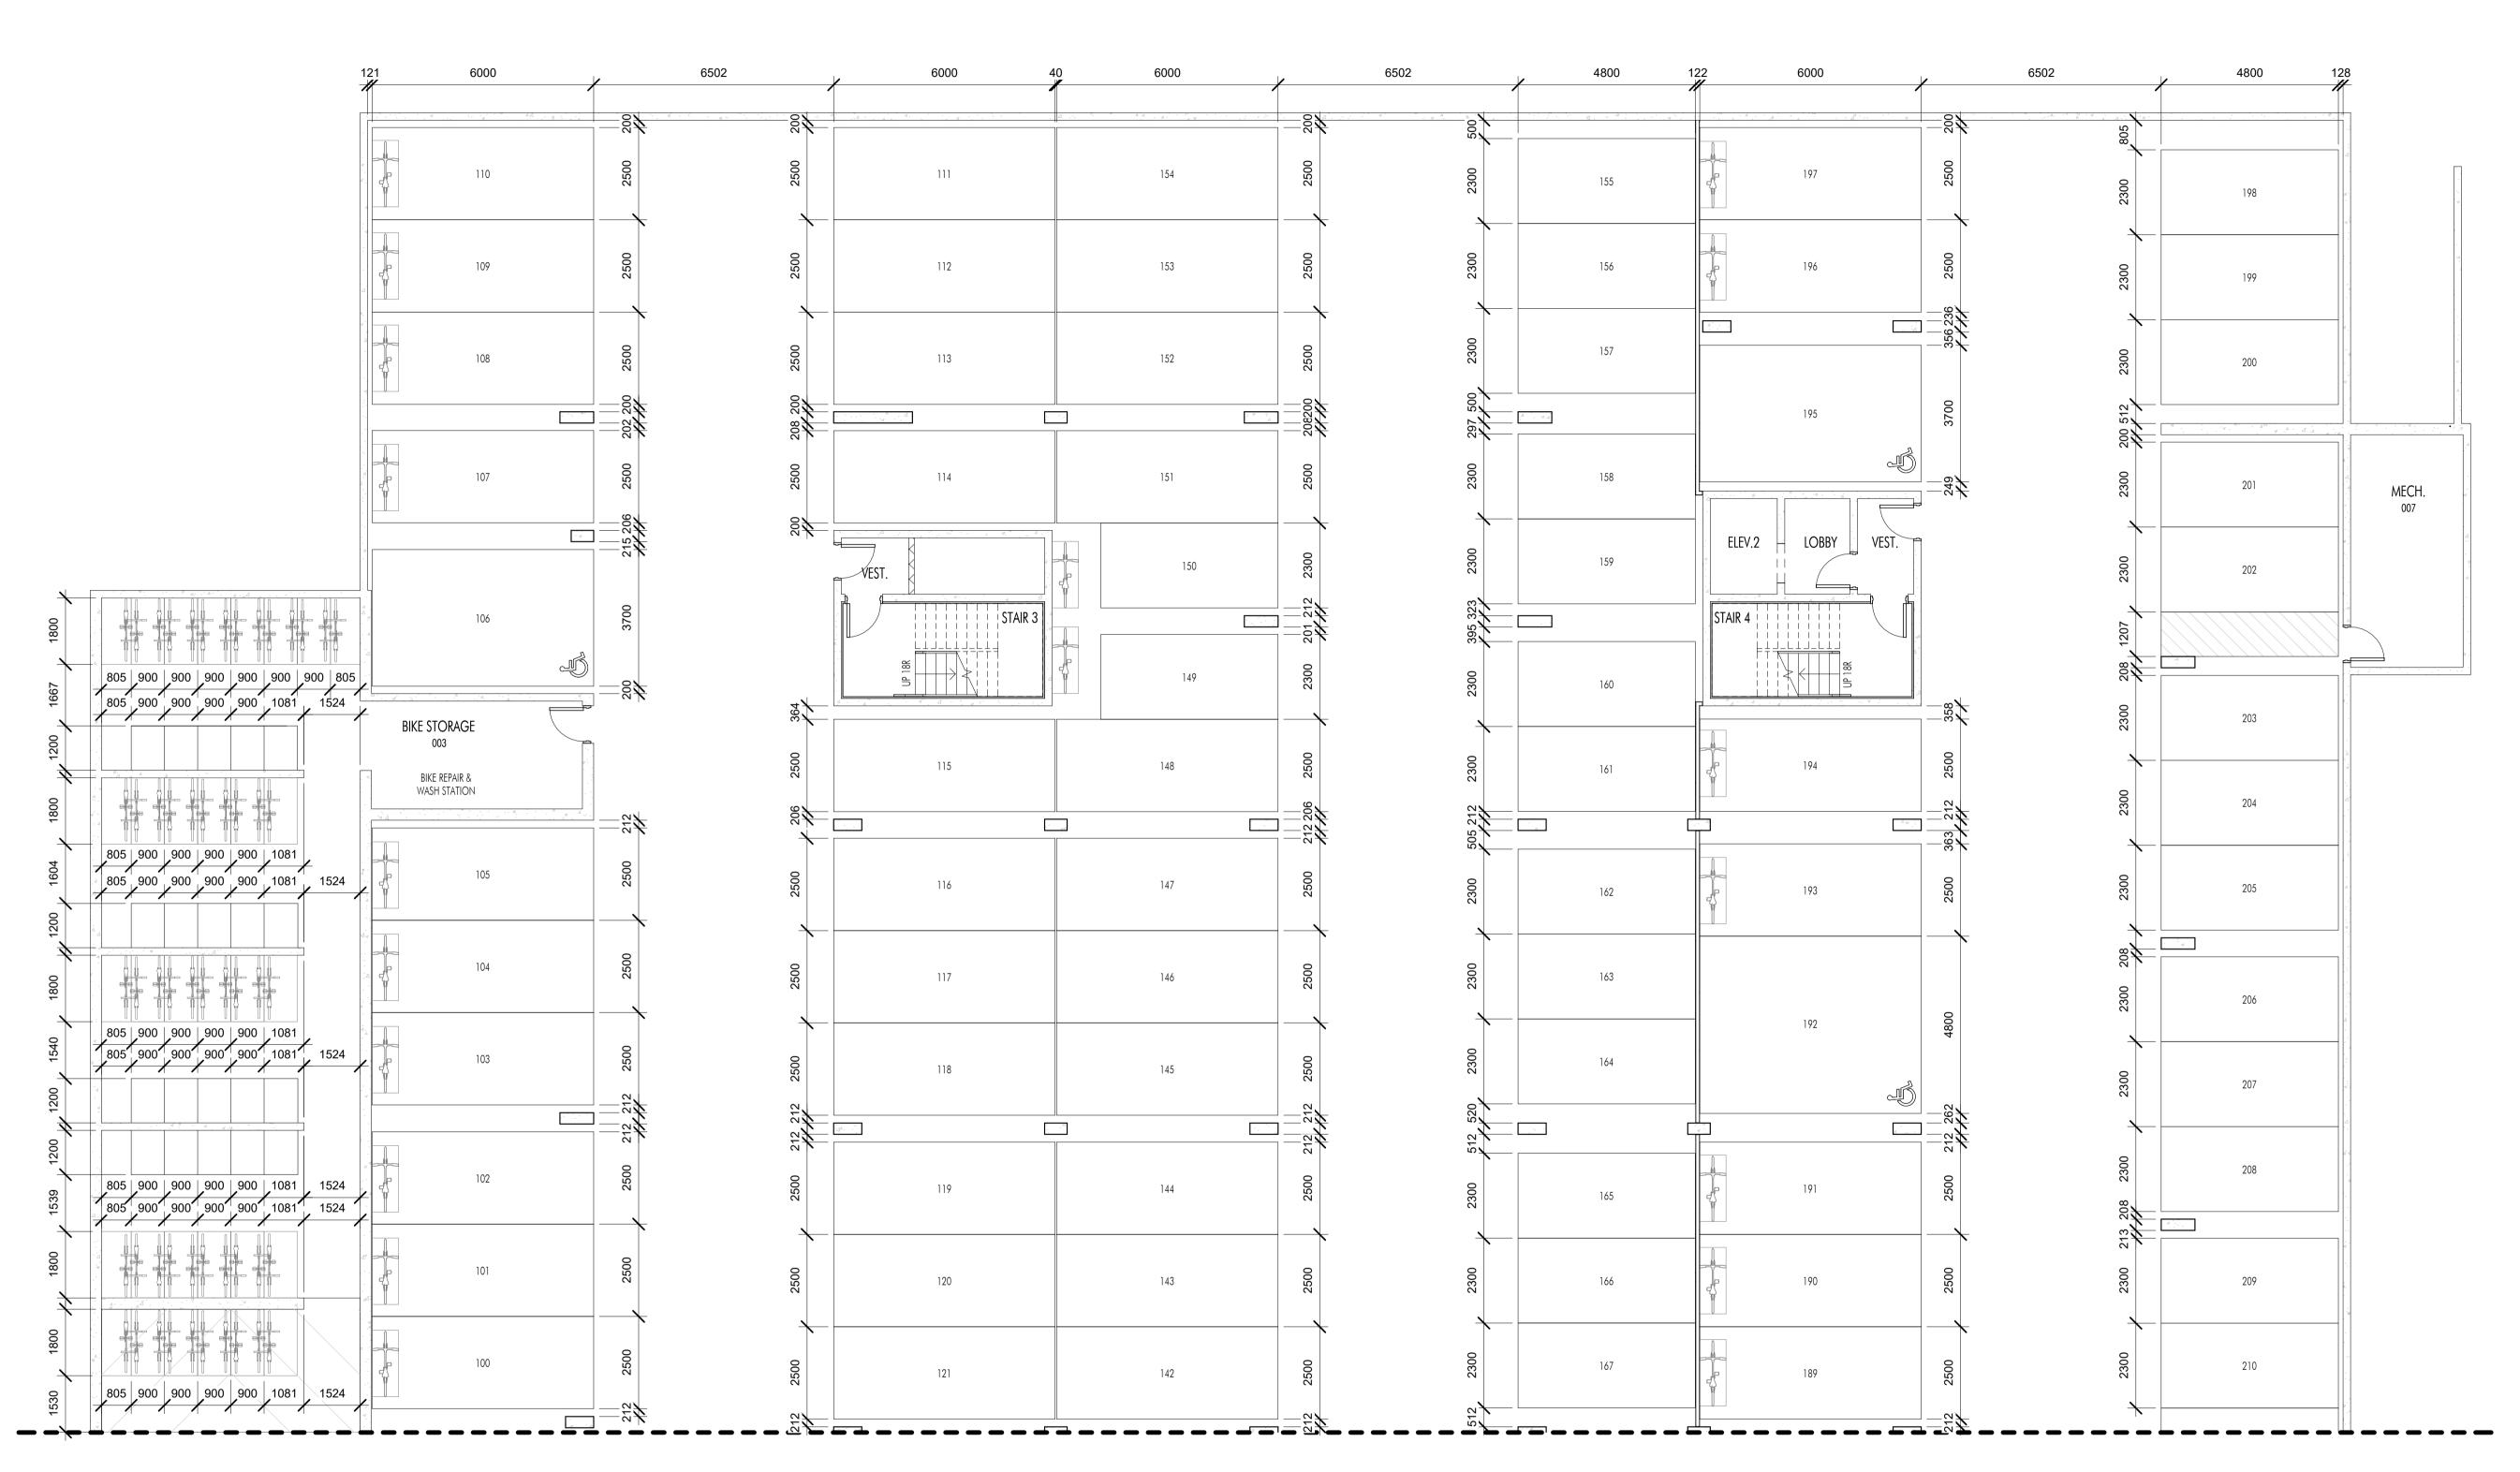

1 BASEMENT PARKADE PLAN - NORTH PARKING PLAN
1/8" = 1'-0"

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**Revision No., Date** and Description

03.17.21 FOR DP 04.14.23 ADDENDUM NO.2 04.25.23 ADDENDUM NO.3 05.03.23 25% BP REVIEW 05.31.23 50% BP REVIEW 06.26.23 FOR COORDINATION 07.07.23 75% BP REVIEW


07.14.23 ADDENDUM NO.4

Plot Date 07.14.23

PROJECT Revo (Collinson Rise) DRAWING TITLE

BASEMENT -NORTH PARKING PLAN



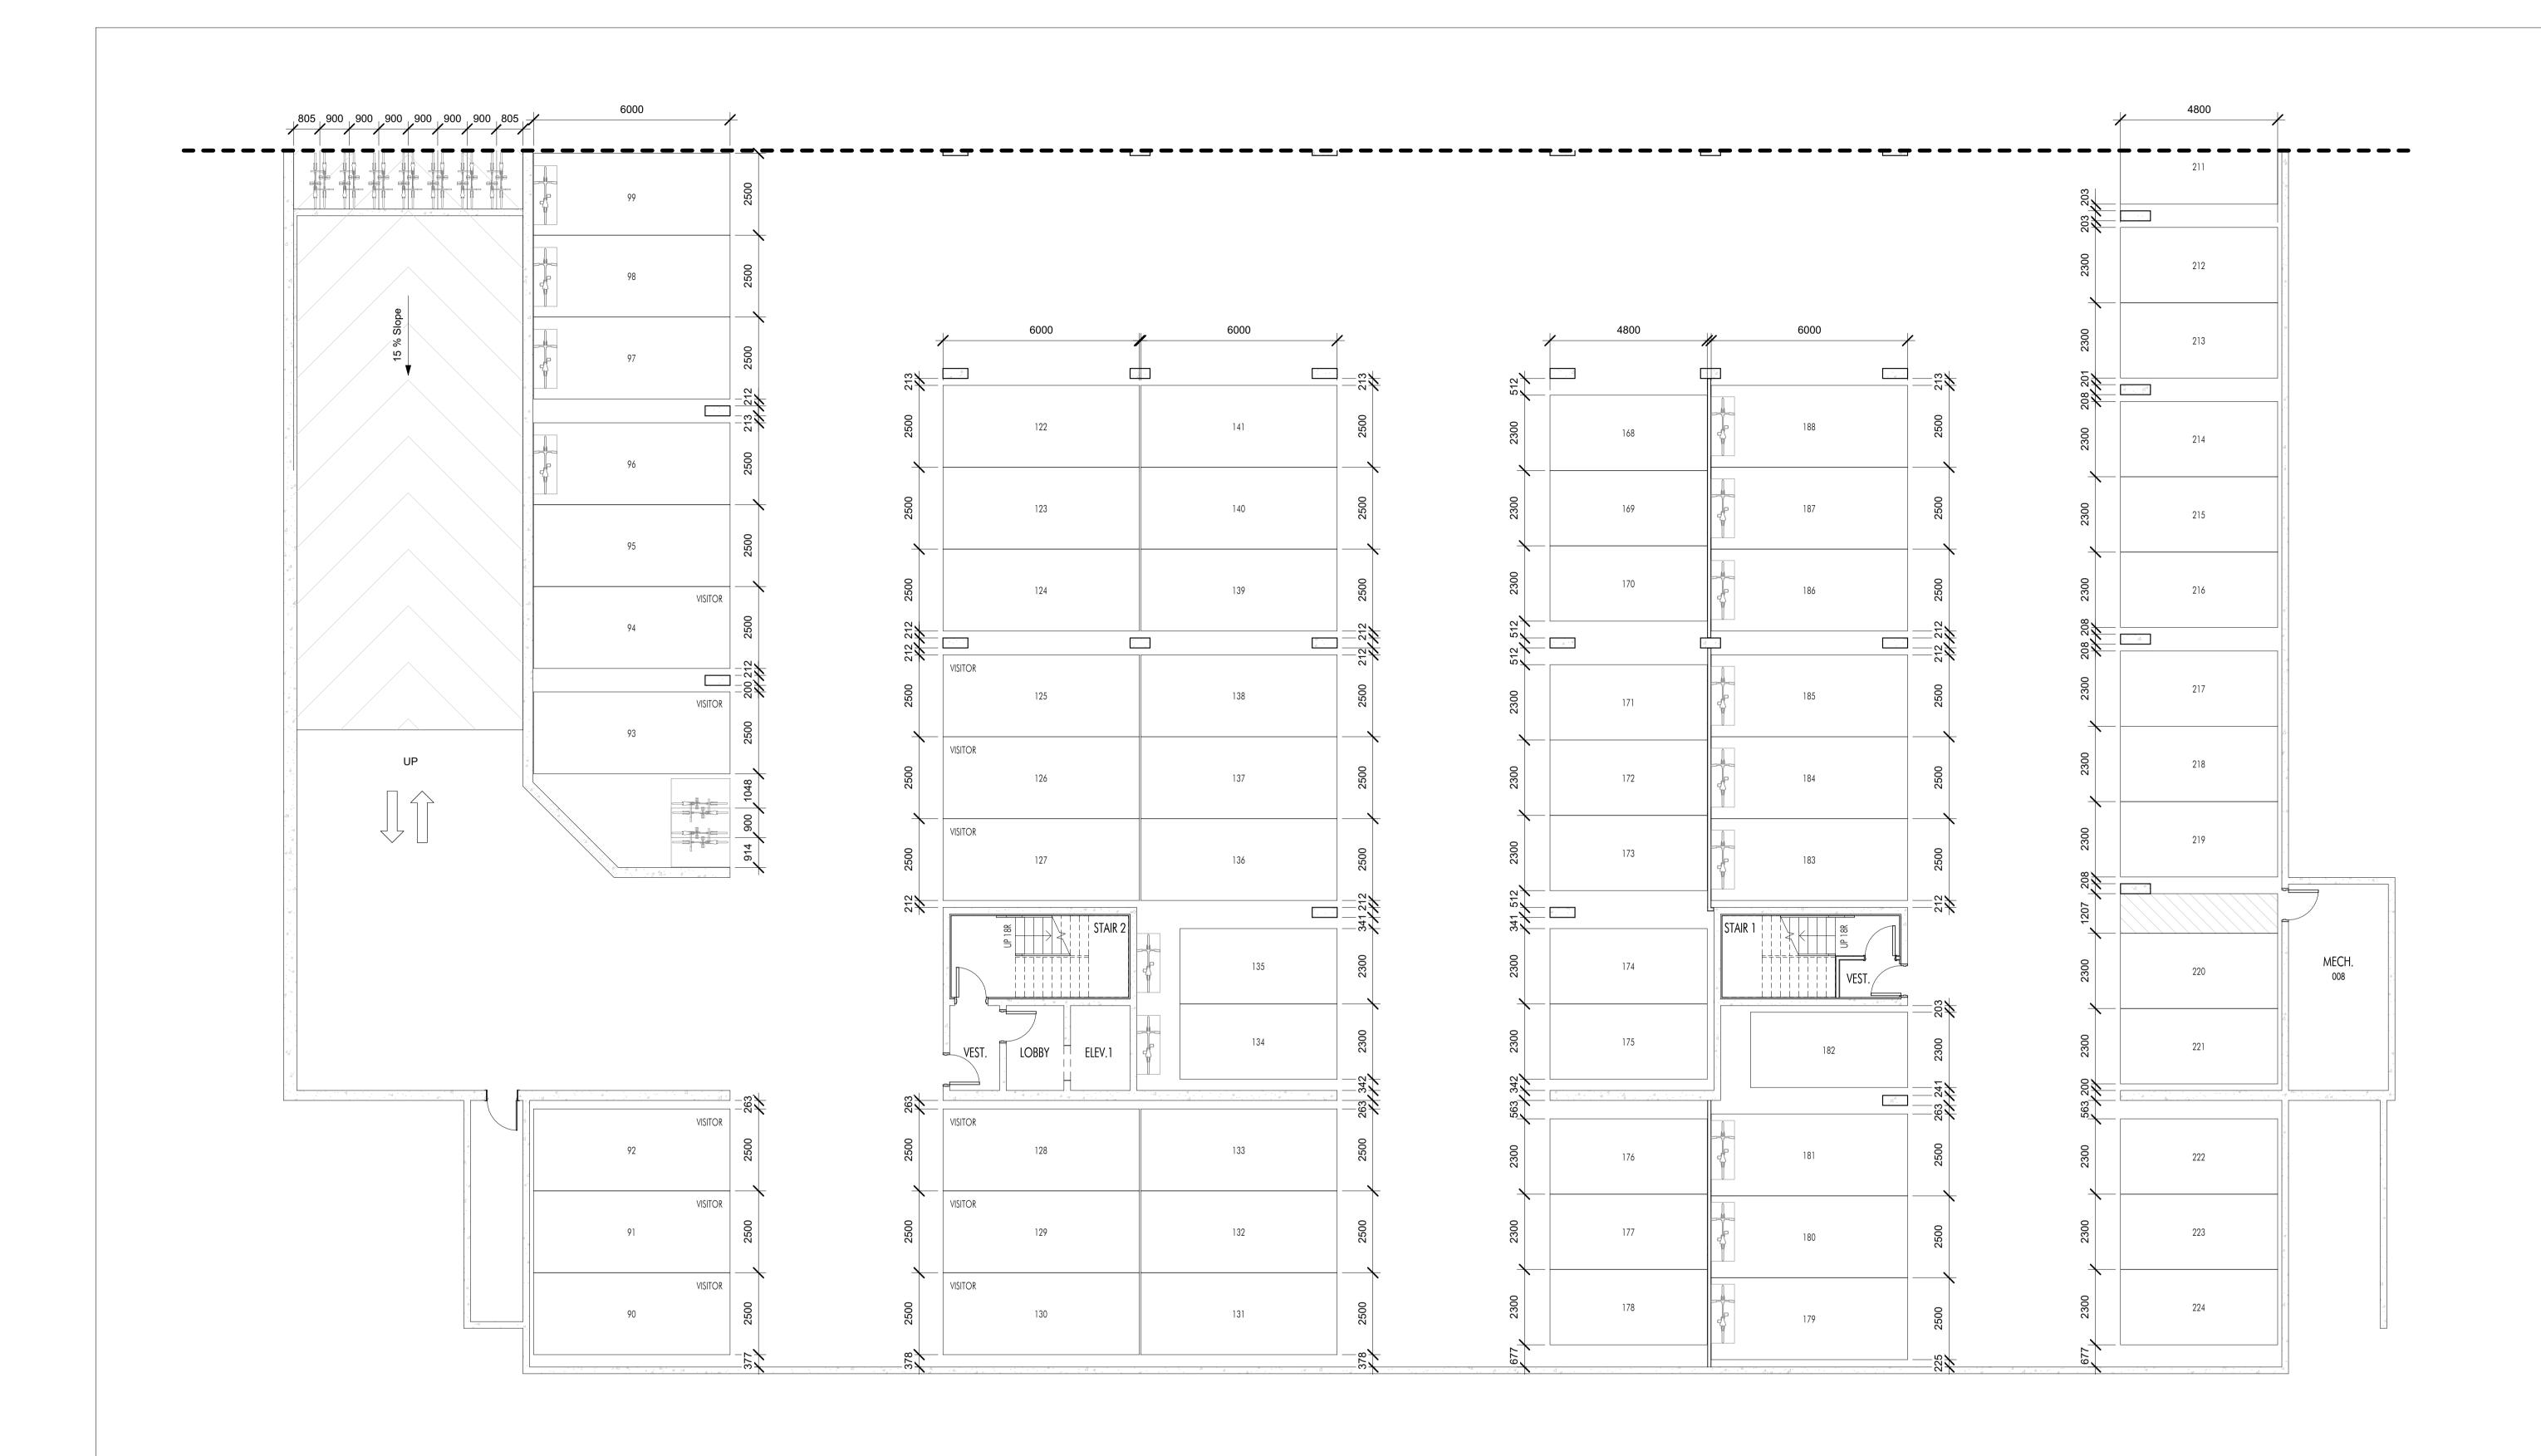



1 BASEMENT PARKADE PLAN - SOUTH PARKING PLAN
A-103 1/8" = 1'-0"

ADDENDUM NO.4



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Revision No., Date and Description

03.17.21 FOR DP

04.14.23 ADDENDUM NO.2

04.25.23 ADDENDUM NO.3

05.03.23 25% BP REVIEW

05.31.23 50% BP REVIEW

06.26.23 FOR COORDINATION


07.07.23 75% BP REVIEW 07.14.23 ADDENDUM NO.4


**Plot Date** 07.14.23

PROJECT
Revo (Collinson Rise)
DRAWING TITLE

BASEMENT -SOUTH PARKING PLAN

Drawing No.

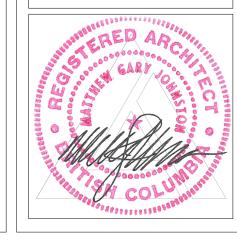

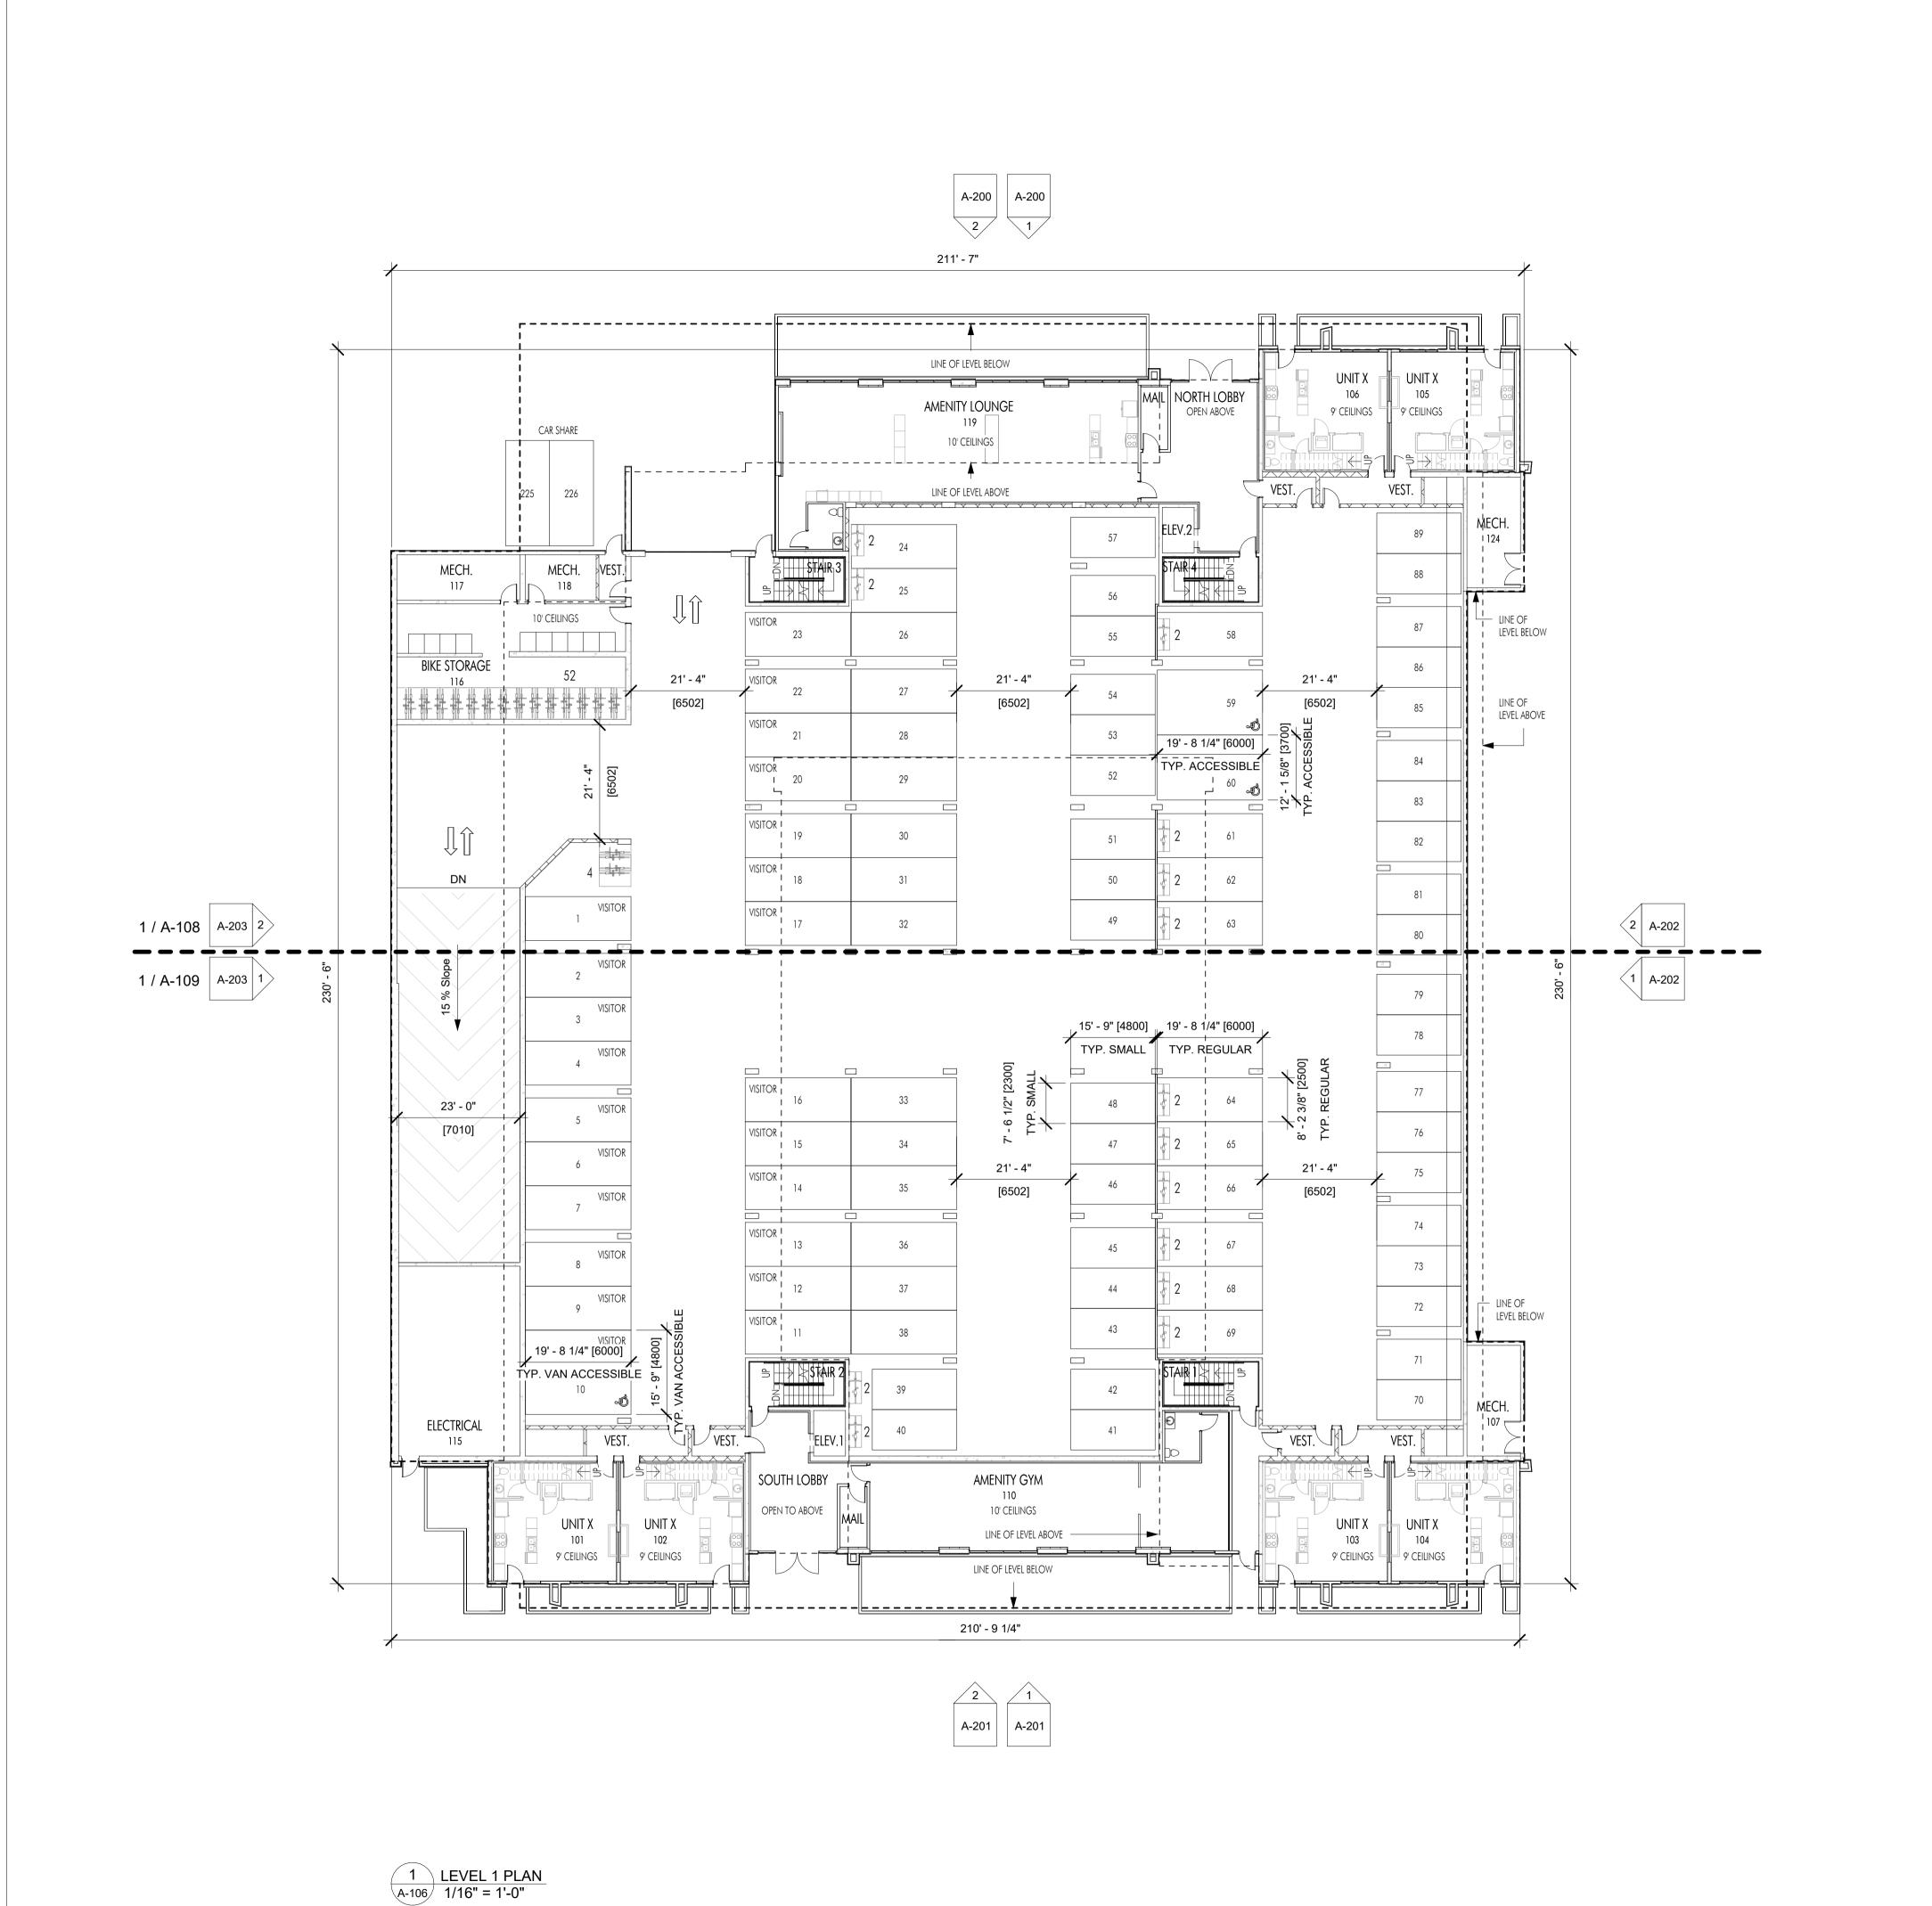



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Planner

Initials



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Kelowna, BC V1Y 2M3

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**Revision No., Date** 

and Description 02.17.23 FOR COORDINATION 02.25.23 FOR DP 03.17.21 FOR DP 04.14.23 ADDENDUM NO.2

04.25.23 ADDENDUM NO.3 05.03.23 25% BP REVIEW 05.31.23 50% BP REVIEW 06.26.23 FOR COORDINATION


07.07.23 75% BP REVIEW 07.14.23 ADDENDUM NO.4

**Plot Date** 07.14.23 **PROJECT** 

Revo (Collinson Rise) DRAWING TITLE

LEVEL 1 PLAN



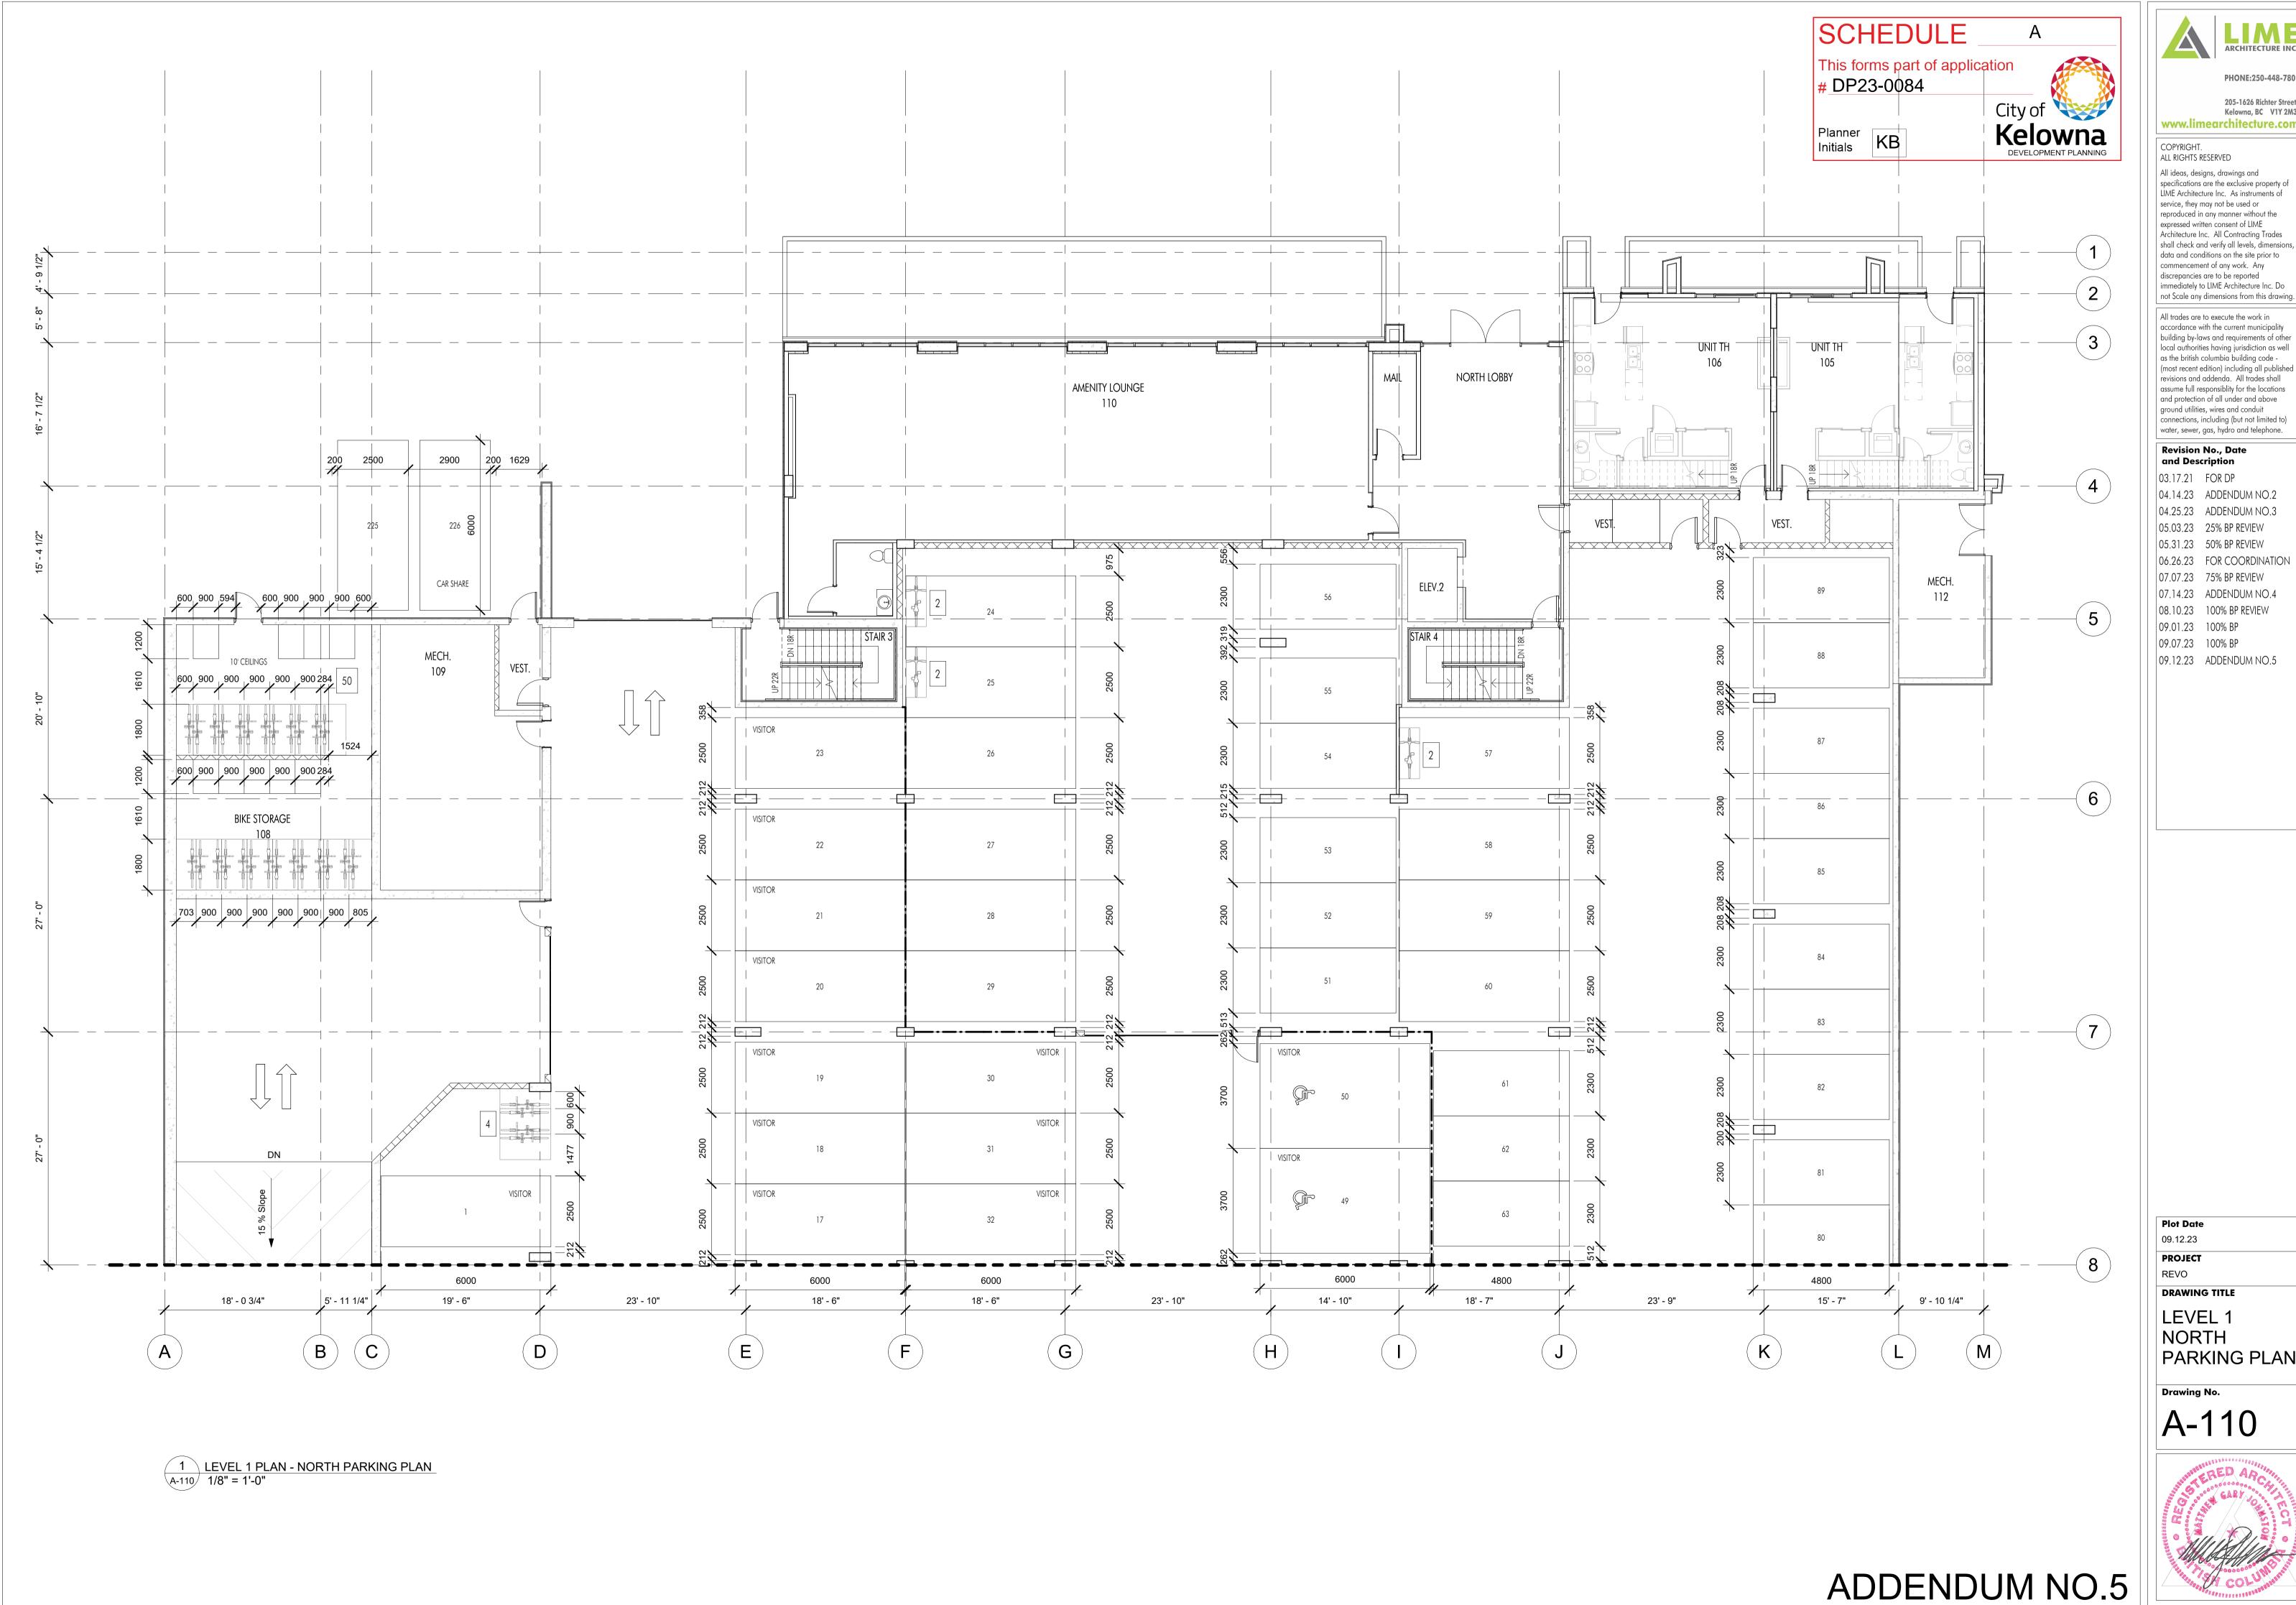

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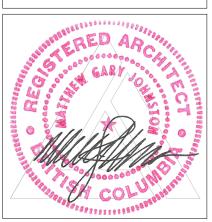
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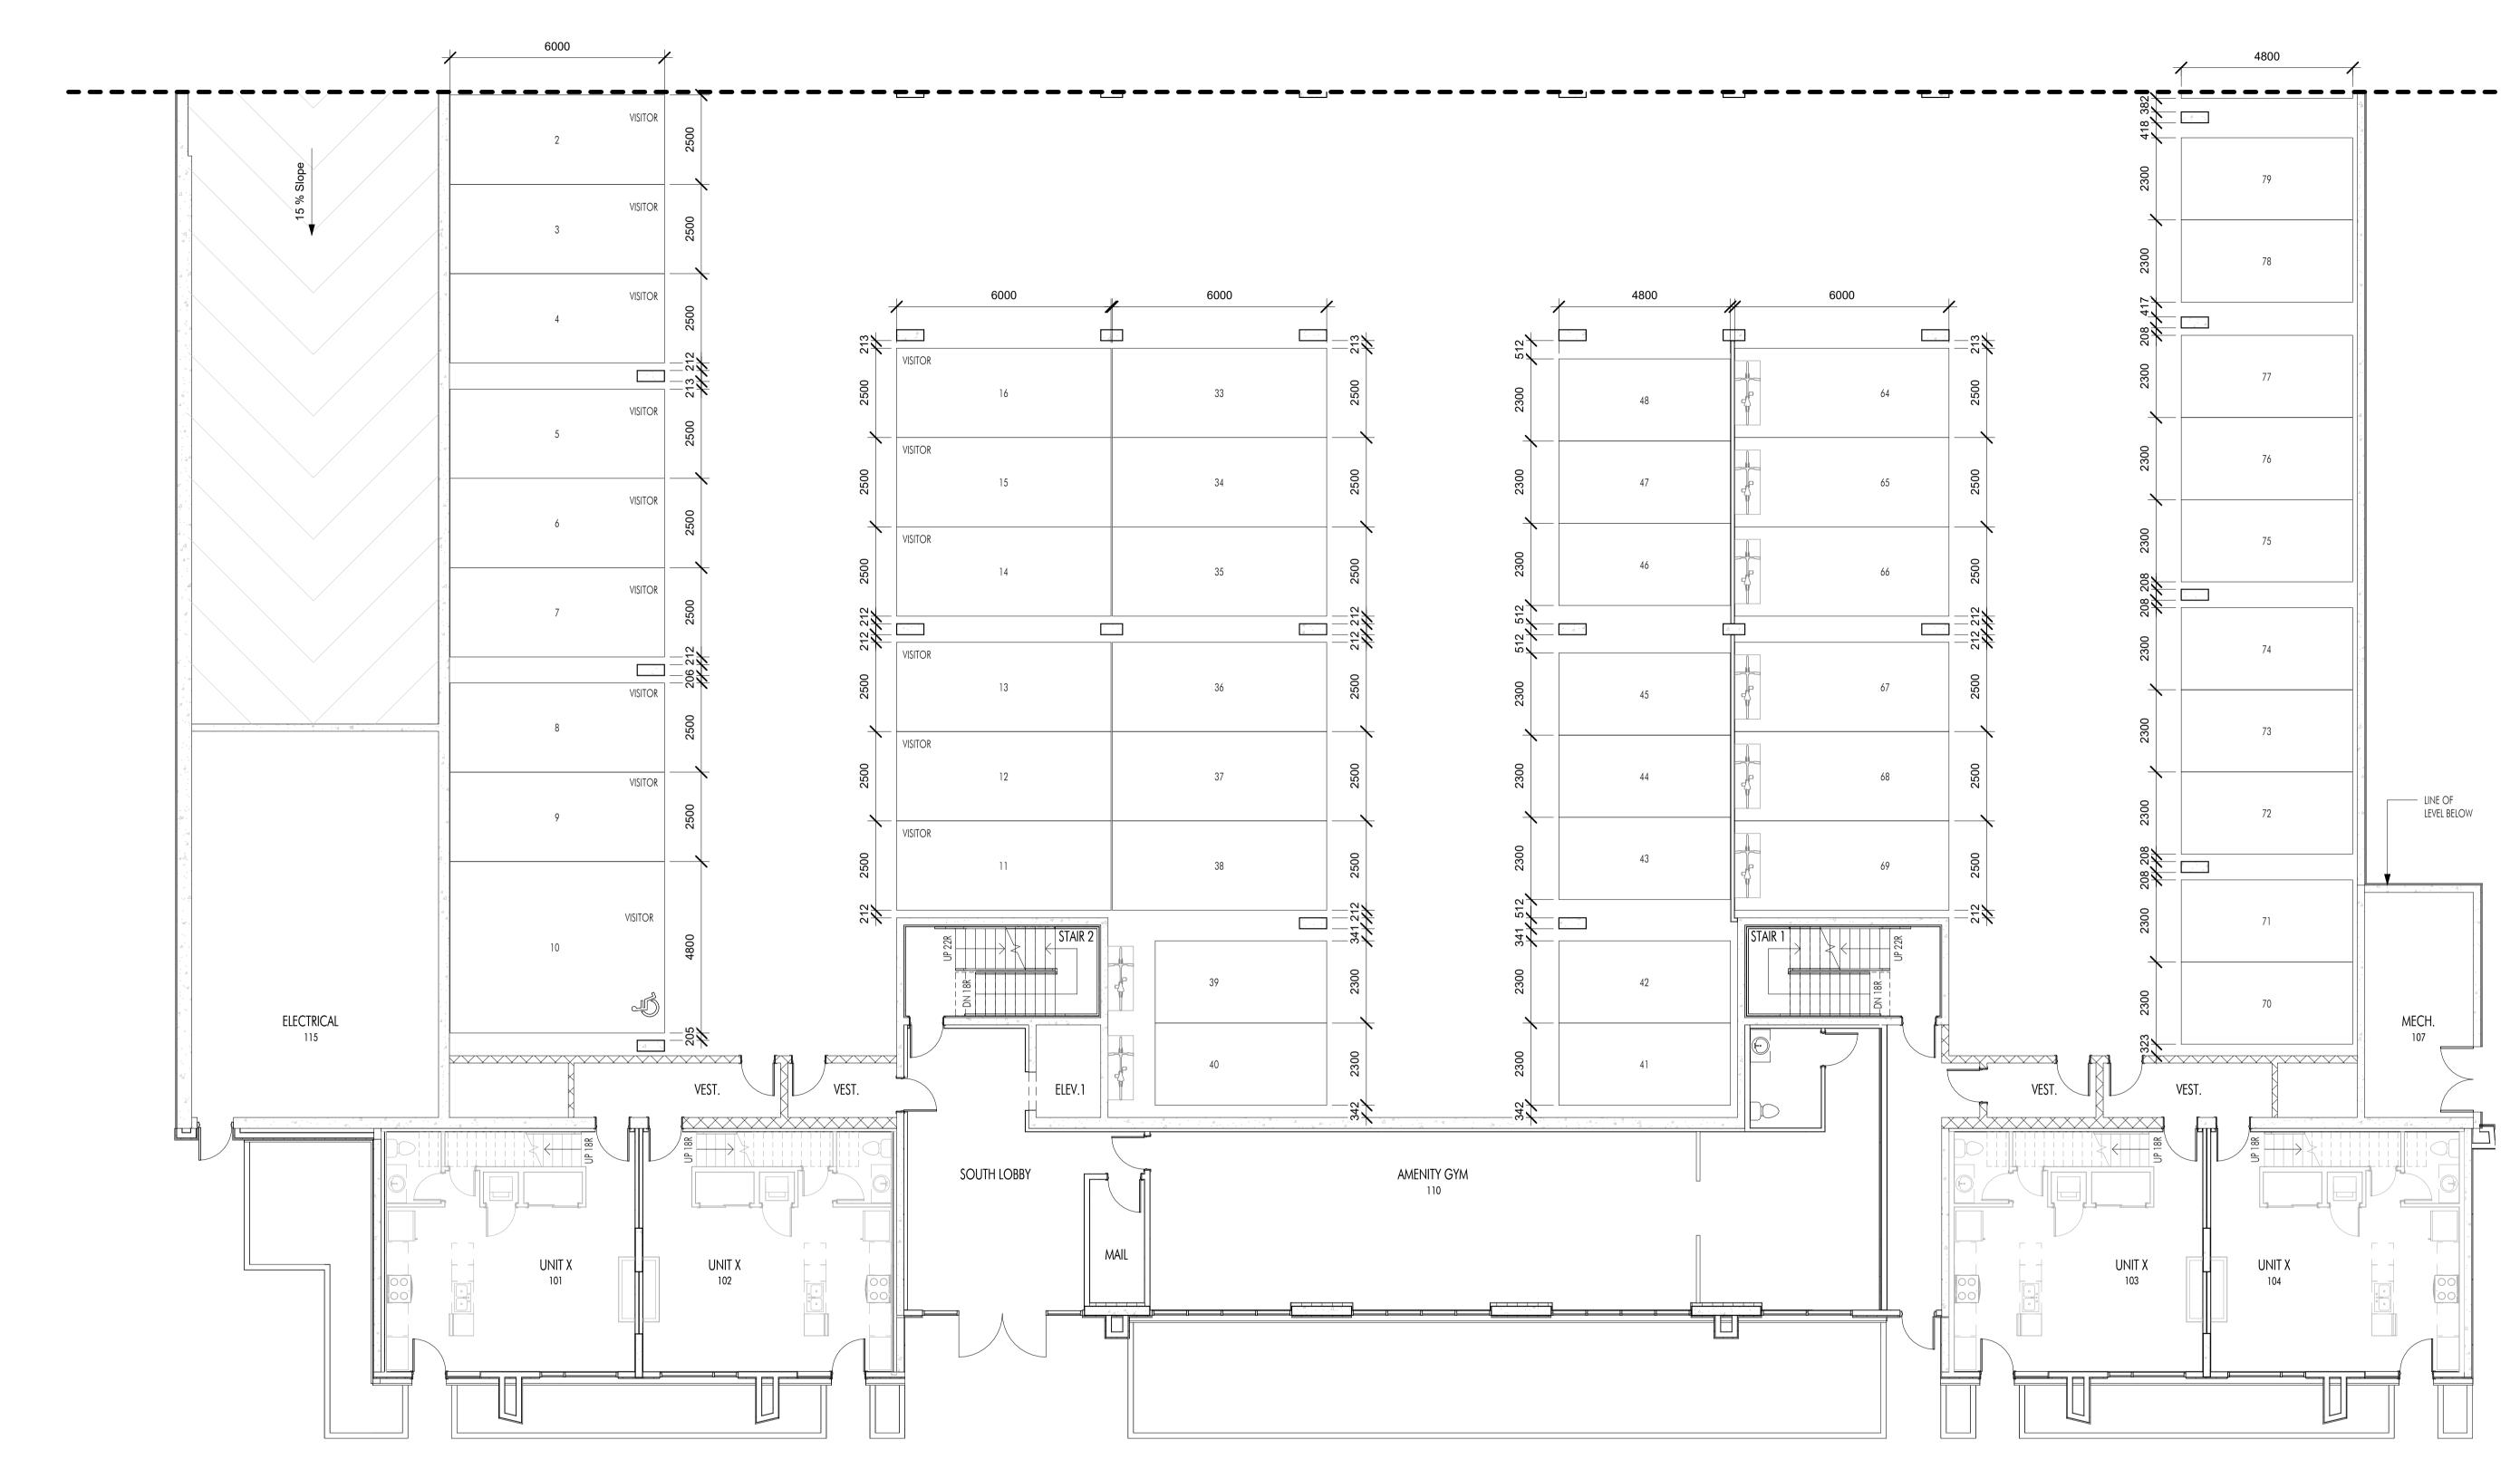
**Revision No., Date** 

and Description 03.17.21 FOR DP 04.14.23 ADDENDUM NO.2 04.25.23 ADDENDUM NO.3 05.03.23 25% BP REVIEW 05.31.23 50% BP REVIEW 06.26.23 FOR COORDINATION 07.07.23 75% BP REVIEW 07.14.23 ADDENDUM NO.4 08.10.23 100% BP REVIEW 09.01.23 100% BP 09.07.23 100% BP

PROJECT DRAWING TITLE

LEVEL 1 NORTH PARKING PLAN





SCHEDULE Α This forms part of application # DP23-0084 City of Kelowna

DEVELOPMENT PLANNING Planner Initials KB

1 LEVEL 1 PLAN - SOUTH PARKING PLAN 1/8" = 1'-0"

ADDENDUM NO.4

Plot Date 07.14.23

PROJECT Revo (Collinson Rise) DRAWING TITLE

LEVEL 1 -

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Revision No., Date and Description

04.14.23 ADDENDUM NO.2

04.25.23 ADDENDUM NO.3 05.03.23 25% BP REVIEW 05.31.23 50% BP REVIEW

06.26.23 FOR COORDINATION


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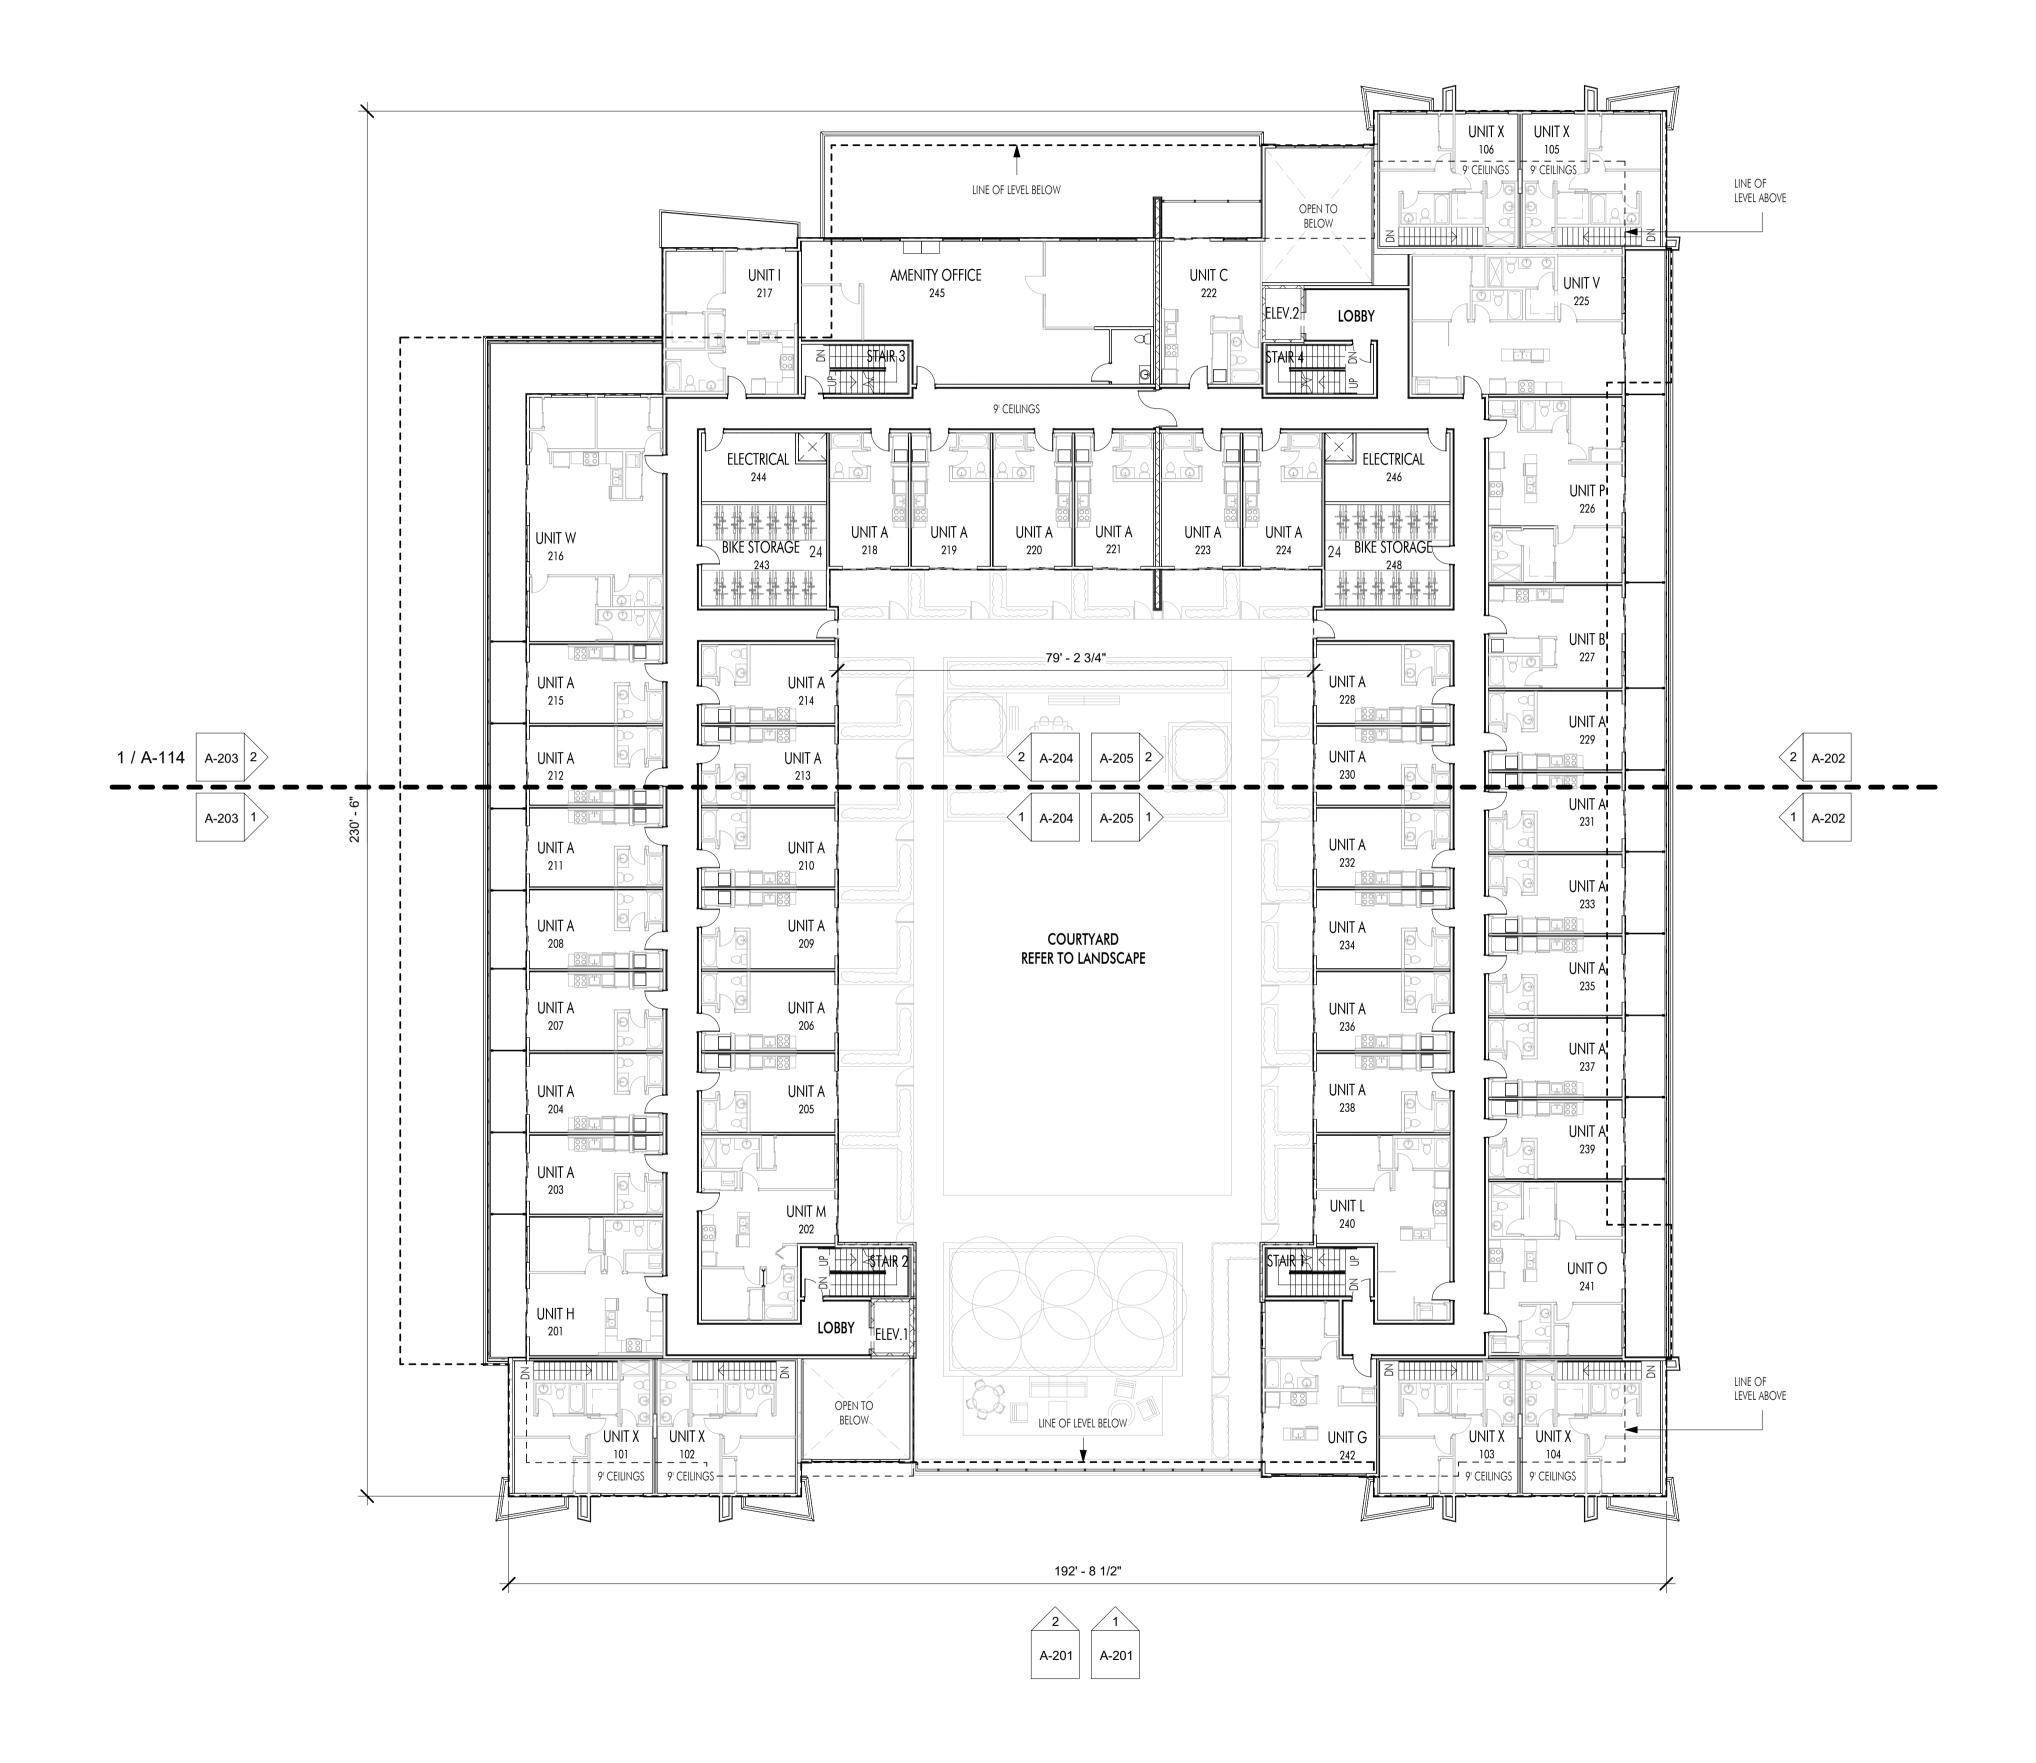
07.14.23 ADDENDUM NO.4

03.17.21 FOR DP

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SOUTH PARKING PLAN



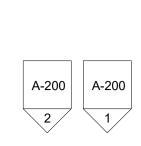

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06.26.23 FOR COORDINATION 07.07.23 75% BP REVIEW

07.14.23 ADDENDUM NO.4


**Plot Date** 07.14.23 **PROJECT** 

Revo (Collinson Rise) DRAWING TITLE

LEVEL 2 PLAN





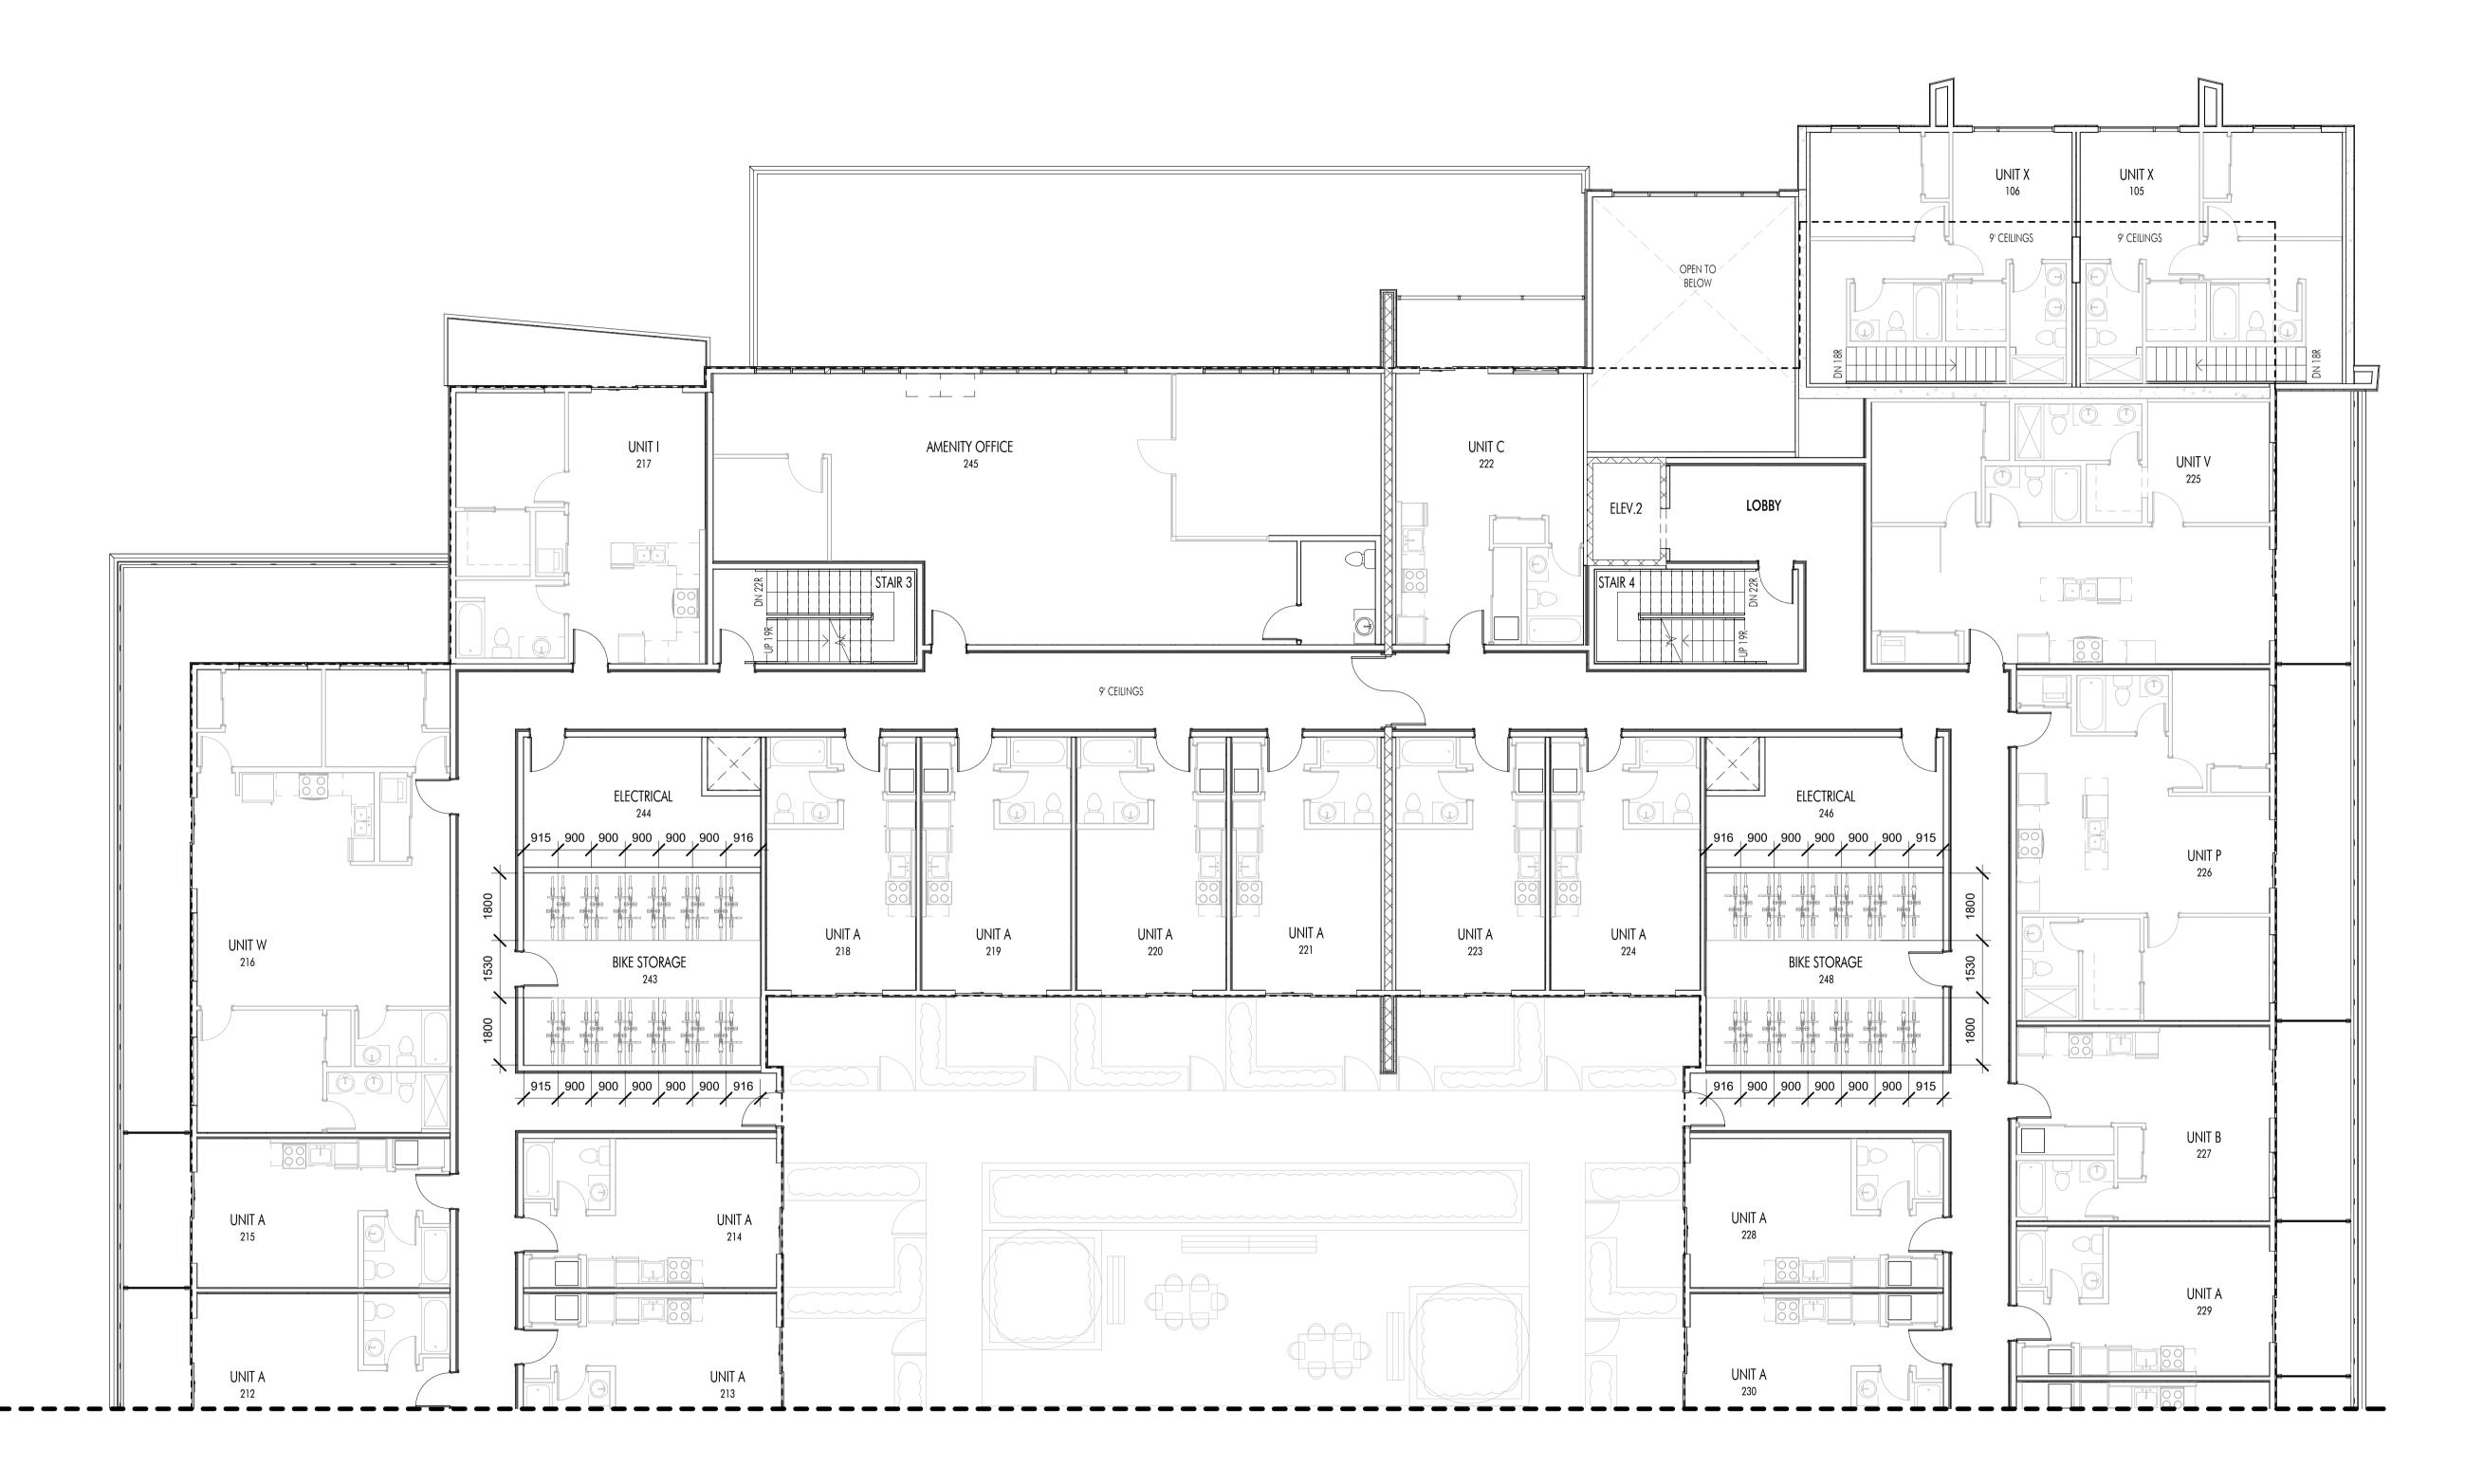

1 LEVEL 2 PLAN - BIKE STORAGE PLAN A-114 1/8" = 1'-0"

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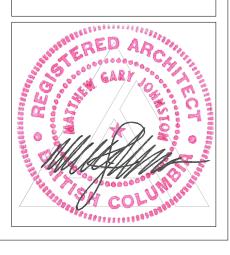
**Revision No., Date** 


and Description 03.17.21 FOR DP 04.14.23 ADDENDUM NO.2 05.31.23 50% BP REVIEW 07.07.23 75% BP REVIEW 07.14.23 ADDENDUM NO.4

Plot Date 07.14.23

PROJECT Revo (Collinson Rise) DRAWING TITLE

> LEVEL 2 - BIKE STORAGE PLAN



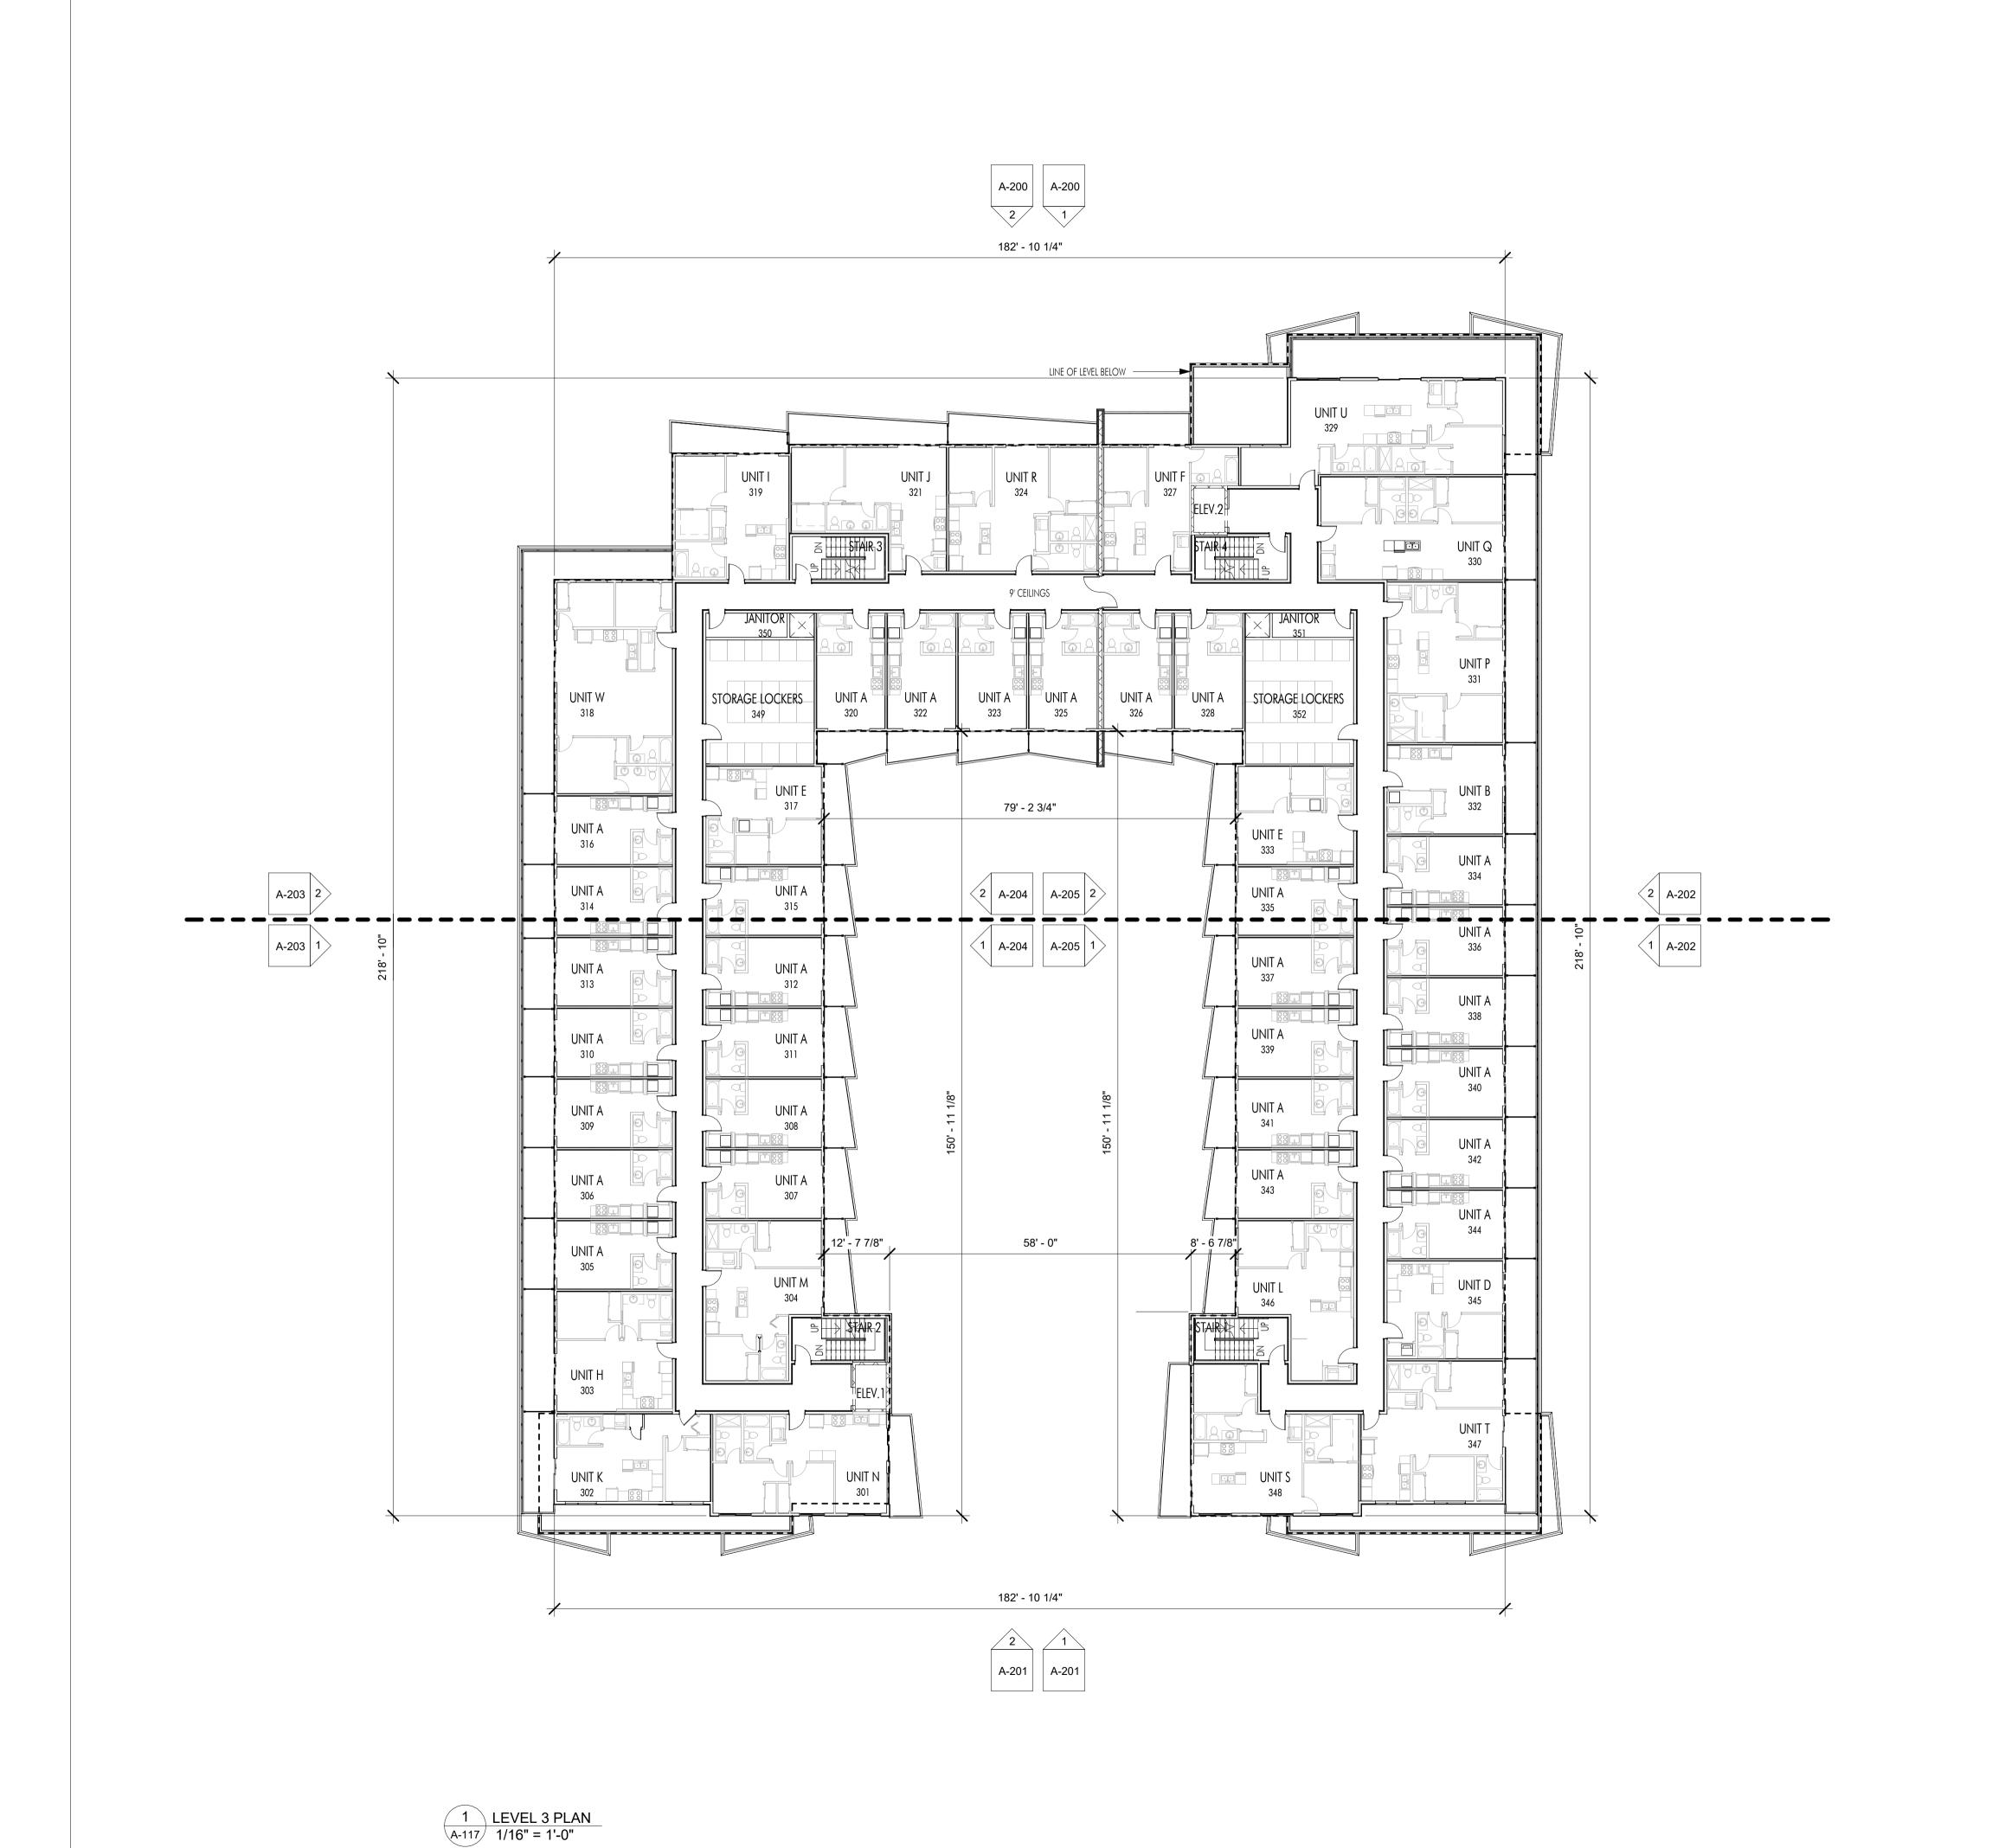



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Revision No., Date and Description

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02.25.23 FOR DP
03.06.23 FOR DP
03.17.21 FOR DP
05.03.23 25% BP REVIEW
05.31.23 50% BP REVIEW

06.26.23 FOR COORDINATION

07.07.23 75% BP REVIEW 07.14.23 ADDENDUM NO.4


Plot Date 07.14.23 PROJECT


Revo (Collinson Rise)

DRAWING TITLE

LEVEL 3 PLAN

Drawing No

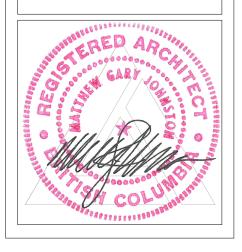

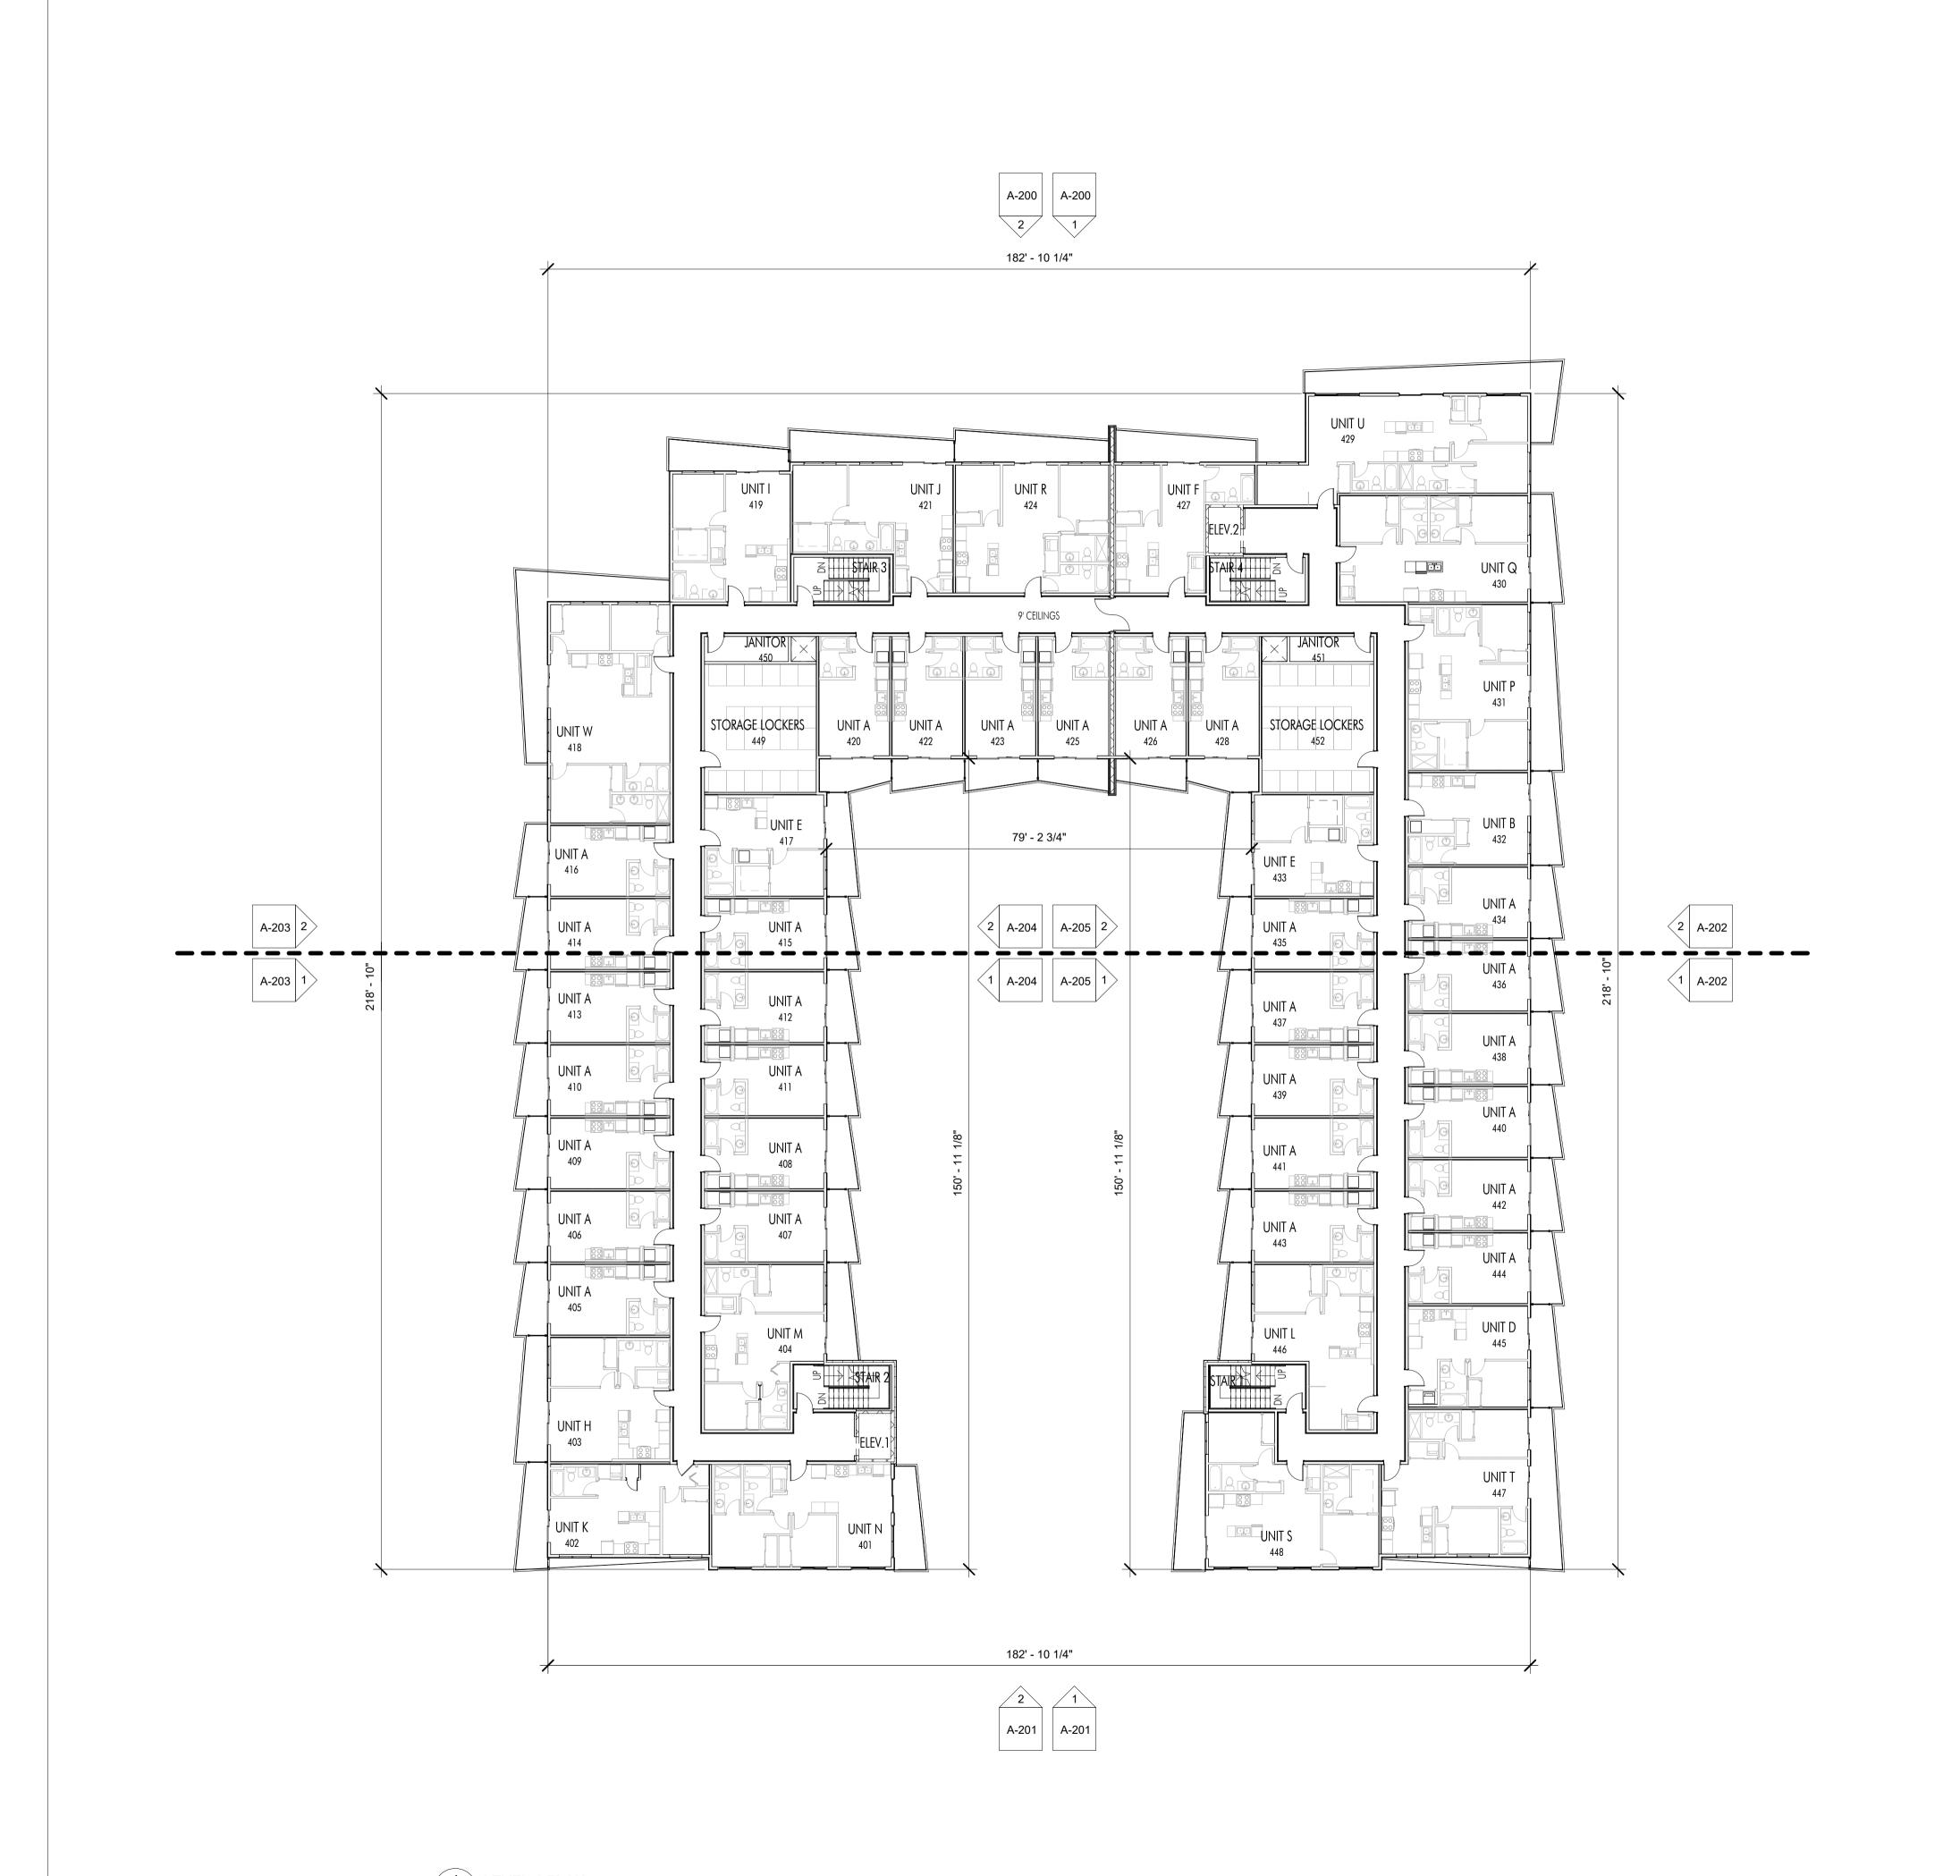

SCHEDULE

This forms part of application

#\_DP23-0084

Planner Initials KB City of Kelowna

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Revision No., Date and Description

and Description
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02.25.23 FOR DP
03.06.23 FOR DP
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07.07.23 75% BP REVIEW 07.14.23 ADDENDUM NO.4

Plot Date 07.14.23 PROJECT


Revo (Collinson Rise)

DRAWING TITLE

LEVEL 4 PLAN

Drawing No.



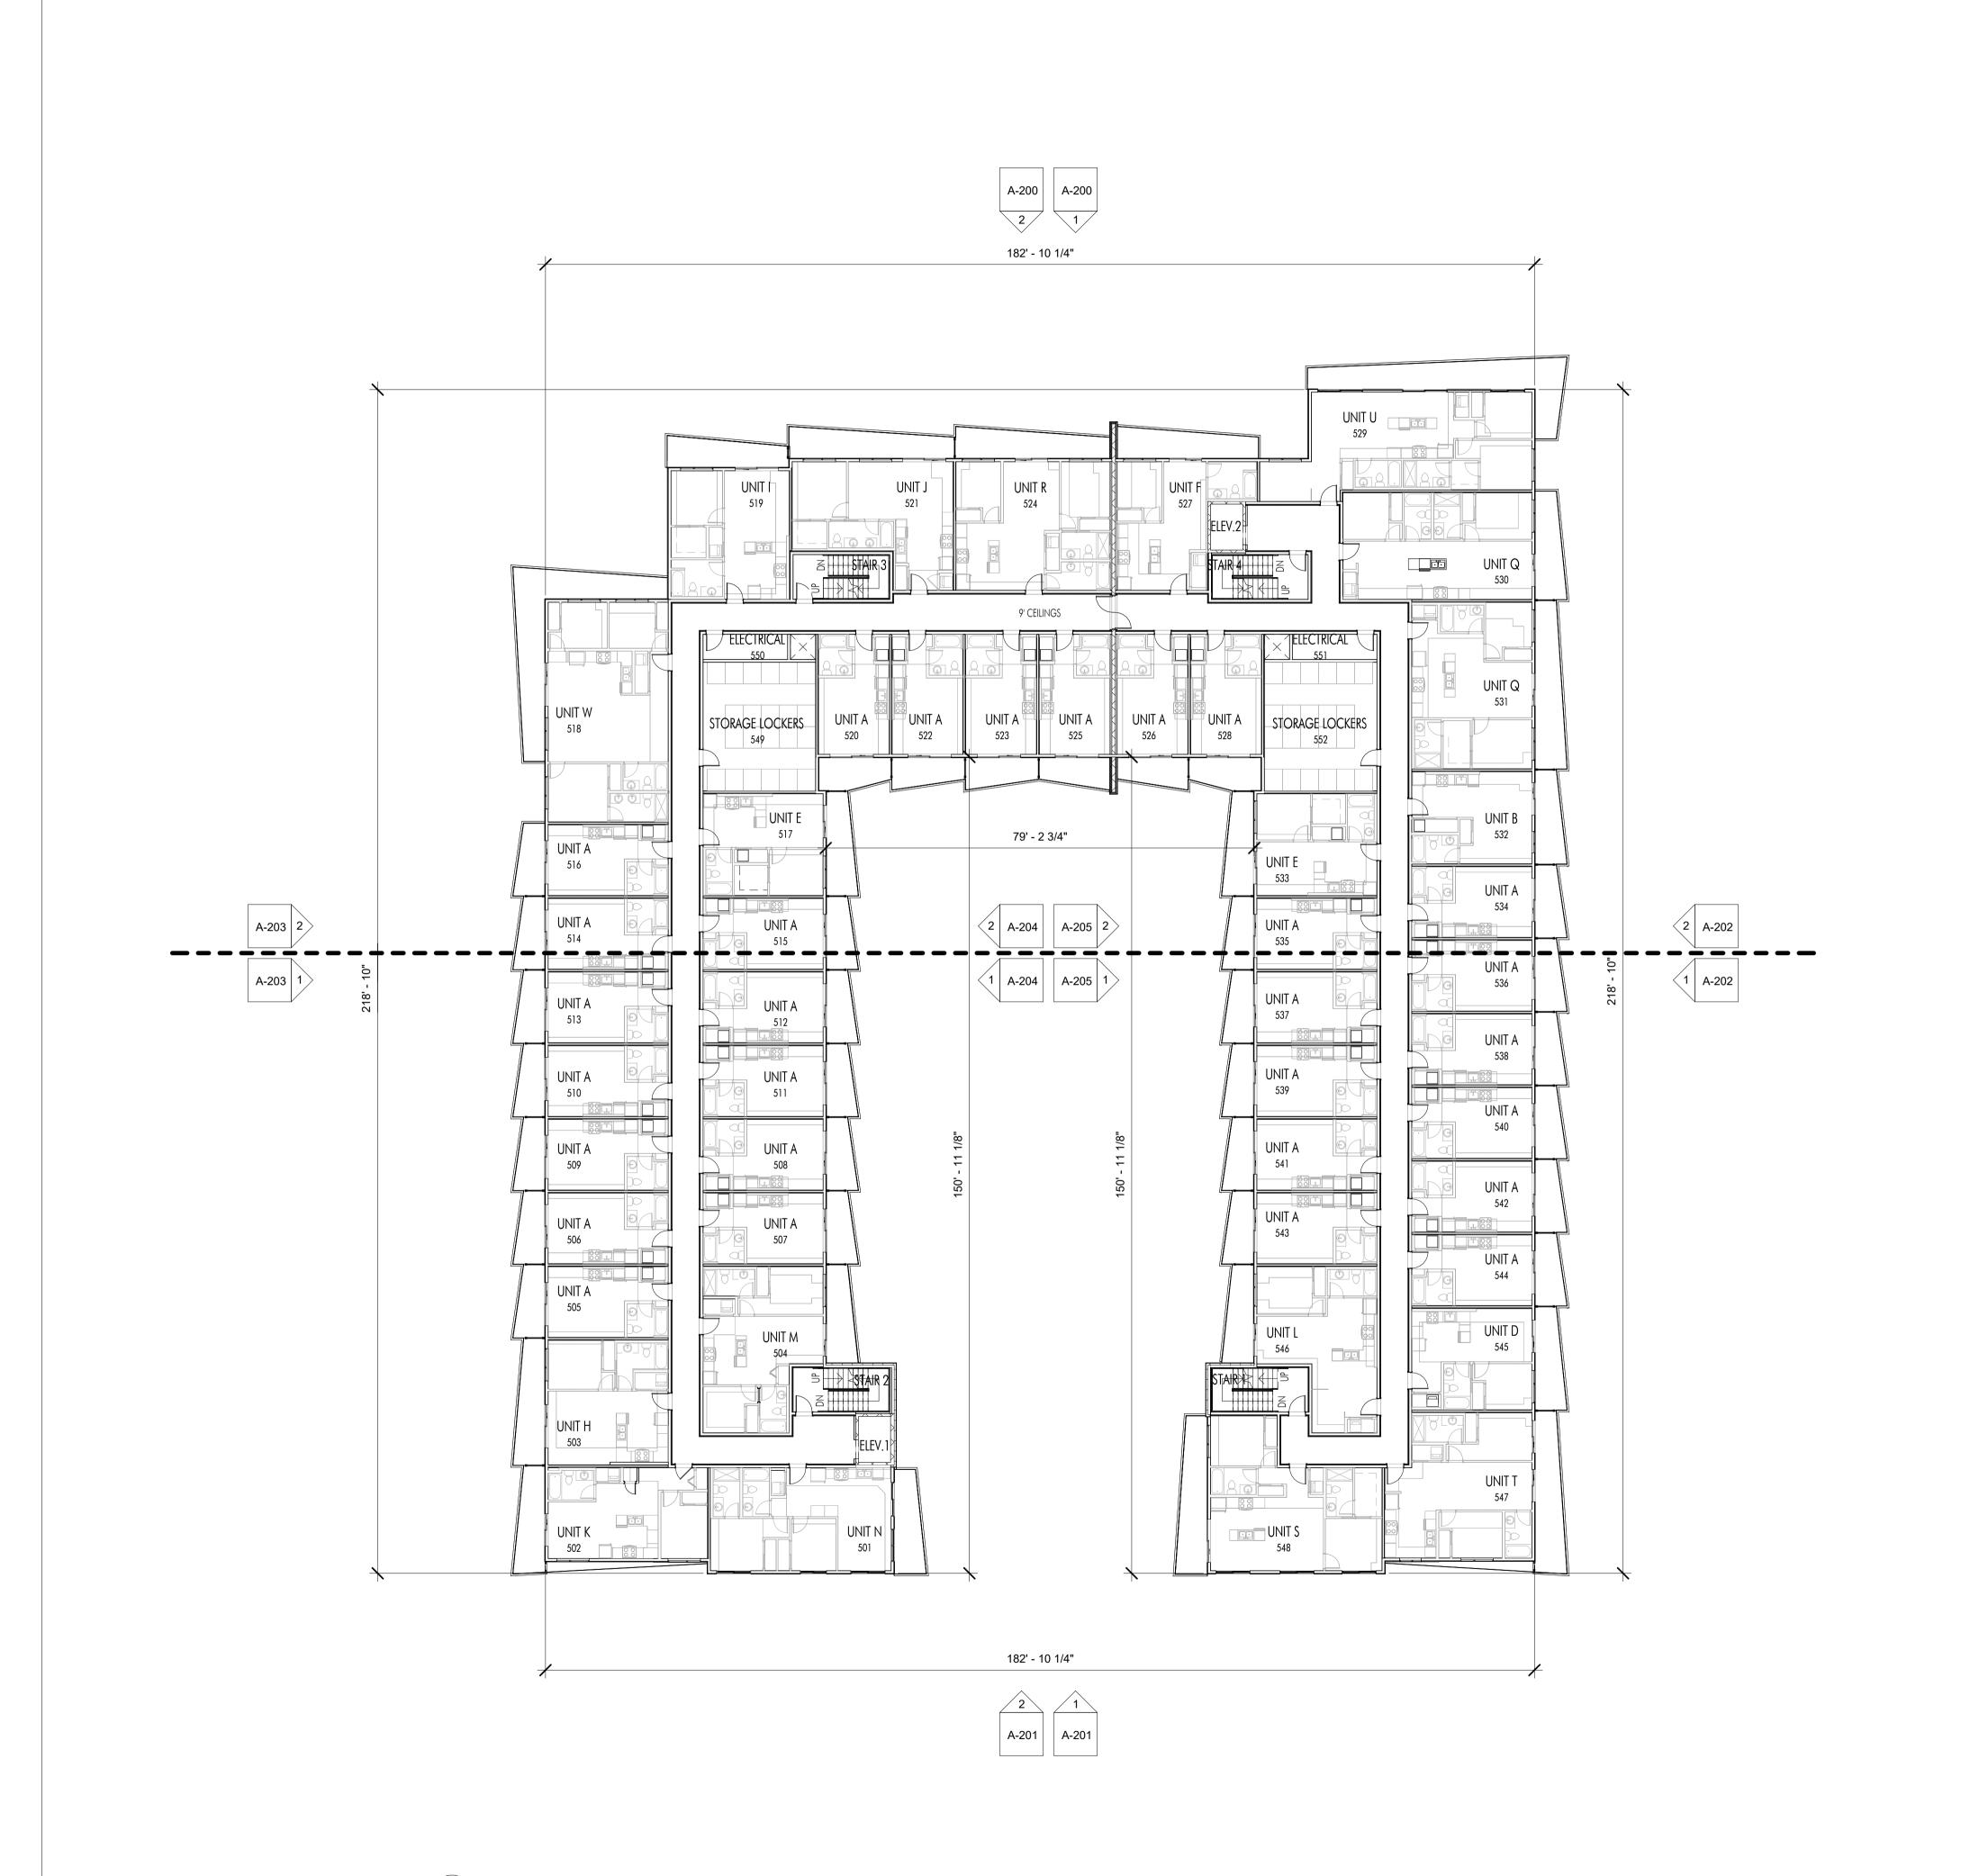

SCHEDULE

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06.26.23 FOR COORDINATION 07.07.23 75% BP REVIEW

07.14.23 ADDENDUM NO.4

07.14.23 **PROJECT** Revo (Collinson Rise)

Plot Date

DRAWING TITLE

LEVEL 5 PLAN





SCHEDULE This forms part of application

# DP23-0084

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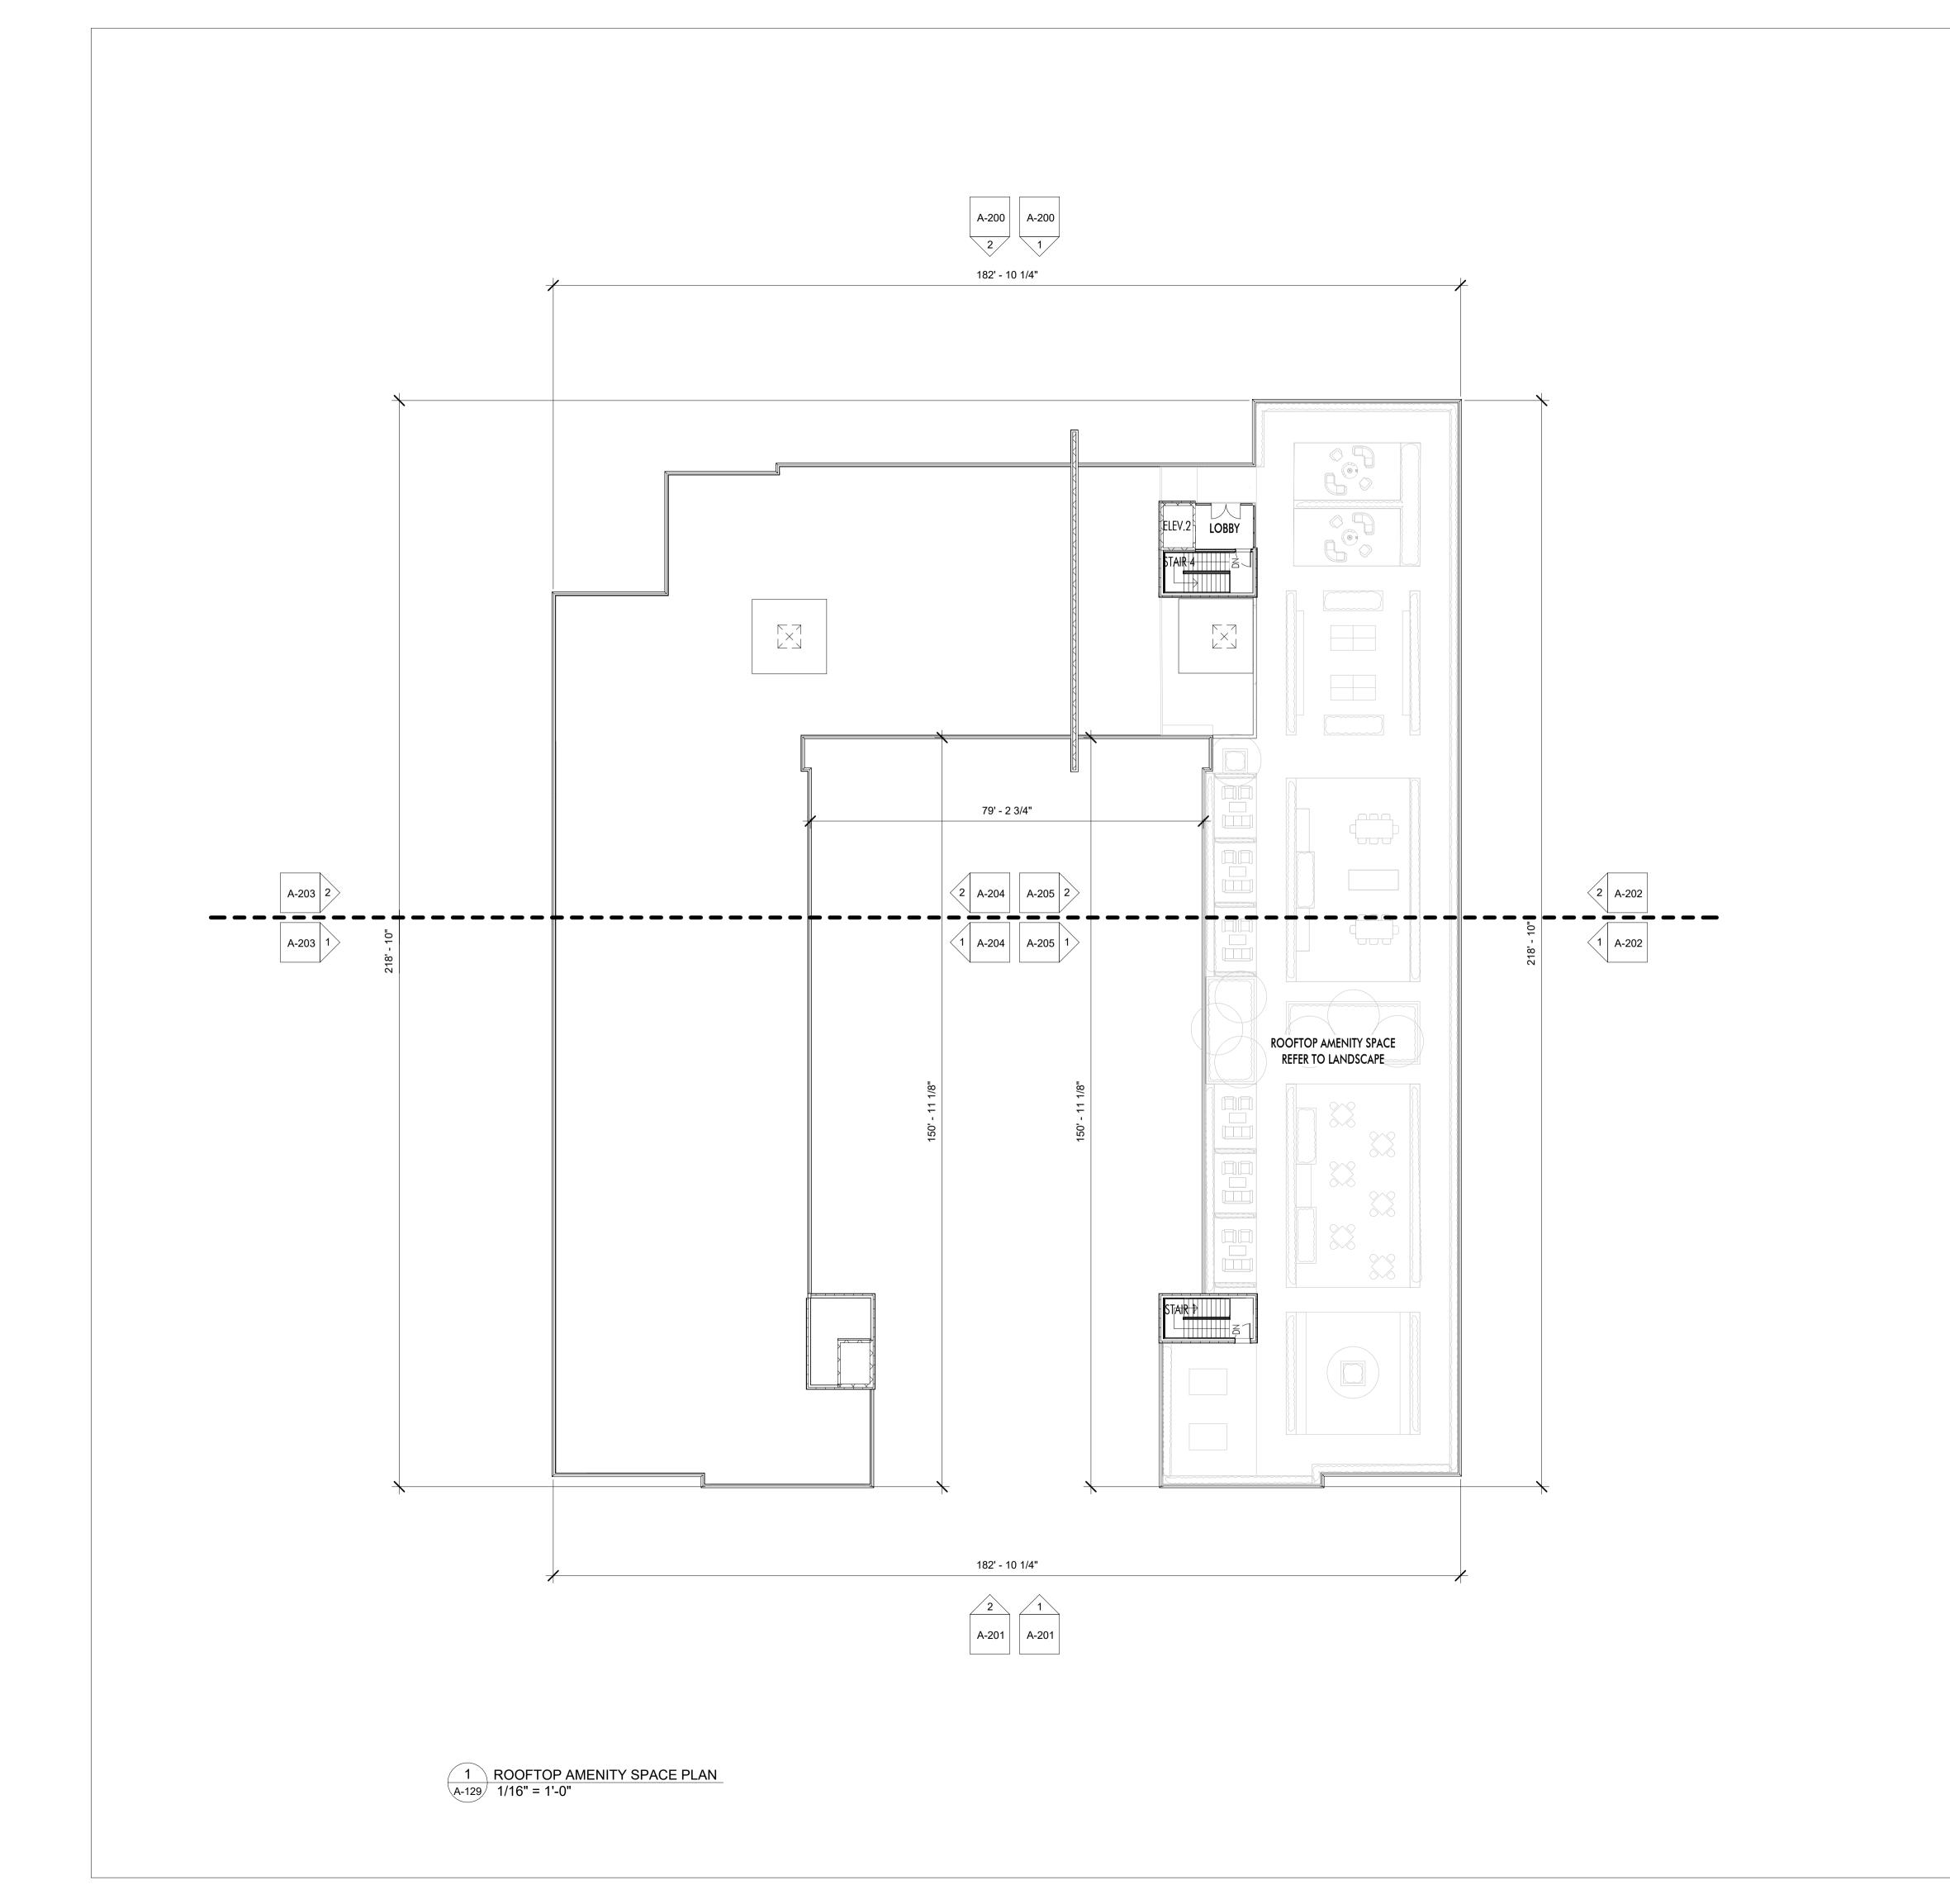
07.07.23 75% BP REVIEW 07.14.23 ADDENDUM NO.4

Plot Date 07.14.23

PROJECT Revo (Collinson Rise) DRAWING TITLE

LEVEL 6 PLAN





SCHEDULE
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02.25.23 FOR DP
03.06.23 FOR DP
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05.03.23 25% BP REVIEW
05.31.23 50% BP REVIEW
06.26.23 FOR COORDINATION

07.07.23 75% BP REVIEW 07.14.23 ADDENDUM NO.4


**Plot Date** 07.14.23

PROJECT
Revo (Collinson Rise)

DRAWING TITLE

ROOFTOP AMENITY

Drawing No

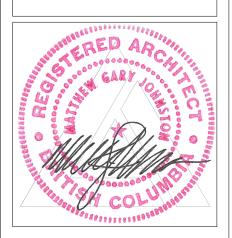





07.14.23

PROJECT

Revo (Colli

**Plot Date** 

Revo (Collinson Rise)

DRAWING TITLE

COLOUR KEY PLANS

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**Revision No., Date** 

11.15.22 SCHEMATICS 12.09.22 SCHEMATICS

01.06.23 SCHEMATICS 02.08.23 SCHEMATICS

05.03.23 25% BP REVIEW

05.31.23 50% BP REVIEW

07.07.23 75% BP REVIEW

07.14.23 ADDENDUM NO.4

06.26.23 FOR COORDINATION

02.25.23 FOR DP 03.06.23 FOR DP 03.17.21 FOR DP


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rawing No.

A-133



ADDENDUM NO.4

City of

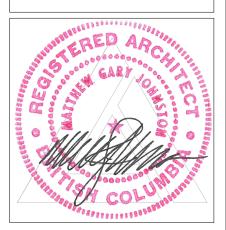Kelowna DEVELOPMENT PLANNING


SCHEDULE

# DP23-0084

Planner Initials KB


This forms part of application



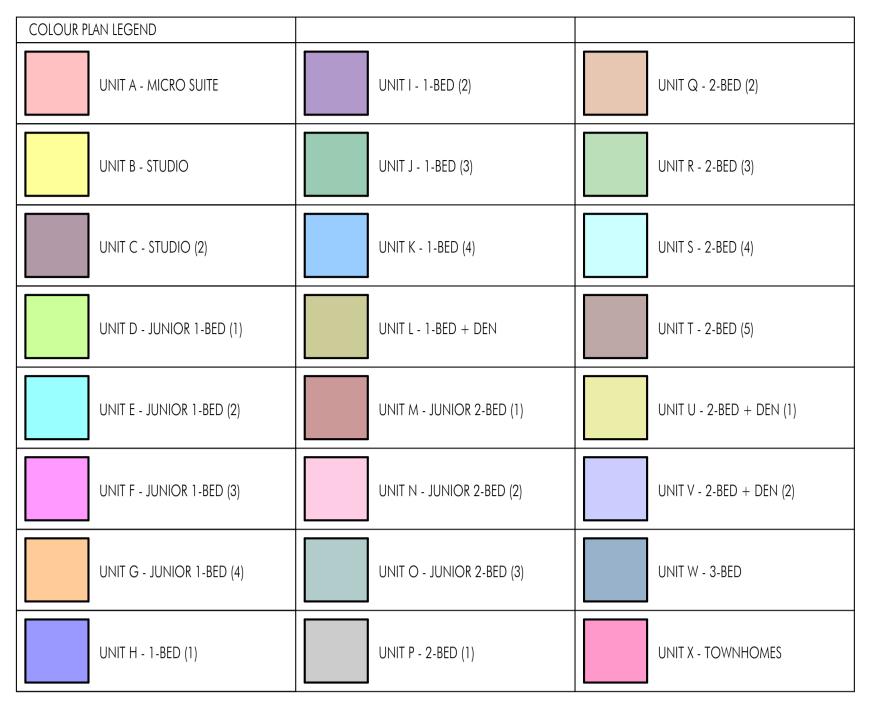

PLANS A-134

SCHEDULE This forms part of application # DP23-0084 City of Kelowna DEVELOPMENT PLANNING

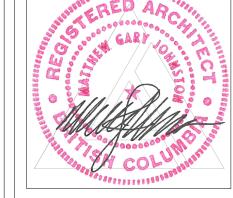

Plot Date 07.14.23 **PROJECT** 

Revo (Collinson Rise)

**COLOUR KEY** 

DRAWING TITLE

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02.25.23 FOR DP


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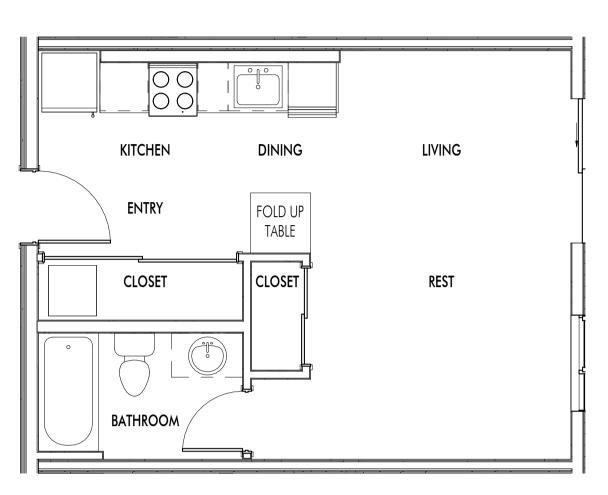
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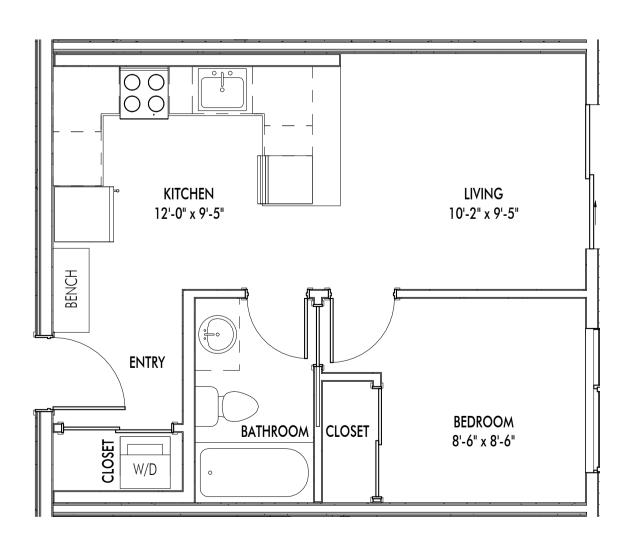





1 UNIT A - MICRO - 307 SF A-135 1/4" = 1'-0"




2 UNIT B - STUDIO (1) - 396 SF A-135 1/4" = 1'-0"

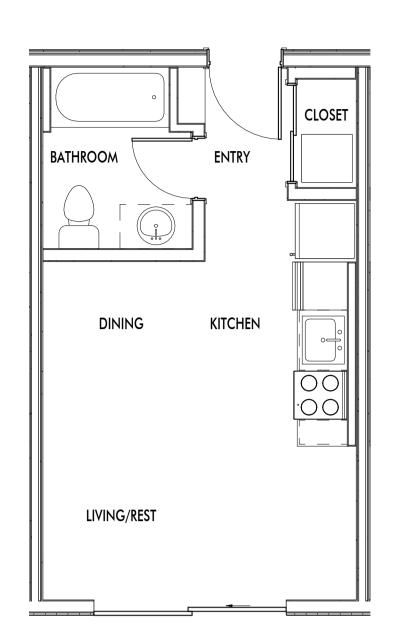


4 UNIT D - JUINIOR 1-BED (1) - 434 SF A-135 1/4" = 1'-0"

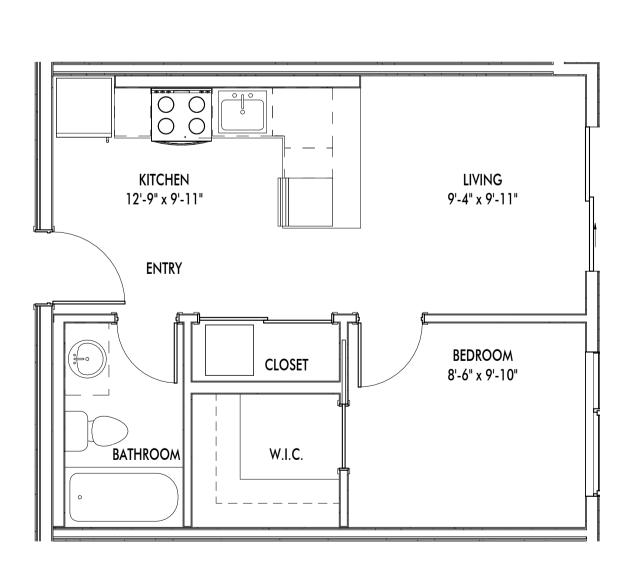

5 UNIT E - JUNIOR 1-BED (2) - 436 SF A-135 1/4" = 1'-0"

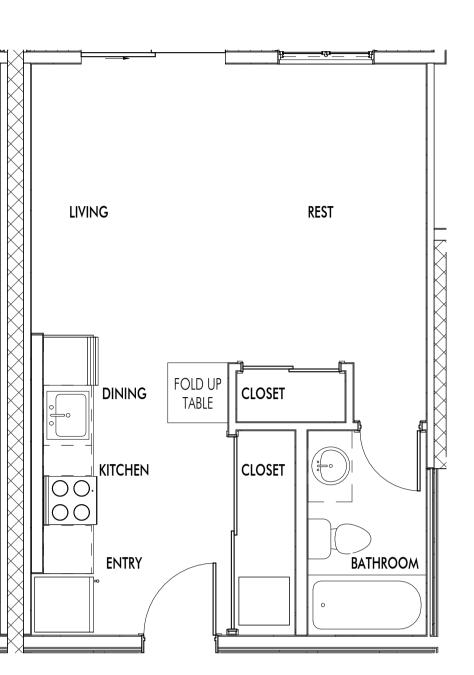

3 UNIT C - STUDIO (2) - 425 SF A-135 1/4" = 1'-0"

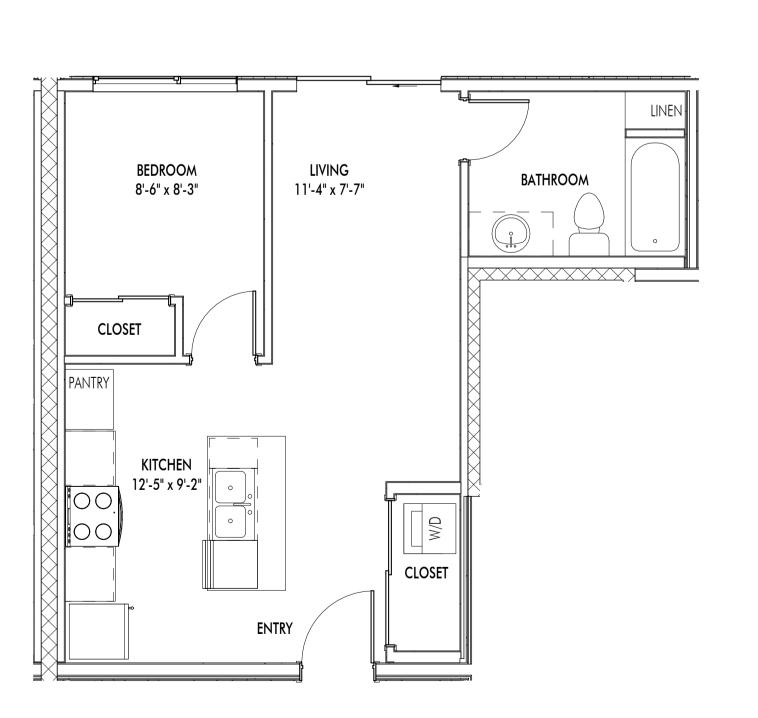

6 UNIT F - JUNIOR 1-BED (3)- 493 SF A-135 1/4" = 1'-0" Plot Date
07.14.23

PROJECT
Revo (Collinson Rise)

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07.07.23 75% BP REVIEW 07.14.23 ADDENDUM NO.4

06.26.23 FOR COORDINATION

02.25.23 FOR DP 03.06.23 FOR DP 03.17.21 FOR DP

and Description


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TYPICAL UNIT LAYOUTS


Drawing No.






1 UNIT G - JUNIOR 1-BED (4) - 486 SF A-136 1/4" = 1'-0"

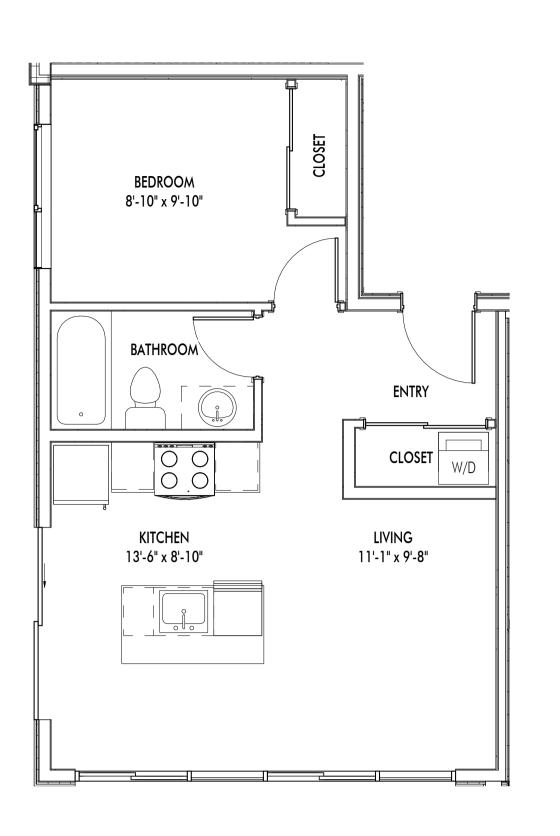4 UNIT J - 1-BED (3) - 591 SF A-136 1/4" = 1'-0"

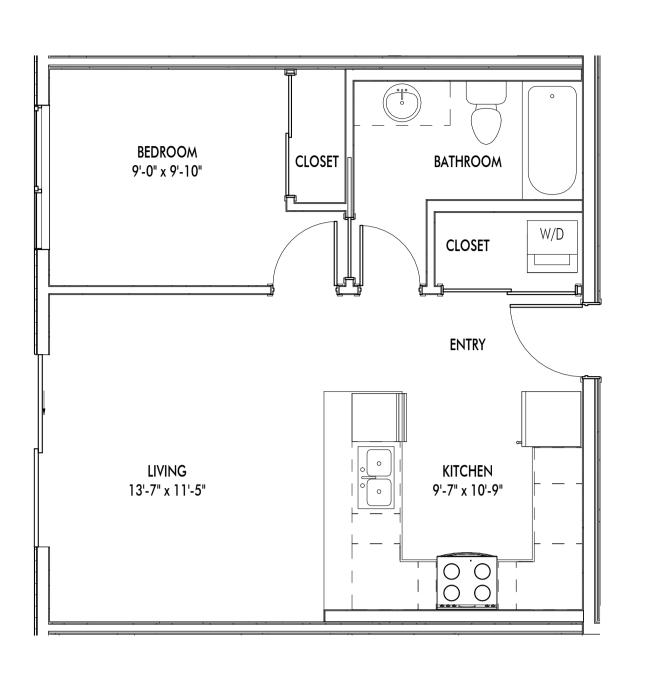

2 UNIT H - 1-BED (1) - 530 SF A-136 1/4" = 1'-0"

5 UNIT K - 1-BED (4)- 508 SF A-136 1/4" = 1'-0"

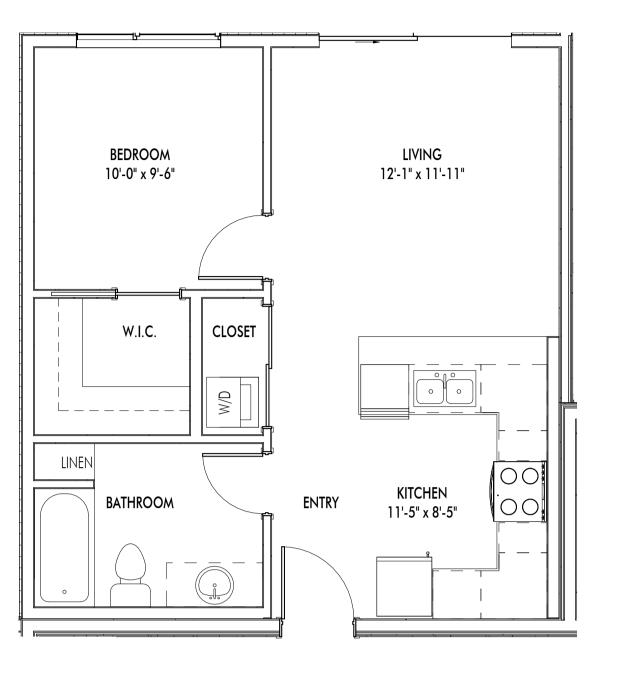

SCHEDULE

# DP23-0084

BATHROOM


KITCHEN 12'-9" x 9'-1"


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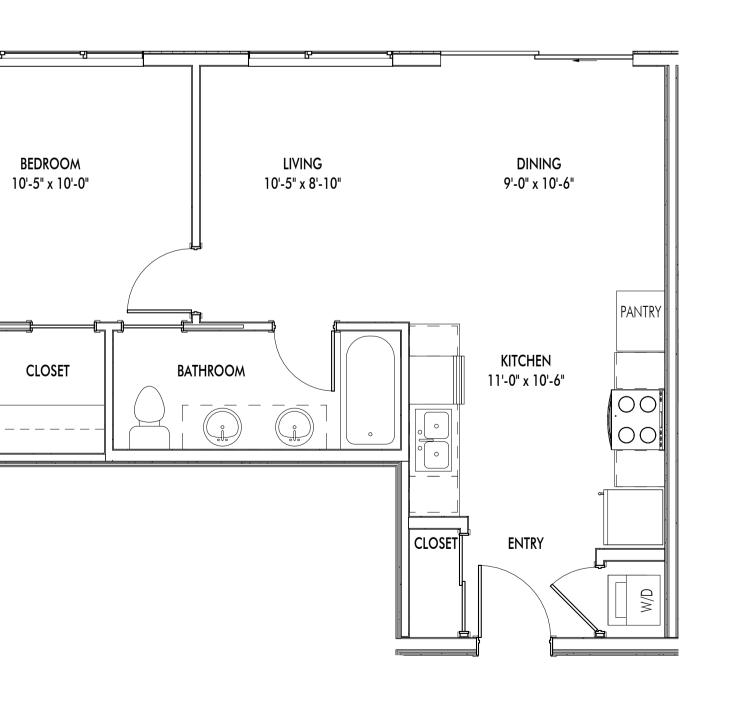
Planner


Initials

This forms part of application




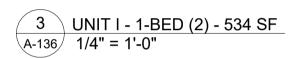

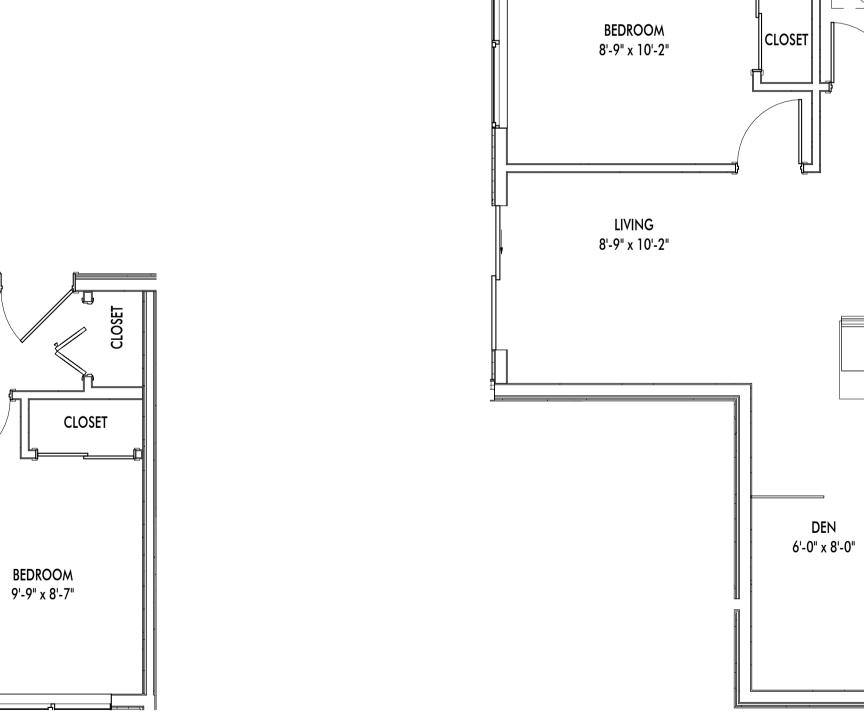

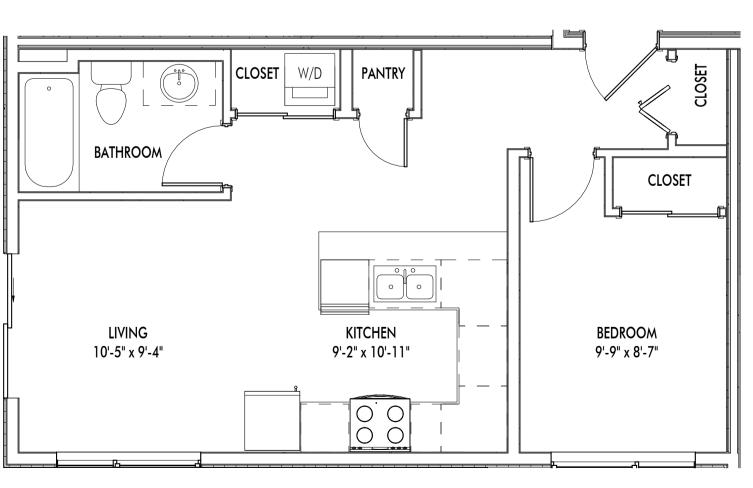

6 UNIT L - 1-BED + DEN - 581 SF A-136 1/4" = 1'-0"

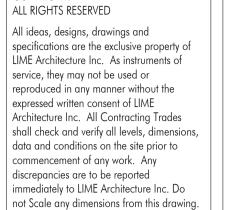

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# Revision No., Date and Description

11.15.22 SCHEMATICS
12.09.22 SCHEMATICS
01.06.23 SCHEMATICS
02.08.23 SCHEMATICS
02.25.23 FOR DP
03.06.23 FOR DP

03.06.23 FOR DP 03.17.21 FOR DP 03.29.23 FOR REVIEW

03.30.23 ADDENDUM NO.1 04.14.23 ADDENDUM NO.2 05.03.23 25% BP REVIEW

05.31.23 50% BP REVIEW
06.26.23 FOR COORDINATION
07.07.23 75% BP REVIEW

07.14.23 ADDENDUM NO.4


Plot Date 07.14.23 PROJECT


Revo (Collinson Rise)

DRAWING TITLE


TYPICAL UNIT LAYOUTS

Drawing No.

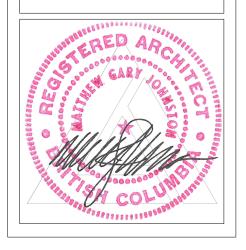


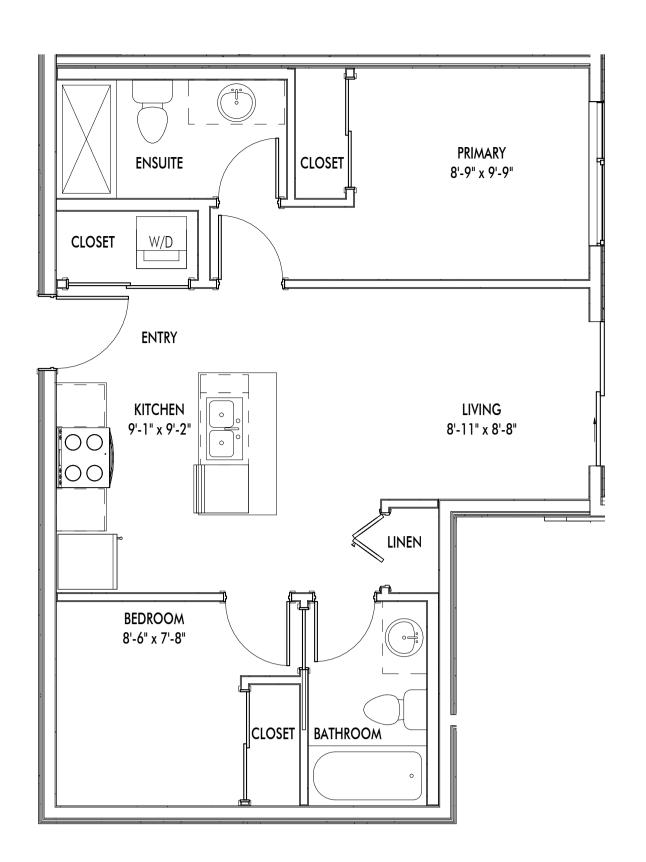


1 UNIT M - JUNIOR 2-BED (1) - 631 SF A-137 1/4" = 1'-0"

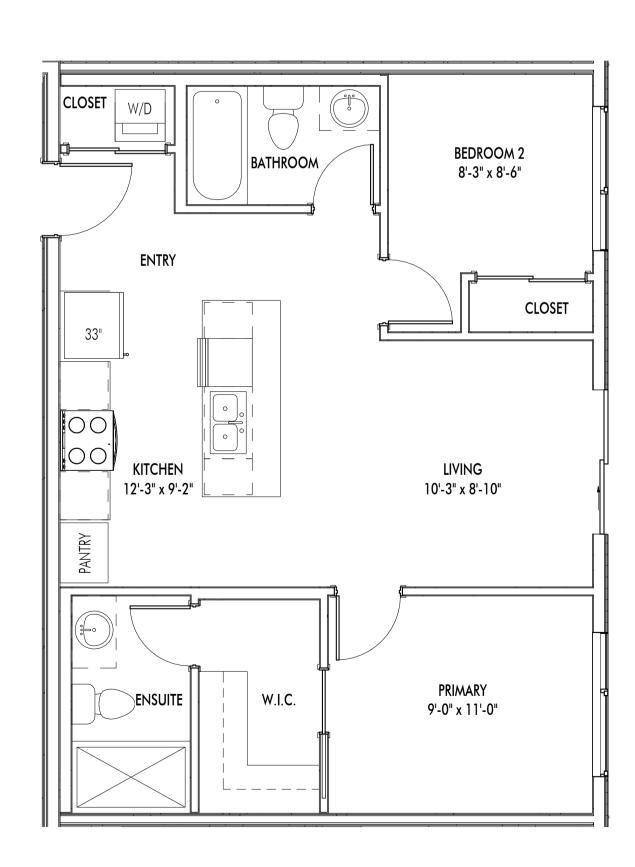


4 UNIT P - 2-BED (1) - 706 SF 1/4" = 1'-0"

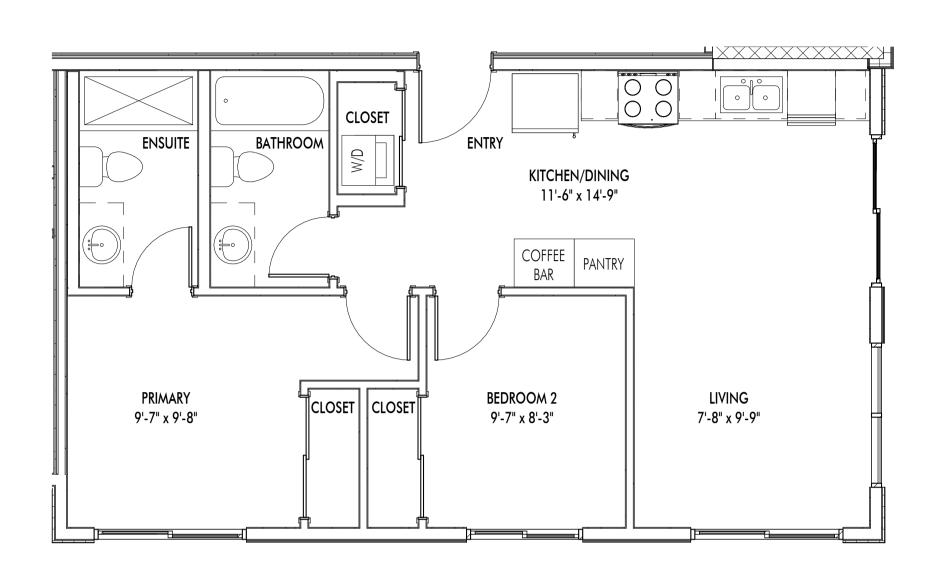

2 UNIT N - JUNIOR 2-BED (2) - 652 SF A-137 1/4" = 1'-0"

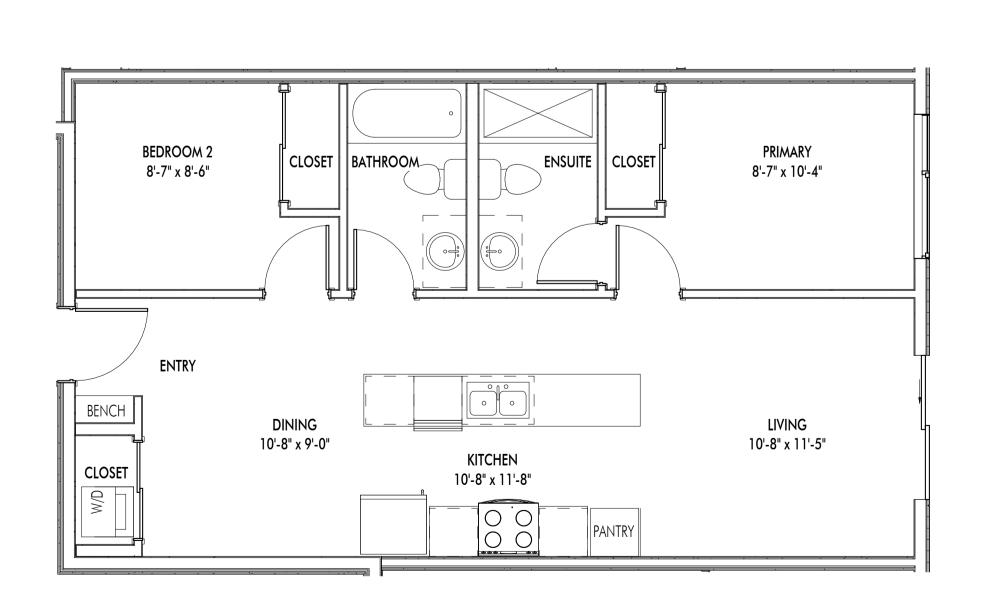


5 UNIT Q - 2-BED (2)- 715 SF A-137 1/4" = 1'-0"

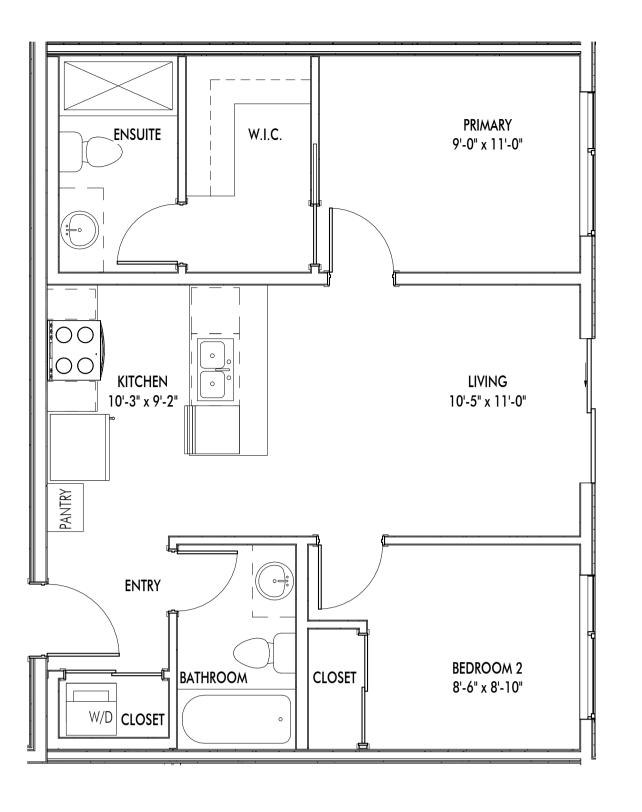

3 UNIT O - JUNIOR 2-BED (3) - 663 SF A-137 1/4" = 1'-0"



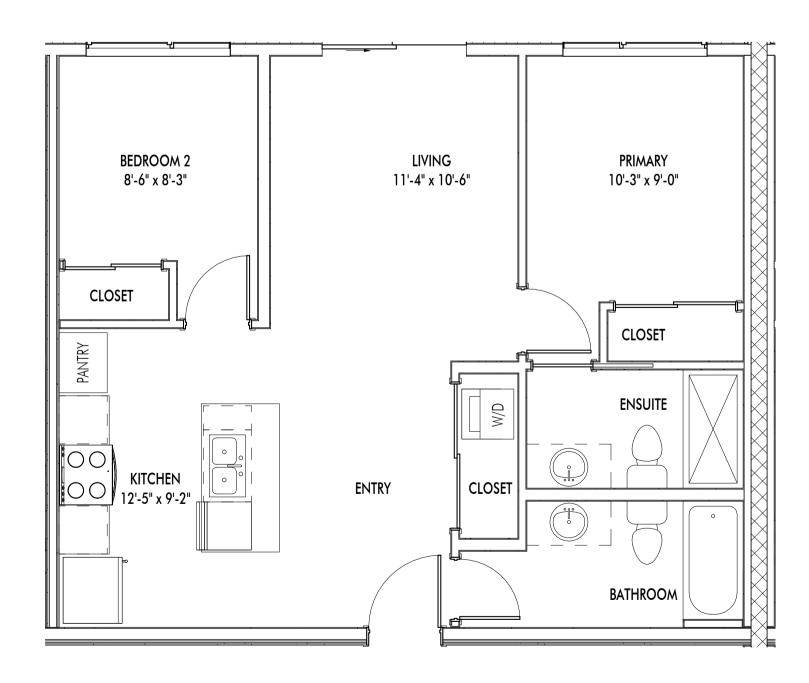

6 UNIT R - 2-BED (3) - 710 SF A-137 1/4" = 1'-0"



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#### Revision No., Date

and Description
11.15.22 SCHEMATICS
12.09.22 SCHEMATICS
01.06.23 SCHEMATICS
02.08.23 SCHEMATICS
02.25.23 FOR DP

02.08.23 SCHEMATICS 02.25.23 FOR DP 03.06.23 FOR DP 03.17.21 FOR DP

03.17.21 FOR DP 05.03.23 25% BP REVIEW 05.31.23 50% BP REVIEW 06.26.23 FOR COORDINATION 07.07.23 75% BP REVIEW

07.07.23 75% BP REVIEW 07.14.23 ADDENDUM NO.4

Plot Date
07.14.23

PROJECT
Revo (Collinson Rise)


DRAWING TITLE


TYPICAL UNIT

Drawing No.


A-137

LAYOUTS

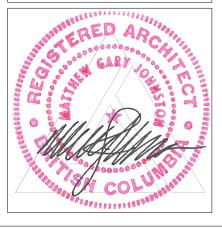


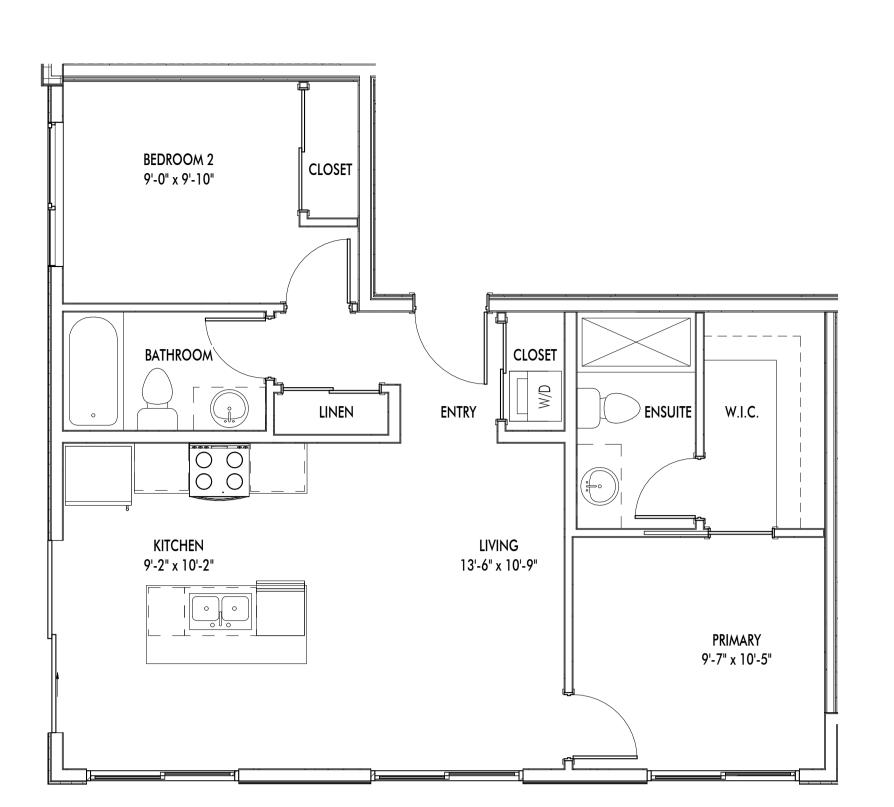


1 UNIT S - 2-BED (4) - 740 SF A-138 1/4" = 1'-0"

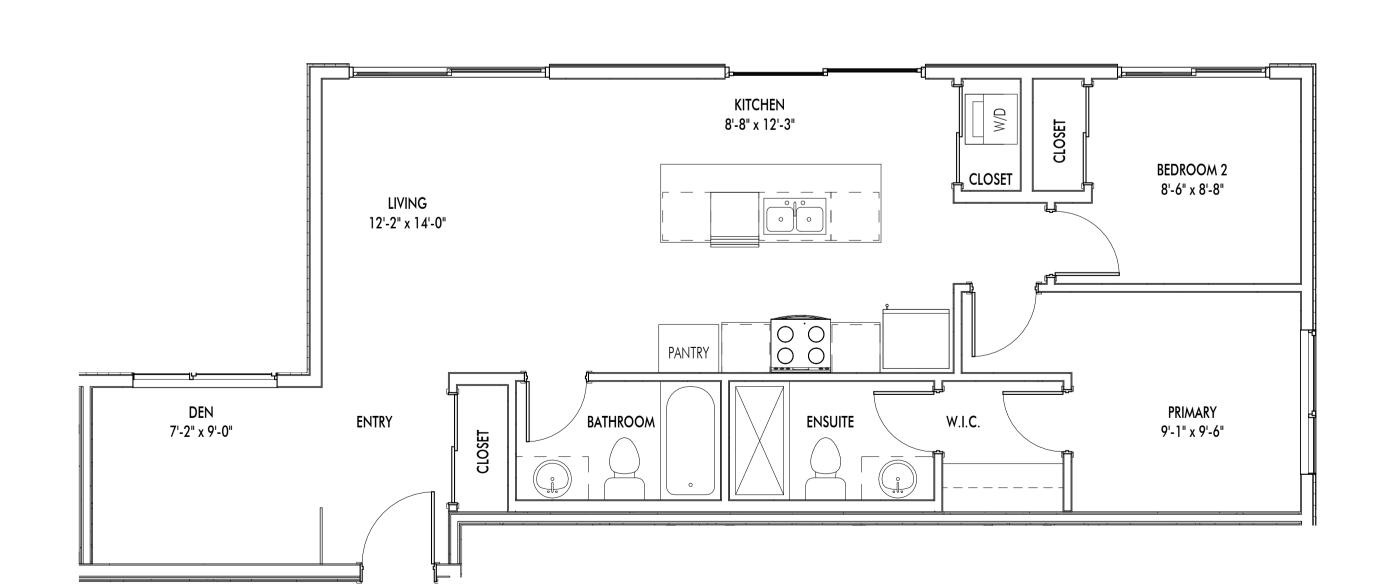

3 UNIT U - 2-BED + DEN (1) - 829 SF A-138 1/4" = 1'-0"

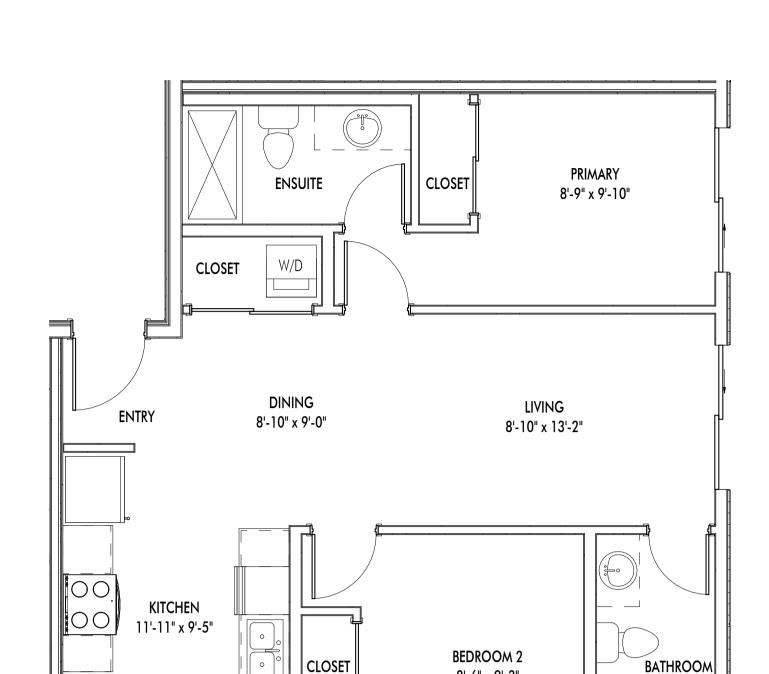

2 UNIT T - 2-BED (5) - 695 SF A-138 1/4" = 1'-0"

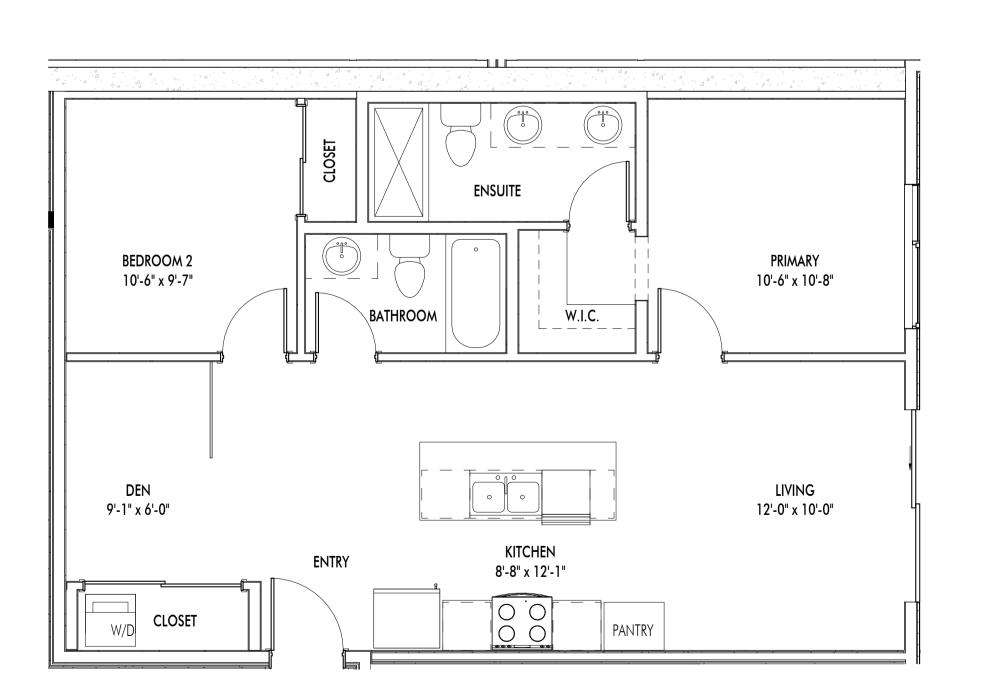

8'-6" x 9'-3"

4 UNIT V - 2-BED + DEN (2) - 854 SF A-138 1/4" = 1'-0"



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#### **Revision No., Date**

and Description 11.15.22 SCHEMATICS 12.09.22 SCHEMATICS 01.06.23 SCHEMATICS 02.08.23 SCHEMATICS 02.25.23 FOR DP 03.06.23 FOR DP

03.17.21 FOR DP 03.29.23 FOR REVIEW 03.30.23 ADDENDUM NO.1 04.14.23 ADDENDUM NO.2

05.03.23 25% BP REVIEW 05.31.23 50% BP REVIEW 06.26.23 FOR COORDINATION

07.07.23 75% BP REVIEW


07.14.23 ADDENDUM NO.4

Plot Date 07.14.23

PROJECT Revo (Collinson Rise)

DRAWING TITLE

TYPICAL UNIT LAYOUTS

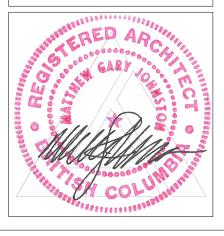



Planner Initials



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connections, including (but not limited to) water, sewer, gas, hydro and telephone.

**Revision No., Date** and Description 02.08.23 SCHEMATICS


05.03.23 25% BP REVIEW 05.31.23 50% BP REVIEW

07.07.23 75% BP REVIEW


07.14.23 ADDENDUM NO.4

06.26.23 FOR COORDINATION


02.25.23 FOR DP 03.06.23 FOR DP 03.17.21 FOR DP

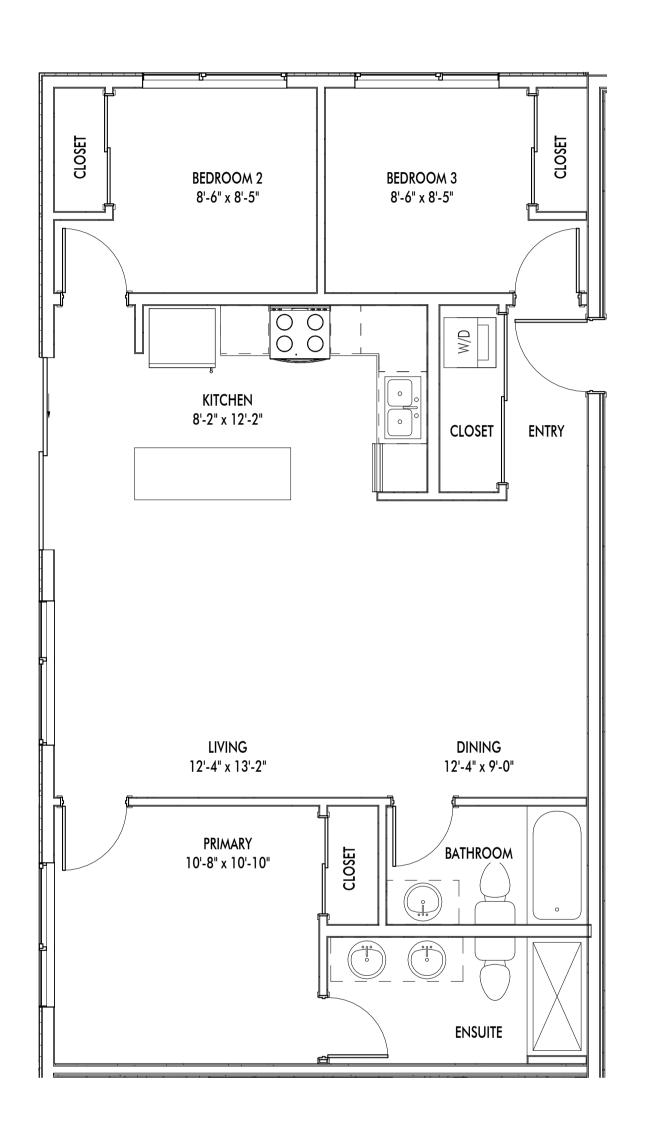

1 UNIT W - 3-BED - 921 SF A-139 1/4" = 1'-0"

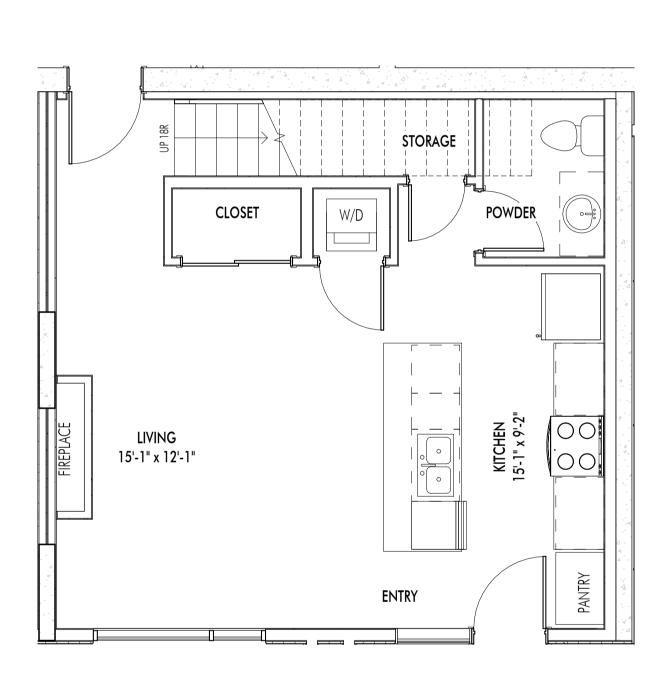

2 UNIT X - TOWNHOUSE - ENTRY - 529 SF A-139 1/4" = 1'-0"

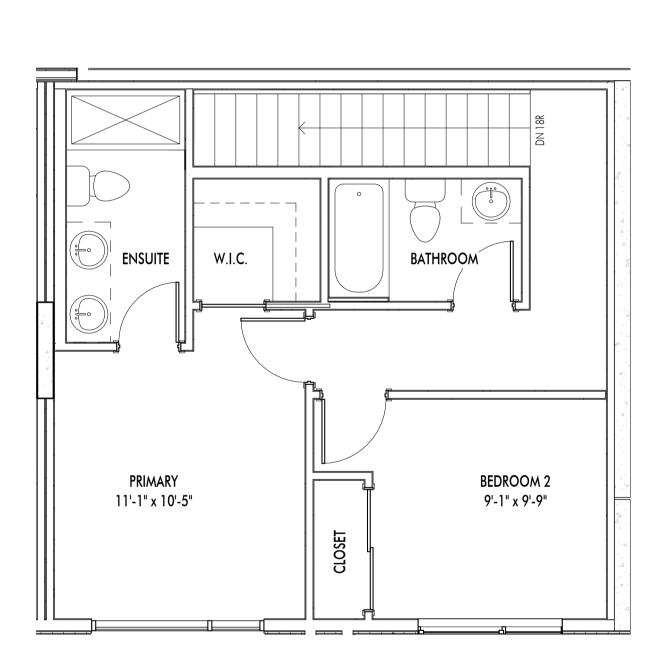


3 UNIT X - TOWNHOUSE - SECOND LEVEL - 475 SF A-139 1/4" = 1'-0"


Plot Date 07.14.23

PROJECT


Revo (Collinson Rise) DRAWING TITLE

TYPICAL UNIT LAYOUTS

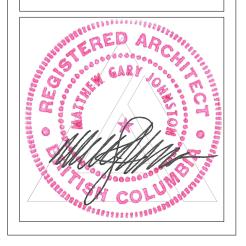

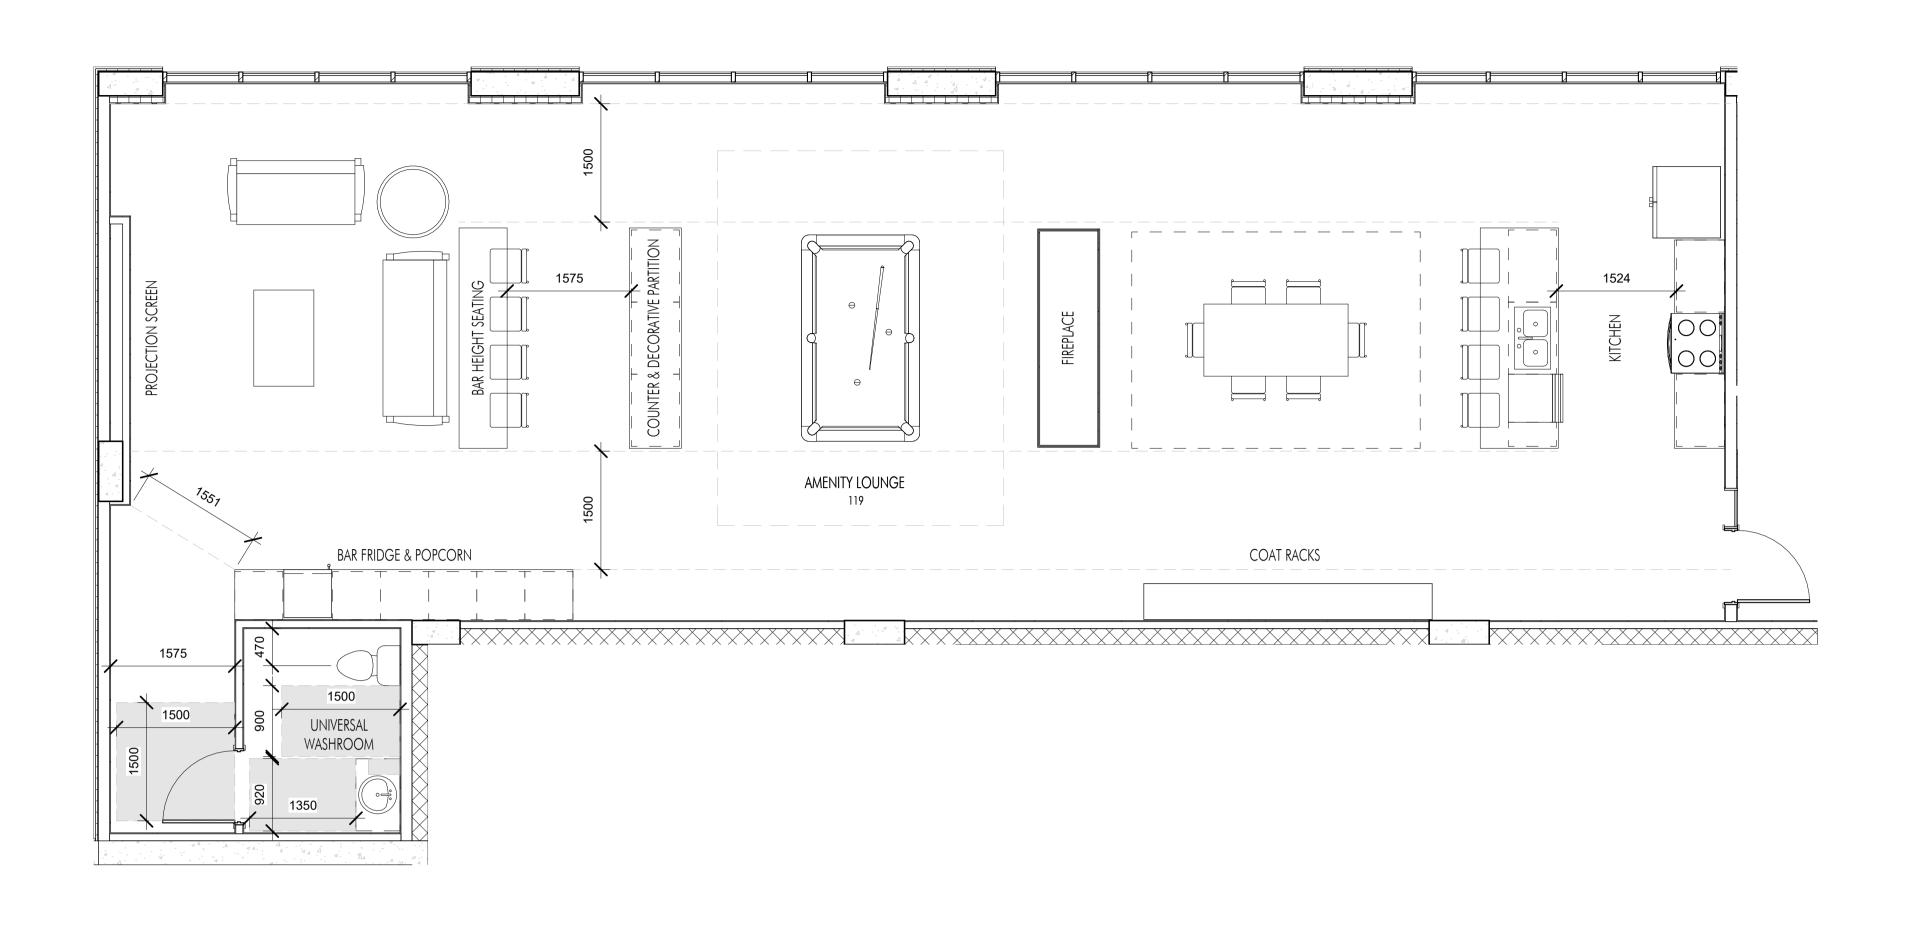

1 LEVEL 1 NORTH AMENITY SPACE - LOUNGE A-140 1/4" = 1'-0"

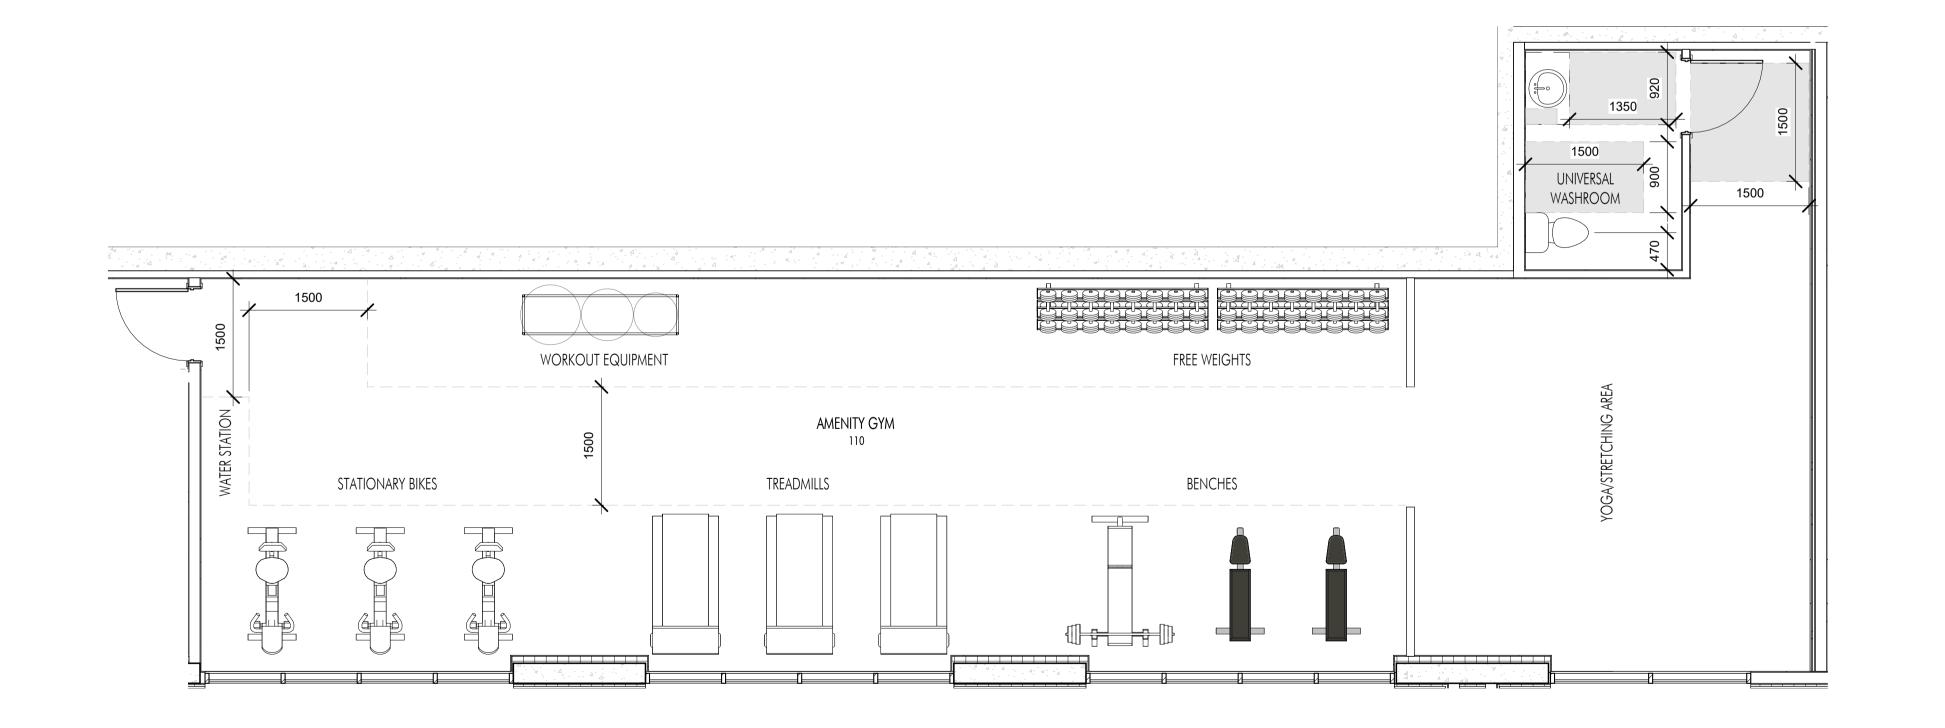

2 LEVEL 1 SOUTH AMENITY SPACE - GYM
A-140 1/4" = 1'-0"



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Revision No., Date and Description

07.07.23 75% BP REVIEW 07.14.23 ADDENDUM NO.4


97.14.23


PROJECT
Revo (Collinson Rise)

DRAWING TITLE

AMENITY SPACE PLANS

Drawing No.

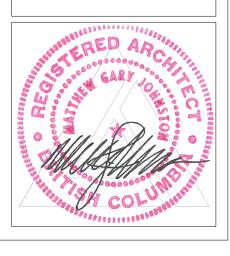

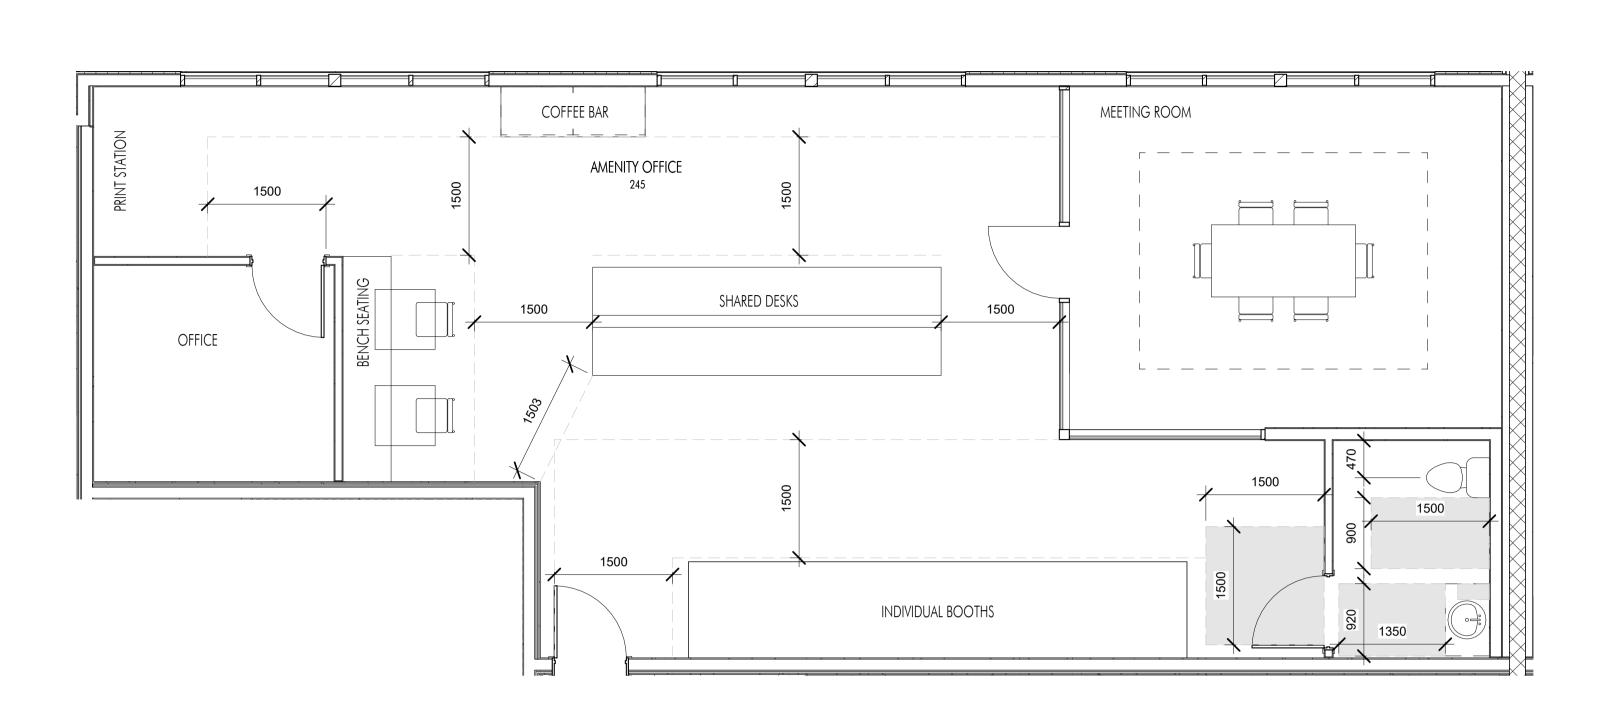

1 LEVEL 2 NORTH AMENITY SPACE - OFFICE A-141 1/4" = 1'-0"

SCHEDULE This forms part of application

# DP23-0084

Planner Initials KB

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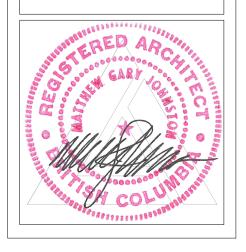
Revision No., Date and Description

07.07.23 75% BP REVIEW 07.14.23 ADDENDUM NO.4

07.14.23

Revo (Collinson Rise) DRAWING TITLE

AMENITY SPACE PLANS







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03.06.23 FOR DP
03.17.21 FOR DP
05.03.23 25% BP REVIEW
05.31.23 50% BP REVIEW
07.07.23 75% BP REVIEW
07.14.23 ADDENDUM NO.4

**Plot Date** 07.14.23

PROJECT
Revo (Collinson Rise)


DRAWING TITLE

NORTH ELEVATION

Drawing No.





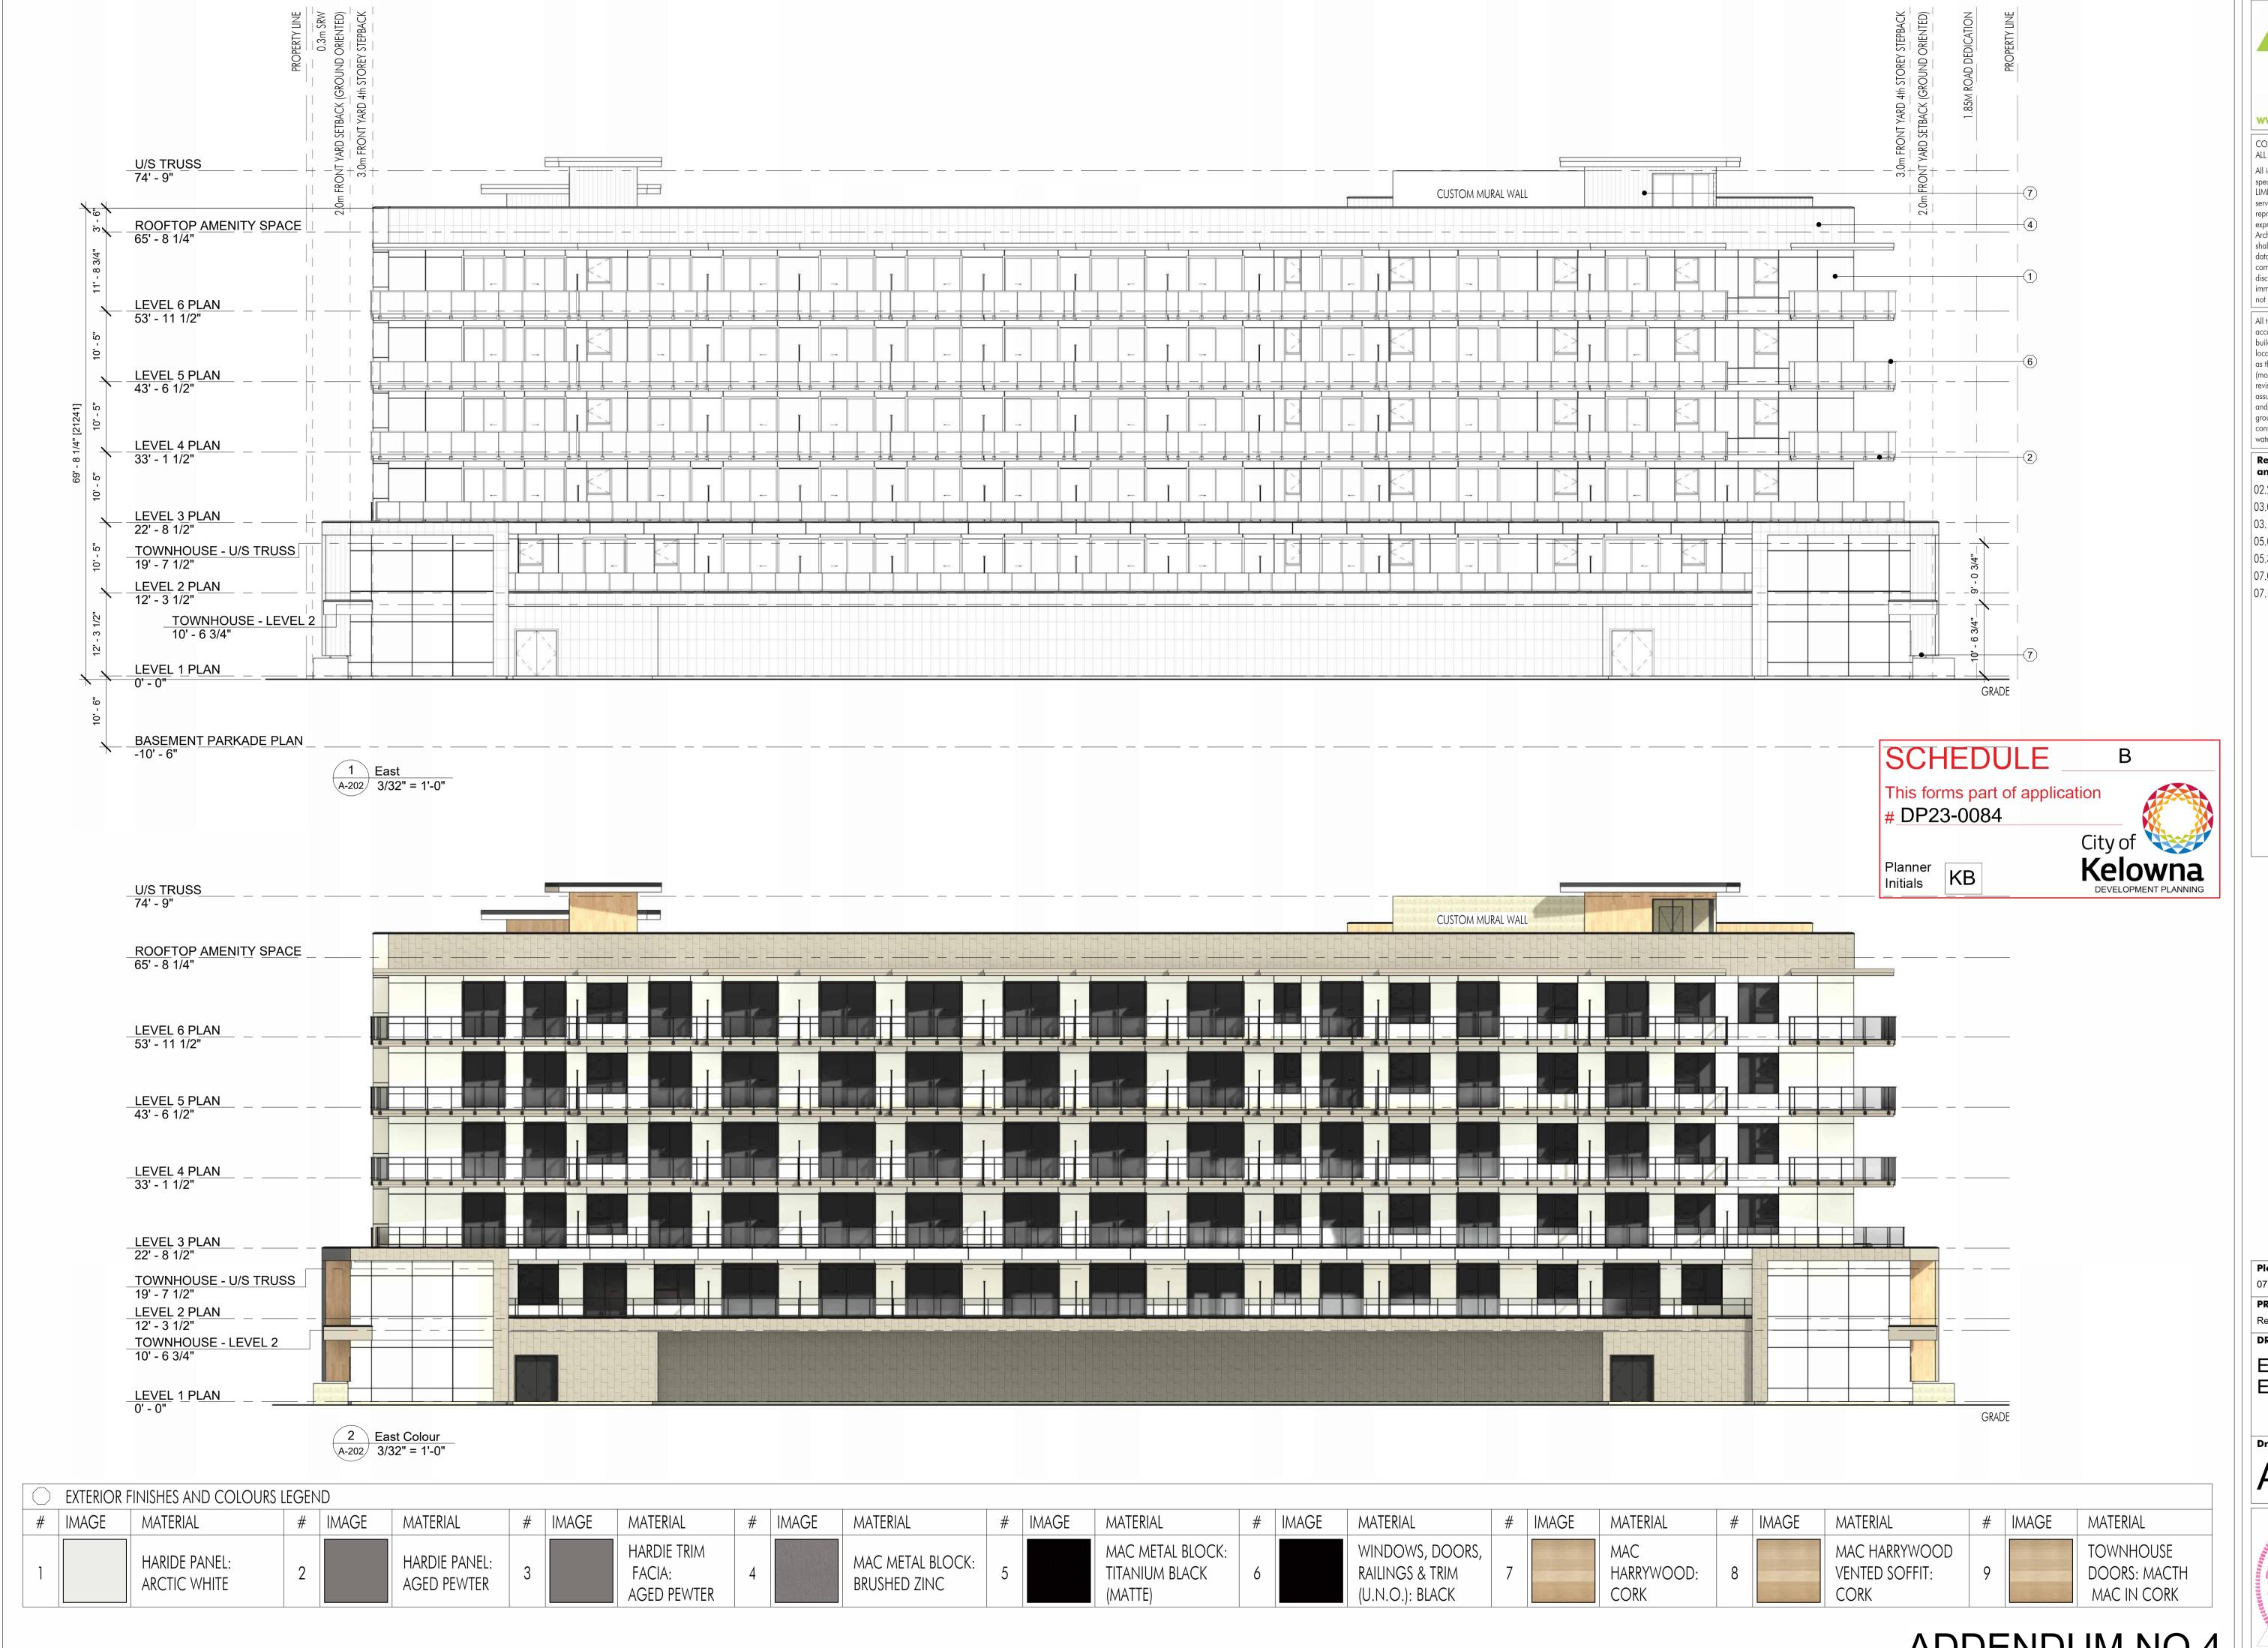

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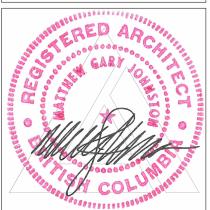
**Plot Date** 07.14.23


> **PROJECT** Revo (Collinson Rise)


**DRAWING TITLE** 

EAST **ELEVATION** 

Drawing No.



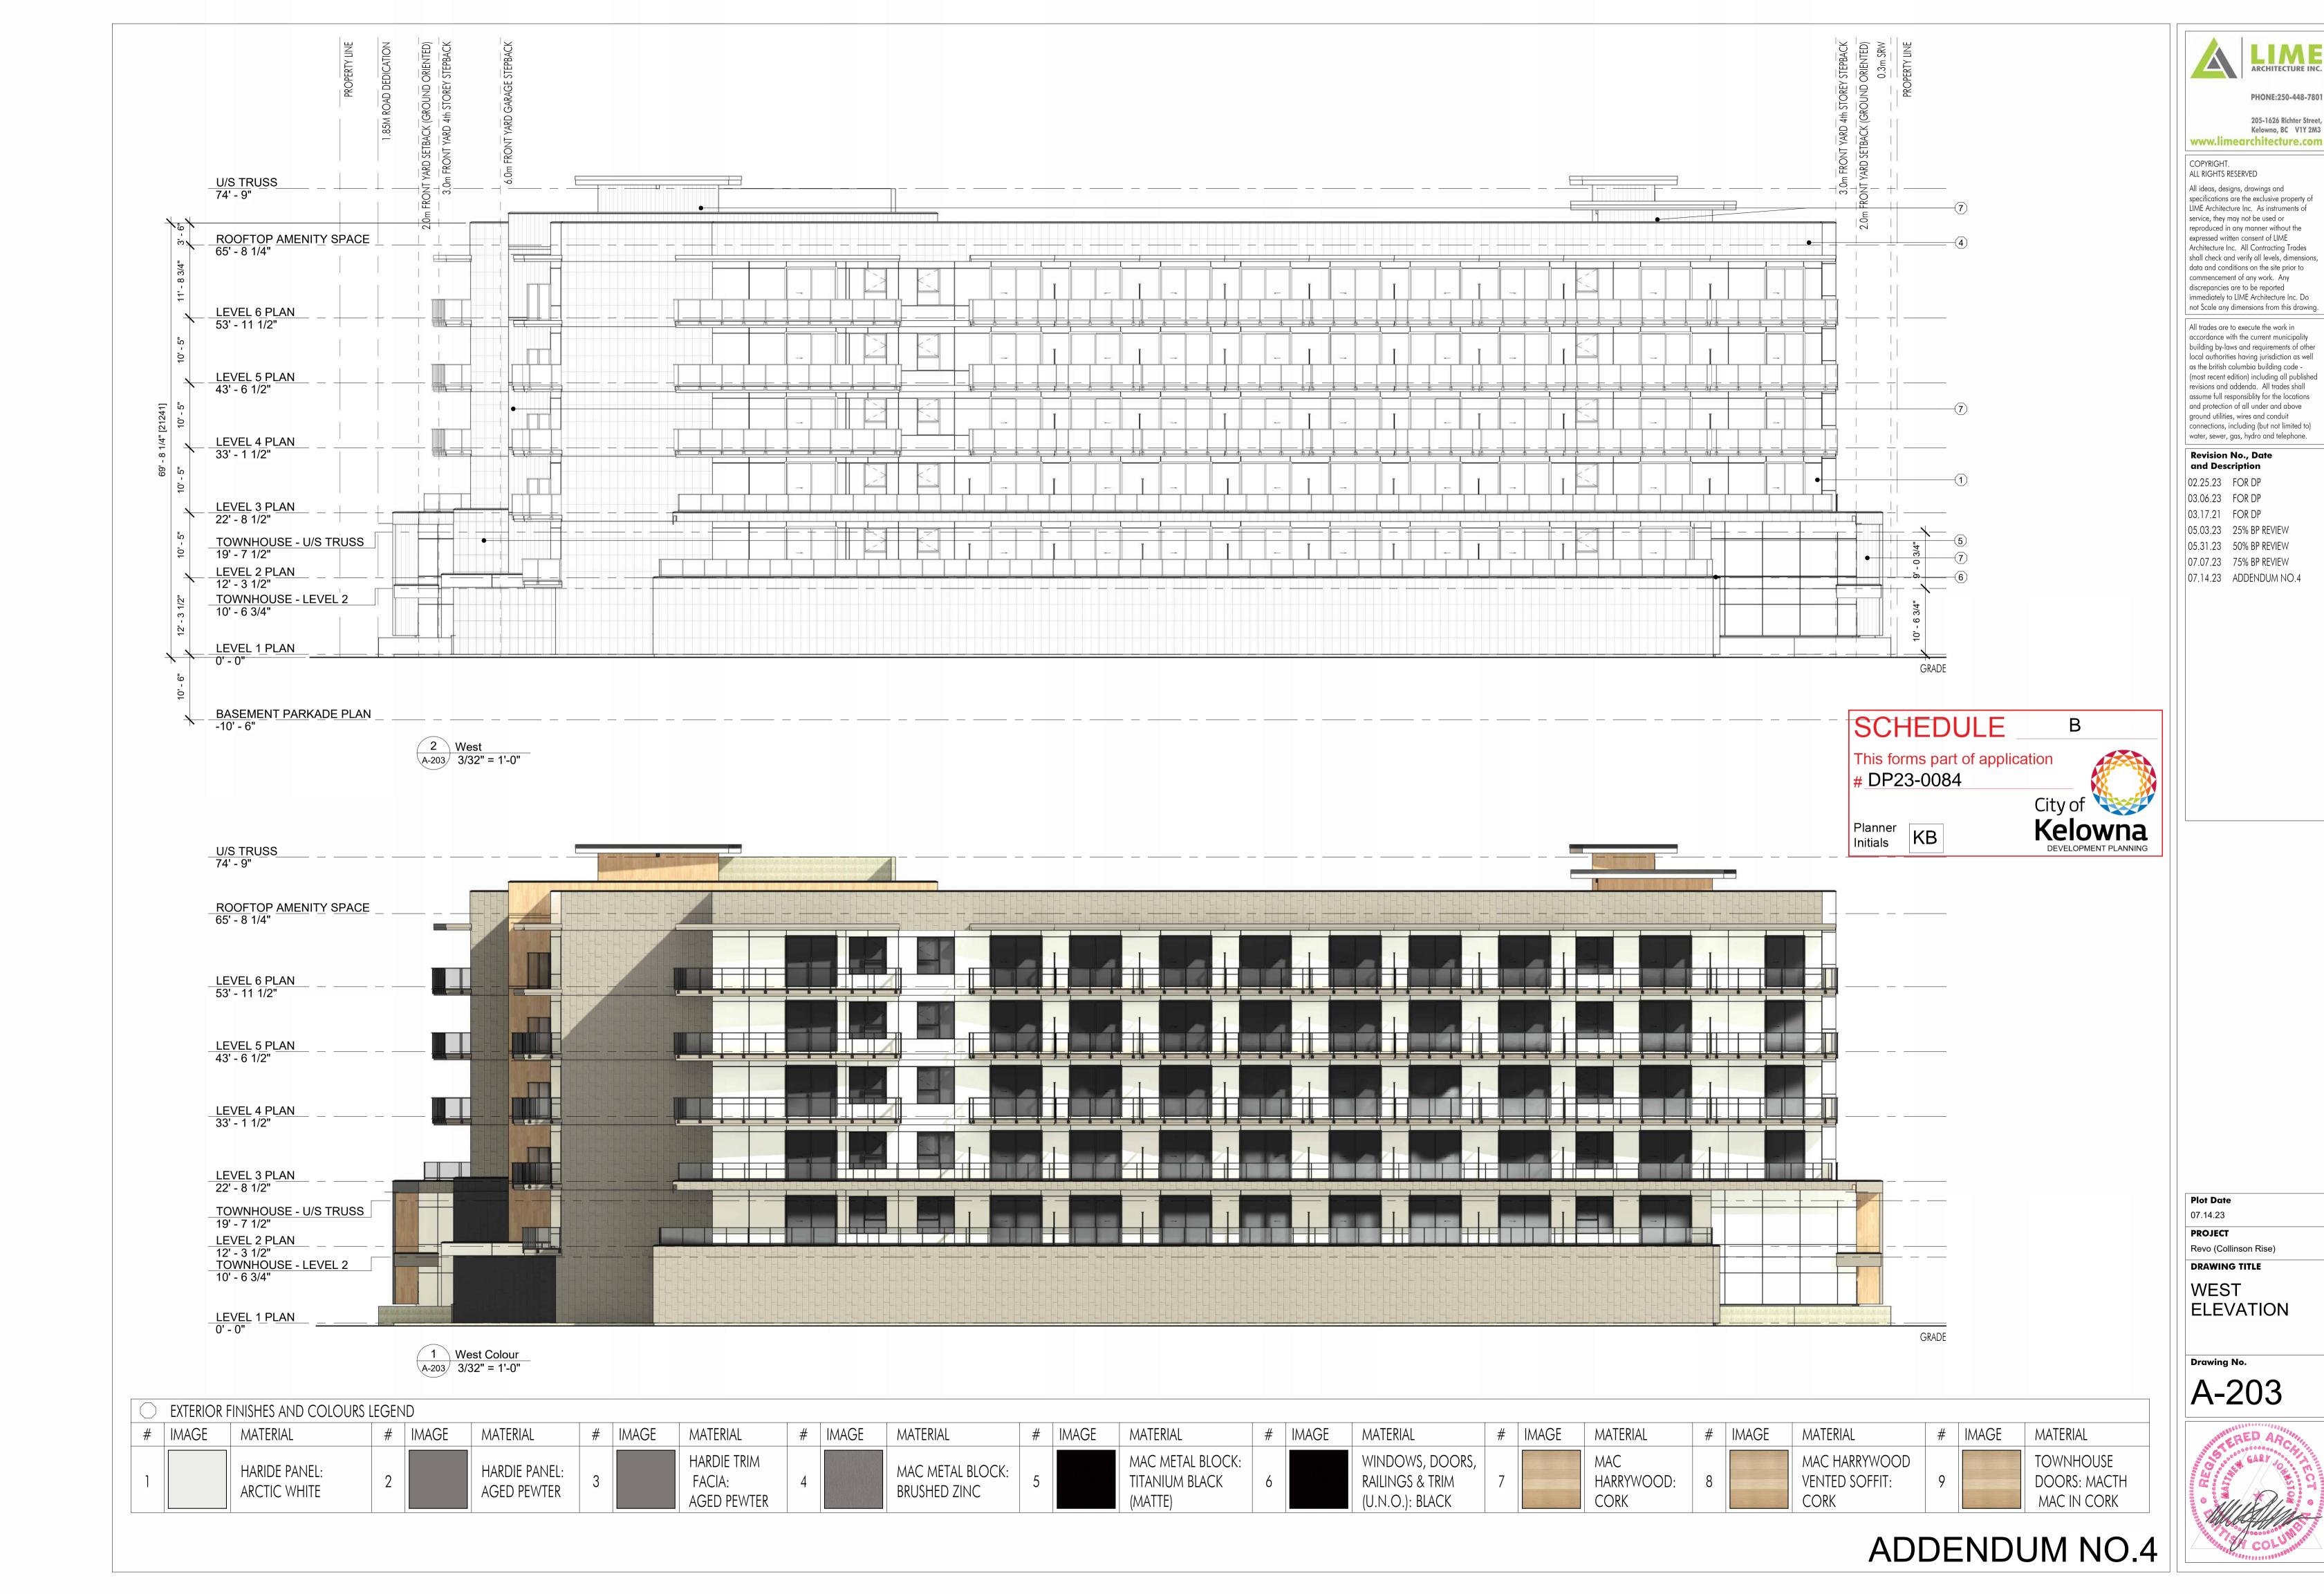

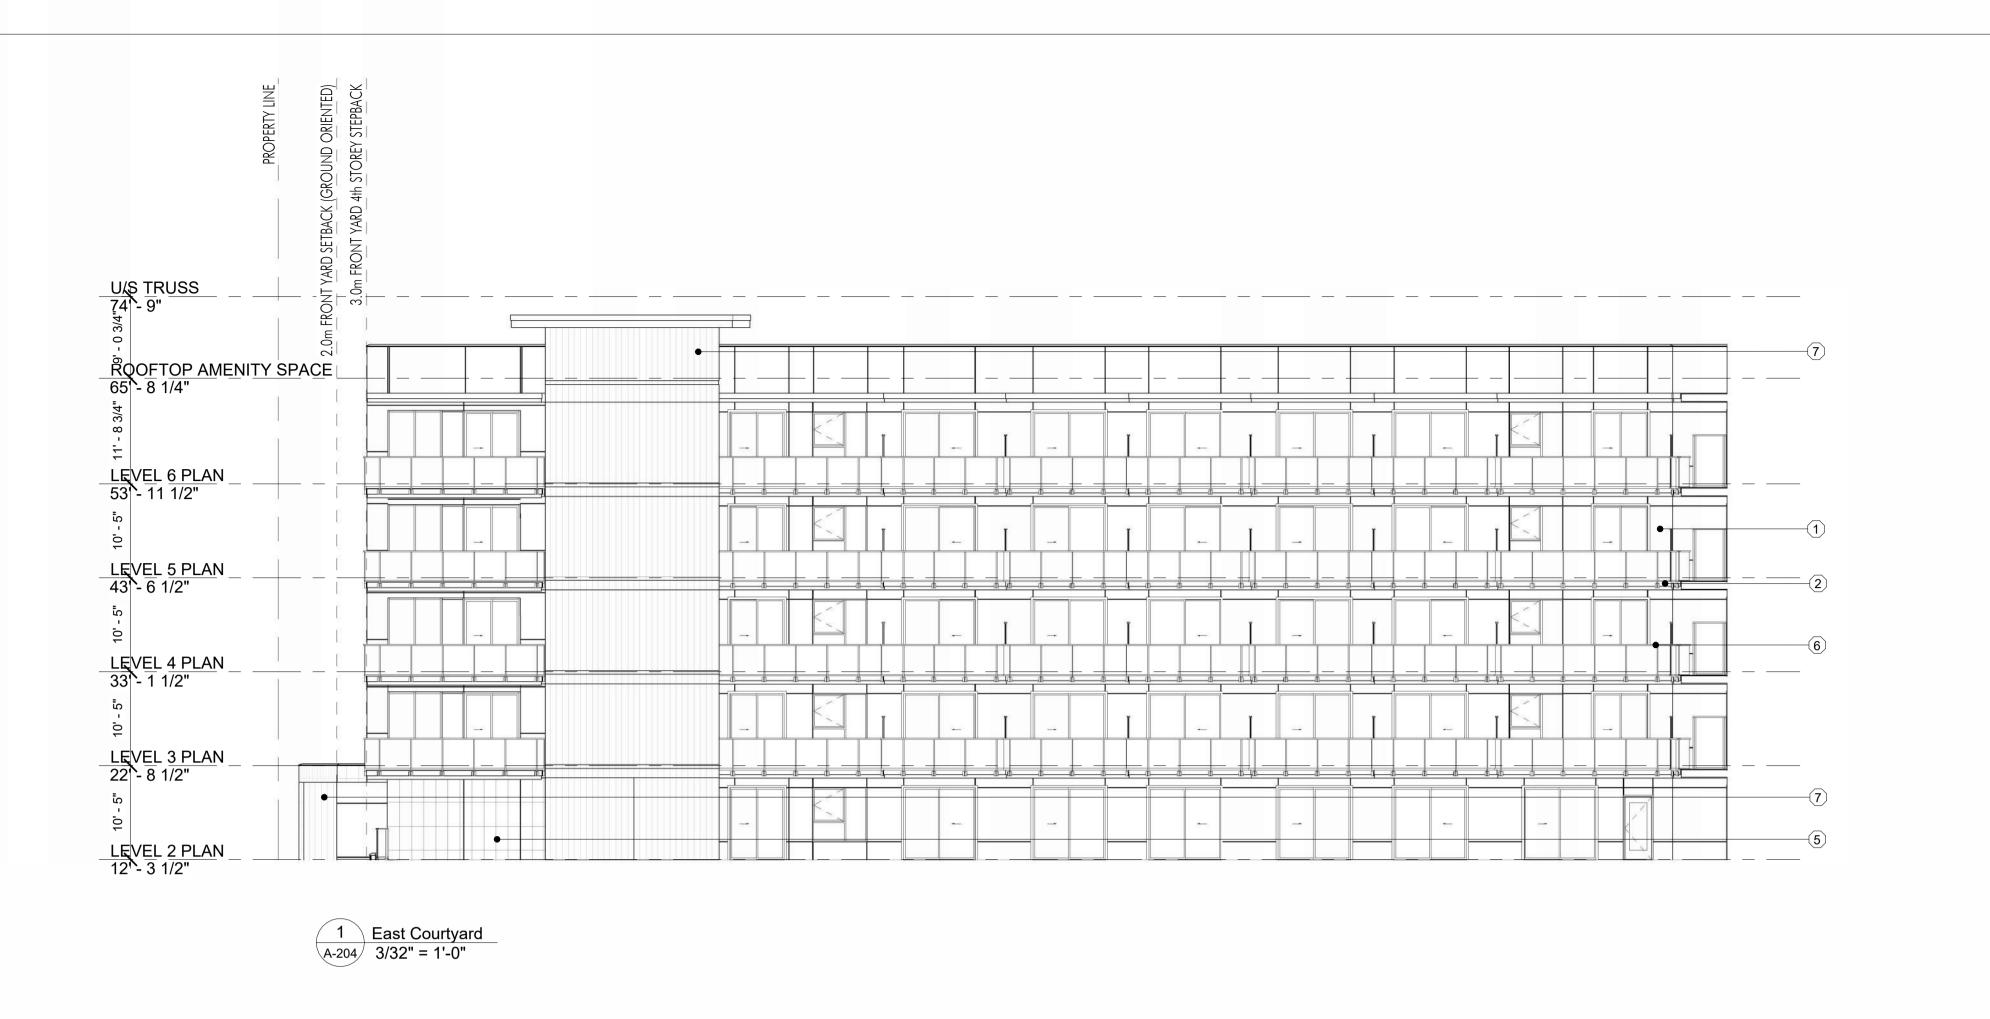



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1	HARIDE PANEL: ARCTIC WHITE	2	HARDIE PANEL: AGED PEWTER	3	HARDIE TRIM FACIA: AGED PEWTER	4		MAC METAL BLOCK: BRUSHED ZINC	5		MAC METAL BLOCK: TITANIUM BLACK (MATTE)	6		WINDOWS, DOORS, RAILINGS & TRIM (U.N.O.): BLACK	7		MAC HARRYWOOD: CORK	8		MAC HARRYWOOD VENTED SOFFIT: CORK	9		TOWNHOUSE DOORS: MACTH MAC IN CORK

SCHEDULE

This forms part of application

# DP23-0084

City of

Planner Initials

KB

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 FOR DP

 03.06.23
 FOR DP

 03.17.21
 FOR DP

 05.03.23
 25% BP REVIEW

 05.31.23
 50% BP REVIEW

 07.07.23
 75% BP REVIEW


 07.14.23
 ADDENDUM NO.4


**Plot Date** 07.14.23

PROJECT
Revo (Collinson Rise)

COURTYARD ELEVATION

rawing No.

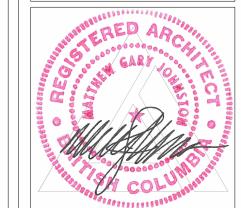

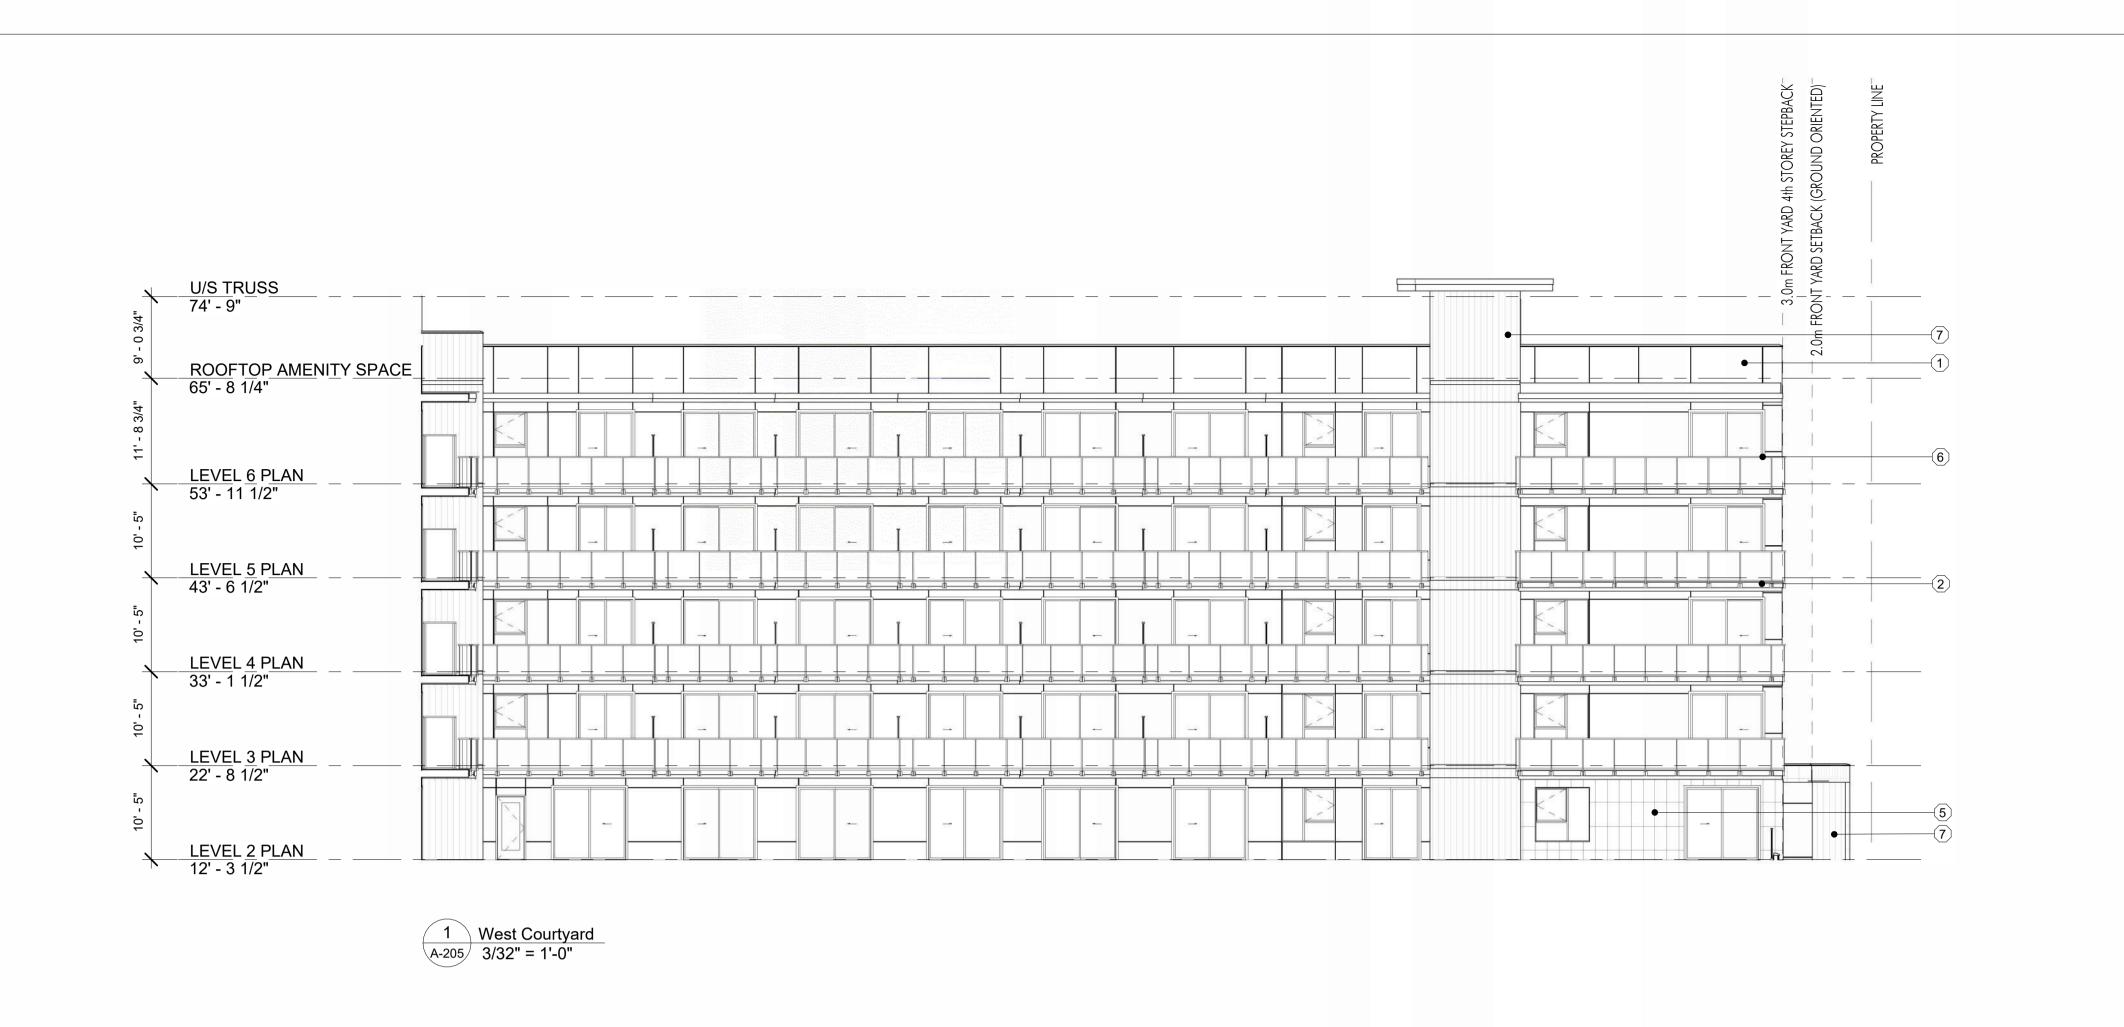



EXTERIOR F	EXTERIOR FINISHES AND COLOURS LEGEND																						
# IMAGE	MATERIAL	# IMAGE	MATERIAL	# IMAGE	MATERIAL	#	IMAGE	MATERIAL	#	IMAGE	MATERIAL	#	IMAGE	MATERIAL	#	IMAGE	MATERIAL	#	IMAGE	MATERIAL	#	IMAGE	MATERIAL
1	HARIDE PANEL: ARCTIC WHITE	2	HARDIE PANEL: AGED PEWTER	3	HARDIE TRIM FACIA: AGED PEWTER	4		MAC METAL BLOCK: BRUSHED ZINC	5		MAC METAL BLOCK: TITANIUM BLACK (MATTE)	6		WINDOWS, DOORS, RAILINGS & TRIM (U.N.O.): BLACK	7		MAC HARRYWOOD: CORK	8		MAC HARRYWOOD VENTED SOFFIT: CORK	9		TOWNHOUSE DOORS: MACTH MAC IN CORK



SCHEDULE

# DP23-0084

Planner Initials

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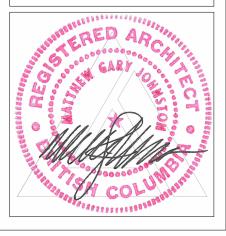
**Plot Date** 07.14.23

PROJECT
Revo (Collinson Rise)

DRAWING TITLE

COURTYARD ELEVATION

rawing No.





#### DOG RUN



## **COMMUNITY GARDEN PLOT**

#### **NOTES**

1. PLANT MATERIAL AND CONSTRUCTION METHODS SHALL MEET OR EXCEED CANDAIAN LANDSCAPE STANDARDS. ALL OFFSITE LANDSCAPE WORKS TO MEET CITY OF KELOWNA BYLAW 12375 STANDARDS.

2. ALL SOFT LANDSCAPE AREAS SHALL BE WATERED BY A FULLY AUTOMATIC TIMED UNDERGROUND IRRIGATION SYSTEM.

3. TREE AND SHRUB BEDS TO BE DRESSED IN A MINIMUM 75mm NATURAL WOOD MULCH AS SHOWN IN PLANS. DO NOT PLACE WEED MAT UNDERNEATH TREE AND SHRUB BEDS

4. SHRUB BEDS TO RECEIVE A MINIMUM 300mm DEPTH TOPSOIL PLACEMENT. TREE BEDS TO RECEIVE A MINIMUM 1000mm DEPTH TOPSOIL PLACEMENT. SMALL TREE BEDS TO RECEIVE 1500mm DEPTH TOPSOIL PLACEMENT TO ACHIEVE SOIL VOLUME PER TREE REQUIREMENTS.

5. TURF AREA FROM SOD SHALL BE NO.1 GRADE GROWN FROM CERTIFIED SEED OF IMPROVED CULTIVARS REGISTERED FOR SALE IN B.C. AND SHALL BE TOLERANT OF DROUGHT CONDITIONS. A MINIMUM OF 150mm DEPTH OF GROWING MEDIUM IS REQUIRED BENEATH TURF AREAS. TURF AREAS SHALL MEET EXISTING GRADES AND HARD SURFACES FLUSH.

6. SITE GRADING AND DRAINAGE WILL ENSURE THAT ALL STRUCTURES HAVE POSITIVE DRAINAGE AND THAT NO WATER OR LOOSE IMPEDIMENTS WILL BE DISCHARGED FROM THE LOT ONTO ADJACENT PUBLIC, COMMON, OR PRIVATE PROPERTIES.

7. SOIL CELLS WITH FULL DEPTH GROWING MEDIUM UNDER ALL HARDSCAPE AND CRUSHER FINES PAVING IN SETBACK.

ACHILLEA MILLEFOLIUM 'TERRACOTTA'

ATHYRIUM FILIX-FEMINA 'LADY IN RED'

ECHINACEA PURPUREA 'SOLAR FLARE'

RUDBECKIA FULGIDA 'GOLDSTURM'

SEDUM SPECTABILE 'AUTUMN JOY'

SPOROBOLUS HETEROLEPIS

TIARELLA CORDIFOLIA

CALAMAGROSTIS ACUTIFLORA 'KARL FOERSTER'

#### **PLANT LIST BOTANICAL NAME** COMMON NAME QTY SIZE/SPACING & REMARKS ACER RUBRUM 'ARMSTRONG' ARMSTRONG MAPLE 4 5cm CAL. AMELANCHIER X GRANDIFLORA 'AUTUMN BRILLIANCE' AUTUMN BRILLIANCE SERVICEBERRY 4 3cm CAL. BETULA OCCIDENTALIS RIVER BIRCH 10 4cm CAL. CARPINUS CAROLINIANA AMERICAN HORNBEAM 4 4cm CAL. CERCIDIPHYLLUM JAPONICUM Katsura Tree 3 5cm CAL. SYRINGA RETICULATA 'IVORY SILK' IVORY SILK TREE LILAC 10 3cm CAL. SHRUBS ARCTOSTAPHYLOS UVA-URSI 196 #02 CONT. /0.6M O.C. SPACING KINNIKINNICK 149 #02 CONT. /1.2M O.C. SPACING BUXUS 'GREEN VELVET' GREEN VELVET BOXWOOD 43 #02 CONT. /1.3M O.C. SPACING MAHONIA AQUIFOLIUM OREGON GRAPE HOLLY rosa 'radcon' RAINBOW KNOCKOUT ROSE 71 #02 CONT. /1.0M O.C. SPACING 279 #02 CONT. /1.0M O.C. SPACING TAXUS MEDIA 'TAUTONII' TAUTON YEW 31 #02 CONT. /1.5M O.C. SPACING VIBURNUM TRILOBUM 'COMPACTUM' COMPACT CRANBERRY PERENNIALS, GRASSES & GROUNDCOVERS

TERRACOTTA YARROW

SOLAR FLARE CONEFLOWER

GOLDSTURM CONEFLOWER

AUTUMN JOY STONECROP

LADY IN RED FERN

PRAIRIE DROPSEED

FOAMFLOWER

114 #01 CONT. /0.6M O.C. SPACING

51 #01 CONT. /0.9M O.C. SPACING

114 #01 CONT. /0.6M O.C. SPACING

114 #01 CONT. /0.6M O.C. SPACING

114 #01 CONT. /0.6M O.C. SPACING

41 #01 CONT. /1.0M O.C. SPACING

114 #01 CONT. /0.6M O.C. SPACING

KARL FOESTER FEATHER REED GRASS 41 #01 CONT. /1.0M O.C. SPACING





200-2045 Enterprise Way Kelowna, BC V1Y 9T5 T (250) 469-9757 www.ecora.ca

SCHEDULE \_

This forms part of application # DP23-0084

Planner Initials KB





PROJECT TITLE

**COLLINSON RISE** 

Kelowna, BC

DRAWING TITLE

CONCEPTUAL LANDSCAPE PLAN - AT GRADE

ISSU	JED FOR / REVISION	
1	23.02.24	Review
2	23.03.02	Review
3	23.03.17	Review
4	23.04.13	Review
5	23.07.17	Review

PROJECT NO	22-1201
DESIGN BY	AM
DRAWN BY	TR
CHECKED BY	AM
DATE	JULY 17, 2023
SCALE	1:150
PAGE SIZE	24"x36"

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drawing number

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LS-101

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#### ROOFTOP SEATING AREAS



### **RIVER BIRCH BOSQUE**

#### **NOTES**

1. PLANT MATERIAL AND CONSTRUCTION METHODS SHALL MEET OR EXCEED CANDAIAN LANDSCAPE STANDARDS. ALL OFFSITE LANDSCAPE WORKS TO MEET CITY OF KELOWNA BYLAW 12375 STANDARDS.

2. ALL SOFT LANDSCAPE AREAS SHALL BE WATERED BY A FULLY AUTOMATIC TIMED UNDERGROUND IRRIGATION SYSTEM.

3. TREE AND SHRUB BEDS TO BE DRESSED IN A MINIMUM 75mm NATURAL WOOD MULCH AS SHOWN IN PLANS. DO NOT PLACE WEED MAT UNDERNEATH TREE AND SHIPLING BEDS


4. SHRUB BEDS TO RECEIVE A MINIMUM 300mm DEPTH TOPSOIL PLACEMENT. TREE BEDS TO RECEIVE A MINIMUM 1000mm DEPTH TOPSOIL PLACEMENT. SMALL TREE BEDS TO RECEIVE 1500mm DEPTH TOPSOIL PLACEMENT TO ACHIEVE SOIL VOLUME PER TREE REQUIREMENTS.

5. TURF AREA FROM SOD SHALL BE NO.1 GRADE GROWN FROM CERTIFIED SEED OF IMPROVED CULTIVARS REGISTERED FOR SALE IN B.C. AND SHALL BE TOLERANT OF DROUGHT CONDITIONS. A MINIMUM OF 150mm DEPTH OF GROWING MEDIUM IS REQUIRED BENEATH TURF AREAS. TURF AREAS SHALL MEET EXISTING GRADES AND HARD SURFACES FLUSH.

6. SITE GRADING AND DRAINAGE WILL ENSURE THAT ALL STRUCTURES HAVE POSITIVE DRAINAGE AND THAT NO WATER OR LOOSE IMPEDIMENTS WILL BE DISCHARGED FROM THE LOT ONTO ADJACENT PUBLIC, COMMON, OR PRIVATE PROPERTIES.

7. SOIL CELLS WITH FULL DEPTH GROWING MEDIUM UNDER ALL HARDSCAPE AND CRUSHER FINES PAVING IN SETBACK.

BOTANICAL NAME	COMMON NAME	QTY	SIZE/SPACING & REMARKS
TREES			
ACER RUBRUM 'ARMSTRONG'	ARMSTRONG MAPLE	4	5cm CAL.
AMELANCHIER X GRANDIFLORA 'AUTUMN BRILLIANCE'	AUTUMN BRILLIANCE SERVICEBERRY	4	3cm CAL.
BETULA OCCIDENTALIS	RIVER BIRCH	10	4cm CAL.
CARPINUS CAROLINIANA	AMERICAN HORNBEAM	4	4cm CAL.
CERCIDIPHYLLUM JAPONICUM	Katsura Tree	3	5cm CAL.
Syringa reticulata 'Ivory Silk'	IVORY SILK TREE LILAC	10	3cm CAL.
SHRUBS			
ARCTOSTAPHYLOS UVA-URSI	KINNIKINNICK	196	#02 CONT. /0.6M O.C. SPACIN
BUXUS 'GREEN VELVET'	GREEN VELVET BOXWOOD	149	#02 CONT. /1.2M O.C. SPACIN
MAHONIA AQUIFOLIUM	OREGON GRAPE HOLLY	43	#02 CONT. /1.3M O.C. SPACIN
ROSA 'RADCON'	rainbow knockout rose	<i>7</i> 1	#02 CONT. /1.0M O.C. SPACIN
TAXUS MEDIA 'TAUTONII'	TAUTON YEW	279	#02 CONT. /1.0M O.C. SPACIN
VIBURNUM TRILOBUM 'COMPACTUM'	COMPACT CRANBERRY	31	#02 CONT. /1.5M O.C. SPACIN
PERENNIALS, GRASSES & GROUNDCOVERS			
ACHILLEA MILLEFOLIUM 'TERRACOTTA'	TERRACOTTA YARROW	114	#01 CONT. /0.6M O.C. SPACIN
ATHYRIUM FILIX-FEMINA 'LADY IN RED'	LADY IN RED FERN	51	#01 CONT. /0.9M O.C. SPACIN
CALAMAGROSTIS ACUTIFLORA 'KARL FOERSTER'	KARL FOESTER FEATHER REED GRASS	41	#01 CONT. /1.0M O.C. SPACIN
ECHINACEA PURPUREA 'SOLAR FLARE'	SOLAR FLARE CONEFLOWER	114	#01 CONT. /0.6M O.C. SPACIN
RUDBECKIA FULGIDA 'GOLDSTURM'	GOLDSTURM CONEFLOWER	114	#01 CONT. /0.6M O.C. SPACIN
SEDUM SPECTABILE 'AUTUMN JOY'	AUTUMN JOY STONECROP	114	#01 CONT. /0.6M O.C. SPACIN
SPOROBOLUS HETEROLEPIS	PRAIRIE DROPSEED	41	#01 CONT. /1.0M O.C. SPACIN
TIARELLA CORDIFOLIA	FOAMFLOWER	114	#01 CONT. /0.6M O.C. SPACIN

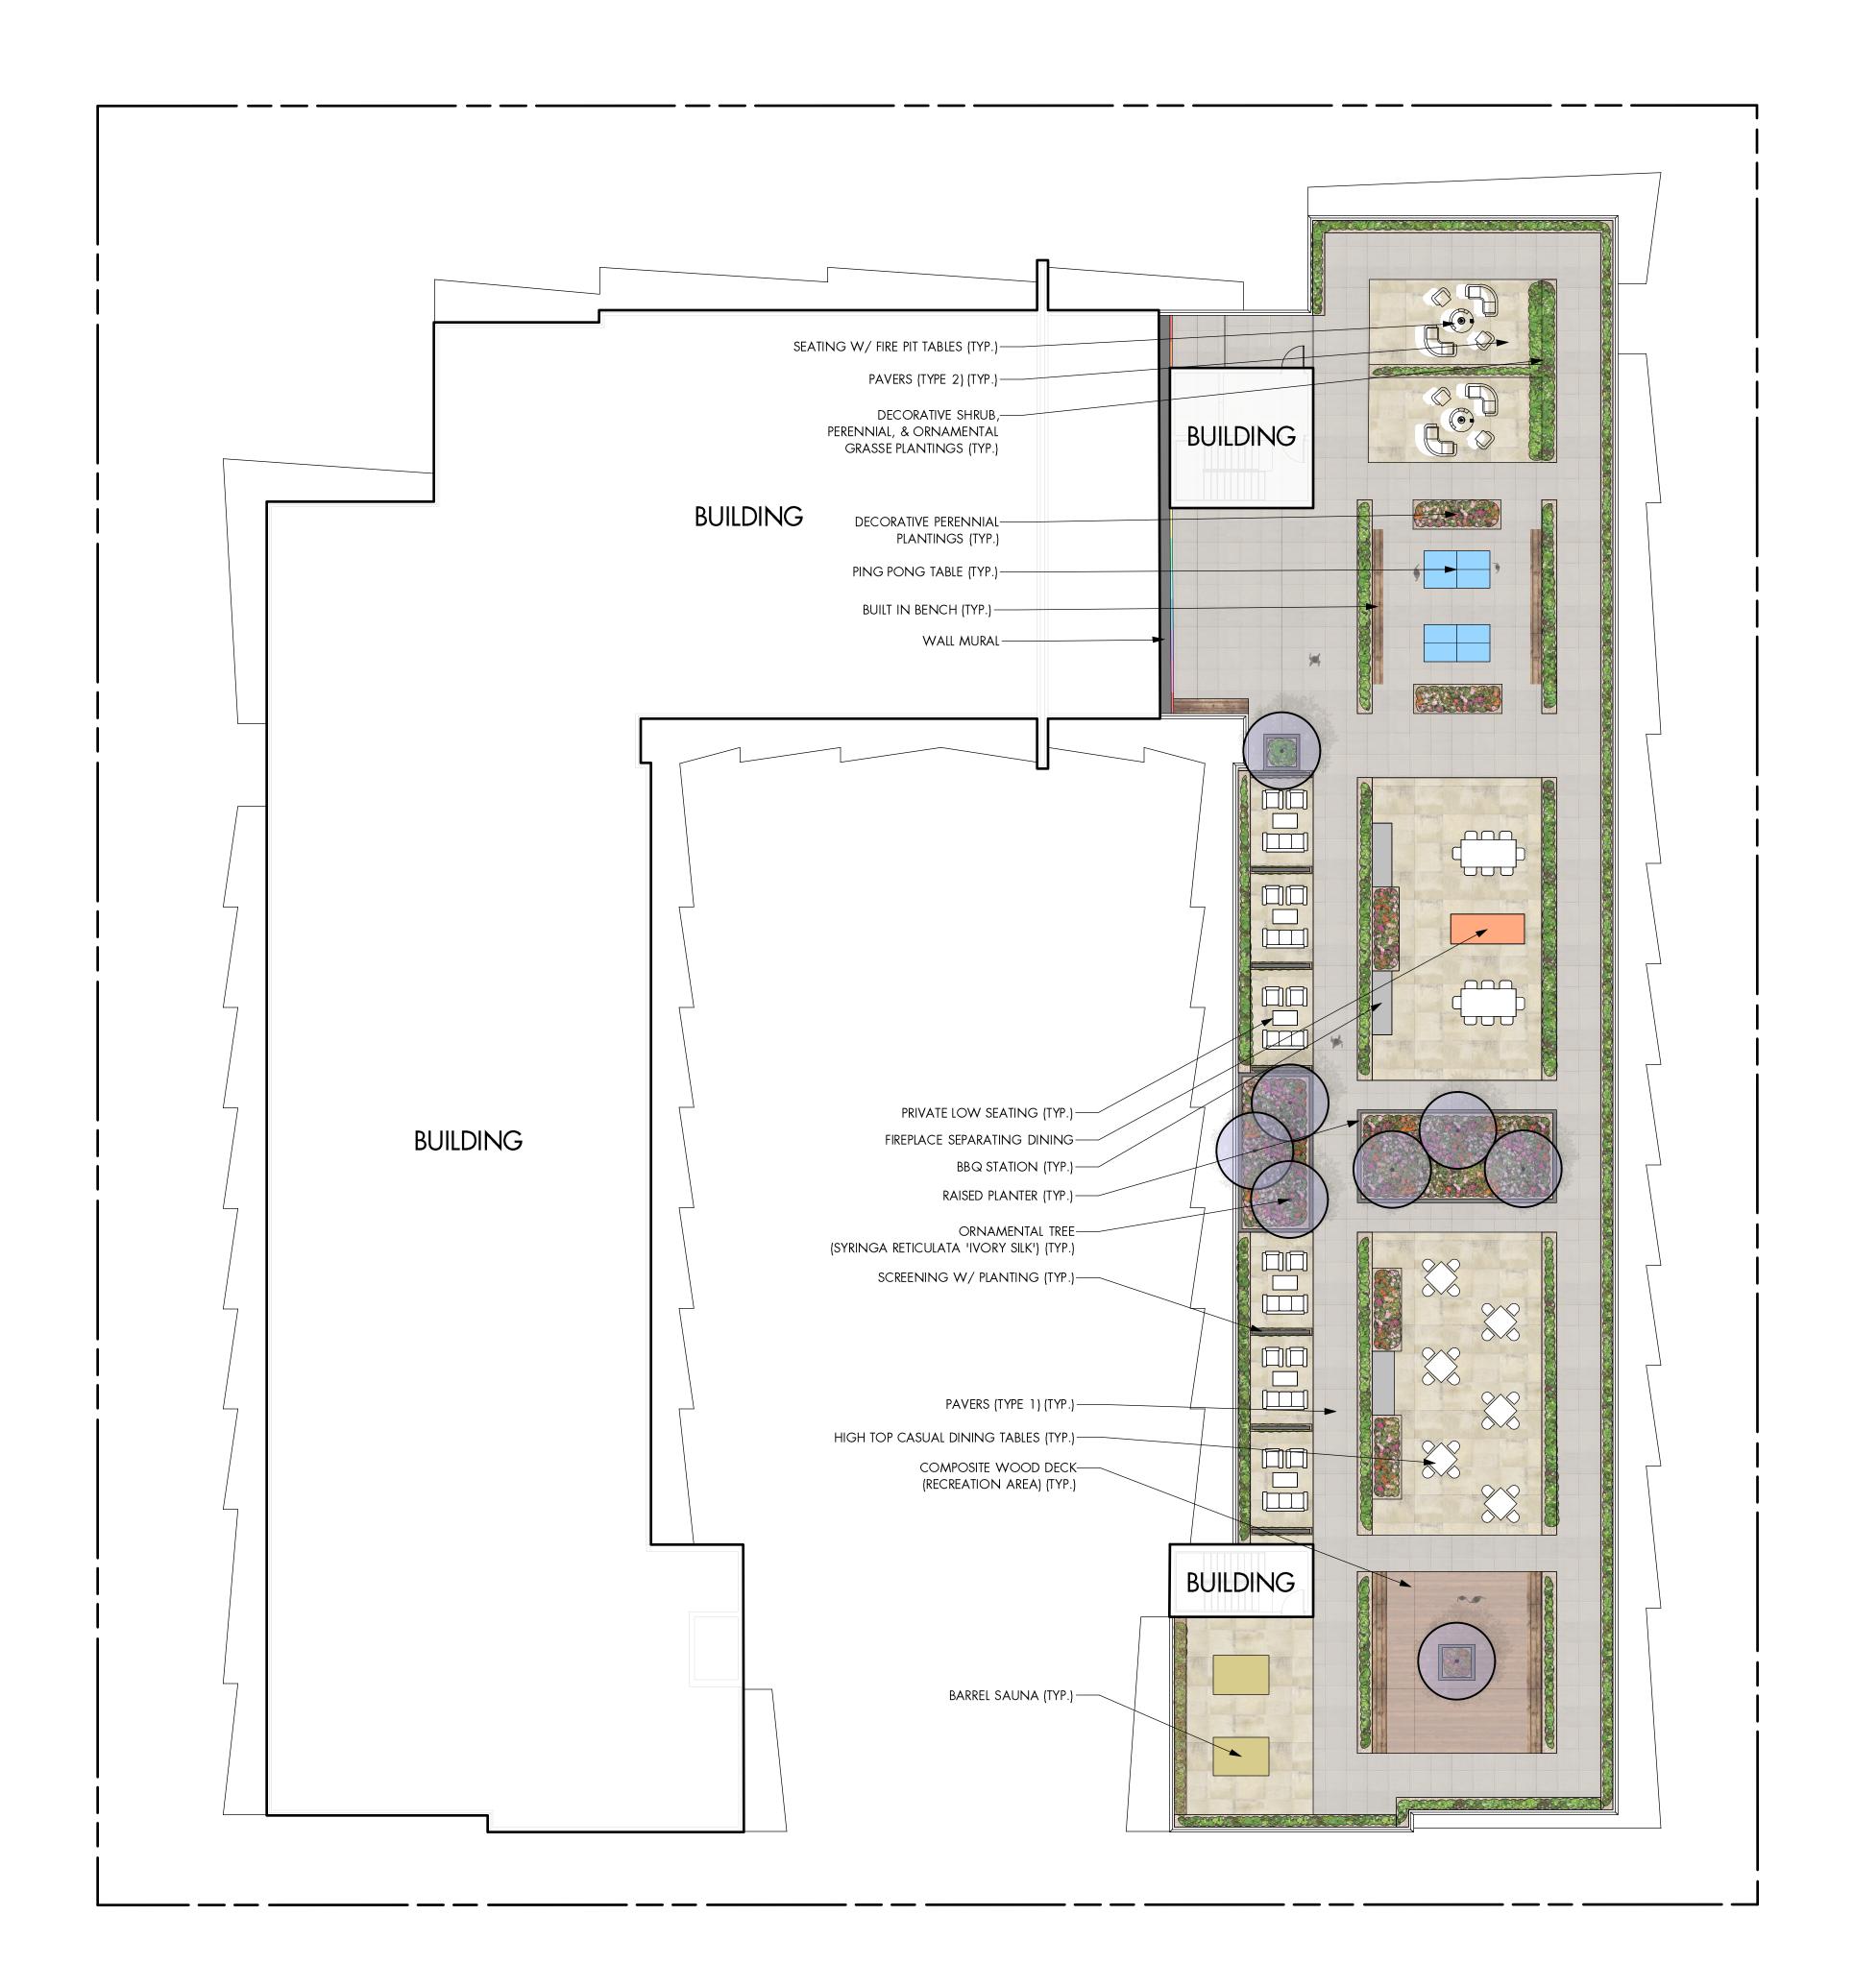



200-2045 Enterprise Way Kelowna, BC V1Y 9T5 T (250) 469-9757 www.ecora.ca

SCHEDULE

This forms part of application

# DP23-0084

Planner KB





PROJECT TITLE

#### **COLLINSON RISE**

Kelowna, BC

drawing title

#### CONCEPTUAL LANDSCAPE PLAN - ROOF

ISSL	JED FOR / REVISION	
1	23.02.24	Review
2	23.03.02	Review
3	23.03.17	Review
4	23.04.13	Review
5	23.07.17	Review

PROJECT NO	22-1201
DESIGN BY	AM
DRAVVN BY	TR
CHECKED BY	AM
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SCALE	1:150
PAGE SIZE	24"x36"

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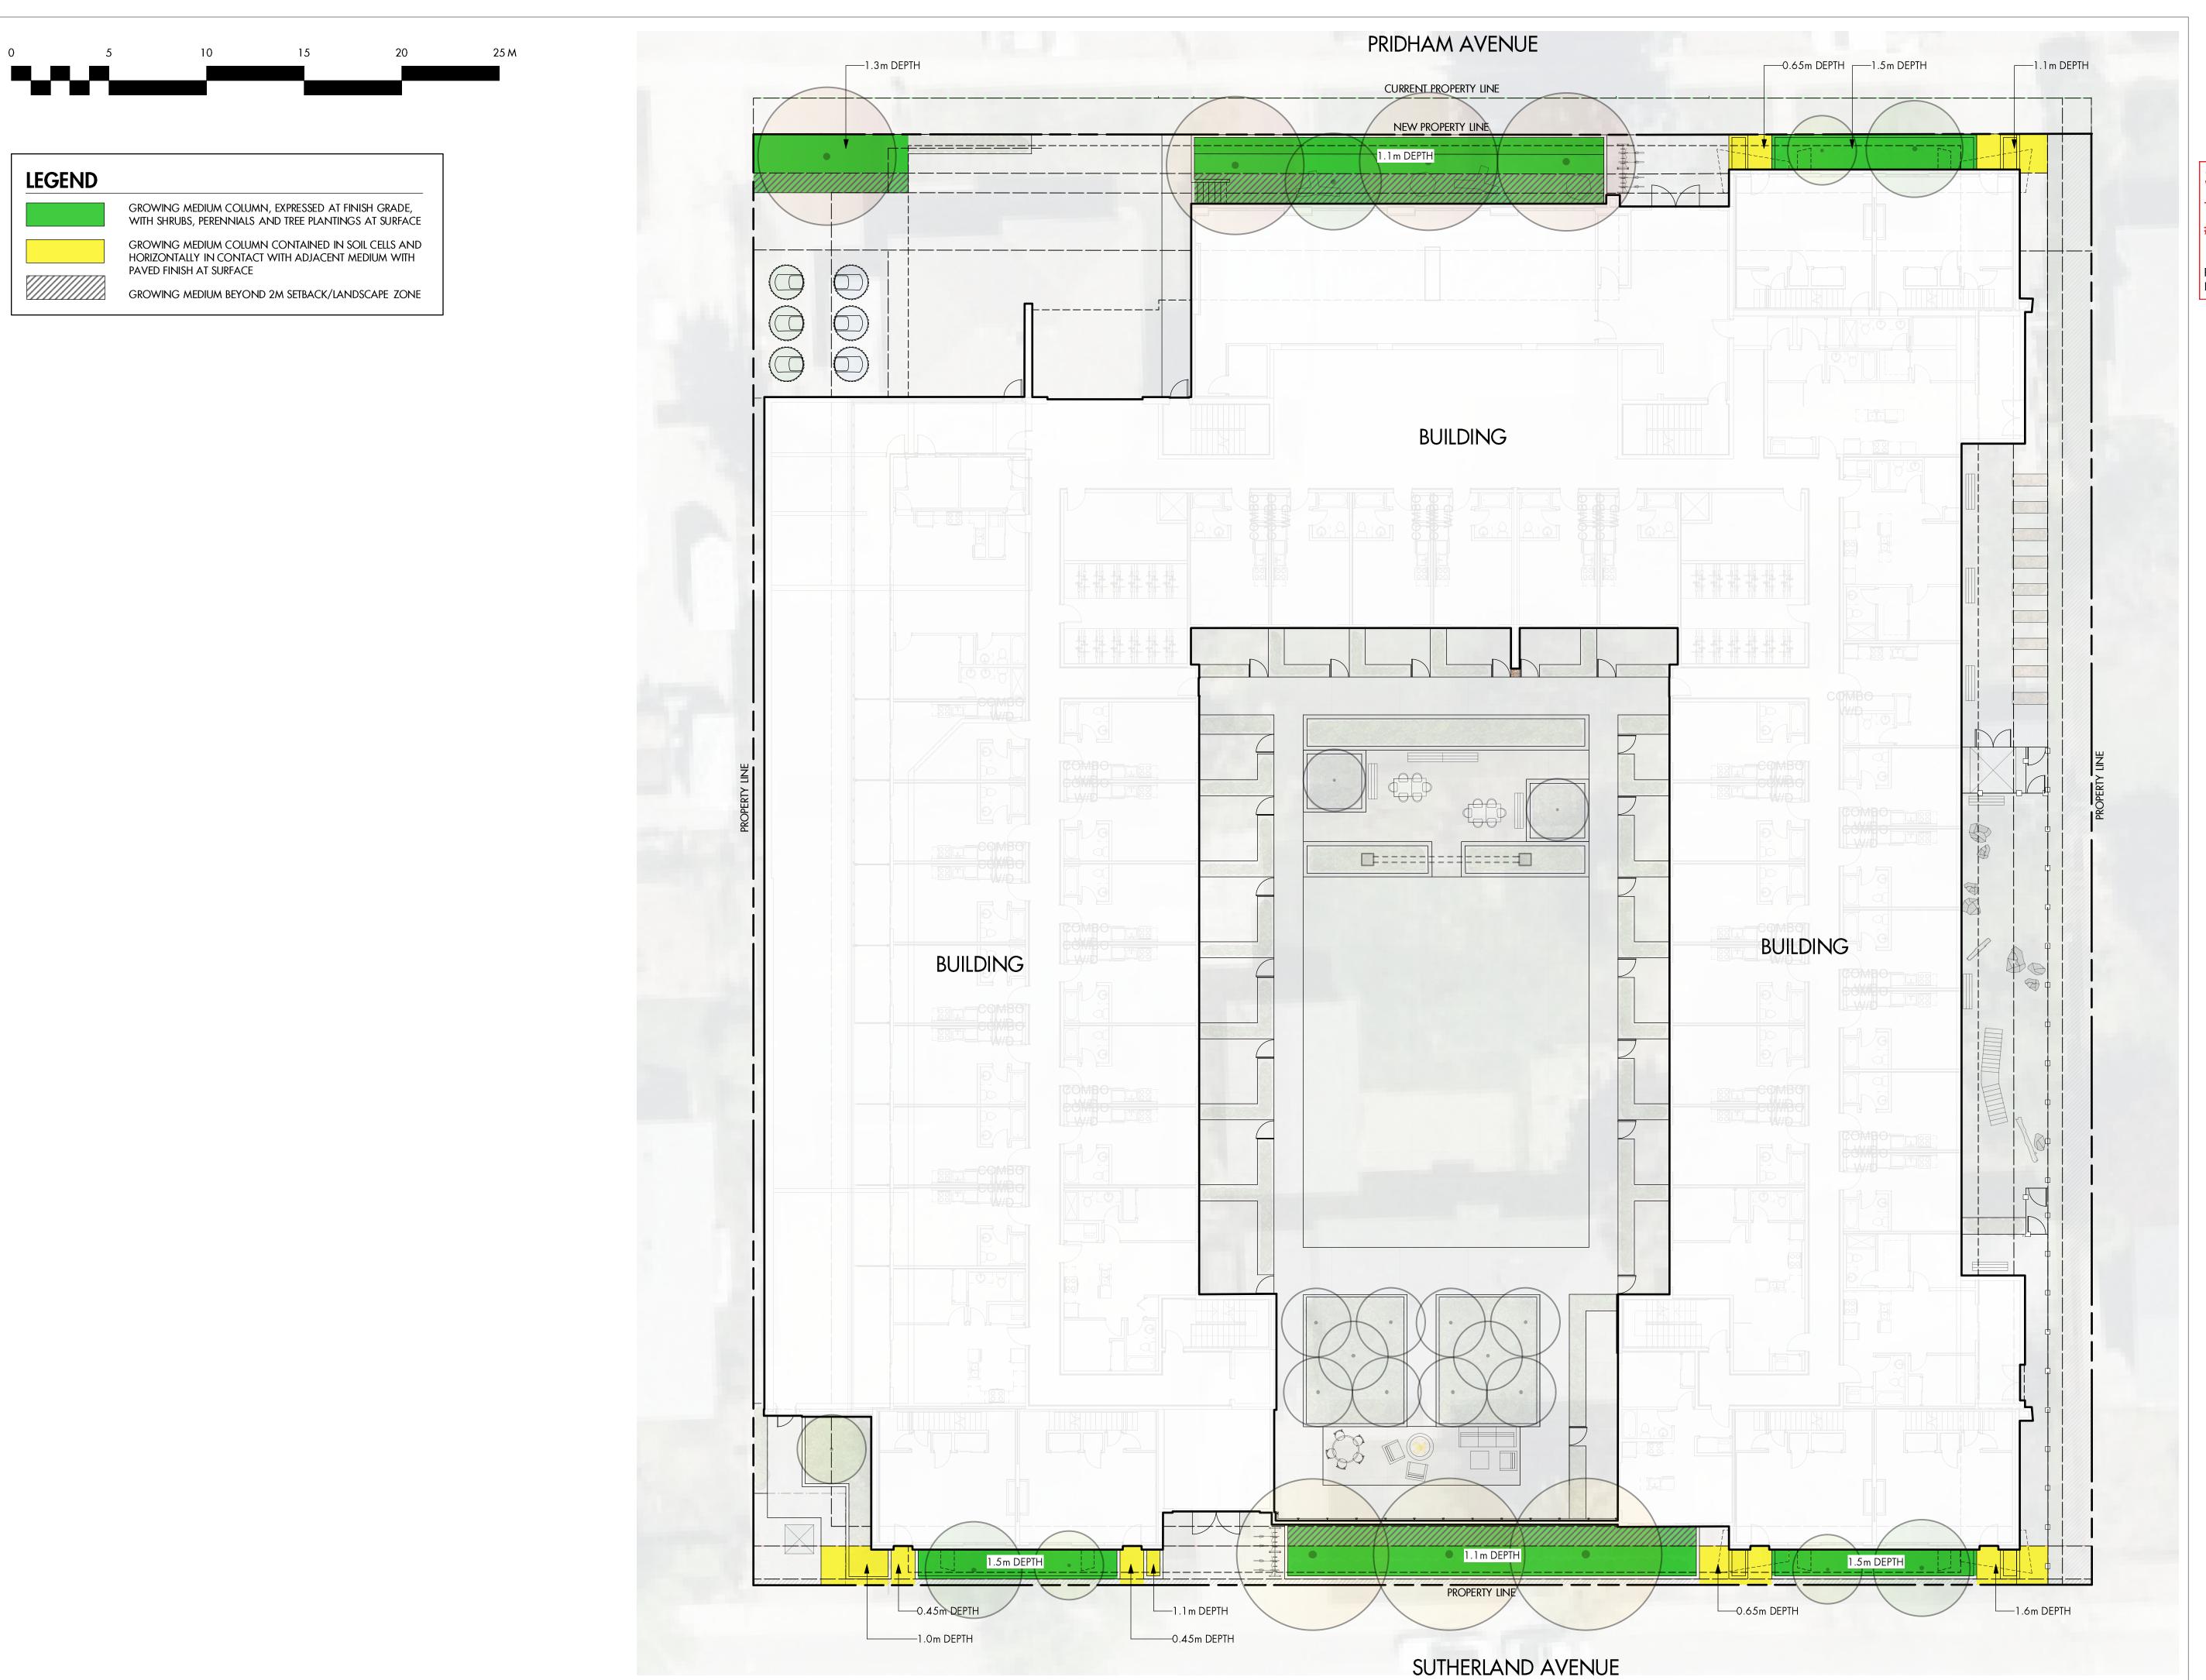
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# SCHEDULE

This forms part of application # DP23-0084









PROJECT TITLE

#### **COLLINSON RISE**

Kelowna, BC

DRAWING TITLE

### **GROWING MEDIUM** DISTRIBUTION PLAN

ISS		ISSU	ued for / revision		
		]	23.02.24	Review	
		2	23.03.02	Review	
		3	23.03.17	Review	
		4	23.04.13	Review	
		5	23.07.17	Review	

PROJECT NO	22-1201
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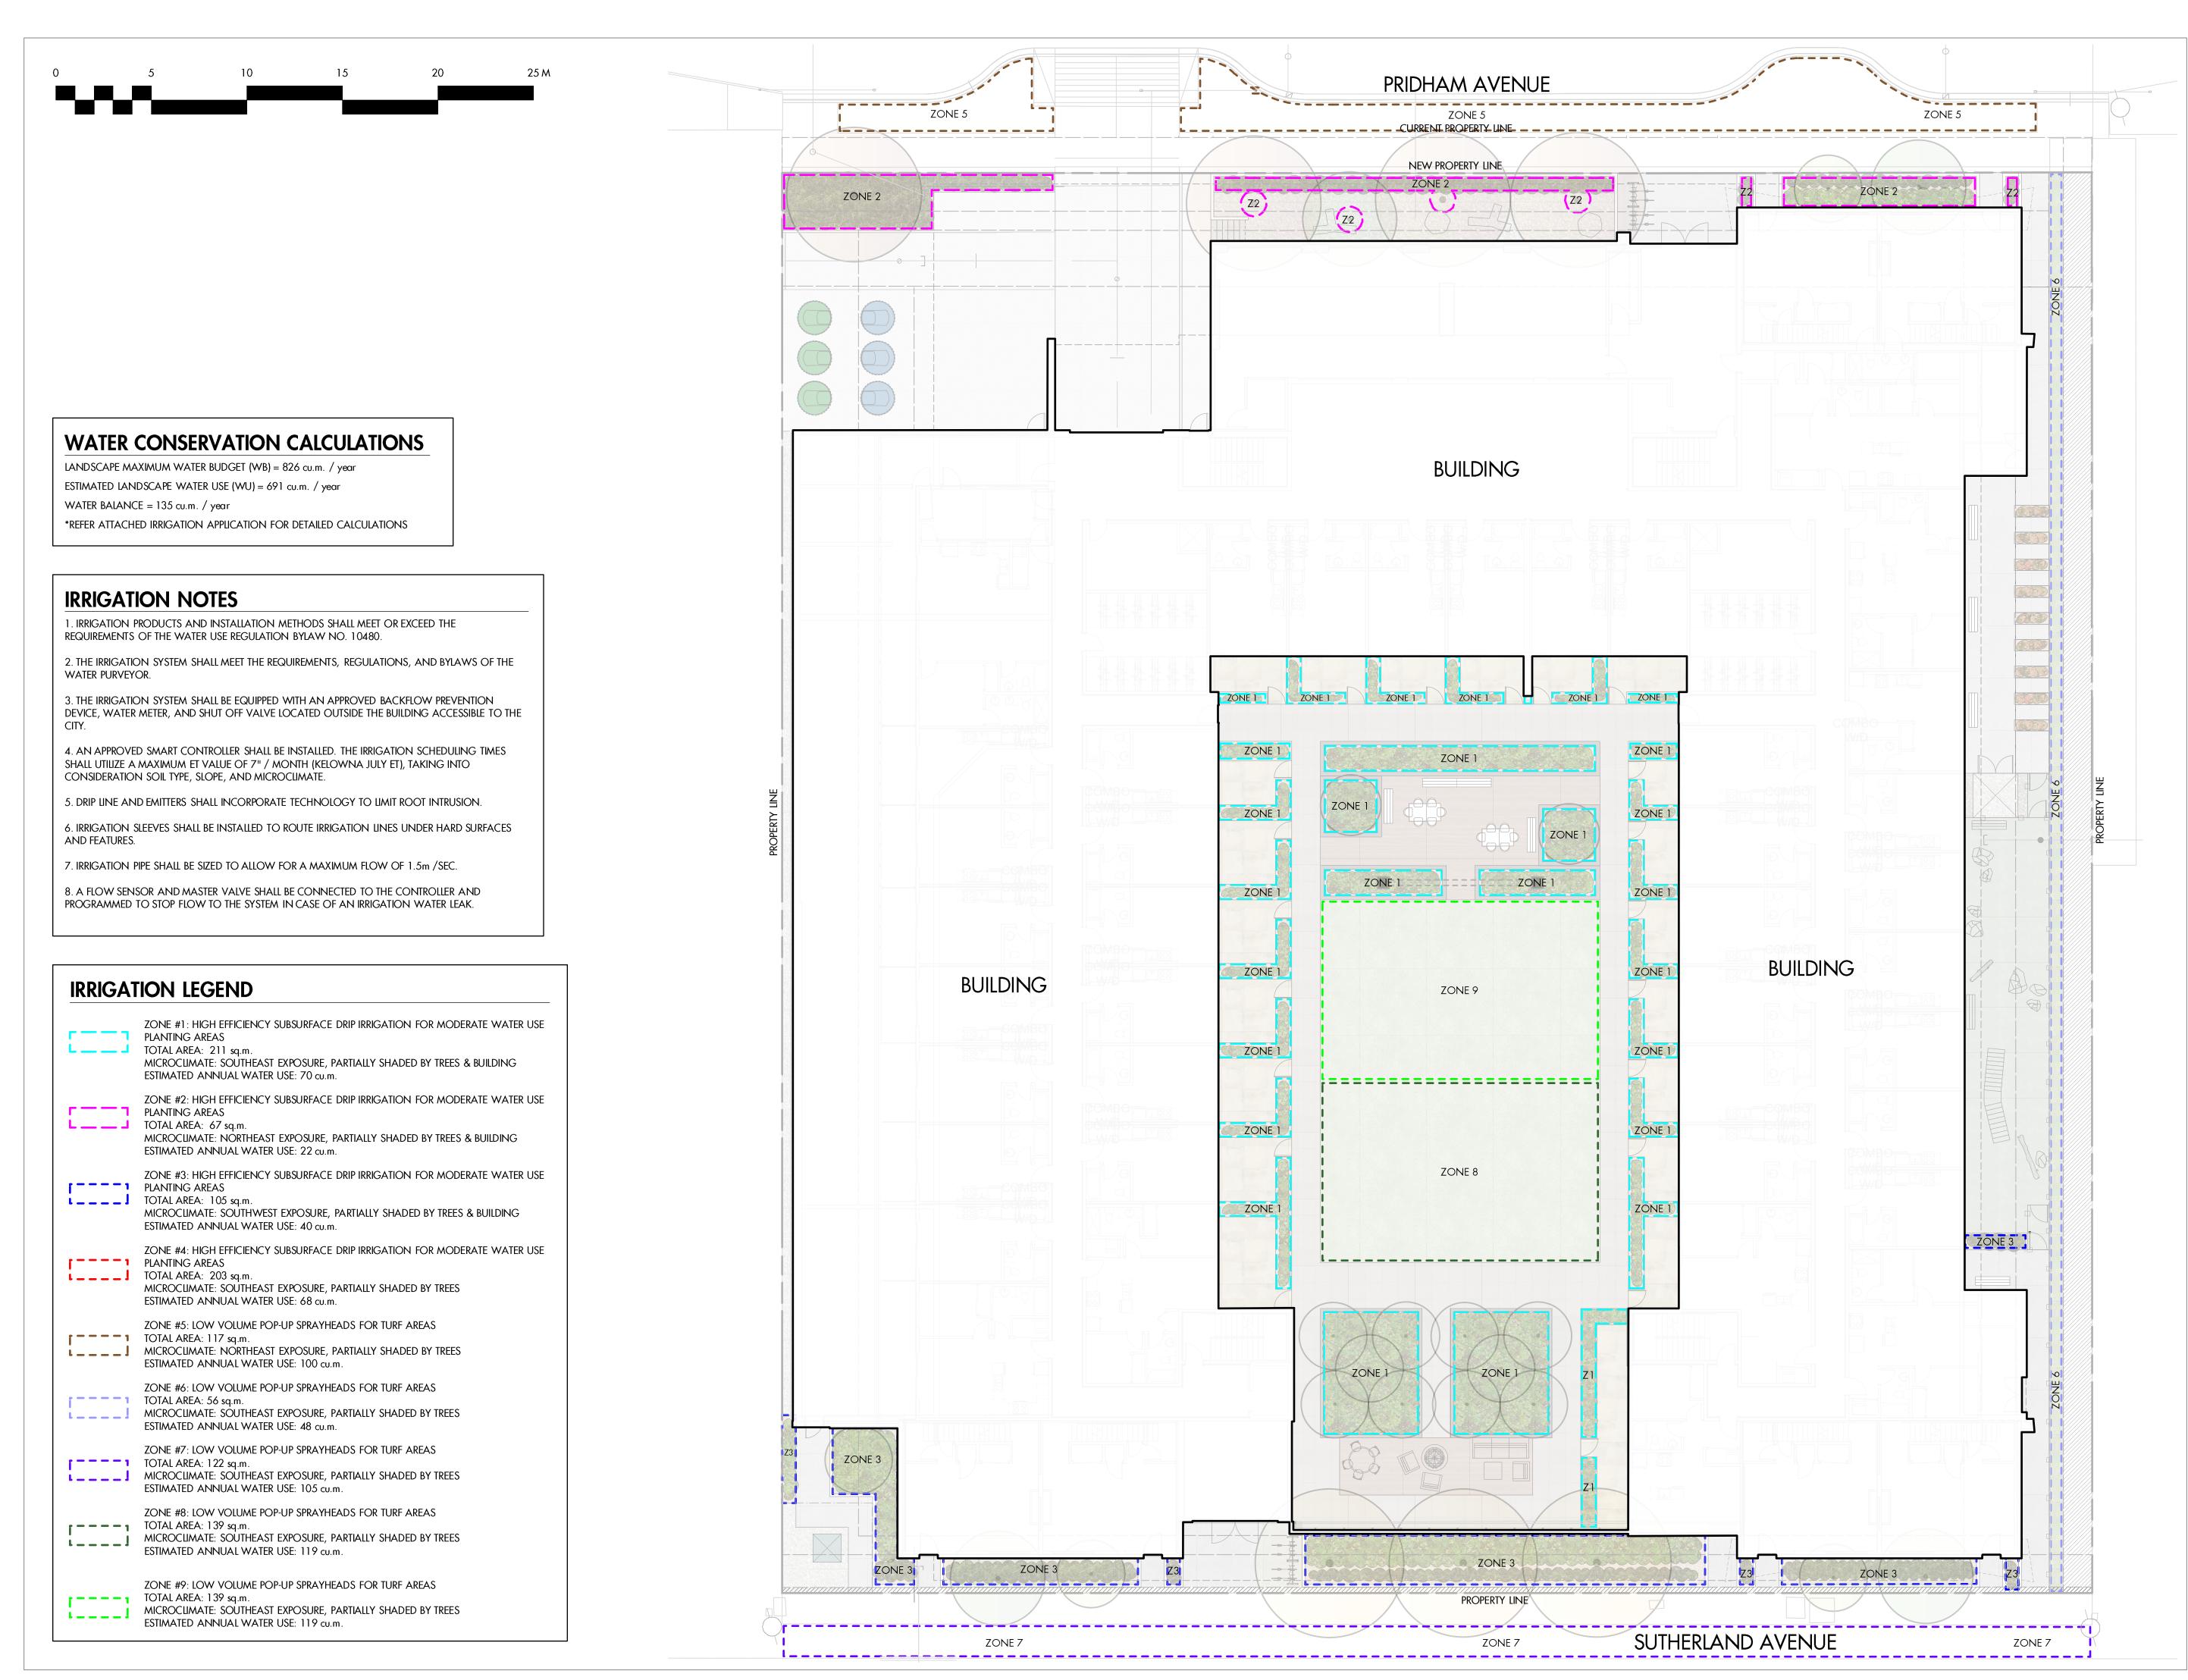
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SCHEDULE

This forms part of application # DP23-0084

Planner Initials KB



PROJECT TITLE

### **COLLINSON RISE**

Kelowna, BC

DRAWING TITLE

### WATER CONSERVATION/ **IRRIGATION PLAN** - AT GRADE

	JED FOR / REVISION	
1	23.02.24	Review
2	23.07.17	Review
3		
4		
5		

project no	22-1201	
design by	AM	
DRAVVN BY	TR	
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#### Collinson Rise - Zoning Bylaw 12375 Landscape Summary

Landscaping Standards (7.2)	Zone (MF3)		Proposed
Min. tree amount	14		14
Min. deciduous tree caliper	L: 5cm		L: 5cm
	M: 4cm		M: 4 cm
	S: 3cm		S: 3cm
Min. coniferous tree height	250cm		N/A
Min. ratio between tree size	L: 50% minimum (min.)		L: 50%
	M: no min. or max.		M: 29%
	S: 25% maximum (max.)		S: 21%
Min. growing medium area	75% soil based landscaping		80% soil based landscaping
Min. growing medium volumes per tree	L: 30 cu.m or 25 cu.m if		L: 30 cu.m & 25 cu.m where
	connected trench/cluster		connected trench/cluster and
	M: 20 cu.m or 18 cu.m if		adjacent growing medium on
	connected trench/cluster		private development site
	S: 15 cu.m or 12 cu.m if		M: 18 cu.m (soil cells creating
	connected trench/cluster		trench and adjacent growing
			medium on private
			development site)
			S: 12 cu.m (soil cells creating
			trench and adjacent growing
			medium on private
			development site)
Landscape graded area (7.2.7)	Max. 1:3 (33%) lawn areas,		Max. 1:3 (33%) lawn areas,
	Max. 1:2 (50%) planting areas	5,	Max. 1:2 (50%) planting areas,
	Min. 1:50 (2%) cross slopes		Min. 1:50 (2%) cross slopes
Fence Height	1.2m		1.2m
Riparian management area?	N	y/n	N
Retention of existing trees on site?	N	y/n	N
Surface parking lot (7.2.10)?	N	y/n	N
Refuse & recycle bins screened?	N	y/n	
			interior room in parkade
Other:			





Friday, July 17, 2023

#### Collinson Rise

Millennial Developments Corporation 1100-1631 Dickson Avenue

Attn: Ryan Tamblyn

Via email to: rtamblyn@millennialdev.ca

Re: Collinson Rise – Preliminary Cost Estimate for Bonding

Dear Ryan:

Please be advised of the following preliminary cost estimate for bonding of the proposed landscape works shown in the **Collinson Rise** conceptual landscape plan dated 23.07.17;

- Landscape Improvements on site at grade: 462 square metres. Total cost: \$162,860.00.
- Landscape Improvements exterior amenity areas on podiums: 566 square meters as required per City of Kelowna Zoning Bylaw No.12375 based on the development units count and the balance of square meters of interior common amenity space provided.
   Total cost: \$104,220.00
- Landscape Improvements off site: 240 square metres. Total cost: \$14,380.00

Grand Total Landscape Improvements: \$ 281,460.00

This preliminary cost estimate is inclusive of trees, shrubs, turf, artificial turf, hardscape, site furnishings, mulch, growing medium & irrigation.

You will be required to submit a performance bond to the City of Kelowna in the amount of 125% of the preliminary cost estimate. Please do not hesitate to contact me with any questions about the landscape plan.

**IONA BARTO** 

Best regards,

Fiona Barton, MBCSLA, CSLA

as per Ecora Engineering & Resource Group Ltd.

200-2045 Enterprise Way, Kelowna, BC, V1Y 9T5 P 250.469.9757

#### prepared for

### Estimate of Probable Construction Costs (On-Site) Collinson Rise

Conceptual Landscape Plan Dated July 17, 2023

prepared on:23.07.14

prepared by: AM/TR

Millennial Developments Corporation

Ground Level Setback Area and Amenity Areas

462 m<sup>2</sup>

em #	Description	Qty	Unit	Cost	Item Total	Subtotal
Α	Growing Medium & Mulch					
1.	Growing Medium, Trees (0.6 - 1.6m depth)	288	m3	\$75.00	\$21,600.00	
2.	Growing Medium, Planting Areas (0.3m depth)	10	m3	\$75.00	\$750.00	
4.	Wood Mulch, Planting Areas (0.075m depth)	100	m3	\$100.00	\$10,000.00	
						\$32,350.00
В	Site Construction					
1.	Concrete Paving	50	m²	\$100.00	\$5,000.00	
3.	Crusher Fines Paving	80	m²	\$25.00	\$2,000.00	
						\$7,000.00
С	Planting					
1.	Trees, 5cm Cal.	14	ea.	\$500.00	\$7,000.00	
2.	Shrubs, Grasses, Perennials, #01 Cont.	20	ea.	\$16.00	\$320.00	
3.	Shrubs, Grasses, Perennials, #02 Cont.	20	ea.	\$22.00	\$440.00	
						\$7,760.0
E	Irrigation					
2.	Irrigation System, planting areas	300	m²	\$20.00	\$6,000.00	
						\$6,000.0
F	Site Furnishings					
1.	Bench	6	ea.	\$2,000.00	\$12,000.00	
2.	Bike Rack (multi stall)	4	ea.	\$1,500.00	\$6,000.00	
3.	Artificial Turf	125	m²	\$200.00	\$25,000.00	
4.	Dog Ramp	3	ea.	\$2,500.00	\$7,500.00	
5.	Boulder	8	ea.	\$75.00	\$600.00	
6.	CIP Bench	4	ea.	\$2,000.00	\$8,000.00	
8.	Garden Shed	1	m²	\$2,500.00	\$2,500.00	
9.	Community Garden Plot	18	ea.	\$800.00	\$14,400.00	
10.	Solid Screen Fencing	150	lm	\$225.00	\$33,750.00	
						\$109,750.0
G	Total Construction Costs					\$162,860.0

The above items, amounts, quantities, and related information are based on Ecora's judgment at this level of document preparation and is offered only as reference data. Ecora has no control over construction quantities, costs and related factors affecting costs, and advises the client that significant variation may occur between this estimate of probable construction costs and actual construction prices.





#### **Estimate of Probable Construction Costs (On-Site)**

prepared for

Collinson Rise
Conceptual Landscape Plan Dated July 17, 2023

prepared on:23.07.14

prepared by: AM/TR

Millennial Developments Corporation

Common Amenity Space Exterior (Required)

566 m<sup>2</sup>

Item #	Description	Qty	Unit	Cost	Item Total	Subtotal
Α	Growing Medium & Mulch					
3.	Growing Medium, Raised Planters (0.3 - 0.45m depth)	30	m3	\$75.00	\$2,250.00	
4.	Wood Mulch, Planting Areas (0.075m depth)	60	m3	\$100.00	\$6,000.00	
						\$8,250.00
В	Site Construction					
2.	Pavers(type 1)	150	m²	\$175.00	\$26,250.00	
						\$26,250.00
С	Planting					
1.	Trees, 5cm Cal.	8	ea.	\$300.00	\$2,400.00	
2.	Shrubs, Grasses, Perennials, #01 Cont.	40	ea.	\$16.00	\$640.00	
3.	Shrubs, Grasses, Perennials, #02 Cont.	40	ea.	\$22.00	\$880.00	
						\$3,920.00
D	Turf					
1.	Turf from Sod	600	m²	\$8.00	\$4,800.00	
						\$4,800.00
E	Irrigation					
1.	Irrigation System, turf areas	600	m²	\$15.00	\$9,000.00	
2.	Irrigation System, planting areas	100	m²	\$20.00	\$2,000.00	
						\$11,000.00
F	Site Furnishings					
7.	Modular Planters	50	ea.	\$1,000.00	\$50,000.00	
						\$50,000.00
G	Total Construction Costs					\$104,220.00

The above items, amounts, quantities, and related information are based on Ecora's judgment at this level of document preparation and is offered only as reference data. Ecora has no control over construction quantities, costs and related factors affecting costs, and advises the client that significant variation may occur between this estimate of probable construction costs and actual construction prices.







1435 Water Street Kelowna, BC V1Y 1J4 250 469-8500 kelowna.ca

## Landscape Water Conservation Report

#### **APPLICANT INFORMATION**

Owner	Millennial Developments Corporation	Contractor co. name	Ecora Engineering & Resource Group Ltd.
Project address	1255, 1267 & 1277 Pridham Avenue, 1254, 1266 & 1276 Sutherland Avenue	Contractor contact name	Fiona Barton
	Kelowna	Contractor phone #	250-469-9757
Owner phone #	250-212-6743	Contractor email	fiona.barton@ecora.ca
Owner email	rtamblyn@millennialdev.ca		
Province	BC Postal Code: V1Y 6B3	Preferred contact	Owner  Contractor
	3 PAGES OF THE APPLICATION MI	UST BE COMPLETE	D AND SUBMITTED
	n submitting this application, has adhered to:		
✓	Applicable elctrical standards, plumbing star		evention standards
<u> </u>	Bylaw 12375		
<b>/</b>	Requirements of Water Regulation Bylaw		
Where an exemp	ption is required (e.g. golf course or large sch	nool field), contact the V	Vater Smart program directly.
Note that checklis	sts for selecting an irrigation contractor are availal	ble through the IIABC or the	e IA. Below is the link to the IIABC checklist.
https://www.irrig	gationbc.com/page/selecting-a-contractor		
<b>✓</b>			
Applicant notes	pertaining to the application:		
SCHEDIII	F C		Page 1 of 3



1435 Water Street Kelowna, BC V1Y 1J4 250 469-8500 kelowna.ca

### Landscape Water Conservation Report

#### LANDSCAPE WATER USE AREA

Applicant: Millennial Developments Corporation

1255, 1267 & 1277 Pridham Avenue, 1254,
Address: 1266 & 1276 Sutherland Avenue

#### Step 1: Measure Total Landscape Area (LA)

Area of site that will absorb water:

**1140** s

sa.m.

(over 100 square meters)

Note: Include boulevard, and proposed lawn, plants, mulch, pervious decks or paving stones. Do not include areas that are not pervious such as buildings, paved driveways, concrete patios etc.

Step 2: Divide Into Landscap	e Treatments*	Plant Factor	Irrig Efficiency	Hydrozone	% of Total LA	Estimated Wate
Note: each of the areas below are a 'HYI	DROZONE'	(PF)	(IE)	(HA)		(WU)
Unwatered Pervious Areas (	 not impervious paving	z)				
Mulch (Stone, bark or sand)		N/A	N/A	103	9%	N/A
Pervious deck (Spaced wood deck)		N/A	N/A		0%	N/A
Pervious paving (ie: AquaPave, Rima	Pave)	N/A	N/A		0%	N/A
Naturalized meadow (wildflowers)		N/A	N/A		0%	N/A
Naturalized area (Existing natural a	rea)	N/A	N/A		0%	N/A
Other: Artificial Turf		N/A	N/A	100	9%	N/A
Swimming or ornamental pool		1	1		0%	0
Watered Planting Beds (shru	bs or groundcover)					
Planting Type	Irrig Efficiency					
Low water use plants	High (Drip or Bubbler)	0.3	0.9		0%	0
Low water use plants	Moderate (Spray orRotor)	0.3	0.7		0%	0
Moderate water use plants	High (Drip or Bubbler)	0.5	0.9	603	53%	201
Moderate water use plants	Moderate (Spray orRotor)	0.5	0.7		0%	0
High water use plants	High (Drip or Bubbler)	0.7	0.9		0%	0
High water use plants	Moderate (Spray orRotor)	0.7	0.7		0%	0
Watered Mown Lawn Areas	Moderate (Spray orRotor)	1	0.7	334	29%	286
Special Landscape Areas (SLA	<b>A)</b>					
Vegetable Garden	High (Drip or Bubbler)	1	0.9		0%	0
Vegetable Garden	Moderate (Spray orRotor)	1	0.7		0%	0
Commercial sportsfield turf	Moderate (Spray orRotor)	1	0.7		0%	0
Rainwater or Recycled Water Use		0.3	1		0%	0
Totals				1140	100%	487
Special Landscape Area (SLA) Sub to	tal			0		1 .0,

<sup>\*</sup>If proposed design conditions are not shown on the form please contact Water Smart 250-469-8502





Planner

Kelowna

1435 Water Street Kelowna, BC V1Y 1J4 250 469-8500 kelowna.ca

### Landscape Water Conservation Report

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Millennial Developments Corpora

Address:

1255, 1267 & 1277 Pridham Avenue, 1254, 1266 & 1276 Sutherland Avenue

#### CALCULATE & COMPARE WATER BUDGET TO ESTIMATED WATER USE

Total Landscape Area	1140	sq.m.
Landscape Water Budget (WB)	684	cu.m./yr.
Estimated Landscape Water Use (WU)	487	cu.m./yr.
Under (-OVER) Budget (Must be under Water Budget WB)	197 ок	cu.m./yr.
I confirm by completing the attached Landscape Water Corpractices for landscape and irrigation installation in Kelowi will conform to the Hydrozone areas as identified in the Landscape	na. I also acknowle	dge that the landscape treatments of the project
Name of Applicant (person submitting the form)		Date:
FOR CITY OF KELOWNA OFFICE USE ONLY		
The calculations above satisfy the requirements of the Wais hereby APPROVED with the signature of the Water Manag		w 10480 Section 4.4.2 and 4.4.3.and the application
Name of Kelowna Water Smart designate		Date:
For Water Manager		
SCHEDULE C		
This forms part of application # DP23-0084		D 2



#### FORM & CHARACTER - DEVELOPMENT PERMIT GUIDELINES

Chapter 2 - The Design Foundations: apply to all projects and provide the overarching principles for supporting creativity, innovation and design excellence in Kelowna.

- Facilitate Active Mobility
- Use Placemaking to Strengthen Neighbourhood Identity
- Create Lively and Attractive Streets & Public Spaces
- Design Buildings to the Human Scale
- Strive for Design Excellence

The General Residential and Mixed Use Guidelines: provide the key guidelines that all residential and mixed use projects should strive to achieve to support the Design Foundations.

 The General Guidelines are supplement by typology-specific guidelines (e.g., Townhouses & Infill on page 18-19, High-Rise Residential and Mixed-Use on page 18-42), which provide additional guidance about form and character.

# Chapter 2 - Design Foundations Apply To All Projects Page 18-8

Section 2.1 - General Residential and Mixed Use Design Guidelines
Page 18-9

Section 2.2 - Achieving High Performance Page 18-17

Chapter 3
Townhouses & Infill

Page 18-19

Chapter 4 Low & Mid-Rise Residential & Mixed Use

Page 18-34

Chapter 5 High-Rise Residential & Mixed Use

Page 18-42

<sup>\*</sup>Note: Refer to the Design Foundations and the Guidelines associated with the specific building typology.



Consideration has been given to the following guidelines as identified in Chapter 18 of the City of Kelowna 2040 Official Community Plan:

	·						
	SECTION 2.0: GENERAL RESIDENTIAL AND MIX	KED US	SE				
	TE PROPOSALS COMPLIANCE TO PERTINENT GUIDELINE	N/A	1	2	3	4	5
	s least complying & 5 is highly complying)						
	General residential & mixed use guidelines		1	1			
2.1	.1 Relationship to the Street	N/A	1	2	3	4	5
a.	Orient primary building facades and entries to the fronting street						<b>✓</b>
	or open space to create street edge definition and activity.	4					
b.	On corner sites, orient building facades and entries to both	✓					
	fronting streets.						
C.	Minimize the distance between the building and the sidewalk to						✓
	create street definition and a sense of enclosure.						
d.	Locate and design windows, balconies, and street-level uses to						✓
	create active frontages and 'eyes on the street', with additional						
	glazing and articulation on primary building facades.						
e.	Ensure main building entries are clearly visible with direct sight						✓
_	lines from the fronting street.						
f.	Avoid blank, windowless walls along streets or other public open						✓
	spaces.	/					
g.	Avoid the use of roll down panels and/or window bars on retail and	✓					
	commercial frontages that face streets or other public open						
1.	spaces.						<b>√</b>
h.	In general, establish a street wall along public street frontages to						•
	create a building height to street width ration of 1:2, with a						
	minimum ration of 11:3 and a maximum ration of 1:1.75.						
•	Wider streets (e.g. transit corridors) can support greater streetwall						
	heights compared to narrower streets (e.g. local streets);						
•	The street wall does not include upper storeys that are setback						
	from the primary frontage; and						
•	A 1:1 building height to street width ration is appropriate for a lane						
	of mid-block connection condition provided the street wall height						
	is no greater than 3 storeys.	NI/A	_	_	_	_	_
	2 Scale and Massing  Provide a transition in building height from taller to shorter	N/A	1	2	3	4	5
a.	buildings both within and adjacent to the site with consideration						•
	for future land use direction.						
b.	Break up the perceived mass of large buildings by incorporating						<b>√</b>
D.	visual breaks in facades.						,
C.	Step back the upper storeys of buildings and arrange the massing			<b>✓</b>			
ر.	and siting of buildings to:			1			
•	Minimize the shadowing on adjacent buildings as well as public						
	and open spaces such as sidewalks, plazas, and courtyards; and						
	Allow for sunlight onto outdoor spaces of the majority of ground						
	floor units during the winter solstice.						
	noor office during the wifiter solution.			1			1



2.1	.3 Site Planning	N/A	1	2	3	4	5
	Site and design buildings to respond to unique site conditions and					•	<b>√</b>
	opportunities, such as oddly shaped lots, location at prominent						
	intersections, framing of important open spaces, corner lots, sites						
	with buildings that terminate a street end view, and views of						
	natural features.						
b.	Use Crime Prevention through Environmental Design (CPTED)						✓
	principles to better ensure public safety through the use of						
	appropriate lighting, visible entrances, opportunities for natural						
	surveillance, and clear sight lines for pedestrians.						
C.	Limit the maximum grades on development sites to 30% (3:1)						✓
d.	Design buildings for 'up-slope' and 'down-slope' conditions	✓					
	relative to the street by using strategies such as:						
•	Stepping buildings along the slope, and locating building						
	entrances at each step and away from parking access where						
	possible;						
•	Incorporating terracing to create usable open spaces around the						
	building						
•	Using the slope for under-building parking and to screen service						
	and utility areas;						
•	Design buildings to access key views; and						
•	Minimizing large retaining walls (retaining walls higher than 1 m						
	should be stepped and landscaped).						
e.	Design internal circulation patterns (street, sidewalks, pathways)						<b>✓</b>
	to be integrated with and connected to the existing and planed						
	future public street, bicycle, and/or pedestrian network.	4					
f.	Incorporate easy-to-maintain traffic calming features, such as on-	✓					
	street parking bays and curb extensions, textured materials, and						
	crosswalks.						
g.	Apply universal accessibility principles to primary building entries,						<b>✓</b>
	sidewalks, plazas, mid-block connections, lanes, and courtyards						
	through appropriate selection of materials, stairs, and ramps as						
	necessary, and the provision of wayfinding and lighting elements.	N1/A					
	.4 Site Servicing, Access, and Parking	N/A	1	2	3	4	5
a.	Locate off-street parking and other 'back-of-house' uses (such as				•		
	loading, garbage collection, utilities, and parking access) away						
h	from public view.					<b>✓</b>	
b.	Ensure utility areas are clearly identified at the development					•	
	permit stage and are located to not unnecessarily impact public or						
<u>_</u>	common open spaces.  Avoid locating off street parking between the front facade of a						
C.	Avoid locating off-street parking between the front façade of a						•
4	building and the fronting public street.			$\vdash$		<b>✓</b>	$\vdash$
d.	In general, accommodate off-street parking in one of the					•	
	following ways, in order of preference:						
	Underground (where the high water table allows)						
	Parking in a half-storey (where it is able to be accommodated to						
	not negatively impact the street frontage);				<u> </u>		



	DEVELOPMENT PLANNING						
•	Garages or at-grade parking integrated into the building (located						
	at the rear of the building); and						
•	Surface parking at the rear, with access from the lane or						
	secondary street wherever possible.		<b>√</b>				
e.	Design parking areas to maximize rainwater infiltration through		•				
	the use of permeable materials such as paving blocks, permeable						
f.	concrete, or driveway planting strips.  In cases where publicly visible parking is unavoidable, screen using					<b>✓</b>	
١.	strategies such as:					•	
•	Landscaping;						
	Trellises;						
	•						
•	Grillwork with climbing vines; or						
•	Other attractive screening with some visual permeability.					<b>✓</b>	
g.	Provide bicycle parking at accessible locations on site, including:					•	
•	Covered short-term parking in highly visible locations, such as						
	near primary building entrances; and						
•	Secure long-term parking within the building or vehicular parking						
<b>L</b>	area.					<b>✓</b>	
h.	Provide clear lines of site at access points to parking, site					•	
i.	servicing, and utility areas to enable casual surveillance and safety.						./
1.	Consolidate driveway and laneway access points to minimize curb						ľ
	cuts and impacts on the pedestrian realm or common open						
	spaces.						
-	Minimize pogetive impacts of parking ramps and entrances					<b>√</b>	
j.	Minimize negative impacts of parking ramps and entrances					<b>√</b>	
j.	through treatments such as enclosure, screening, high quality					<b>√</b>	
	through treatments such as enclosure, screening, high quality finishes, sensitive lighting and landscaping.	N/A	1	2	3		-
2.1	through treatments such as enclosure, screening, high quality finishes, sensitive lighting and landscaping.  .5 Streetscapes, Landscapes, and Public Realm Design	N/A	1	2	3	4	5
	through treatments such as enclosure, screening, high quality finishes, sensitive lighting and landscaping.  5 Streetscapes, Landscapes, and Public Realm Design Site buildings to protect mature trees, significant vegetation, and	N/A	1	2	3 🗸		5
<b>2.1</b> a.	through treatments such as enclosure, screening, high quality finishes, sensitive lighting and landscaping.  5 Streetscapes, Landscapes, and Public Realm Design  Site buildings to protect mature trees, significant vegetation, and ecological features.	N/A	1	2	3 🗸	4	5
<b>2.1</b> a.	through treatments such as enclosure, screening, high quality finishes, sensitive lighting and landscaping.  5 Streetscapes, Landscapes, and Public Realm Design  Site buildings to protect mature trees, significant vegetation, and ecological features.  Locate underground parkades, infrastructure, and other services	N/A	1	2	3 🗸		5
<b>2.1</b> a. b.	through treatments such as enclosure, screening, high quality finishes, sensitive lighting and landscaping.  5 Streetscapes, Landscapes, and Public Realm Design  Site buildings to protect mature trees, significant vegetation, and ecological features.  Locate underground parkades, infrastructure, and other services to maximize soil volumes for in-ground plantings.	N/A	1	2	3 🗸	4	5
<b>2.1</b> a.	through treatments such as enclosure, screening, high quality finishes, sensitive lighting and landscaping.  5 Streetscapes, Landscapes, and Public Realm Design  Site buildings to protect mature trees, significant vegetation, and ecological features.  Locate underground parkades, infrastructure, and other services to maximize soil volumes for in-ground plantings.  Site trees, shrubs, and other landscaping appropriately to	N/A	1	2	3 🗸	4	5
<b>2.1</b> a. b. c.	through treatments such as enclosure, screening, high quality finishes, sensitive lighting and landscaping.  5 Streetscapes, Landscapes, and Public Realm Design  Site buildings to protect mature trees, significant vegetation, and ecological features.  Locate underground parkades, infrastructure, and other services to maximize soil volumes for in-ground plantings.  Site trees, shrubs, and other landscaping appropriately to maintain sight lines and circulation.	N/A	1	2	3 🗸	4	5
<b>2.1</b> a. b.	through treatments such as enclosure, screening, high quality finishes, sensitive lighting and landscaping.  5 Streetscapes, Landscapes, and Public Realm Design  Site buildings to protect mature trees, significant vegetation, and ecological features.  Locate underground parkades, infrastructure, and other services to maximize soil volumes for in-ground plantings.  Site trees, shrubs, and other landscaping appropriately to maintain sight lines and circulation.  Design attractive, engaging, and functional on-site open spaces	N/A	1	2	3 ~	4	
<b>2.1</b> a. b. c.	through treatments such as enclosure, screening, high quality finishes, sensitive lighting and landscaping.  5 Streetscapes, Landscapes, and Public Realm Design  Site buildings to protect mature trees, significant vegetation, and ecological features.  Locate underground parkades, infrastructure, and other services to maximize soil volumes for in-ground plantings.  Site trees, shrubs, and other landscaping appropriately to maintain sight lines and circulation.  Design attractive, engaging, and functional on-site open spaces with high quality, durable, and contemporary materials, colors,	N/A	1	2	3 ~	4	
<b>2.1</b> a. b. c. d.	through treatments such as enclosure, screening, high quality finishes, sensitive lighting and landscaping.  5 Streetscapes, Landscapes, and Public Realm Design  Site buildings to protect mature trees, significant vegetation, and ecological features.  Locate underground parkades, infrastructure, and other services to maximize soil volumes for in-ground plantings.  Site trees, shrubs, and other landscaping appropriately to maintain sight lines and circulation.  Design attractive, engaging, and functional on-site open spaces with high quality, durable, and contemporary materials, colors, lighting, furniture, and signage.	N/A	1	2	3 🗸	4	
<b>2.1</b> a. b. c.	through treatments such as enclosure, screening, high quality finishes, sensitive lighting and landscaping.  5 Streetscapes, Landscapes, and Public Realm Design  Site buildings to protect mature trees, significant vegetation, and ecological features.  Locate underground parkades, infrastructure, and other services to maximize soil volumes for in-ground plantings.  Site trees, shrubs, and other landscaping appropriately to maintain sight lines and circulation.  Design attractive, engaging, and functional on-site open spaces with high quality, durable, and contemporary materials, colors, lighting, furniture, and signage.  Ensure site planning and design achieves favourable microclimate	N/A	1	2	3 ~	4	
2.1 a. b. c. d.	through treatments such as enclosure, screening, high quality finishes, sensitive lighting and landscaping.  5 Streetscapes, Landscapes, and Public Realm Design  Site buildings to protect mature trees, significant vegetation, and ecological features.  Locate underground parkades, infrastructure, and other services to maximize soil volumes for in-ground plantings.  Site trees, shrubs, and other landscaping appropriately to maintain sight lines and circulation.  Design attractive, engaging, and functional on-site open spaces with high quality, durable, and contemporary materials, colors, lighting, furniture, and signage.  Ensure site planning and design achieves favourable microclimate outcomes through strategies such as:	N/A	1	2	3 ~	4	
<b>2.1</b> a. b. c. d.	through treatments such as enclosure, screening, high quality finishes, sensitive lighting and landscaping.  • Streetscapes, Landscapes, and Public Realm Design  Site buildings to protect mature trees, significant vegetation, and ecological features.  Locate underground parkades, infrastructure, and other services to maximize soil volumes for in-ground plantings.  Site trees, shrubs, and other landscaping appropriately to maintain sight lines and circulation.  Design attractive, engaging, and functional on-site open spaces with high quality, durable, and contemporary materials, colors, lighting, furniture, and signage.  Ensure site planning and design achieves favourable microclimate outcomes through strategies such as:  Locating outdoor spaces where they will receive ample sunlight	N/A	1	2	3 ~	4	
2.1 a. b. c. d.	through treatments such as enclosure, screening, high quality finishes, sensitive lighting and landscaping.  5 Streetscapes, Landscapes, and Public Realm Design  Site buildings to protect mature trees, significant vegetation, and ecological features.  Locate underground parkades, infrastructure, and other services to maximize soil volumes for in-ground plantings.  Site trees, shrubs, and other landscaping appropriately to maintain sight lines and circulation.  Design attractive, engaging, and functional on-site open spaces with high quality, durable, and contemporary materials, colors, lighting, furniture, and signage.  Ensure site planning and design achieves favourable microclimate outcomes through strategies such as:  Locating outdoor spaces where they will receive ample sunlight throughout the year;	N/A	1	2	3 ~	4	
2.1 a. b. c. d.	through treatments such as enclosure, screening, high quality finishes, sensitive lighting and landscaping.  5 Streetscapes, Landscapes, and Public Realm Design  Site buildings to protect mature trees, significant vegetation, and ecological features.  Locate underground parkades, infrastructure, and other services to maximize soil volumes for in-ground plantings.  Site trees, shrubs, and other landscaping appropriately to maintain sight lines and circulation.  Design attractive, engaging, and functional on-site open spaces with high quality, durable, and contemporary materials, colors, lighting, furniture, and signage.  Ensure site planning and design achieves favourable microclimate outcomes through strategies such as:  Locating outdoor spaces where they will receive ample sunlight throughout the year;  Using materials and colors that minimize heat absorption;	N/A	1	2	3 ~	4	
2.1 a. b. c. d.	through treatments such as enclosure, screening, high quality finishes, sensitive lighting and landscaping.  • Streetscapes, Landscapes, and Public Realm Design  Site buildings to protect mature trees, significant vegetation, and ecological features.  Locate underground parkades, infrastructure, and other services to maximize soil volumes for in-ground plantings.  Site trees, shrubs, and other landscaping appropriately to maintain sight lines and circulation.  Design attractive, engaging, and functional on-site open spaces with high quality, durable, and contemporary materials, colors, lighting, furniture, and signage.  Ensure site planning and design achieves favourable microclimate outcomes through strategies such as:  Locating outdoor spaces where they will receive ample sunlight throughout the year;  Using materials and colors that minimize heat absorption;  Planting both evergreen and deciduous trees to provide a balance	N/A	1	2	3 ~	4	
2.1 a. b. c. d.	through treatments such as enclosure, screening, high quality finishes, sensitive lighting and landscaping.  5 Streetscapes, Landscapes, and Public Realm Design  Site buildings to protect mature trees, significant vegetation, and ecological features.  Locate underground parkades, infrastructure, and other services to maximize soil volumes for in-ground plantings.  Site trees, shrubs, and other landscaping appropriately to maintain sight lines and circulation.  Design attractive, engaging, and functional on-site open spaces with high quality, durable, and contemporary materials, colors, lighting, furniture, and signage.  Ensure site planning and design achieves favourable microclimate outcomes through strategies such as:  Locating outdoor spaces where they will receive ample sunlight throughout the year;  Using materials and colors that minimize heat absorption;  Planting both evergreen and deciduous trees to provide a balance of shading in the summer and solar access in the winter; and	N/A	1	2	3 ~	4	
2.1 a. b. c. d.	through treatments such as enclosure, screening, high quality finishes, sensitive lighting and landscaping.  5 Streetscapes, Landscapes, and Public Realm Design  Site buildings to protect mature trees, significant vegetation, and ecological features.  Locate underground parkades, infrastructure, and other services to maximize soil volumes for in-ground plantings.  Site trees, shrubs, and other landscaping appropriately to maintain sight lines and circulation.  Design attractive, engaging, and functional on-site open spaces with high quality, durable, and contemporary materials, colors, lighting, furniture, and signage.  Ensure site planning and design achieves favourable microclimate outcomes through strategies such as:  Locating outdoor spaces where they will receive ample sunlight throughout the year;  Using materials and colors that minimize heat absorption;  Planting both evergreen and deciduous trees to provide a balance of shading in the summer and solar access in the winter; and Using building mass, trees and planting to buffer wind.	N/A	1	2	3 ~	4	
2.1 a. b. c. d.	through treatments such as enclosure, screening, high quality finishes, sensitive lighting and landscaping.  5 Streetscapes, Landscapes, and Public Realm Design  Site buildings to protect mature trees, significant vegetation, and ecological features.  Locate underground parkades, infrastructure, and other services to maximize soil volumes for in-ground plantings.  Site trees, shrubs, and other landscaping appropriately to maintain sight lines and circulation.  Design attractive, engaging, and functional on-site open spaces with high quality, durable, and contemporary materials, colors, lighting, furniture, and signage.  Ensure site planning and design achieves favourable microclimate outcomes through strategies such as:  Locating outdoor spaces where they will receive ample sunlight throughout the year;  Using materials and colors that minimize heat absorption;  Planting both evergreen and deciduous trees to provide a balance of shading in the summer and solar access in the winter; and	N/A	1	2	3 ~	<b>4</b> ✓	



g. Plant native and/or drought tolerant trees and plants suitable for the local climate. h. Select trees for long-term durability, climate and soil suitability, and compatibility with the site's specific urban conditions. Design sites and landscapes to maintain the pre-development flows through capture, infiltration, and filtration strategies, such as the use of rain gardens and permeable surfacing. ✓ Design sites to minimize water use for irrigation by using strategies such as: Designing planting areas and tree pits to passively capture rainwater and stormwater run-off; and Using recycled water irrigation systems. k. Create multi-functional landscape elements wherever possible, such as planting areas that also capture and filter stormwater or landscape features that users can interact with. **√** Select materials and furnishings that reduce maintenance requirements and use materials and site furnishings that are sustainably sourced, re-purposed or 100% recycled. ✓ m. Use exterior lighting to complement the building and landscape design, while: Minimizing light trespass onto adjacent properties; Using full cut-off lighting fixtures to minimize light pollution; and Maintaining lighting levels necessary for safety and visibility. n. Employ on-site wayfinding strategies that create attractive and **√** appropriate signage for pedestrians, cyclists, and motorists using a 'family' of similar elements. 2.1.6 Building Articulation, Features and Materials N/A 1 2 3 4 a. Express a unified architectural concept that incorporates variation in façade treatments. Strategies for achieving this include: Articulating facades by stepping back or extending forward a portion of the façade to create a series of intervals or breaks; Repeating window patterns on each step-back and extension interval; Providing a porch, patio, or deck, covered entry, balcony and/or bay window for each interval; and Changing the roof line by alternating dormers, stepped roofs, gables, or other roof elements to reinforce each interval. **√** b. Incorporate a range of architectural features and details into building facades to create visual interest, especially when approached by pedestrians. Include architectural features such as: bay windows and balconies; corner feature accents, such as turrets or cupolas; variations in roof height, shape and detailing; building entries; and canopies and overhangs. Include architectural details such as: Masonry such as tiles, brick, and stone; siding including score lines and varied materials to distinguish between floors; articulation of columns and pilasters;



ornamental features and art work; architectural lighting; grills and railings; substantial trim details and moldings / cornices; and trellises, pergolas, and arbors. c. Design buildings to ensure that adjacent residential properties ✓ have sufficient visual privacy (e.g. by locating windows to minimize overlook and direct sight lines into adjacent units), as well as protection from light trespass and noise. d. Design buildings such that their form and architectural character reflect the buildings internal function and use. e. Incorporate substantial, natural building materials such as masonry, stone, and wood into building facades. Provide weather protection such as awnings and canopies at primary building entries. g. Place weather protection to reflect the building's architecture. h. Limit signage in number, location, and size to reduce visual clutter and make individual signs easier to see. Provide visible signage identifying building addresses at all entrances.

	SECTION 4.0: LOW & MID-RISE RESIDENTIAL MIXED USE							
R/	TE PROPOSALS COMPLIANCE TO PERTINENT GUIDELINE	N/A	1	2	3	4	5	
(1	is least complying & 5 is highly complying)							
4.:	4.1 Low & mid-rise residential & mixed use guidelines							
4.:	1.1 Relationship to the Street	N/A	1	2	3	4	5	
i.	Ensure lobbies and main building entries are clearly visible from the fronting street.						✓	
j.	Avoid blank walls at grade wherever possible by:					✓		
•	Locating enclosed parking garages away from street frontages or public open spaces;							
•	Using ground-oriented units or glazing to avoid creating dead frontages; and							
•	When unavoidable, screen blank walls with landscaping or							
	incorporate a patio café or special materials to make them more							
	visually interesting.							
Re	Residential & Mixed Use Buildings							
k.	Set back residential buildings on the ground floor between 3-5 m from the property line to create a semi-private entry or transition zone to individual units and to allow for an elevated front entryway or raised patio.			<b>√</b>				
•	A maximum 1.2 m height (e.g. 5-6 steps) is desired for front entryways.							
•	Exceptions can be made in cases where the water table requires this to be higher. In these cases, provide a larger patio and screen parking with ramps, stairs and landscaping.							



Incorporate individual entrances to ground floor units accessible from the fronting street or public open spaces. m. Site and orient buildings so that windows and balconies overlook public streets, parks, walkways, and shared amenity spaces while minimizing views into private residences. 4.1.2 Scale and Massing N/A 1 3 4 5 a. Residential building facades should have a maximum length of 60 m. A length of 40 m is preferred. b. Residential buildings should have a maximum width of 24 m. c. Buildings over 40 m in length should incorporate a significant horizontal and vertical break in the façade. **√** d. For commercial facades, incorporate a significant break at intervals of approximately 35 m. 4.1.3 Site Servicing, Access, and Parking N/A 2 3 5 4 On sloping sites, floor levels should step to follow natural grade and avoid the creation of blank walls. b. Site buildings to be parallel to the street and to have a distinct front-to-back orientation to public street and open spaces and to rear yards, parking, and/or interior court yards: Building sides that interface with streets, mid-block connections and other open spaces and should positively frame and activate streets and open spaces and support pedestrian activity; and Building sides that are located away from open spaces (building backs) should be designed for private/shared outdoor spaces and vehicle access. Break up large buildings with mid-block connections which should be publicly-accessible wherever possible. ✓ d. Ground floors adjacent to mid-block connections should have entrances and windows facing the mid-block connection. 4.1.4 Site Servicing, Access and Parking N/A 1 2 3 4 a. Vehicular access should be from the lane. Where there is no lane, and where the re-introduction of a lane is difficult or not possible, access may be provided from the street, provided: Access is from a secondary street, where possible, or from the long face of the block; Impacts on pedestrians and the streetscape is minimised; and There is no more than one curb cut per property. b. Above grade structure parking should only be provided in instances where the site or high water table does not allow for other parking forms and should be screened from public view with active retail uses, active residential uses, architectural or landscaped screening elements. ✓ Buildings with ground floor residential may integrate half-storey underground parking to a maximum of 1.2 m above grade, with the following considerations:



•	Semi-private spaces should be located above to soften the edge						
	and be at a comfortable distance from street activity; and						
•	Where conditions such as the high water table do not allow for this						
	condition, up to 2 m is permitted, provided that entryways, stairs,						
	landscaped terraces, and patios are integrated and that blank						
	walls and barriers to accessibility are minimized.						
4.1	.5 Publicly-Accessible and Private Open Spaces	N/A	1	2	3	4	5
a.		✓				-	
	courtyards accessible and available to the public) with public open						
	areas to create seamless, contiguous spaces.						
b.	Locate semi-private open spaces to maximize sunlight						✓
	penetration, minimize noise disruptions, and minimize 'overlook'						
	from adjacent units.						
Ου	tdoor amenity areas						
C.	Design plazas and urban parks to:						✓
•	Contain 'three edges' (e.g. building frontage on three sides) where						
	possible and be sized to accommodate a variety of activites;						
•	Be animated with active uses at the ground level; and						
•	Be located in sunny, south facing areas.						
d.	Design internal courtyards to:						✓
•	Provide amenities such as play areas, barbecues, and outdoor						
	seating where appropriate.						
•	Provide a balance of hardscape and softscape areas to meet the						
	specific needs of surrounding residents and/or users.						
e.	Design mid-block connections to include active frontages, seating			<b>√</b>			
	and landscaping.						
Ro	oftop Amenity Spaces	I.		•			
f.	Design shared rooftop amenity spaces (such as outdoor recreation					✓	
	space and rooftop gardens on the top of a parkade) to be						
	accessible to residents and to ensure a balance of amenity and						
	privacy by:						
•	Limiting sight lines from overlooking residential units to outdoor						
	amenity space areas through the use of pergolas or covered areas						
	where privacy is desired; and						
•	Controlling sight lines from the outdoor amenity space into						
	adjacent or nearby residential units by using fencing, landscaping,						
	or architectural screening.						
g.	Reduce the heat island affect by including plants or designing a				✓		
	green roof, with the following considerations:						
•	Secure trees and tall shrubs to the roof deck; and						
•	Ensure soil depths and types are appropriate for proposed plants						
	and ensure drainage is accommodated.						
4.1	.6 Building Articulation, Features, and Materials	N/A	1	2	3	4	5
a.	3						✓
	m wide for mixed-use buildings and 20 m wide for residential						
	buildings. Strategies for articulating buildings should consider the						
	potential impacts on energy performance and include:						



•	Façade Modulation – stepping back or extending forward a					
	portion of the façade to create a series of intervals in the façade;					
•	Repeating window pattern intervals that correspond to extensions					
	and step backs (articulation) in the building façade;					
•	Providing a porch, patio, deck, or covered entry for each interval;					
•	Providing a bay window or balcony for each interval, while					
	balancing the significant potential for heat loss through thermal					
	bridge connections which could impact energy performance;					
•	Changing the roof line by alternating dormers, stepped roofs,					
	gables, or other roof elements to reinforce the modulation or					
	articulation interval;					
•	Changing the materials with the change in building plane; and					
•	Provide a lighting fixture, trellis, tree or other landscape feature					
	within each interval.					
b.	Break up the building mass by incorporating elements that define				✓	
	a building's base, middle and top.					
C.	Use an integrated, consistent range of materials and colors and					✓
	provide variety, by for example, using accent colors.		<u> </u>			
d.	Articulate the façade using design elements that are inherent to				✓	
	the buildings as opposed to being decorative. For example, create					
	depth in building facades by recessing window frames or partially					
	recessing balconies to allow shadows to add detail and variety as a					
	byproduct of massing.					
e.	Incorporate distinct architectural treatments for corner sites and					✓
	highly visible buildings such as varying the roofline, articulating					
	the façade, adding pedestrian space, increasing the number and					
	size of windows, and adding awnings or canopies.					
f.	Provide weather protection (e.g. awnings, canopies, overhangs,	✓				
	etc.) along all commercial streets and plazas with particular					
	attention to the following locations:					
•	Primary building entrances;,					
•	Adjacent to bus zones and street corners where people wait for					
	traffic lights;					
•	Over store fronts and display windows; and					
•	Any other areas where significant waiting or browsing by people					
	occurs.					
g.	Architecturally-integrate awnings, canopies, and overhangs to the					✓
	building and incorporate architectural design features of buildings					
	from which they are supported.					
h.	Place and locate awnings and canopies to reflect the building's					✓
	architecture and fenestration pattern.					
i.	Place awnings and canopies to balance weather protection with					✓
	daylight penetration. Avoid continuous opaque canopies that run					
	the full length of facades.					
j.	Provide attractive signage on commercial buildings that identifies	✓				
	uses and shops clearly but which is scaled to the pedestrian rather					
	than the motorist. Some exceptions can be made for buildings					




	located on highways and/or major arterials in alignment with the City's Sign Bylaw.				
k.	Avoid the following types of signage:	✓			
•	Internally lit plastic box signs;				
•	Pylon (stand alone) signs; and				
•	Rooftop signs.				
I.	Uniquely branded or colored signs are encouraged to help	✓			
	establish a special character to different neighbourhoods.				



What sets Millennial Developments apart from other developers is our reliance on market data to inform our decisions
-Ryan Tamblyn, CEO, Millennial Developments Corp

# SITE CONTEXT

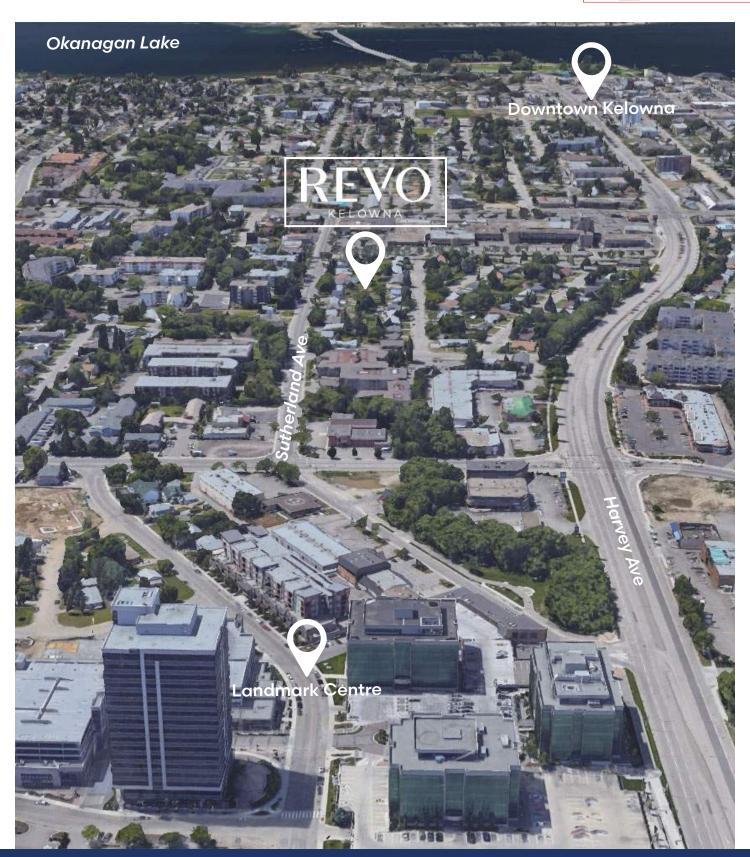



### **REVO KELOWNA**



View Looking North from Sutherland



View Looking South from Pridham Ave



# **REVO AMENITIES - INTERIOR**





Lobby View






Fitness Centre with Dedicated Yoga Space (1,351 SF) View 1



Fitness Centre with Dedicated Yoga Space (1,351 SF) View 2



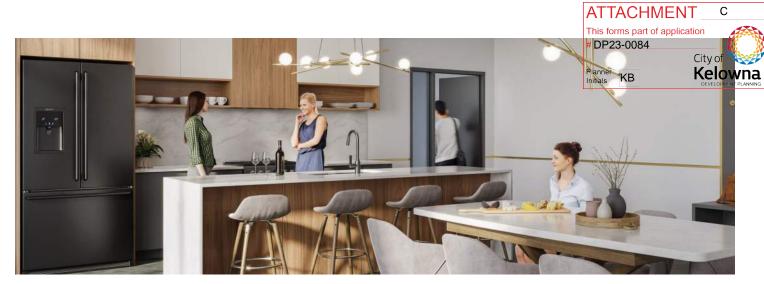

Lounge (1,738 SF) View 1



Lounge (1,738 SF) View 2



Lounge (1,738 SF) View 3





Shared Workspace (1,297 SF) View 1



Shared Workspace (1,297 SF) View 2




### **REVO AMENITIES - EXTERIOR**





Courtyard View from Sutherland



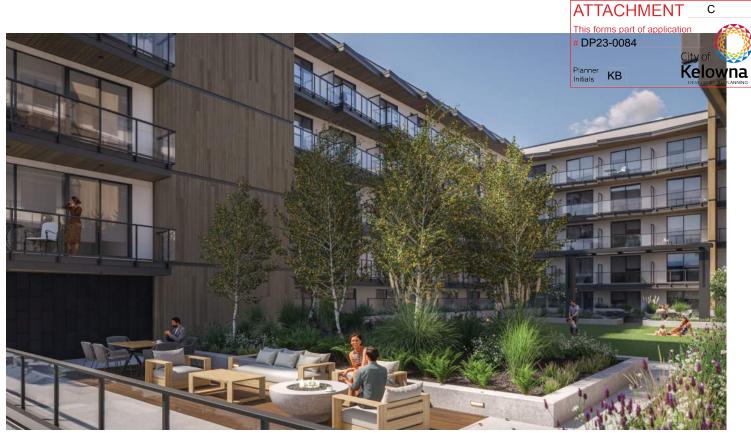

Second Level Courtyard (8,106 SF) View 1



Second Level Courtyard (8,106 SF) View 2






Second Level Courtyard with Outdoor Projector (8,106 SF) View 3

ATTACHMENT




Second Level Courtyard (8,106 SF) View 4



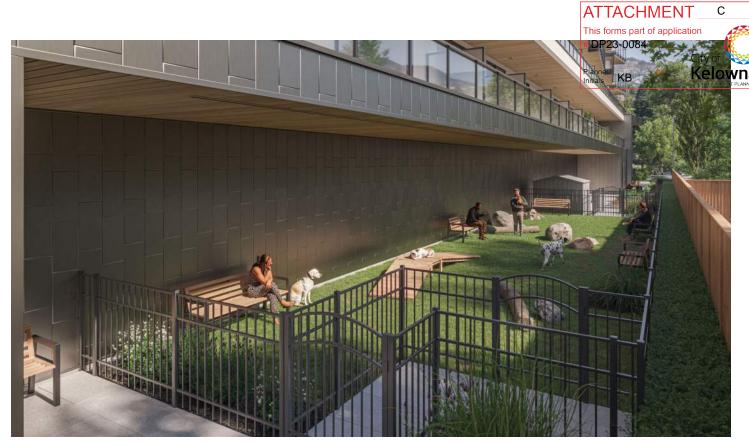

Pet Park (1,401 SF)

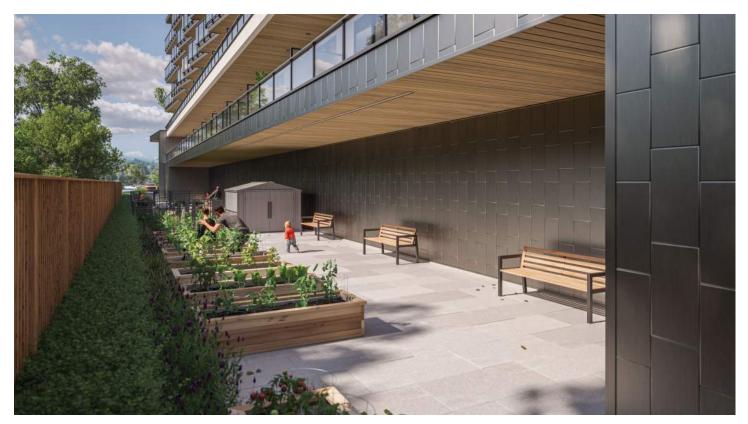

Organic Garden Space (974 SF)



# **REVO AMENITIES - ROOFTOP**







REVO Rooftop Terrace (10,669 SF)





Sauna & Cold Plunge Zone



 ${\sf Meditation} \ \& \ {\sf Yoga} \ {\sf Platform}$ 





Alfresco Dining Area



Ping Pong Courts









#### CO-OPERATIVE CARSHARING AGREEMENT

THIS AGREEMENT made the 9th day of September, 2023,

#### BETWEEN:

MODO CO-OPERATIVE

200 - 470 Granville Street Vancouver, BC V6C 1V5

("Modo")

#### AND:

**COLLINSON RISE LP** 

1100 – 1631 Dickson Avenue Kelowna, BC V1Y 0B5

("Developer")

#### WHEREAS:

A. Developer is the registered owner of those certain lands located at 1266, 1276, 1288 Sutherland Avenue & 1267, 1277, 1289 Pridham Avenue, Kelowna and legally described as follows:

PID: 009-696-300, legal lot description Lot 13, Block 3, Plan KAP9625, PID: 009-696-318, legal lot description Lot 14, Block 3, Plan KAP9625, PID: 009-696-326, legal lot description Lot 15, Block 3, Plan KAP9625, PID: 009-696-229, legal lot description Lot 5, Block 3, Plan KAP9625, PID: 009-696-237, legal lot description Lot 6, Block 3, Plan KAP9625, PID: 008-037-523, legal lot description Lot 7, Block 3, Plan KAP9625.

(the "Lands"); and

- B. Developer intends to construct or to cause to be constructed a strata residential development (the "Development") on the Lands;
- C. Upon the completion of construction of the Development, Developer intends to subdivide the Lands by way of a strata plan (the "Strata Plan") pursuant to the Strata Property Act (British Columbia) to create 240 residential strata lots (collectively, the "Strata Lots", and each a "Strata Lot");
- Modo is a member-owned co-operative that facilitates carsharing for individuals and businesses as an alternative to privately-owned automobiles;

- E. As a condition of approving the Development, the City of Kelowna in British Columbia (the "Municipality") requires Developer to provide one (1) co-operative vehicle (the "Shared Vehicle") in connection with the Development and to be available as part of a service to share the use of the Shared Vehicle (the "Carsharing Program");
- F. In addition, the Municipality requires Developer to designate one (1) parking space at the Development for the exclusive use of the Shared Vehicle (the "Shared Vehicle Parking Space" as set out in Schedule A hereto) and free-of-charge to Modo;
- G. Modo will deliver the Shared Vehicle to the Shared Vehicle Parking Space and will make the Shared Vehicle available for use in accordance with the terms of this Agreement;
- H. Modo will, at its cost, operate, maintain, repair and insure the Shared Vehicle and administer the service to share the Shared Vehicle (collectively, the "Services");
- Developer and Modo intend that the Shared Vehicle will be available for use by all members of Modo (collectively, the "Modo Members" and each a "Modo Member"), including the Residents who become Modo Members; and
- J. Developer and Modo wish to set out in this Agreement the terms and conditions of the Carsharing Program as it pertains to the Development.

**NOW THEREFORE** in consideration of the sum of Ten (\$10.00) Dollars now paid by each party to the other (the receipt and sufficiency of which is hereby acknowledged) and in consideration of the mutual promises and covenants contained herein, the parties agree as follows:

#### **ARTICLE 1 - DEFINITIONS**

- 1.1 Definitions. In this Agreement, the following terms have the following meanings:
  - (a) "Agreement" means this agreement, any schedules attached hereto which are referred to in this agreement, and every properly executed instrument which by its terms amends, modifies, supplements, or extends this agreement;
  - (b) "Arbitrator" has the meaning set out in section 13.1(d);
  - (c) "Carsharing Program" has the meaning set out in Recital E;
  - (d) "Commencement Date" means the date on which the Occupancy Permit is issued by the Municipality;
  - (e) "Developer" means the party defined as Developer on the first page of this Agreement and any of its heirs, executors, administrators,

successors, assigns, subsidiaries or nominees who may assume Developer's right, title or interest in the Development and/or this Agreement from Developer named herein, and expressly includes any person which may manage or operate the Development for Developer from time to time;

- (f) "Development" has the meaning set out in Recital B;
- (g) "Driving Credits" has the meaning set out in section 7.2;
- (h) "Estimated Occupancy Date" has the meaning set out in section 3.5;
- (i) "EV Station" means one (1) electric vehicle charging station (which specifications are defined in Schedule B) to be provided, installed, maintained and replaced by Developer, at Developers sole cost, to be used for the sole purpose of charging the Shared Vehicle, and to be located adjacent to the Shared Vehicle Parking Space;
- (j) "Lands" has the meaning set out in Recital A;
- (k) "Marketing Program" has the meaning set out in section 7.2;
- (I) "Mediator" means a member in good standing of the Arbitrators Association of British Columbia or Mediate BC;
- (m) "Membership Holder" means the Strata Corporation;
- (n) "Membership Shares" means membership shares in Modo;
- (o) "Modo Members" has the meaning set out in Recital I;
- (p) "Municipality" has the meaning set out in Recital E:
- (q) "Occupancy Permit" means the first occupancy permit issued by the Municipality in respect of the Development;
- (r) "Partner User" means a Resident (as defined below) who benefits from Modo membership privileges by way of the Partnership Membership;
- (s) "Partnership Membership" means the Membership Holder membership in Modo by way of ownership of the Subject Shares (as defined in section 2.1);
- (t) "Project Fee" has the meaning set out in section 2.1;
- (u) "Residents" means, collectively, the residents of the Development and "Resident" means any one of them and, for greater certainty,

"Residents" includes any of the following persons who are residents of the Development: owners of Strata Lots and tenants of Strata Lots;

- (v) "Rules" has the meaning set out in section 5.4(a);
- (w) "Services" has the meaning set out in Recital H;
- (x) "Shared Vehicle Deployment Sequence" has the meaning set out in section Error! Reference source not found.;
- (y) "Shared Vehicle Minimum Term" means the term of three (3) years for the Shared Vehicle, commencing from the later of the Commencement Date or the first date that the Shared Vehicle is made available for use by Modo Members at the Shared Vehicle Parking Space;
- (z) "Shared Vehicle" has the meaning set out in Recital E;
- (aa) "Shared Vehicle Parking Space" has the meaning set out in Recital F
- (bb) "Strata Corporation" means the strata corporation to be formed pursuant to the Strata Property Act upon deposit of the Strata Plan at the New Kamloops Land Title Office;
- (cc) "Development" has the meaning set out in Recital B;
- (dd) "Lands" has the meaning set out in Recital A;
- (ee) "Strata Lots" has the meaning set out in Recital C, and "Strata Lot" means any one of them;
- (ff) "Strata Plan" has the meaning set out in Recital C;
- (gg) "Strata Property Act" means S.B.C. 1998, c. 43, as amended, restated or replaced from time to time;
- (hh) "Subject Shares" has the meaning set out in section 2.1;
- (ii) "Sustainable Usage Levels" means the level of use of the Modo vehicles by Modo Members that remains cost-effective to meet Modo's usage goals; and,
- (jj) "Term" means the term of this Agreement as described in section 9.1.

#### ARTICLE 2 - PROJECT FEE

2.1 At least sixty (60) days prior to Estimated Occupancy Date, Developer will pay to Modo the aggregate sum of \$32,000.00 plus GST (the "Project Fee"), representing the following:

- \$1,000.00 for the purchase of one hundred (100) Membership Shares (the "Subject Shares"); and
- (b) the Project Fee minus \$1,000.00 to be used by Modo toward the ownership costs of the Shared Vehicle.
- 2.2 Upon payment of the Project Fee, Modo will issue the Subject Shares to Developer and will issue a receipt to Developer confirming payment of the Project Fee to Modo.
- 2.3 Developer agrees that Modo will not be under any obligation whatsoever to provide the Services or issue the Subject Shares if Modo has not received full payment of the Project Fee from Developer by the required deadline set out in section 2.1 of this Agreement.
- 2.4 If the Occupancy Permit is issued later than in the year 2026, the Project Fee will increase by 4% for each year thereafter, on January 1<sup>st</sup> of such year and until the Occupancy Permit is issued, including the year the Occupancy Permit is issued.

### ARTICLE 3 - BENEFITS AND OBLIGATIONS OF DEVELOPER

- 3.1 Developer agrees to designate the Shared Vehicle Parking Space for the exclusive use of Modo as set out in Schedule A hereto, in compliance with the standards set out in Schedule B and free-of-charge to Modo from the Commencement Date and throughout the Term.
- 3.2 Developer agrees that throughout the Term, subject to section 11.5, the Shared Vehicle Parking Space will be accessible to Modo Members on a 24 hours a day, 7 days a week basis.
- 3.3 Developer permits Modo to directly authorize removal of unauthorized vehicles parked in the Shared Vehicle Parking Space through the towing company contracted by Developer, or a towing company of Modo's choice in the event there is not a designated contractor or if that contractor is unavailable. Any unauthorized vehicle parked in the Shared Vehicle Parking Space may be removed by Modo at the vehicle owner's risk and expense.
- 3.4 Developer agrees that from the Commencement Date and throughout the Term, the EV Station will be operational and designated for the exclusive use of Modo.
- 3.5 At least sixty (60) days prior to the date Developer anticipates that the Occupancy Permit will be issued, Developer will provide written notice to Modo of such estimated date (the "Estimated Occupancy Date").
- 3.6 Promptly upon issuance of the Occupancy Permit, Developer will further provide Modo with written notice of the Commencement Date.

- 3.7 Upon completion of Developer's obligations under section 2.1 and assumption of this Agreement by the Membership Holder pursuant to section 4.1, Developer will cause the Subject Shares, which together form the Partnership Membership, to be transferred to and registered in the name of the Membership Holder and the Membership Holder will hold the Subject Shares on behalf of and for the benefit of the Residents, subject to section 5.4.
- 3.8 Developer warrants that it will cause its subsidiaries and any party which may manage or operate the Development from time to time to comply with the terms of this Agreement and will cause any of its successors or permitted assigns to enter into an assumption agreement, provided that, upon such assumption, Developer will be released of its obligations hereunder to the extent its obligations are so assumed.

### ARTICLE 4 - ASSUMPTION BY MEMBERSHIP HOLDER

- 4.1 Upon the filing of the Strata Plan, Developer will:
  - (a) assign the Developer's interest in and to this Agreement to the Strata Corporation;
  - (b) cause the Strata Corporation to assume: (i) Developer's covenants and obligations under this Agreement as it relates to the Development; and (ii) any other covenants and obligations under this Agreement as it relates to the Development which are expressly identified as covenants or obligations of the Strata Corporation or the Membership Holder; and
  - (c) transfer an undivided interest in and to the Subject Shares to the Strata Corporation concurrently with such assumption, and Modo hereby consents to such transfer.
- 4.2 Effective upon the assumption of this Agreement by the Membership Holder pursuant to section 4.1, Developer and its nominees, subsidiaries and other affiliates will have no further obligations or liabilities whatsoever hereunder.

### ARTICLE 5 - BENEFITS AND OBLIGATIONS OF THE MEMBERSHIP HOLDER

- 5.1 The parties agree that, following the transfer described in section4.1, Subject Shares will be registered in the name of the Membership Holder. The Membership Holder will be the legal owner of all the Subject Shares, and their beneficial interest will vest in the Residents in accordance with this Agreement.
- 5.2 The Subject Shares, and the benefit of the Partnership Membership, will not be allocated or divided in any manner as between the Residents, and there will be no limit on the number of Residents of any Strata Lot that may apply to be Partner Users at any given time (subject to the overall limit on the number of Partner Users set out in section 6.1).

- 5.3 The parties agree that the Residents will not automatically become Modo Members and must apply to join Modo and meet Modo's membership requirements in order to be eligible to use the Shared Vehicle and participate in the Carsharing Program.
- 5.4 The Membership Holder agrees that, upon assuming this Agreement, it will:
  - administer the Partnership Membership in accordance with the rules set out in Schedule D hereto (the "Rules");
  - use reasonable commercial efforts to make available to the Residents the Rules; and
  - (c) at all times retain ownership of the Subject Shares.
- 5.5 Every six (6) months during the Term (commencing within six (6) months after the Commencement Date), Modo will provide the Strata Corporation in writing with the name of each Partner User.
- 5.6 Within thirty (30) days after receipt of the information, referred to in section 5.5, the Membership Holder will confirm to Modo in writing which Partner Users have, to the best of the applicable Membership Holder's knowledge, ceased to be Residents, and Modo will cancel such Partner Users' benefits of the Partnership Membership and such former Residents will cease to be Partner Users.
- 5.7 The Strata Corporation agrees to pay for the electricity withdrawn from the EV Station when due and Modo will reimburse the Strata Corporation in accordance with section 6.15.

#### ARTICLE 6 - BENEFITS AND OBLIGATIONS OF MODO

- 6.1 Modo agrees that the Partnership Membership will allow up to a maximum number of Residents to be Partner Users at any given time, such maximum number to be equal to the Project Fee paid hereunder at such given time divided by \$500, rounded down to the closest whole number. For greater certainty, once the foregoing number of Partner Users has been reached, no other Resident may become a Partner User unless an existing Partner User ceases to be a Partner User.
- Any number of Residents of any given Strata Lot may apply to Modo to become Partner Users, and each such Resident who becomes a Partner User will count as a separate Partner User for the purposes of the limit set out in section 6.1.
- 6.3 Modo covenants and agrees that the Partnership Membership will grant Partner Users the benefit of usage of Modo vehicles at the same usage rates as shareholders of Modo but without voting rights.
- 6.4 Modo will use the Project Fee, less the amount required to purchase the Subject Shares, toward the ownership costs of one (1) new four-wheeled automobile with

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# DP23-0084	
	City of
Planner Initials KB	Kelowna

electric motorization, provided that Modo may temporarily use new four-wheeled automobile with internal combustion engine as the Shared Vehicle if Modo is unable to procure and deliver a new four-wheeled automobile with electric motorization within the time period set out in the Shared Vehicle Deployment Sequence. In the event that Modo is temporarily using a four-wheeled automobile with internal combustion engine as the Shared Vehicle, Modo will use reasonable commercial efforts to replace such automobile with a new four-wheeled automobile with electric motorization as soon as possible after the Commencement Date at no additional cost to Developer or the Membership Holder.

- 6.5 Forthwith upon the purchase of the Shared Vehicle, Modo will provide Developer with a copy of the Shared Vehicle's registration evidencing that the Shared Vehicle is registered in the name of Modo together with proof of insurance.
- 6.6 Modo will deliver the Shared Vehicle to the Shared Vehicle Parking Space and will make the Shared Vehicle available for use by Modo Members in accordance with the terms of this Agreement and pursuant to the Shared Vehicle Deployment Sequence.
- 6.7 In the event that the Occupancy Permit is not issued within thirty (30) days after the Estimated Occupancy Date, Modo reserves the right to park the Shared Vehicle at another location suitable for its use within the Carsharing Program and make them available for use by Modo Members, provided always that Modo will deliver the Shared Vehicle to the Shared Vehicle Parking Space by no later than the date(s) set out in the Shared Vehicle Deployment Sequence.
- 6.8 Modo agrees to provide the Shared Vehicle for the use of Modo Members and to cause the Shared Vehicle to be parked in the Shared Vehicle Parking Space at all times when not in use by a Modo Member and when not being repaired or serviced.
- 6.9 Modo will be the sole provider of the Carsharing Program in respect of the Shared Vehicle during the Term.
- 6.10 The parties agree that Modo will not be responsible for any costs related to the use of and access to the Shared Vehicle Parking Space during the Term, including, without limitation, the maintenance of the Shared Vehicle Parking Space.
- 6.11 Notwithstanding the foregoing, Modo must promptly and at its own expense clean up any oil or other substance which spills or leaks from the Shared Vehicle into or onto any part of the Development, failing which Developer may clean up such spill or leak, and Modo will, forthwith on demand reimburse Developer for the cost thereof.



- 6.12 Modo will at its sole expense provide Developer with appropriate signage for the Shared Vehicle Parking Space.
- 6.13 Modo will be solely responsible for providing and paying for the Services, including but not limited to the operation, administration, maintenance, repair, replacement and insurance costs in respect of the Shared Vehicle and the Carsharing Program in a prudent manner. If the Shared Vehicle is damaged beyond repair during the Shared Vehicle Minimum Term, then Modo will promptly replace the Shared Vehicle with a vehicle of at least equivalent value and function and such replacement vehicle will constitute the Shared Vehicle for all purposes hereunder.
- 6.14 The parties agree that Developer and the Membership Holder will not be responsible for any costs associated with the Shared Vehicle, the Carsharing Program or the Services, including, without limitation, any applicable taxes or delivery fees in respect of the purchase of the Shared Vehicle or any user or membership fees of any of the Residents, other than the payment of the Project Fee and the maintenance, use of and access to the Shared Vehicle Parking Space and EV Station.
- 6.15 Modo will reimburse the Strata Corporation the amount paid by the Strata Corporation for the electricity withdrawn from the EV Station, based on data logs and reports from the EV Station. The reimbursement will be made in arrears on a yearly basis, starting on the Commencement Date or such other date as may be agreed upon by the Strata Corporation and Modo.
- 6.16 Modo reserves the right to temporarily relocate the Shared Vehicle parked from the Shared Vehicle Parking Space if the Shared Vehicle Parking Space cannot be used as contemplated in section 3.1 or 3.2 and for a duration greater than twenty-four (24) consecutive hours, provided that once the Shared Vehicle Parking Space is available for use as contemplated in sections 3.1 and 3.2, Modo will promptly the Shared Vehicle back to the Shared Vehicle Parking Space.
- 6.17 Modo reserves the right to temporarily relocate the Shared Vehicle parked in the Shared Vehicle Parking Space if the EV Station cannot be used as contemplated in section 3.4 for a duration greater than twenty-four (24) consecutive hours, provided that once the EV Station is available for use as contemplated in section 3.4, Modo will promptly return the Shared Vehicle back to the Shared Vehicle Parking Space.
- 6.18 Modo will provide orientation to all Residents wishing to participate in the Carsharing Program.
- 6.19 Modo will provide Developer with marketing materials to promote participation in the Services to Residents and prospective residents of the Development.

- 6.20 Modo confirms and agrees that, in accordance with Modo's membership documentation, each Resident will be individually responsible for any and all actions, causes of action, costs or claims of whatsoever type or nature levied or made by Modo or by any other person as a result of or in connection with such Resident's participation in the Services or otherwise arising from the Subject Shares of, or membership in, Modo held by the Membership Holder or its affiliates, subsidiaries, successors or assigns.
- 6.21 Modo represents and warrants that there are no other obligations associated with the holding of the Subject Shares by the Membership Holder beyond those which are contemplated in this Agreement, in the Rules, or at law.

### ARTICLE 7 - MARKETING AND ASSESSMENT

- 7.1 Modo acknowledges that the Strata Lots will be occupied by Residents that will change over time.
- 7.2 Modo will establish a marketing program (the "Marketing Program") where Modo will, within fifteen (15) days following the Commencement Date, credit \$100 of driving credits ("Driving Credits") to the Modo account of each Resident who becomes a Modo Member for the first time, which Driving Credits will only be applied to fees for usage of Modo vehicles, for the duration of the Term.
- 7.3 Throughout the duration of the sale and closing stages of the Development, Developer agrees to communicate the benefits of the Carsharing Program to prospective residents and Residents. This will be done through Developer's existing communications channels such as email, website, collateral, sales agents and property managers, with the intent to raise awareness and usage of the Services, and with the information and materials in support provided by Modo, including:
  - (a) a short description of Modo, the Services, the Driving Credits and the Partnership Membership on the Development's website (if applicable);
  - (b) to the extent permitted by law, a direct email or mail to the Residents shortly after such Residents have moved into the Development, with a link to a dedicated "welcome" page on Modo's website;
  - (c) to the extent permitted by law, a follow up direct email or mail to the Residents six (6) months after first occupation of the Development, with a link to a dedicated "welcome" page on Modo's website; and
  - a small notice (sticker or poster) in a prominent location (i.e. elevator, community room), providing a short description of the Services, the Driving Credits and the Partnership Membership,

and the Membership Holder consents and agrees to the foregoing and will take such steps as reasonably required to assist Developer in carrying out the foregoing obligations.

- 7.4 From the date of this Agreement until the termination of this Agreement,
  Developer and Modo will allow use of each other's graphics in advertising and
  promotional activities conducted by either party. Such use of graphics must be in
  a manner whereby the graphics remain in their original form and each party will
  use the most recent version of the other party's graphics (as approved by each
  party in writing).
- 7.5 Developer and Modo will only use each other's wordmarks, logos or trade names pursuant to section 7.4 solely in connection with activities relating to the Development. Any other use must receive the prior written approval of each party (by mail or electronic mail).
- 7.6 The Membership Holder will permit Modo to assess, not more than once a year, the impacts of its Services by facilitating the administration of assessment measures including, but not limited to (and to the extent permitted by law), the distribution of emails, surveys and questionnaires for the relative to the Services, provided that the Residents, in their sole discretion, may elect not to participate in any such assessment measures.

### **ARTICLE 8 - SECURITY INTEREST**

- 8.1 Subject to receipt of the Project Fee, Modo agrees to grant to Developer a security interest in the Shared Vehicle and to execute and deliver to Developer a security agreement in substantially the form attached as Schedule E hereto.
- 8.2 Modo acknowledges and agrees that Developer may register a security interest in the Shared Vehicle for a term equal to the Shared Vehicle Minimum Term in the British Columbia Personal Property Registry.

### **ARTICLE 9 - NO FIXED TERM**

9.1 The term (the "Term") will commence on the date this Agreement is executed by the parties. This Agreement will not have a fixed term and will continue in full force and effect until terminated in accordance with the terms hereof provided that Modo agrees to provide the Services in respect of each Shared Vehicle for a minimum term equal to the Shared Vehicle Minimum Term.

### **ARTICLE 10 - MUTUAL REPRESENTATIONS**

- 10.1 Each party represents and warrants to the other that:
  - it is an entity duly organized and validly existing under the laws of its jurisdiction of organization or incorporation;

- it has the requisite power and authority to enter into this Agreement and to carry out its obligations under this Agreement; and
- (c) such party's obligations under this Agreement constitute legal, valid and binding obligations, enforceable against such party in accordance with the terms herein.

### **ARTICLE 11 - TERMINATION AND AMENDMENT**

- 11.1 Developer and Modo agree that, if after execution of this Agreement, Developer does not receive approval for a development permit, a building permit or any other permit necessary to construct and complete the Development from the Municipality then Developer will give notice of same and thereafter this Agreement will terminate and both parties will be relieved of their obligations herein, except as expressly set out herein.
- 11.2 No amendment, addition, deletion or other modification to this Agreement will be effective unless in writing and signed by each party.
- 11.3 During the Shared Vehicle Minimum Term, this Agreement may not be amended or terminated without the prior written consent of the General Manager of Engineering Services of the Municipality.
- 11.4 Notwithstanding sections 11.2 and 11.3, Modo reserves the right to make reasonable amendments to the rules governing the Membership Shares and ownership of the Subject Shares as set out in Schedule D, so long as such changes apply equally to all Residents. Upon any amendments, Modo will immediately notify the Membership Holder, following which the Membership Holder will notify the Residents of such amendments.
- 11.5 Developer and Modo agree that, if the usage of the Shared Vehicle falls below Sustainable Usage Levels, and only after the Shared Vehicle Minimum Term has expired, Modo may exercise its right, in its sole discretion, to: (i) replace the Shared Vehicle with any vehicle of Modo's choice, or (ii) relocate the Shared Vehicle from the Shared Vehicle Parking Space, in each case so as to ensure that the terms of the Agreement are not oppressive to Modo or its members.
- 11.6 In the event of relocation of the Shared Vehicle pursuant to section 11.5, then the Shared Vehicle Parking Space will no longer need to be made available to Modo and sections 3.1 to 3.4, 5.7, 6.8, 6.9, 6.12 and 6.15 will cease to apply, and Modo will not be obligated hereunder to provide the Services or make the Shared Vehicle available for use of Residents, but, for greater certainty, the Partnership Membership will continue in effect. For the avoidance of doubt, in the event of a replacement of the Shared Vehicle pursuant to section 11.5, this section 11.6 will not apply.

- 11.7 If the Development is destroyed and not rebuilt in a form substantially similar to the original buildings, either of the parties may terminate this Agreement and in such case Modo will cancel the Subject Shares held by the Membership Holder, and the Membership Holder will not be entitled to a refund of the purchase price paid for the Subject Shares or any part thereof.
- 11.8 Either party will have the right to terminate this Agreement forthwith on the dissolution, winding up or bankruptcy of the other party.

### **ARTICLE 12 - DEFAULT**

12.1 A party claiming default under the terms of this Agreement must provide the defaulting party with written notice of the default. If the defaulting party fails to correct the default within thirty (30) days of receipt of such written notice, the party claiming default may deliver notice of dispute in accordance with section 13.1(a) and proceed with the dispute resolution procedures provided for in ARTICLE 13 -.

### **ARTICLE 13 - DISPUTE RESOLUTION**

- 13.1 If a dispute arises between the parties in connection with this Agreement, then Developer and Modo agree to use the following procedure to resolve the dispute:
  - (a) the party initiating the dispute will send a notice of dispute in writing to the other party which notice will contain the particulars of the matter in dispute and the relevant provisions of this Agreement and the responding party will send a notice of reply in writing to the other party to the dispute within ten (10) days after receipt of the notice of dispute, setting out particulars of its response and any relevant provisions of the Agreement;
  - (b) if the dispute remains unresolved for thirty (30) days after a notice of dispute has been issued as per section 13.1 (a)., or if a default is not cured within thirty (30) days after either party notifies the other of such default, the parties will agree upon and appoint a Mediator for the purpose of mediating such dispute. The appointment of the Mediator will be carried out in accordance with the terms and conditions of an agreement to be entered into between the parties and the Mediator which will set out the terms of reference for the engagement of the Mediator. The Mediator will conduct a non-binding mediation of the dispute according to the rules and procedures as determined by the Mediator. If the parties fail or neglect to agree upon a Mediator within ten (10) days following the end of the relevant 30-day period referred above, the dispute will be resolved by an Arbitrator (as defined below) in accordance with section 13.1(d). No individual with any direct or indirect interest in the subject matter of this Agreement or any direct or indirect interest in the parties to this Agreement may be appointed as a Mediator;

- (c) if the dispute has not been resolved within ten (10) days after the Mediator has been appointed under section 13.1(b), or within such further period agreed to by the parties, the Mediator will terminate the mediated negotiations by giving notice in writing to both parties;
- except for claims for injunctive relief, all claims and disputes between the (d) parties to this Agreement arising out of or relating to this Agreement which are not resolved by the Mediator in accordance with section 13.1, will be decided by final and binding arbitration before a single arbitrator (the "Arbitrator") in accordance with the Arbitration Act (British Columbia). The parties will agree upon the Arbitrator within fifteen (15) days of the Mediator terminating the mediated negotiations. Failing such agreement between the parties, such Arbitrator will be finally chosen by reference to a Judge of the Supreme Court of British Columbia. The Arbitrator will not have any direct or indirect interest in the subject matter of the Development or any direct or indirect interest in either party of subsidiaries of the parties to this Agreement. No arbitration arising out of or relating to this Agreement will include, by consolidation or joinder or in any other manner, an additional person not a party to this Agreement, except by written consent containing specific reference to this Agreement and signed by each party and any other person sought to be joined. This provision will be specifically enforceable in any Court of competent jurisdiction;
- (e) the parties covenant and agree that the Arbitrator appointed hereunder will have the power to, among other things, specifically declare that a party to this Agreement is in default of the terms of the Agreement and, in appropriate circumstances, declare that the Agreement is terminated and award damages for breach of contract or otherwise;
- (f) an award or order rendered by the Arbitrator will be final and binding upon the parties, and judgment may be entered upon it in accordance with applicable law in any Court having jurisdiction within the Province of British Columbia;
- unless otherwise agreed in writing by the parties, the parties will continue to meet their obligations under this Agreement while the mediation and arbitration processes are continuing; and
- (h) the parties will each bear their own costs in connection with the foregoing and all costs of any mediation or arbitration (including the cost of the Mediator and the Arbitrator) will be shared equally by the parties.
- 13.2 The dispute resolution provisions of section 13.1 will survive termination of this Agreement in respect of any dispute resolution process that is commenced under section 13.1 prior to the date of termination.

### **ARTICLE 14 - NOTICES**

- 14.1 Notices under this Agreement will be given in writing by personal delivery or by email to the following addresses or electronic mail addresses set out below:
  - (a) Developer:
    - 1100-1631 Dickson Avenue, Kelowna, BC V1Y 0B5
    - Email: RTamblyn@MillennialDev.ca
  - (b) · Modo
    - 200 470 Granville Street, Vancouver, BC, V6C 1V5
    - Email: info@Modo.coop
- 14.2 All notices will be deemed to have been delivered on the date of delivery, if delivered, and on the next business day following, if emailed.
- 14.3 Addresses for notices may be amended by written notice from one party to the other.

### ARTICLE 15 - ASSIGNMENT

15.1 Neither party will transfer or assign this Agreement to any other party without the prior written consent of the parties to this Agreement, which consent will not be unreasonably withheld. Notwithstanding the foregoing, Developer may assign this Agreement to the Strata Corporation without Modo's prior consent but on notice to Modo, which notice will include the contact information of the parties to which the Agreement is being assigned.

### **ARTICLE 16 - INDEMNITY**

16.1 Each party agrees to indemnify and save harmless the other party from and against all losses, costs, damages, suits, actions, causes of action, claims or demands in any way resulting from, connected with or arising out of the first party's breach of its obligations under this Agreement. This section 16.1 will survive the termination of the Agreement.

### **ARTICLE 17 - GENERAL**

17.1 Nothing in this Agreement nor the acts of the parties will be construed, implied or deemed to create an agency, partnership or joint venture relationship between the parties. Neither party has the right or authority to, and will not, assume or create any obligation of any nature whatsoever on behalf of the other party or bind the other party in any respect whatsoever.

- 17.2 This Agreement constitutes the entire agreement between the parties with respect to the subject-matter hereof and cancels and supersedes any prior understandings and agreements between the parties with respect thereto. There are no representations, warranties, terms, conditions, undertakings or collateral agreements, express, implied or statutory, between the parties other than as expressly set forth in this Agreement. For avoidance of the doubt, this Agreement supersedes and replaces the agreement made between the parties on June 20<sup>th</sup>, 2023.
- 17.3 Any provision of this Agreement that is or becomes unenforceable will be unenforceable to the extent of such unenforceability without invalidating the remaining provisions hereof.
- 17.4 Any waiver or consent will be effective only in the instance and for the purpose for which it is given. No failure or delay on the part of either party in exercising any right, power or privilege under this Agreement will constitute a waiver thereof nor will any single or partial exercise of any right, power or privilege preclude any other or further exercise thereof or the exercise thereof or the exercise of any other right, power or privilege.
- 17.5 This Agreement will enure to the benefit of and be binding upon the parties and their heirs, executors, administrators, personal representatives, respective successors and permitted assigns.
- 17.6 The parties will at all times do, execute, acknowledge and deliver such acts, deeds, agreements and other instruments as may be reasonably necessary or desirable to give full force and effect to the terms of this Agreement.
- 17.7 This Agreement will be governed by and construed in accordance with the laws of the Province of British Columbia, and the federal laws of Canada applicable therein and each party irrevocably attorns to the exclusive jurisdiction of the courts of the Province of British Columbia.
- 17.8 This Agreement may be executed in any number of counterparts, each of which will be deemed to be an original and all of which taken together will be deemed to constitute one and the same instrument. Delivery of an executed counterpart of this Agreement by facsimile or electronic means will be equally effective as delivery of a manually executed counterpart thereof.

[Remainder of page intentionally left blank; signature page to follow.]



IN WITNESS WHEREOF the parties have executed this Agreement as of the date first written above.

By Modo:

MODO CO-OPERATIVE, by its authorized signatory

By:

Name: Sylvain Celaire

Title: Director of Business Development


By Developer:

**COLLINSON RISE LP**, by its authorized signatory



# SCHEDULE A SHARED VEHICLE PARKING SPACE

[NDLR: Insert plan showing location and dimensions of parking space]

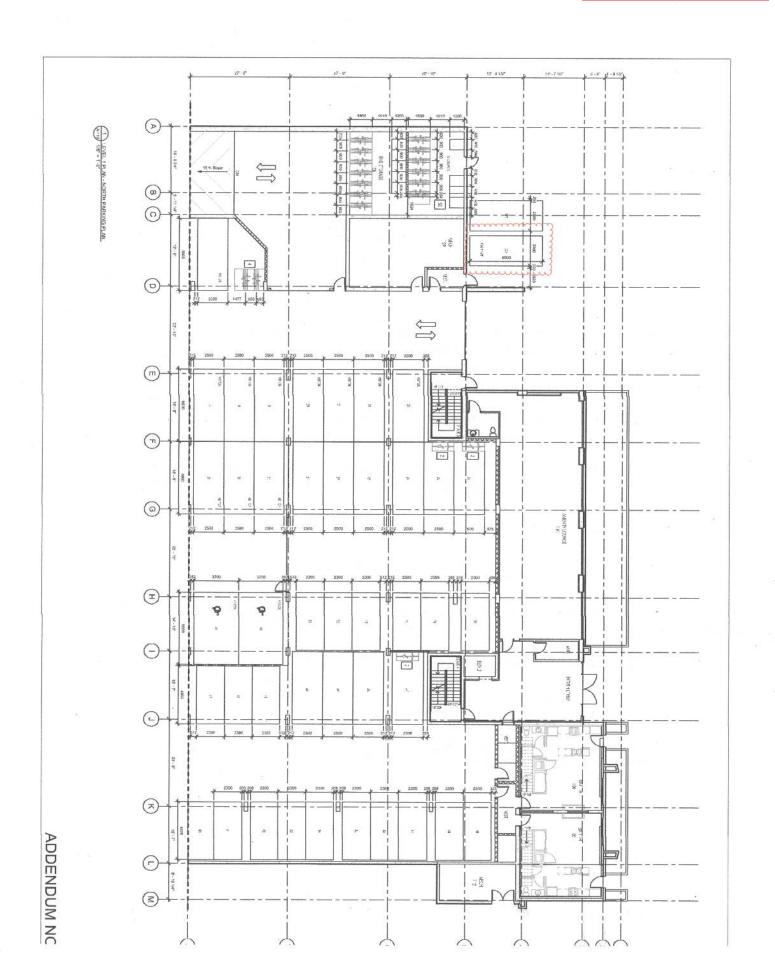

# SCHEDULE B CONSTRUCTION STANDARDS FOR SHARED VEHICLE PARKING SPACE

The Shared Vehicle Parking Space shall be constructed to the satisfaction of the General Manager of Engineering Services of the municipality where the Shared Vehicle Parking Space is being constructed, and in accordance with the following specifications and requirements:

### 1. General

The Shared Vehicle Parking Space shall be constructed, finished and designated in accordance with applicable municipal building permits, by-laws, policies and guidelines, including the municipal standards as required by the Parking By-law and Building By-law applying to the property upon which the Shared Vehicle Parking Space is being constructed.

### 2. Dimensions

The Shared Vehicle Parking Space dimensions shall be standardized:

- The minimum height shall be 2.0 meters.
- The minimum width shall be 2.9 meters.
- The minimum length shall be 5.5 meters.

Tandem parking shall not be permitted. Perpendicular and angle parking shall be preferred.

Where one side of a Shared Vehicle Parking Space abuts any portion of a fence or structure, there shall be a horizontal clearance of at least 30 centimetres between such side of the Shared Vehicle Parking Space and the said fence or structure.

### 3. Location

It is preferred to locate the Shared Vehicle Parking Space at either street level or lane level. If locating the Shared Vehicle Parking Space at street level or lane level is not feasible, the Shared Vehicle Parking Space shall be located at the parking level of the parkade closest to the street level, second only in selection to the siting of disability parking spaces.

If the Shared Vehicle Parking Space is located underground or above ground, the location of the Shared Vehicle Parking Space will be chosen to ensure the greatest possible visibility of the space and most convenient access to the building, second only in selection to the siting of disability parking spaces.

When several Shared Vehicle Parking Space are provided, the spaces shall be located next to each other or in close proximity.



# 4. Access

Permitted users of the Shared Vehicle to be parked on the Shared Vehicle Parking Space must have the ability to access the Shared Vehicle Parking Space 24 hours a day, 7 days a week.

The procedure for permitted users to self-access the Shared Vehicle Parking Space by foot when the Shared Vehicle Parking Space is located in a gated parkade shall consist in typing a code on a keypad or swiping a key fob on a fob reader. The procedure shall be simple and consistent to prevent access disruption.

In the event that a keypad is being used to provide access to the Shared Vehicle Parking Space, it should be possible to change the code of the keypad over time.

The procedure for permitted users to depart from and return to the parkade with a Shared Vehicle when the Shared Vehicle Parking Space for the Shared Vehicle is located in a gated parkade shall consist in typing a code on a keypad or swiping a key fob on a fob reader or using a remote control. The procedure shall not require for the permitted users to step out of the Shared Vehicle to perform the procedure.

In the event that remote controls are being used for permitted users to depart from and return to the parkade with a Shared Vehicle, Modo shall be provided with one more remote control than the number of Shared Vehicle to be parked in the parkade.

The location of the Shared Vehicle Parking Space and procedure to access the Shared Vehicle Parking Space in a gated parkade shall be designed to mitigate potential security concerns from users of the parkade.

# 5. Maneuverability

The location of the Shared Vehicle Parking Space will be chosen to ensure the Shared Vehicle can be parked in the Shared Vehicle Parking Space driving forward with an angle of approach between 0° and 90°.

An angle of approach to park the Shared Vehicle in the Shared Vehicle Parking Space between 90° and 180° or the need to park the Shared Vehicle in reverse shall not be permitted.

The location of the Shared Vehicle Parking Space shall not require a maneuver more complex than a three-point turn to drive the Shared Vehicle out of the Shared Vehicle Parking Space.

If the Shared Vehicle Parking Space is located in a parkade with an entry/exit ramp, the location of the Shared Vehicle Parking Space shall not require for the Shared Vehicle to be driven in reverse to exit the parkade.

# 6. Signage

The Shared Vehicle Parking Space shall be clearly designated with signage and pavement markings.

Clear, visible and legible signs shall be placed directing users of the Shared Vehicle to the location of the Shared Vehicle Parking Space, indicating which parking space is the Shared Vehicle Parking Space and marking it as being reserved for the exclusive purpose of parking a Shared Vehicle.

A symbol (similar to that approved for a disability space) shall be stamped/painted on the Shared Vehicle Parking Space.

### 7. Lighting

The Shared Vehicle Parking Stall shall be illuminated to the satisfaction of the General Manager of Engineering Services of the municipality where the Shared Vehicle Parking Space is being constructed with:

- average illumination levels of 11 Lux with a uniformity ratio (average level to minimum level) of 3:1;
- luminaires situated in such a way so as not to directly throw light onto streets, lanes, or adjacent properties; and
- a photocell or equivalent switch that will activate the lighting system when ambient light levels are 11 Lux or less.

### 8. Connectivity

Sufficient 3G and/or 4G LTE cellular network reception signal of the cellular network used for the operation of the Shared Vehicle shall be supplied at the Shared Vehicle Parking Space to ensure the reliable operation of the Shared Vehicle service, with:

- a Received Signal Strength Indicator (RSSI) for 3G cellular network superior to -86 dBm; and
- a Reference Signal Received Power (RSRP) for 4G LTE cellular network superior to -106 dBm.

# 9. Electric Vehicle charging infrastructure

The Vehicle Parking Space shall be provided with an EV Station (as defined below) featuring:

 an RFID card reader to enable/disable power distribution, which card reader must be programmable to authorize a defined set of RFID cards; and

ATTACHMENT D

This forms part of application
# DP23-0084

City of

Planner Initials

KB

Kelowna

DEVELOPMENT PLANNING

 networking/telematic capabilities for which the adequate administration credentials/rights have been granted to Modo, allowing Modo to remotely monitor equipment status and collect utilization data.

EV Station means a 40 amp (minimum), 208-volt, single phase Level 2 electric vehicle charging level (as defined by SAE International's J1772 standard) charging outlet capable of charging an electric vehicle and includes all wiring, electrical transformer and other electrical equipment necessary to supply the required electricity for such outlet, and mechanical ventilation modifications, all of which is to be provided, installed, maintained and replaced by Developer, at Developer's sole cost and to be used for the sole purpose of supplying electricity to the Shared Vehicle Parking Space.



# SCHEDULE C SHARED VEHICLE DEPLOYMENT SEQUENCE

Commencement of Shared Vehicle deployment	Conditions for deployment of the Shared Vehicle		
Within seven (7) days after the Commencement Date.	<ul> <li>The Project Fee has been paid to Modo at least 60 days prior to the Estimated Occupancy Date as per section 2.1 of this Agreement;</li> </ul>		
*	The Shared Vehicle Parking Space are available for use by Modo as contemplated in sections 3.1 and 3.2.of this Agreement; and		
	<ul> <li>The EV Station is available for use by Modo as contemplated in section 3.4 this Agreement.</li> </ul>		



# SCHEDULE D PARTNERSHIP MEMBERSHIP RULES

1.	Th	e following terms have the following meanings:	
	(a)	"Development" means the residential development known as located at, British Columbia.	
	(b)	"Membership Holder" means the Strata Corporation (as defined below);	
	(c)	"Modo" means Modo Co-operative;	
	(d)	"Residents" means, collectively, residents of the Development, and each such resident is referred to herein as a "Resident";	
	(e)	"Strata Corporation" means the strata corporation for the Development; and	
2.	op the iss (th Ca	The Membership Holder has entered into, or has assumed an agreement (the "operative Carsharing Agreement") with Modo pursuant to which Modo grante the Membership Holder a Modo partnership membership ( the "Membership") be issuing to the Membership Holder a certain number of membership shares in M (the "Modo Shares") for the benefit of Residents, as set out in the Co-operative Carsharing Agreement, so Residents can benefit from Modo membership privileges without the need to themselves pay Modo membership fees.	
3.	nu ma	e Membership Holder will be the legal owner of the Modo Shares, and a certain mber of Residents, as further set out in the Co-operative Carsharing Agreement, by, on a continuing basis, enjoy the benefits of the Membership subject to set ing Modo's eligibility requirements as set out on Modo's website from time to	

4. Residents who are granted the rights and benefits of the Membership from time to time (the "Partner Users" and, each a "Partner User") will benefit from the same price plan for usage of Modo vehicles as other member shareholders of Modo but,

for clarity, will not have any voting rights in respect of the Membership or Modo.

- Any Resident may apply to become a Partner User, provided that membership
  privileges will be granted to applying and eligible Residents on a first-come, firstserved basis.
- 6. In order for a Resident to become a Partner User, the Resident must submit to Modo, an application including (but not limited) to the following:
  - (a) the applicant Resident, if the holder of a driver's licence issued in British Columbia, Canada, must prove current residency at the Development by providing Modo with a copy of its current driver's records indicating their address within the Development;
  - (b) the applicant Resident, if the holder of a driver's licence issued outside of British Columbia, Canada, must prove current residency at the Development



- by providing Modo with a copy of a bill indicating the name of the Resident and the Resident's address within the Development; and
- (c) the applicant Resident, must provide contact information and such other information regarding the Resident as may be reasonably required by Modo for the purposes of determining if the Resident qualifies for the Membership Eligibility Criteria.
- 7. Each Partner User will be responsible for and will save the Membership Holder harmless from any and all liabilities incurred by the Membership Holder and any and all actions, causes of action, costs or claims of whatsoever type or nature levied or made against the Membership Holder by Modo or by any other person, to the extent resulting from such Partner User's participation in the Membership and except to the extent resulting from the negligence or willful misconduct of the Membership Holder.
- A Resident may only be a Partner User and may only exercise the rights and benefits of the Membership while such Resident meets the Membership Eligibility Criteria.
- If at any time Resident who is a Partner User ceases to meet the Membership Eligibility Criteria, then the Resident will cease to be a Partner User and may only reapply to be a Partner User when the Resident again meets the Membership Eligibility Criteria.
- 10. Except as otherwise provided in these rules, a Partner User may only enjoy and exercise the benefits of the Membership while the Partner User is a Resident, and the benefits that a Partner User enjoys under the Membership may not under any circumstances be assigned, transferred or sold by the Partner User to any person.
- If a Partner User does not book a Modo vehicle at least once during a period of twelve (12) consecutive months, Modo may cancel such Partner User's participation in the Membership.
- 12. The Modo Shares remain at all times in the name of the Membership Holder.
- Partner Users may only make use of Modo vehicles in accordance with the policies and rules of Modo.
- These rules will have no further force or effect upon termination of the Co-operative Carsharing Agreement.



# SCHEDULE E SECURITY AGREEMENT

-

MODO CO-OPERATIVE 200 - 470 Granville Street, Vancouver, BC V6C IV5				
	(the "Grantor"	")		
IN FAVOUR OF:				
	(the "Secured	l Party")		
WHEREAS: A. The Secured Party has	financed the acquis	ition by the Gr	antor of the fo	llowing vehicle:
Make/Model:	n Number:		-0	
(the "Shared Vehic	le"); and			

B. The Grantor has agreed to deliver this Agreement to create security over the interest it has in the Shared Vehicle for the benefit of the Secured Party.

**NOW THEREFORE THIS AGREEMENT WITNESSES** that in consideration of the premises and the covenants and agreements herein contained the Grantor and the Secured Party hereby agree as follows:

- Security Interest in the Shared Vehicle. As security for the performance by the Grantor
  of its obligations set forth in the Co-operative Carsharing Agreement attached hereto (the
  "Co-op Car Agreement"), the Grantor grants to the Secured Party a security interest (the
  "Security Interest") in all of its present and future right, title and interest in and to the
  Shared Vehicle.
- 2. Grant of Security Interest in Proceeds of Collateral. The Grantor also grants the Secured Party a security interest in the proceeds derived directly or indirectly from any dealing with the Shared Vehicle, including but not limited to, accounts receivable, bills of exchange, insurance proceeds, chattel paper, intangibles, motor vehicles, and all other after acquired property constituting proceeds. The Grantor acknowledges that the Security Interest hereby created attaches upon the execution of this Security Agreement, that the value has been given and that the Grantor has rights in the Shared Vehicle.
- Use and Location of the Shared Vehicle. The Grantor will not sell, lease or otherwise dispose of the Shared Vehicle without the prior written consent of the Secured Party and



the Grantor will keep the Shared Vehicle in good condition, reasonable wear and tear excepted.

- 4. No Liens on Shared Vehicle. The Grantor will not permit any lien, charge, encumbrance or security interest (each, a "Lien") to attach to the Shared Vehicle which ranks prior to or equal with or could in any event rank prior to the equal with the rank of the Security Interest. The Grantor will not enter into any agreement with any person which would obtain prior or equal rank for any Lien over the rank of the 'Security Interest'.
- 5. Name of Grantor. The Grantor covenants not to change its name without giving fifteen (15) days' prior written notice to the Secured Party (so as to enable the Secured Party to amend its registration in respect of this Agreement and protect its rights hereunder).
- Default. It will be a "Default" under this Agreement if:
  - (a) the Grantor breaches or fails to perform any of the terms, conditions, obligations or covenants to be observed and performed by the Grantor under the Co-op Car Agreement, and persists in such failure or breach after thirty (30) days' notice by the Secured Party requiring that the Grantor remedy such failure or breach,
  - the Grantor commits an act of bankruptcy or becomes insolvent or files a proposal or a notice of intention to file a proposal,
  - (c) an assignment for the benefit of creditors under applicable bankruptcy or similar legislation is made or a petition is filed,
  - (d) an order is made, a resolution is passed, or any other step is taken for the bankruptcy, liquidation, dissolution or winding-up of the Grantor or for any arrangement or composition of its debts, or
  - (e) a receiver, receiver and manager or receiver-manager of the Grantor is appointed.
- 7. Remedies. The Security Interest is immediately enforceable, upon the occurrence of a Default, and the Secured Party, at its option, may exercise at any time following such Default any or all of the rights, remedies, privileges and powers available to it under this Agreement, the Personal Property Security Act (British Columbia) or any other applicable legislation. All rights, remedies, privileges and powers of the Secured Party hereunder are cumulative and no such right, remedy, privilege or power is exhaustive but is in addition to each other right, remedy, privilege and power of the Secured Party hereunder or under any other agreement, instrument or document now or hereafter existing at law or in equity or by statute.
- 8. **Costs of Enforcement.** The Grantor will be responsible for payment of all costs, charges and expenses (including legal costs on a solicitor and own client basis) of the Secured Party of and incidental to any proceeding taken to enforce the remedies of this Agreement.
- Loss, Injury or Destruction. The loss, injury or destruction of the Shared Vehicle will not operate in any manner to release the Grantor from its obligations to the Secured Party under the Co-op Car Agreement.

- 10. Term. The Security Interest granted hereunder will terminate and be of no further force and effect as of the expiry of the Shared Vehicle Minimum Term (as defined in the Co-Op Car Agreement) for the Shared Vehicle.
- Amendment. This Agreement may be altered or amended only by an agreement in writing signed by the parties hereto.
- Binding Effect. This Agreement will enure to the benefit of and be binding upon the heirs, executors, administrators, legal and personal representatives, successors and permitted assigns of the parties, as applicable.
- 13. **Governing Law.** This Agreement is governed by and will be construed in accordance with the laws of the Province of British Columbia and the laws of Canada applicable therein.
- 14. Counterparts. This Agreement may be executed in any number of counterparts, each of which will be deemed to be an original and all of which taken together will he deemed to constitute one and the same instrument.
- 15. **Execution by Electronic Means**. This Agreement may be executed by the Grantors and transmitted by facsimile or other electronic means, and when it is executed and transmitted this Agreement will be for all purposes as effective as if the Grantor had delivered an executed original Agreement.

IN WITNESS WHEREOF the Grant	or has executed this Agreem	ent on the	 day of
··			
MODO CO-OPERATIVE, by its aut	horized signatory		
By:			

Name: Title: