Development Permit & Development Variance Permit DP23-0011 DVP23-0123



This permit relates to land in the City of Kelowna municipally known as

2479 Hwy 97 N

and legally known as

Lot 2 of District Lot 125 and Section 22 Township 26 ODYD Plan KAP45081 Except Plans KAP47345 and KAP78607 and permits the land to be used for the following development:

Retail, Automotive & Equipment, and Offices

The present owner and any subsequent owner of the above described land must comply with any attached terms and conditions.

Date of Council Approval: August 15, 2023

Development Permit Area: Form & Character

Existing Zone: C2 – Vehicle Oriented Commercial
Future Land Use Designation: RCOM – Regional Commercial

This Development Permit is valid for two (2) years from the date of approval, with no opportunity to extend.

This is NOT a Building Permit.

In addition to your Development Permit, a Building Permit may be required prior to any work commencing. For further information, contact the City of Kelowna, Development Services Branch.

NOTICE

This permit does not relieve the owner or the owner's authorized agent from full compliance with the requirements of any federal, provincial or other municipal legislation, or the terms and conditions of any easement, covenant, building scheme or agreement affecting the building or land.

Owner: Victor Projects Ltd., Inc. No. BC1326399

Applicant: McElhanney Ltd.

Terry Barton

Development Planning Department Manager Planning & Development Services Date of Issuance





1. SCOPE OF APPROVAL

This Development Permit applies to and only to those lands within the Municipality as described above, and any and all buildings, structures and other development thereon.

This Development Permit is issued subject to compliance with all of the Bylaws of the Municipality applicable thereto, except as specifically varied or supplemented by this permit, noted in the Terms and Conditions below.

The issuance of a permit limits the permit holder to be in strict compliance with regulations of the Zoning Bylaw and all other Bylaws unless specific variances have been authorized by the Development Permit. No implied variances from bylaw provisions shall be granted by virtue of drawing notations that are inconsistent with bylaw provisions and that may not have been identified as required Variances by the applicant or Municipal staff.

2. CONDITIONS OF APPROVAL

THAT Council authorizes the issuance of Development Permit No. DP23-0011 and Development Variance Permit No. DVP23-0123 for Lot 2 of District Lot 125 and Section 22 Township 26 ODYD Plan KAP45081 Except Plans KAP47345 and KAP78607 located at 2479 Hwy 97 N, Kelowna, BC, subject to the following:

- a) The dimensions and siting of the building to be constructed on the land be in accordance with Schedule "A";
- b) The exterior design and finish of the building to be constructed on the land be in accordance with Schedule "B";
- c) Landscaping to be provided on the land be in accordance with Schedule "C";
- d) The applicant be required to post with the City a Landscape Performance Security deposit in the amount of 125% of the estimated value of the Landscape Plan, as determined by a Registered Landscape Architect;

AND THAT variances to the following sections of Sign Bylaw No. 11530 be granted:

Section 10.3(b)a.: Major Commercial Zones, Signage Regulations

To vary the maximum number of non-illuminated Fascia or Window signs per business from 2 non-illuminated Fascia or Window Signs permitted to 1 non-illuminated Fascia sign and 3 Window Signs proposed.

Section 10.3(b)g.: Major Commercial Zones, Signage Regulations

To vary the maximum number of illuminated Fascia Signs per business from 2 illuminated Fascia Signs permitted to 10 illuminated Fascia Signs proposed.

AND FURTHER THAT this Development Permit & Development Variance Permit is valid for two (2) years from the date of Manager approval, with no opportunity to extend.

3. PERFORMANCE SECURITY

As a condition of the issuance of this Permit, Council is holding the security set out below to ensure that development is carried out in accordance with the terms and conditions of this Permit. Should any interest be earned upon the security, it shall accrue to the Developer and be paid to the Developer or his or her designate if the security is returned. The condition of the posting of the security is that should the Developer fail to carry out the development hereby authorized, according to the terms and conditions of this Permit within the time provided, the Municipality may use enter into an agreement with the property owner of the day to have the work carried out, and any surplus shall be paid over to the property owner of the day. Should the Developer carry out the development as per the conditions of this permit, the security shall be returned to the Developer or his or her designate following proof of Substantial Compliance as defined in Bylaw No. 12310. There is filed accordingly:

a) An Irrevocable Letter of Credit OR certified cheque OR a Surety Bond in the amount of \$321,860

Before any bond or security required under this Permit is reduced or released, the Developer will provide the City with a statutory declaration certifying that all labour, material, workers' compensation and other taxes and costs have been paid.

4. INDEMNIFICATION

Upon commencement of the works authorized by this Permit the Developer covenants and agrees to save harmless and effectually indemnify the Municipality against:

a) All actions and proceedings, costs, damages, expenses, claims, and demands whatsoever and by whomsoever brought, by reason of the Municipality said Permit.

All costs, expenses, claims that may be incurred by the Municipality where the construction, engineering or other types of works as called for by the Permit results in damages to any property owned in whole or in part by the Municipality or which the Municipality by duty or custom is obliged, directly or indirectly in any way or to any degree, to construct, repair, or maintain.

The PERMIT HOLDER is the <u>CURRENT LAND OWNER</u>. Security shall <u>ONLY</u> be returned to the signatory of the Landscape Agreement or their designates.





VEHICLE PARKING PROVIDED PARKING TYPE No. of SPACES ACCESSIBLE PARKING LOADING SPACE SMALL CAR STANDARD PARKING VAN ACCESSIBLE PARKING

SITE COVERAGE:

MAXIMUM ALLOWABLE SITE COVERAGE: 85%

CURRENT SITE AREA: 44,560.94m² CURRENT LANDSCAPED OR PERMEABLE AREA: 6,700.00 m²

TOTAL SITE COVERAGE: 85%

PARKING CALCULATION:

GENERAL PARKING REQURIEMENTS: COMMERCIAL / RETAIL C2 (COMMERICAL OVER 20,000m²): 3 SPACES / 100m² COMMERCIAL / SERVICE CENTER / TIRE WAREHOUSE C2 (COMMERICAL OVER 20,000m 2): 3 SPACES / 100m² WAREHOUSE: 0.5 SPACES / 100m²

INCLUDED IN TOTAL REQUIRED PARKING:

ACCESSIBLE SPACE REQUIREMENTS, GFA >20,000m² ACCESSIBLE: 7 SPACES, INCLUDING 2 VAN ACCESSIBLE

LOADING SPACE REQUIREMENTS: COMMERCIAL LOADING: 1 SPACE / 1900m² 10 SPACES TOTAL **LOADING SPACES PROVIDED: 10**

TOTAL PARKING REQUIRED:

COMMERCIAL - RETAIL AREA, SERVICE CENTER, TIRE STORAGE 11,673m ²: 352 SPACES WAREHOUSE - 7,128m²: 36 SPACES

TOTAL PARKING REQUIRED: 412 PARKING SPACES TOTAL PARKING CURRENTLY PROVIDED: 412 PARKING SPACES

BICYCLE PARKING CALCULATION: 39 BIKE PARKING REQUIREMENTS: SHORT TERM BIKE PARKING: 4.0 / ENTRANCE

SHORT TERM SPACES: 8 LONG TERM: SPACES: 39

CURRENTLY PROVIDED:


4 TOILETS 4 LAVATORIES

4 SHOWERS 0.5 LOCKERS / LONG TERM BICYCLE SPACE

END OF TRIP BICYCLING FACILITIES TO BE PROVIDED INSIDE BUILDING.

REFER TO LANDSCAPE AND CIVIL DRAWINGS FOR PLANTING, GRADING, SIDEWALK MODIFICATIONS AND TURNING STUDIES NOMINALLY SHOWN ON ARCHITECTURAL PLANS. REFER TO TRAFFIC ENGINEERING

STATISTICS		(IMPERIAL/METRIC)	
		CT PROPOSED RETAIL	
		EXTENSION	
	RETAIL		
1	GROUND FLOOR	107,333 / 9,972	58
	WAREHOUSE		
2	GROUND FLOOR	45,482 / 4,225	
3	ECOMM	1,381 / 128	
4	MEZZANINE	29,858 / 2,774	
5	TOTAL	76,721 / 7,128	42
	SERVICE CENTRE		
6	GROUND FLOOR	14,201 / 1,319	
7	MEZZANINE	533 / 50	
8	TOTAL	14,734 / 1,369	
	OFFICES		
9	GROUND FLOOR	2,835 / 263	
10	MEZZANINE	3,235 / 301	
11	TOTAL	6,070 / 564	
	GROUND FLOOR COVERAGE		
12	CTC TOTAL (ROWS 9+6+3+2+1)	171,232 / 15,908	
13	2HR FIRE RATED TIRE STORAGE	4,090 / 382	
14	TOTAL (13+12)	175,322 / 16,290	}
15	BUILDING STRUCTURAL AREA (ROWS 14+10+7)	179,116 / 16,640	
16	BUILDING FUNCTIONAL AREA (ROWS 15+4)	208,974 / 19,414	
	GARDEN CENTRE		
17	CANOPY	-	
18	COMPOUND	25,683 / 2,386	
19	TOTAL	25,683 / 2,386]
20	CTC TOTAL GROUND COVERAGE (ROW 14)	175,322 / 16,290	
21	CTC STORE SITE AREA	7.52 AC / 3.04 HA	
22	CTC STORE SITE PARKING	398	1
23	PARKING RATIO / 1000S.F	24.43	
24	PARKING RATIO / 100 S.M	2.44	1

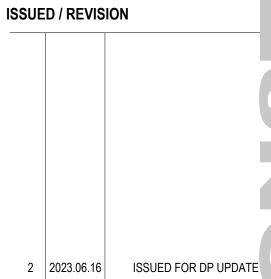

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ARCHITECTURE INC. to any party with whom NEXT ARCHITECTURE INC. has not entered into a contract. This drawing shall not be used for construction purposes until it is issued for the purpose. The contractor is solely responsible for verification of all site conditions in relation to the architectural design. The contractor is to verify all dimensions, elevations and set out points, reporting any errors and/or discrepancies to NEXT ARCHITECTURE INC. prior to construction.

True North

CTR 353 KELOWNA

2479 Hwy 97 N, Kelowna, BC

Legal Description Plan: KAP45081 Lot: 2

Stamp Scale Project No. 1:520 22016 Checked By Drawn By

Drawing PROPOSED SITE PLAN

Sheet No. **A.10**


T5J 1Z7


Revision No.

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PROPOSED SITE PLAN
SCALE: 1:520



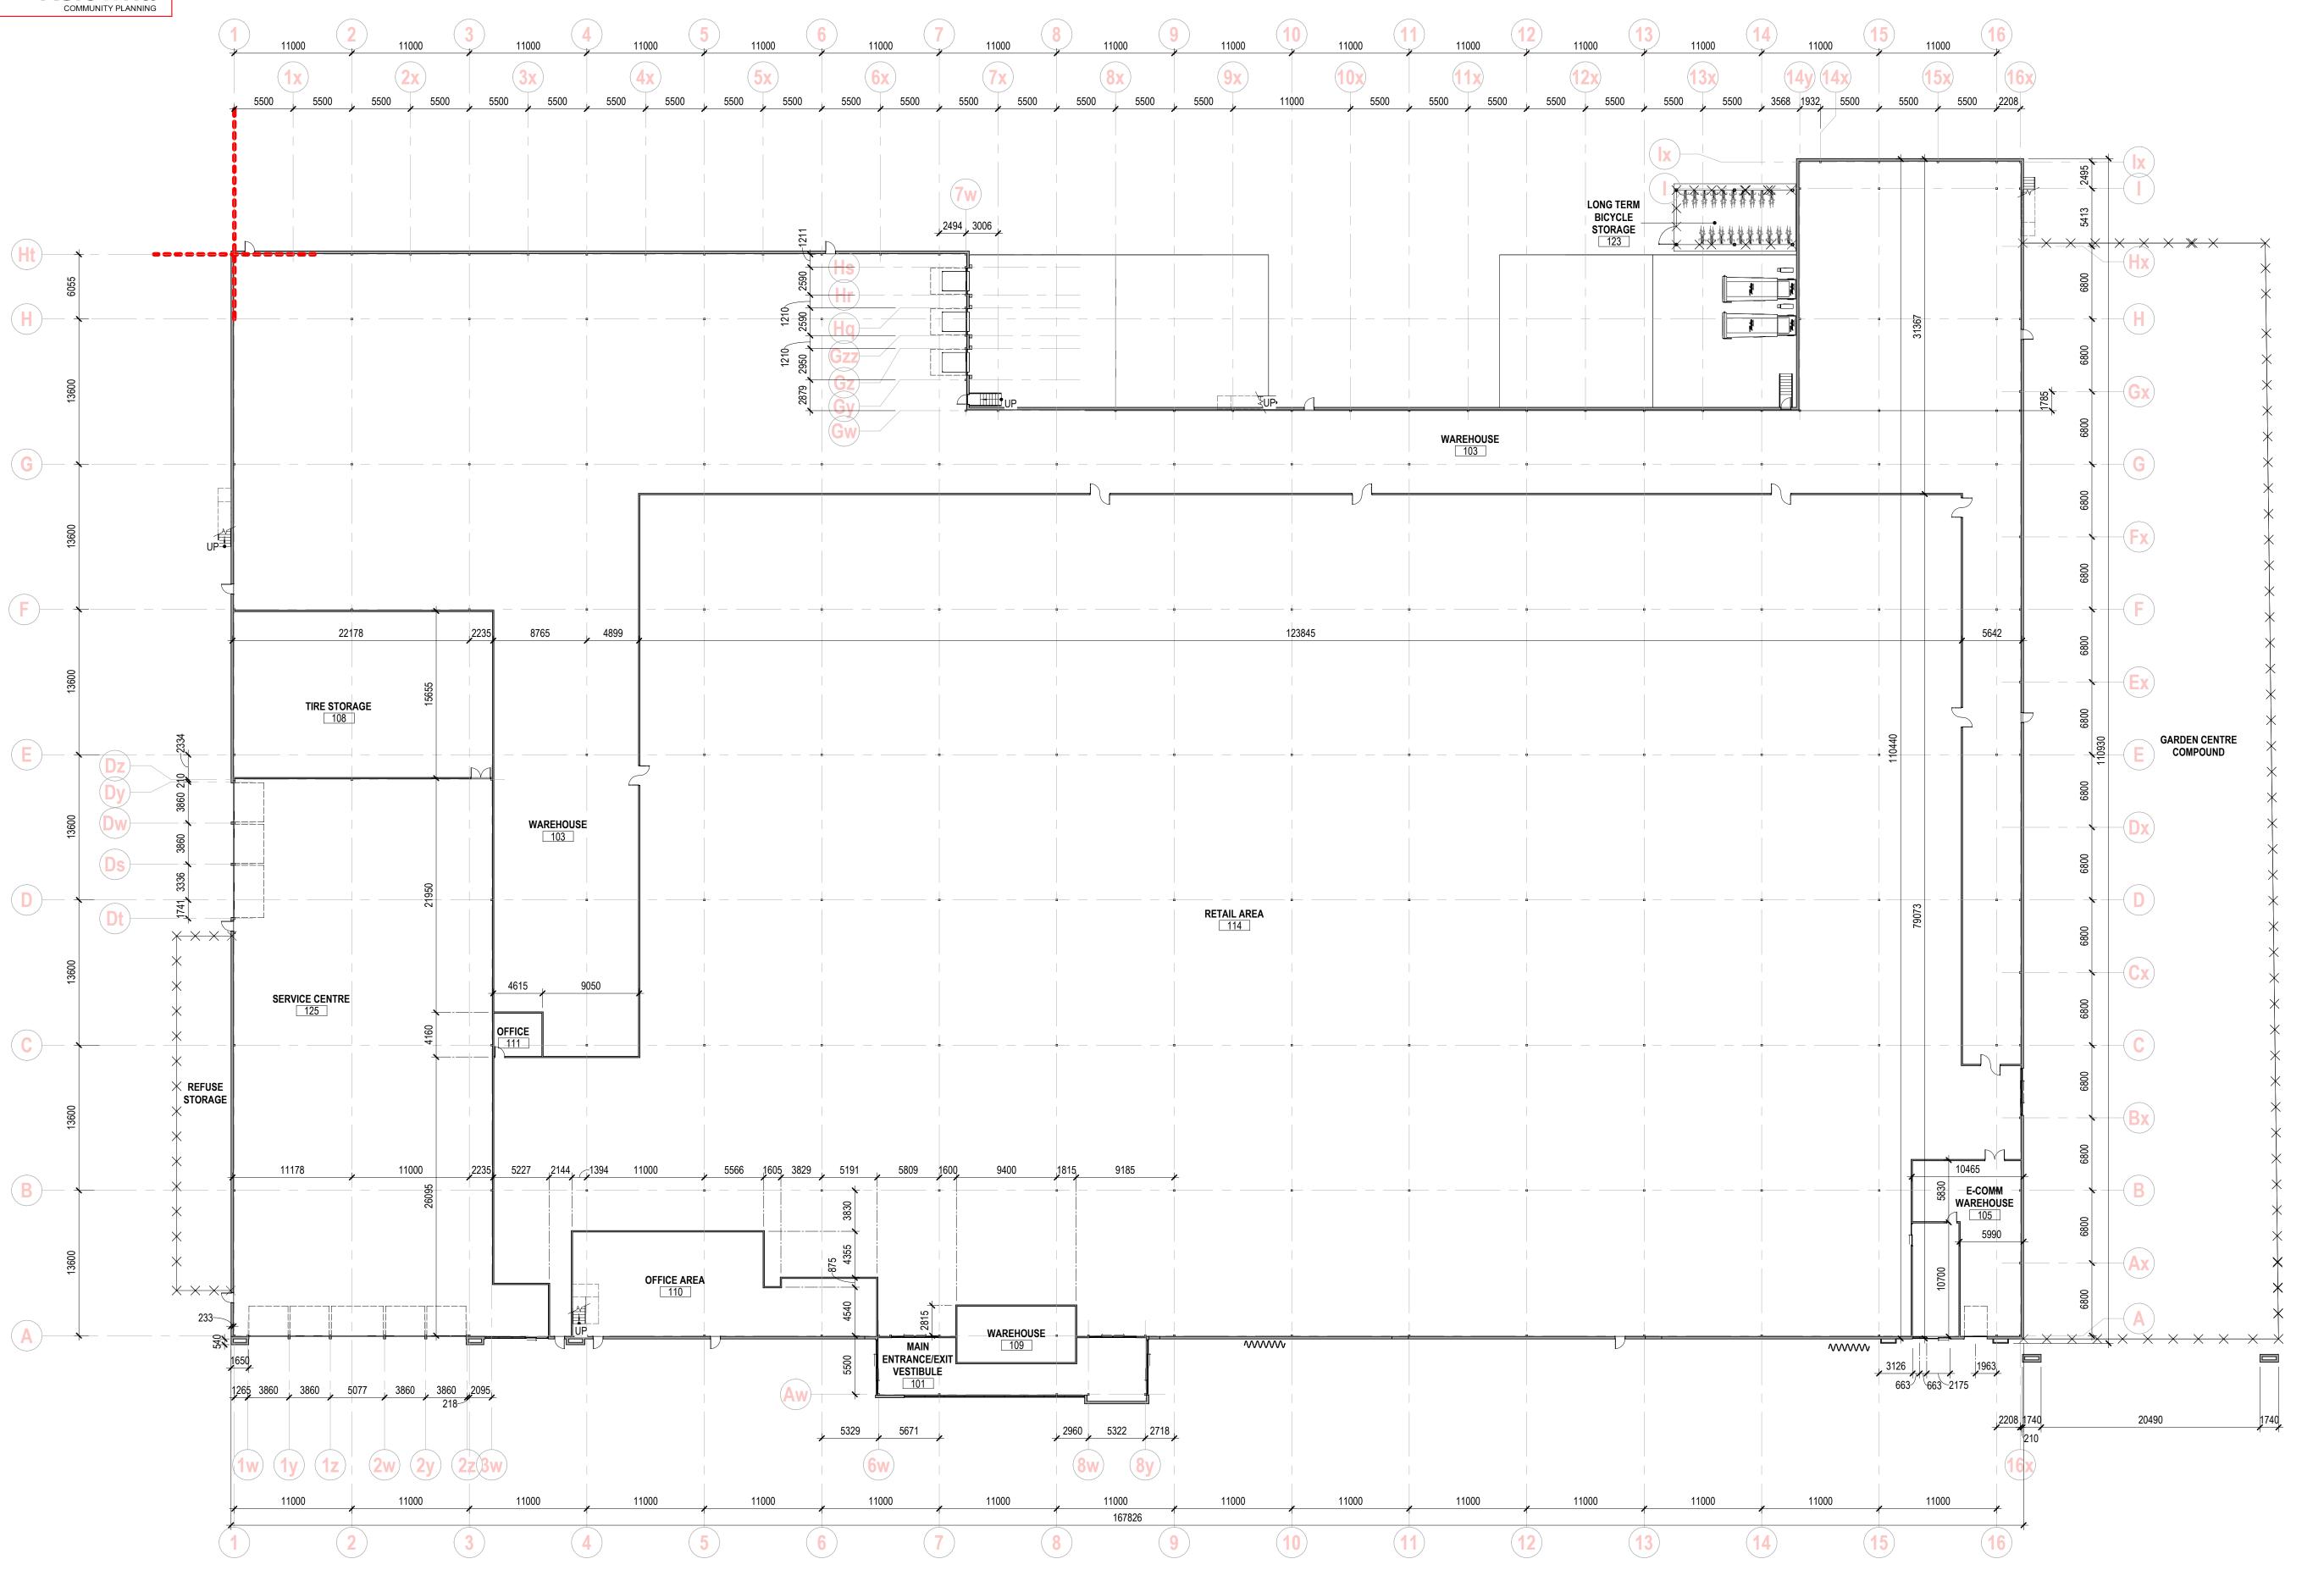

Stamp Scale Project No. 1:300 22016 Drawn By Checked By

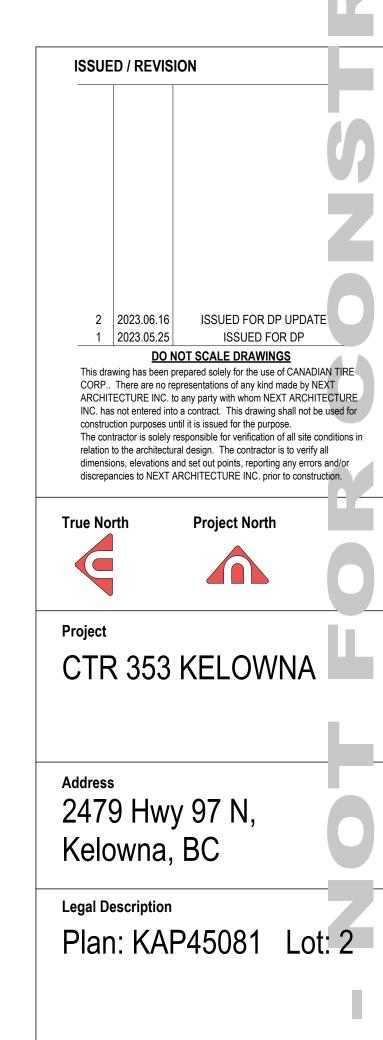
Drawing MAIN FLOOR

Sheet No. **A.21**


NOTE: ALL EXITS TO BE REVIEWED BY ARCHITECT

Revision No.



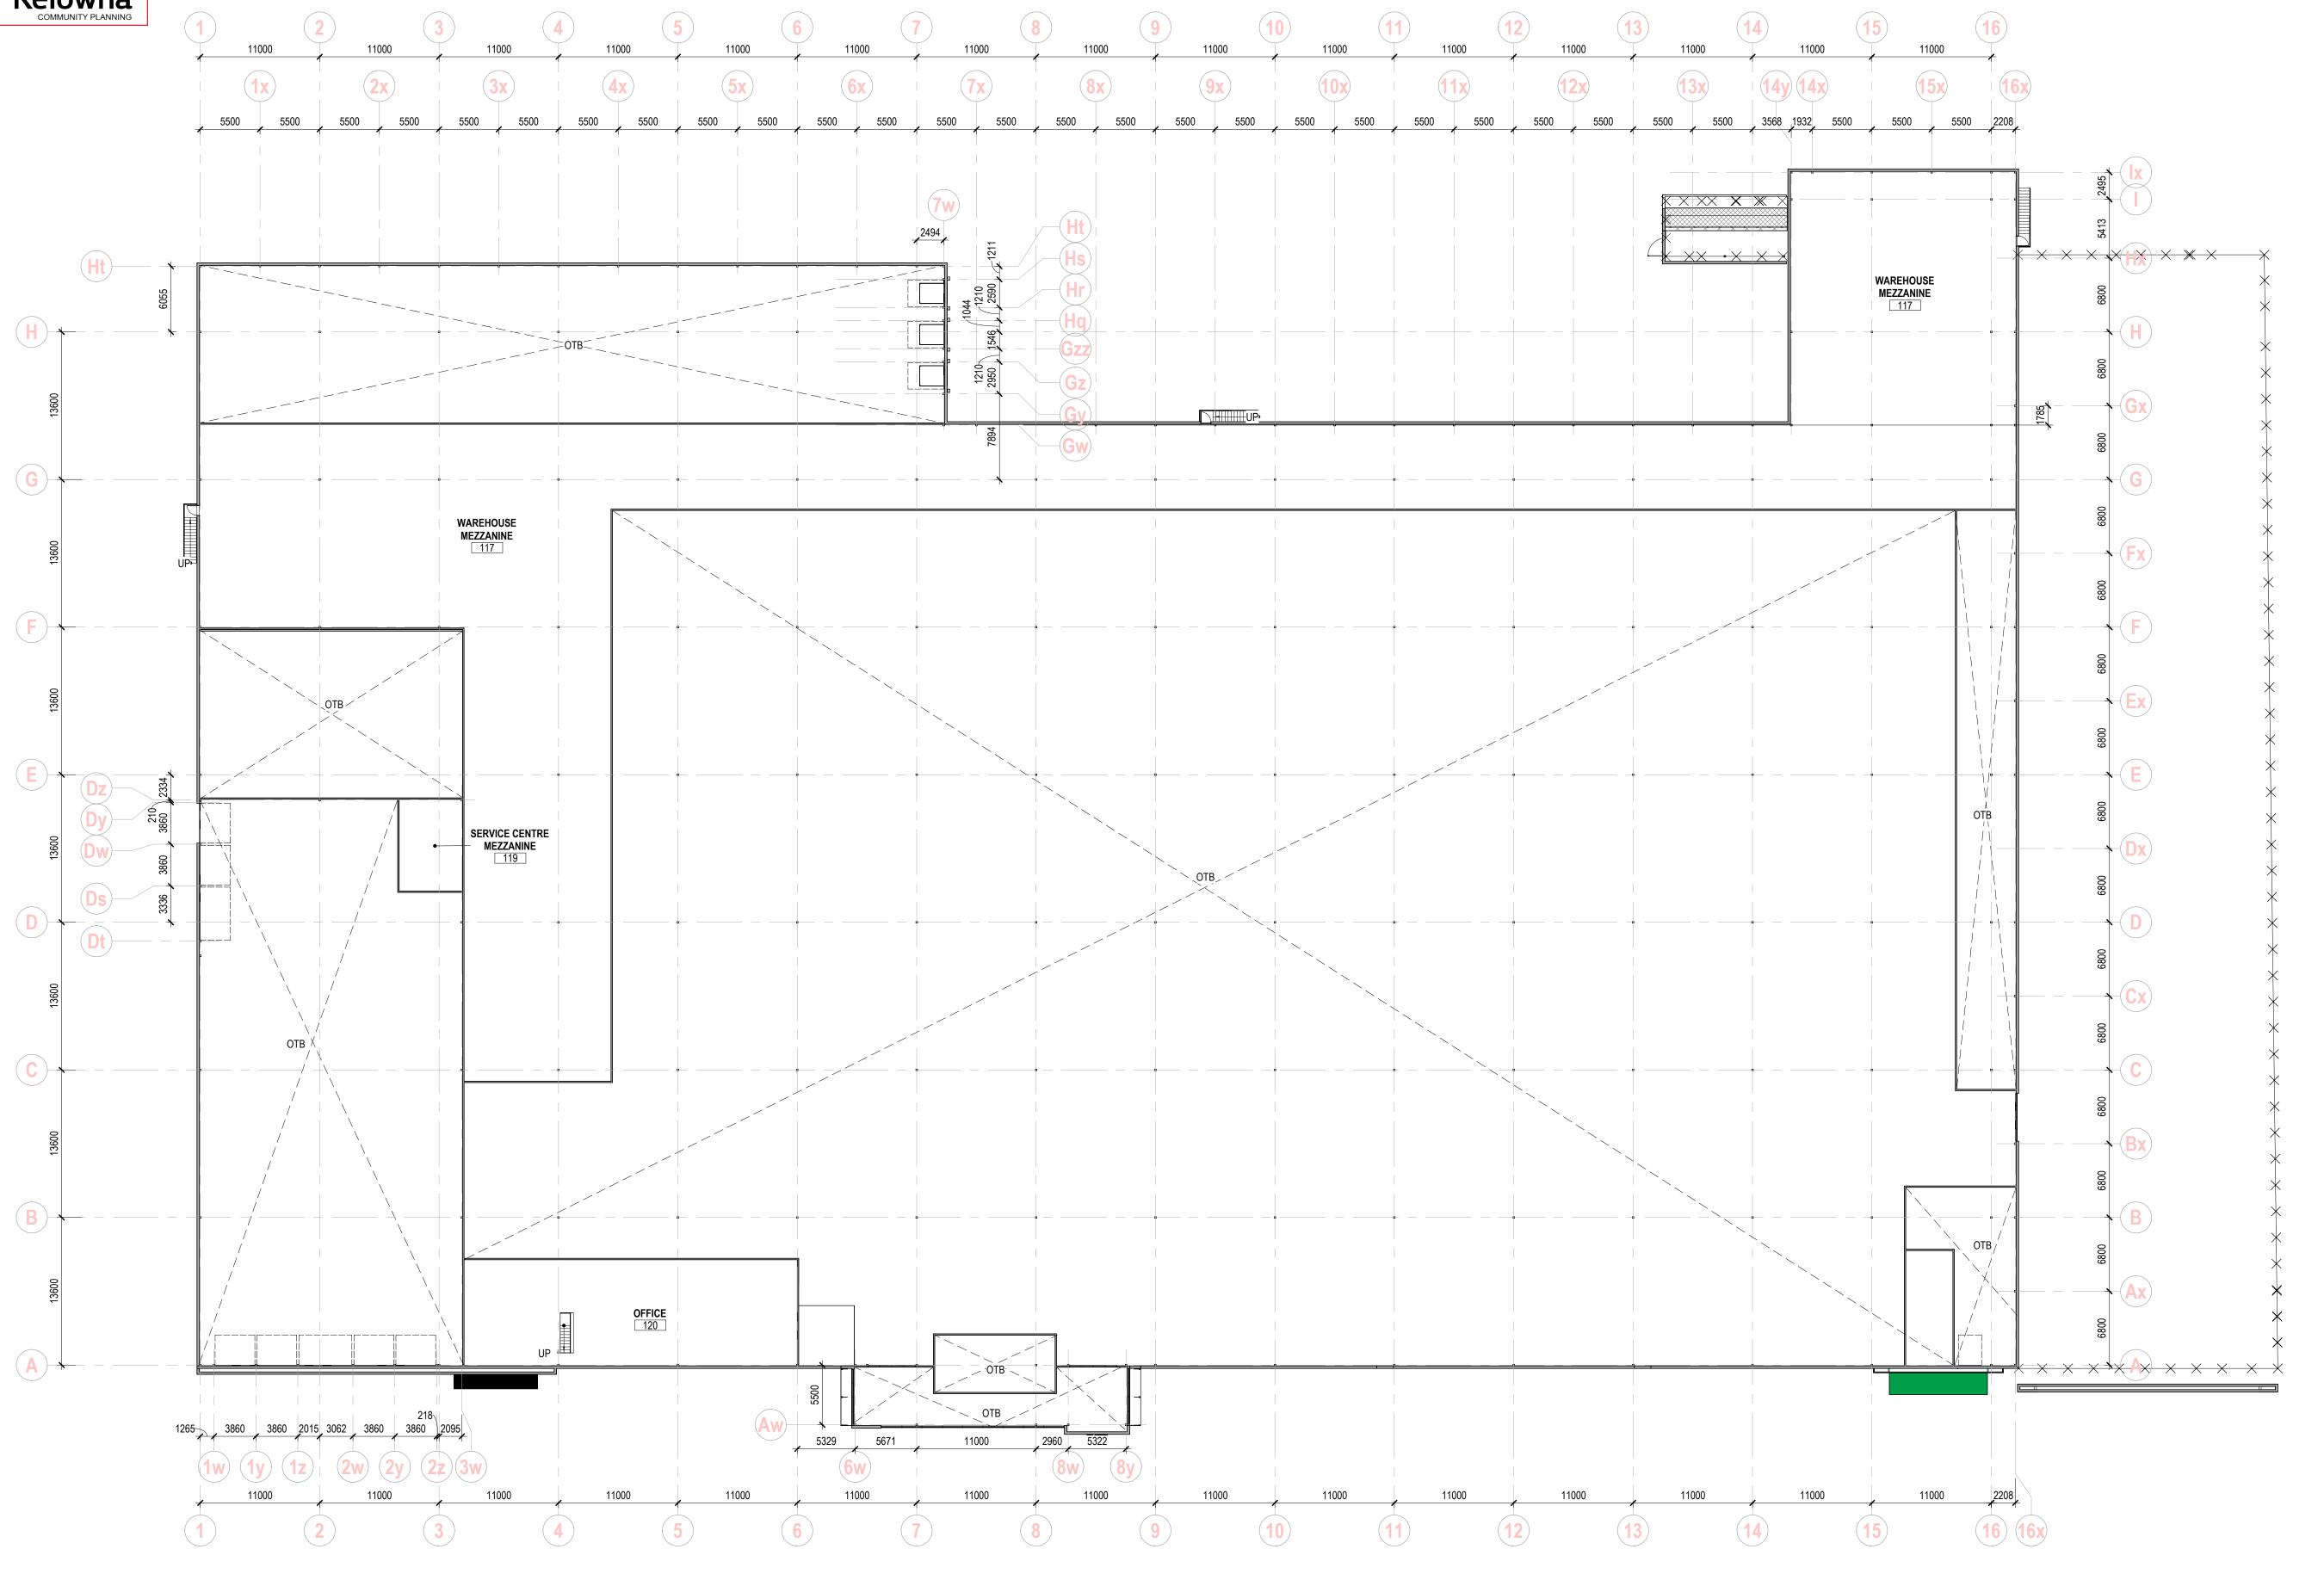

NOTE: ALL EXITS TO BE REVIEWED BY ARCHITECT

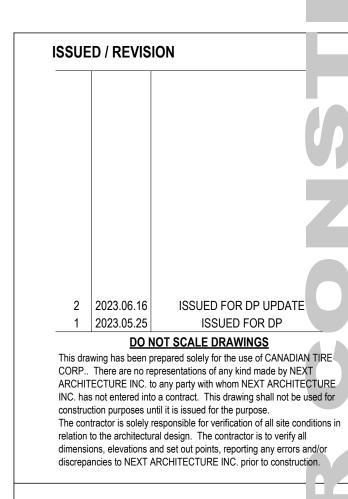

True North

CTR 353 KELOWNA

Address 2479 Hwy 97 N, Kelowna, BC

Legal Description Plan: KAP45081 Lot: 2


Project No. Scale 1:300 22016 Drawn By Checked By

Drawing MEZZANINE FLOOR

Sheet No. **A.22** Revision No.

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ISSUED / REVISION 2 | 2023.06.16 | ISSUED FOR DP UPDATE ISSUED FOR DP 1 2023.05.25 **DO NOT SCALE DRAWINGS** This drawing has been prepared solely for the use of CANADIAN TIRE CORP.. There are no representations of any kind made by NEXT ARCHITECTURE INC. to any party with whom NEXT ARCHITECTURE INC. has not entered into a contract. This drawing shall not be used for construction purposes until it is issued for the purpose. The contractor is solely responsible for verification of all site conditions in relation to the architectural design. The contractor is to verify all dimensions, elevations and set out points, reporting any errors and/or discrepancies to NEXT ARCHITECTURE INC. prior to construction.

CTR 353 KELOWNA

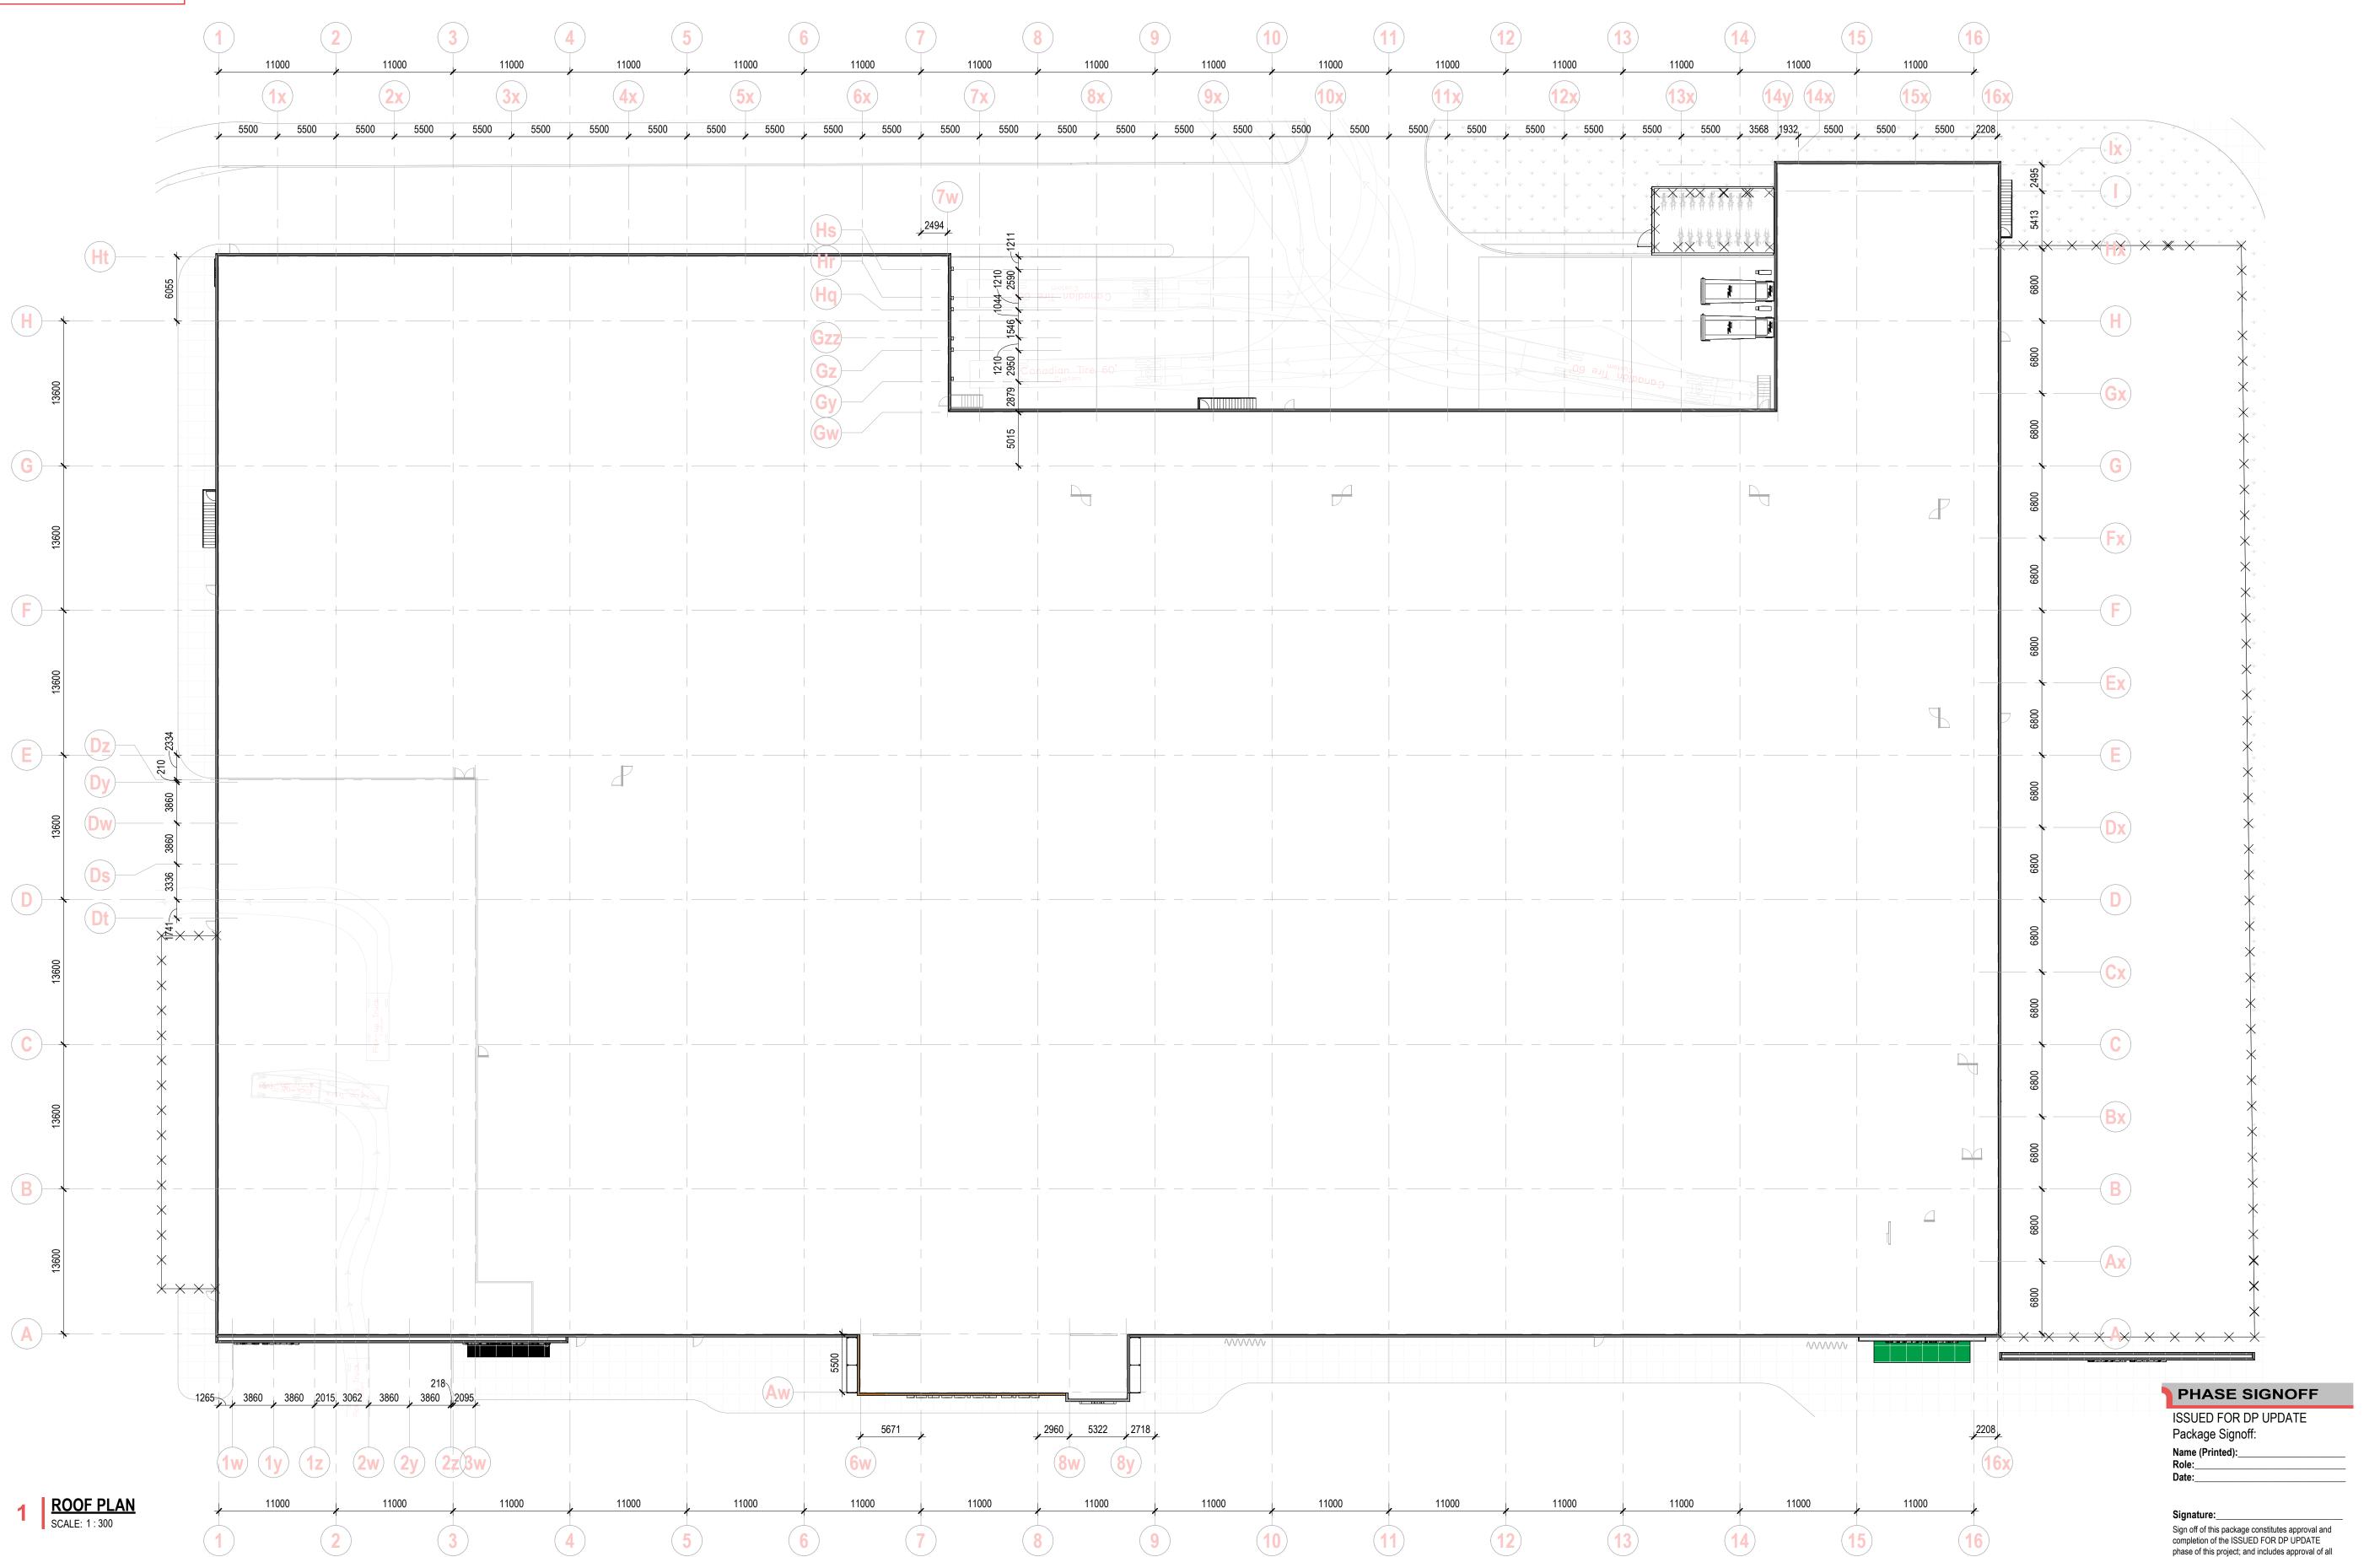Address 2479 Hwy 97 N, Kelowna, BC

Legal Description Plan: KAP45081 Lot: 2

Stamp Stage Project No. Scale 1:300 22016 Checked By Drawn By

Drawing **ROOF PLAN**

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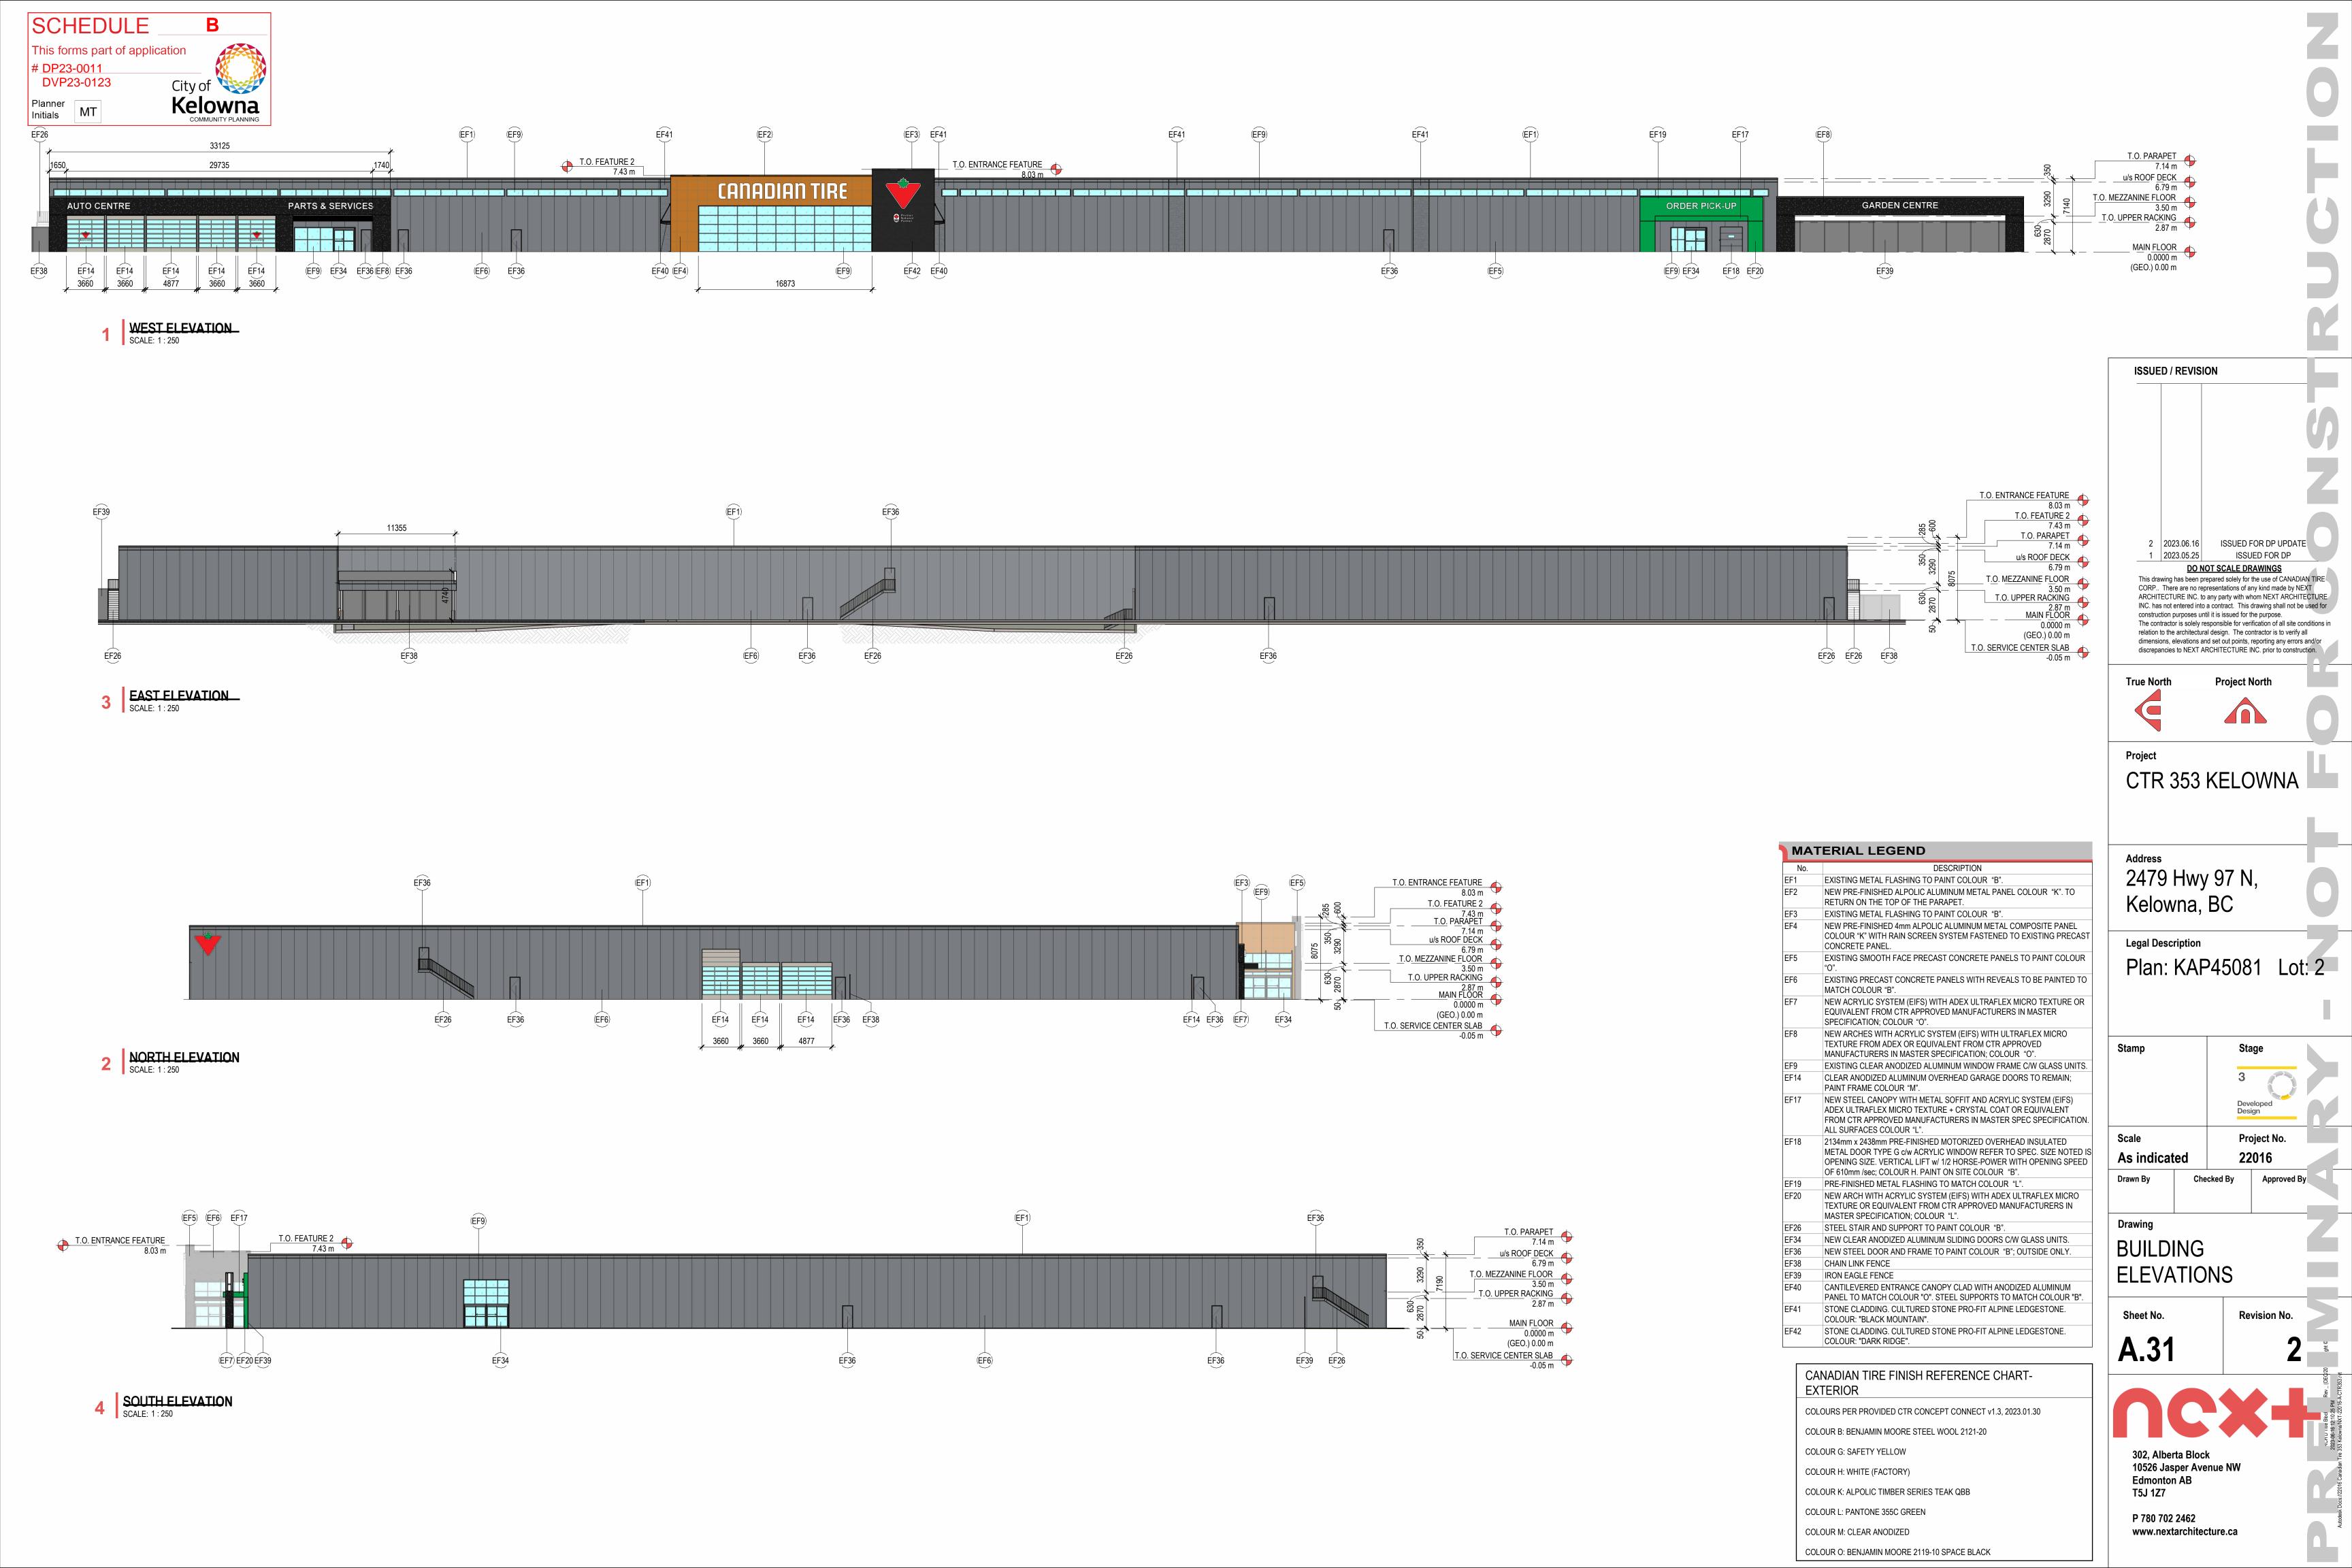
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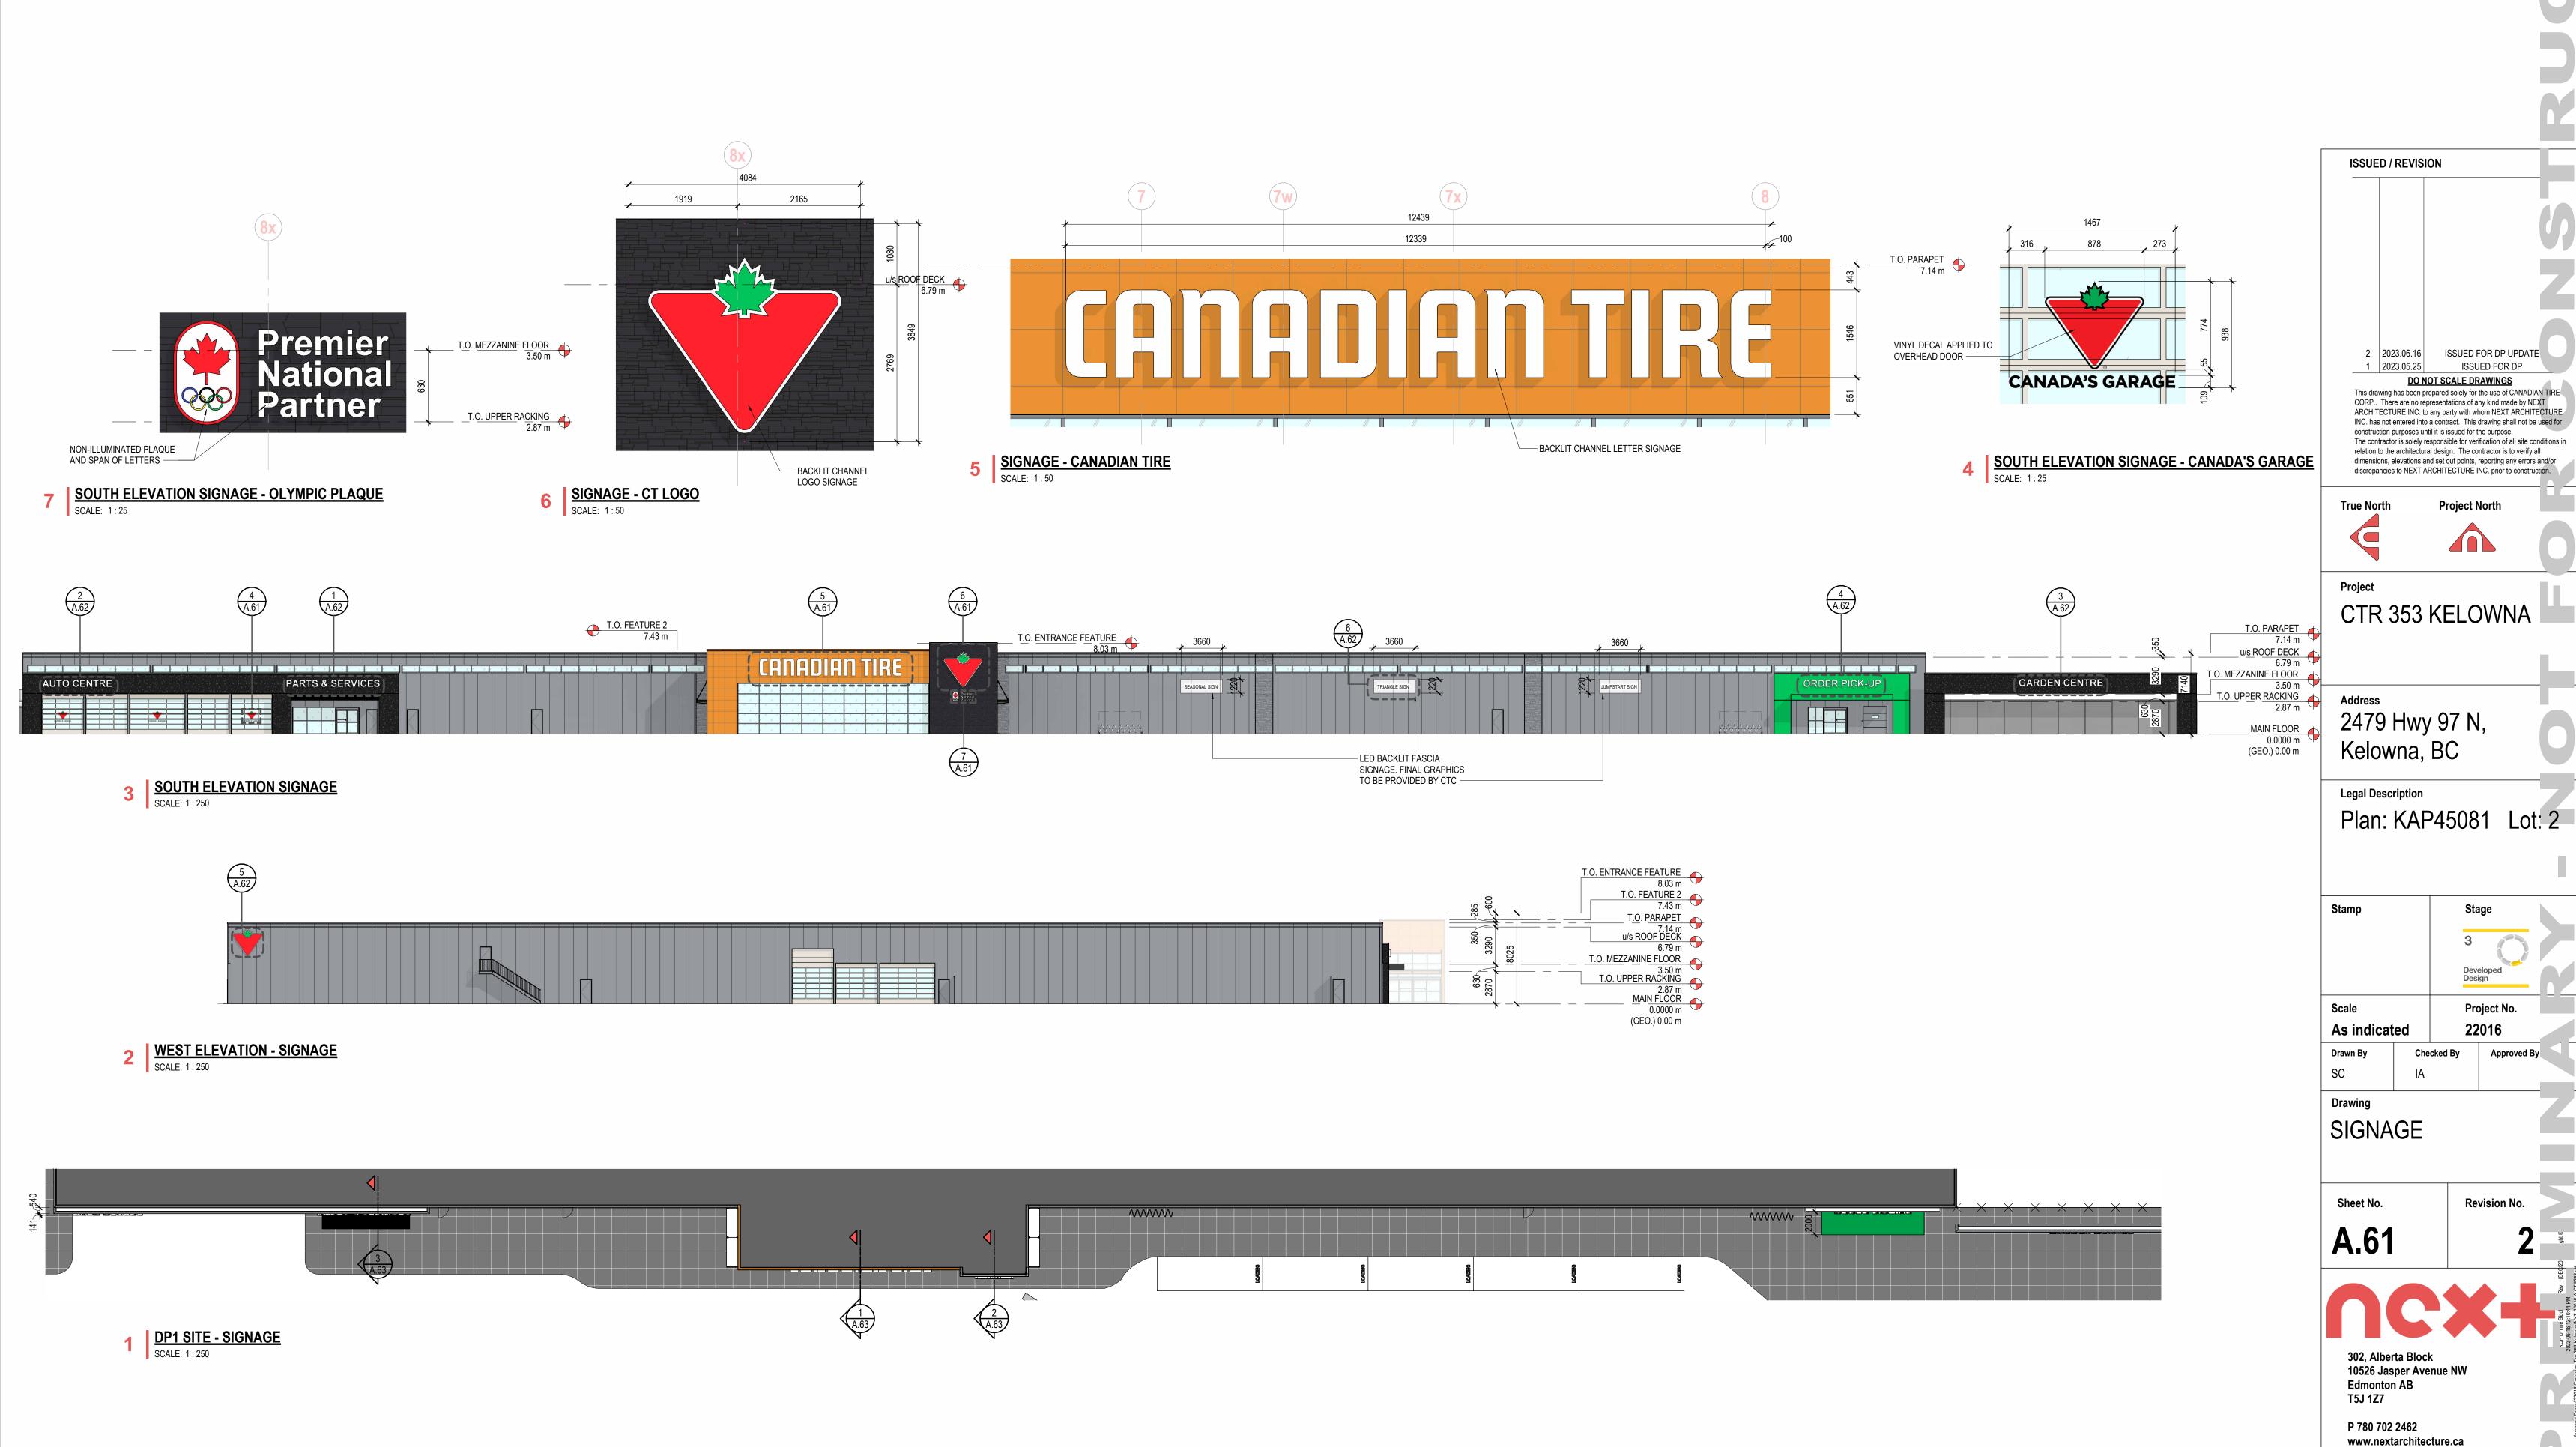
presented materials including: floor plan(s), general design concept, general finishes concept and general millwork concept(s). Further development of the project will be completed in upcoming Design Development and Technical Documentation stages of this project. Any major design concept and/or floor plan changes


hereafter approval of this package may be subject to additional fees, at the discretion of the


Revision No. **A.23**

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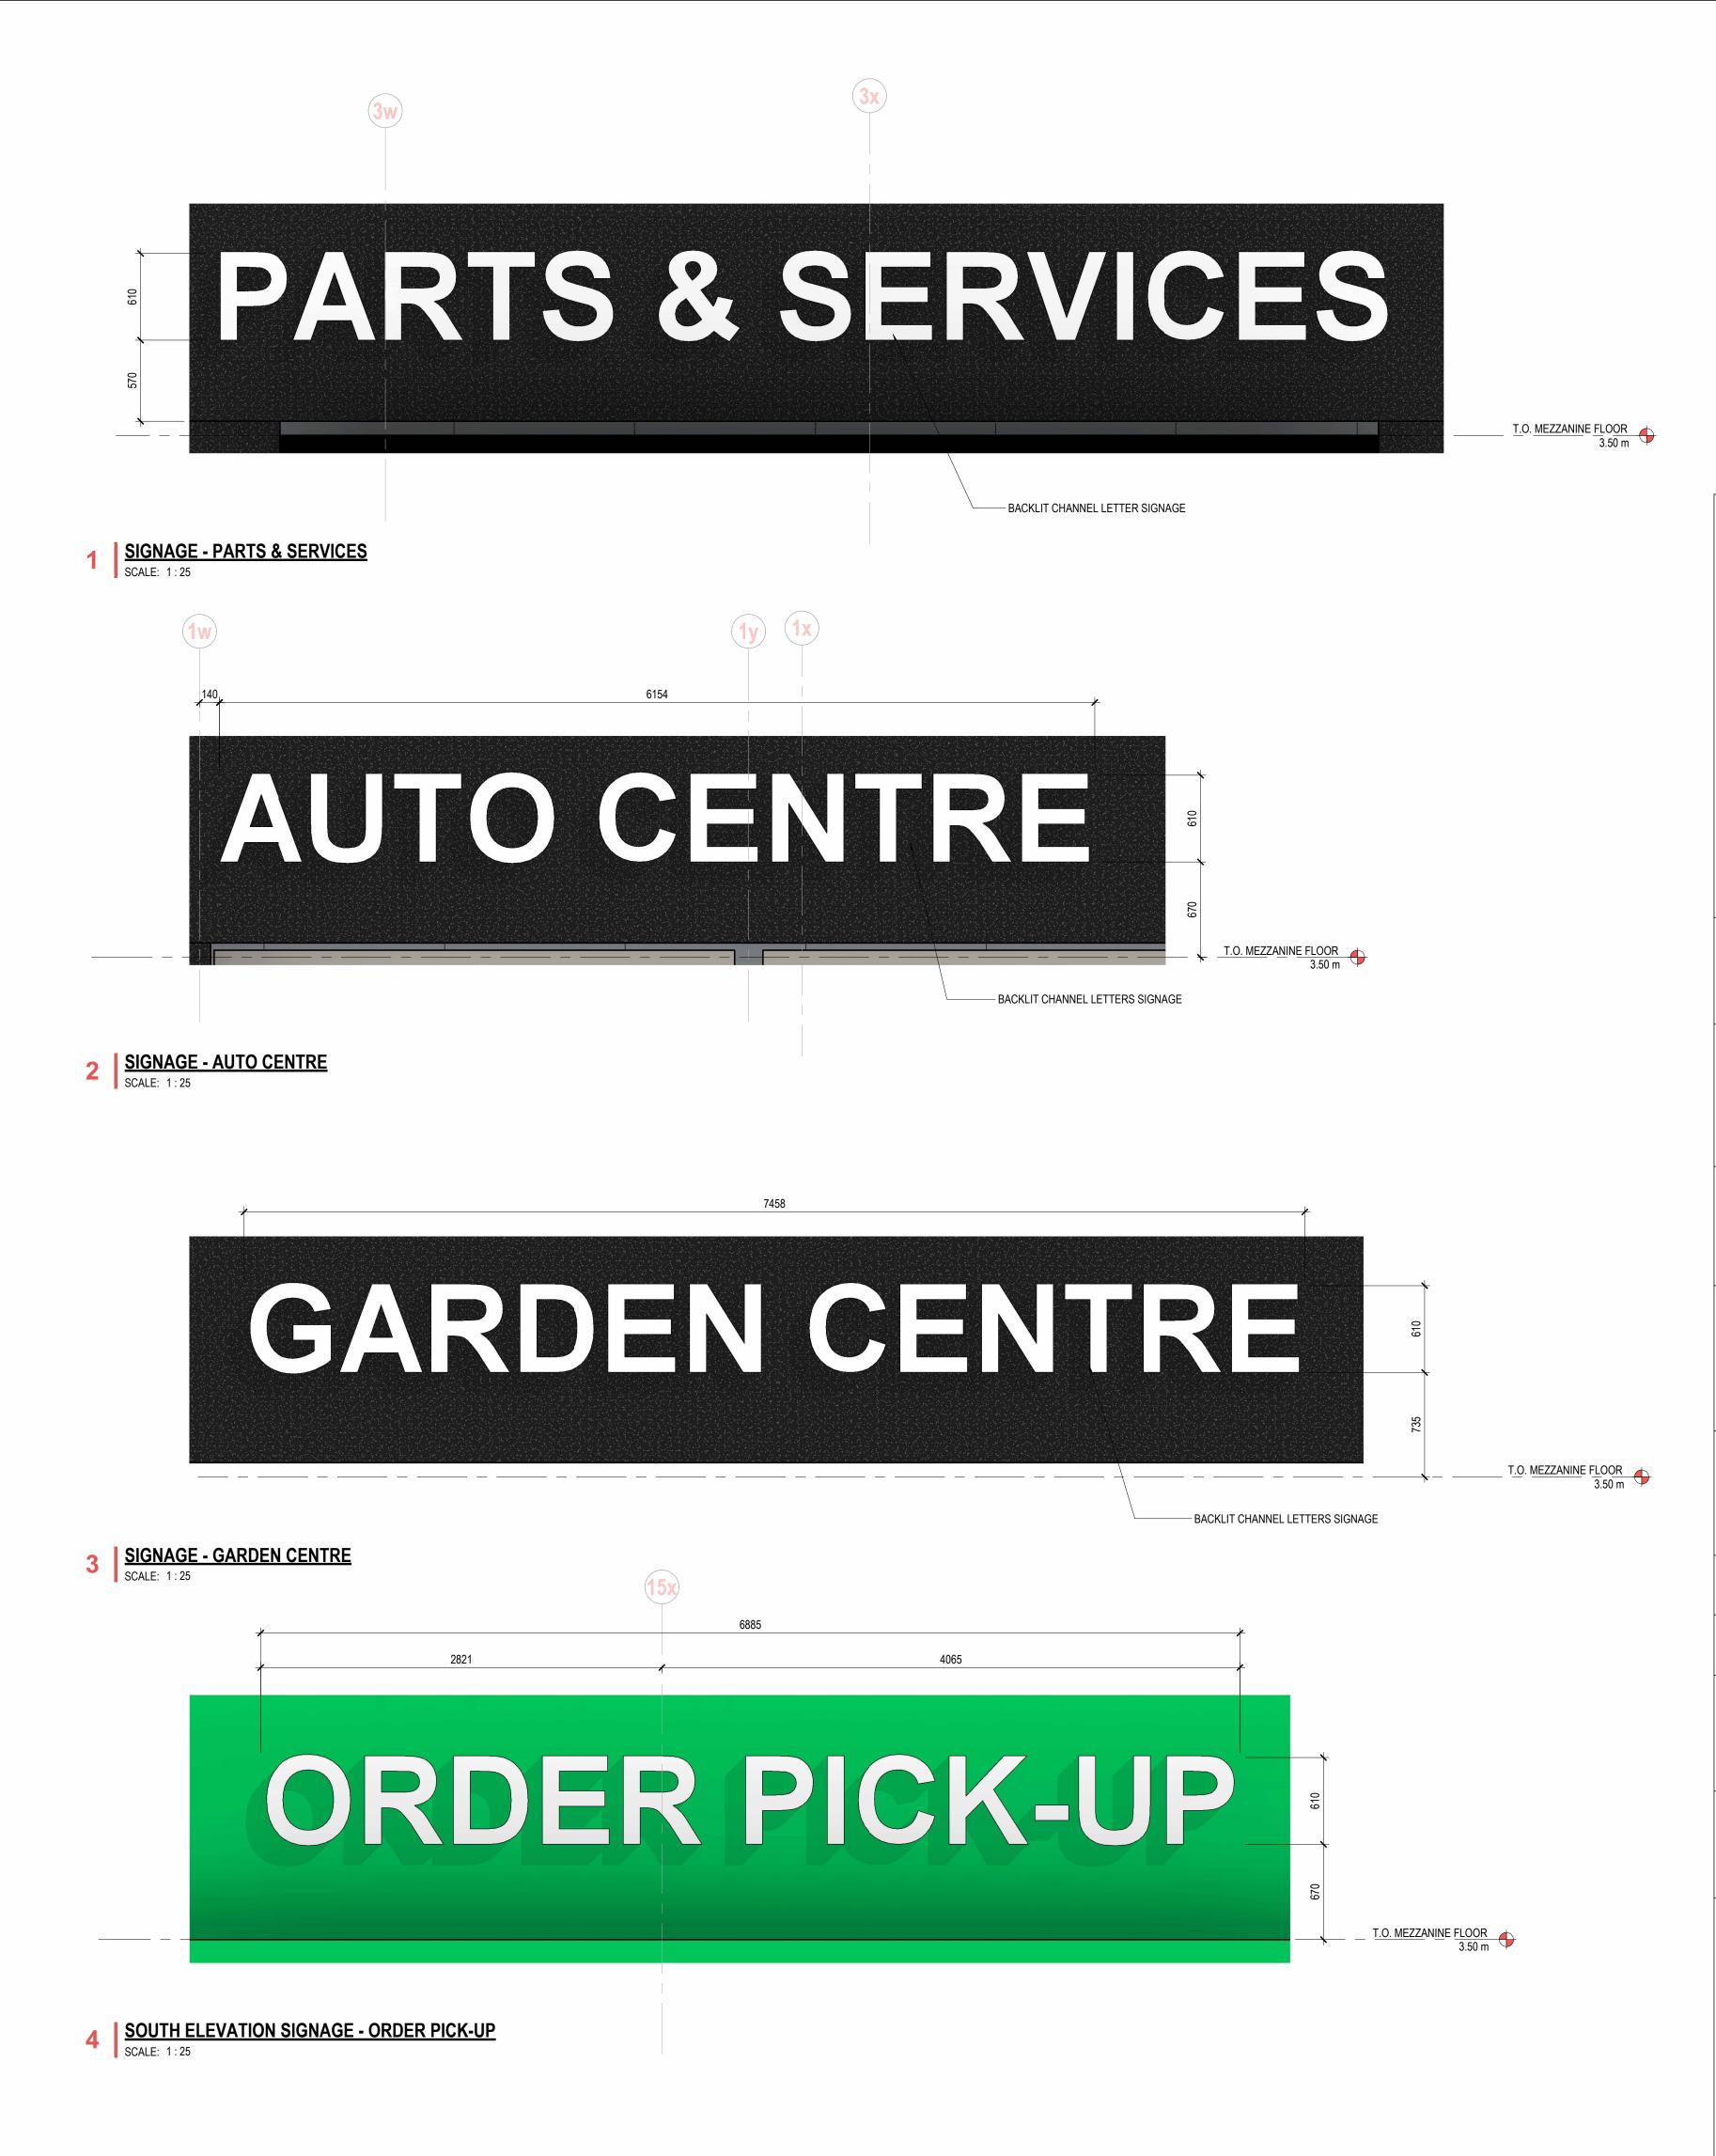






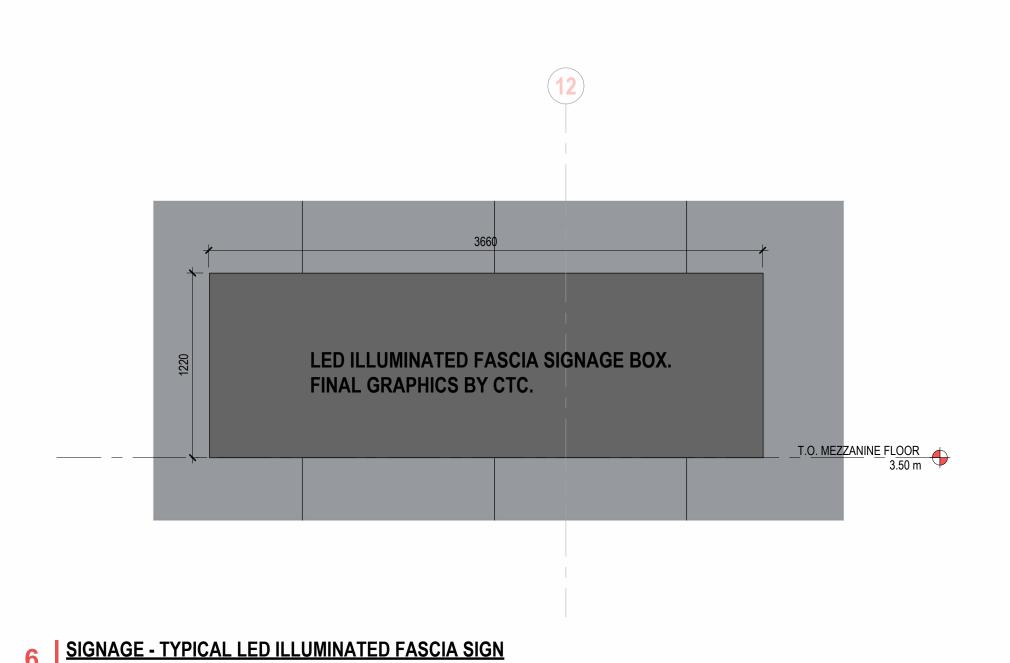

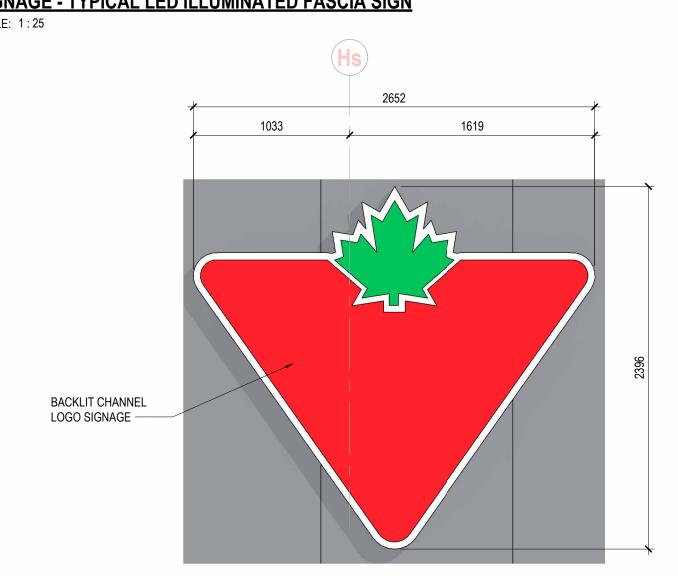5 WEST ELEVATION - SIGNAGE - SMALL CT LOGO
SCALE: 1:25



ISSUED / REVISION

2 2023.06.16

1 2023.05.25

True North

ISSUED FOR DP UPDATE
ISSUED FOR DP

relation to the architectural design. The contractor is to verify all dimensions, elevations and set out points, reporting any errors and/discrepancies to NEXT ARCHITECTURE INC. prior to construction.

CTR 353 KELOWNA

Plan: KAP45081 Lot: 2

22016

Revision No

Checked By

2479 Hwy 97 N,

Kelowna, BC

Legal Description

Drawn By

Drawing


SIGNAGE

A.62


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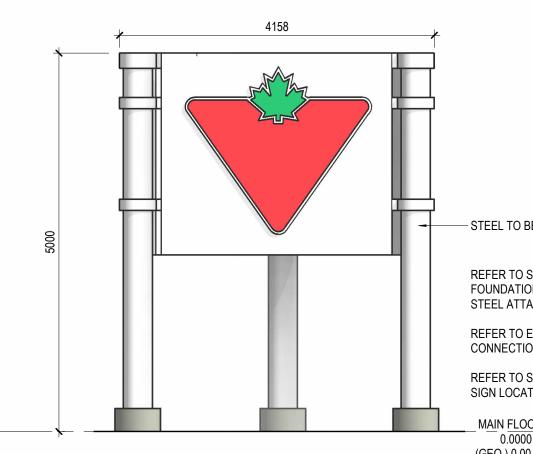
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SCHEDULE This forms part of application #_DP23-0011 DVP23-0123 City of Kelowna COMMUNITY PLANNING Planner Initials MT



3 TRIANGLE PYLON TOP VIEW
SCALE: 1:50

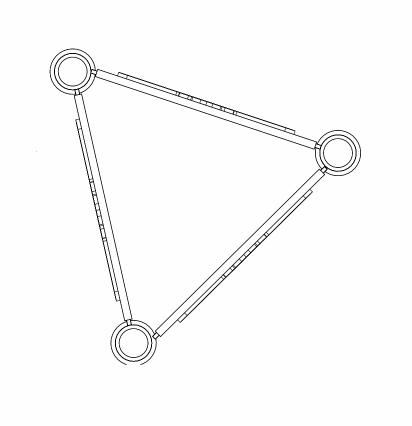

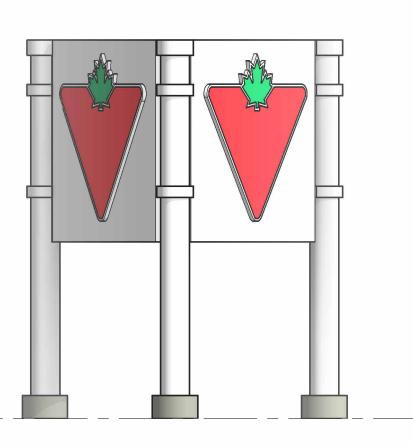

STEEL TO BE PAINTED WHITE REFER TO STRUCTURAL FOR FOUNDATIONS, STEEL SIZING AND STEEL ATTACHMENT.

phase of this project; and includes approval of all presented materials including: floor plan(s), general design concept, general finishes concept and general millwork concept(s). Further development of the project will be completed in upcoming Design Development and Technical Documentation stages of this project. Any major design concept and/or floor plan changes hereafter approval of this package may be subject to additional fees, at the discretion of the

PHASE SIGNOFF ISSUED FOR DP UPDATE Package Signoff:

Sheet No.

A.66 Sign off of this package constitutes approval and completion of the ISSUED FOR DP UPDATE phase of this project; and includes approval of all

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2 PYLON SIDE VIEW
SCALE: 1:50

1 PYLON FACE VIEW
SCALE: 1:50

REFER TO ELECTRICAL FOR CONNECTIONS AND LIGHTING

REFER TO SITE PLAN FOR PYLON SIGN LOCATION

MAIN FLOOR 0.0000 m (GEO.) 0.00 m

Name (Printed):_

Signature:_

1:50 Drawn By Checked By Checker Drawing

Scale

Stamp

ISSUED / REVISION

2 | 2023.06.16 | ISSUED FOR DP UPDATE 1 2023.05.25 ISSUED FOR DP

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CTR 353 KELOWNA

2479 Hwy 97 N, Kelowna, BC

Legal Description

construction purposes until it is issued for the purpose.

Project No. 22016

Plan: KAP45081 Lot: 2

Approved By Approver

Revision No.


PYLON SIGNAGE DETAILS







EF42

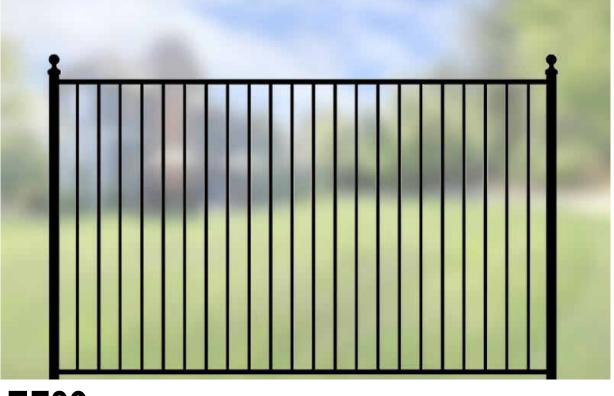

EF39




SBS ROOF MEMBRANE




COLOUR B



COLOUR K

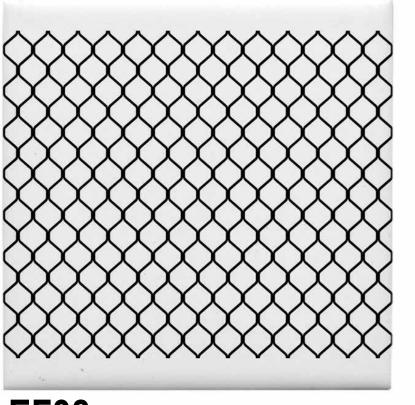

EF38

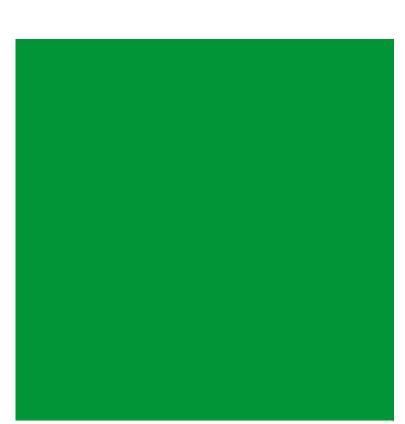

COLOUR L



COLOUR G



COLOUR O

MATERIAL LEGEND

EXISTING METAL FLASHING TO PAINT COLOUR "B". NEW PRE-FINISHED ALPOLIC ALUMINUM METAL PANEL COLOUR "K". TO RETURN ON THE TOP OF THE PARAPET. EXISTING METAL FLASHING TO PAINT COLOUR "B".

DESCRIPTION

NEW PRE-FINISHED 4mm ALPOLIC ALUMINUM METAL COMPOSITE PANEL COLOUR "K" WITH RAIN SCREEN SYSTEM FASTENED TO EXISTING PRECAST

CONCRETE PANEL. EXISTING SMOOTH FACE PRECAST CONCRETE PANELS TO PAINT COLOUR

EXISTING PRECAST CONCRETE PANELS WITH REVEALS TO BE PAINTED TO MATCH COLOUR "B". NEW ACRYLIC SYSTEM (EIFS) WITH ADEX ULTRAFLEX MICRO TEXTURE OR

EQUIVALENT FROM CTR APPROVED MANUFACTURERS IN MASTER SPECIFICATION; COLOUR "O". NEW ARCHES WITH ACRYLIC SYSTEM (EIFS) WITH ULTRAFLEX MICRO

TEXTURE FROM ADEX OR EQUIVALENT FROM CTR APPROVED MANUFACTURERS IN MASTER SPECIFICATION; COLOUR "O". EXISTING CLEAR ANODIZED ALUMINUM WINDOW FRAME C/W GLASS UNITS. CLEAR ANODIZED ALUMINUM OVERHEAD GARAGE DOORS TO REMAIN; PAINT FRAME COLOUR "M".

NEW STEEL CANOPY WITH METAL SOFFIT AND ACRYLIC SYSTEM (EIFS) ADEX ULTRAFLEX MICRO TEXTURE + CRYSTAL COAT OR EQUIVALENT FROM CTR APPROVED MANUFACTURERS IN MASTER SPEC SPECIFICATION. ALL SURFACES COLOUR "L".

DESCRIPTION

2134mm x 2438mm PRE-FINISHED MOTORIZED OVERHEAD INSULATED METAL DOOR TYPE G c/w ACRYLIC WINDOW REFER TO SPEC. SIZE NOTED IS OPENING SIZE. VERTICAL LIFT w/ 1/2 HORSE-POWER WITH OPENING SPEED OF 610mm /sec; COLOUR H. PAINT ON SITE COLOUR "B". PRE-FINISHED METAL FLASHING TO MATCH COLOUR "L".

NEW ARCH WITH ACRYLIC SYSTEM (EIFS) WITH ADEX ULTRAFLEX MICRO TEXTURE OR EQUIVALENT FROM CTR APPROVED MANUFACTURERS IN MASTER SPECIFICATION; COLOUR "L".

STEEL STAIR AND SUPPORT TO PAINT COLOUR "B". NEW CLEAR ANODIZED ALUMINUM SLIDING DOORS C/W GLASS UNITS. NEW STEEL DOOR AND FRAME TO PAINT COLOUR "B"; OUTSIDE ONLY.

EF38 CHAIN LINK FENCE IRON EAGLE FENCE

CANTILEVERED ENTRANCE CANOPY CLAD WITH ANODIZED ALUMINUM PANEL TO MATCH COLOUR "O". STEEL SUPPORTS TO MATCH COLOUR "B". STONE CLADDING. CULTURED STONE PRO-FIT ALPINE LEDGESTONE. COLOUR: "BLACK MOUNTAIN".

> STONE CLADDING. CULTURED STONE PRO-FIT ALPINE LEDGESTONE. COLOUR: "DARK RIDGE".

CANADIAN TIRE FINISH REFERENCE CHART-

EXTERIOR

COLOURS PER PROVIDED CTR CONCEPT CONNECT v1.3, 2023.01.30

COLOUR B: BENJAMIN MOORE STEEL WOOL 2121-20 COLOUR G: SAFETY YELLOW

COLOUR H: WHITE (FACTORY)

COLOUR K: ALPOLIC TIMBER SERIES TEAK QBB

COLOUR L: PANTONE 355C GREEN COLOUR M: CLEAR ANODIZED

COLOUR O: BENJAMIN MOORE 2119-10 SPACE BLACK

SCHEDULE This forms part of application #_DP23-0011 DVP23-0123 Kelowna

2 2023.06.16 ISSUED FOR DP UPDATE 1 2023.05.25 ARCHITECTURE INC. to any party with whom NEXT ARCHITECTURE INC. has not entered into a contract. This drawing shall not be used for relation to the architectural design. The contractor is to verify all dimensions, elevations and set out points, reporting any errors and/or discrepancies to NEXT ARCHITECTURE INC. prior to construction.

CTR 353 KELOWNA

2479 Hwy 97 N, Kelowna, BC

Legal Description Plan: KAP45081 Lot: 2

Scale Project No. 22016 1:1 Drawn By Checked By Approved By Checker Approver

Drawing PROPOSED MATERIALS

Sheet No. **A.64**


Stamp


Revision No.

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FORM & CHARACTER - DEVELOPMENT PERMIT GUIDELINES

Consideration has been given to the following guidelines as identified in Chapter 18 of the City of Kelowna 2040 Official Community Plan:

SECTION 6.o: RETAIL, COMMERCIAL AND INDUSTRIAL							
RA	TE PROPOSALS COMPLIANCE TO PERTINENT GUIDELINE	N/A	1	2	3	4	5
(1 is least complying & 5 is highly complying)							
6.1	General Guidelines						
6.1	1 Relationship to the Street	N/A	1	2	3	4	5
a.	Orient the long side of each building to be parallel to the public street.					√	
b.	Locate entries to be visible and directly accessible from the public street.		✓				
C.	For buildings fronting highways, entries can be located away from the street, as long as there is a direct pedestrian connection to the site.						✓
d.	Avoid blank walls adjacent to the highway, streets, walkways, parks, or other amenity spaces.			√			
6.1	2 Site Planning and Landscaping	N/A	1	2	3	4	5
a.	Locate buildings to ensure good sight lines for vehicular and pedestrian traffic.						✓
b.	Provide direct, safe, continuous, and clearly defined pedestrian access from public sidewalks, parking areas, and transit stops to building entrances.						✓
C.	Use large canopy trees to define the public realm (e.g. at the sidewalk and property edge facing the street)						✓
d. •	Distribute trees and landscaping throughout the site in order to: Soften property edges facing the street;						√
•	Define internal roads, pedestrian routes, and open spaces; Create pleasant pedestrian conditions; Screen parking, loading, service, and utility areas;						
•	Manage stormwater on-site; and						
•	Break up large rows of parking by substituting a parking stall with a canopy tree in planter every 8-10 parking stalls;						
e.	Use permeable materials such as paving blocks or permeable concrete in parking areas to maximize rainwater infiltration.					√	
f.	Pedestrian pathways should provide clear sight lines and connect the following:						✓
•	Parking areas to building entrances;						
•	Main building entrances to public sidewalks (where applicable); Main building entrances to transit stopes (where applicable);						
•	Between buildings on adjacent lots.						
g.	Provide separation between vehicular routes (especially truck access/loading) and pedestrian routes on-site to avoid conflict and						√

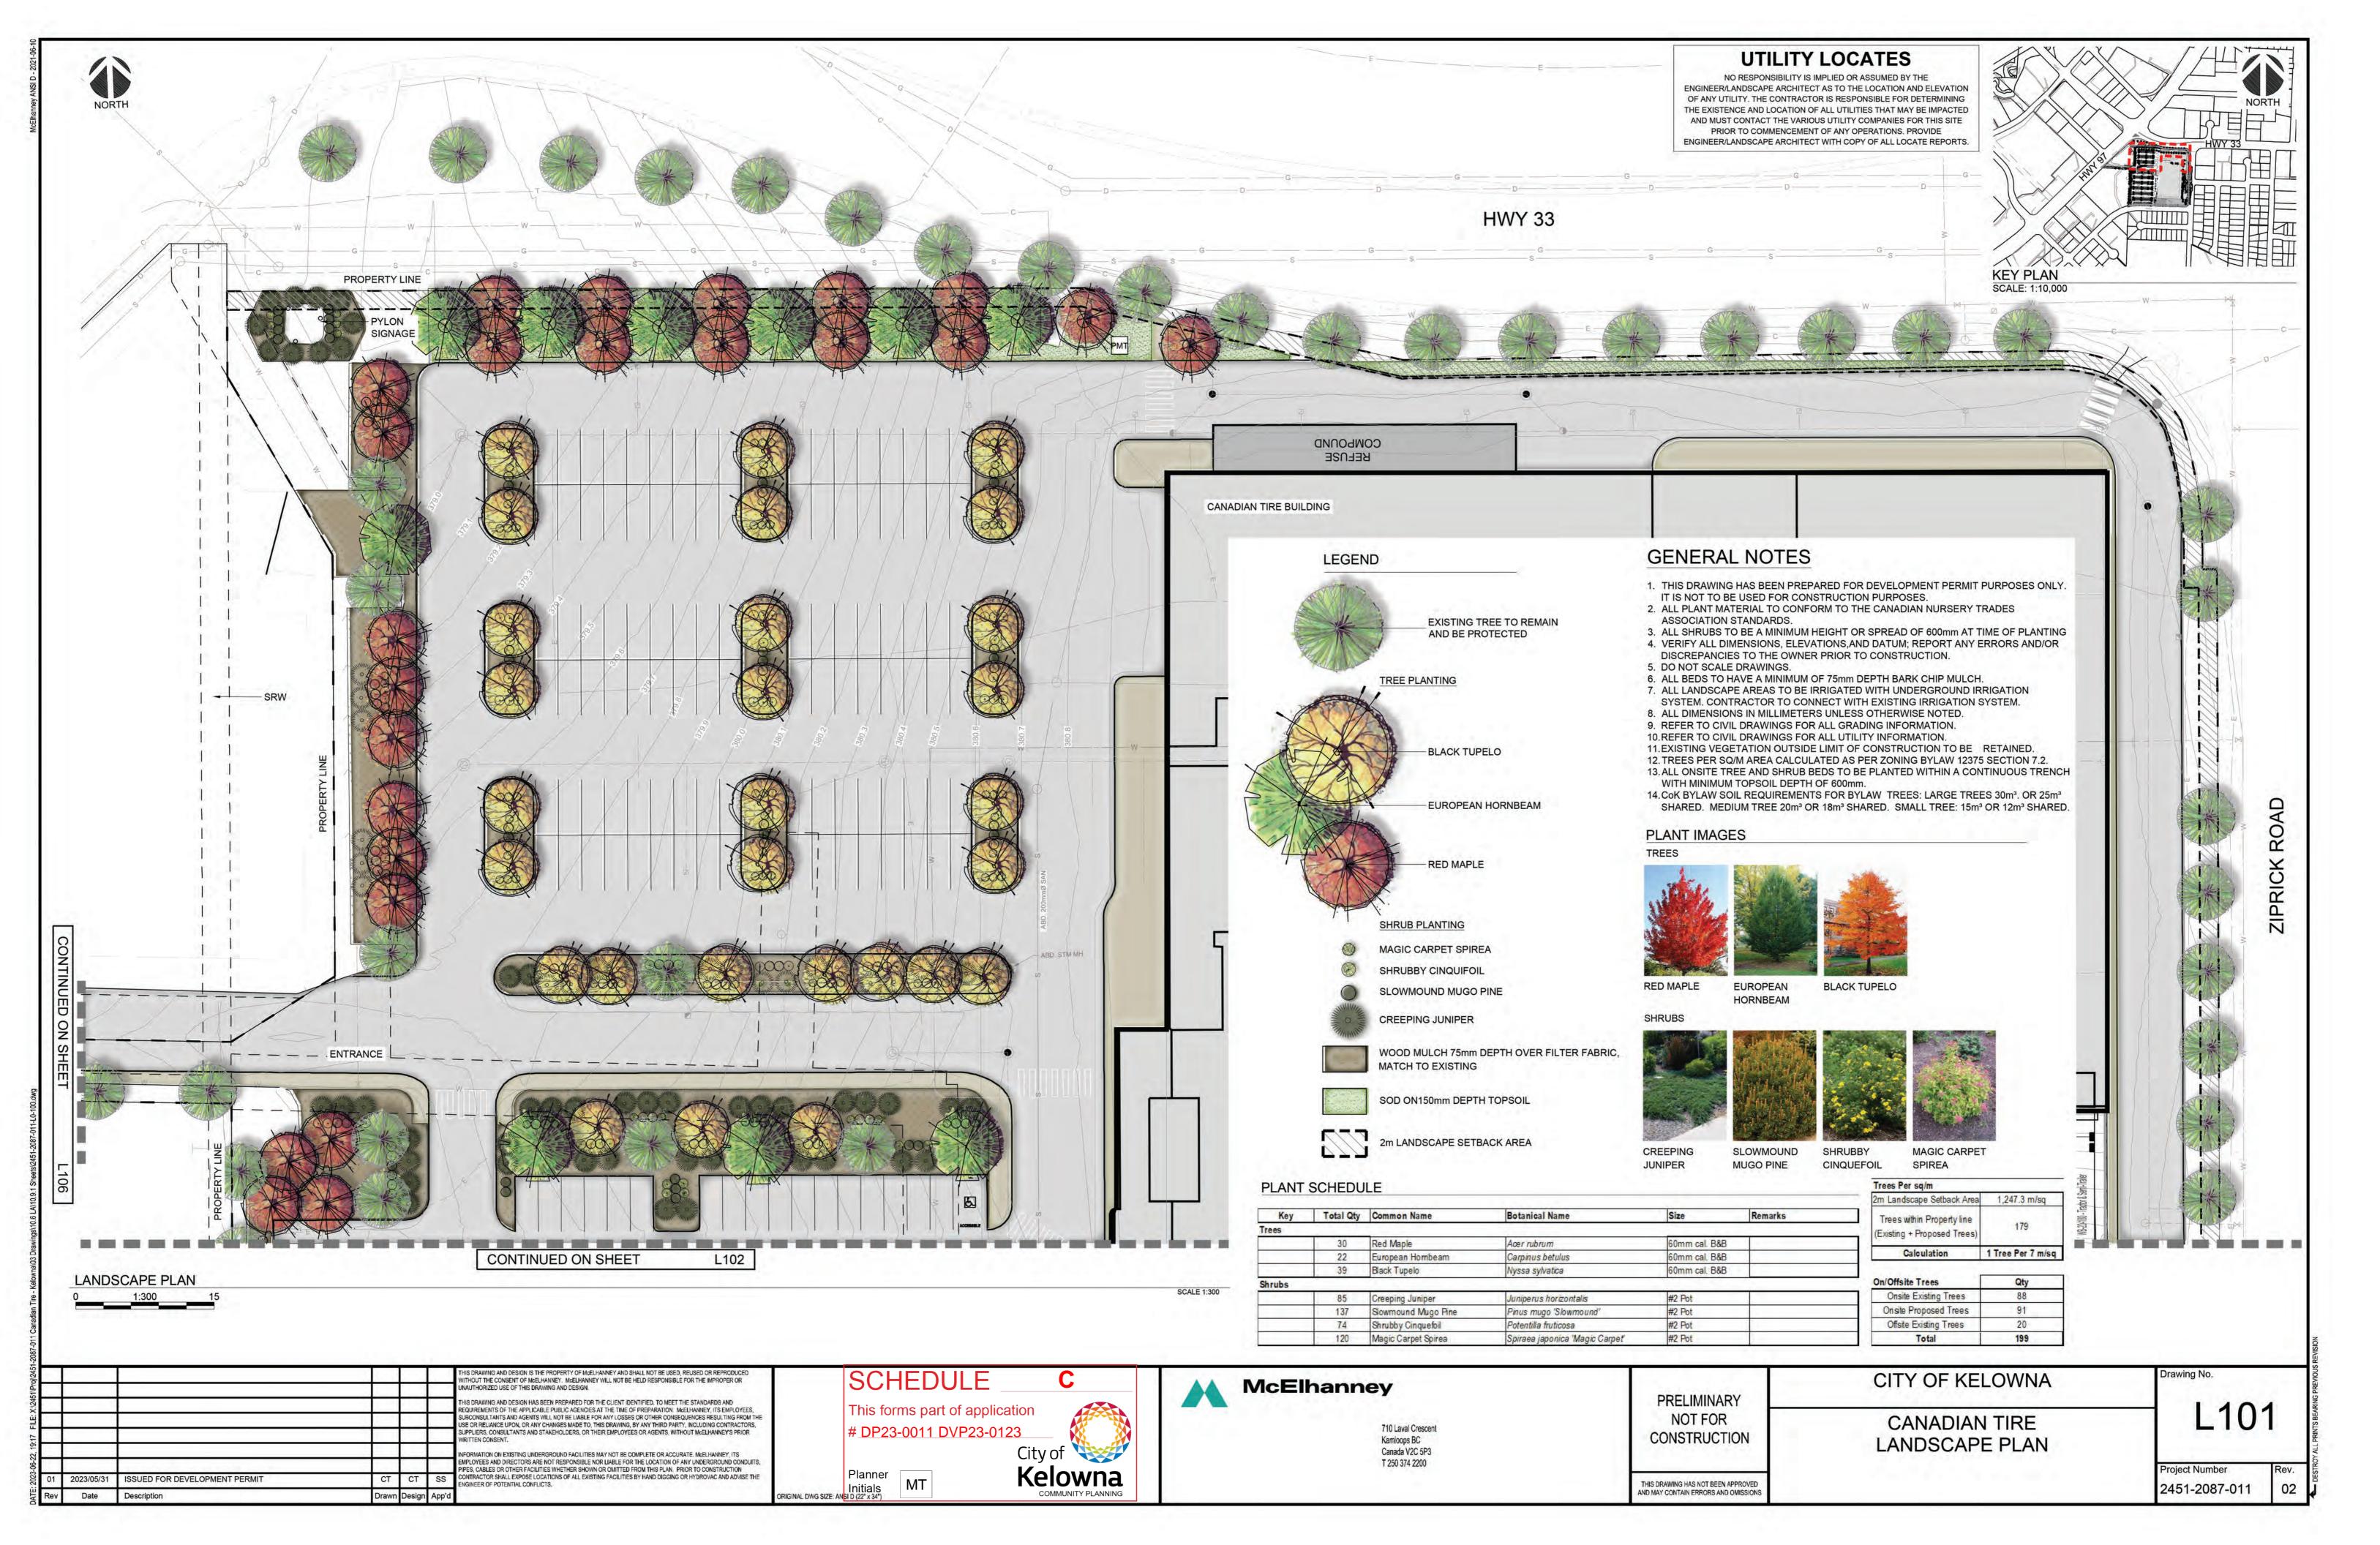

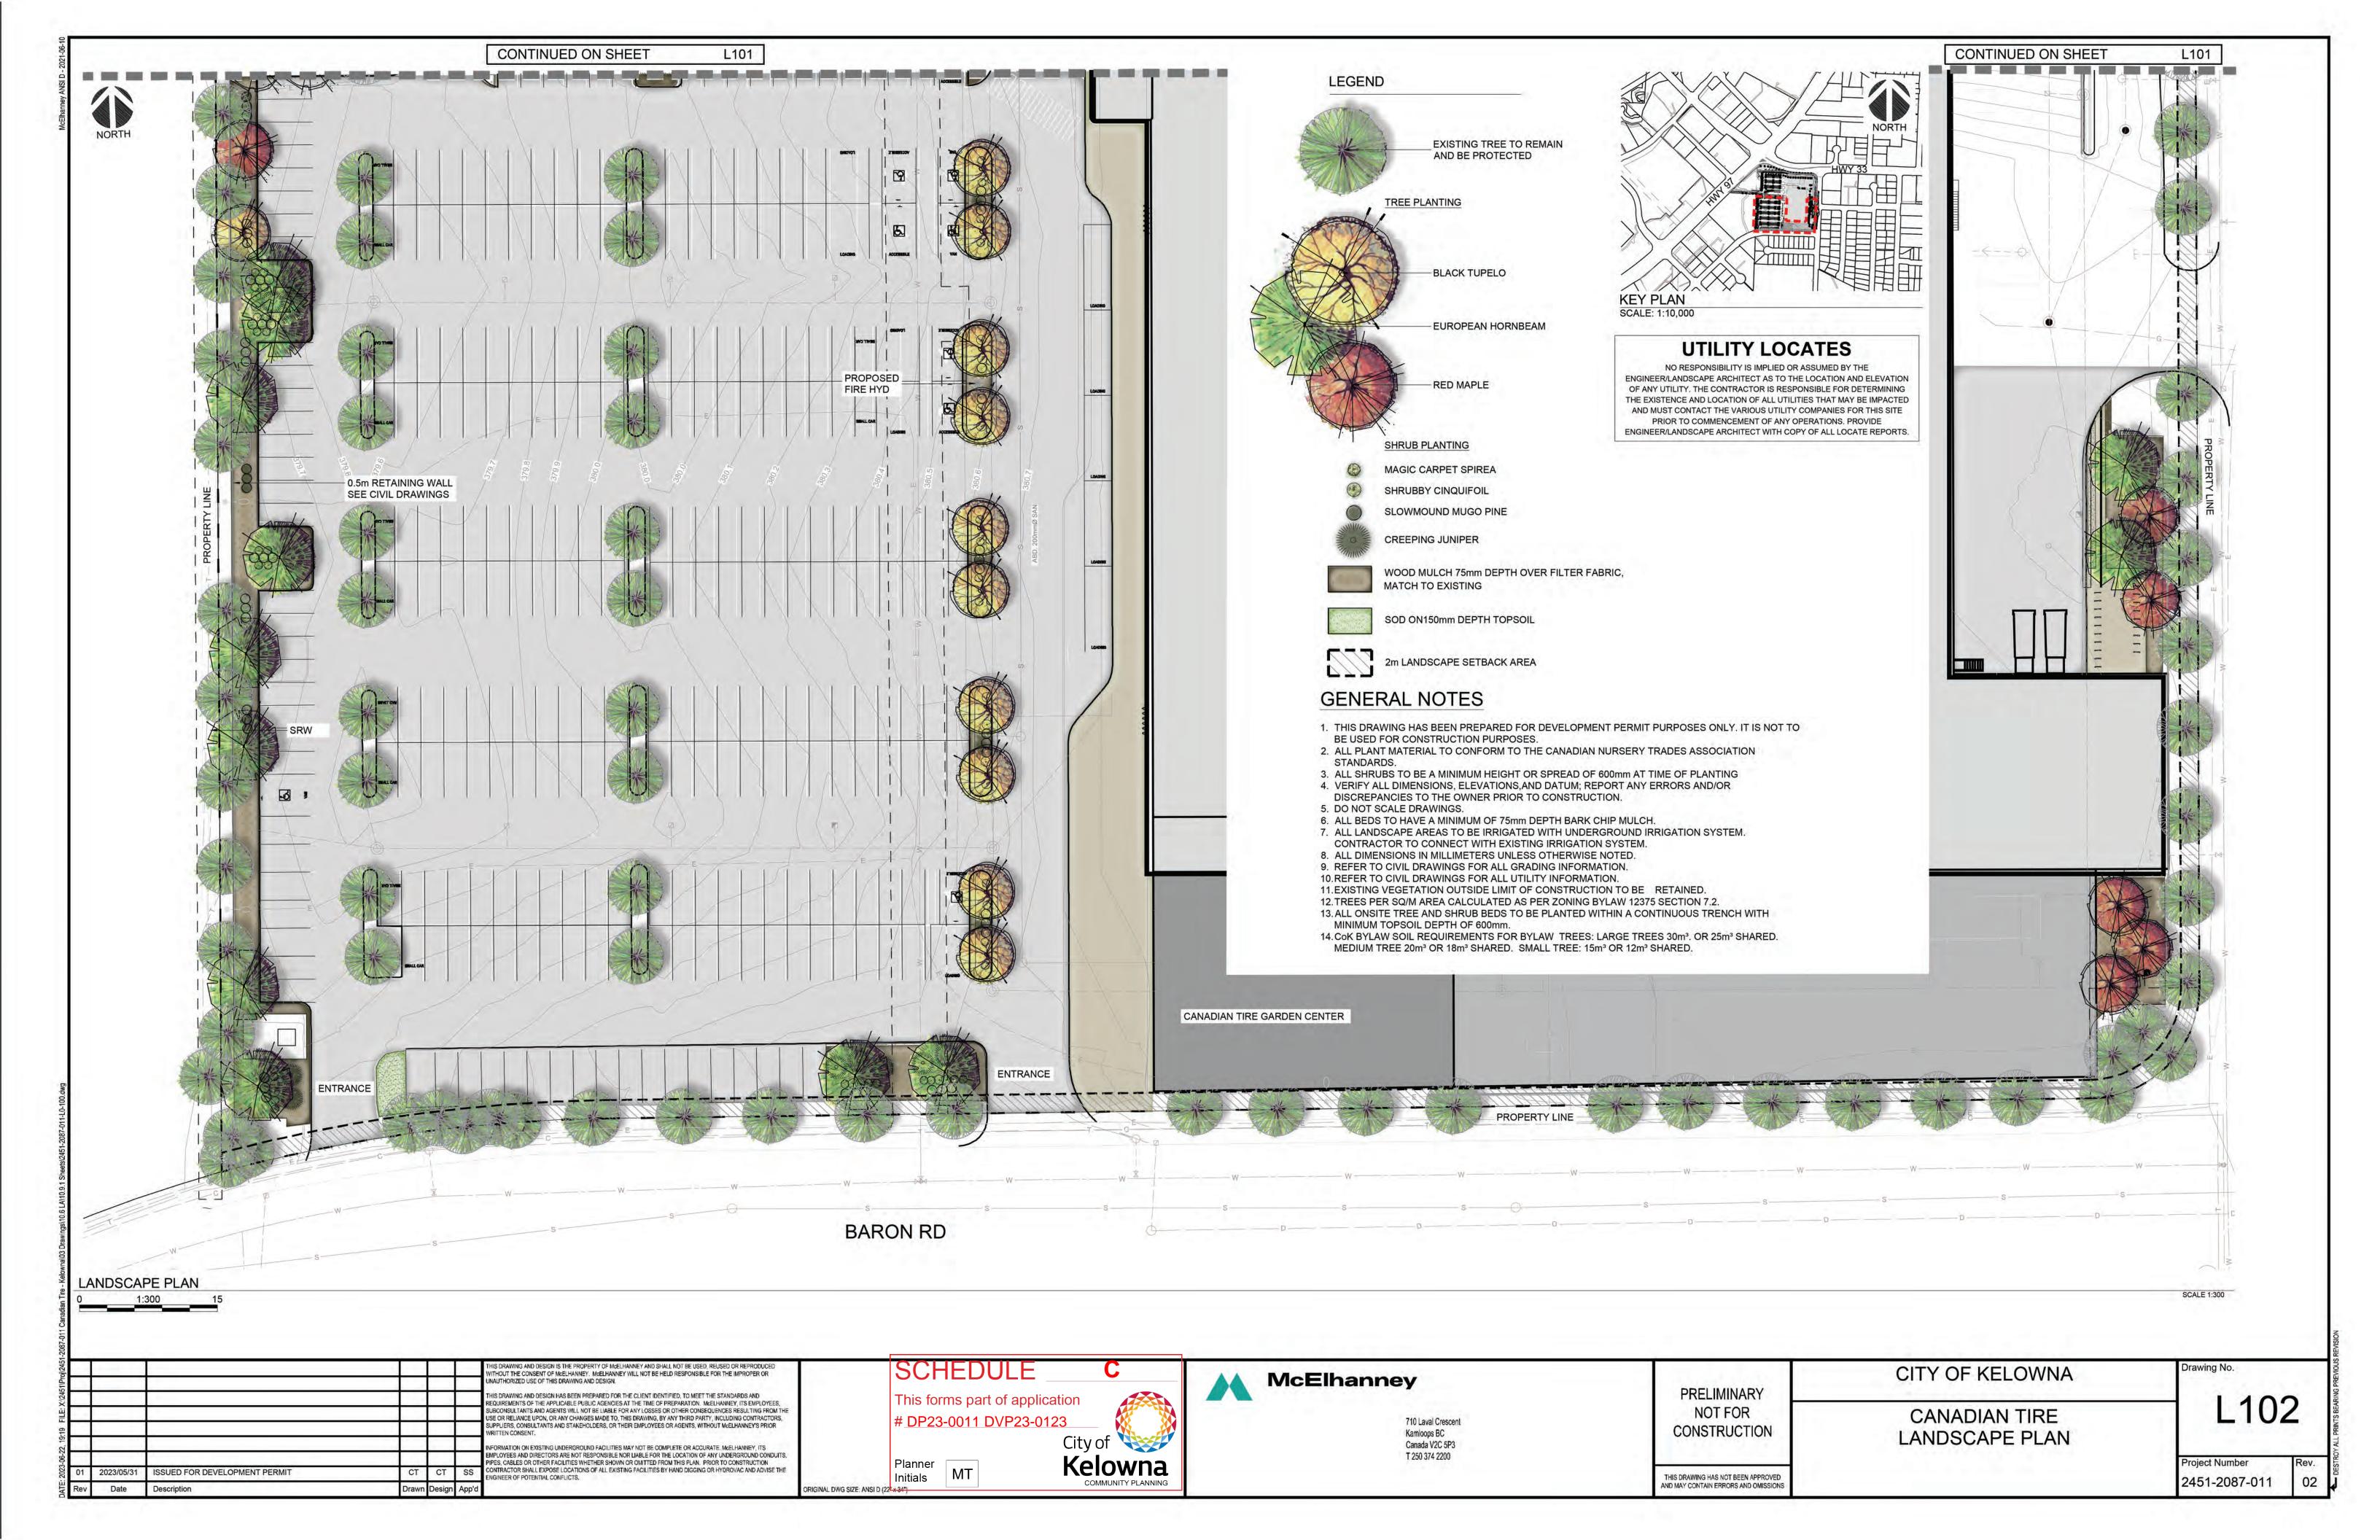	distinguish pedestrian routes from driving surfaces by using varied						
	paving treatments and/or raising walkways to curb level.						
h.	Base new development on an internal circulation pattern that						√
	allows logical movement throughout the site and that will						-
	accommodate, and not preclude, intensification over time.						
6.1	3 Site Servicing, Access, and Parking	N/A	1	2	3	4	5
a.	Design site accesses to provide the potential for future shared	, , .	_	_	<u> </u>	7	<i>√</i>
u.	access with neighbours and to minimize curb cuts.						\ \ \
b.	Where practical, link access drives and parking lots of adjacent						/
υ.	properties in order to allow for circulation of vehicles between						✓
	sites.						
					,		
C.	The preferred location for main parking areas is at the rear and/or				V		
	side of the building. Avoid locating large parking areas between						
	the building and the street.					_	
d.	Where parking areas are visible from the street, screen them using					✓	
	strategies such as tree planting, berming, low walls, decorative						
	fencing and/or hedging.						
e.	Break parking areas into smaller blocks defined by landscaping in				✓		
	order to minimize the amount of paved areas.						
f.	Locate loading, utilities, mechanical equipment and garbage					✓	
	collection areas away from public view by:						
•	Integrating these facilities into the footprint of the building; or						
•	Screening using fencing, walls, and/or landscaping						
6.1	4 Building Articulation, Features, and Materials	N/A	1	2	3	4	5
a.	Avoid facing unarticulated facades to the street and use				V		Ĭ
	projections, recesses, arcades, awnings, color, and texture to				`		
	improve the pedestrian experience						
b.	Design primary entrances to face the street, exhibit design						√
٥.	emphasis, and provide weather protection by means of canopy or						•
	emphasis, and provide weather proceeding by means of earlopy of						
	recessed entry						
	recessed entry. Design buildings such that their form and architectural character.						/
C.	Design buildings such that their form and architectural character						√
C.	Design buildings such that their form and architectural character reflect the building's internal function and use (e.g. an industrial						✓
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6.3 Large Format Retail							
6.3.1 Relationship to the Street		N/A	1	2	3	4	5
a.	Locate active uses at grade, such as restaurants, boutique shops,		\				
	food concessions and waiting areas and use clear windows and						
	doors to make the pedestrian level façade highly transparent						
6.3.2 Site Planning and Landscaping		N/A	1	2	3	4	5
a.	Break parking areas into smaller blocks defined by landscaped						✓
	islands and pedestrian paths (min. 1.5 m wide) in order to						
	minimize the amount of paved areas.						
b.	Design the internal circulation pattern to have direct connections						✓
	to surrounding streets.						
C.	Provide publicly-accessible open space on-site to provide places to		^				
	linger.						
d.	Provide site furnishings, such as seating, bike racks, and shelters					✓	
	at building entrances and amenity areas.						
6.3.3 Site Servicing, Access, and Parking		N/A	1	2	3	4	5
a.	Provide sheltered bicycle parking in visible and well-lit locations					✓	
	near building entrances and pedestrian walkways.						
6.3.4 Building Articulation, Features & Materials		N/A	1	2	3	4	5
a.	Design the façade of buildings with multiple storefronts so that	✓					
	each is defined through individual signage, entrances, canopies,						
	and/or materiality.						
b.	Wrap large format retail uses with smaller retail units around the		✓				
	periphery with individual entries accessed from the fronting						
	sidewalk or open space.						



PHASE SIGNOFF

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Sign off of this package constitutes approval and completion of the ISSUED FOR DP UPDATE phase of this project; and includes approval of all presented materials including: floor plan(s), general design concept, general finishes concept and general millwork concept(s). Further development of the project will be completed in upcoming Design Development and Technical
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CTR 353 KELOWNA

2479 Hwy 97 N, Kelowna, BC

Legal Description Plan: KAP45081 Lot: 2

Scale Project No. 22016 Checked By Drawn By

Drawing

COVER

Revision No. Sheet No.

302, Alberta Block 10526 Jasper Avenue NW

P 780 702 2462 www.nextarchitecture.ca

Edmonton AB T5J 1Z7

CTR 353 KELOWNA

- IMAGE FOR ILLUSTRATION PURPOSES ONLY -





1 MAIN ENTRANCE PERSPECTIVE SCALE:

2 MAIN ENTRANCE PERSPECTIVE 2
SCALE:



ORDER PICK-UP

3 OVERALL PERSPECTIVE 1
SCALE:

4 OVERALL PERSPECTIVE 2
SCALE:



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CTR 353 KELOWNA

2479 Hwy 97 N, Kelowna, BC

Legal Description

Plan: KAP45081 Lot: 2

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3D RENDERS

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1 FRONT EXIT CANOPY OPTION BLACK
SCALE:

2 | FRONT ENTRANCE CANOPY OPTION BLACK SCALE:



3 EYE LEVEL MAIN ENTRANCE PERSPECTIVE SCALE:



2 2023.06.16 ISSUED FOR DP UPDATE
1 2023.05.25 ISSUED FOR DP

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CTR 353 KELOWNA

Address 2479 Hwy 97 N, Kelowna, BC

Plan: KAP45081 Lot: 2

Scale Project No.

22016

Drawn By Checked By Approved By
IA Checker Approver

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Package Signoff:

Name (Printed):_





INTERIOR ENTRANCE PERSPECTIVE SCALE:



2 INTERIOR VESTIBULE EXIT PERSPECTIVE SCALE:



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Checker Drawing

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3 FRONT EXIT CANOPY OPTION WOOD SCALE: