# **Development Permit**

# DP22-0177



This permit relates to land in the City of Kelowna municipally known as

# 2592 Hwy 97 N

and legally known as

# Lot A District Lot 125 ODYD Plan EPP118863

and permits the land to be used for the following development:

## Hotels / Motels

The present owner and any subsequent owner of the above described land must comply with any attached terms and conditions.

Date of Council Approval:	February 6, 2023
Development Permit Area:	Form and Character
Existing Zone:	CA1 – Core Area Mixed Use
Future Land Use Designation:	RCOM – Regional Commercial

This Development Permit is valid for two (2) years from the date of approval, with no opportunity to extend.

# This is NOT a Building Permit.

In addition to your Development Permit, a Building Permit may be required prior to any work commencing. For further information, contact the City of Kelowna, Development Services Branch.

# <u>NOTICE</u>

This permit does not relieve the owner or the owner's authorized agent from full compliance with the requirements of any federal, provincial or other municipal legislation, or the terms and conditions of any easement, covenant, building scheme or agreement affecting the building or land.

Owner:

647700 B.C. LTD., INC.NO. BC0647700

Applicant:

Premier Building Solutions

Terry Barton Development Planning Department Manager Planning & Development Services Date of Issuance



### SCOPE OF APPROVAL 1.

This Development Permit applies to and only to those lands within the Municipality as described above, and any and all buildings, structures and other development thereon.

This Development Permit is issued subject to compliance with all of the Bylaws of the Municipality applicable thereto, except as specifically varied or supplemented by this permit, noted in the Terms and Conditions below.

The issuance of a permit limits the permit holder to be in strict compliance with regulations of the Zoning Bylaw and all other Bylaws unless specific variances have been authorized by the Development Permit. No implied variances from bylaw provisions shall be granted by virtue of drawing notations that are inconsistent with bylaw provisions and that may not have been identified as required Variances by the applicant or Municipal staff.

### CONDITIONS OF APPROVAL 2.

THAT Council authorizes the issuance of Development Permit No. DP22-0177 for Lot A District Lot 125 ODYD Plan EPP118863 located at 2592 Hwy 97 N, Kelowna, BC, subject to the following:

- a) The dimensions and siting of the building to be constructed on the land be in accordance with Schedule "A";
- b) The exterior design and finish of the building to be constructed on the land be in accordance with Schedule "B";
- Landscaping to be provided on the land be in accordance with Schedule "C"; c)
- d) The applicant be required to post with the City a Landscape Performance Security deposit in the amount of 125% of the estimated value of the Landscape Plan, as determined by a Registered Landscape Architect;

### PERFORMANCE SECURITY 3.

As a condition of the issuance of this Permit, Council is holding the security set out below to ensure that development is carried out in accordance with the terms and conditions of this Permit. Should any interest be earned upon the security, it shall accrue to the Developer and be paid to the Developer or his or her designate if the security is returned. The condition of the posting of the security is that should the Developer fail to carry out the development hereby authorized, according to the terms and conditions of this Permit within the time provided, the Municipality may use enter into an agreement with the property owner of the day to have the work carried out, and any surplus shall be paid over to the property owner of the day. Should the Developer carry out the development as per the conditions of this permit, the security shall be returned to the Developer or his or her designate following proof of Substantial Compliance as defined in Bylaw No. 12310. There is filed accordingly:

a) An Irrevocable Letter of Credit OR certified cheque OR a Surety Bond in the amount of \$94,872.99

Before any bond or security required under this Permit is reduced or released, the Developer will provide the City with a statutory declaration certifying that all labour, material, workers' compensation and other taxes and costs have been paid.

### INDEMNIFICATION 4.

Planner

Initials


JI

Upon commencement of the works authorized by this Permit the Developer covenants and agrees to save harmless and effectually indemnify the Municipality against:


All actions and proceedings, costs, damages, expenses, claims, and demands whatsoever and by whomsoever brought, by a) reason of the Municipality said Permit.


All costs, expenses, claims that may be incurred by the Municipality where the construction, engineering or other types of works as called for by the Permit results in damages to any property owned in whole or in part by the Municipality or which the Municipality by duty or custom is obliged, directly or indirectly in any way or to any degree, to construct, repair, or maintain.


### TACHMENT А The PERMIT HOLDER is the CURRENT LAND OWNER. This forms part of application Security shall ONLY be returned to the signatory of the # DP22-0177 Landscape Agreement or their designates.

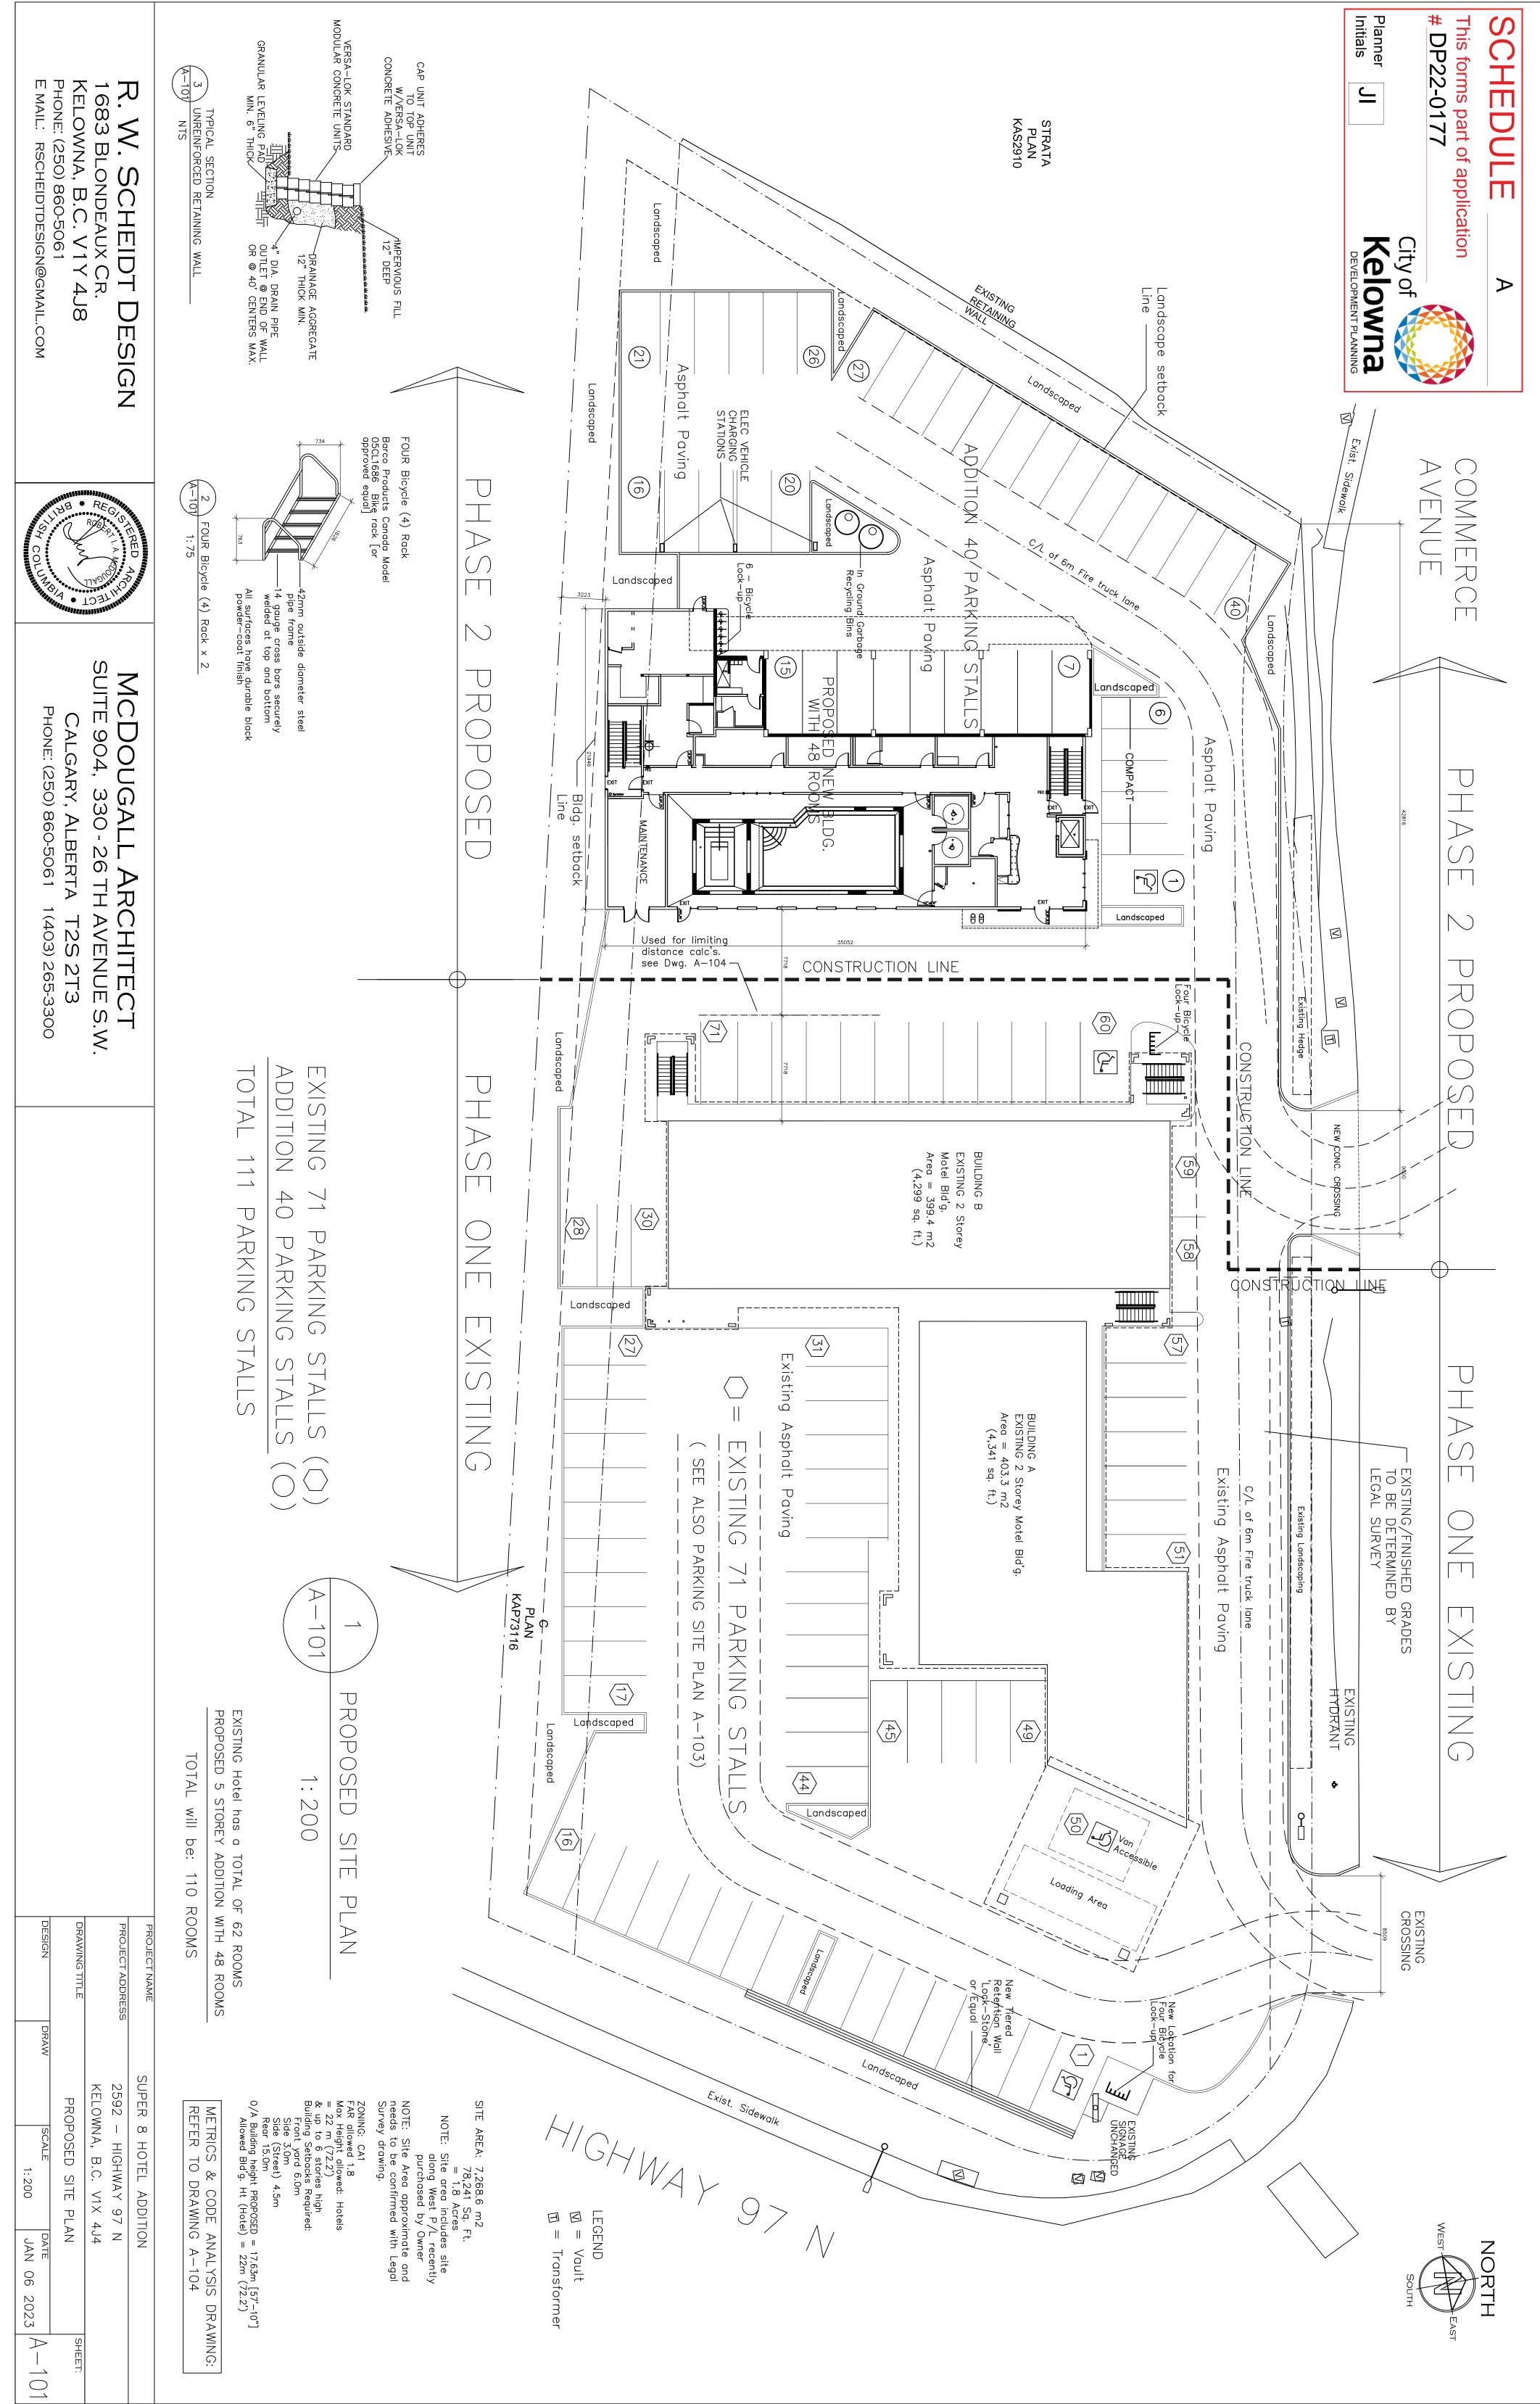





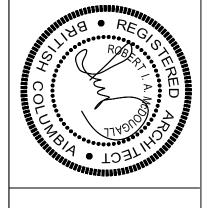


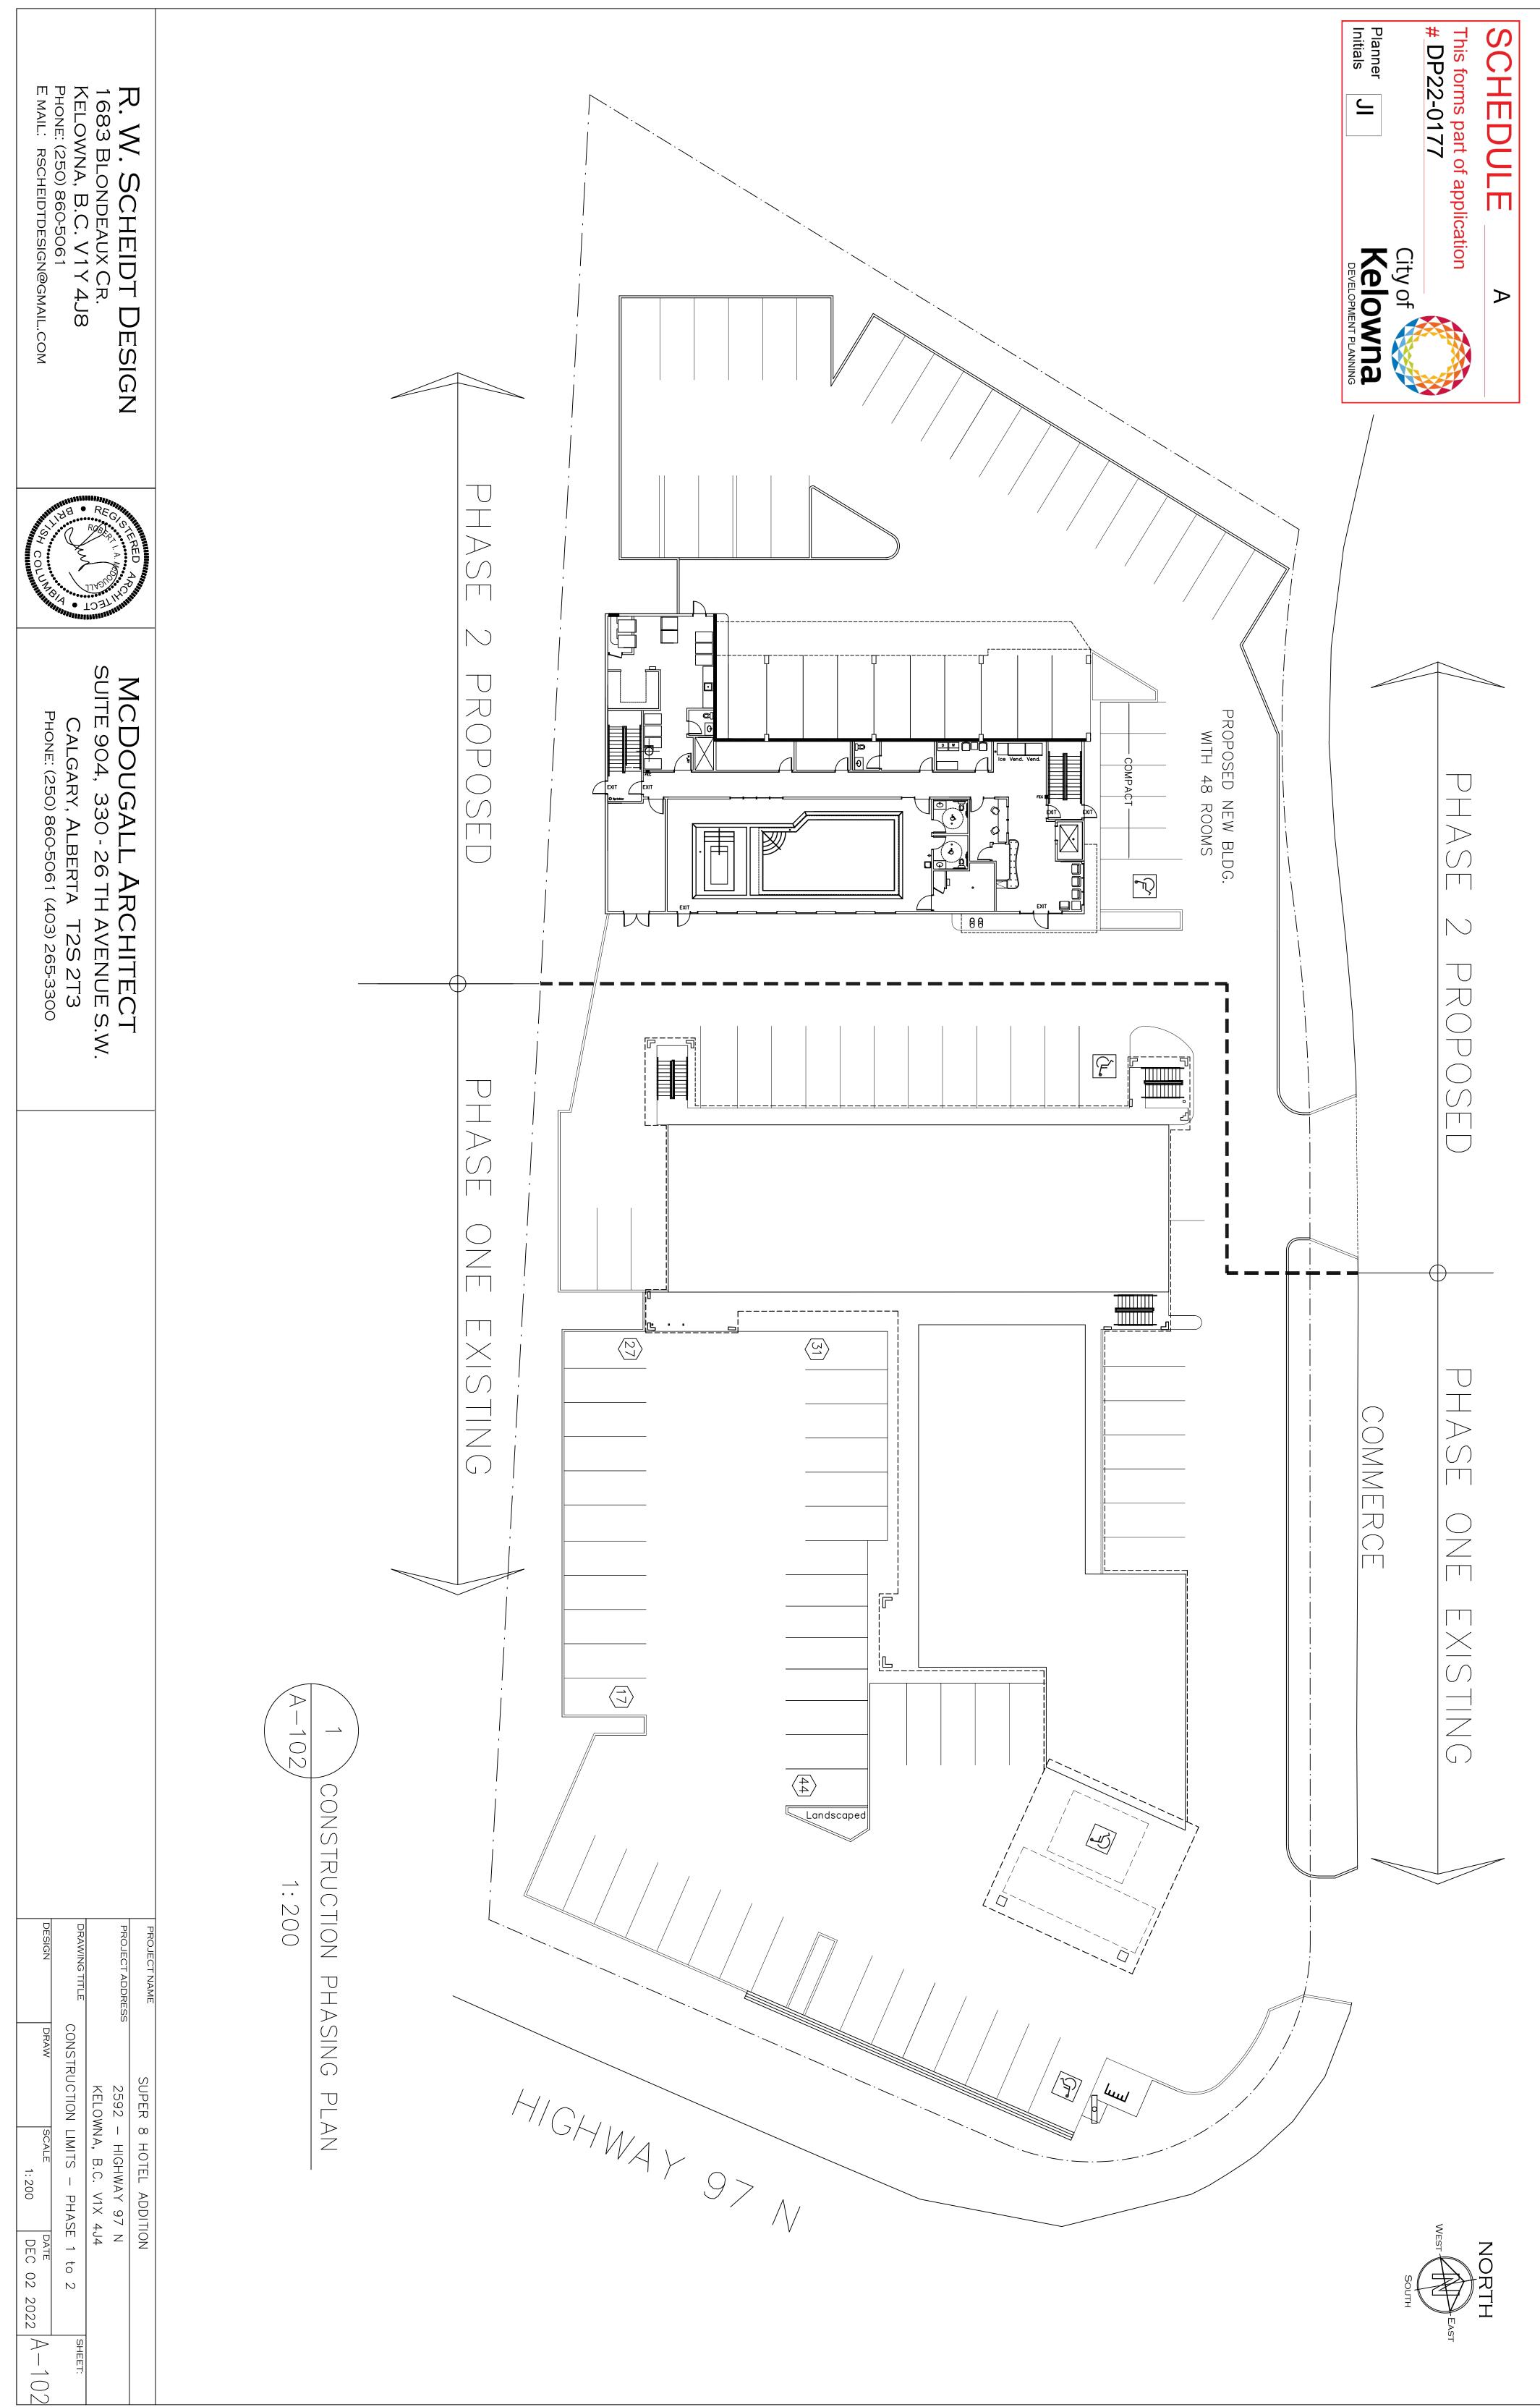


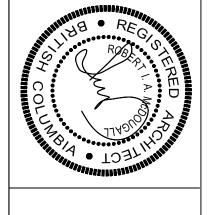


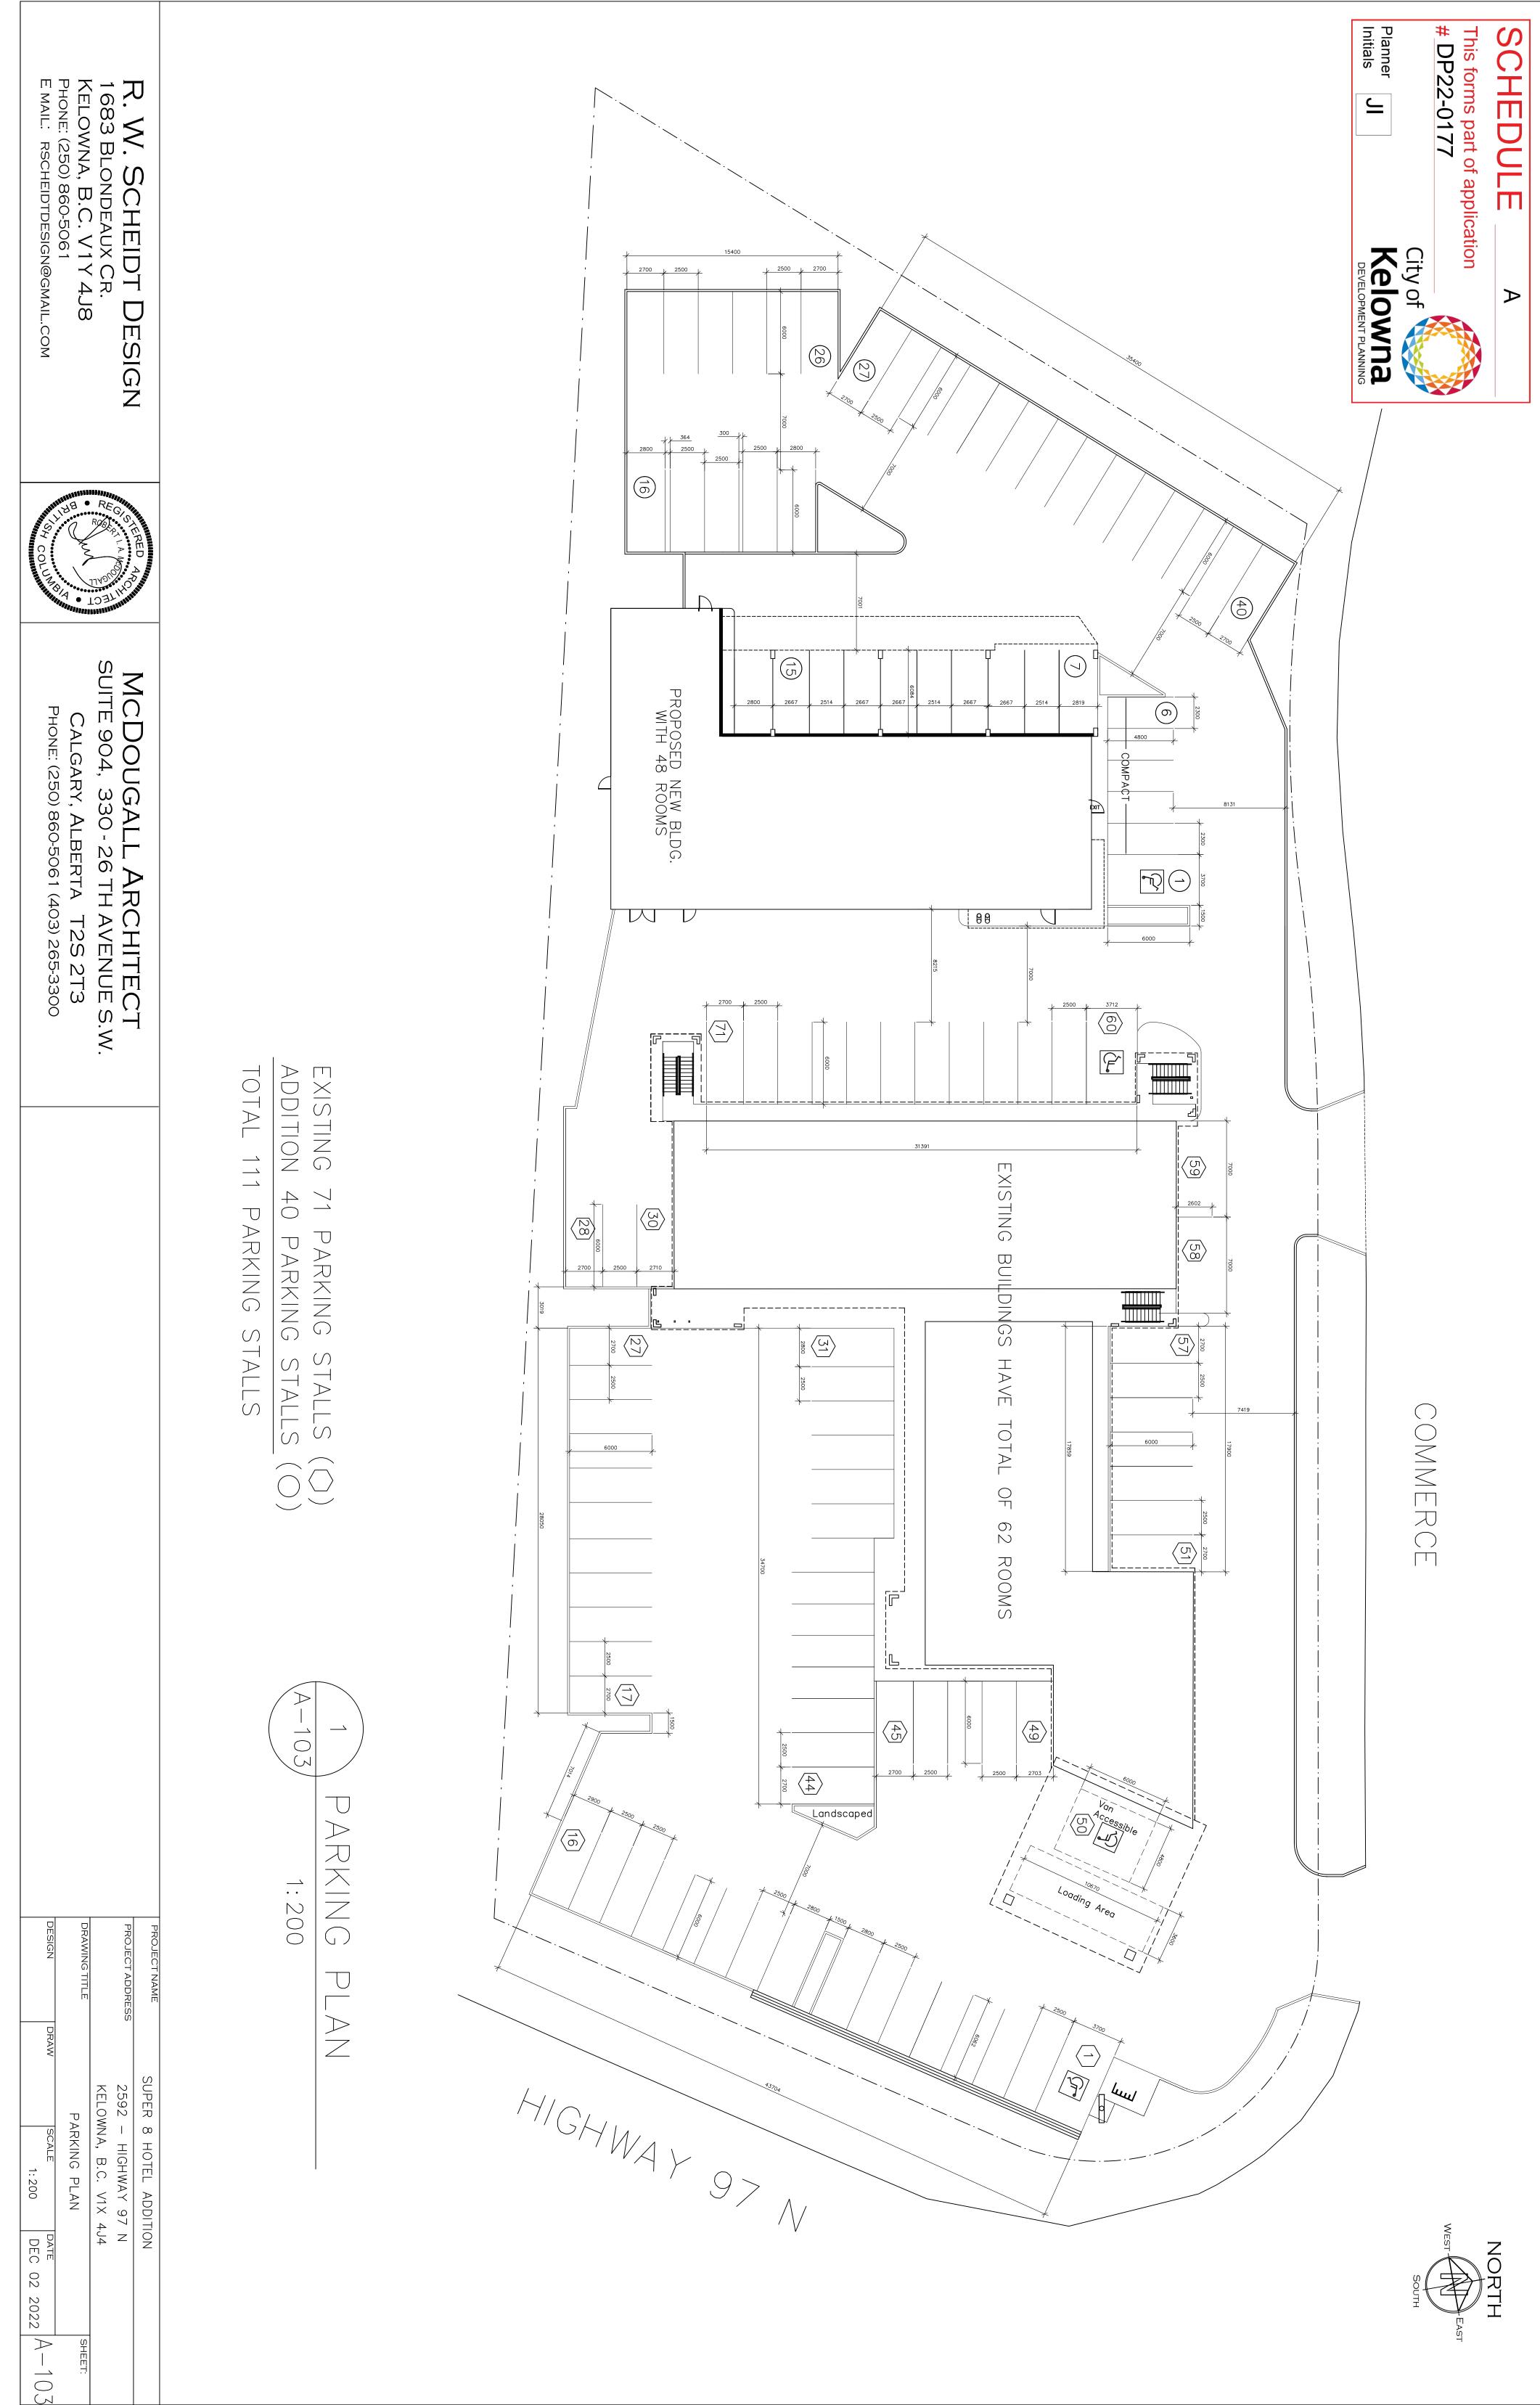


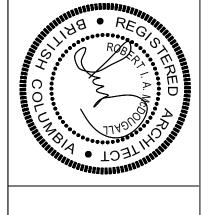

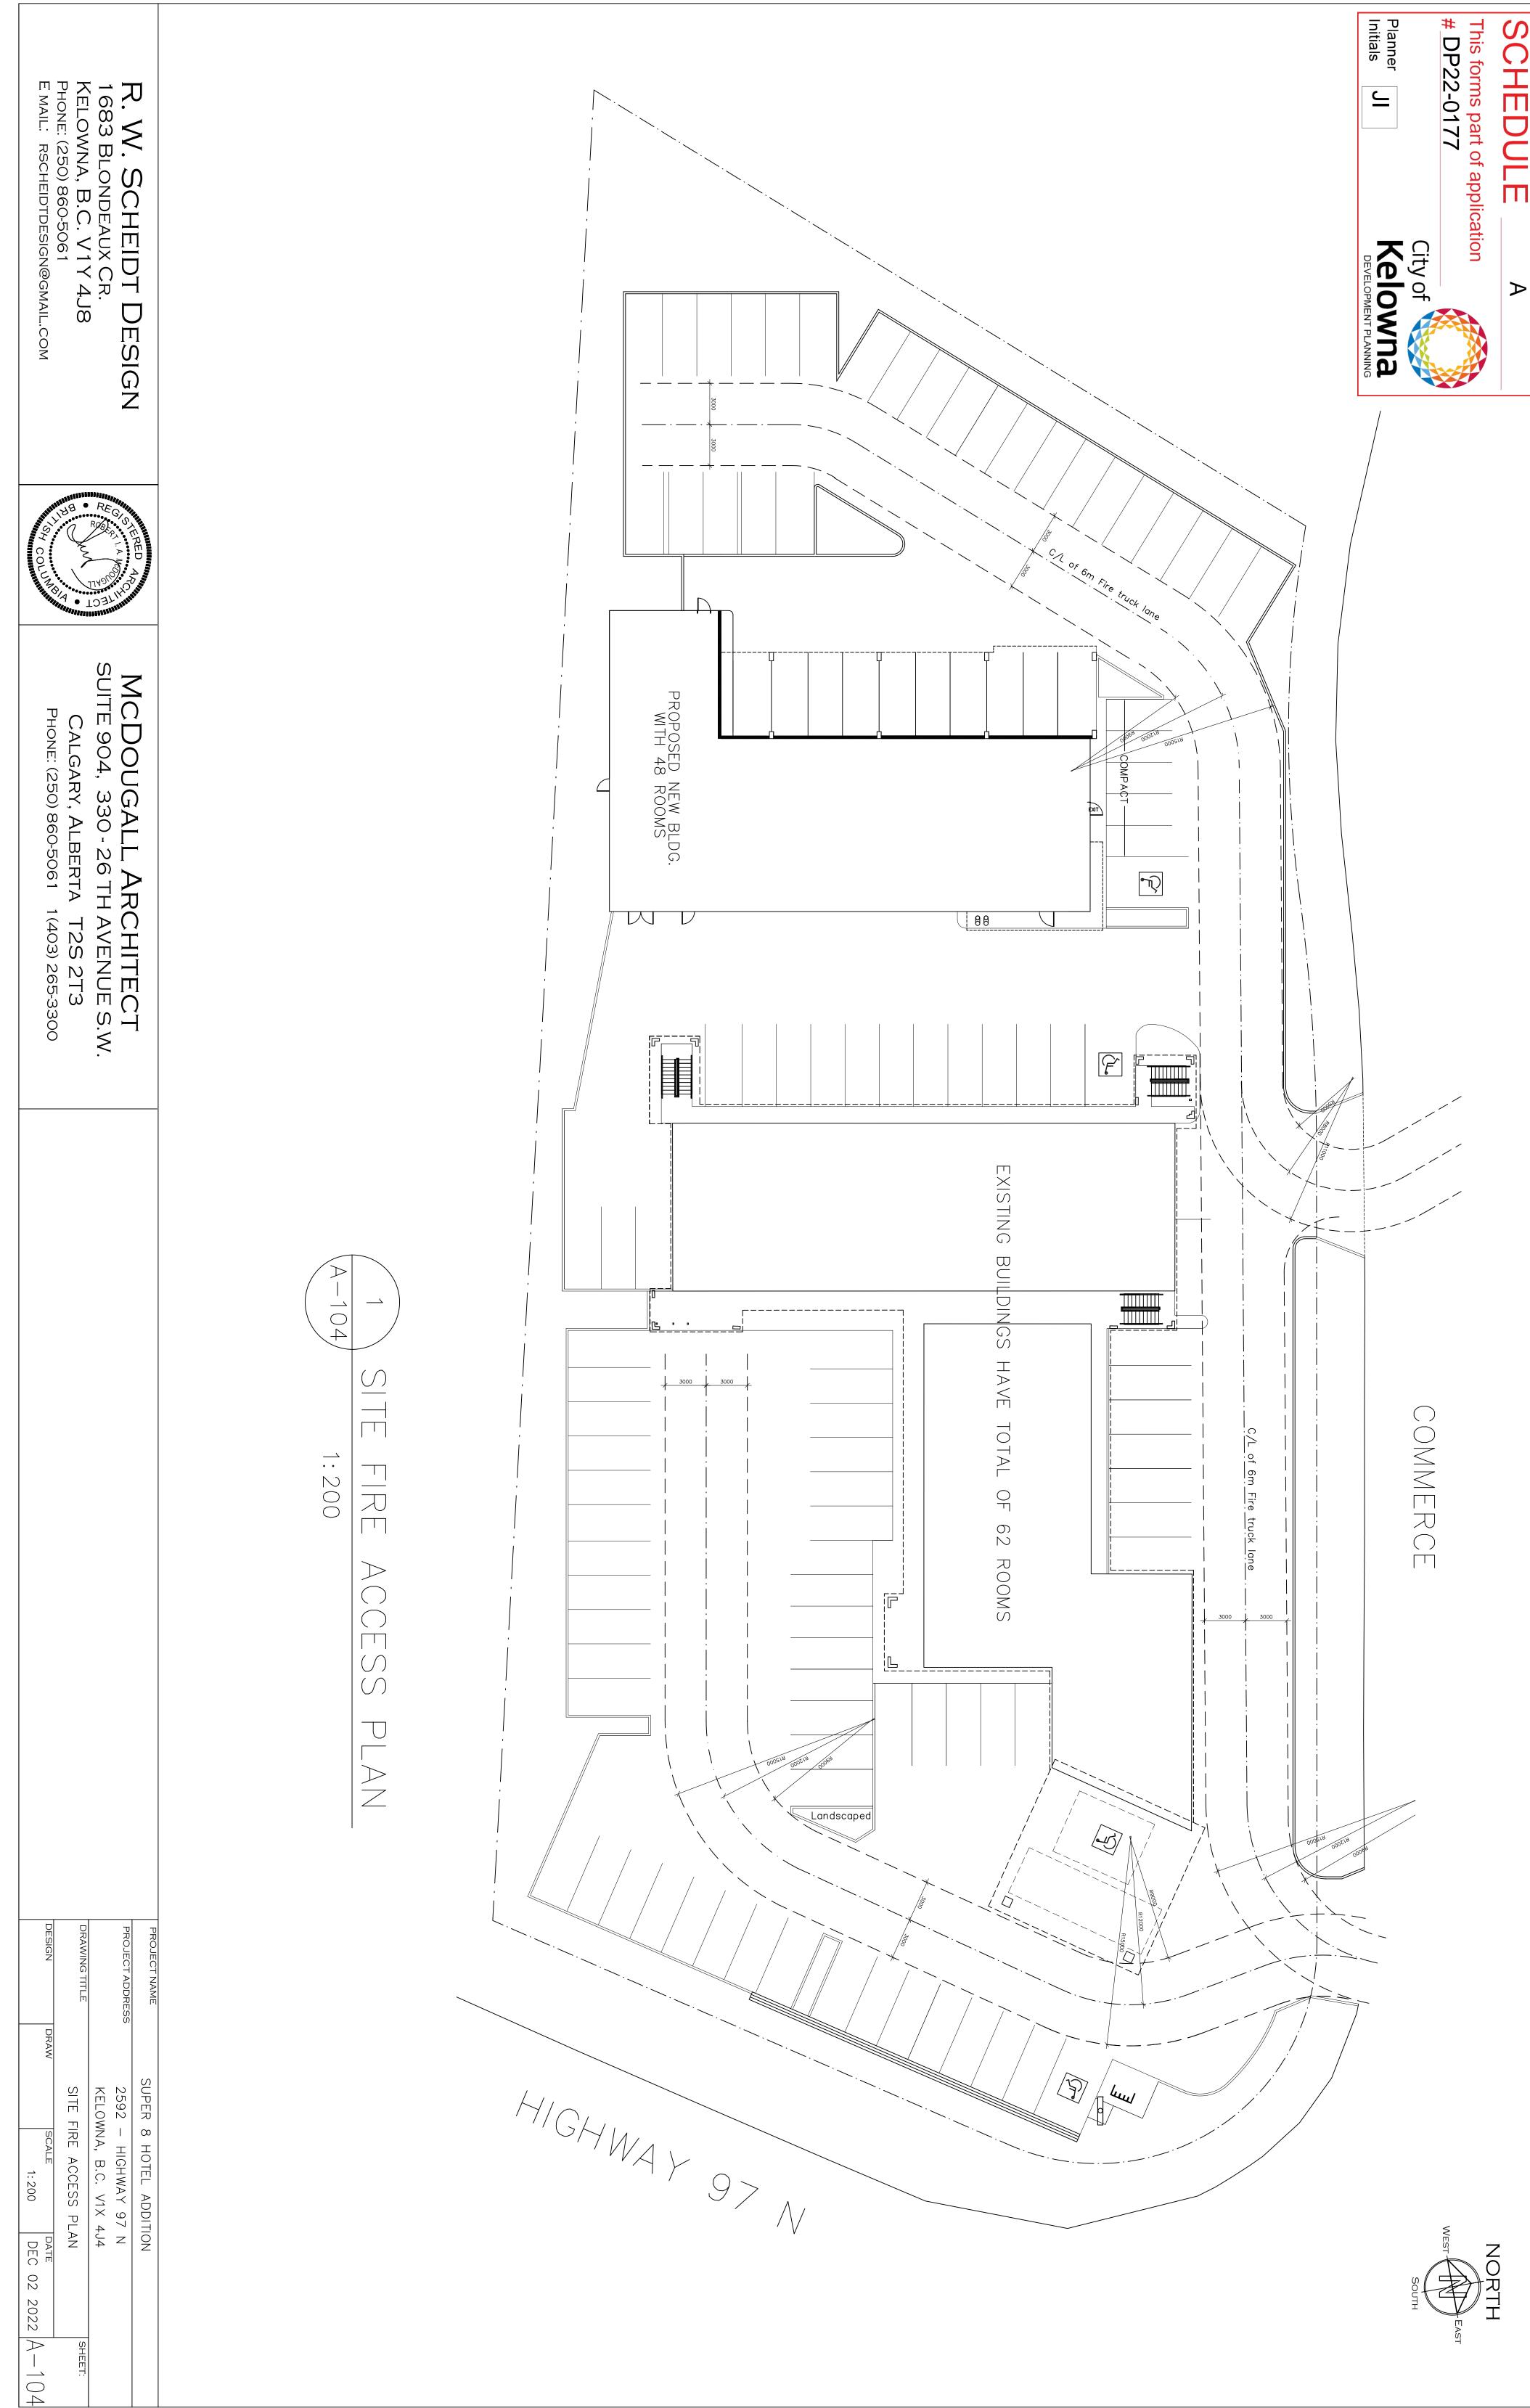


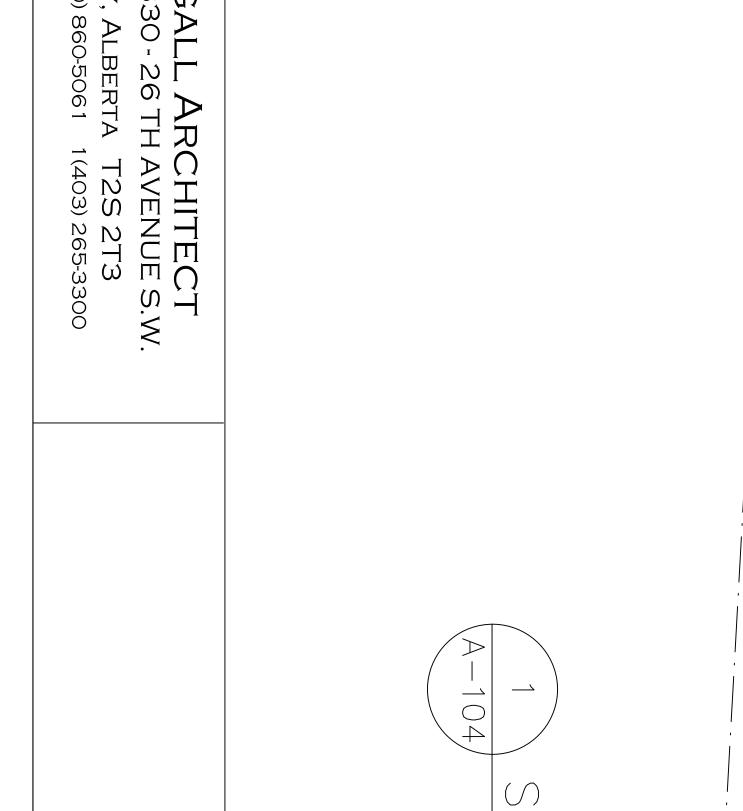

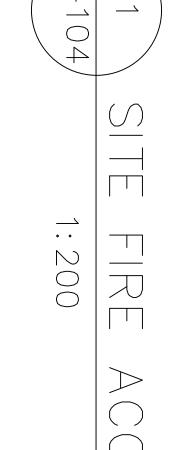

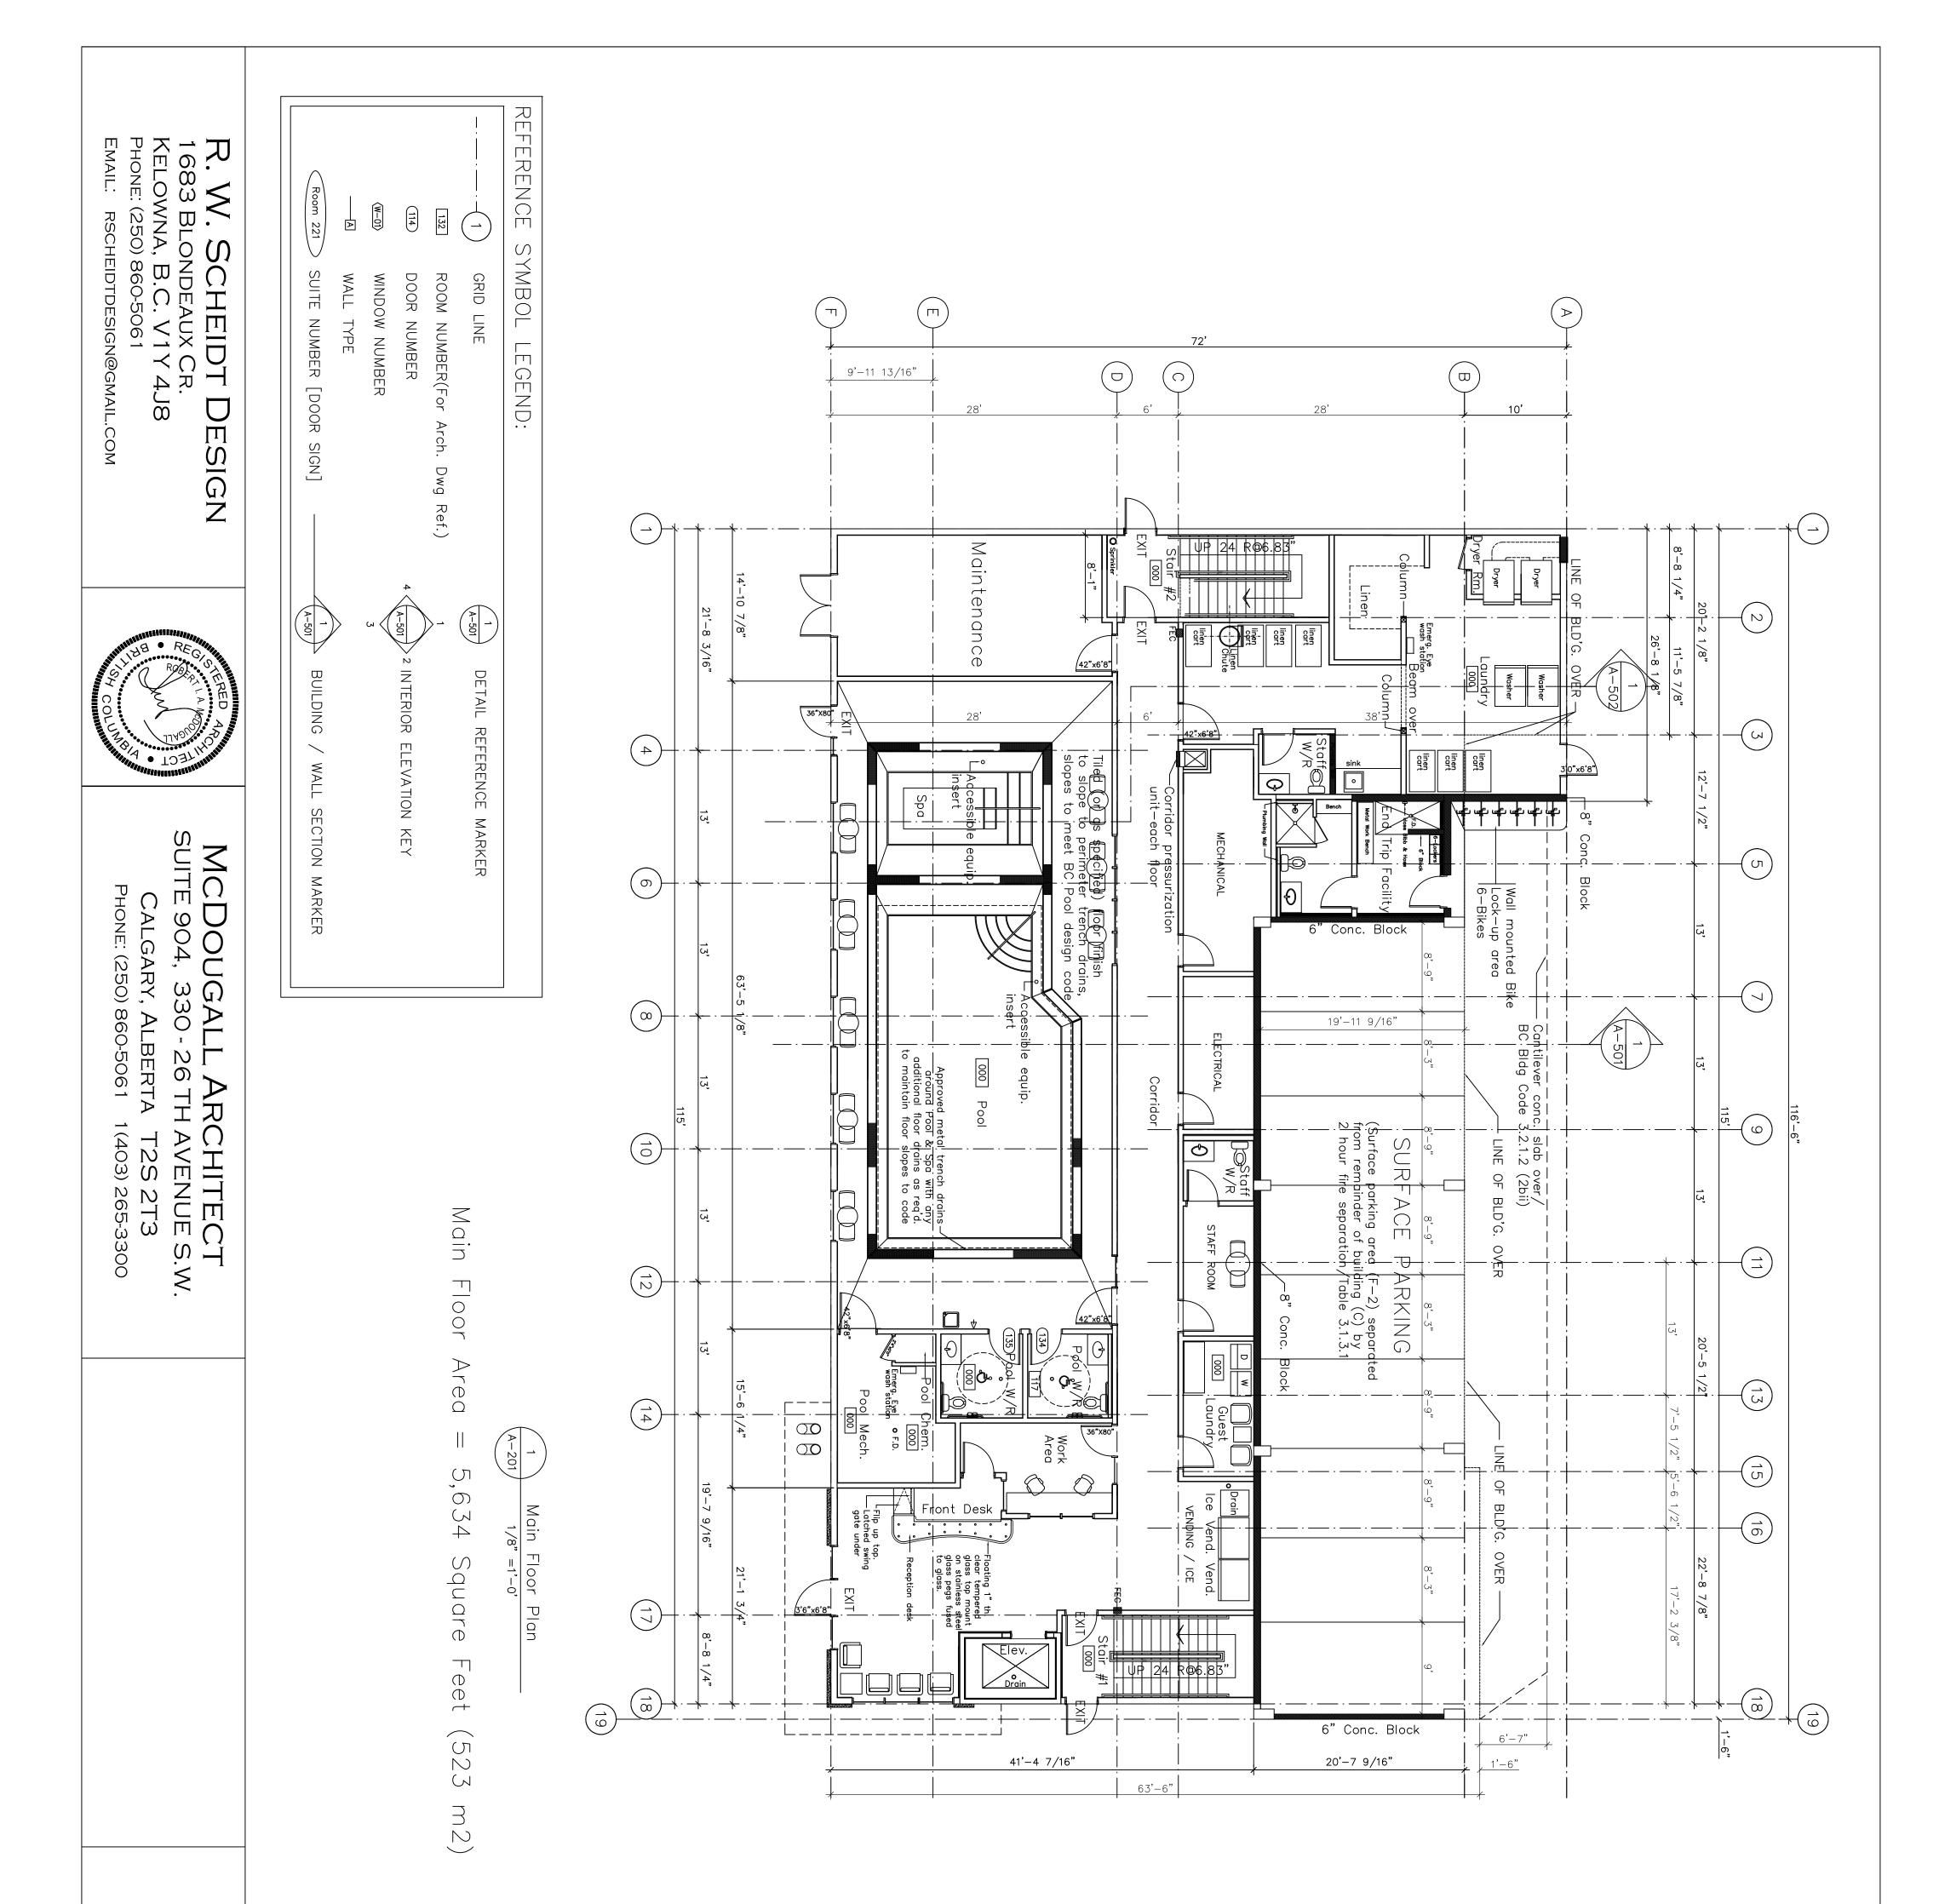

SOI

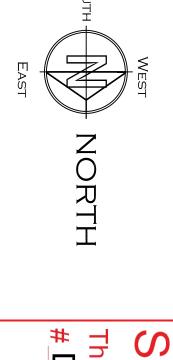



PROPOSED KELOWNA SUPER 8 HOTEL ADDITION EXISTING: 62 Rooms ADDITION PROPOSED = 48 ROOMS TOTAL ROOMS TO BE: 110 <u>CWC ADDRESS</u> 2592 HIGHWAY 97 N., KELOWNA B.C. V1X 4J4 <u>EEGAL DESCRETION</u> LOT 125 OSOYOOS DIVISION YALE DISTRICT PLAN 3522 EXCEPT PLAN KAP87674 PROJECT DATA: REFER TO DRAWING A-104 METRICS & CODE ANALYSIS DRAWING GROUP C (Hote)) - 3.2.2.50 GROUP C (Hote)) - 3.2.2.50 COMBUSTBLE OR NON COMBUSTBLE CONSTRUCTION FULLY SPRINKLERED COMBUSTBLE OR NON COMBUSTBLE CONSTRUCTION FLOOR ASSEMBLES-FIRE SEPARATION WITH 1 HOU' FIRE RESISTANCE RATING. ROOF 1 HOUR FIRE RESISTANCE RATING. POOL DESIGN: General Contractor to retain qualified pool design sub-contractor copuble of preparing pool shop drawings. for opproval. Pool design sub-contractor copuble of preparing pool shop drawings. for mounting docensible equipment to be installed to Pool & Spa.

 PROJECT NAME
 SUPER 8 HOTEL ADDITION

 PROJECT ADDRESS
 KELOWNA, BRITISH COLUMBIA

 DRAWING TITLE
 MAIN Floor Plan


 DESIGN
 DRAW


 DESIGN
 DRAW


 DRAW
 SCALE


 1/8"=1'-0"
 JAN 06 2023

201

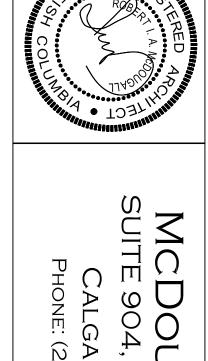

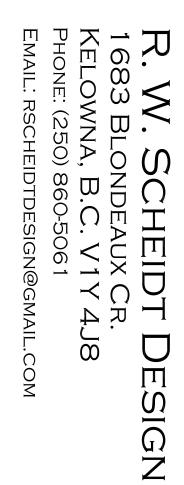

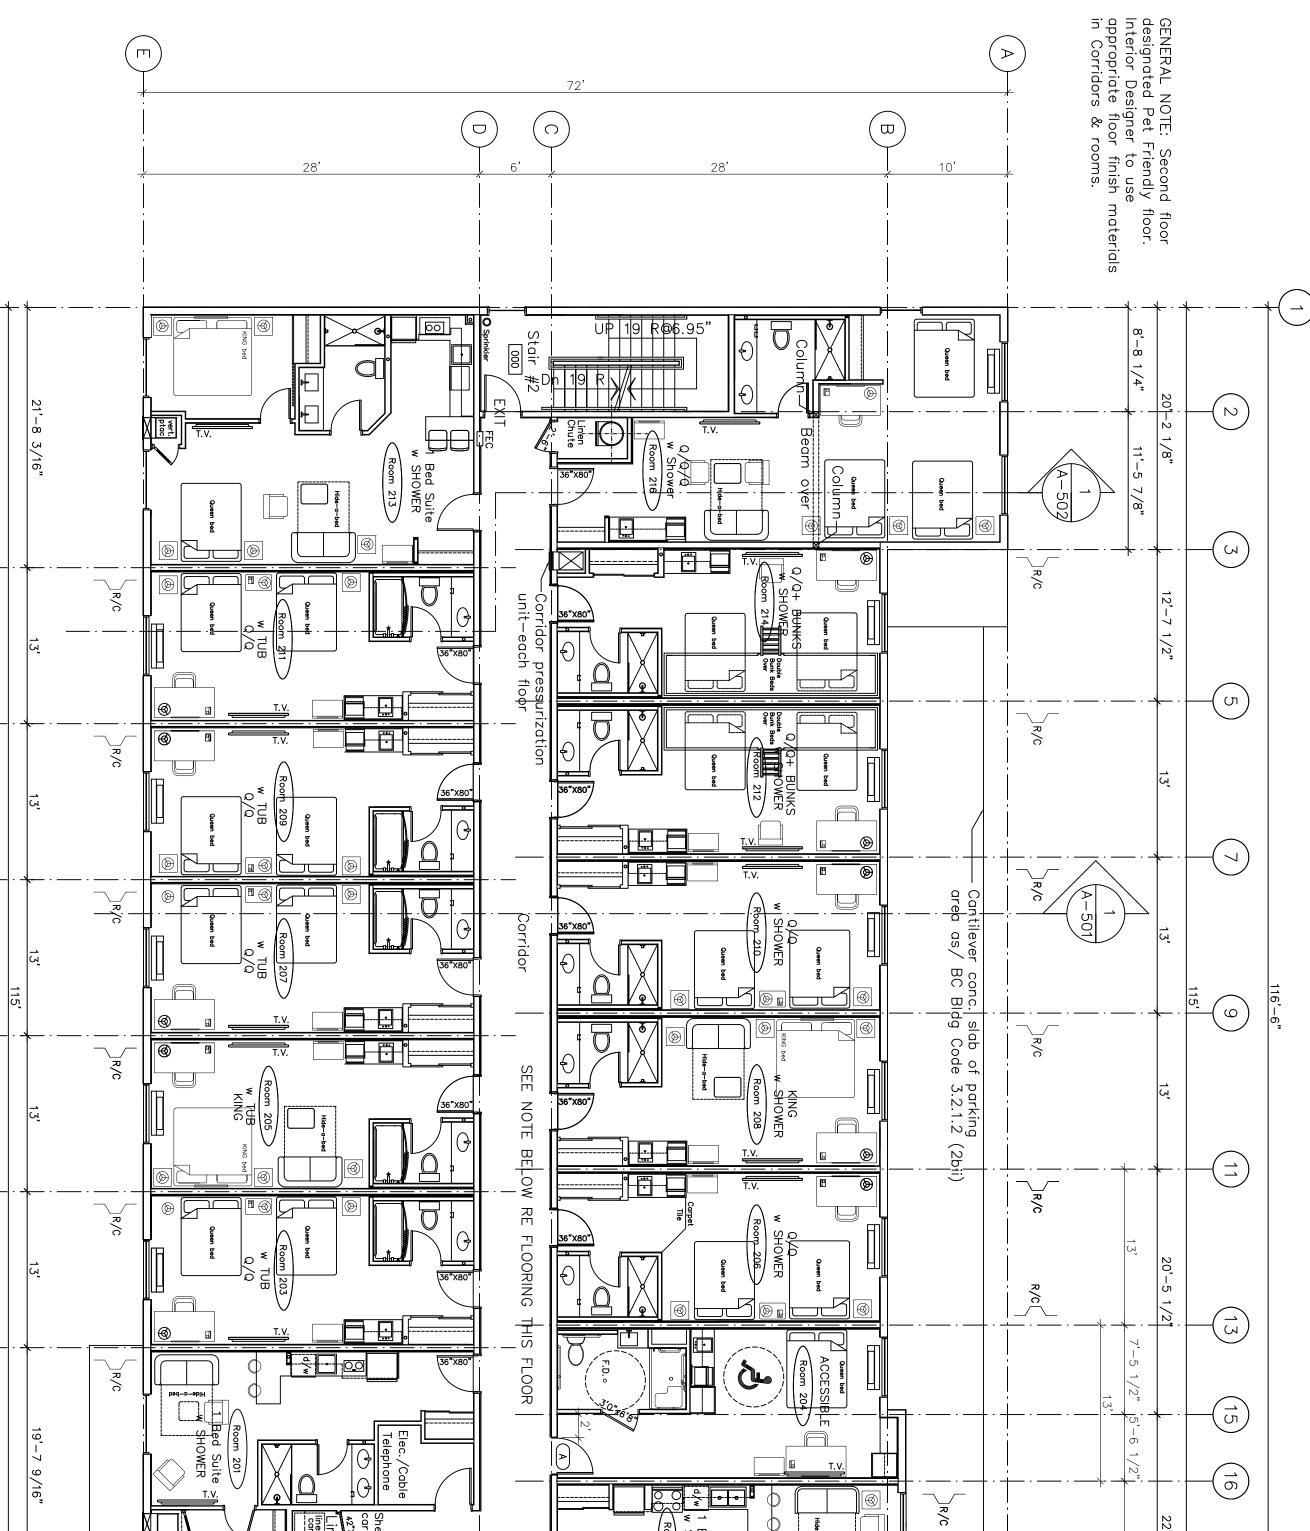

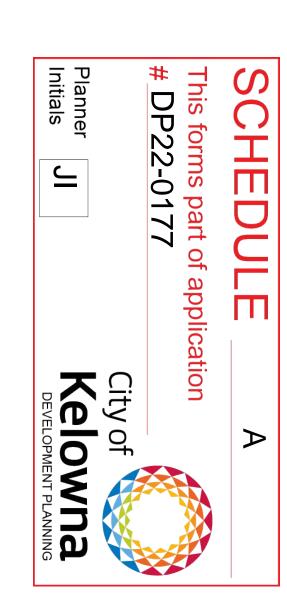

MCDOUGALL ARCHITECT SUITE 904, 330 - 26 TH AVENUE S.W. CALGARY, ALBERTA T2S 2T3 PHONE: (250) 860-5061 (403) 265-3300

> $\Box$ ROOMS

Floor Area =  $\sim$ 

]R/C A-202 RESILIENT NH SE

GENERAL NOTE: Second floor designated Pet Friendly floor. Interior Designer to use appropriate floor finish materials in Corridors & rooms.

(10)


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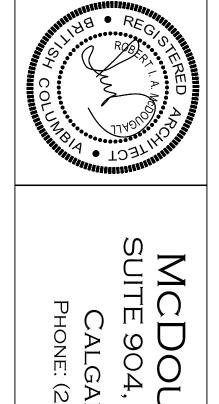
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6





			SECOND FLOOR	=1'-0' quare Fe	r channel side of wall COND Floor Plan	8 <sup>°</sup> -81/4" 1 <sup>°</sup> -6"		Drain			22'-8 7/8"	
1 01	NTLE KELOW	PROJECT NAME SUPER 8 HOTEL										EAST
DATE DEC 07 2022	COLUMBIA	FEL ADDITION										


SOUTH NORTH

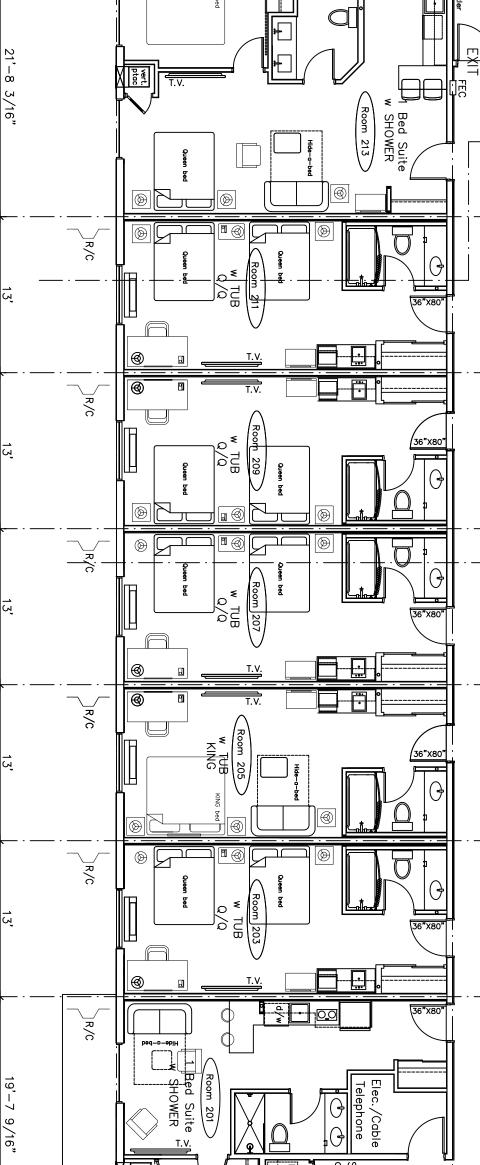


R. W. SCHEIDT DESIGN 1683 BLONDEAUX CR. Kelowna, B.C. V1Y 4J8 Phone: (250) 860-5061 Email: RSCHEIDTDESIGN@GMAIL.COM

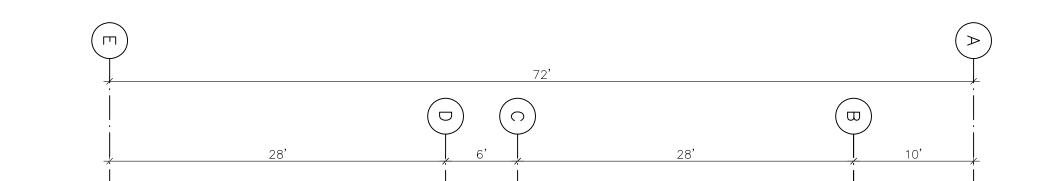

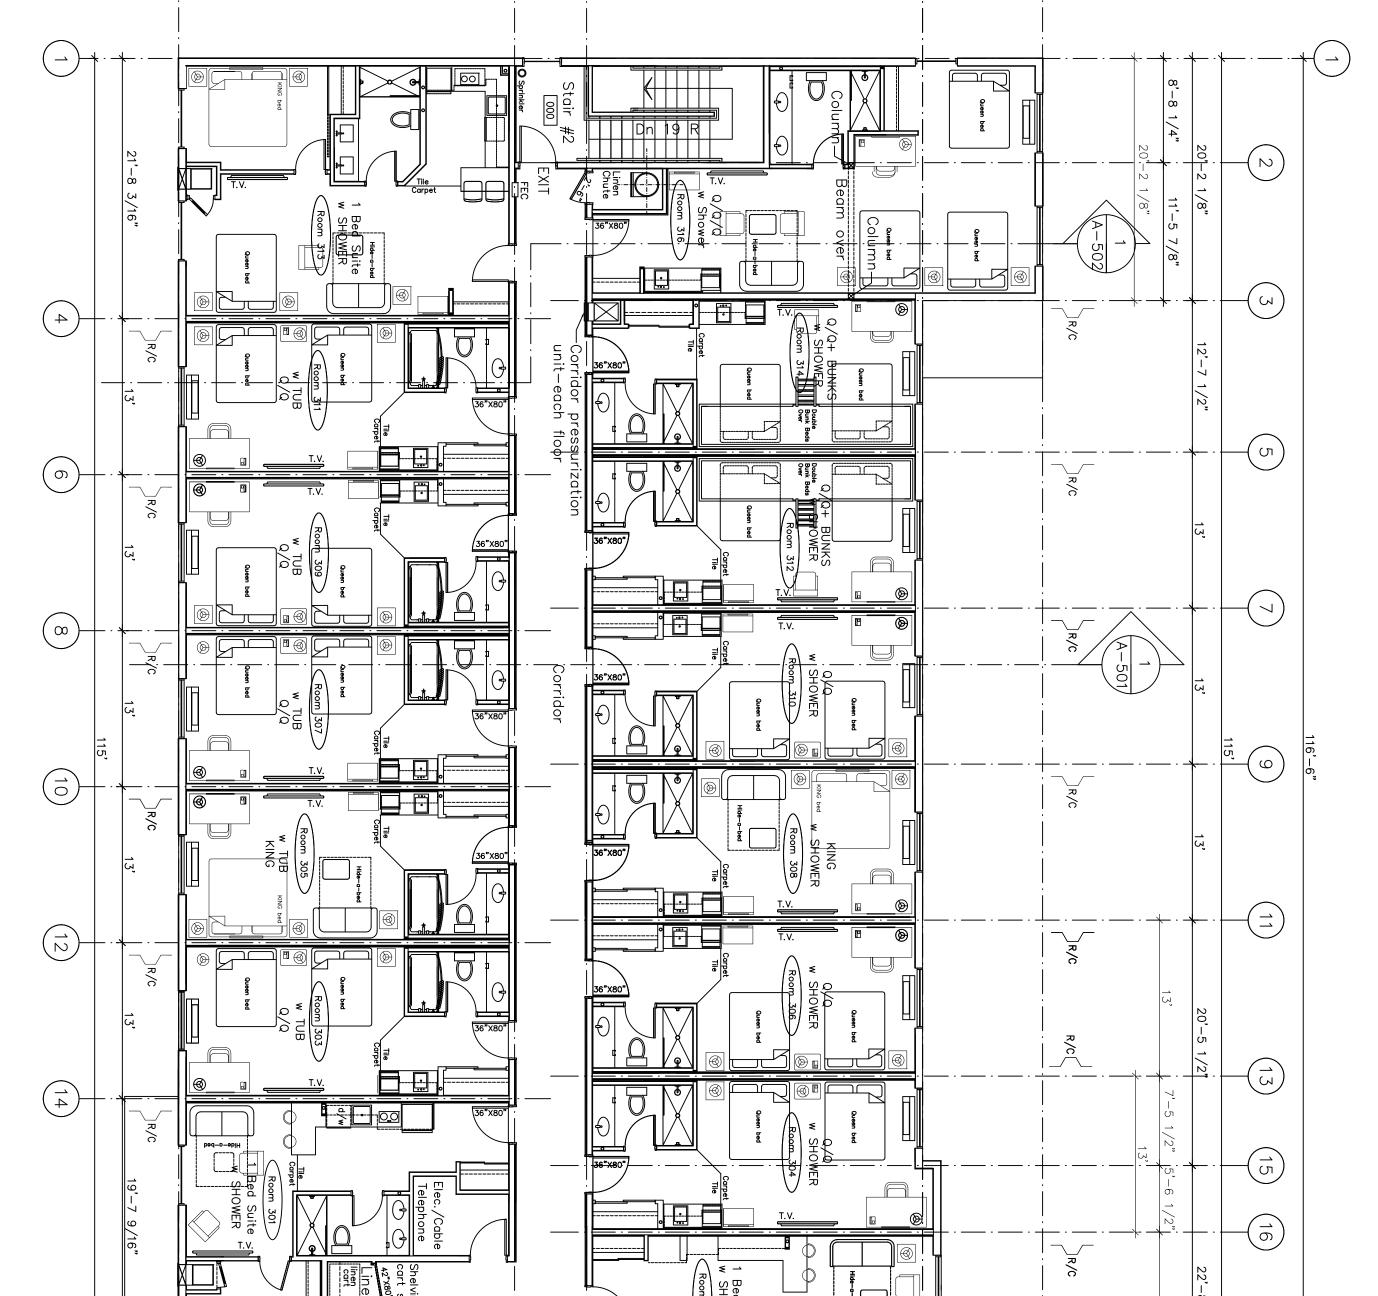

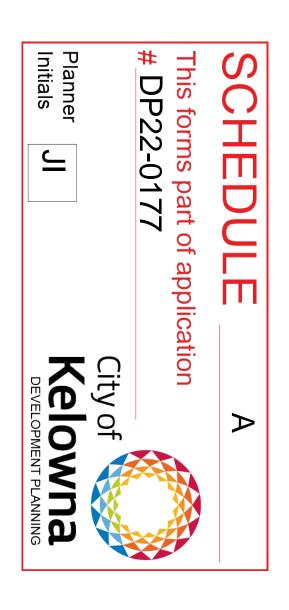

MCDOUGALL ARCHITECT 3UITE 904, 330 - 26 TH AVENUE S.W. CALGARY, ALBERTA T2S 2T3 PHONE: (250) 860-5061 (403) 265-3300

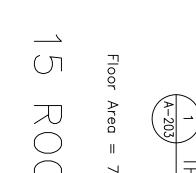



SCALE 1/8"=1'-0"	THIRD Floor Plan	
DATE DEC 07 2022		
A-203	SHEET:	

KELOWNA, BRITISH COLUMBIA

SUPER 8 HOTEL ADDITION

DRAWING TITLE


PROJECT ADDRESS

PROJECT NAME


# OMS THIRD FLOOR

,463 Square Feet (693 m2)


HRD Floor Plan 1/8" =1'-0' CHANNEL SIDE OF WALL

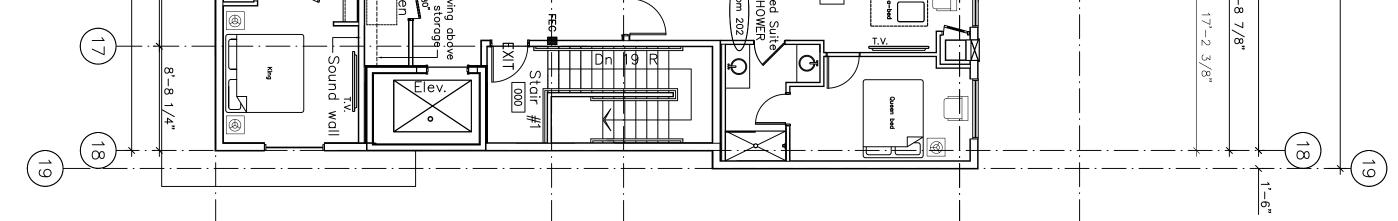



SOUTH WEST NORTH

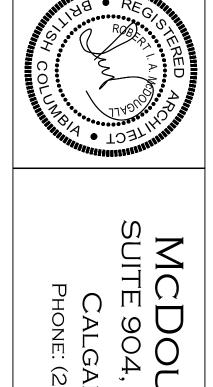


R. W. SCHEIDT DESIGN 1683 BLONDEAUX CR. Kelowna, B.C. V1Y 4J8 Phone: (250) 860-5061 Email: RSCHEIDTDESIGN@GMAIL.COM

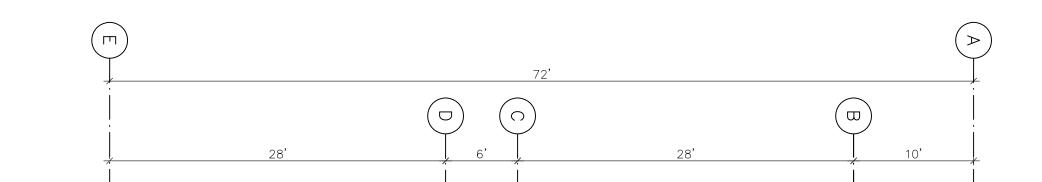

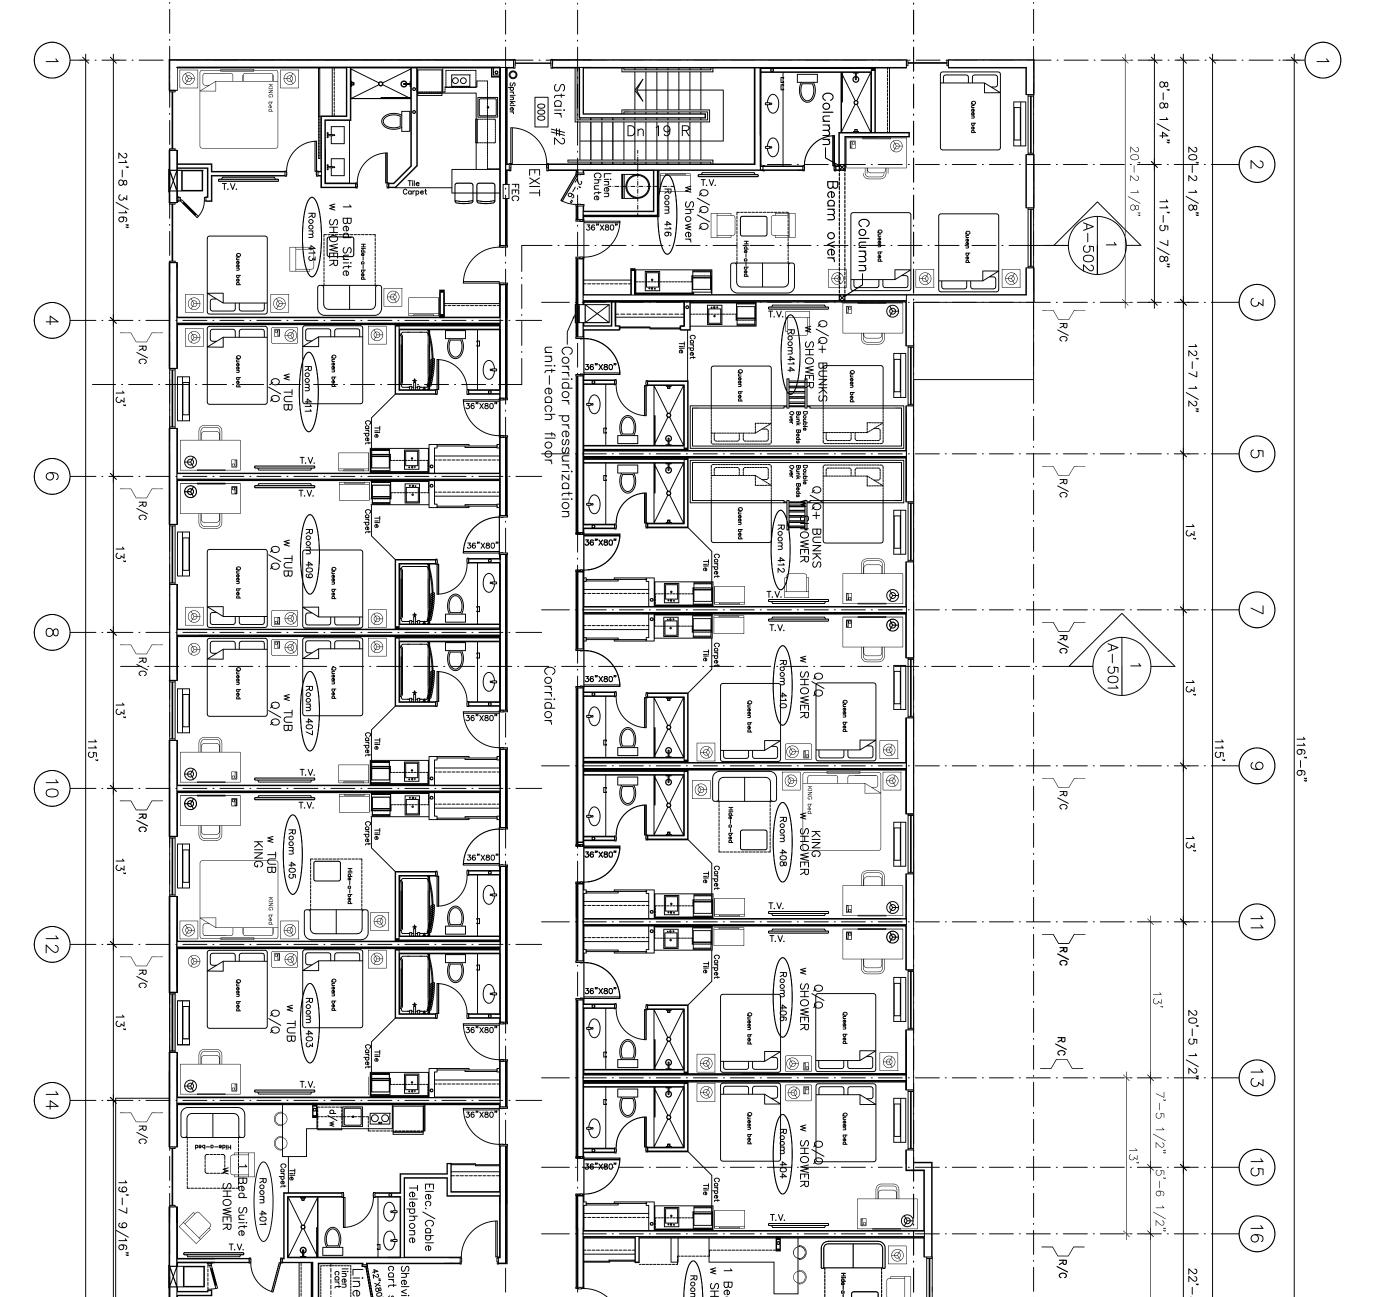

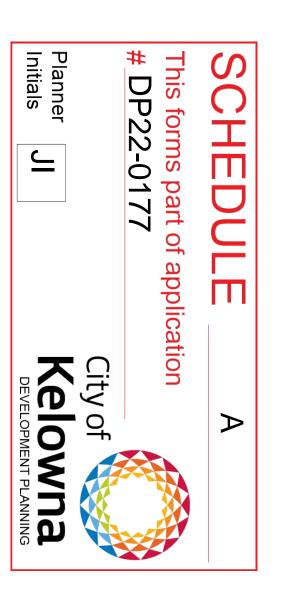

MCDOUGALL ARCHITECT 3UITE 904, 330 - 26 TH AVENUE S.W. CALGARY, ALBERTA T2S 2T3 PHONE: (250) 860-5061 (403) 265-3300

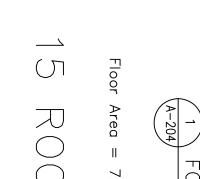

R/C RESILIENT

SCALE $1/8" = 1' - 0"$	FOURTH Floor Plan	
DEC 07 2022		
A-204	SHEET:	

KELOWNA, BRITISH COLUMBIA

SUPER 8 HOTEL ADDITION

DRAWING TITLE

PROJECT ADDRESS


PROJECT NAME

# OMS FOURTH FLOOR


,463 Square Feet (693 m2)

OURTH Floor Plan 1/8" =1'-0'

CHANNEL SIDE OF WALL

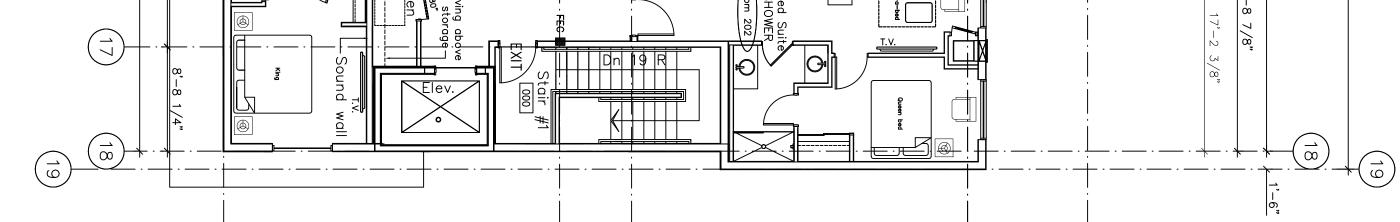



SOUTH WEST NORTH

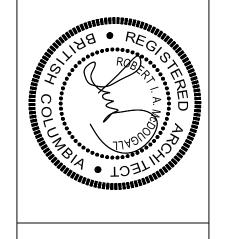

SUITE 904,

R. W. SCHEIDT DESIGN 1683 BLONDEAUX CR. Kelowna, B.C. V1Y 4J8 Phone: (250) 860-5061 EMAIL: RSCHEIDTDESIGN@GMAIL.COM

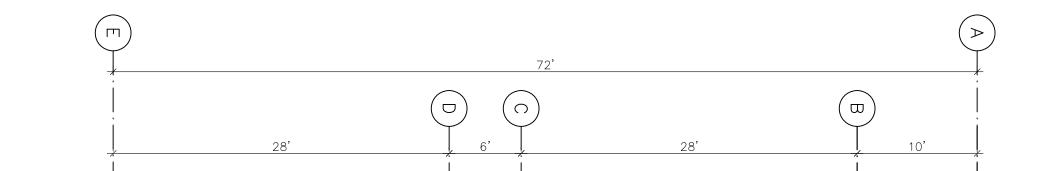

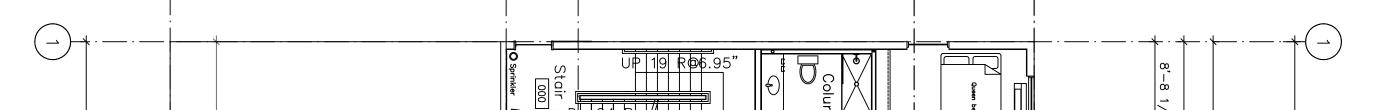

Planner Initials


City of Kelowna

This forms part of application # DP22-0177


SCHEDULE

 $\triangleright$ 

MCDOUGALL ARCHITECT SUITE 904, 330 - 26 TH AVENUE S.W. CALGARY, ALBERTA T2S 2T3 PHONE: (250) 860-5061 (403) 265-3300

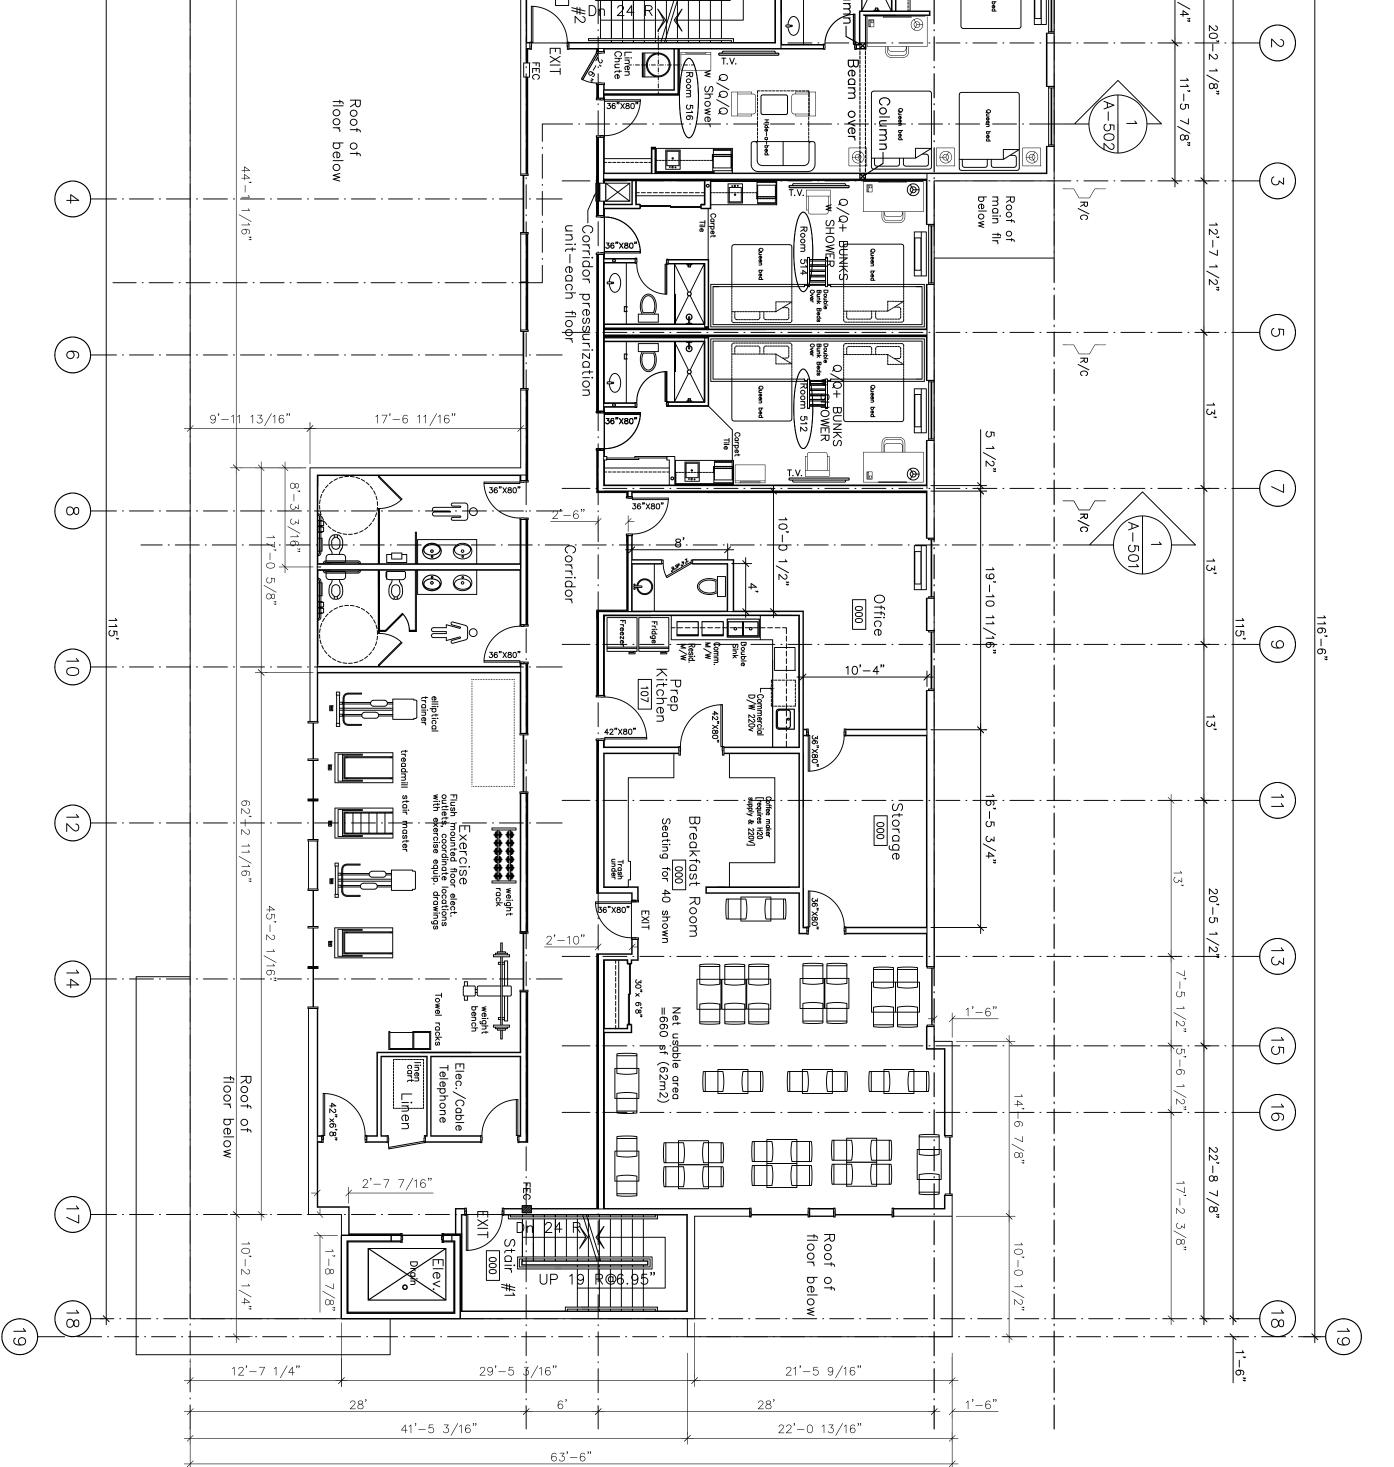

					·
			12'-7 1/4"	29'-5 J/16"	21'-
		7	28'		28'
		7	4	·-5 3/16"	22'-0
		7	1	63'-6"	
PROJECT NAME PROJECT ADDRESS KELOWNA, BRITISH COLUMBIA DRAWING TITLE FIFTH Floor Plan	$\int \frac{1}{A-205} RESILIENT CHANNEL SIDE OF$ $\int \frac{1}{A-205} FIFTH Floor Plan$ $\int \frac{1}{B''} = 1'-0'$ $\int FIFTH Floor Area = 5,255 Square Feet (48)$ $\int ROMS FIFTH F$				
ADDITION UMBIA NOV 28 2022 A-205	OF WALL (488 m2) FLOOR				

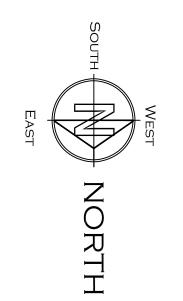













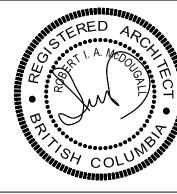



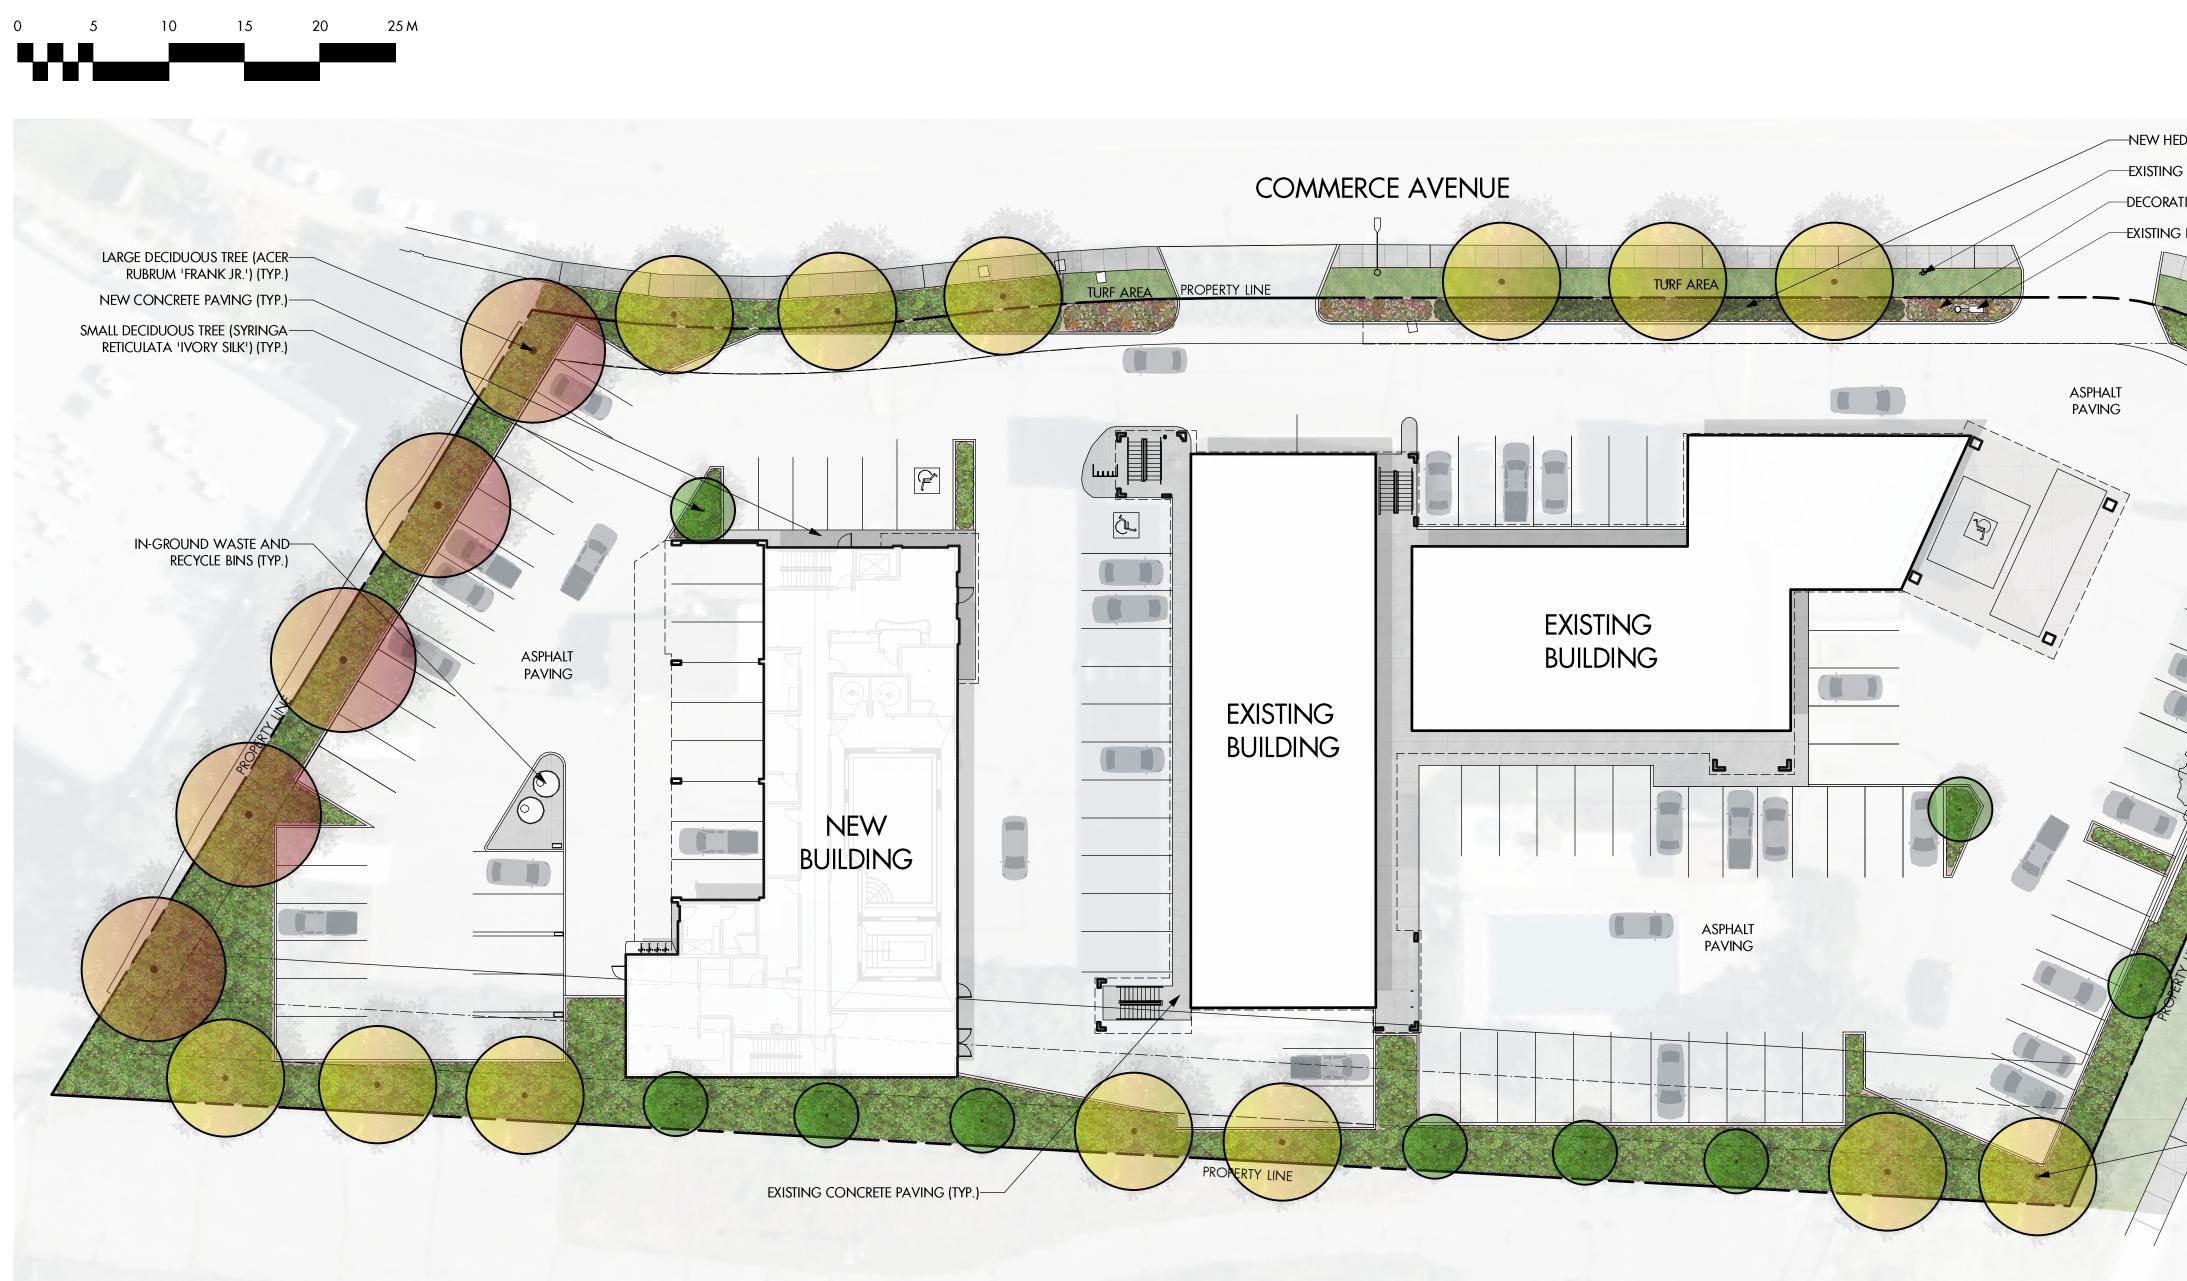

BOTANICAL NAME	COMMON NAME	QTY	SIZE/SPACING & REMARKS
TREES			
acer rubrum 'frank jr.'	REDPOINTE MAPLE	5	6cm CAL
CARPINUS BETULUS 'FASTIGIATA'	PYRAMIDAL EUROPEAN HORNBEAM	13	6cm CAL
SYRINGA RETICULATA 'IVORY SILK'	IVORY SILK TREE LILAC	11	6cm CAL
SHRUBS			
BERBERIS THUNBERGII 'MONOMB'	CHERRY BOMB BARBERRY	49	#02 CONT. /1.2M O.C. SPACING
Cornus Sanguinea 'midwinter fire'	MIDWINTER FIRE DOGWOOD	31	#02 CONT. /1.5M O.C. SPACING
EUONYMUS ALATUS 'SELECT'	FIRE BALL BURNING BUSH	49	#02 CONT. /1.2M O.C. SPACING
JUNIPERUS 'IDYLLWILD'	Idyllwild Juniper	18	#02 CONT. /2.0M O.C. SPACING
MAHONIA AQUIFOLIUM	OREGON GRAPE HOLLY	49	#02 CONT. /1.25M O.C. SPACING
PHILADELPHUS LEWISII 'BLIZZARD'	BLIZZARD MOCKORANGE	31	#02 CONT. /1.5M O.C. SPACING
PINUS MUGO 'SLOWMOUND'	SLOWMOUND MUGO PINE	71	#02 CONT. /1.0M O.C. SPACING
PINUS SYLVESTRIS 'GLAUCA NANA'	DWARF BLUE SCOTCH PINE	22	#02 CONT. /1.8M O.C. SPACING
SPIRAEA BUMALDA 'ANTHONY WATERER'	ANTHONY WATERER SPIREA	71	#02 CONT. /1.0M O.C. SPACING
PERENNIALS, GRASSES & VINES			
CALAMAGROSTIS ACUTIFLORA 'KARL FOERSTER'	Karl Foerster Feather Reed Grass	85	#01 CONT. /1.0M O.C. SPACING
Eupatorium dubium 'little joe'	LITTLE JOE DWARF JOE PYE	38	#01 CONT. /1.5M O.C. SPACING
HEMEROCALLIS 'STELLA D'ORO'	Stella d'oro dayuly	105	#01 CONT. /0.9M O.C. SPACING
NEPETA X FAASSENII 'WALKER'S LOW'	WALKER'S LOW CATMINT	59	#01 CONT. /1.2M O.C. SPACING
Perovskia atriplicifolia	RUSSIAN SAGE	85	#01 CONT. /1.5M O.C. SPACING

# NOTES

1. PLANT MATERIAL AND CONSTRUCTION METHODS SHALL MEET OR EXCEED CANADIAN LANDSCAPE NURSERY STANDARD. ALL OFFSITE WORKS TO MEET THE REQUIREMENTS OF THE CITY OF KELOWNA BYLAW 7900.

2. ALL SOFT LANDSCAPE AREAS SHALL BE WATERED BY A FULLY AUTOMATIC TIMED UNDERGROUND IRRIGATION SYSTEM.

3. TREE AND SHRUB BEDS TO BE DRESSED IN A MINIMUM 75mm WOOD MULCH OR ROCK.

4. TREE AND SHRUB BEDS TO RECEIVE A MINIMUM 300mm DEPTH TOPSOIL PLACEMEXNT.

5. TURF AREA FROM SOD SHALL BE NO.1 GRADE GROWN FROM CERTIFIED SEED OF IMPROVED CULTIVARS REGISTERED FOR SALE IN B.C. AND SHALL BE TOLERANT OF DROUGHT CONDITIONS. A MINIMUM OF 150 DEPTH PF GROWING MEDIUM IS REQUIRED BENEATH TURF AREAS. TURD AREAS SHALL MEET EXISTING GRADES AND HARD SURFACES FLUSH.

6. SITE GRADING AND DRAINAGE WILL ENSURE THAT ALL STRUCTURES HAVE POSITIVE DRAINAGE AND THAT NO WATER OR LOOSE IMPEDIMENTS WILL BE DISCHARGED FROM THE LOT ONTO ADJACENT PUBLIC, COMMON, OR PRIVATE PROPERTIES.

# DP22-0177

Planner Initials

-NEW HEDGE PLANTING (JUNIPERUS 'IDYLLWILD') (TYP.) -EXISTING FIRE HYDRANT

-DECORATIVE ENTRY PLANTING (TYP.) -EXISTING LIGHT STANDARD

> -NEW TURF BOULEVARD -EXISTING TURF BOULEVARD -SHORT TERM BIKE PARKING (TYP.) -EXISTING DEVELOPMENT SIGNAGE -EXISTING UTILITY VAULTS (REFER CIVIL DWGS) (TYP.)

DECORATIVE SHRUB, PERENNIAL, AND ORNAMENTAL GRASS PLANTINGS (TYP.) -MEDIUM DECIDUOUS TREE (CARPINUS BETULUS 'FASTIGIATA') (TYP.)

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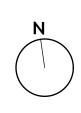
\$

HIGHWAY

AREA



# **60019** 200-2045 Enterprise Way Kelowna, BC V1Y 9T5 T (250) 469-9757 www.ecora.ca



PROJECT TITLE

# **SUPER 8 HOTEL ADDITION** 2592 - Highway 97 N

Kelowna, BC

DRAWING TITLE

# CONCEPTUAL LANDSCAPE PLAN

# ISSUED FOR / REVISION

	1	
1	22.06.10	Review
2	23.01.18	Review
3		
4		
5		

PROJECT NO	21-119
design by	KM/PH
dravvn by	MC
CHECKED BY	FB
DATE	JAN. 18, 2023
SCALE	1:250
PAGE SIZE	24"×36"

SEAL




DRAWING NUMBER



**ISSUED FOR REVIEW ONLY** 

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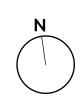


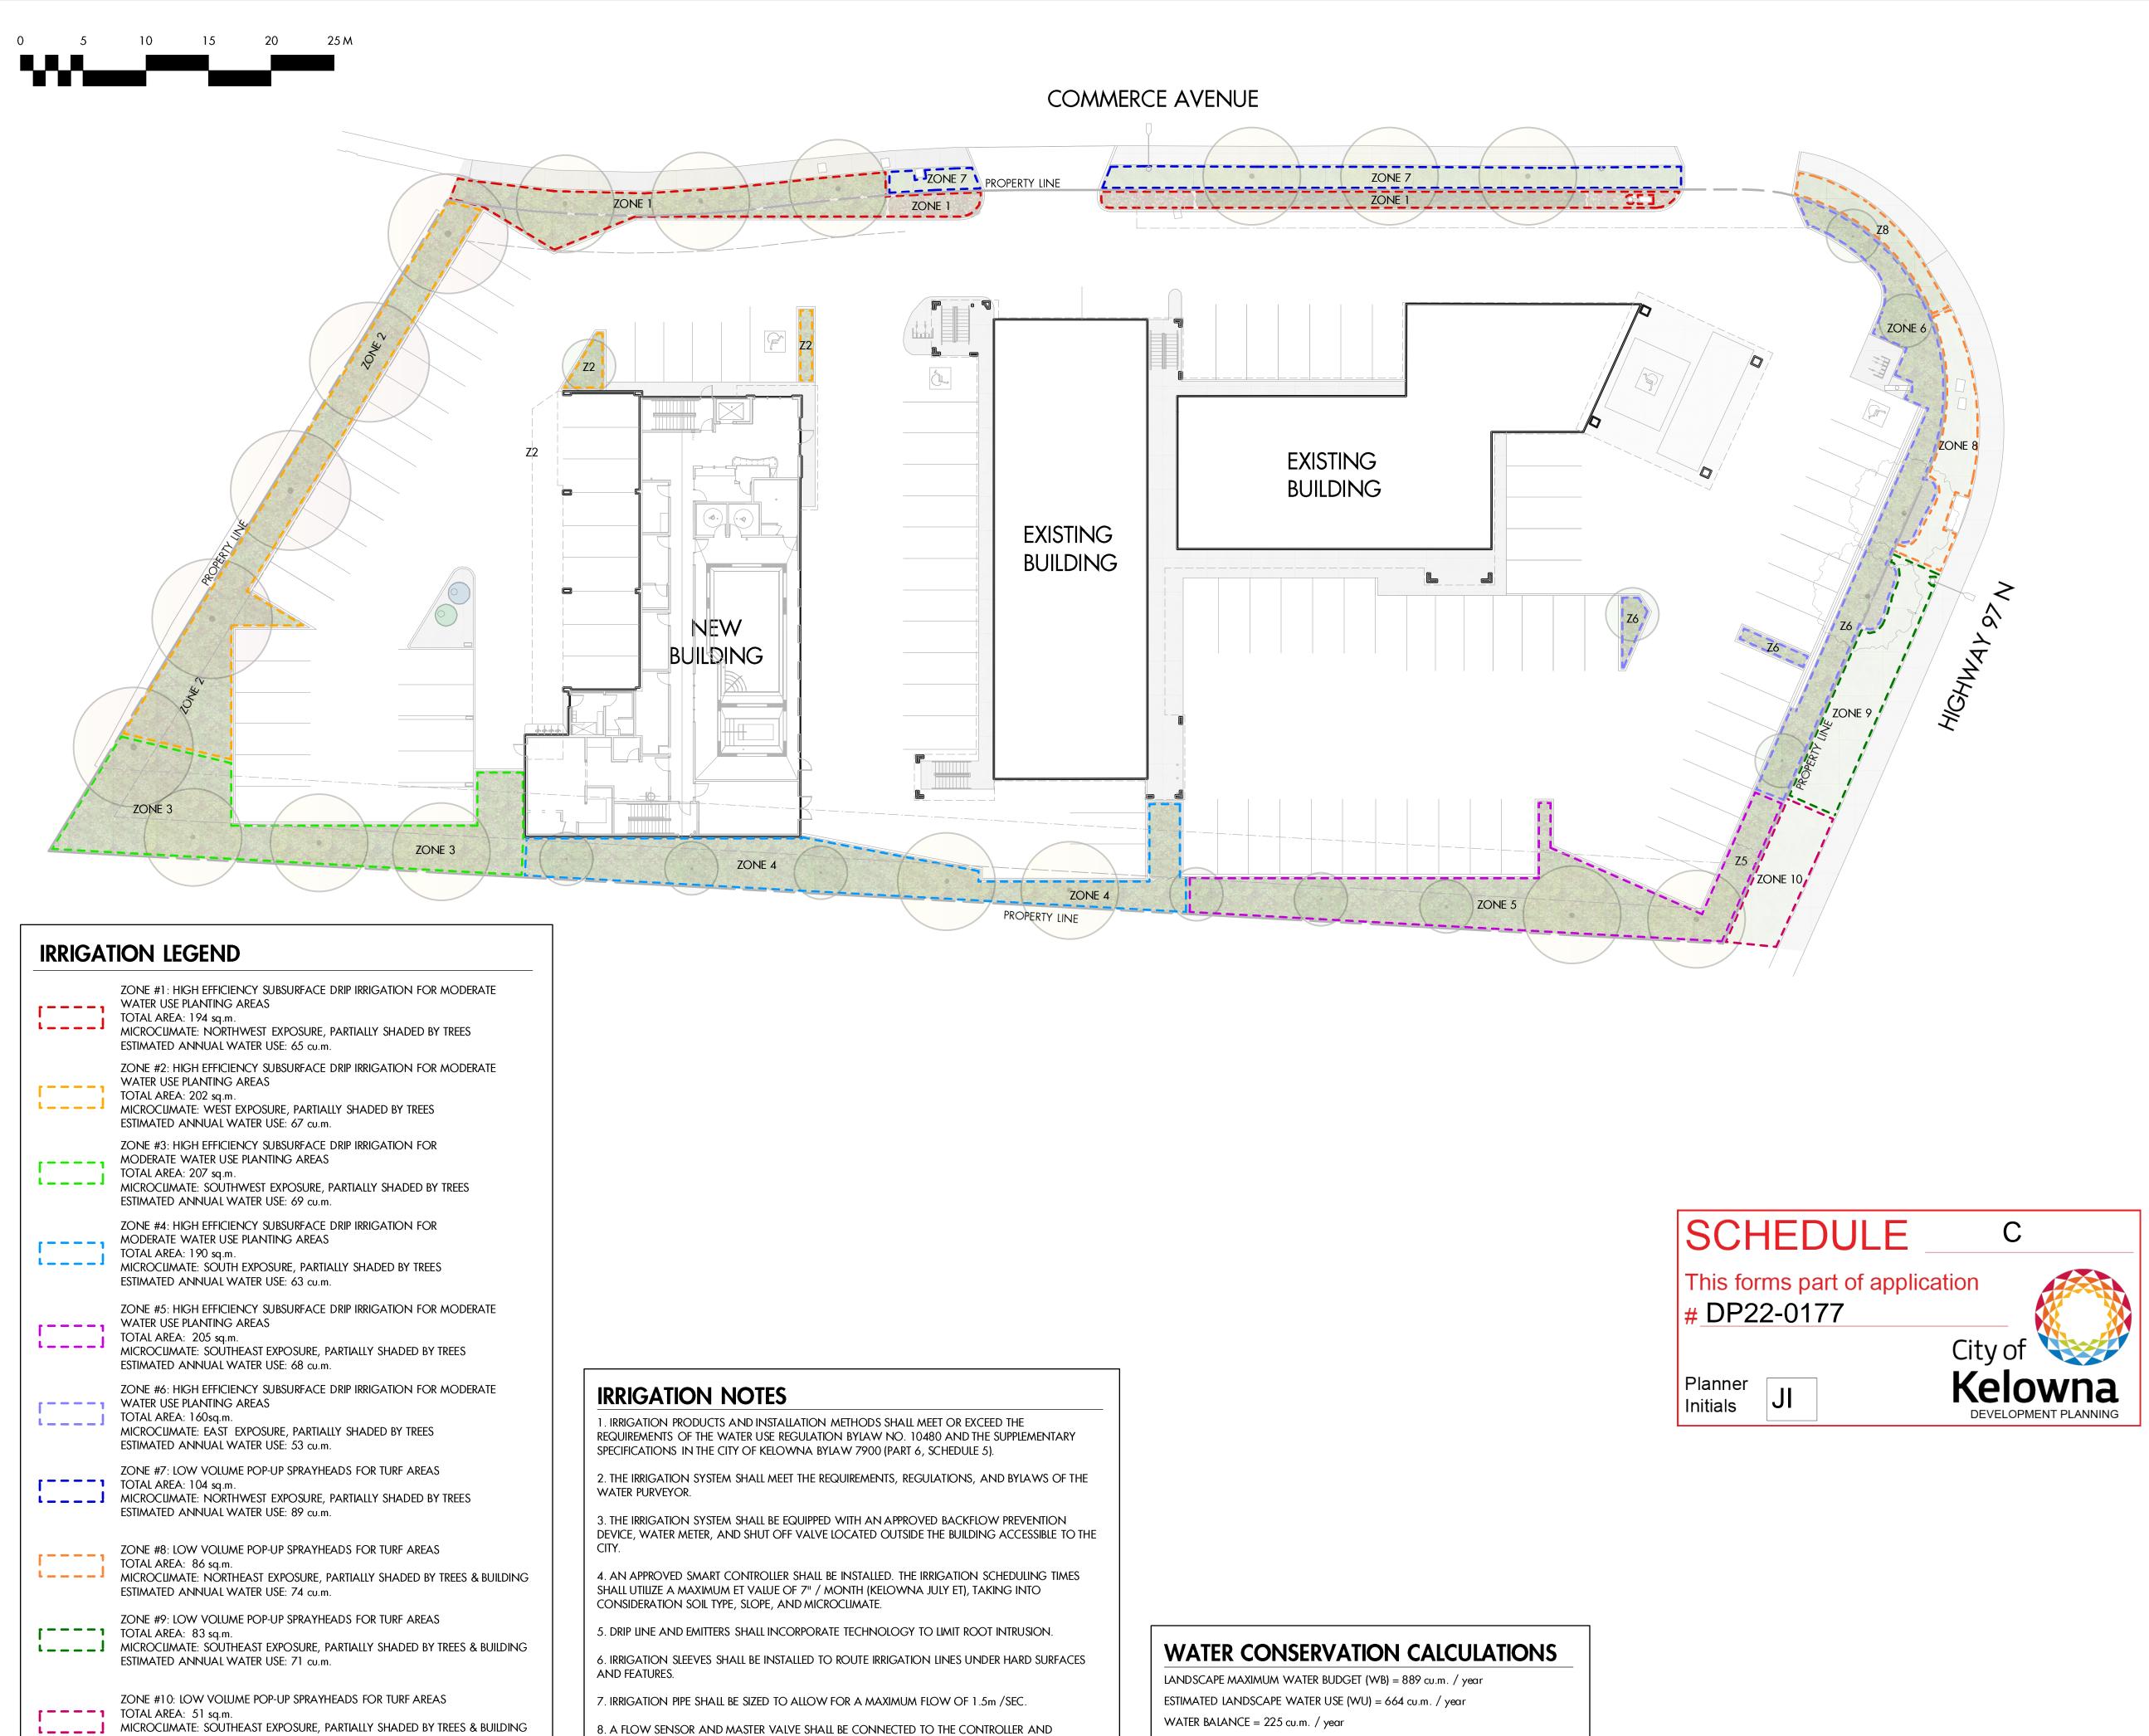ESTIMATED ANNUAL WATER USE: 44 cu.m.

8. A FLOW SENSOR AND MASTER VALVE SHALL BE CONNECTED TO THE CONTROLLER AND PROGRAMMED TO STOP FLOW TO THE SYSTEM IN CASE OF AN IRRIGATION WATER LEAK.

WATER BALANCE = 225 cu.m. / year \*REFER ATTACHED IRRIGATION APPLICATION FOR DETAILED CALCULATIONS





PROJECT TITLE

# **SUPER 8 HOTEL ADDITION** 2592 - Highway 97 N

Kelowna, BC

DRAWING TITLE

# WATER CONSERVATION/ **IRRIGATION PLAN**

# ISSUED FOR / REVISION

1	22.06.10	Review
2	23.01.18	Review
3		
4		
5		

PROJECT NO	21-119
design by	KM/PH
DRAVVN BY	MC
CHECKED BY	FB
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SEAL



DRAWING NUMBER

**ISSUED FOR REVIEW ONLY** 

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# FORM & CHARACTER – DEVELOPMENT PERMIT GUIDELINES

Consideration has been given to the following guidelines as identified in Chapter 18 of the City of Kelowna 2040 Official Community Plan:

ATE PROPOSALS COMPLIANCE TO PERTINENT GUIDELINE	N/A	1	2	3	4	5
1 is least complying & 5 is highly complying)						
.1 General Guidelines						
.1.1 Relationship to the Street	N/A	1	2	3	4	5
. Orient the long side of each building to be parallel to the public street.			x			
<ul> <li>Locate entries to be visible and directly accessible from the public street.</li> </ul>				x		
<ul> <li>For buildings fronting highways, entries can be located away from the street, as long as there is a direct pedestrian connection to the site.</li> </ul>					×	
<ul> <li>Avoid blank walls adjacent to the highway, streets, walkways, parks, or other amenity spaces.</li> </ul>				x		
.1.2 Site Planning and Landscaping	N/A	1	2	3	4	5
<ul> <li>Locate buildings to ensure good sight lines for vehicular and pedestrian traffic.</li> </ul>						x
<ul> <li>Provide direct, safe, continuous, and clearly defined pedestrian access from public sidewalks, parking areas, and transit stops to building entrances.</li> </ul>						x
. Use large canopy trees to define the public realm (e.g. at the sidewalk and property edge facing the street)						x
<ul> <li>Distribute trees and landscaping throughout the site in order to: Soften property edges facing the street; Define internal roads, pedestrian routes, and open spaces; Create pleasant pedestrian conditions; Screen parking, loading, service, and utility areas; Manage stormwater on-site; and Break up large rows of parking by substituting a parking stall with a canopy tree in planter every 8-10 parking stalls;</li> </ul>					x	
. Provide on-site bio-retention facilities (e.g. bioswales, rain gardens) to collect, store and filter stormwater from parking areas.	x					
<ul> <li>Use permeable materials such as paving blocks or permeable concrete in parking areas to maximize rainwater infiltration.</li> </ul>		×				
<ul> <li>Pedestrian pathways should provide clear sight lines and connect the following: Parking areas to building entrances;</li> </ul>					x	
Main building entrances to public sidewalks (where applicable); Main building entrances to transit stopes (where applicable);	AT	TA	СН	ME	NT	
Between buildings on adjacent lots.	# DF		olpart 0177	of app	_	Lity

	Provide separation between vehicular routes (especially truck				x		
	access/loading) and pedestrian routes on-site to avoid conflict and						
	distinguish pedestrian routes from driving surfaces by using varied						
	paving treatments and/or raising walkways to curb level.						
i.	Base new development on an internal circulation pattern that						x
	allows logical movement throughout the site and that will						
	accommodate, and not preclude, intensification over time.						
6.1		N/A	1	2	3	4	5
a.	Design site accesses to provide the potential for future shared	x				<u> </u>	
	access with neighbours and to minimize curb cuts.						
b.	Where practical, link access drives and parking lots of adjacent	x					
	properties in order to allow for circulation of vehicles between						
	sites.						
c.	The preferred location for main parking areas is at the rear and/or					x	
	side of the building. Avoid locating large parking areas between						
	the building and the street.						
d.	Where parking areas are visible from the street, screen them using						x
	strategies such as tree planting, berming, low walls, decorative						
	fencing and/or hedging.						
e.	Break parking areas into smaller blocks defined by landscaping in					x	
	order to minimize the amount of paved areas.						
f.	Locate loading, utilities, mechanical equipment and garbage						x
	collection areas away from public view by:						
•	Integrating these facilities into the footprint of the building; or						
•	Screening using fencing, walls, and/or landscaping						
g.	Provide areas for temporary snow storage that do not conflict						x
5	with site circulation, landscaping, and access to utility boxes. For						
	example, by providing access via a lane away from public view.						
6.1	4 Building Articulation, Features, and Materials	N/A	1	2	3	4	5
a.	Avoid facing unarticulated facades to the street and use					x	
	projections, recesses, arcades, awnings, color, and texture to						
	improve the pedestrian experience						
b.	Design primary entrances to face the street, exhibit design					x	
	emphasis, and provide weather protection by means of canopy or						
	recessed entry.						
c.	Design buildings such that their form and architectural character						x
	reflect the building's internal function and use (e.g. an industrial						
	building, a large format retail mall).						
d.	Design signage as an integral element of the building's façade and						X
	to be compatible in scale and design with the design, color and						
	material of the building.		_				1 7
e.	Allow for brand identification where there are multiple buildings						X
e.	Allow for brand identification where there are multiple buildings and uses on a site, but avoid individual corporate image, color, and						×
e.	Allow for brand identification where there are multiple buildings and uses on a site, but avoid individual corporate image, color, and signage back-lit signs from dominating the site.						×
e. f.	Allow for brand identification where there are multiple buildings and uses on a site, but avoid individual corporate image, color, and signage back-lit signs from dominating the site. Locate, size and design ground-mounted signs to be oriented to			x			X
	Allow for brand identification where there are multiple buildings and uses on a site, but avoid individual corporate image, color, and signage back-lit signs from dominating the site.			X		ТИТ	X
	Allow for brand identification where there are multiple buildings and uses on a site, but avoid individual corporate image, color, and signage back-lit signs from dominating the site. Locate, size and design ground-mounted signs to be oriented to		₩ ŢŢ,	ACI	-IME	-NT	×
	Allow for brand identification where there are multiple buildings and uses on a site, but avoid individual corporate image, color, and signage back-lit signs from dominating the site. Locate, size and design ground-mounted signs to be oriented to		his for	ACI ms pa	-IME rt of ap	-NT pplicati	

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g.	Provide shielded, down lighting to provide security and ambient lighting while minimizing light pollution and spill over lighting into adjacent properties.			x
h.	Provide weather protection at building entrances close to transit			x
	stops, and in areas with pedestrian amenities.			
i.	Incorporate substantial, natural building materials such as		x	
	masonry, stone, and wood into building facades.			
j.	Use an integrated, consistent range of materials and colors and			x
	provide variety by, for example, using accent colors.			

