

City of
Kelowna

Development Permit & Development Variance Permit DP21-0231 DVP21-0232

This permit relates to land in the City of Kelowna municipally known as

2241 Springfield Rd

and legally known as

LOT B DISTRICT LOTS 128 AND 142 OSOYOOS DIVISION YALE DISTRICT PLAN KAP85660

and permits the land to be used for the following development:

Mixed-Use: Multiple Dwelling Housing and Commercial Uses

The present owner and any subsequent owner of the above described land must comply with any attached terms and conditions.

Date of Council Decision August 23, 2022
Decision By: COUNCIL
Development Permit Area: Form and Character Development Permit Area
Existing Zone: C4r - Urban Centre Commercial (Residential Rental Tenure Only)
Future Land Use Designation: UC – Urban Centre

This is NOT a Building Permit.

In addition to your Development Permit, a Building Permit may be required prior to any work commencing. For further information, contact the City of Kelowna, Development Services Branch.

NOTICE

This permit does not relieve the owner or the owner's authorized agent from full compliance with the requirements of any federal, provincial or other municipal legislation, or the terms and conditions of any easement, covenant, building scheme or agreement affecting the building or land.

Owner: Ironclad Developments Mission Heights Holdings Inc., Inc.No. A0119488
Applicant: Ironclad Developments Inc.
Planner: K. Brunet

Terry Barton
Community Planning Department Manager
Planning & Development Services

Date

1. SCOPE OF APPROVAL

This Development Permit applies to and only to those lands within the Municipality as described above, and any and all buildings, structures and other development thereon.

This Development Permit is issued subject to compliance with all of the Bylaws of the Municipality applicable thereto, except as specifically varied or supplemented by this permit, noted in the Terms and Conditions below.

The issuance of a permit limits the permit holder to be in strict compliance with regulations of the Zoning Bylaw and all other Bylaws unless specific variances have been authorized by the Development Permit. No implied variances from bylaw provisions shall be granted by virtue of drawing notations that are inconsistent with bylaw provisions and that may not have been identified as required Variances by the applicant or Municipal staff.

2. CONDITIONS OF APPROVAL

- a) The dimensions and siting of the building to be constructed on the land be in accordance with Schedule "A";
- b) The exterior design and finish of the building to be constructed on the land be in accordance with Schedule "B";
- c) Landscaping to be provided on the land be in accordance with Schedule "C"; and
- d) The applicant be required to post with the City a Landscape Performance Security deposit in the form of a "Letter of Credit" in the amount of 125% of the estimated value of the landscaping, as determined by a Registered Landscape Architect.

AND THAT variances to the following section of Zoning Bylaw No. 8000 be granted:

Section 14.4.6(e): C4 – Urban Centre Commercial Other Regulations

To vary the required minimum amount of functional commercial space for the Springfield Rd frontage from 90 % required to 19.12 % proposed.

This Development Permit is valid for two (2) years from the date of approval, with no opportunity to extend.

3. PERFORMANCE SECURITY

As a condition of the issuance of this Permit, Council is holding the security set out below to ensure that development is carried out in accordance with the terms and conditions of this Permit. Should any interest be earned upon the security, it shall accrue to the Developer and be paid to the Developer or his or her designate if the security is returned. The condition of the posting of the security is that should the Developer fail to carry out the development hereby authorized, according to the terms and conditions of this Permit within the time provided, the Municipality may enter into an agreement with the property owner of the day to have the work carried out, and any surplus shall be paid over to the property owner of the day. Should the Developer carry out the development permitted by this Permit within the time set out above, the security shall be returned to the Developer or his or her designate. There is filed accordingly:

- a) An Irrevocable Letter of Credit **OR** certified cheque in the amount of **\$784,187.25**

Before any bond or security required under this Permit is reduced or released, the Developer will provide the City with a statutory declaration certifying that all labour, material, workers' compensation and other taxes and costs have been paid.

5. INDEMNIFICATION

Upon commencement of the works authorized by this Permit the Developer covenants and agrees to save harmless and effectually indemnify the Municipality against:

- a) All actions and proceedings, costs, damages, expenses, claims, and demands whatsoever and by whomsoever brought, by reason of the Municipality said Permit.

All costs, expenses, claims that may be incurred by the Municipality where the construction, engineering or other types of works as called for by the Permit results in damages to any property owned in whole or in part by the Municipality or which the Municipality by duty or custom is obliged, directly or indirectly in any way or to any degree, to construct, repair, or maintain.

**The PERMIT HOLDER is the CURRENT LAND OWNER.
Security shall ONLY be returned to the signatory of the
Landscape Agreement or their designates.**

DRAFT



2241 SPRINGFIELD ROAD

KELOWNA BC

JUNE 2022

Zoning Summary

Special Planning Designation / Area Zoning Classification	Urban Core / Midtown Urban Centre		
	Existing	Proposed	
	C-4	C-4	■ ■

Lot Area Section 14.4.4	Standards	Proposed	
	Minimum	1300 m ²	
F.A.R.	1.3 to 2.35	1.67	■ ■
Site Coverage	75% Maximum	30.8%	■ ■

Dimensional Standards Section 14.4.4 + 14.4.5	Standards	Proposed	
	Building Height	12 stories / 37 m	
Setbacks: front	0 m	4.6 m	■ ■
: rear	0 m	0 m	■ ■
: flanking side	0 m	7.6 m	■ ■
: internal side	2.0 m	4.6 m	■ ■
Private Open Space [m ²]	4828	5897	■ ■

Parking	Standards	Proposed	
	Vehicle Parking: residential : commercial [in Visitor Parking]	Table 8.3.1 432 Table 8.3.2 10	
Accessible Parking Spaces	Table 8.2.19 9	9	■ ■
Visitor Parking Spaces	Table 8.3.1 56	58	■ ■
Total stalls [residential + accessible + visitor]	488	390	■ ■
Total Including 20% reduction [S.8.2.12]	8.2.12 346	390	■ ■
Small Car Stalls [resident parking stalls only]	Table 8.3.1 max 50%	0.3%	■ ■
Loading Spaces [commercial]	Table 8.4 0	0	■ ■
Bicycle Parking [short term]	Table 8.5 49	59	■ ■
Bicycle Parking [long term]	Table 8.5 312	314	■ ■

Development Summary

Commercial Areas	Building 1	Building 2	Building 3	Building 4	Building 5	TOTAL
	Qty	Qty	Qty	Qty	Qty	SM
	679	0	0	0	0	679

Amenity Area Table 5.4	Building 1	Building 2	Building 3	Building 4	Building 5	TOTAL
	SM	SM	SM	SM	SM	SM
Indoor	135	0	0	0	625	761
Landscape	242	332	557	111	311	1554
Rooftop	0	0	251	167	244	662

Residential Suites	SF	M ²	Building 1	Building 2	Building 3	Building 4	Building 5	TOTAL
			Qty	Qty	Qty	Qty	Qty	Qty
Studio : D1	422	39	27	0	0	6	10	43
One Bedroom: A1	645	60	23	42	48	47	0	160
Two Bedroom: B1	948	39	55	13	11	12	0	155
: B1.1	973	90	0	0	3	4	0	
: B1.2	966	90	10	12	12	8	0	
: B1.3	966	90	4	0	0	0	0	
: B1.4	947	85	0	0	0	0	11	
Three Bedroom: C1	1125	105	12	11	10	10	0	43
TOTAL			131	78	84	87	21	401


Residential Balconies	SF	M ²	Building 1	Building 2	Building 3	Building 4	Building 5	TOTAL
			SM	SM	SM	SM	SM	SM
Studio : D1	60	6	150.5	0.0	0.0	33.4	55.7	240
One Bedroom: A1	100	9	213.7	390.2	445.9	436.6	0.0	1486
Two Bedroom: B1	125	8	306.6	72.5	61.3	66.9	0.0	955
: B1.1	75	7	0.0	0.0	20.9	27.9	0.0	
: B1.2	60	6	55.7	66.9	66.9	44.6	0.0	
: B1.3	100	9	37.2	0.0	0.0	0.0	0.0	
: B1.4	125	12	0.0	0.0	0.0	0.0	127.7	
Three Bedroom: C1	60	6	66.9	61.3	55.7	55.7	0.0	240
TOTAL			2921					

Floor Areas: F.A.R. ELIGIBLE	Building 1	Building 2	Building 3	Building 4	Building 5	TOTAL
	SM	SM	SM	SM	SM	SM
TOTAL	1140	1212	1283	1312	537	5484

SCHEDULE A

This forms part of application
DP21-0231 DVP21-0232

Planner Initials **KB**

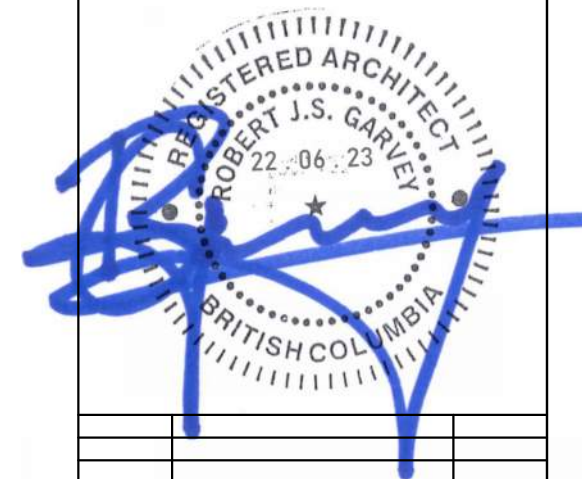

2241 SPRINGFIELD ROAD;
Kelowna BC.

COVER PAGE

Project Number: 2102

04-30-2020 | Rev Date 06-23-2022

Drawn By T.THIMM

Designed By T.THIMM

Checked By R.GARVEY

ESP-0.0

Scale


Consultant



ROB J.S. GARVEY, ARCHITECT
MAA, AIBC, LEED AP

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Ironclad Developments Inc.

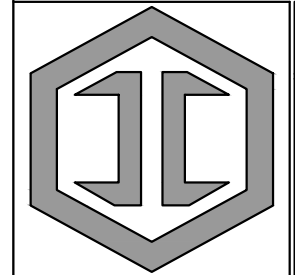


Project Management
General Contracting
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PH:
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info@icdev.ca

IRONCLAD
DEVELOPMENTS INC.



CITY OF KELOWNA

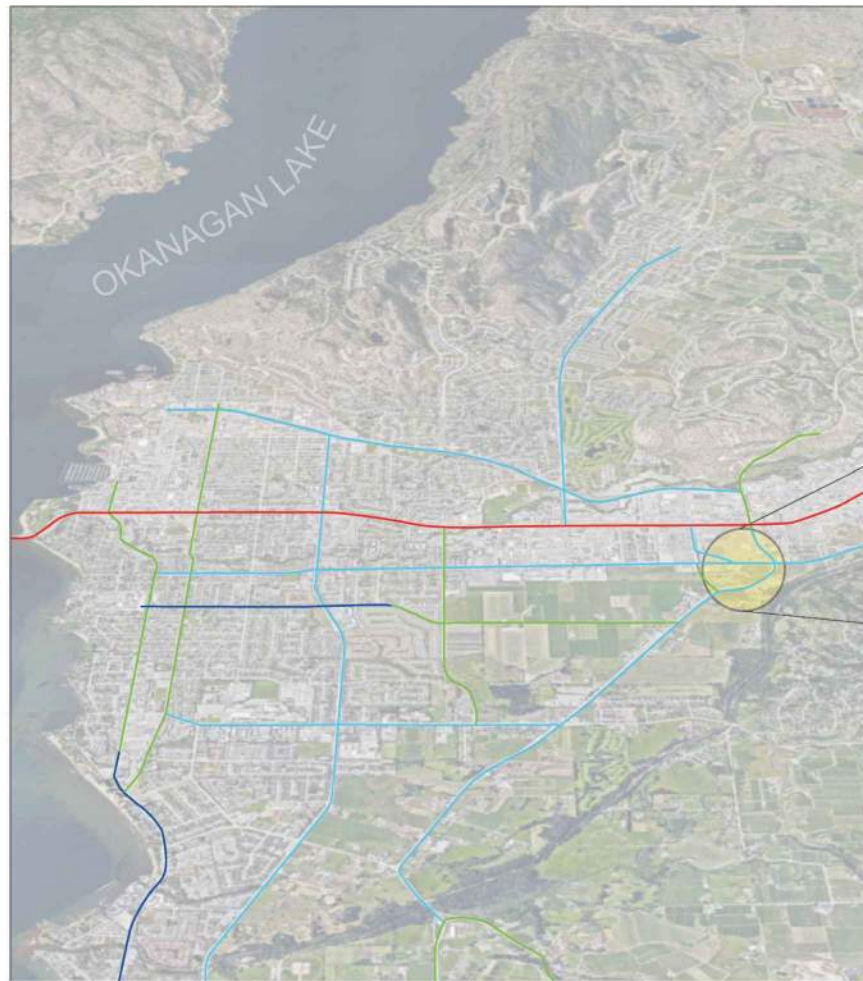

ARIAL VIEW OF EXISTING SITE & SURROUNDING CONTEXT

- MAJOR ROADWAYS
- 6 Lane Arterial (including HOV Lanes)
 - 4 Lane Arterial
 - 2 Lane Arterial
 - 2 Lane Arterial + Center Turn Lane



LEGAL SITE PLAN

SCHEDULE A

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City of **Kelowna**
DEVELOPMENT PLANNING

Ironclad Developments Inc.



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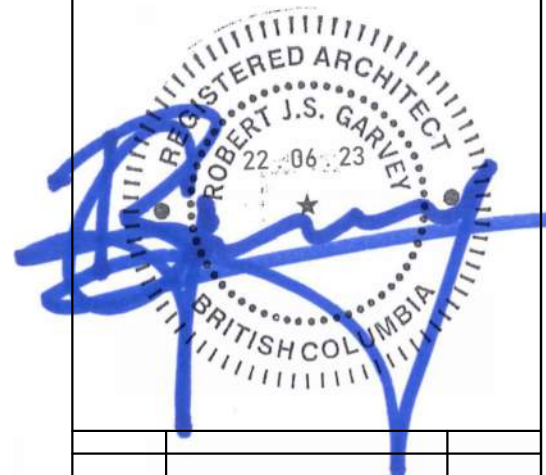
IRONCLAD DEVELOPMENTS INC.

Consultant



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REV.	DESCRIPTION OF WORK REVISED	DATE

2241 SPRINGFIELD ROAD;
Kelowna BC.


CONTEXT MAP & LEGAL
SITE PLAN

Project Number: 2102	
04-30-2020	Rev Date 06-23-2022

Drawn By	T.THIMM
Designed By	T.THIMM
Checked By	R.GARVEY

ESP-0.1

Scale

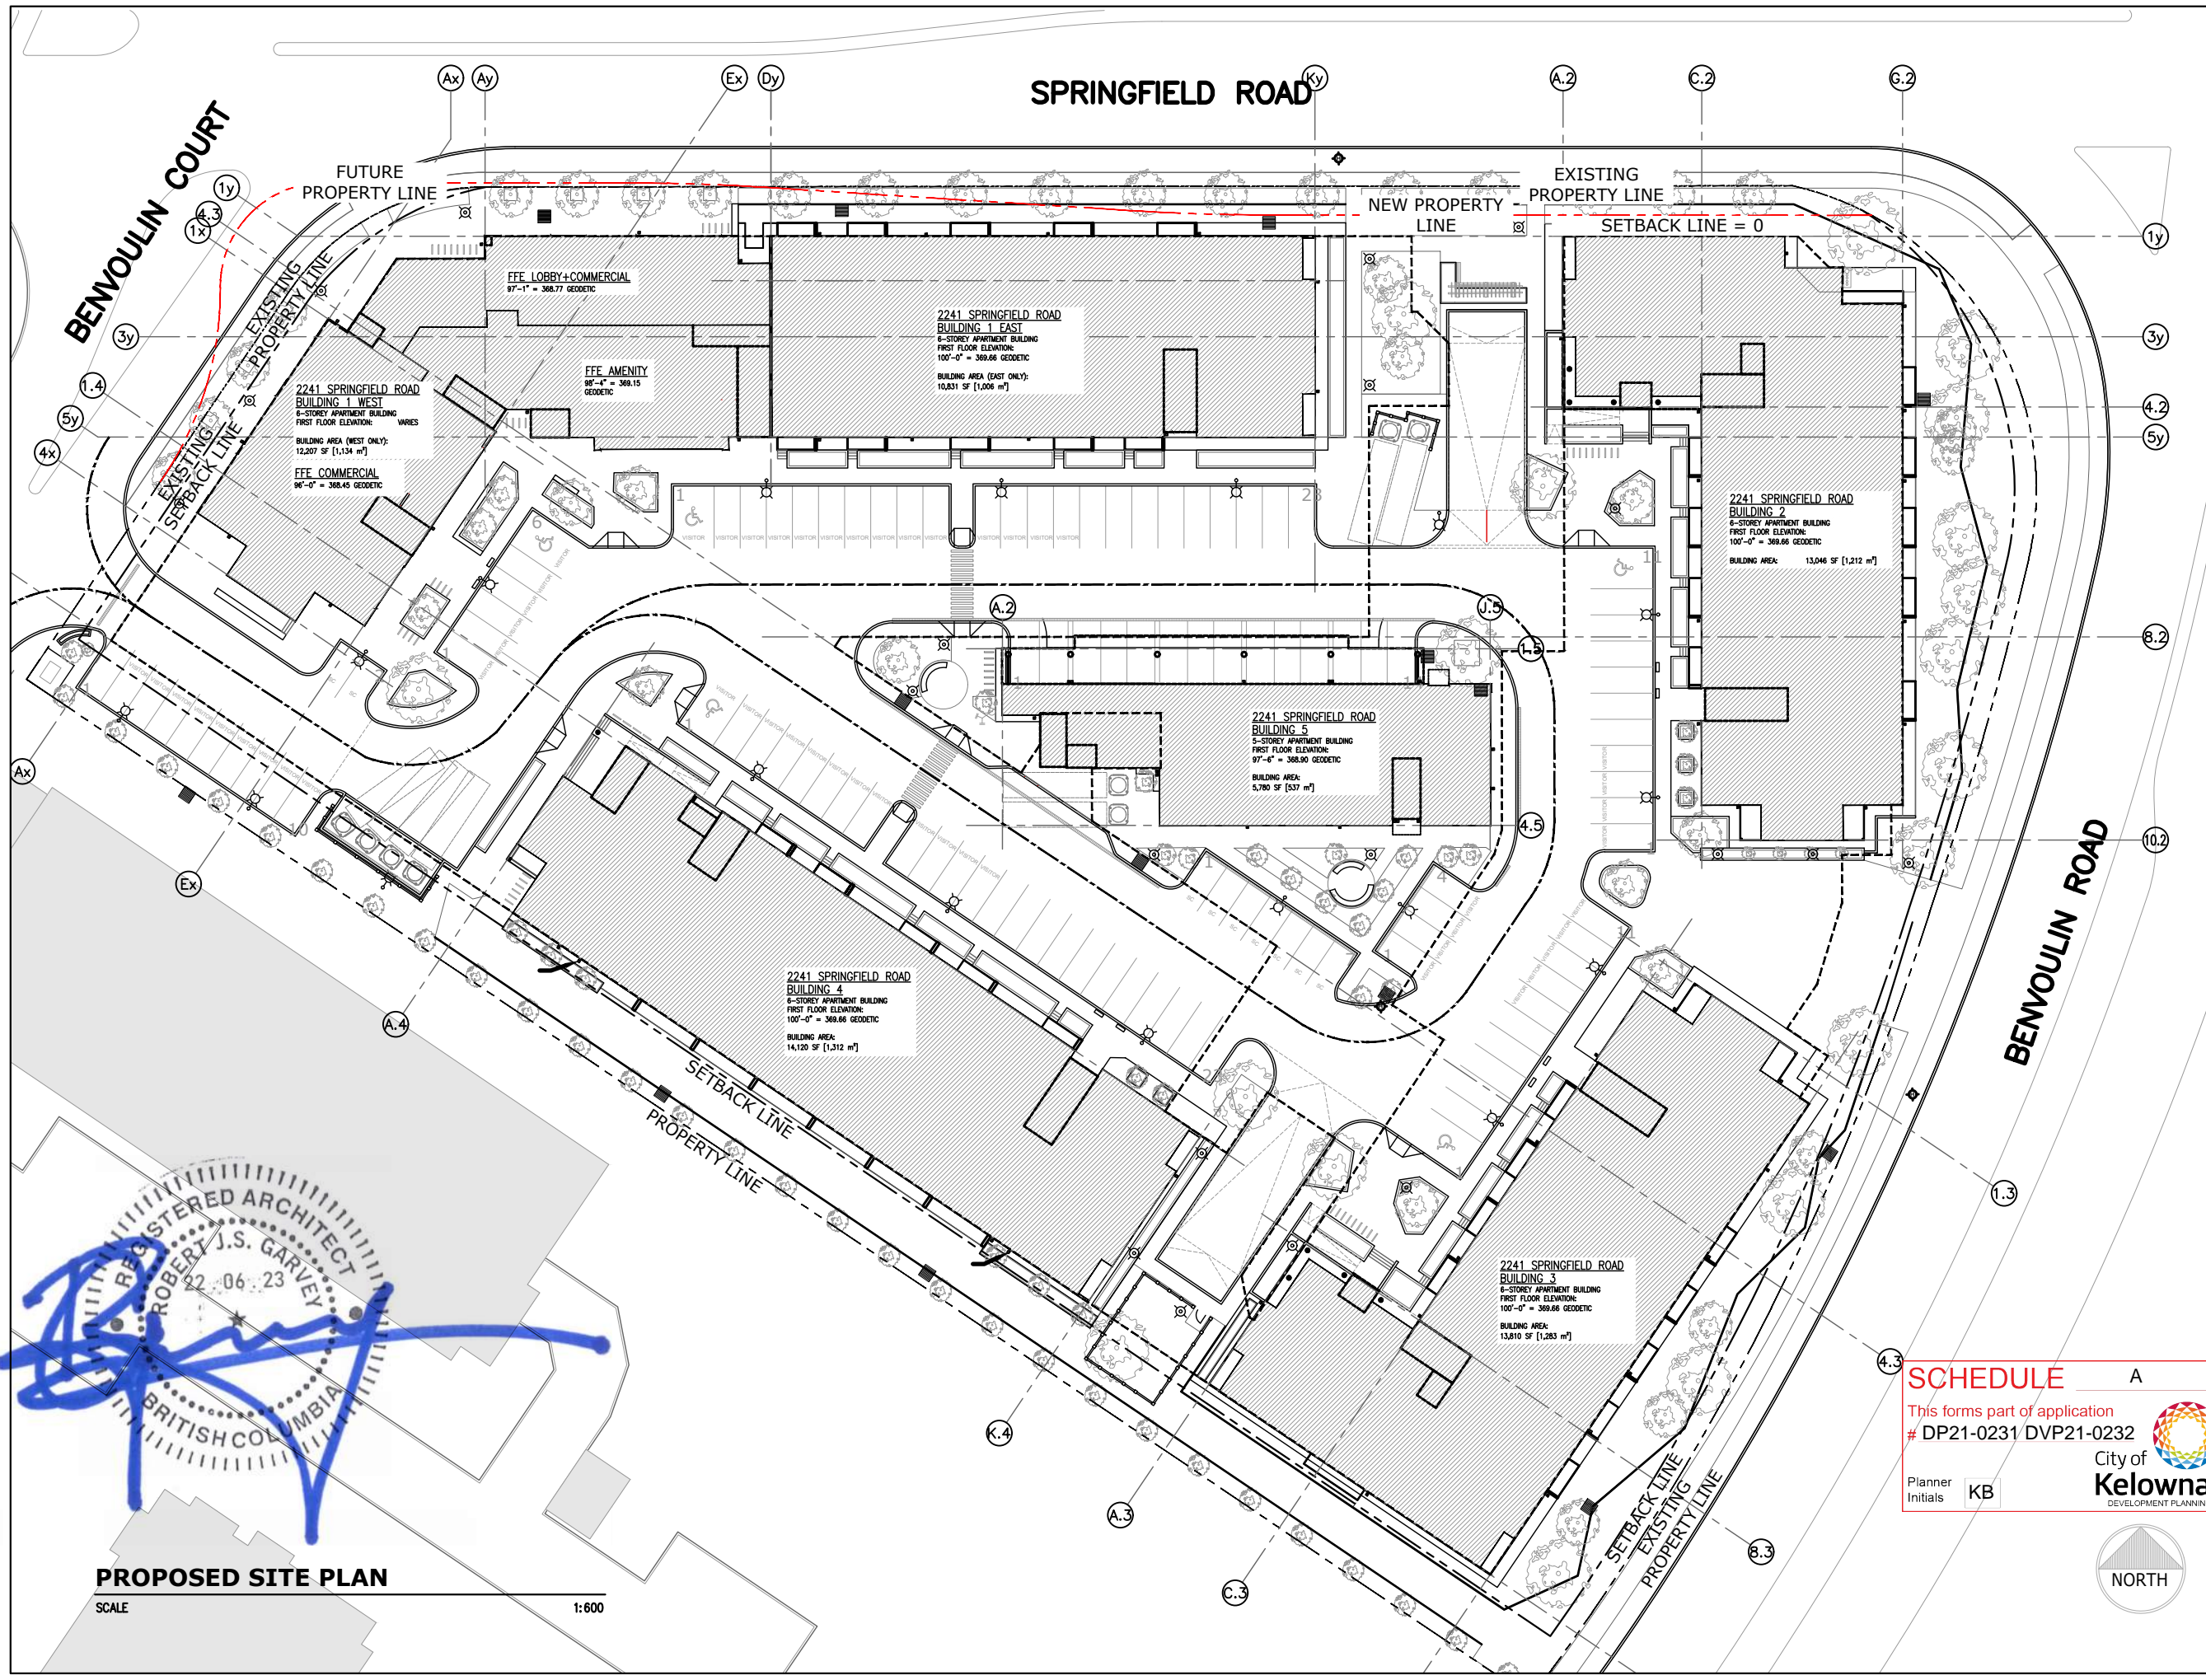

REGISTERED ARCHITECT
ROBERT J.S. GARVEY
2023.06.23
BRITISH COLUMBIA

PROPOSED SITE PLAN

SCALE 1:600

SCHEDULE A
This forms part of application # DP21-0231/DVP21-0232
City of Kelowna DEVELOPMENT PLANNING
Planner Initials KB



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Consultant
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PROJECT DESCRIPTION

LEGAL ADDRESS:
2241 SPRINGFIELD ROAD; Kelowna BC.

LOT AREA: 192,473 SF

RESIDENTIAL UNITS: 401 UNITS
STUDIO: 43 UNITS
1 BEDROOM: 160 UNITS
2 BEDROOM: 160 UNITS
3 BEDROOM: 38 UNITS

REQUIRED PARKING: 354 STALLS
[INCLUDING VISITOR STALLS AT 10% OF TOTAL VEHICLE PARKING]
[INCLUDING SMALL CAR STALLS]
RATIO: 1.5 PER UNIT


PROVIDED PARKING: 406 STALLS
[INCLUDING VISITOR STALLS AND RETAIL STALLS AT 5%]
SURFACE STALLS: 111
UNDERGROUND STALLS: 295

PROVIDED BICYCLE PARKING: 313 STALLS
[INCLUDING BICYCLE STALLS 1 PER 10 VEHICLE STALLS]

REV.	DESCRIPTION OF WORK REVISED	DATE

2241 SPRINGFIELD ROAD;
Kelowna BC.
PROPOSED SITE PLAN

Project Number: 2102
04-30-2020 Rev Date 06-06-2022
Drawn By T.THIMM
Designed By T.THIMM
Checked By R.GARVEY
ESP-1.0
Scale 1:600

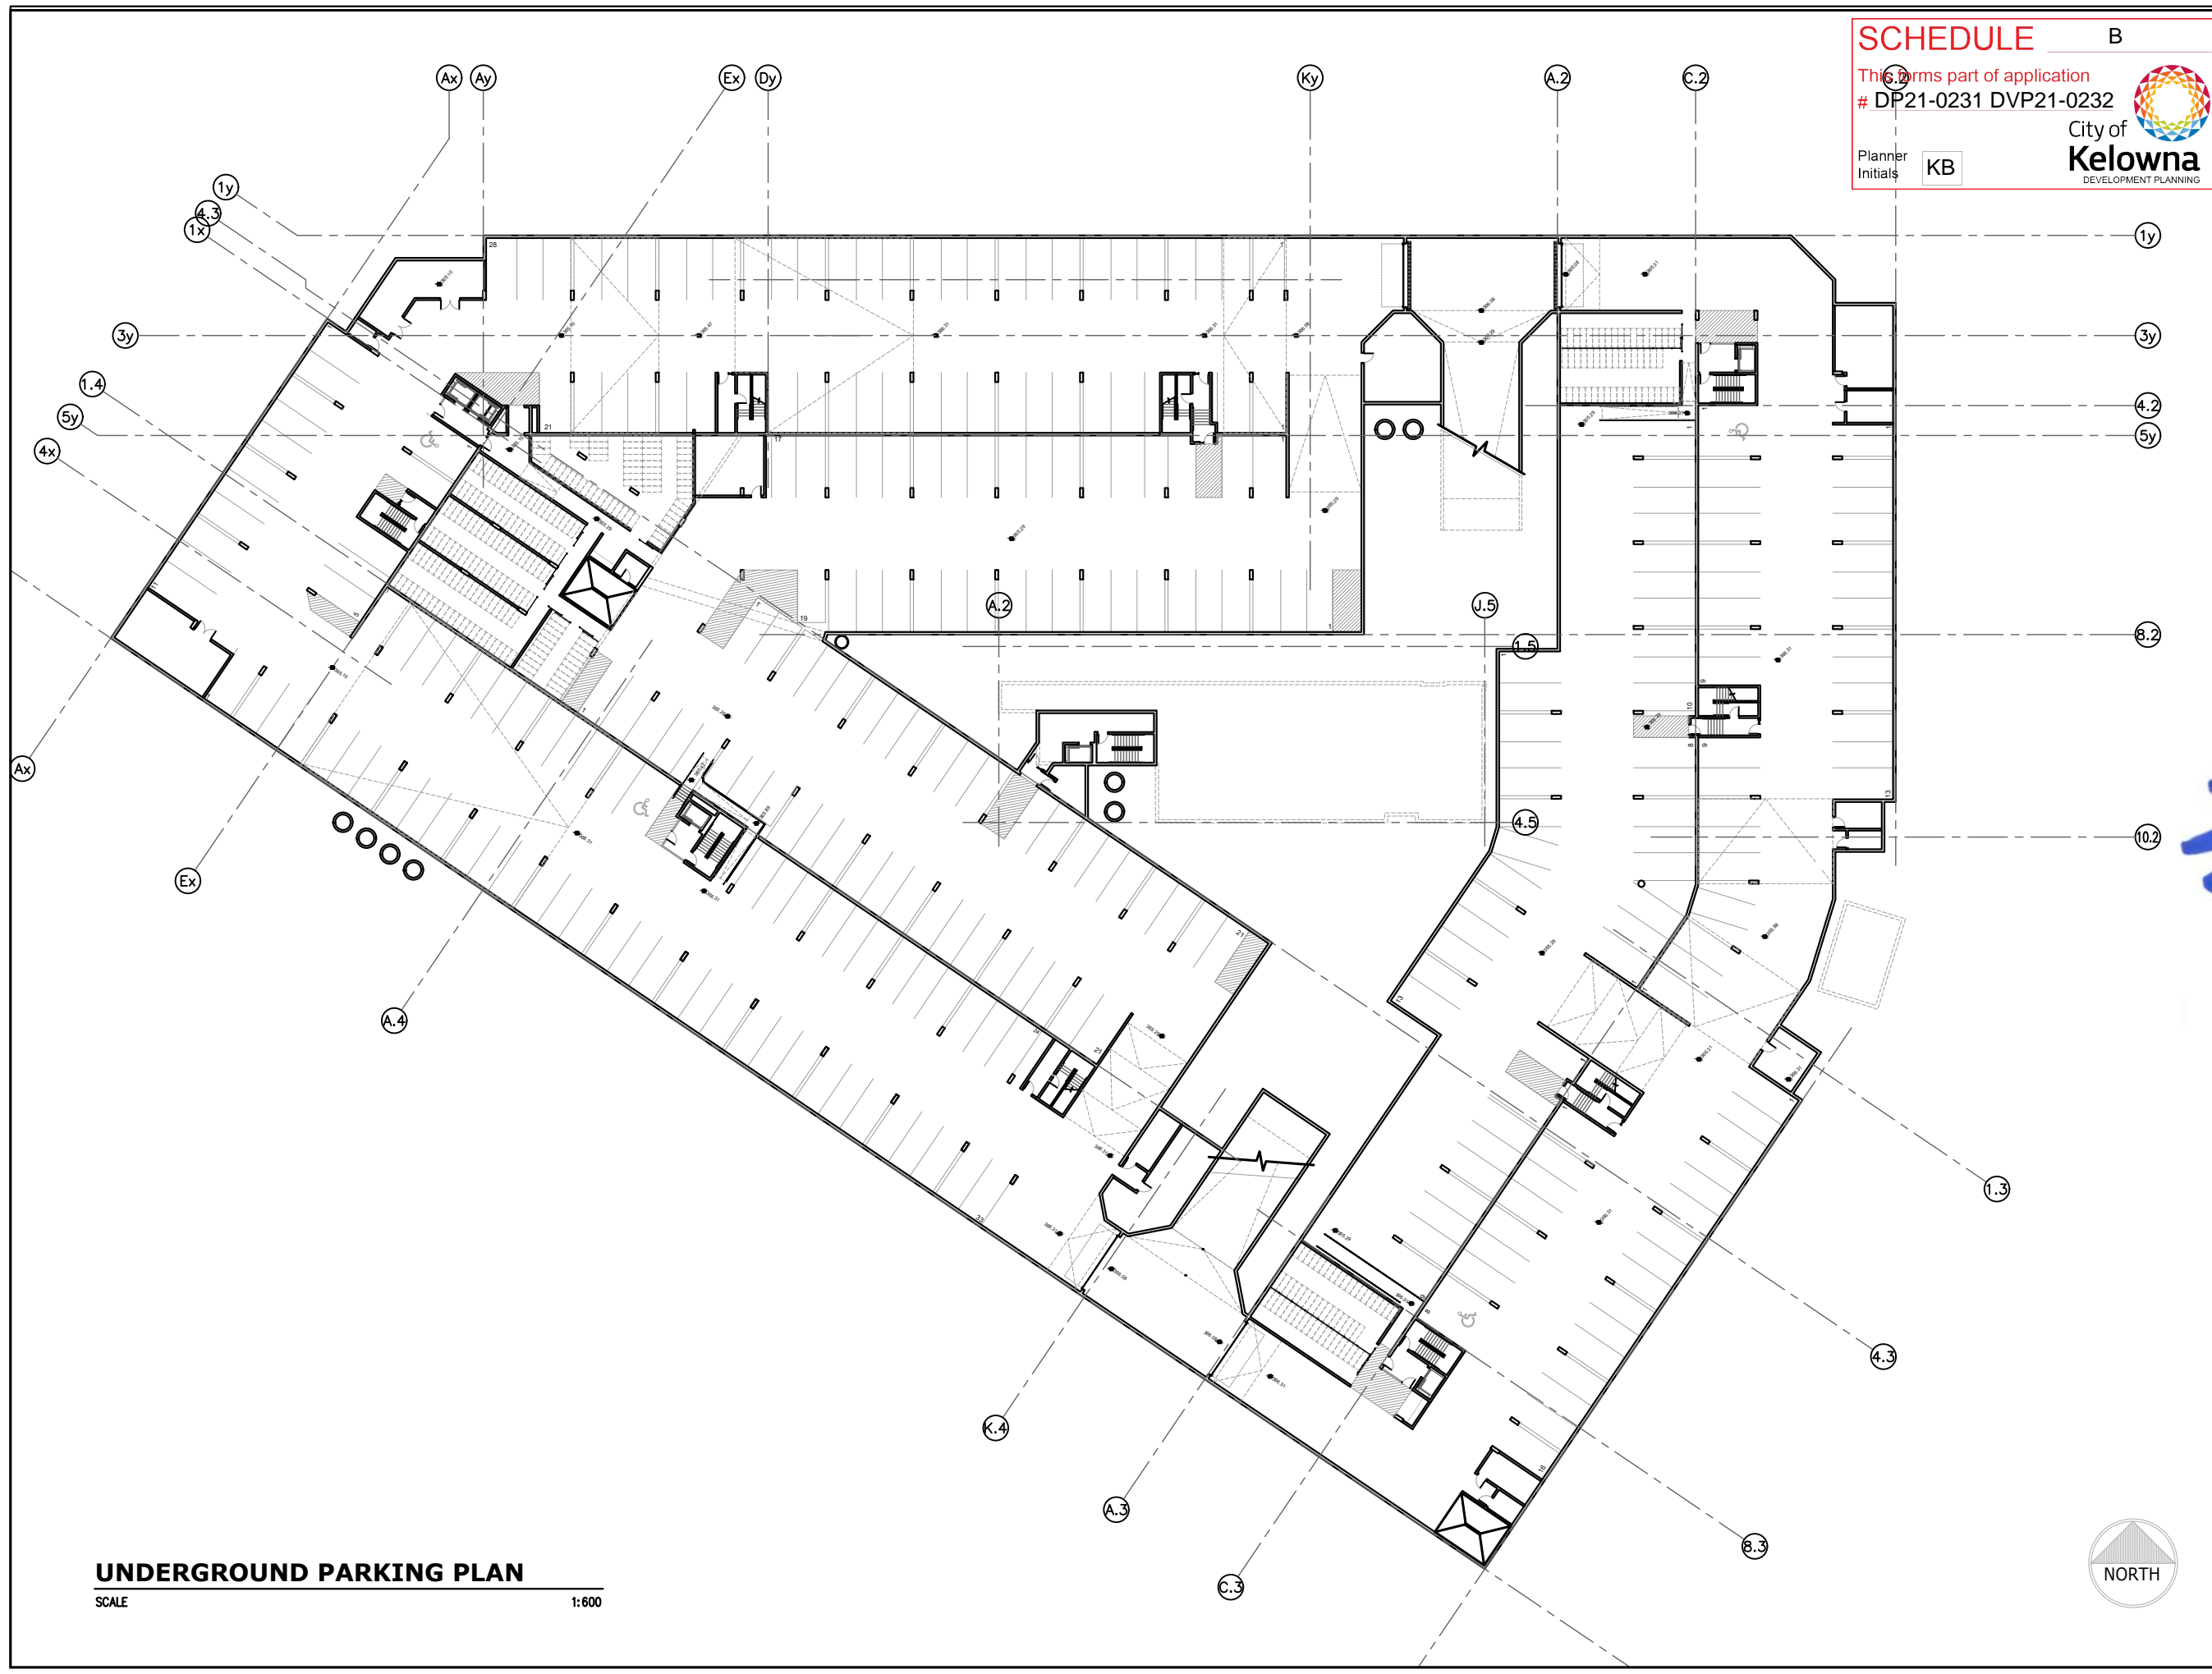


UNDERGROUND PARKING PLAN
SCALE 1:600

SCHEDULE B
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Planner Initials KB
City of Kelowna DEVELOPMENT PLANNING

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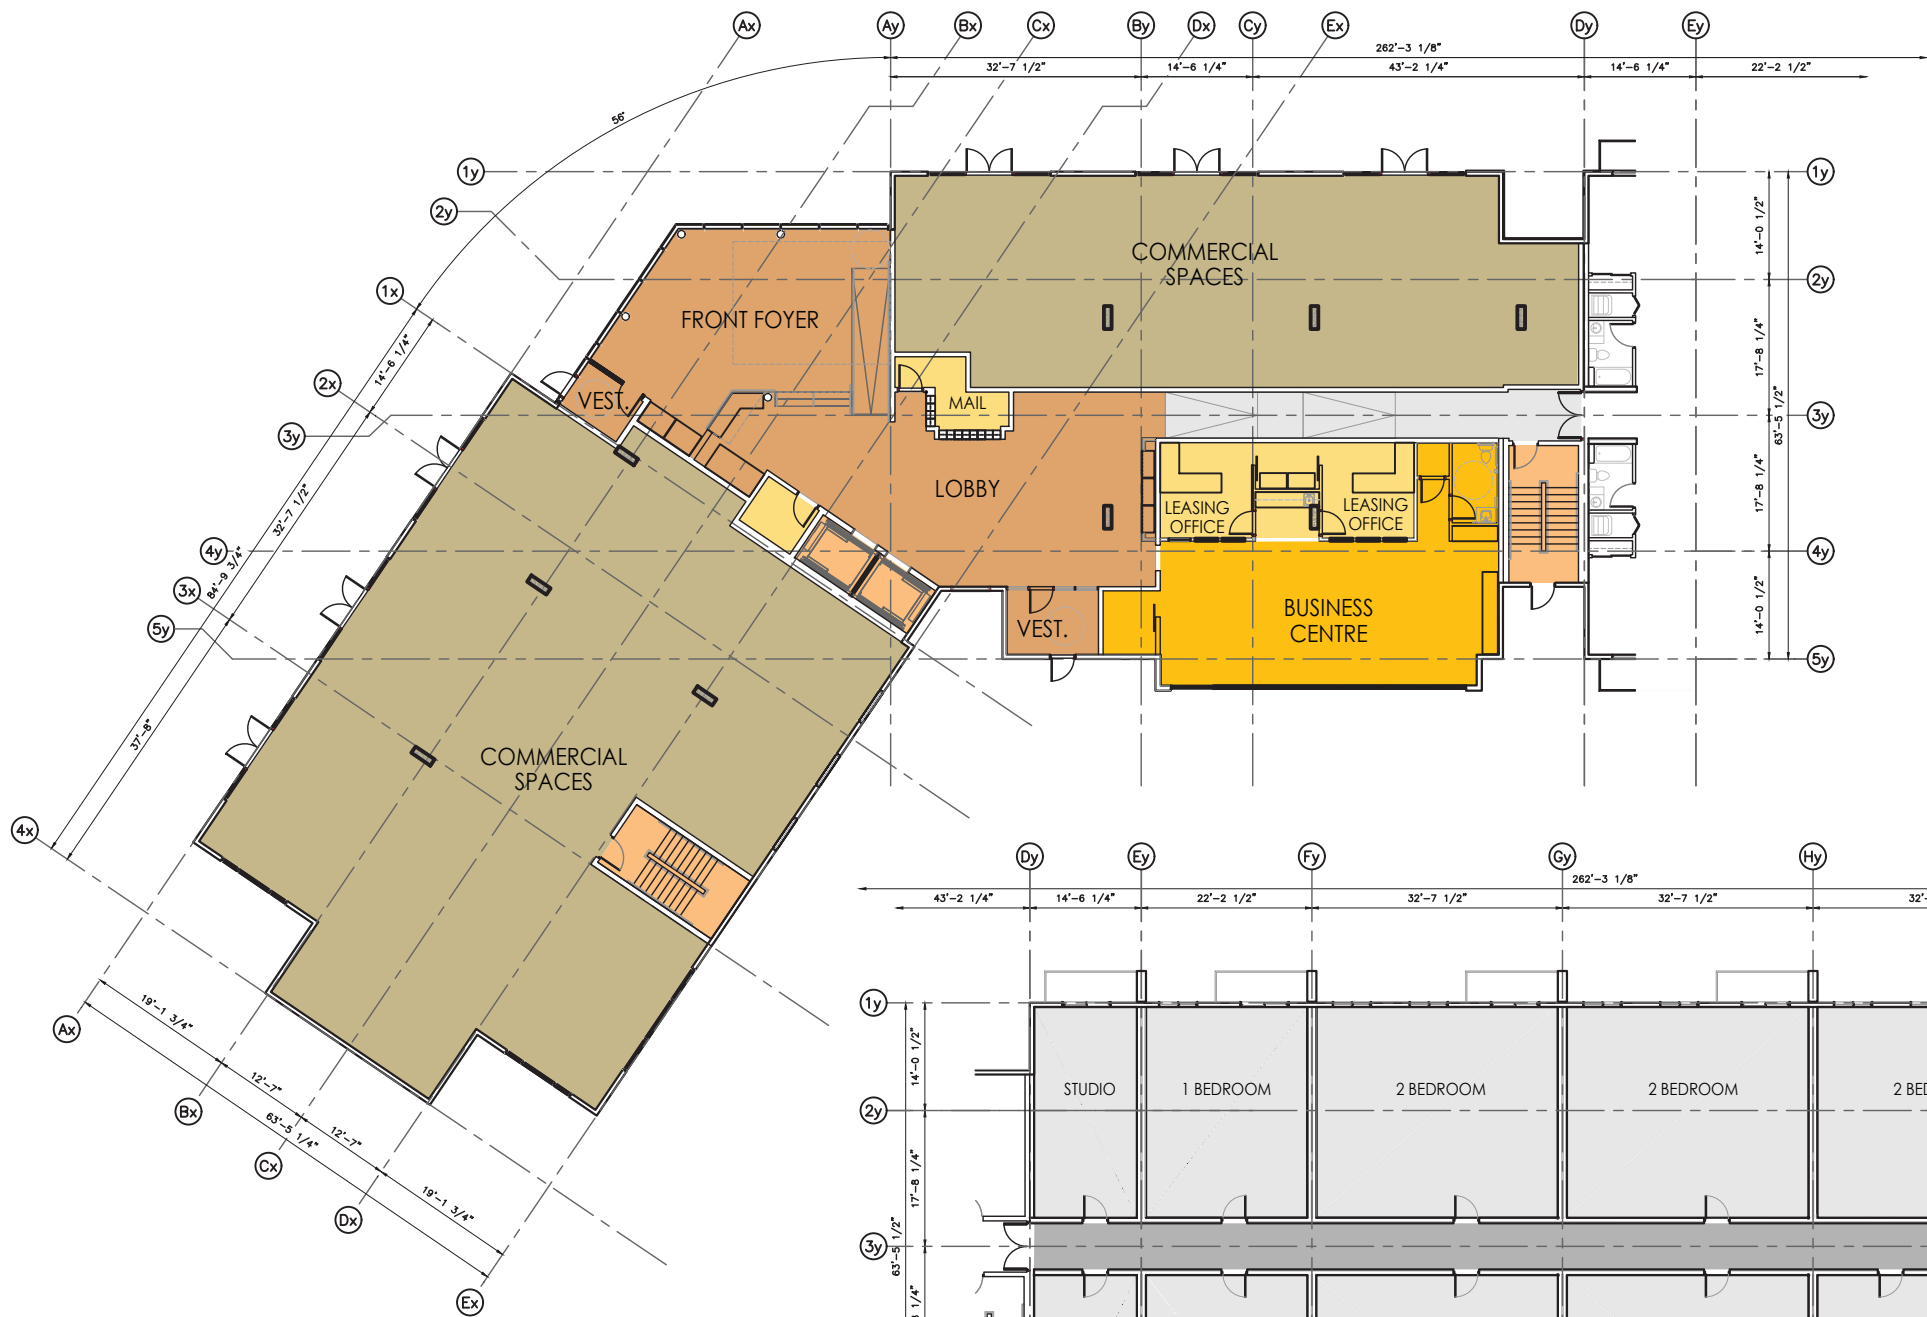
2241 SPRINGFIELD ROAD;
Kelowna BC.

UNDERGROUND PARKING
PLAN

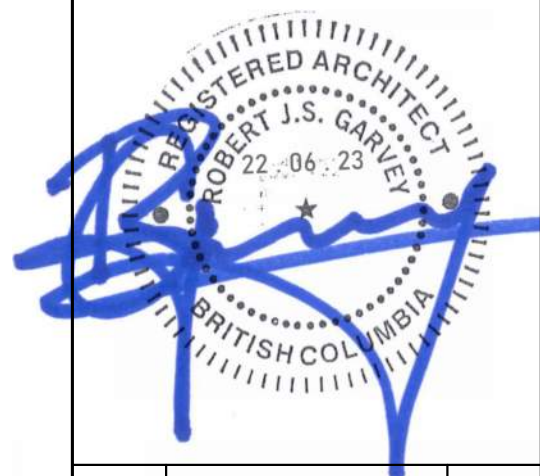Project Number: 2102


04-30-2020	Rev Date 06-06-2022
Drawn By T.THIMM	Designed By T.THIMM
Checked By R.GARVEY	

ESP-2.0
Scale 1:600



BUILDING 1 WEST MAIN FLOOR PLAN

SCALE 1:300

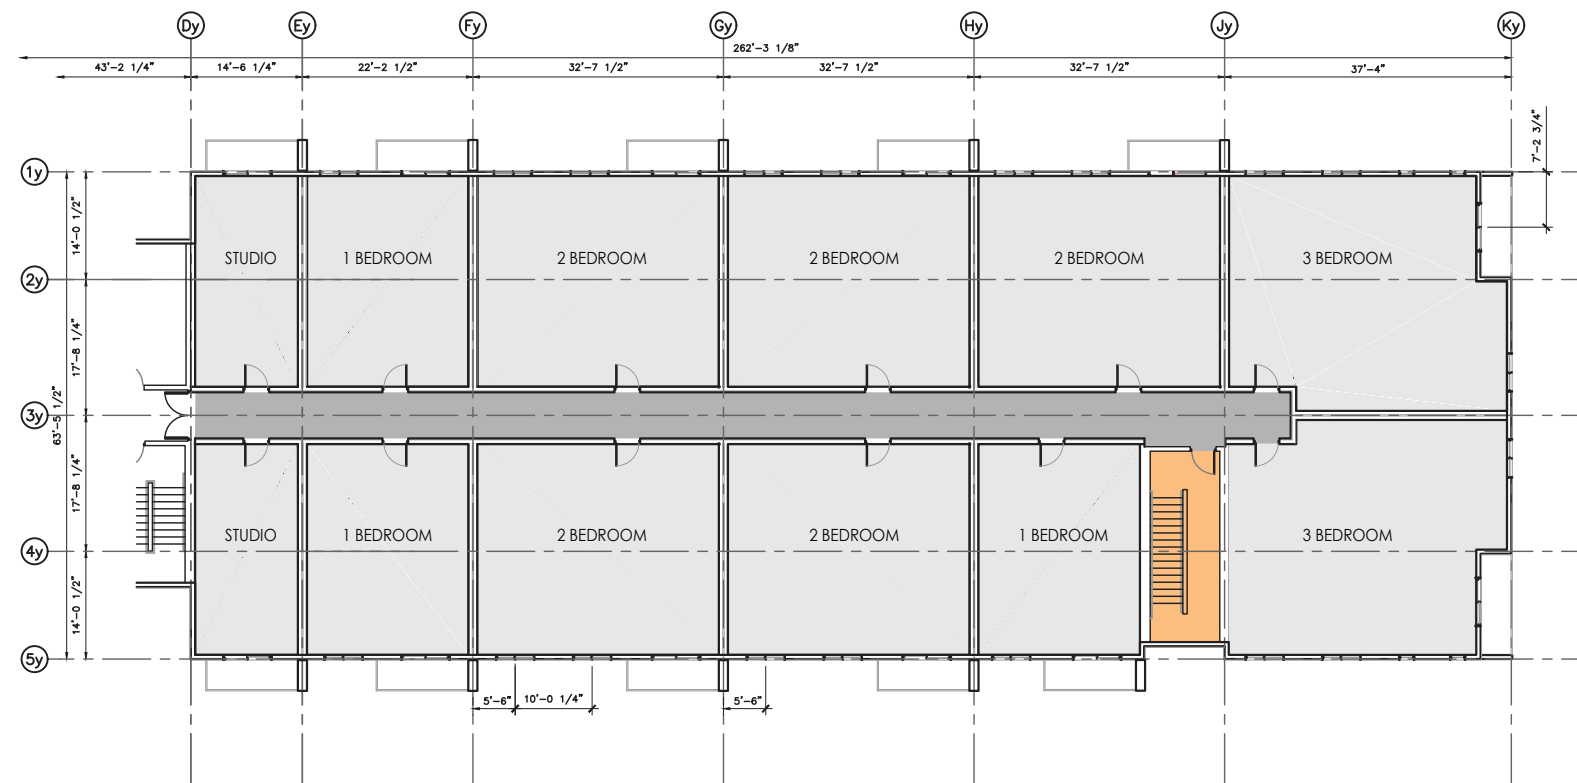

BUILDING 1 EAST MAIN FLOOR PLAN

SCALE 1:300

SCHEDULE B

This forms part of application
DP21-0231 DVP21-0232

Planner Initials **KB**

City of **Kelowna**
DEVELOPMENT PLANNING

Ironclad Developments Inc.

Project Management
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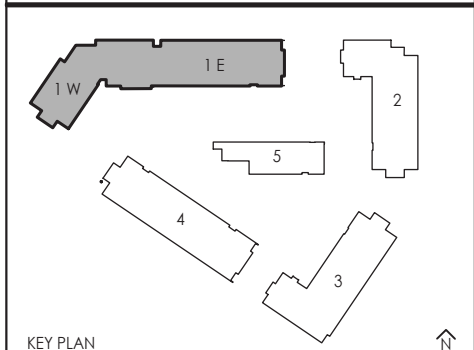
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IRONCLAD DEVELOPMENTS INC.

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- AMENITIES
- ROOFTOP PATIOS
- COMMERCIAL
- SUPPORTING SPACES
- SUITES
- LOBBY/ENTRANCE AREA
- CORRIDOR
- VERTICAL COMMUNICATION

REV.	DESCRIPTION OF WORK REVISED	DATE

2241 SPRINGFIELD ROAD;
Kelowna BC.


BUILDING ONE
MAIN FLOOR PLAN

Project Number: 2102

04-30-2020	Rev Date 06-06-2022
Drawn By T.THIMM	Designed By T.THIMM
Checked By R.GARVEY	

ESP-3.10

Scale 1:300

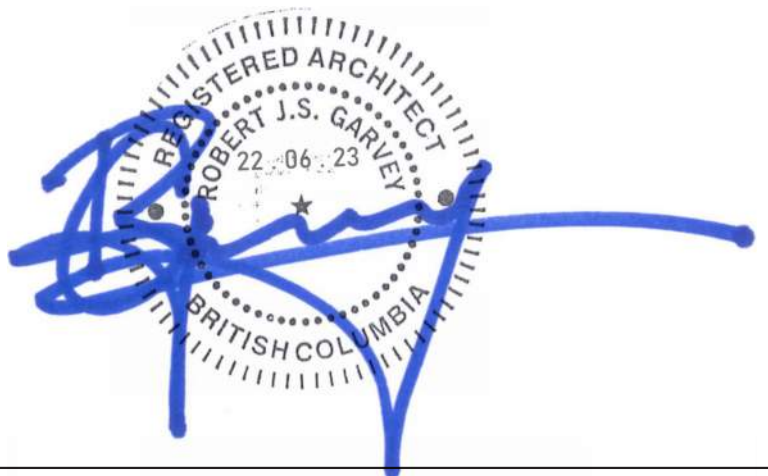

SCHEDULE B

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DP21-0231 DVP21-0232

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DEVELOPMENT PLANNING

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Project Management
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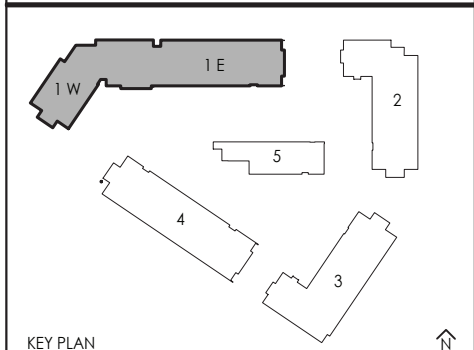
IRONCLAD DEVELOPMENTS INC.

Consultant



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- AMENITIES
- ROOFTOP PATIOS
- COMMERCIAL
- SUPPORTING SPACES
- SUITES
- LOBBY/ENTRANCE AREA
- CORRIDOR
- VERTICAL COMMUNICATION

REV.	DESCRIPTION OF WORK REVISED	DATE

2241 SPRINGFIELD ROAD;
Kelowna BC.




BUILDING ONE
SECOND FLOOR PLAN

Project Number: 2102

04-30-2020	Rev Date 06-06-2022
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Checked By R.GARVEY	

ESP-3.11

Scale 1:300

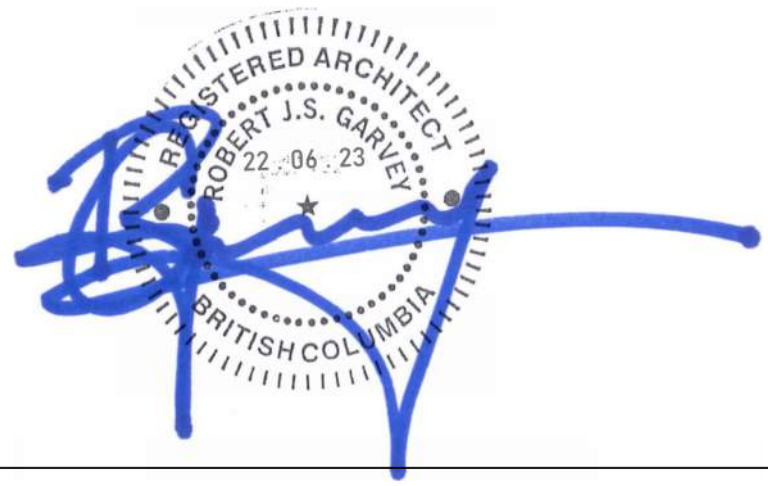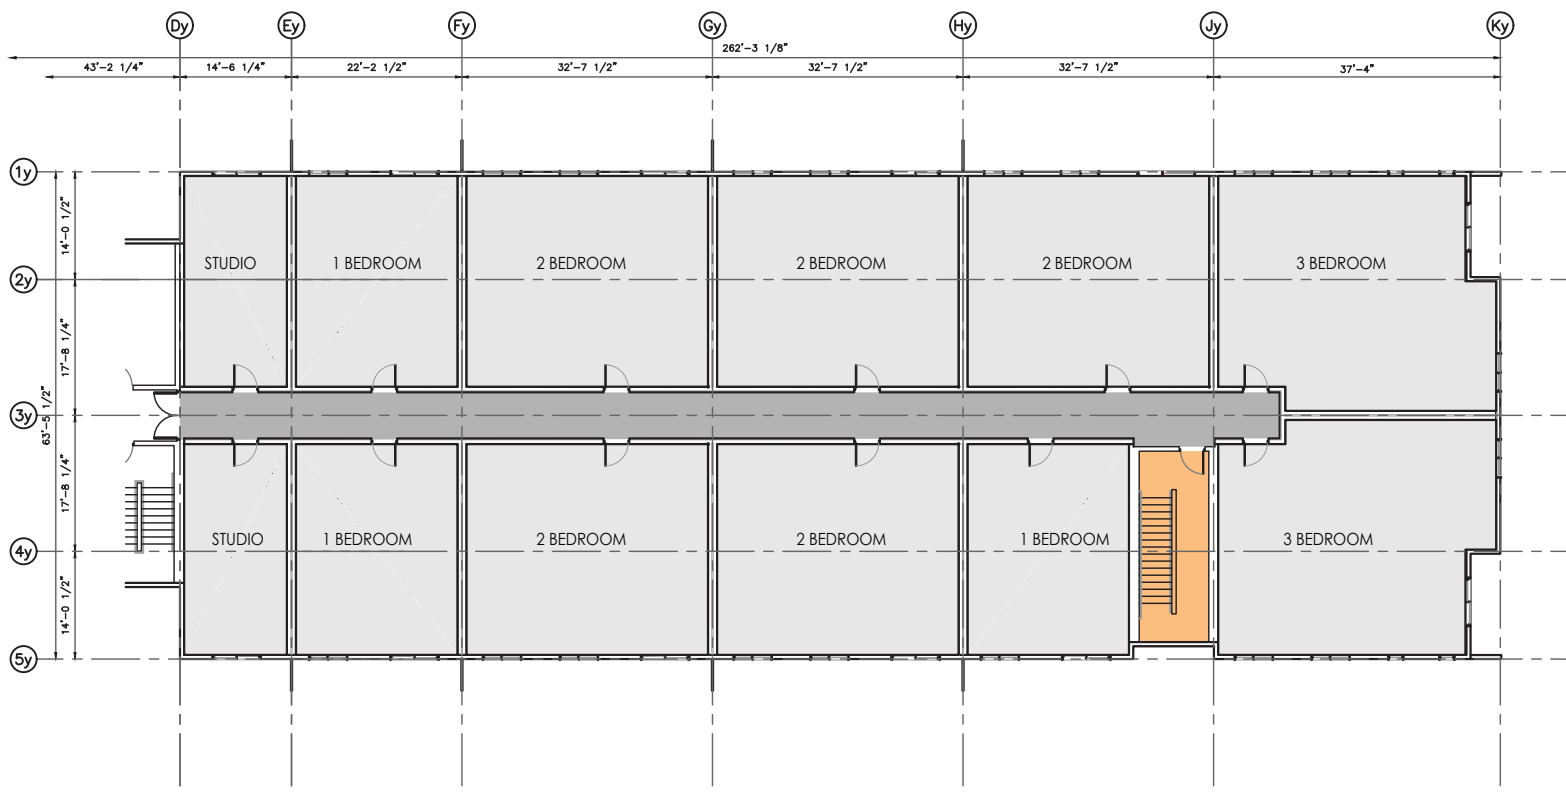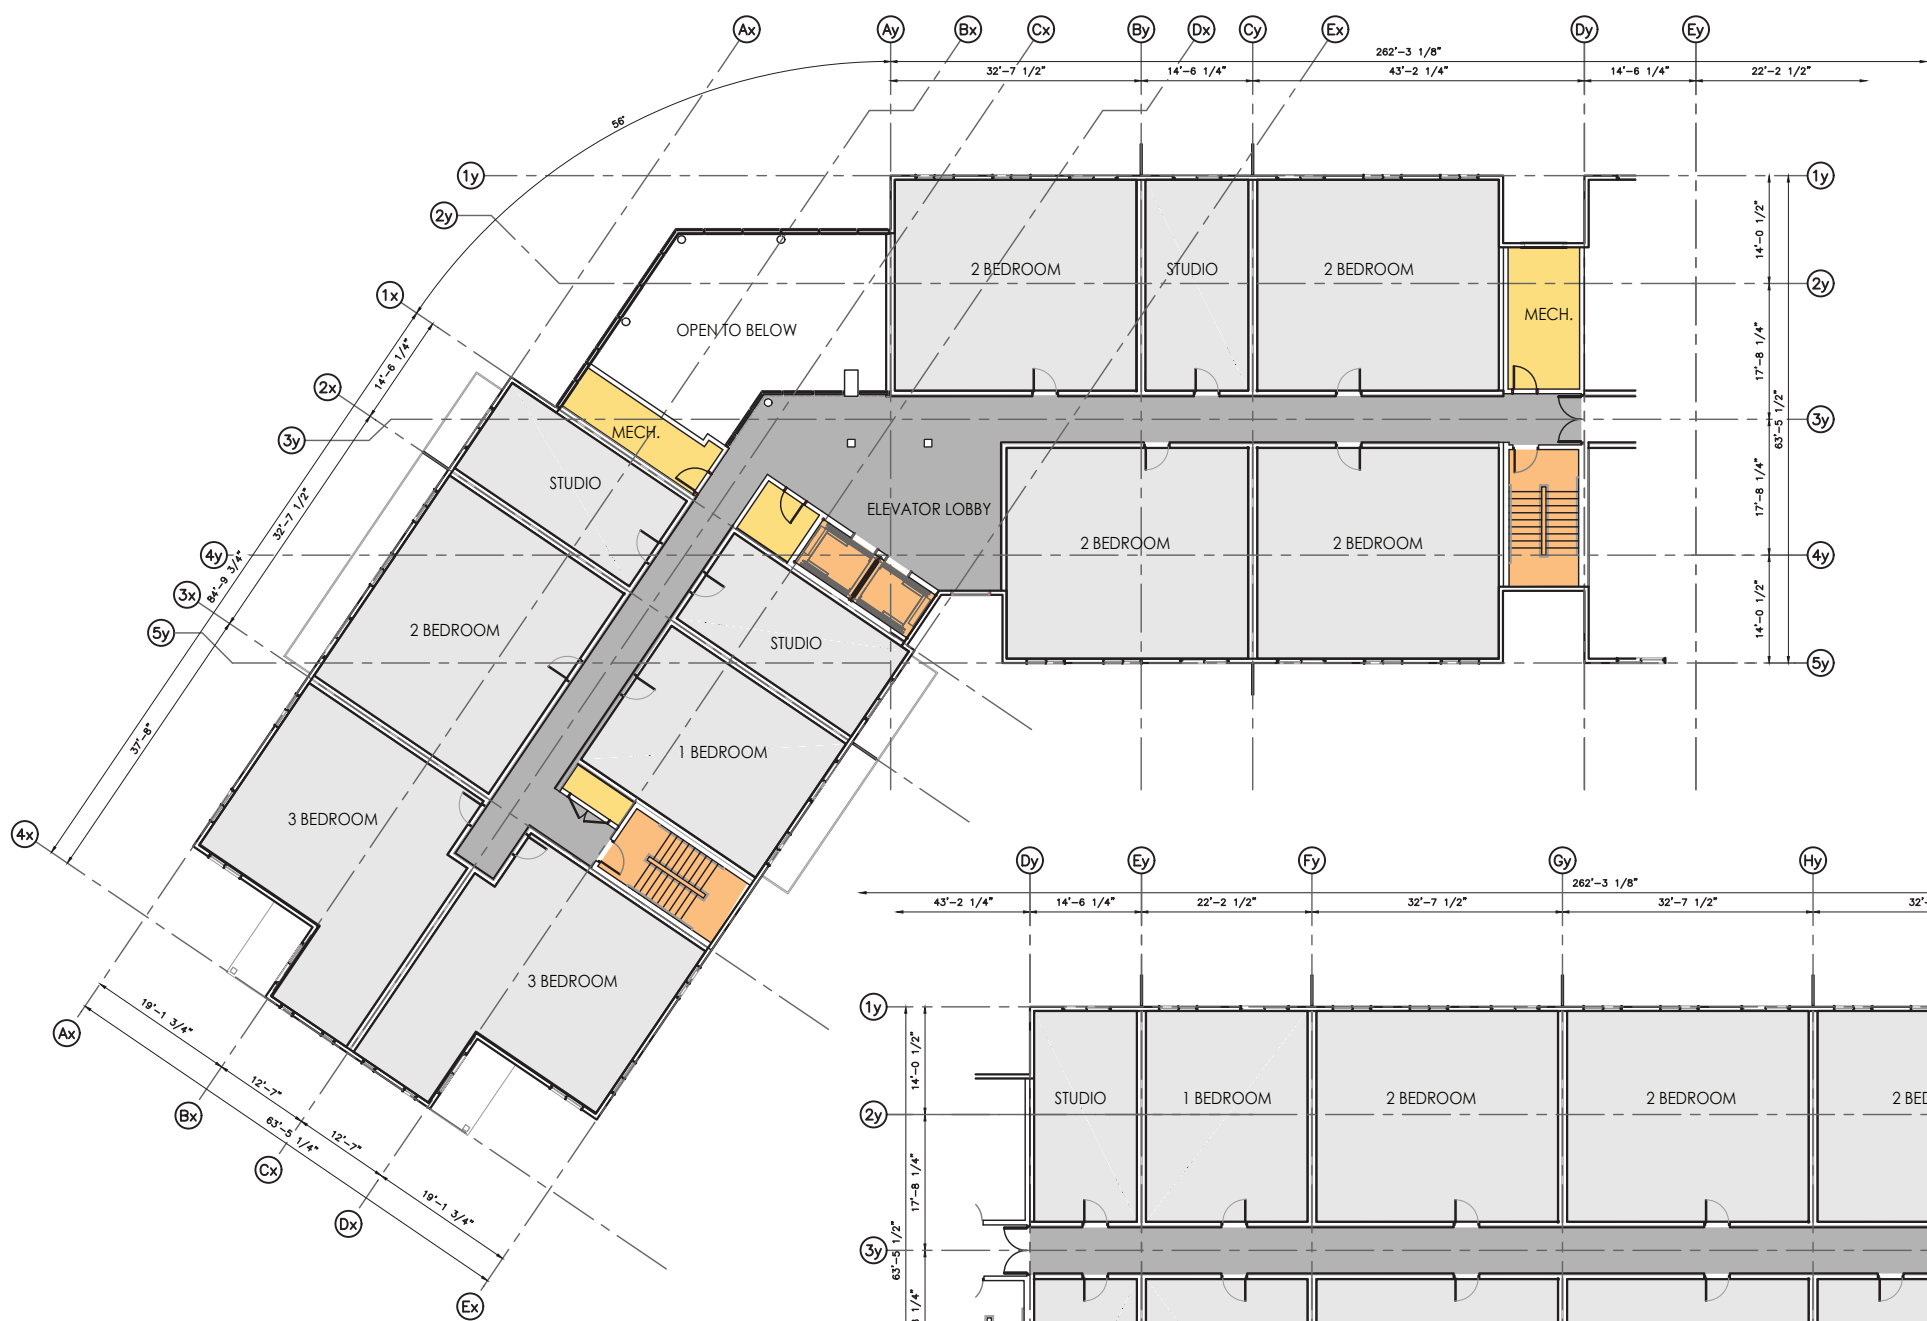

SCHEDULE B

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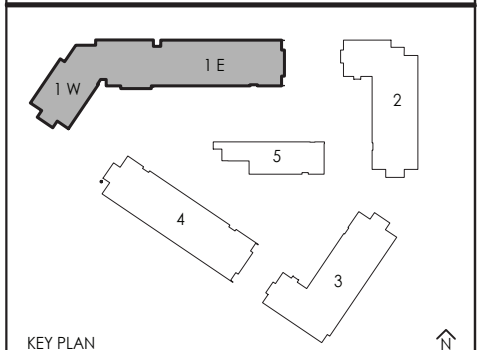
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- AMENITIES
- ROOFTOP PATIOS
- COMMERCIAL
- SUPPORTING SPACES
- SUITES
- LOBBY/ENTRANCE AREA
- CORRIDOR
- VERTICAL COMMUNICATION

REV.	DESCRIPTION OF WORK REVISED	DATE

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Kelowna BC.


BUILDING ONE
TYPICAL FLOOR PLAN (3-6)

Project Number: 2102


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ESP-3.12


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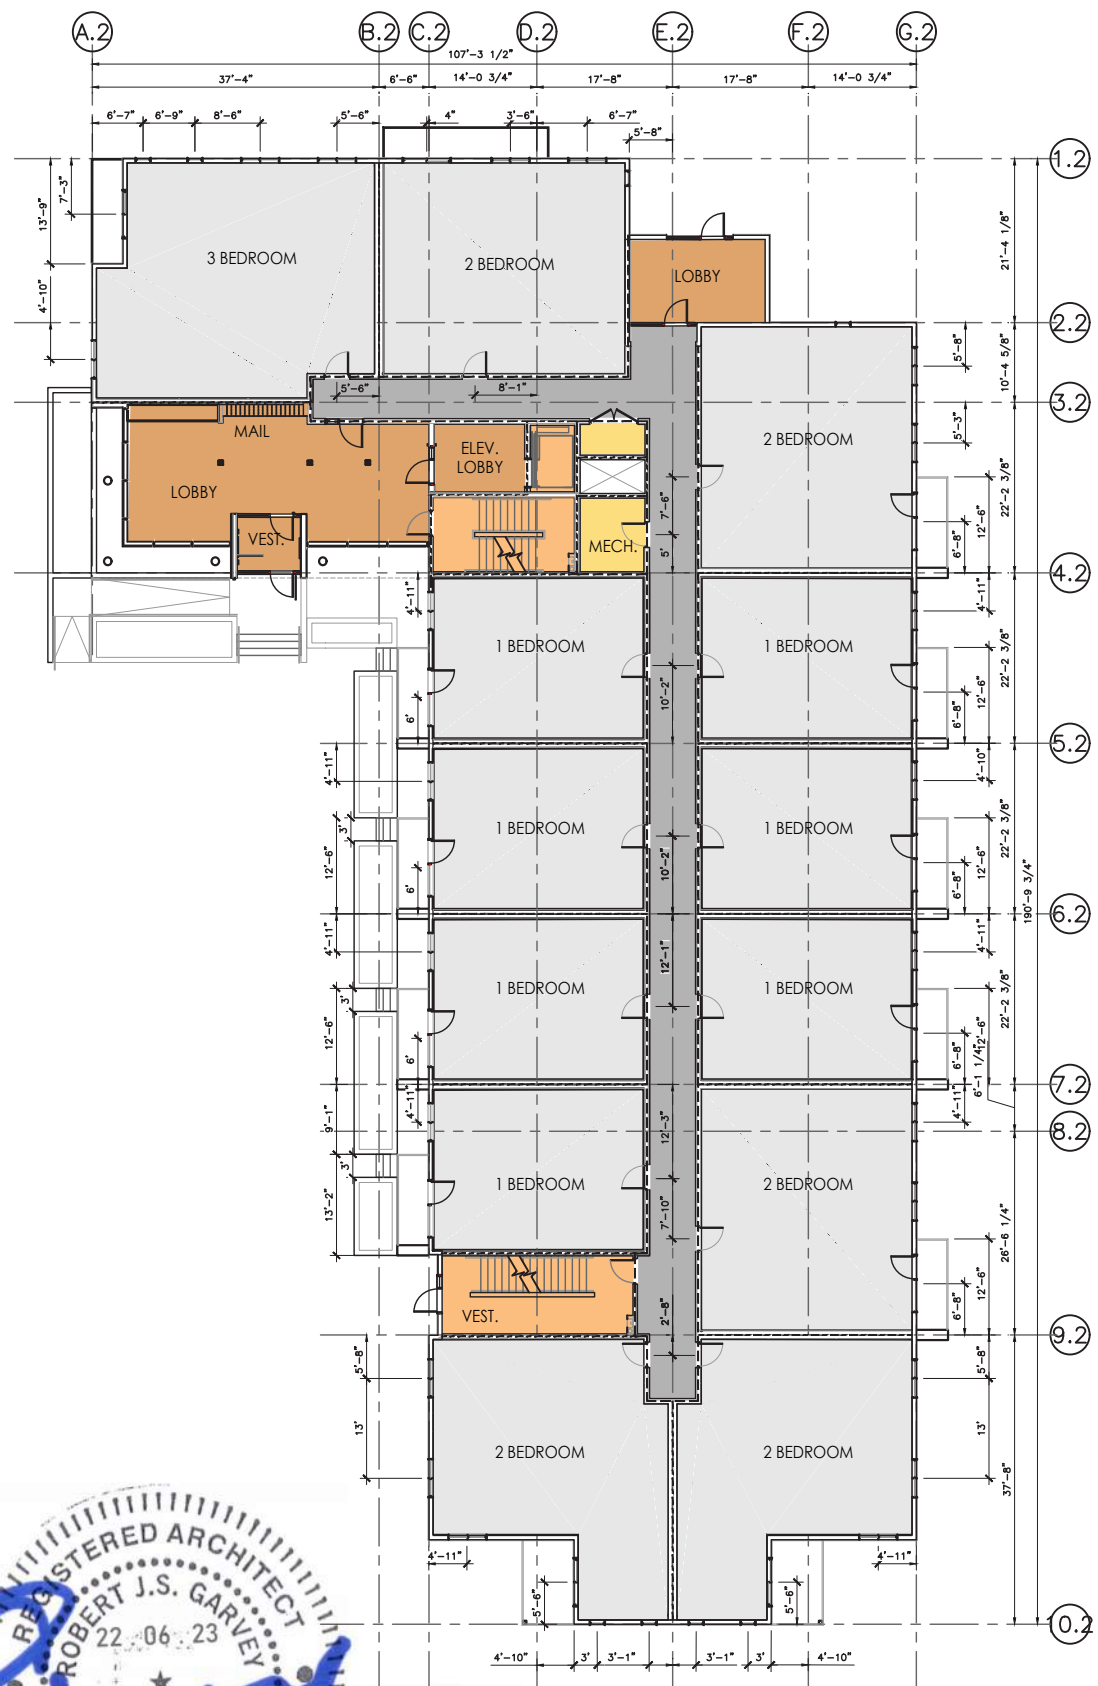


BUILDING 1 WEST TYPICAL PLAN
SCALE 1:300

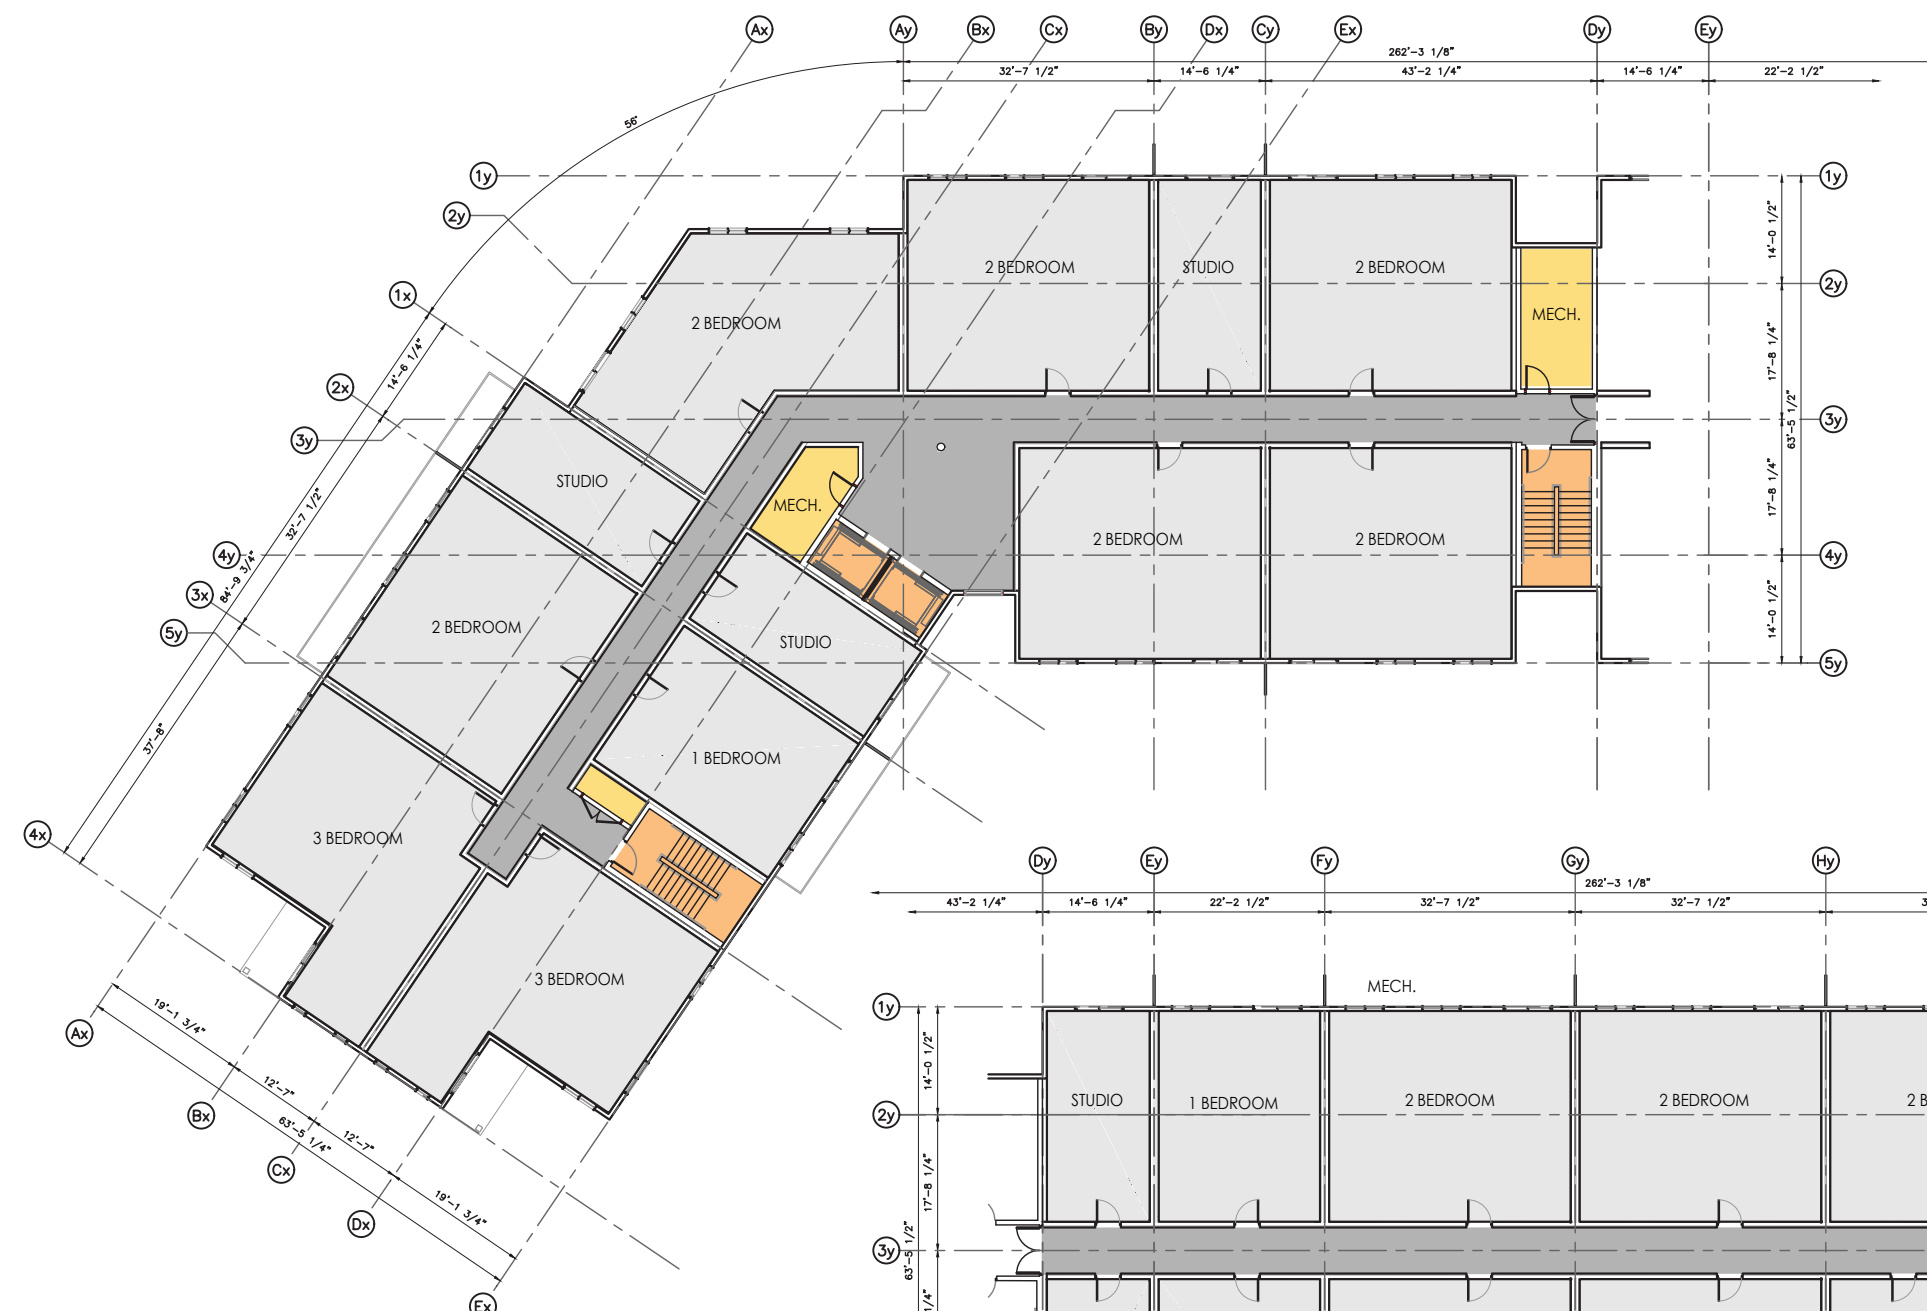


BUILDING 1 EAST TYPICAL PLAN
SCALE 1:300

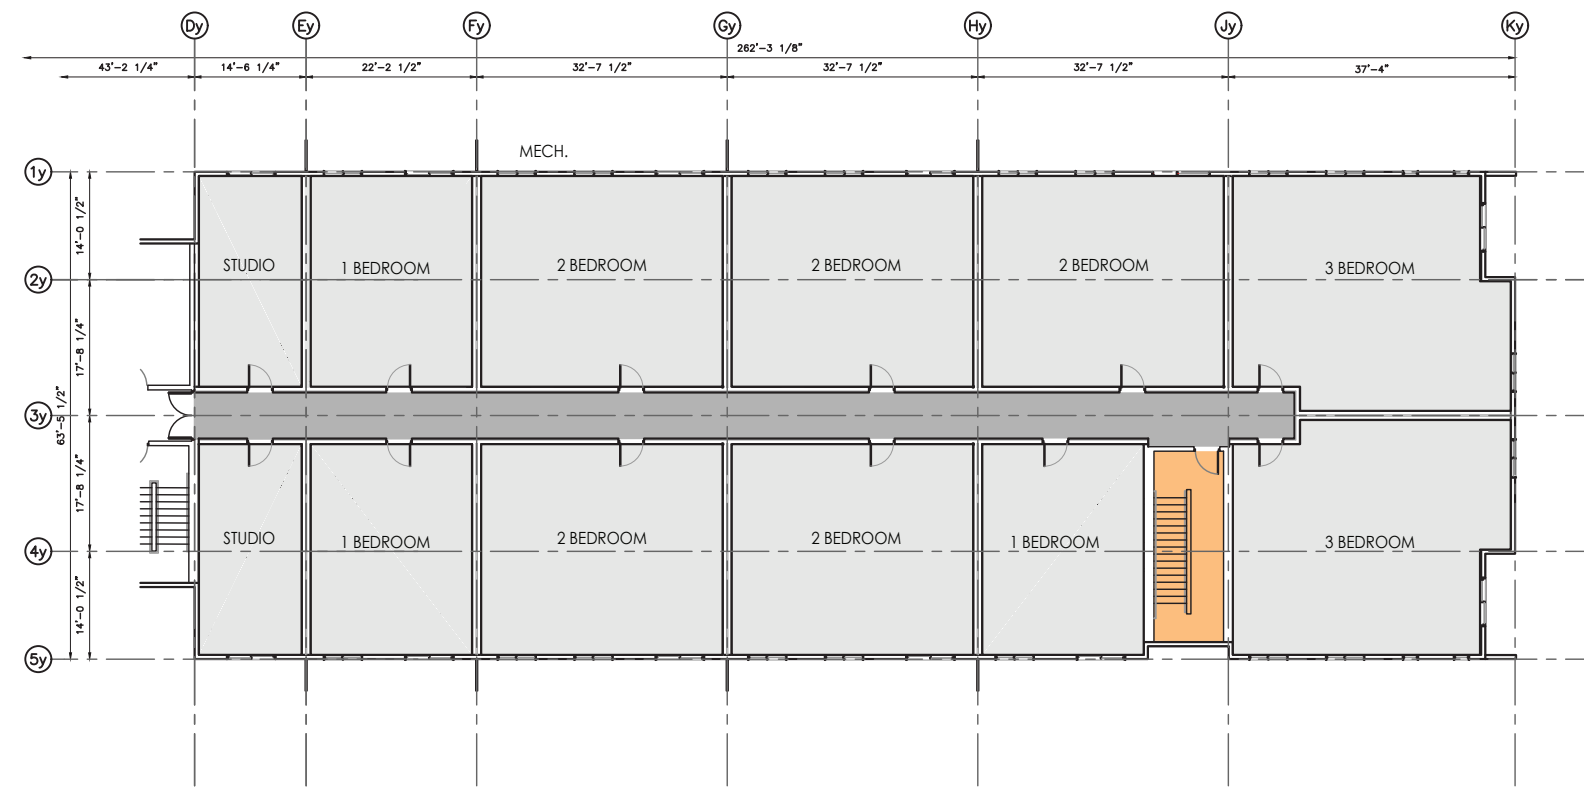

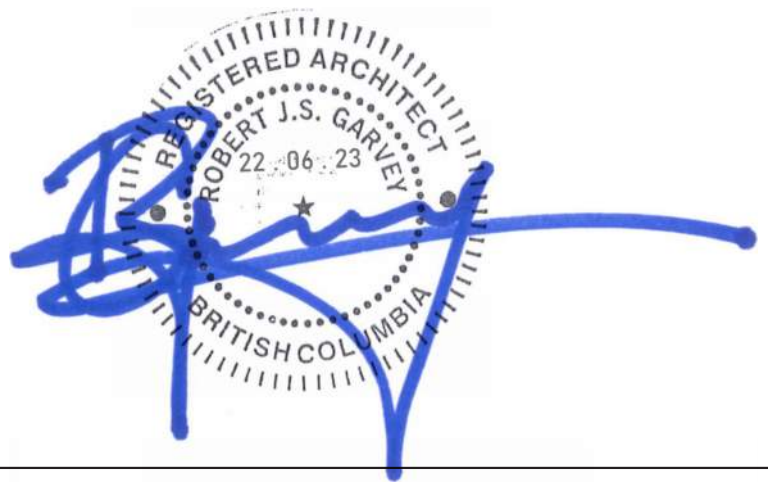

BUILDING 2 MAIN FLOOR PLAN

SCALE 1:300

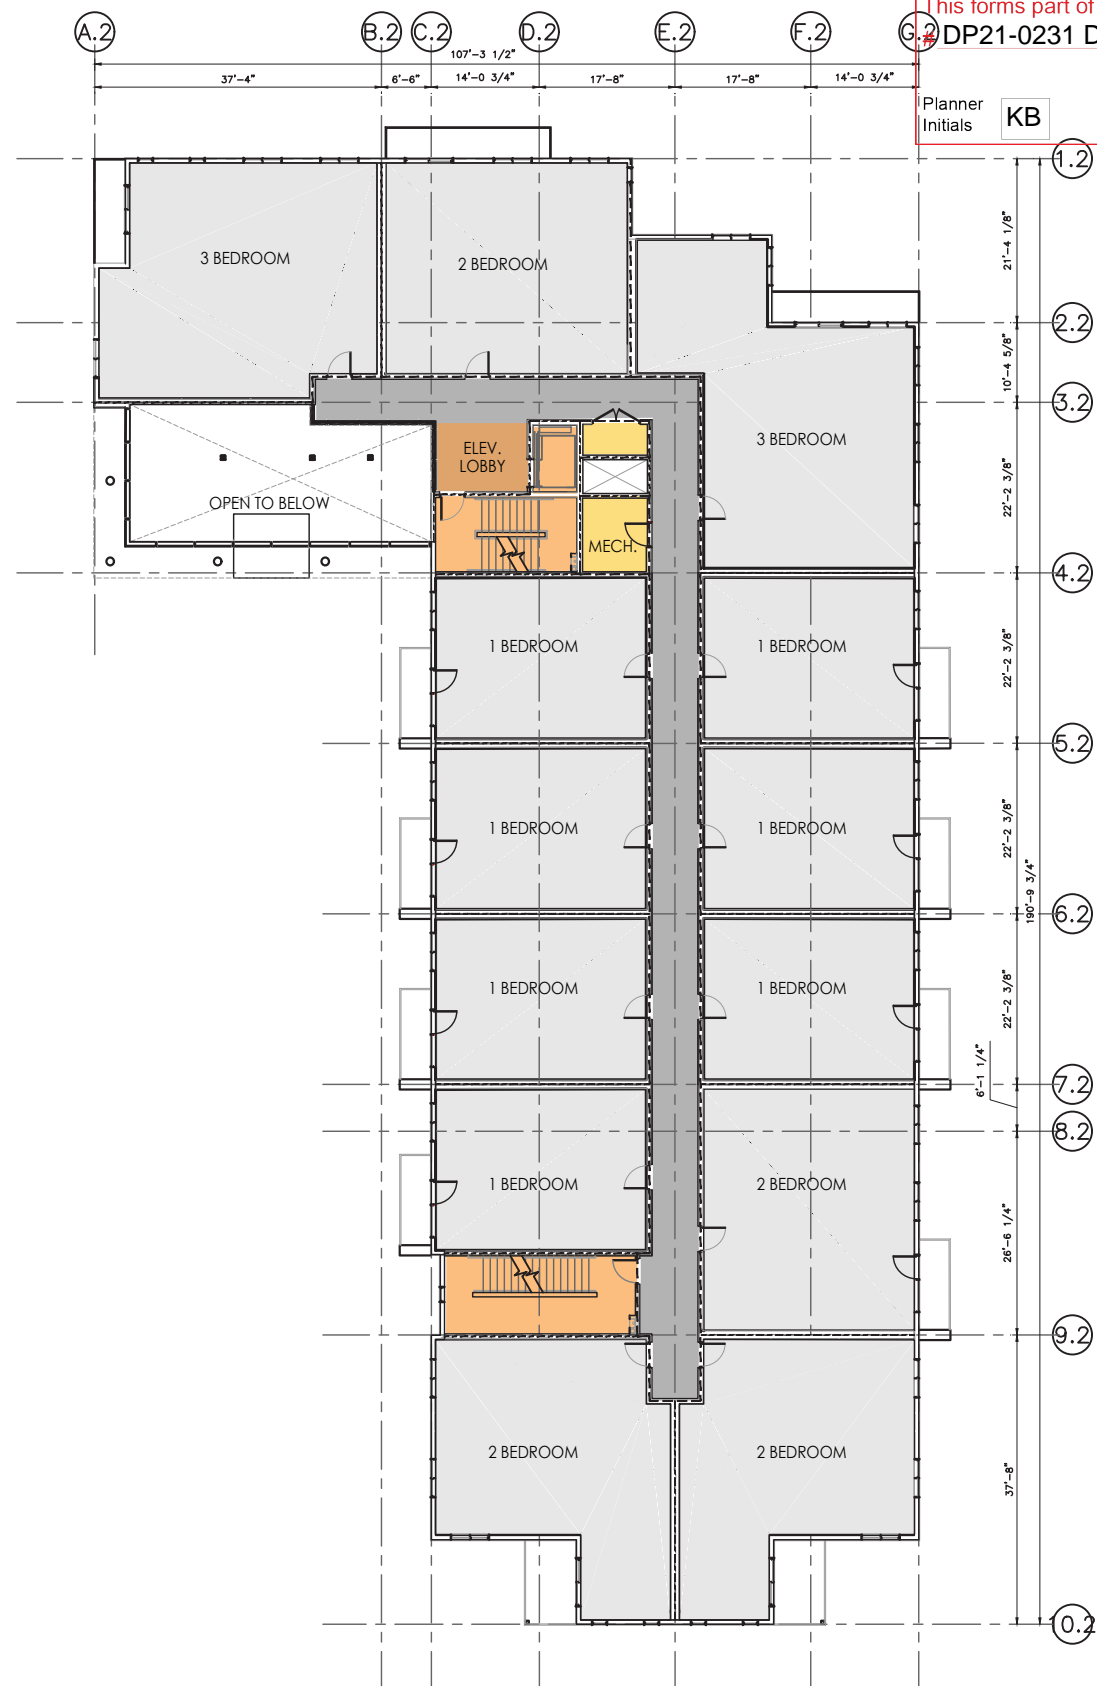

BUILDING 2 SECOND FLOOR PLAN

SCALE 1:300

SCHEDULE B

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 DP21-0231 DVP21-0232

Planner Initials KB



Ironclad Developments Inc.

Project Management
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 Design/ Build


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- KEY PLAN
- AMENITIES
 - ROOFTOP PATIOS
 - COMMERCIAL
 - SUPPORTING SPACES
 - SUITES
 - LOBBY/ENTRANCE AREA
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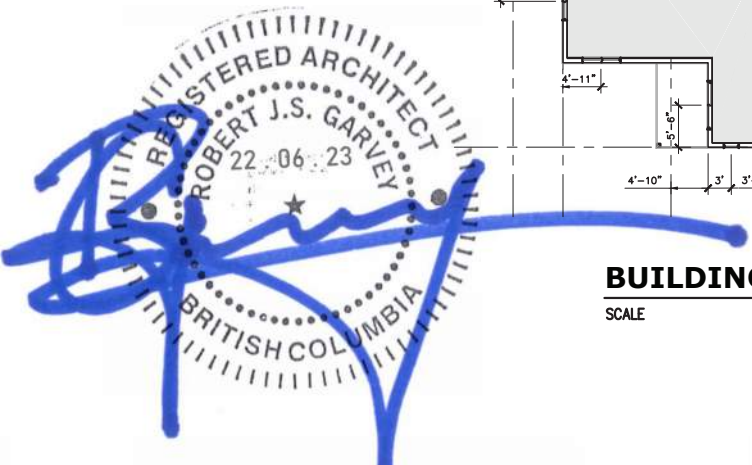
**BUILDING TWO
 MAIN AND SECOND PLAN**

Project Number: 2102

04-30-2020	Rev Date 06-06-2022
Drawn By T.THIMM	Designed By T.THIMM
Checked By R.GARVEY	

ESP-3.20

Scale 1:300

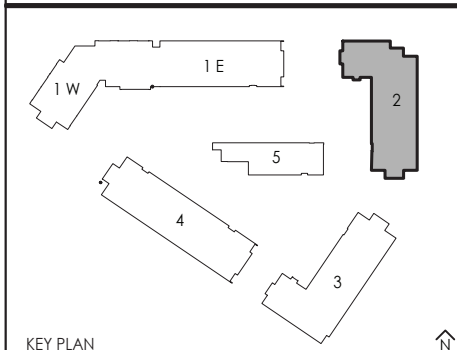

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City of **Kelowna**
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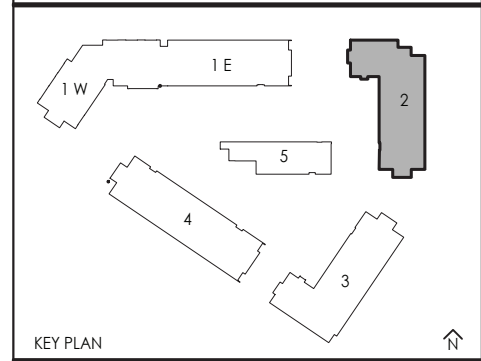
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Consultant



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- AMENITIES
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- COMMERCIAL
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- CORRIDOR
- VERTICAL COMMUNICATION

REV.	DESCRIPTION OF WORK REVISED	DATE

2241 SPRINGFIELD ROAD;
Kelowna BC.


BUILDING TWO
TYPICAL FLOOR PLAN (3-6)

Project Number: 2102


04-30-2020	Rev Date 06-06-2022
Drawn By	T.THIMM
Designed By	T.THIMM
Checked By	R.GARVEY

ESP-3.21

Scale 1:300

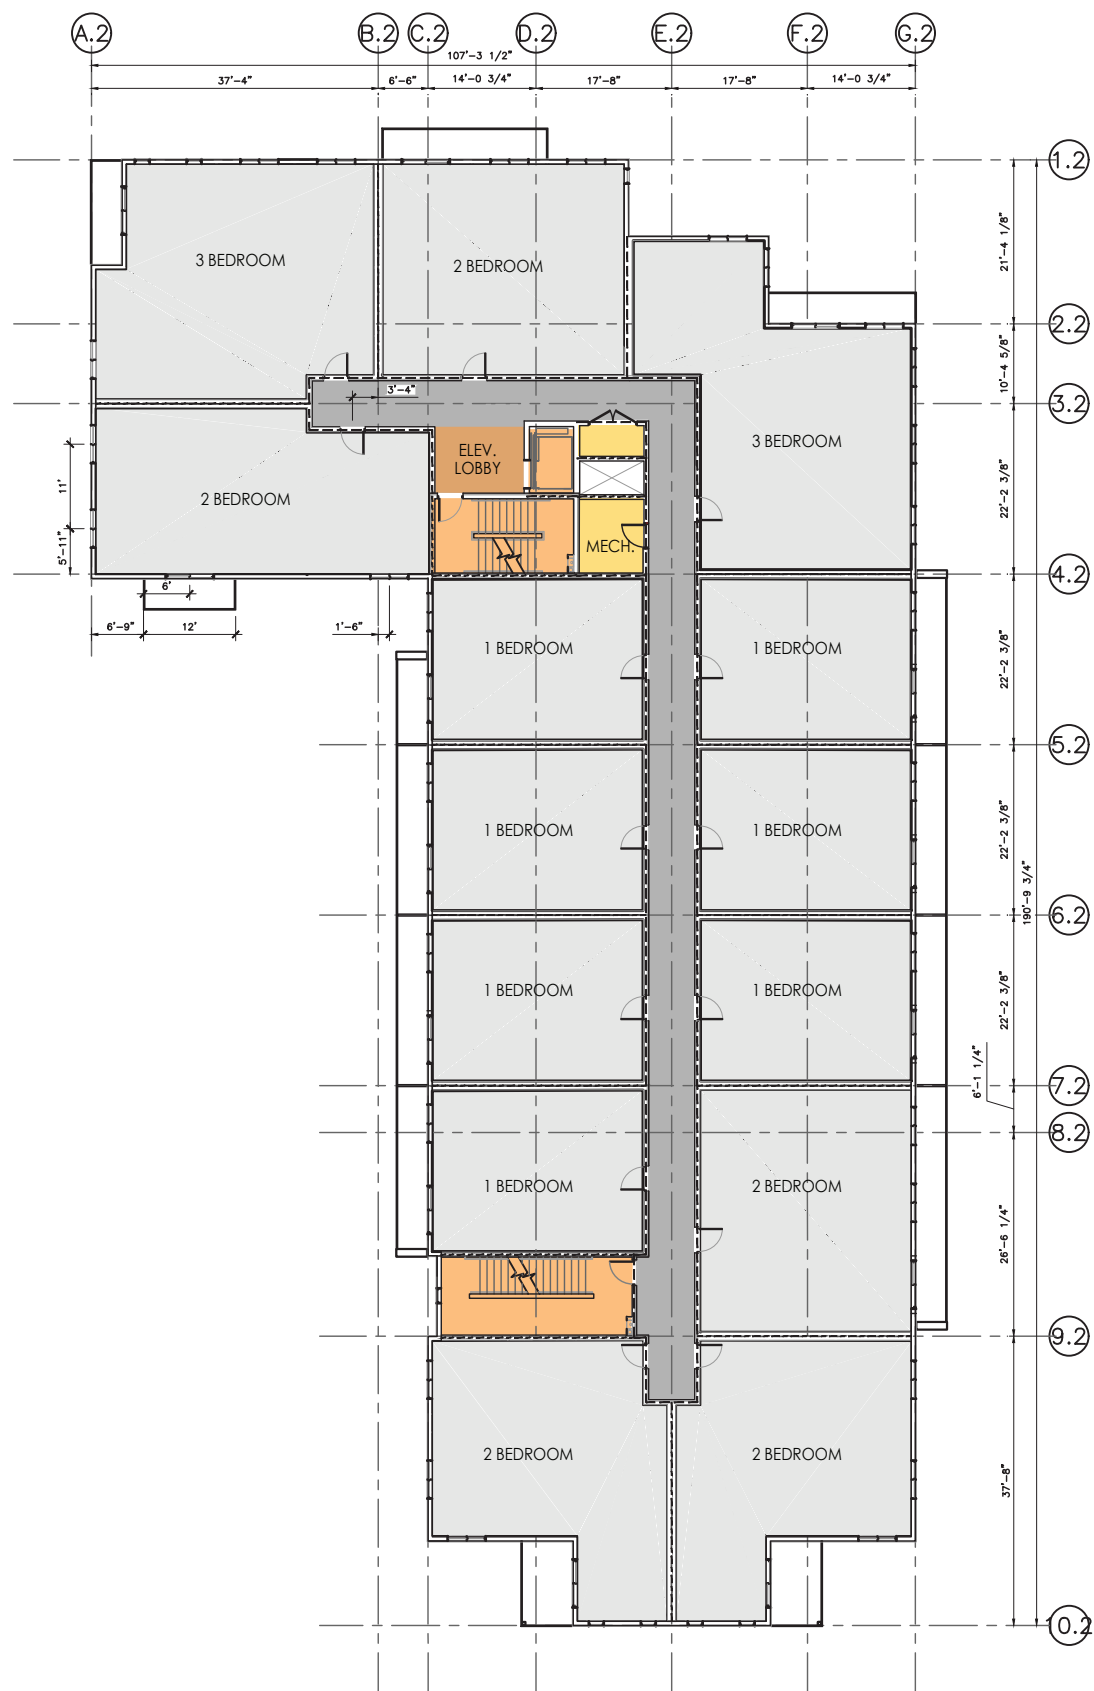

BUILDING 2 TYPICAL FLOOR PLAN
SCALE 1:300

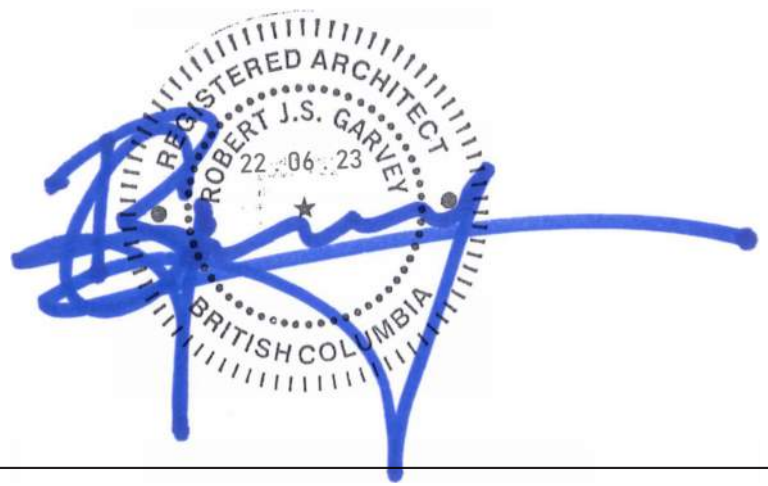



SCHEDULE B
 This forms part of application
 # DP21-0231 DVP21-0232
 Planner Initials KB
 City of Kelowna
 DEVELOPMENT PLANNING

Ironclad Developments Inc.


Project Management
 General Contracting
 Design/ Build

101-57158
 Symington Rd.
 Springfield, MB
 R2J 4L6

PH:
204-777-1972
 info@icdev.ca

Consultant

ROB J.S. GARVEY, ARCHITECT
 MAA, AIBC, LEED AP
 201-57158 SYMINGTON RD 20E
 SPRINGFIELD, MB R2J 4L6
 T: 204.227.9274
 E: RGARVEY@A77.CA

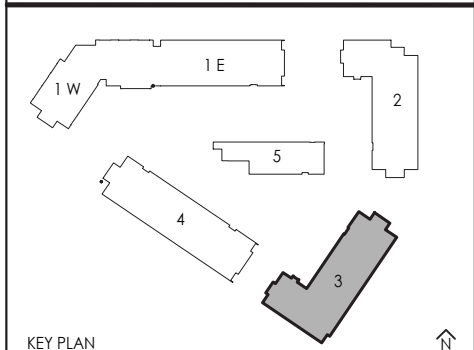

- AMENITIES
- ROOFTOP PATIOS
- COMMERCIAL
- SUPPORTING SPACES
- SUITES
- LOBBY/ENTRANCE AREA
- CORRIDOR
- VERTICAL COMMUNICATION

REV.	DESCRIPTION OF WORK REVISED	DATE


2241 SPRINGFIELD ROAD;
 Kelowna BC.

**BUILDING THREE
 MAIN AND SECOND
 FLOOR PLAN**


Project Number: 2102

04-30-2020	Rev Date 06-06-2022
Drawn By T.THIMM	Designed By T.THIMM
Checked By R.GARVEY	

ESP-3.30
 Scale 1:300

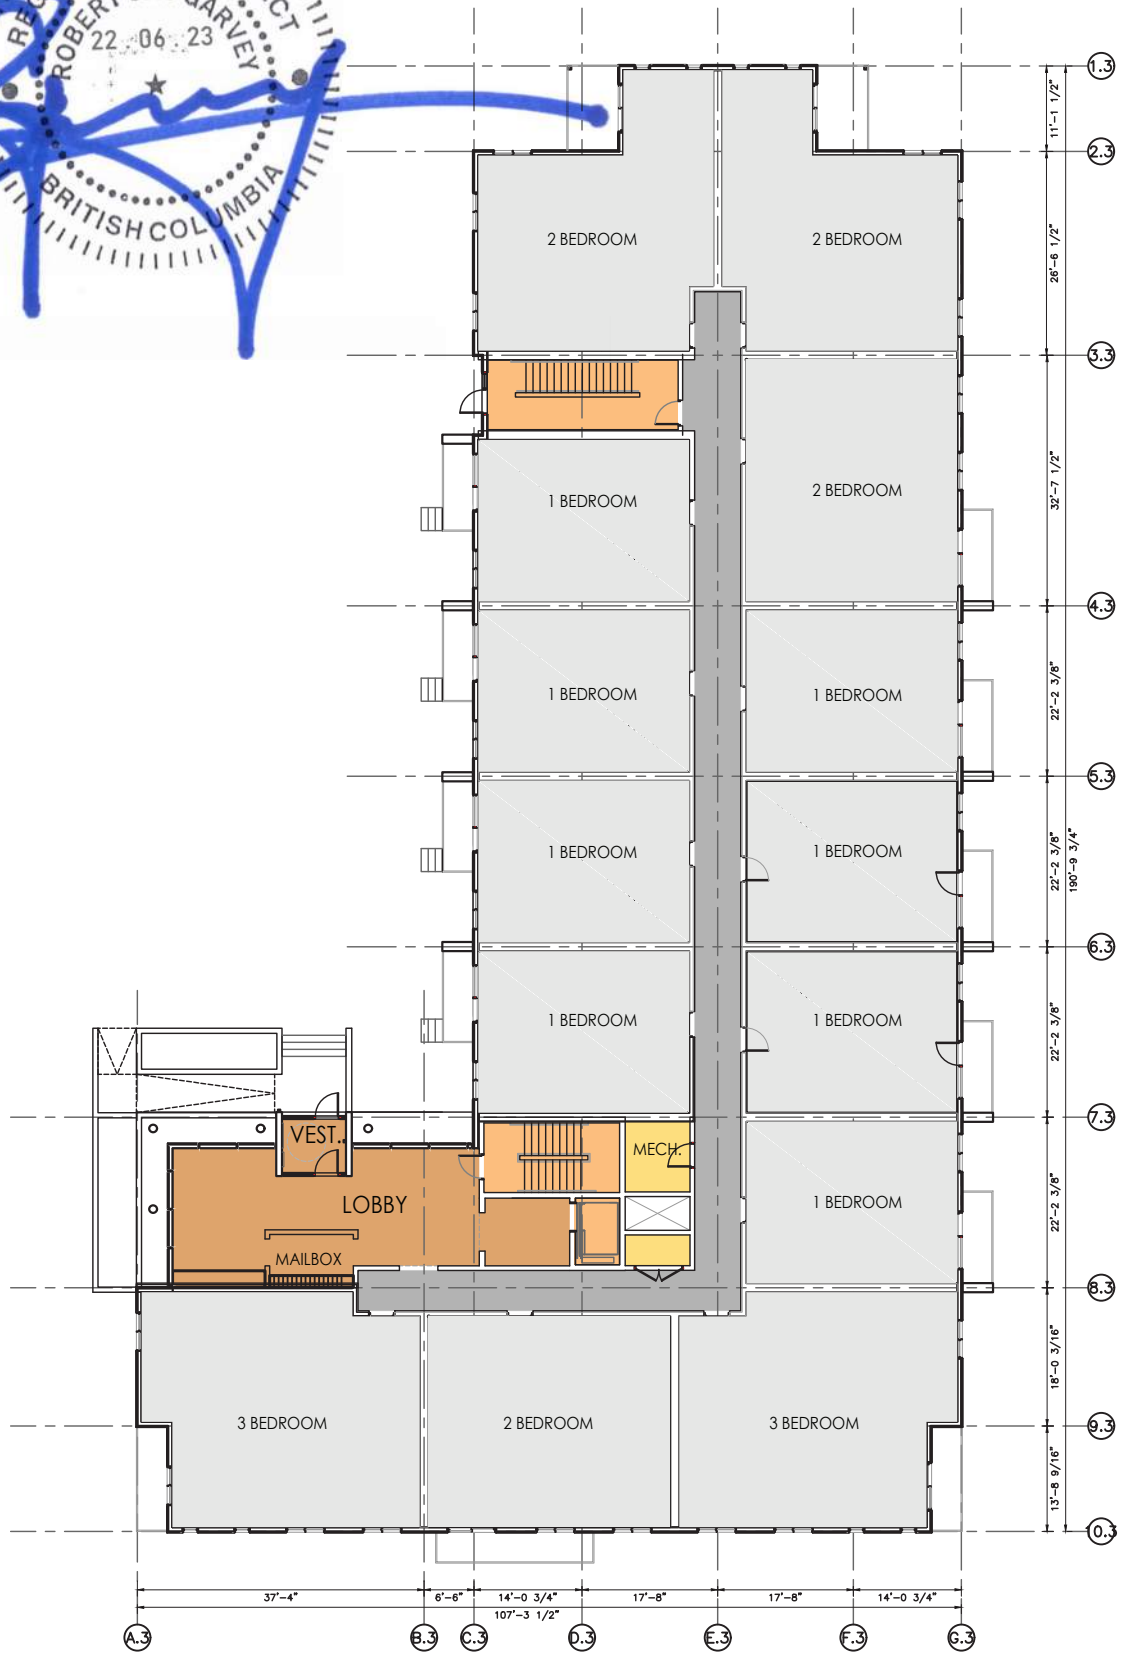

BUILDING 3 MAIN FLOOR PLAN
 SCALE 1:300

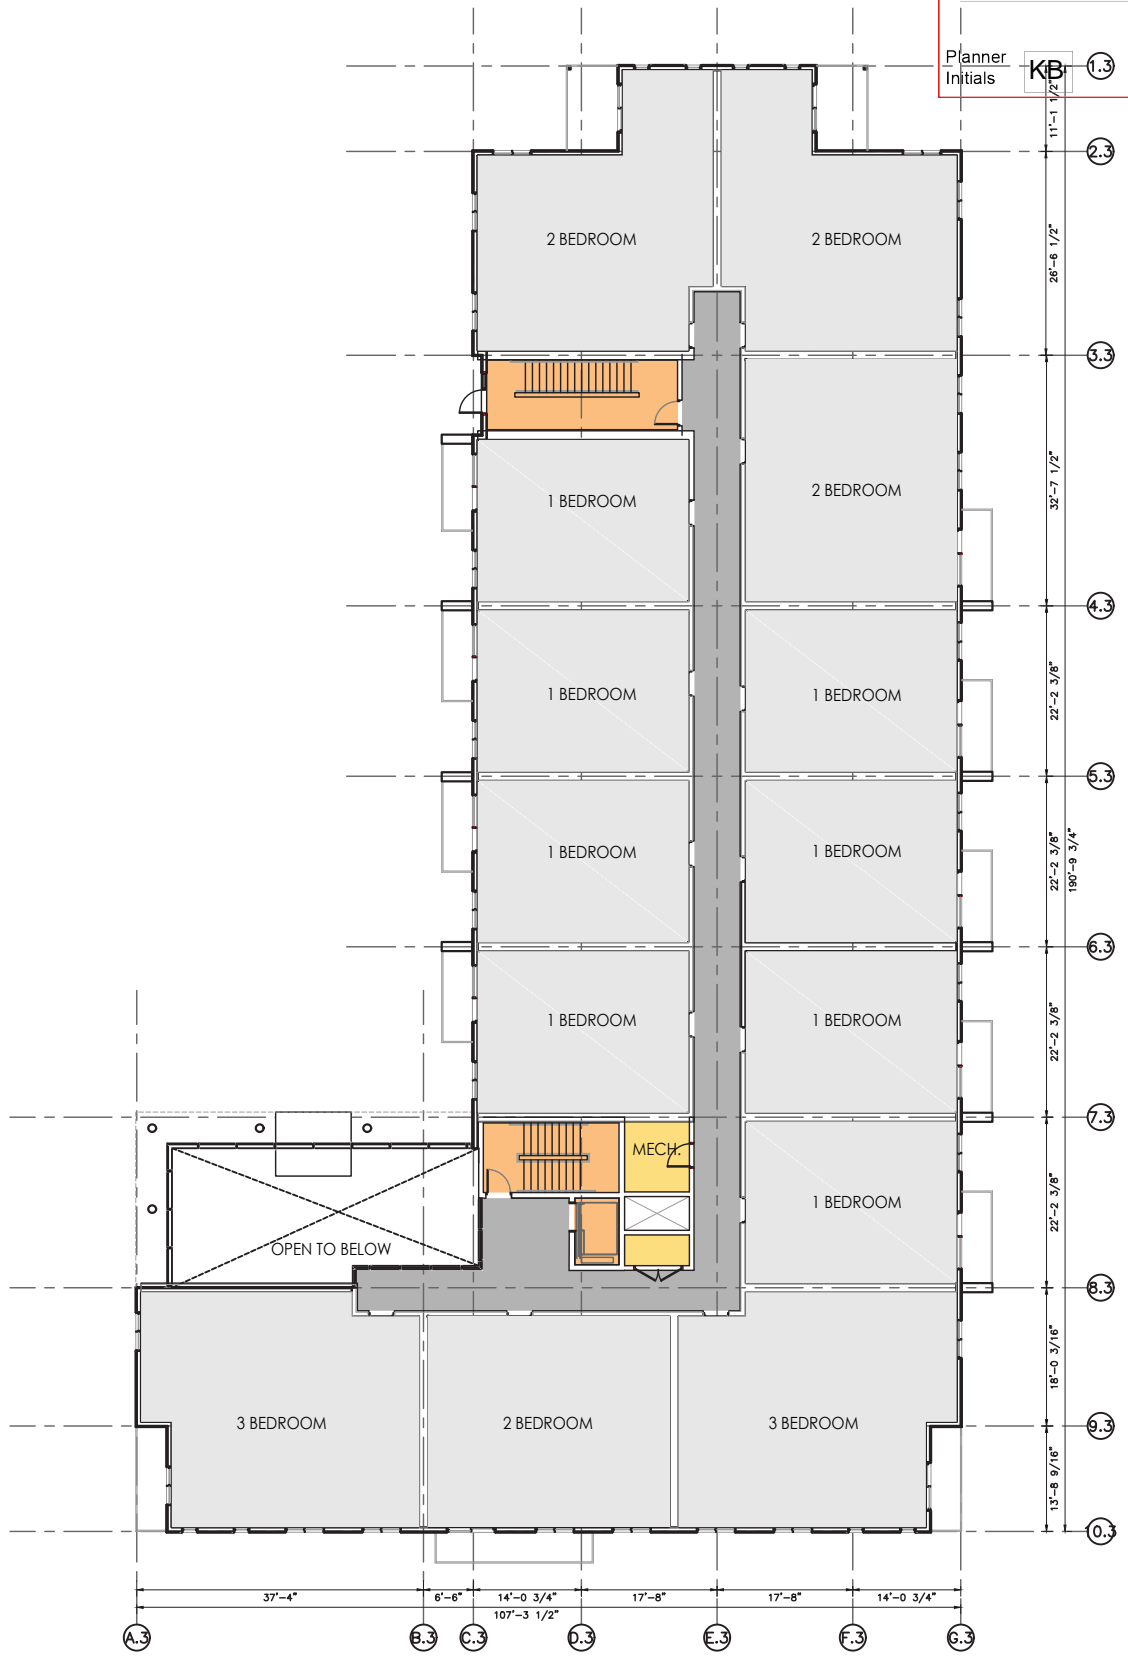

BUILDING 3 SECOND FLOOR PLAN
 SCALE 1:300





SCHEDULE B

This forms part of application
DP21-0231 DVP21-0232

Planner Initials **KB**

City of **Kelowna**
DEVELOPMENT PLANNING

Ironclad Developments Inc.

Project Management
General Contracting
Design/ Build

101-57158
Symington Rd.
Springfield, MB
R2J 4L6


PH:
204-777-1972
info@icdev.ca

IRONCLAD DEVELOPMENTS INC.

Consultant

ROB J.S. GARVEY, ARCHITECT
MAA, AIBC, LEED AP

201-57158 SYMINGTON RD 20E
SPRINGFIELD, MB R2J 4L6
T: 204.227.9274
E: RGARVEY@A77.CA

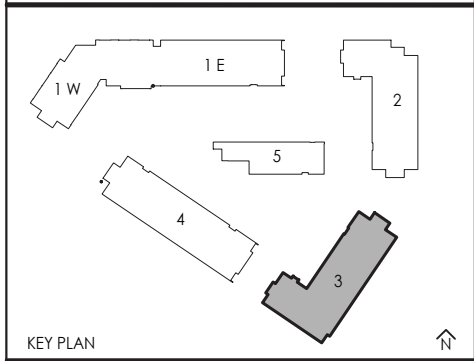

- AMENITIES
- ROOFTOP PATIOS
- COMMERCIAL
- SUPPORTING SPACES
- SUITES
- LOBBY/ENTRANCE AREA
- CORRIDOR
- VERTICAL COMMUNICATION

REV.	DESCRIPTION OF WORK REVISED	DATE

2241 SPRINGFIELD ROAD;
Kelowna BC.

BUILDING THREE
TYPICAL (3-5) AND SIXTH
FLOOR PLAN


Project Number: 2102

04-30-2020	Rev Date 06-06-2022
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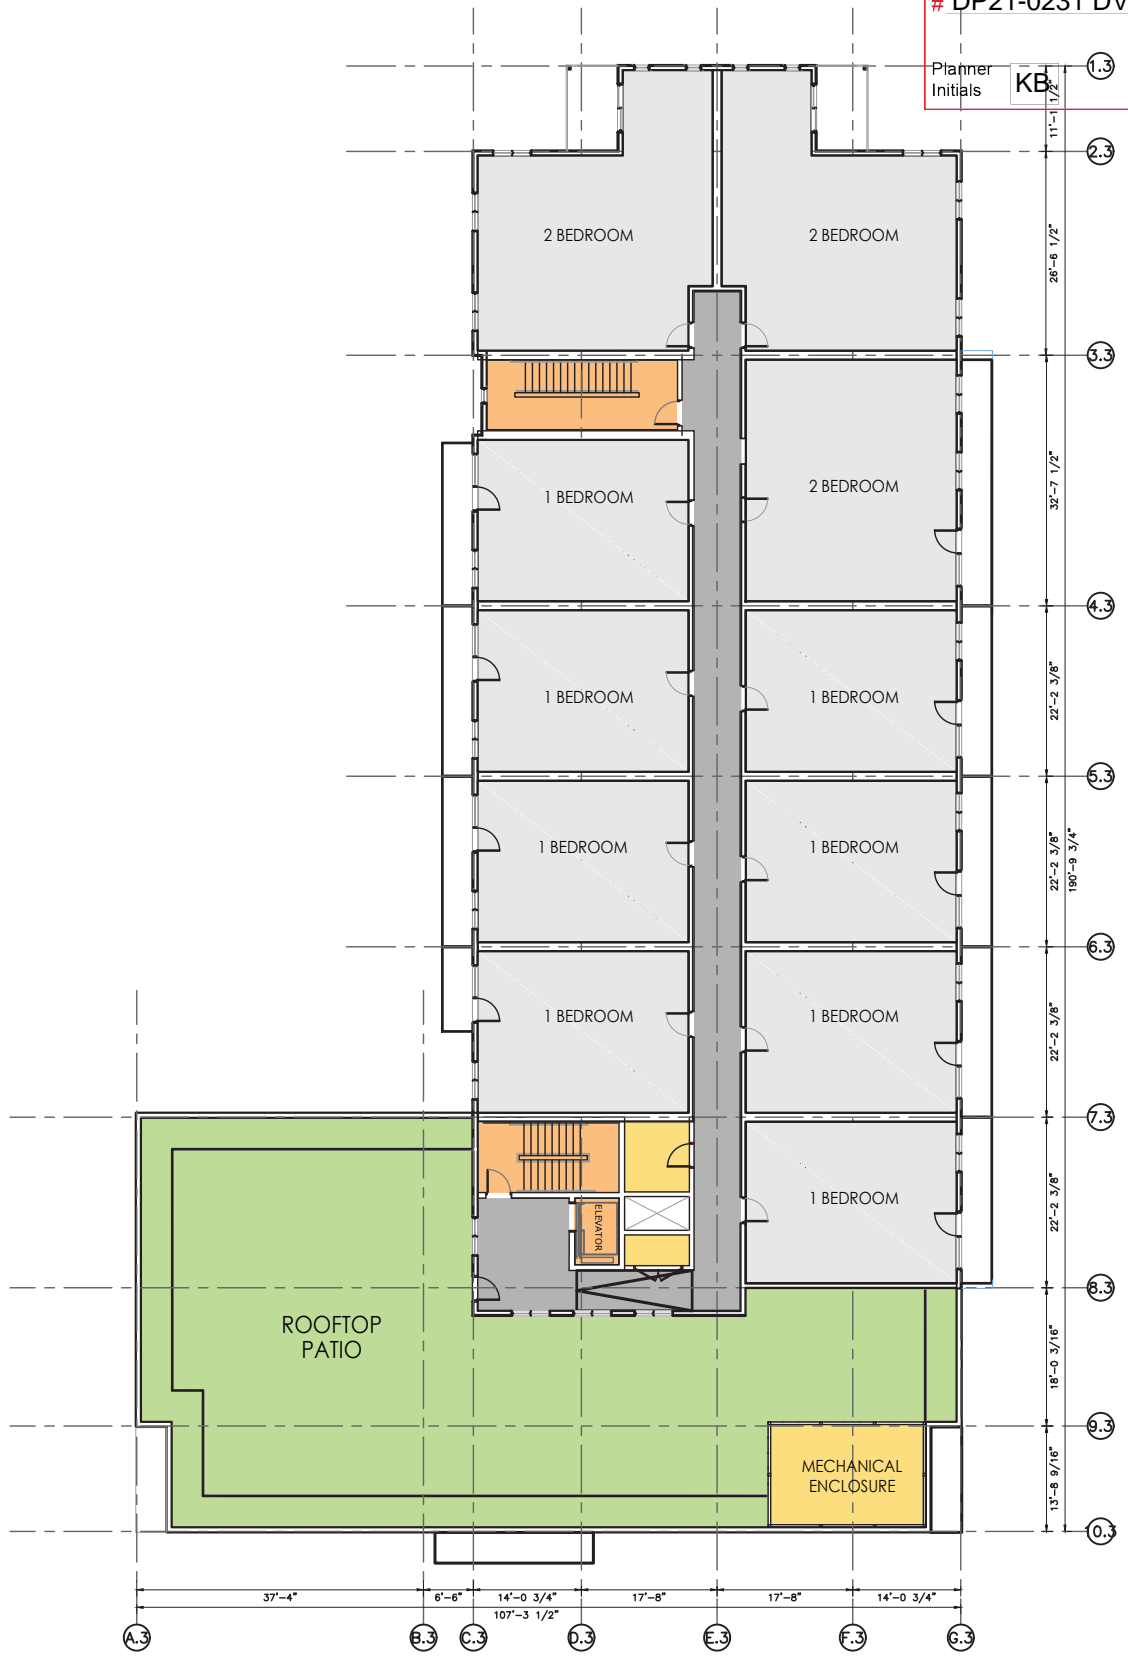
Drawn By T.THIMM
Designed By T.THIMM
Checked By R.GARVEY

ESP-3.31

Scale 1:300

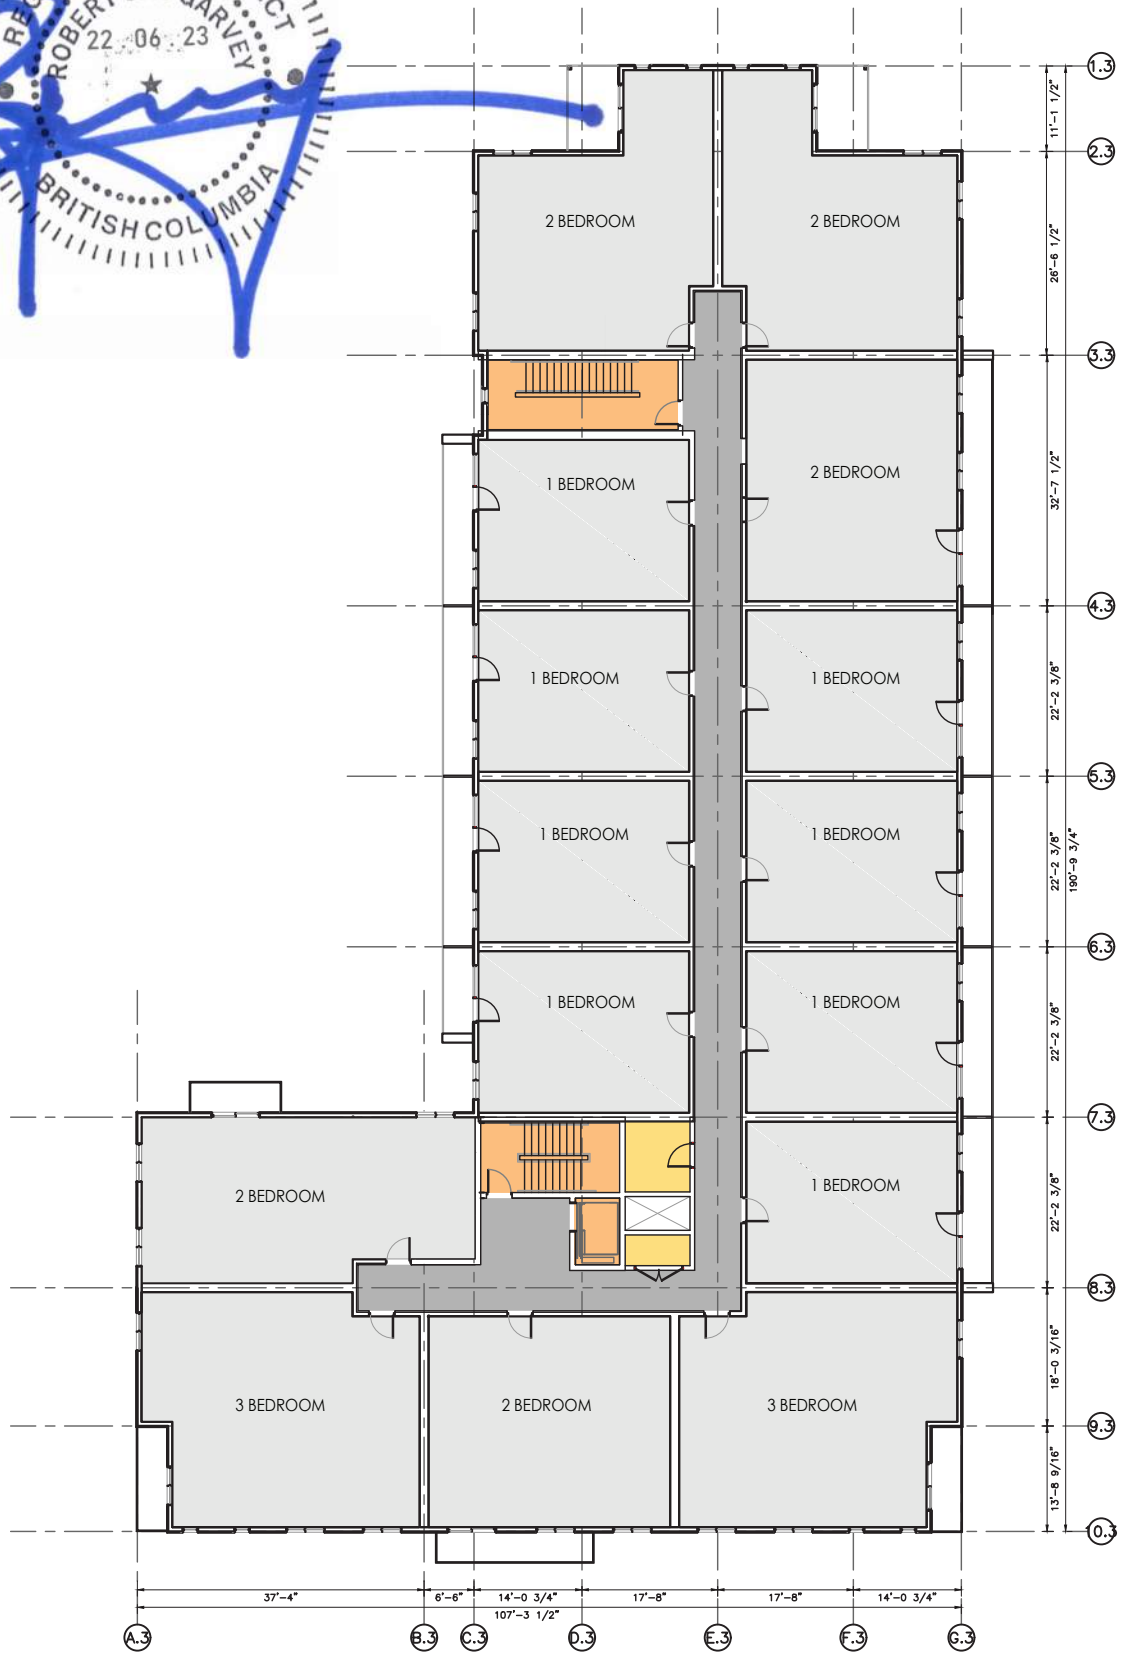

BUILDING 3 TYPICAL PLAN
SCALE 1:300



BUILDING 3 SIXTH FLOOR PLAN
SCALE 1:300



SCHEDULE B

This forms part of application
 # DP21-0231 DVP21-0232

Planner Initials **KB**

City of **Kelowna**
 DEVELOPMENT PLANNING

Ironclad Developments Inc.



Project Management
 General Contracting
 Design/ Build

101-57158
 Symington Rd.
 Springfield, MB.
 R2J 4L6

PH:
204-777-1972

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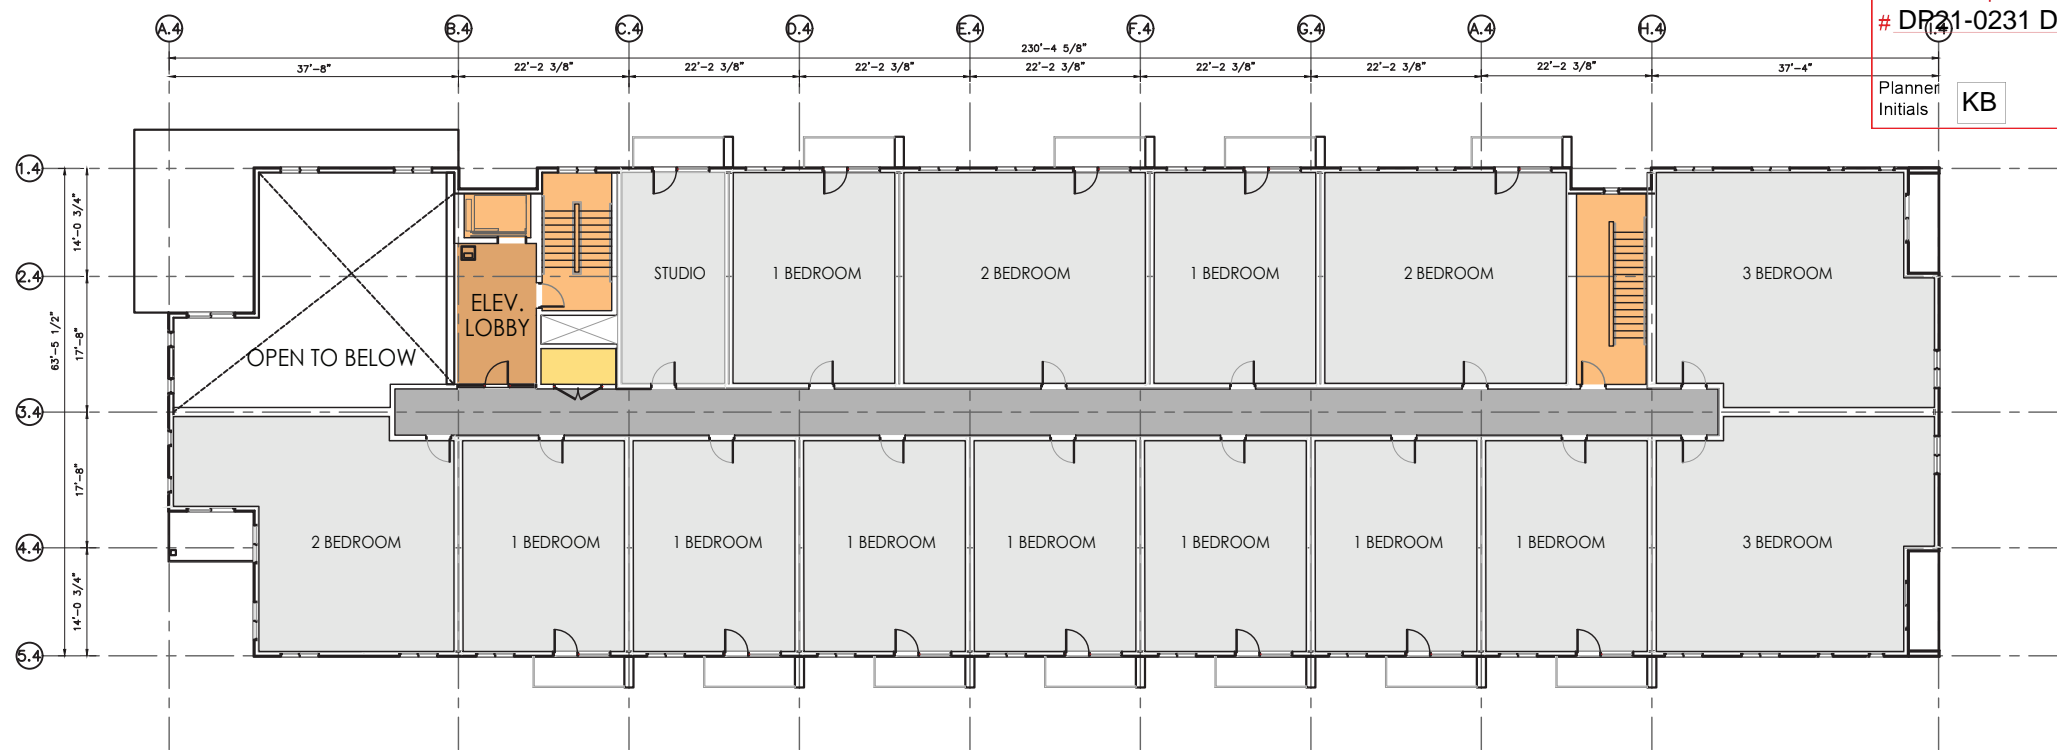
IRONCLAD DEVELOPMENTS INC.

Consultant




ROB J.S. GARVEY, ARCHITECT
 MAA, AIBC, LEED AP


201-57158 SYMINGTON RD 20E
 SPRINGFIELD, MB R2J 4L6
 T: 204.227.9274
 E: RGARVEY@A77.CA



BUILDING 4 SECOND FLOOR PLAN
 SCALE 1:300

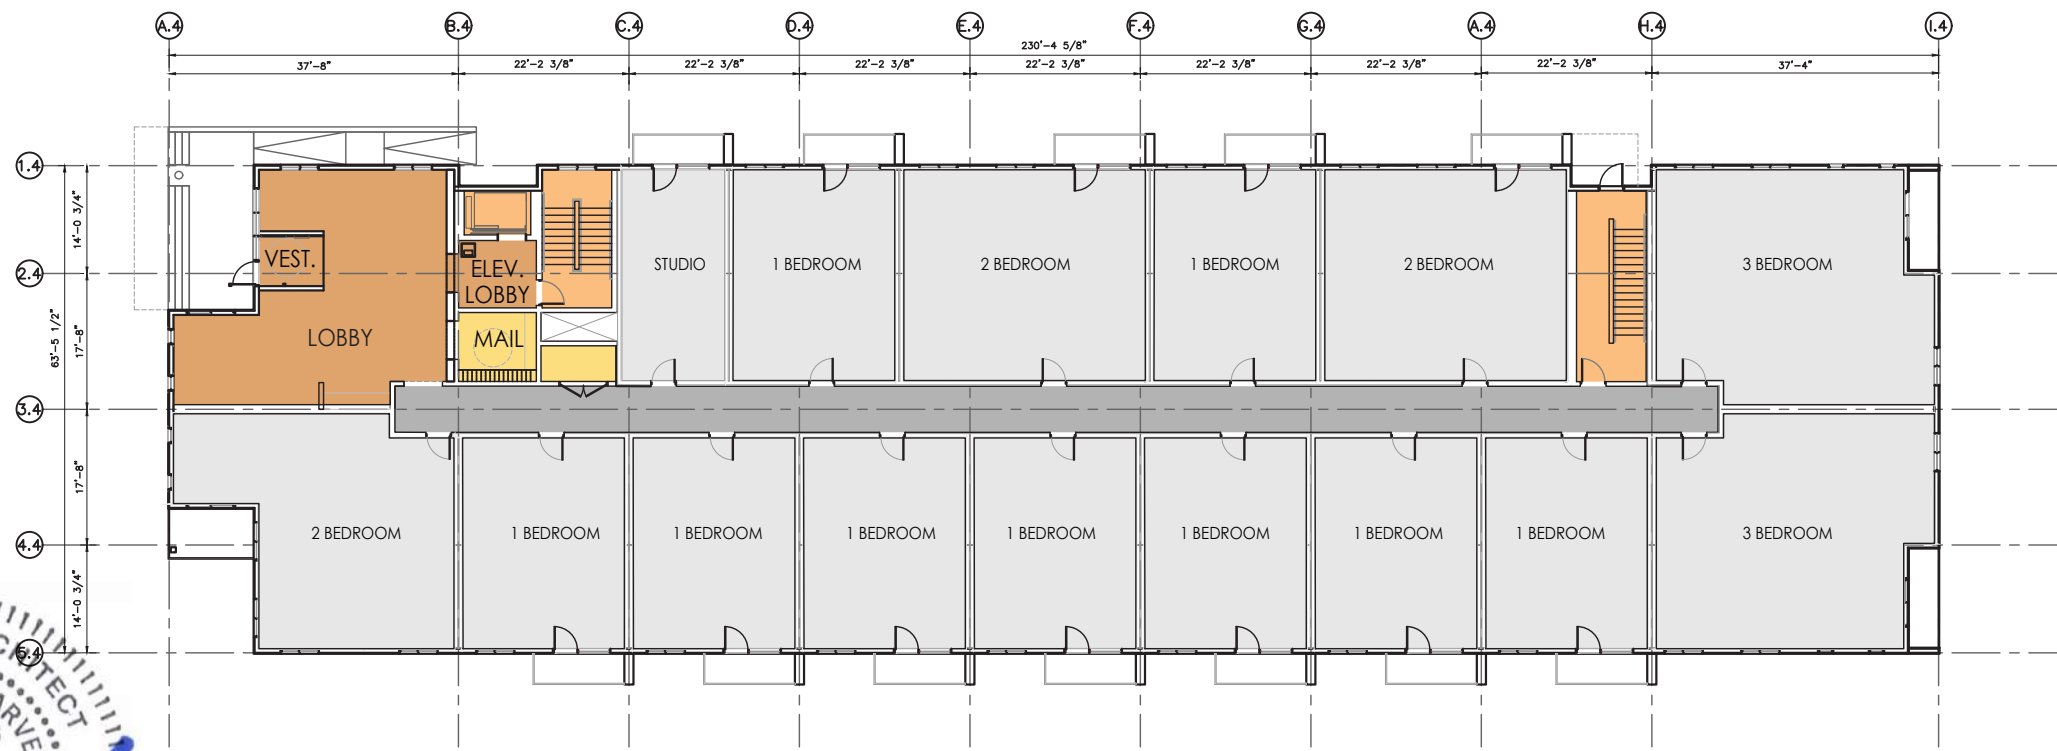

BUILDING 4 MAIN FLOOR PLAN
 SCALE 1:300

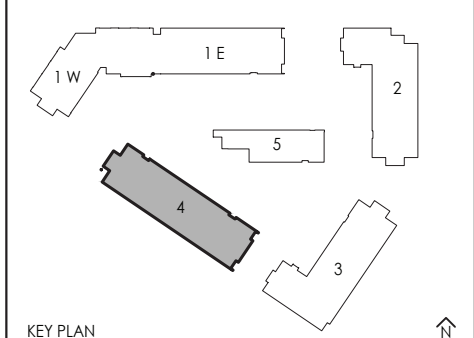

- AMENITIES
- ROOFTOP PATIOS
- COMMERCIAL
- SUPPORTING SPACES
- SUITES
- LOBBY/ENTRANCE AREA
- CORRIDOR
- VERTICAL COMMUNICATION

REV.	DESCRIPTION OF WORK REVISED	DATE

2241 SPRINGFIELD ROAD;
 Kelowna BC.


**BUILDING FOUR
 MAIN AND SECOND FLOOR
 PLAN**

Project Number: 2102

04-30-2020	Rev Date 06-06-2022
Drawn By T.THIMM	Designed By T.THIMM
Checked By R.GARVEY	

ESP-3.40

Scale 1:300

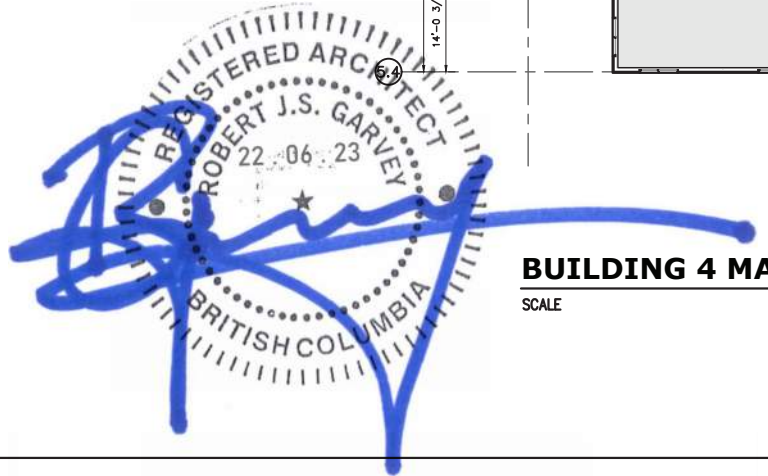

SCHEDULE B

This forms part of application
 # DP21-0231 DVP21-0232

Planner Initials **KB**

City of Kelowna
 DEVELOPMENT PLANNING

Ironclad Developments Inc.



Project Management
 General Contracting
 Design/ Build

101-57158
 Symington Rd.
 Springfield, MB.
 R2J 4L6

PH:
 204-777-1972

info@icdev.ca


IRONCLAD DEVELOPMENTS INC.

Consultant




ROB J.S. GARVEY, ARCHITECT
 MAA, AIBC, LEED AP


201-57158 SYMINGTON RD 20E
 SPRINGFIELD, MB R2J 4L6
 T: 204.227.9274
 E: RGARVEY@A77.CA

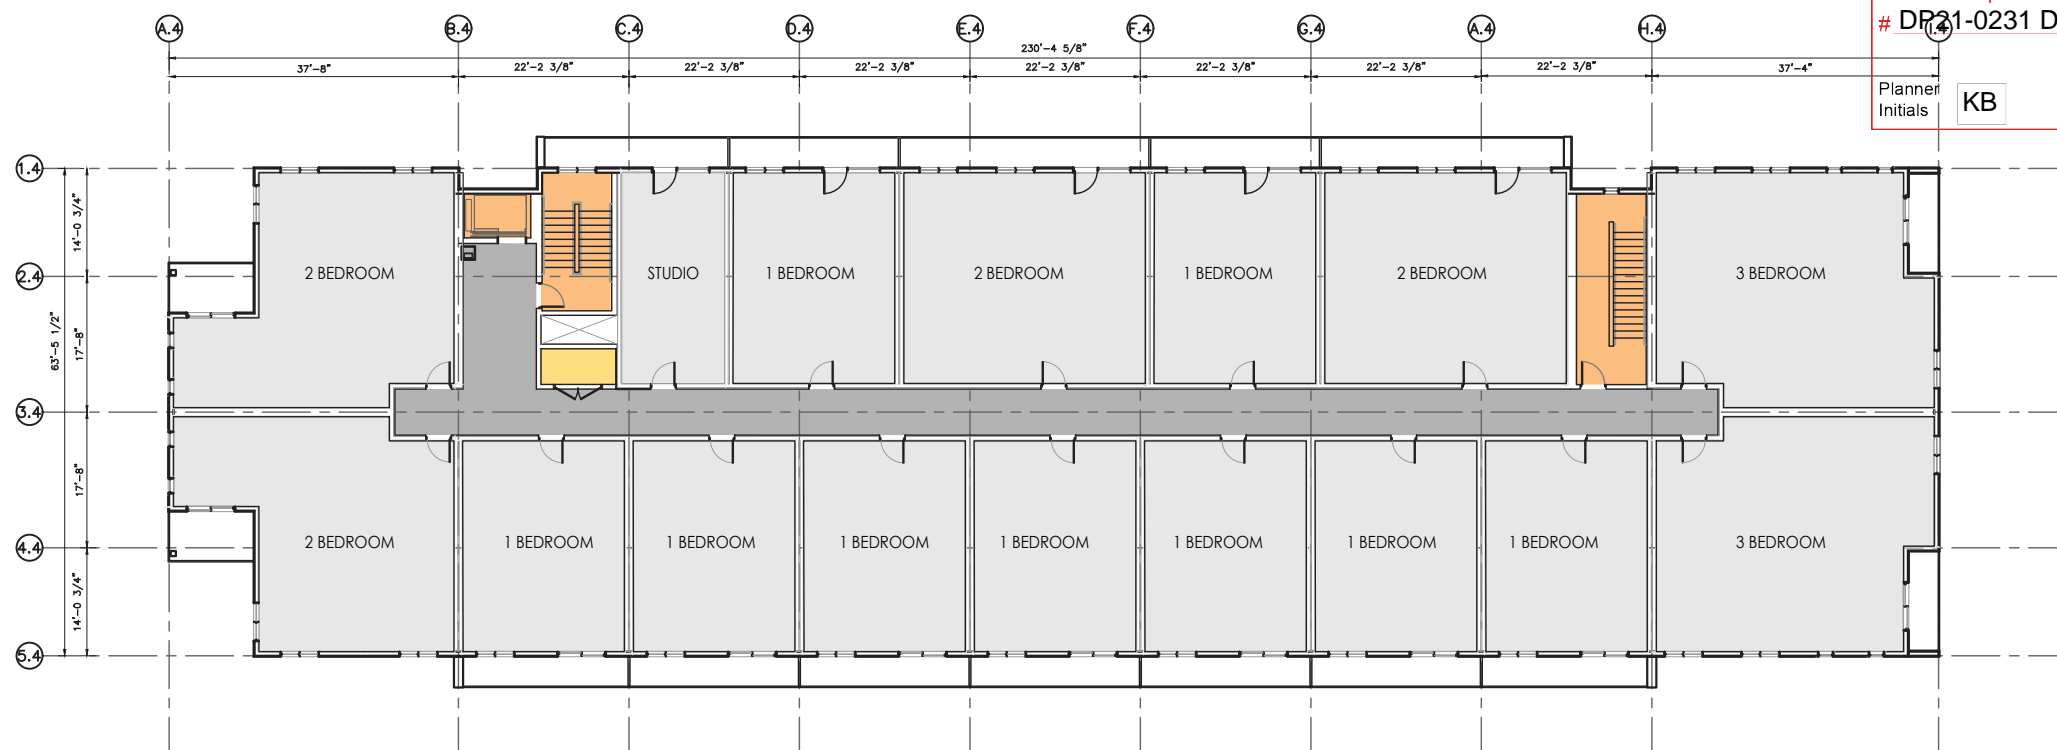




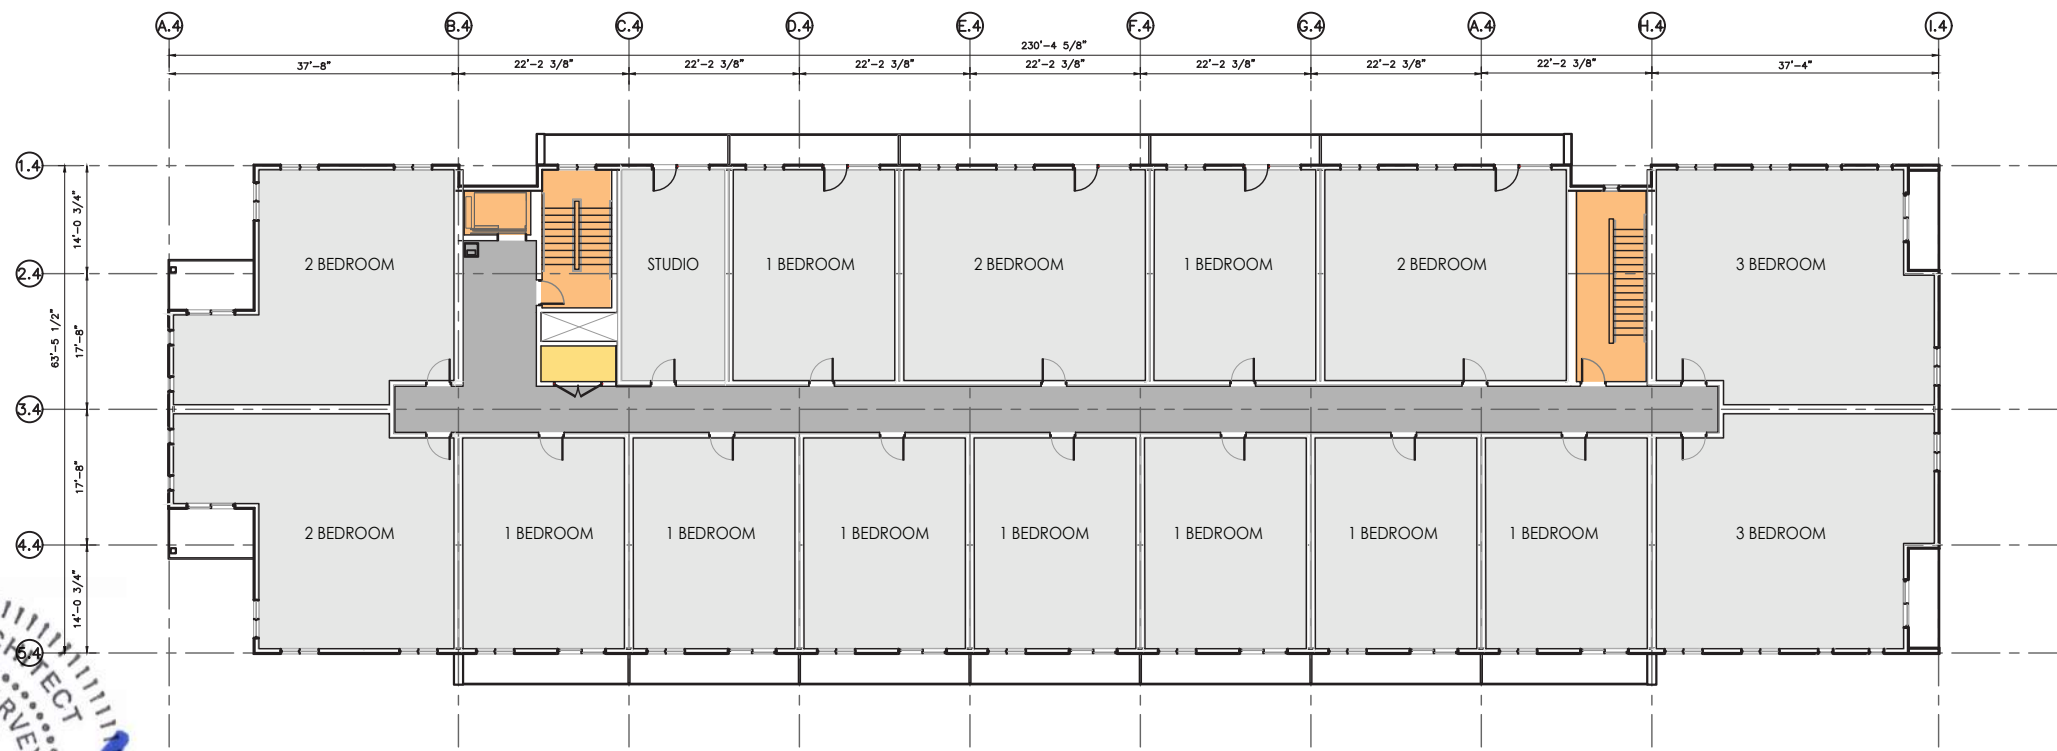


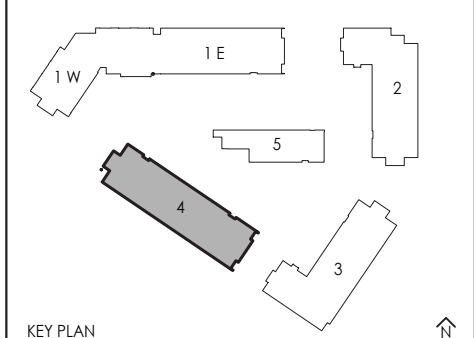

BUILDING 4 FIFTH FLOOR PLAN
 SCALE 1:300

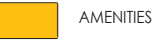

BUILDING 4 TYPICAL FLOOR PLAN
 SCALE 1:300

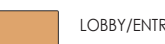

-  AMENITIES
-  ROOFTOP PATIOS
-  COMMERCIAL
-  SUPPORTING SPACES
-  SUITES
-  LOBBY/ENTRANCE AREA
-  CORRIDOR
-  VERTICAL COMMUNICATION

REV.	DESCRIPTION OF WORK REVISED	DATE


2241 SPRINGFIELD ROAD;
 Kelowna BC.

BUILDING FOUR
 TYPICAL (3-4) AND FIFTH
 FLOOR PLAN

Project Number: 2004	06-06-2022
04-30-2020	Rev Date
Drawn By	T.THIMM
Designed By	T.THIMM
Checked By	R.GARVEY

ESP-3.41

Scale 1:300

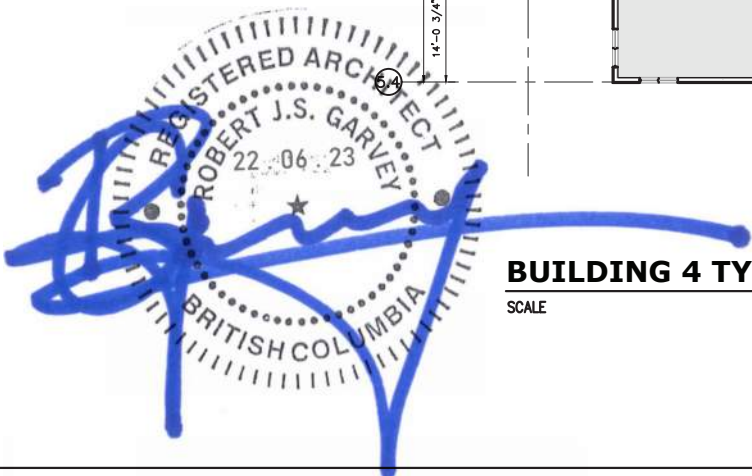

SCHEDULE B

This forms part of application
DP21-0231 DVP21-0232

Planner Initials **KB**

City of **Kelowna**
DEVELOPMENT PLANNING

Ironclad Developments Inc.



Project Management
General Contracting
Design/ Build

101-57158
Symington Rd.
Springfield, MB.
R2J 4L6

PH:
204-777-1972

info@icdev.ca


IRONCLAD DEVELOPMENTS INC.

Consultant




ROB J.S. GARVEY, ARCHITECT
MAA, AIBC, LEED AP

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T: 204.227.9274
E: RGARVEY@A77.CA

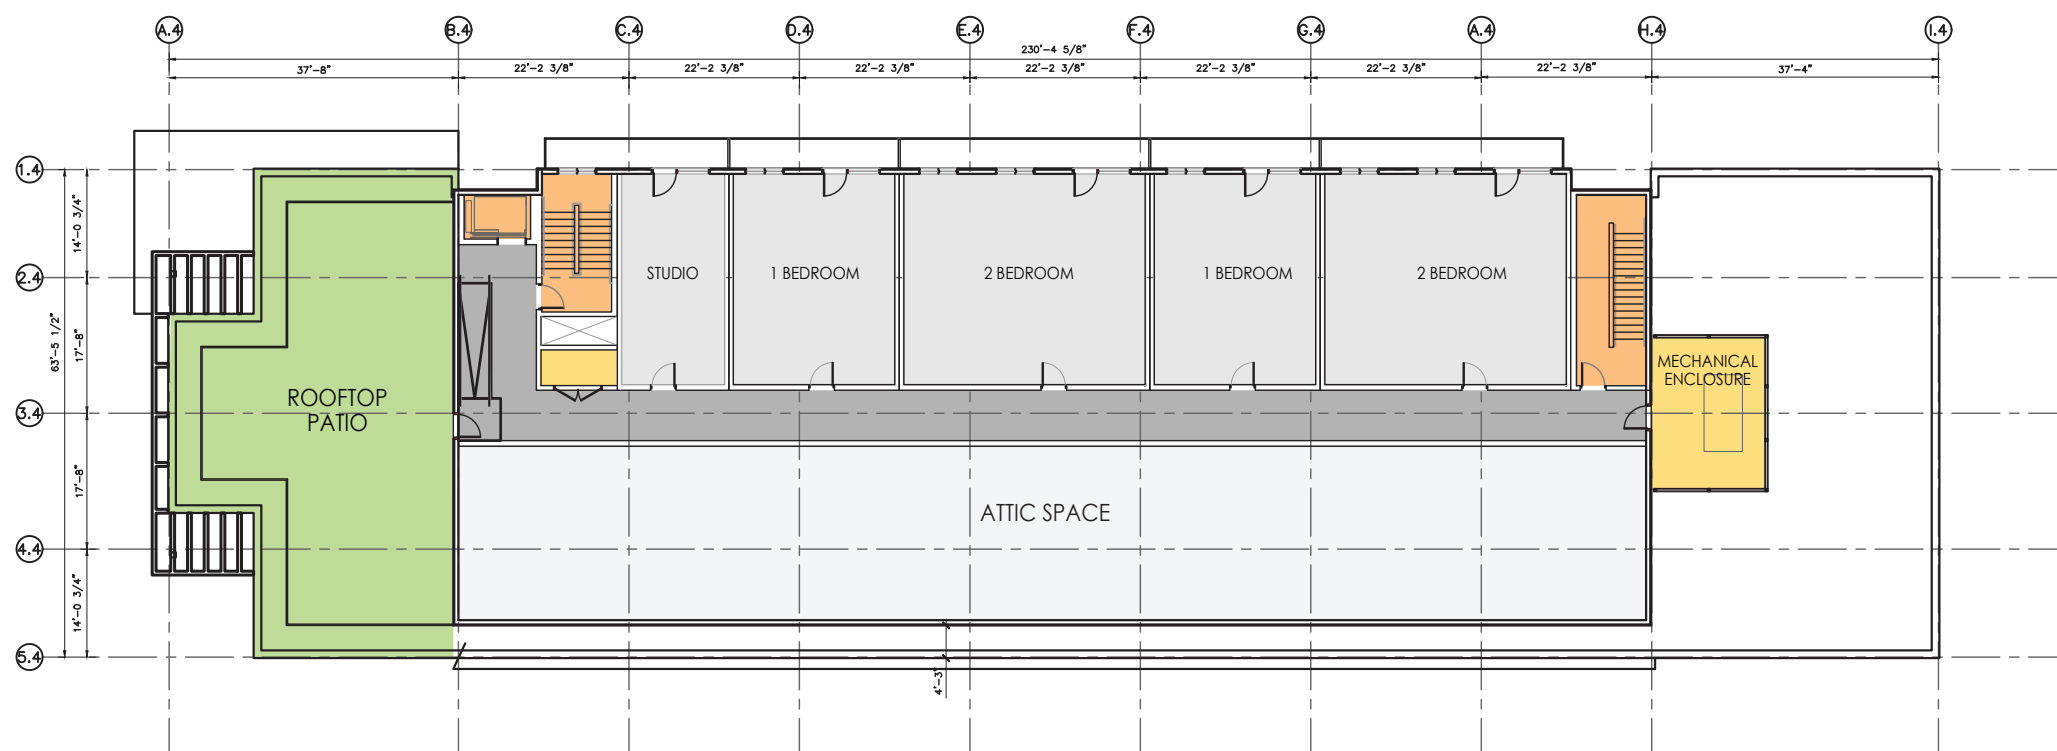

BUILDING 4 SIXTH FLOOR PLAN
SCALE 1:300

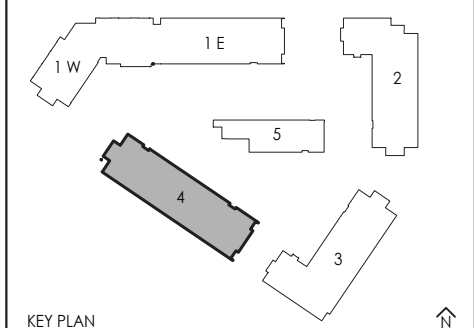

- KEY PLAN
- AMENITIES
 - ROOFTOP PATIOS
 - COMMERCIAL
 - SUPPORTING SPACES
 - SUITES
 - LOBBY/ENTRANCE AREA
 - CORRIDOR
 - VERTICAL COMMUNICATION

REV.	DESCRIPTION OF WORK REVISED	DATE

2241 SPRINGFIELD ROAD;
Kelowna BC.


BUILDING FOUR
SIXTH
FLOOR PLAN


Project Number: 2102

04-30-2020	Rev Date 06-06-2022
Drawn By	T.THIMM
Designed By	T.THIMM
Checked By	R.GARVEY

ESP-3.42


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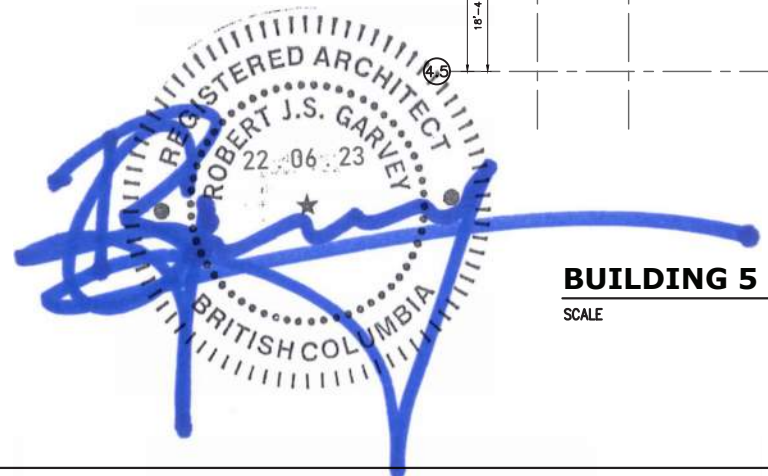
BUILDING 5 SECOND FLOOR PLAN

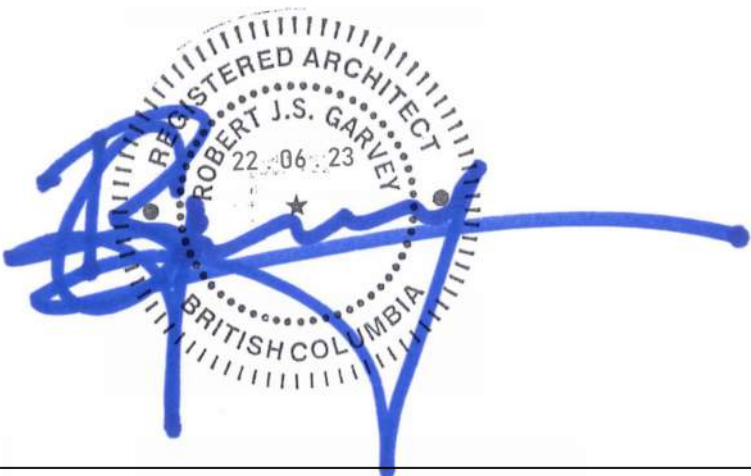SCALE 1:300

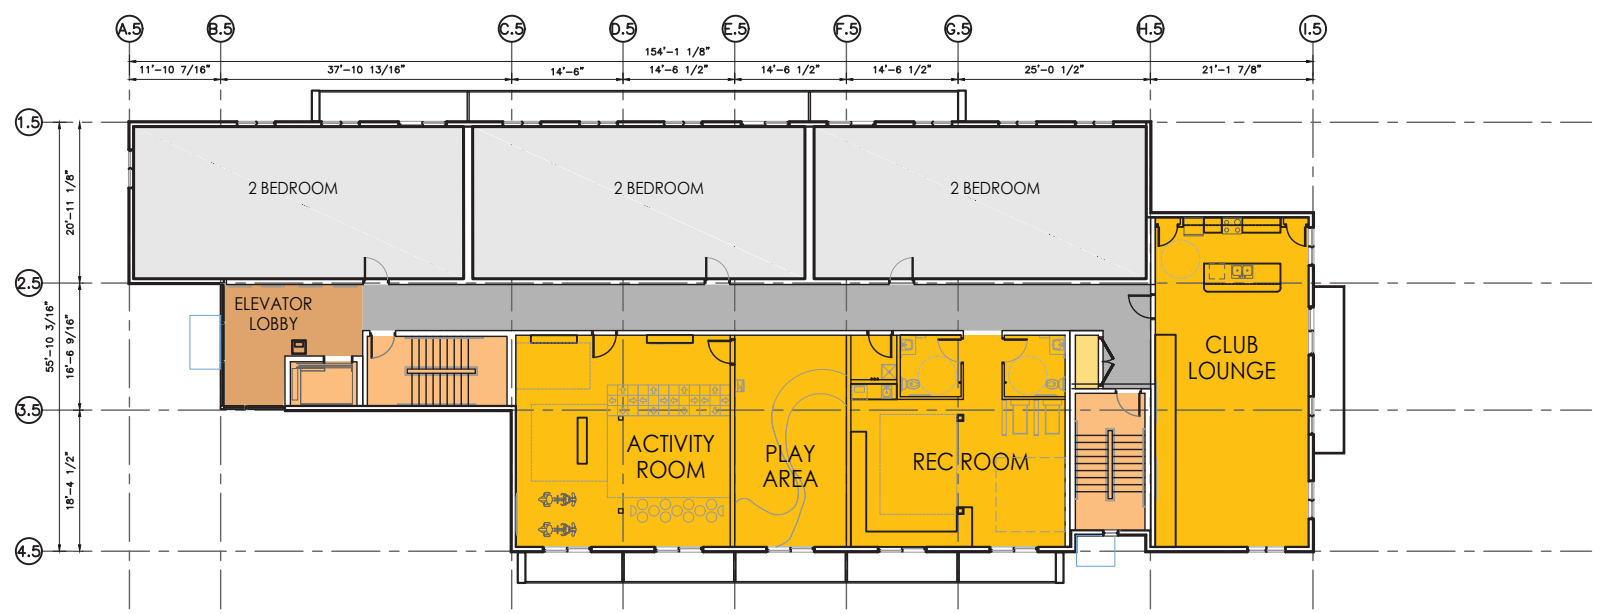

BUILDING 5 MAIN FLOOR PLAN

SCALE 1:300

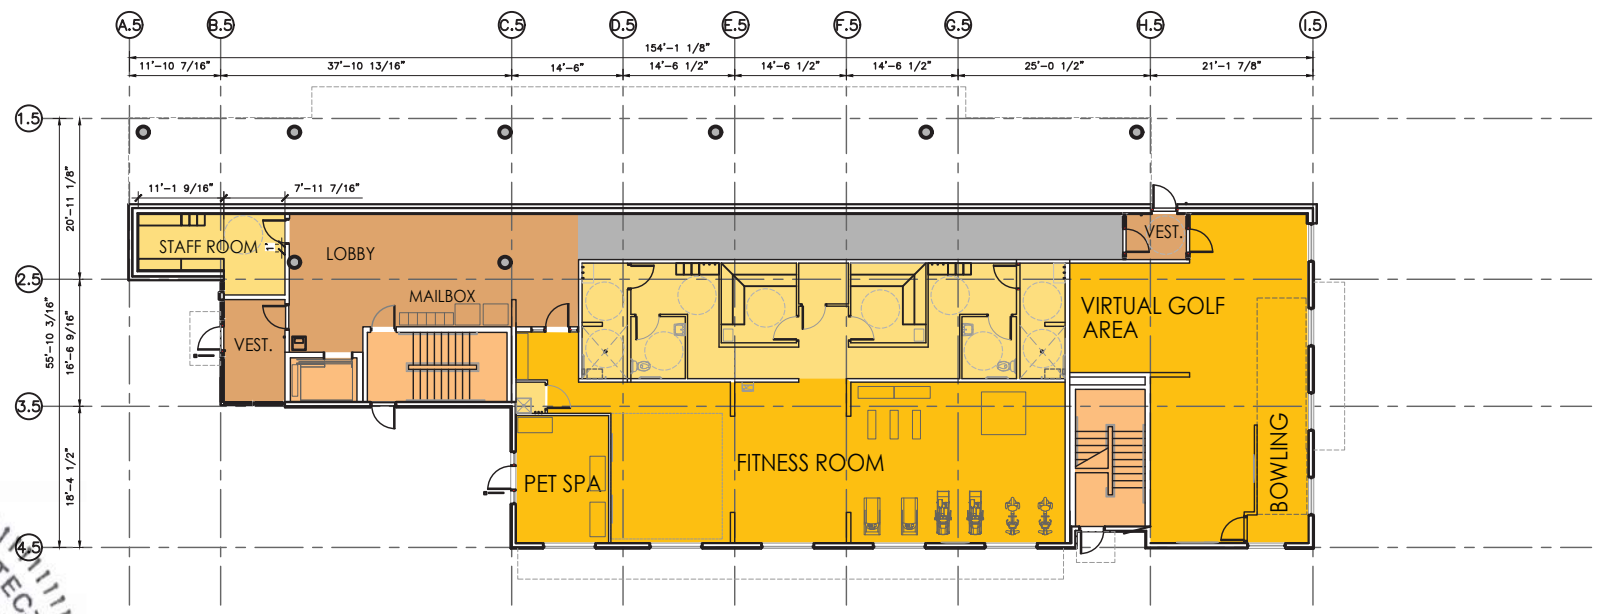

SCHEDULE B

This forms part of application
DP21-0231 DVP21-0232

Planner Initials **KB**

City of **Kelowna**
DEVELOPMENT PLANNING

Ironclad Developments Inc.

Project Management
General Contracting
Design/ Build

101-57158
Symington Rd.
Springfield, MB
R2J 4L6


PH:
204-777-1972

info@icdev.ca

Consultant

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MAA, AIBC, LEED AP

201-57158 SYMINGTON RD 20E
SPRINGFIELD, MB R2J 4L6
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E: RGARVEY@A77.CA

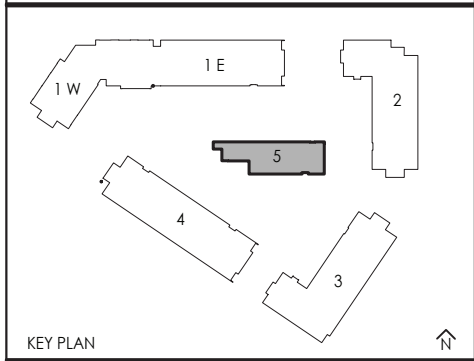

	AMENITIES		ROOFTOP PATIOS
	COMMERCIAL		SUPPORTING SPACES
	SUITES		LOBBY/ENTRANCE AREA
	CORRIDOR		VERTICAL COMMUNICATION

REV.	DESCRIPTION OF WORK REVISED	DATE

2241 SPRINGFIELD ROAD;
Kelowna BC.

BUILDING FIVE
MAIN AND SECOND
FLOOR PLAN

Project Number: 2102

04-30-2020	Rev Date 06-06-2022
Drawn By T.THIMM	Designed By T.THIMM
Checked By R.GARVEY	

ESP-3.50

Scale 1:300



SCHEDULE B

This forms part of application
DP21-0231 DVP21-0232

Planner Initials **KB**

City of **Kelowna**
DEVELOPMENT PLANNING

Ironclad Developments Inc.



Project Management
General Contracting
Design/ Build

101-57158
Symington Rd.
Springfield, MB
R2J 4L6

PH:
204-777-1972

info@icdev.ca


IRONCLAD DEVELOPMENTS INC.

Consultant




ROB J.S. GARVEY, ARCHITECT
MAA, AIBC, LEED AP



201-57158 SYMINGTON RD 20E
SPRINGFIELD, MB R2J 4L6
T: 204.227.9274
E: RGARVEY@A77.CA

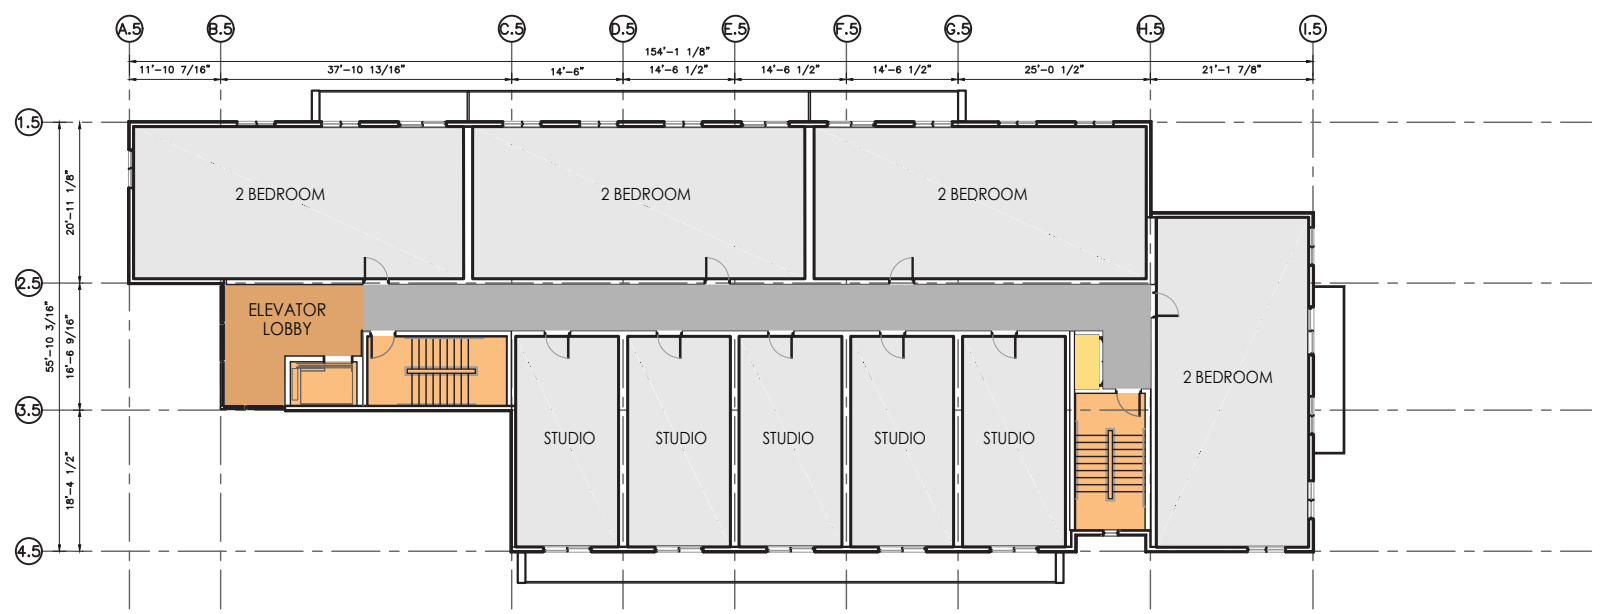

BUILDING 5 FOURTH FLOOR PLAN
SCALE 1:300

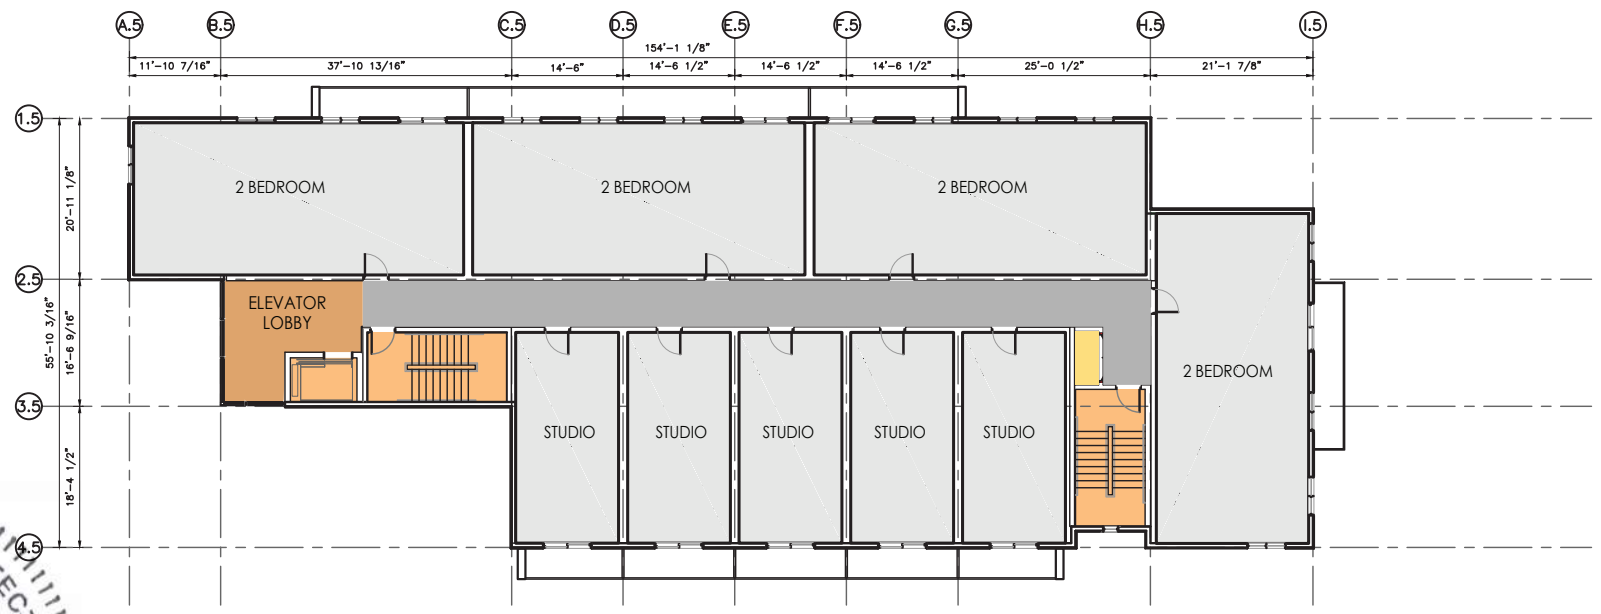

BUILDING 5 THIRD FLOOR PLAN
SCALE 1:300

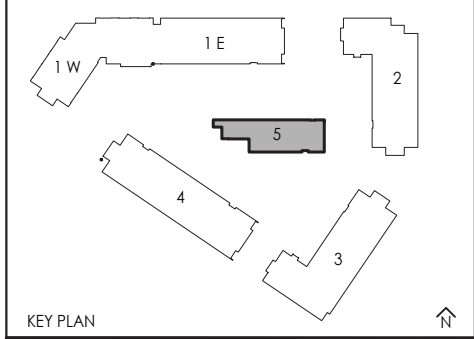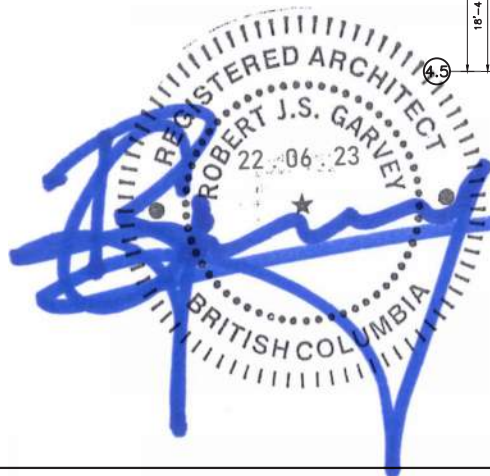

- AMENITIES
- ROOFTOP PATIOS
- COMMERCIAL
- SUPPORTING SPACES
- SUITES
- LOBBY/ENTRANCE AREA
- CORRIDOR
- VERTICAL COMMUNICATION

REV.	DESCRIPTION OF WORK REVISED	DATE

2241 SPRINGFIELD ROAD;
Kelowna BC.

**BUILDING FIVE
THIRD AND FOURTH
FLOOR PLAN**

Project Number: 2102

04-30-2020	Rev Date 06-06-2022
Drawn By T.THIMM	Designed By T.THIMM
Checked By R.GARVEY	

ESP-3.51

Scale 1:300



SCHEDULE B

This forms part of application
DP21-0231 DVP21-0232

Planner Initials **KB**



Ironclad Developments Inc.



Project Management
General Contracting
Design/ Build

101-57158
Symington Rd.
Springfield, MB.
R2J 4L6

PH:
204-777-1972

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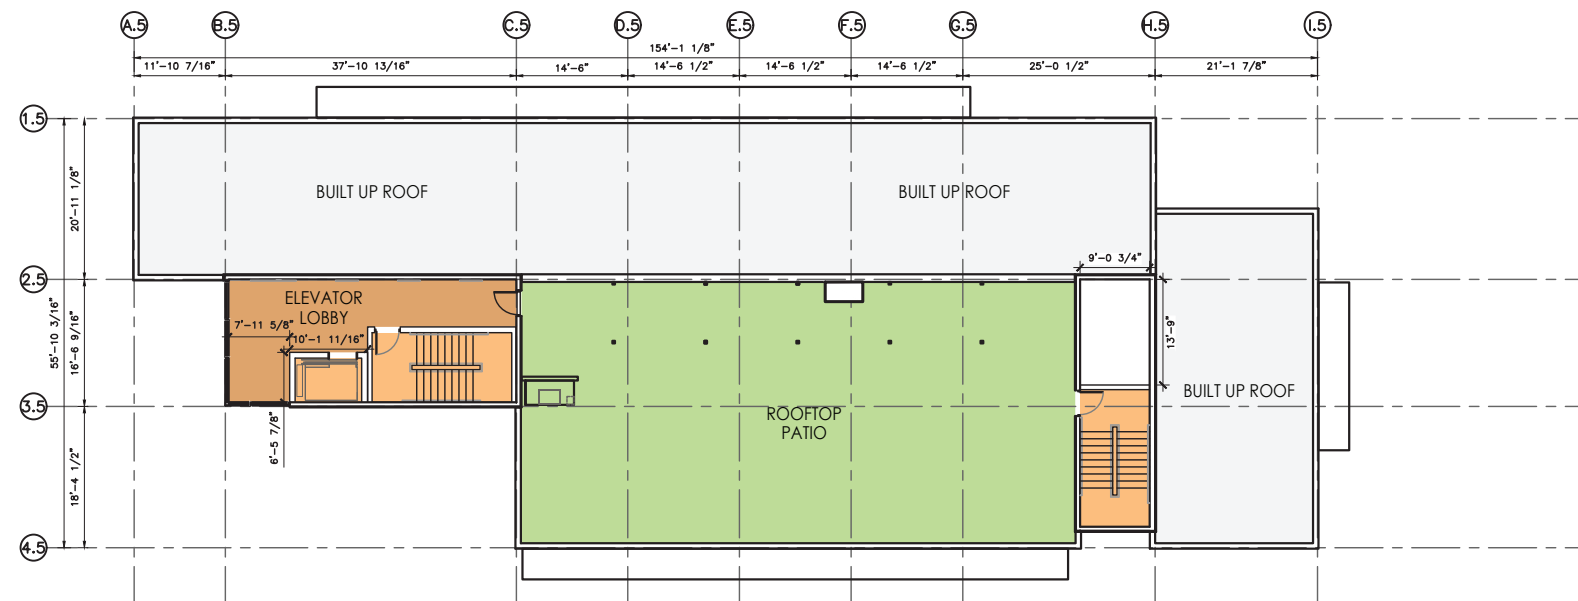
IRONCLAD DEVELOPMENTS INC.

Consultant




ROB J.S. GARVEY, ARCHITECT
MAA, AIBC, LEED AP

201-57158 SYMINGTON RD 20E
SPRINGFIELD, MB R2J 4L6
T: 204.227.9274
E: RGARVEY@A77.CA



BUILDING 5 FIFTH FLOOR PLAN

SCALE 1:300

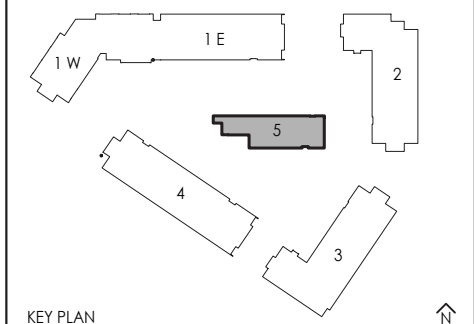

KEY PLAN

	AMENITIES		ROOFTOP PATIOS
	COMMERCIAL		SUPPORTING SPACES
	SUITES		LOBBY/ENTRANCE AREA
	CORRIDOR		VERTICAL COMMUNICATION

REV.	DESCRIPTION OF WORK REVISED	DATE

2241 SPRINGFIELD ROAD;
Kelowna BC.


**BUILDING FIVE
FIFTH FLOOR PLAN**

Project Number: 2102

04-30-2020	Rev Date 06-06-2022
Drawn By	T.THIMM
Designed By	T.THIMM
Checked By	R.GARVEY

ESP-3.52

Scale 1:300









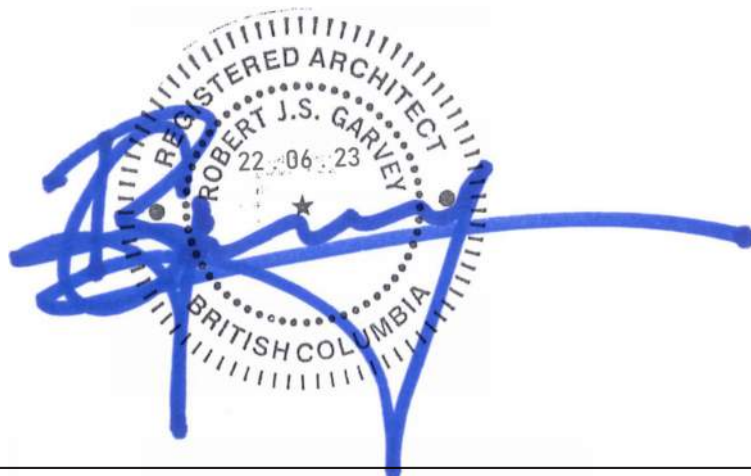


SCHEDULE B

This forms part of application
 # DP21-0231 DVP21-0232

Planner Initials **KB**

City of **Kelowna**
 DEVELOPMENT PLANNING

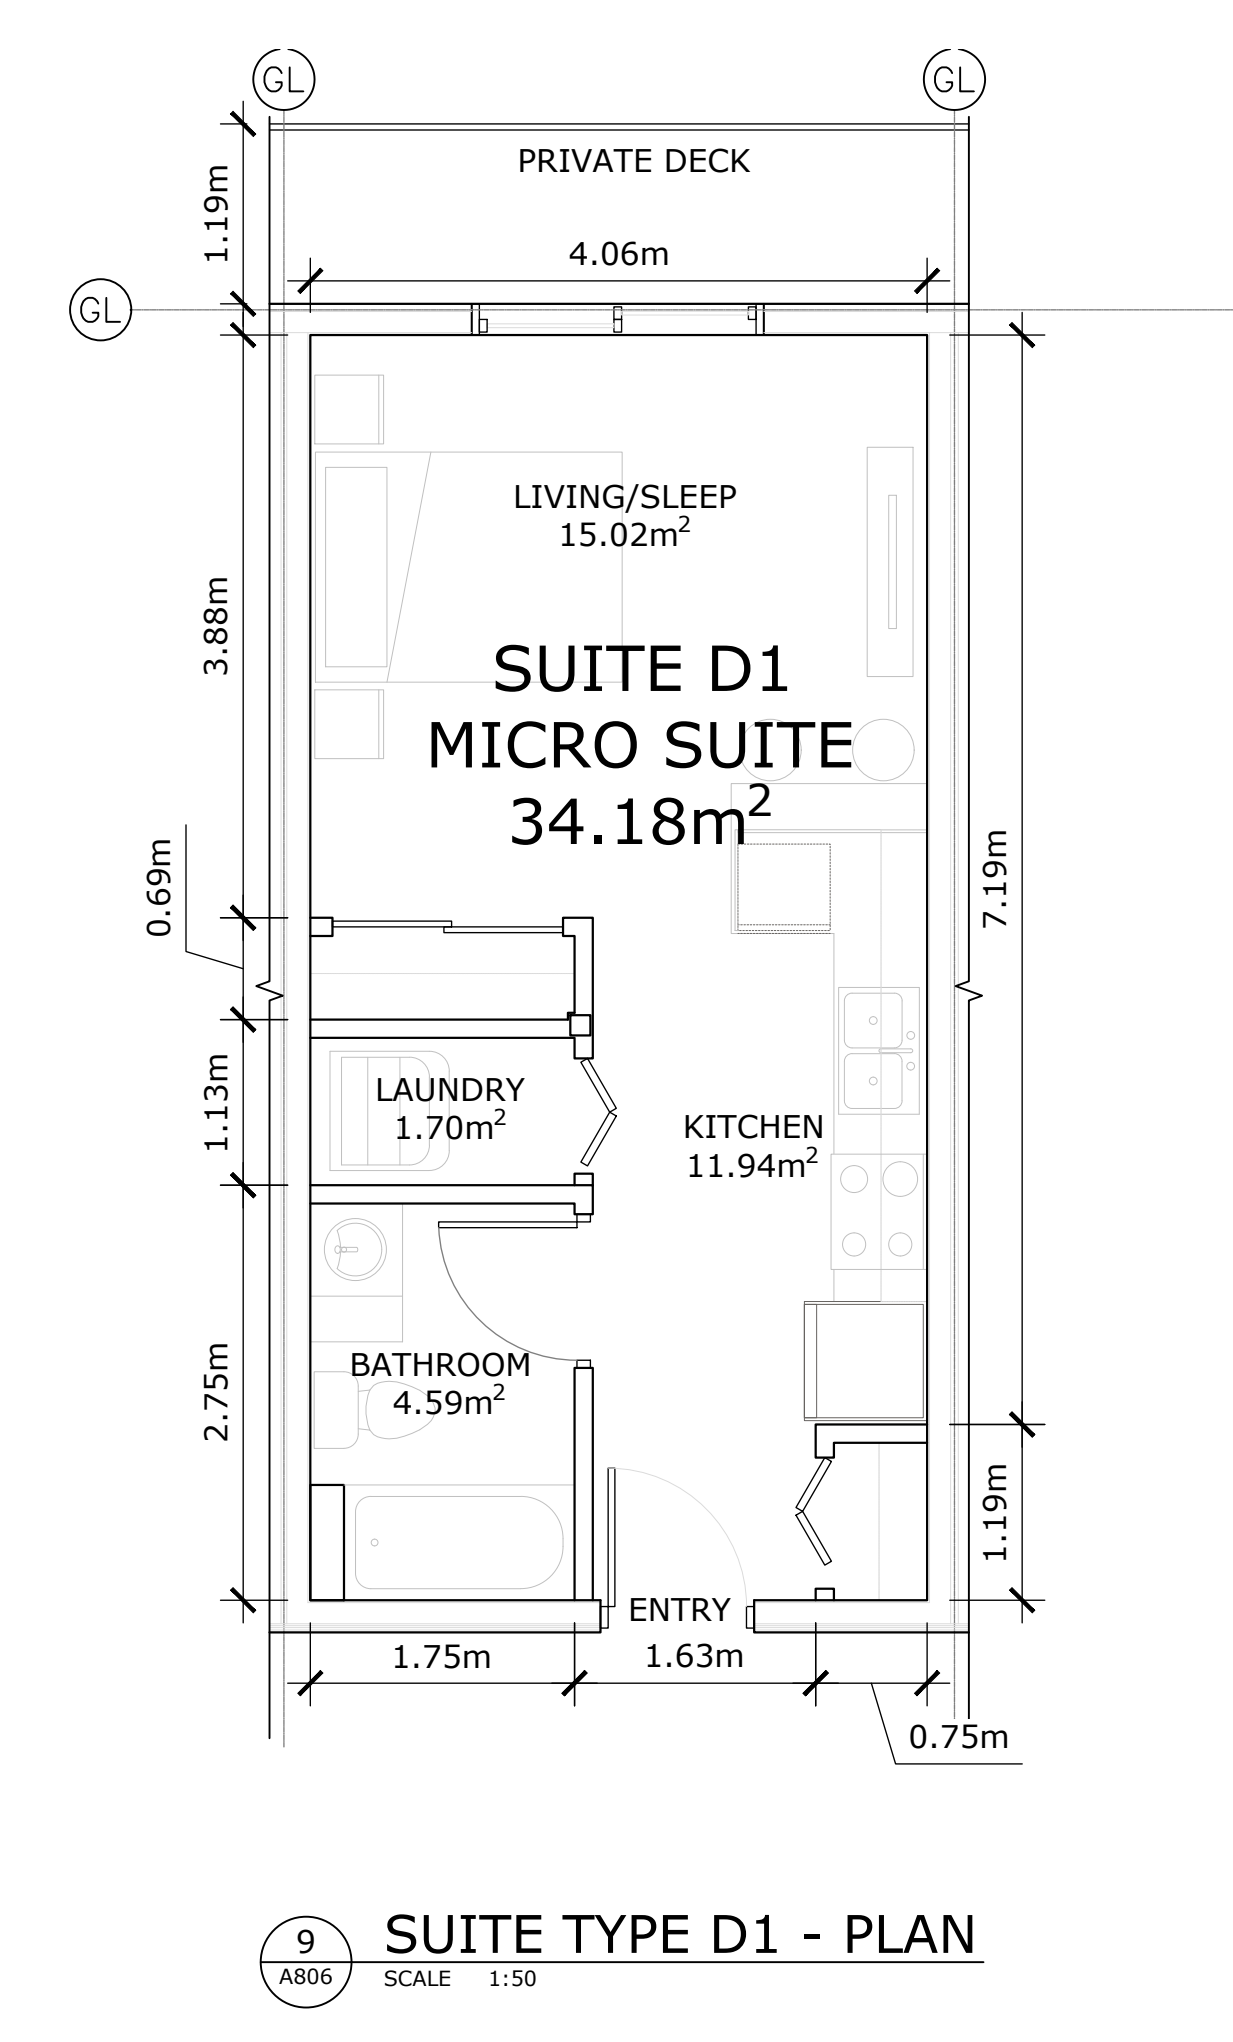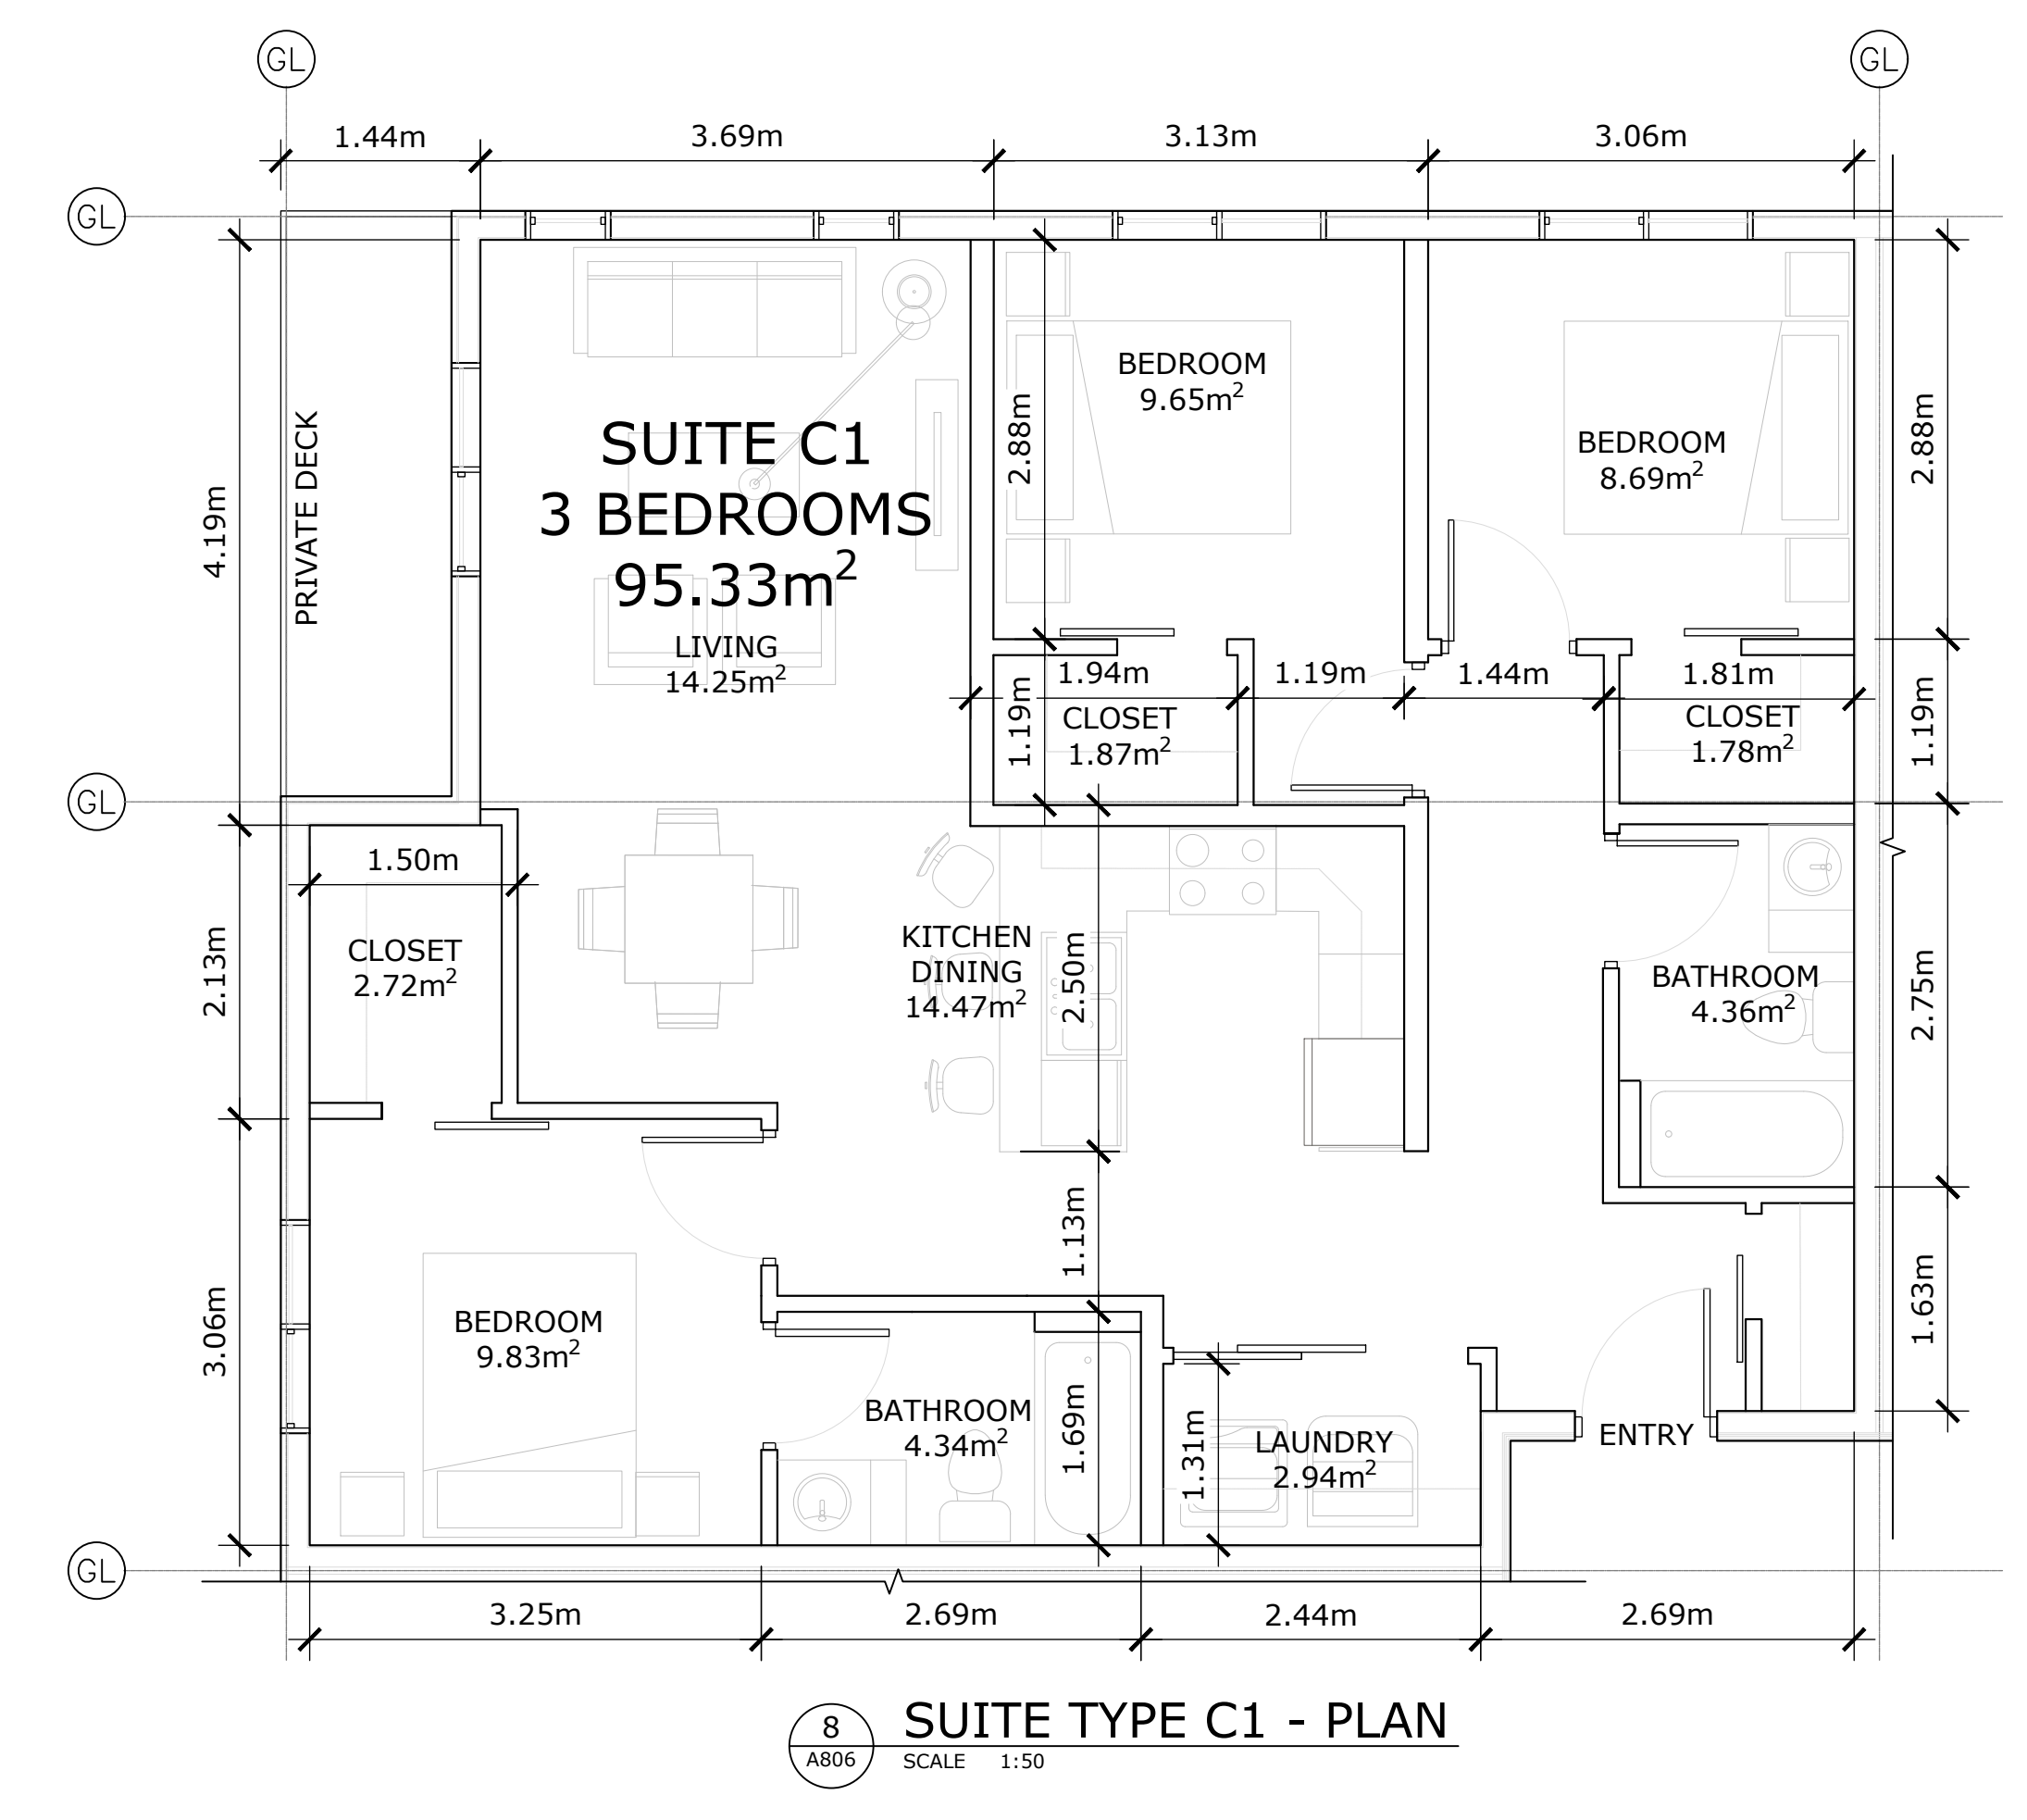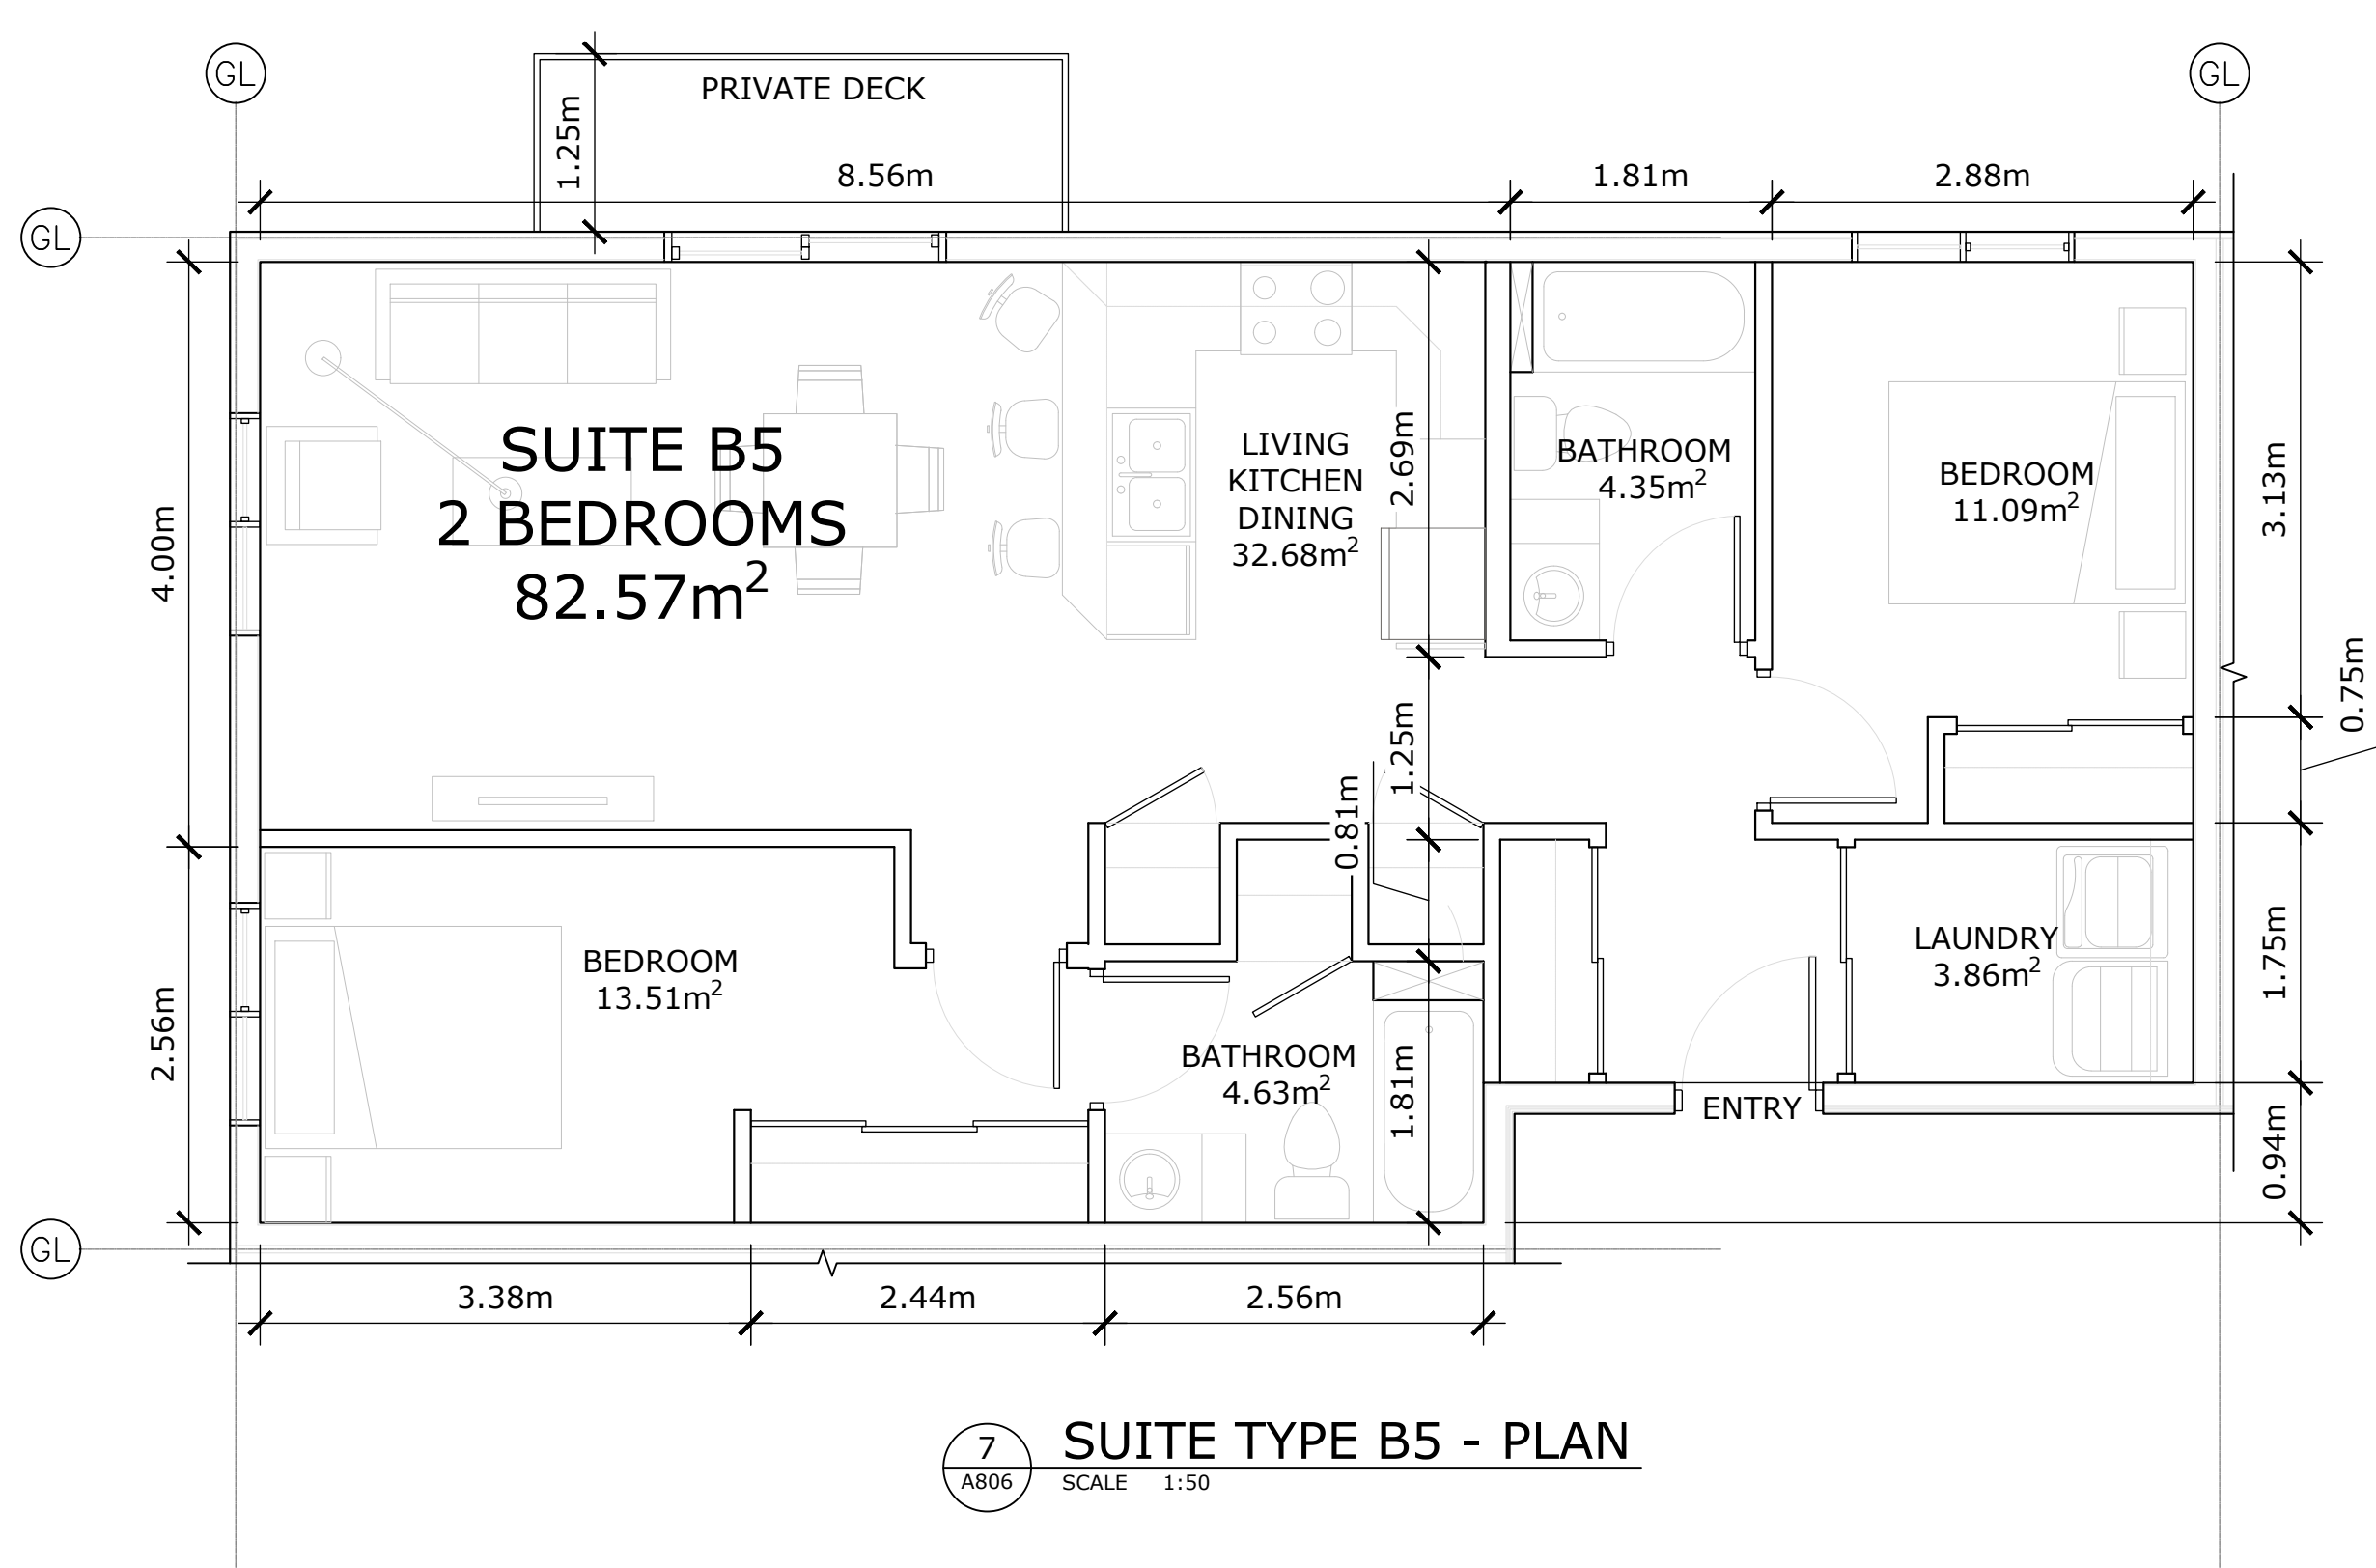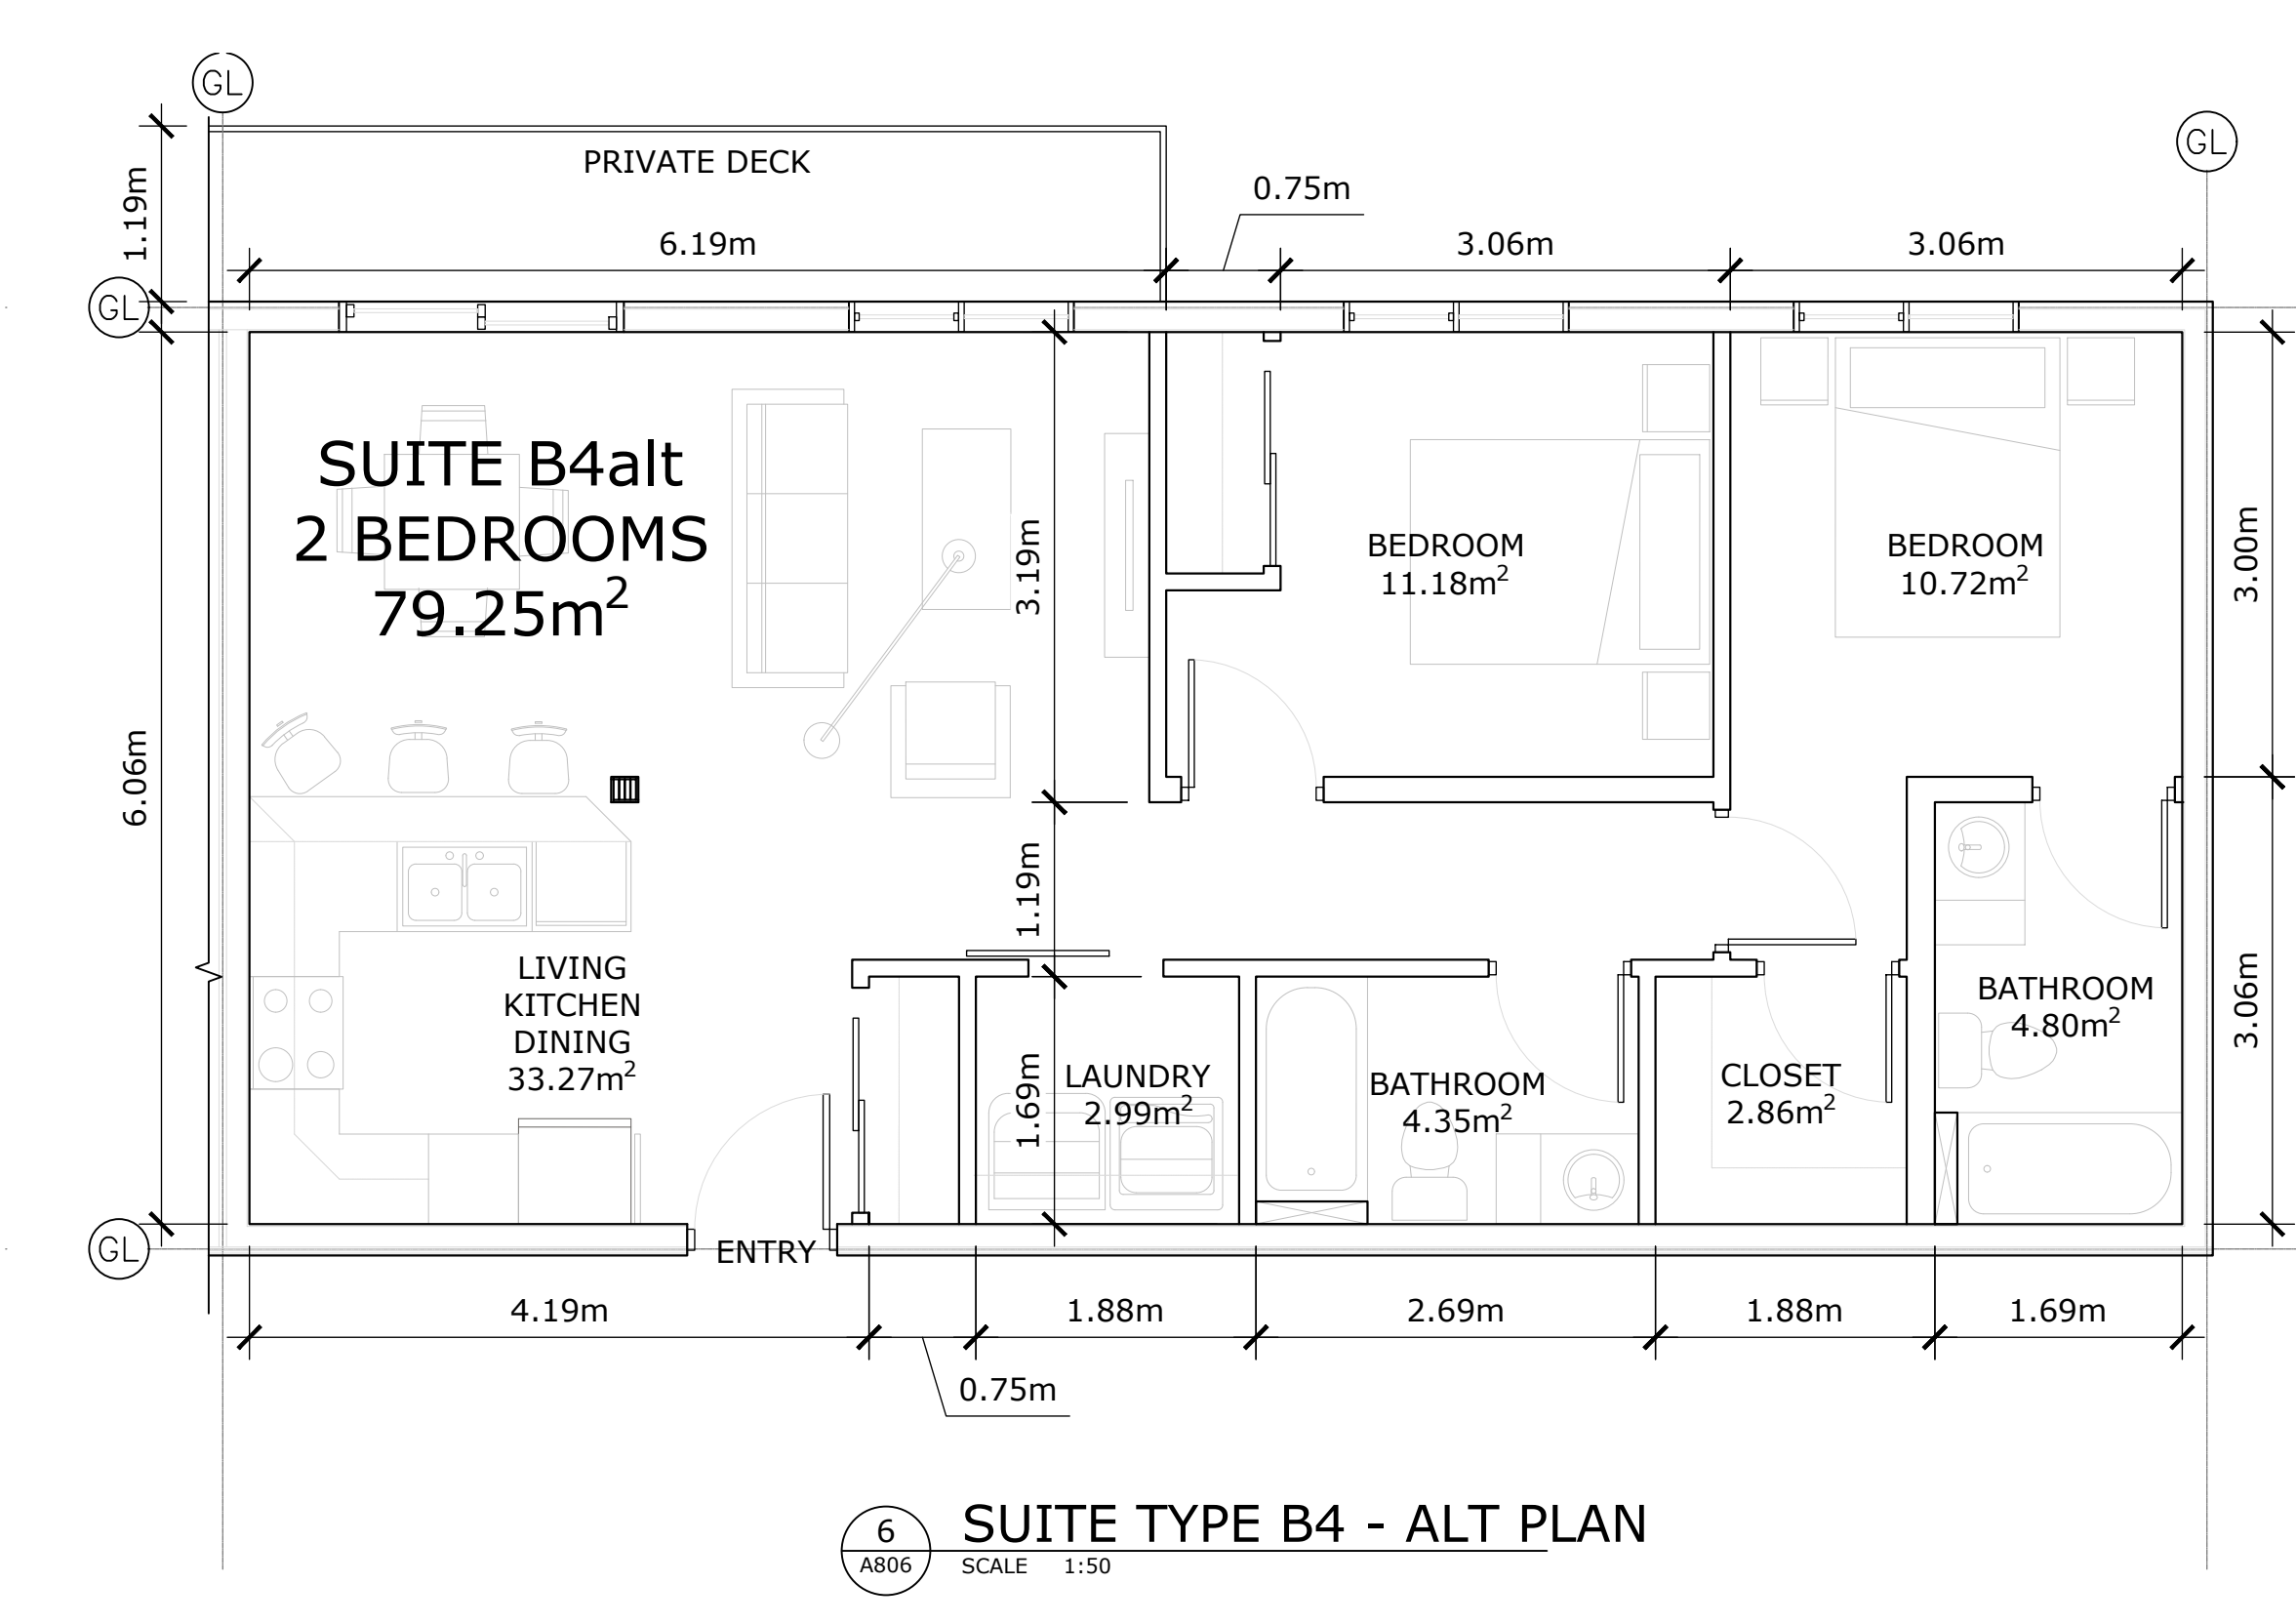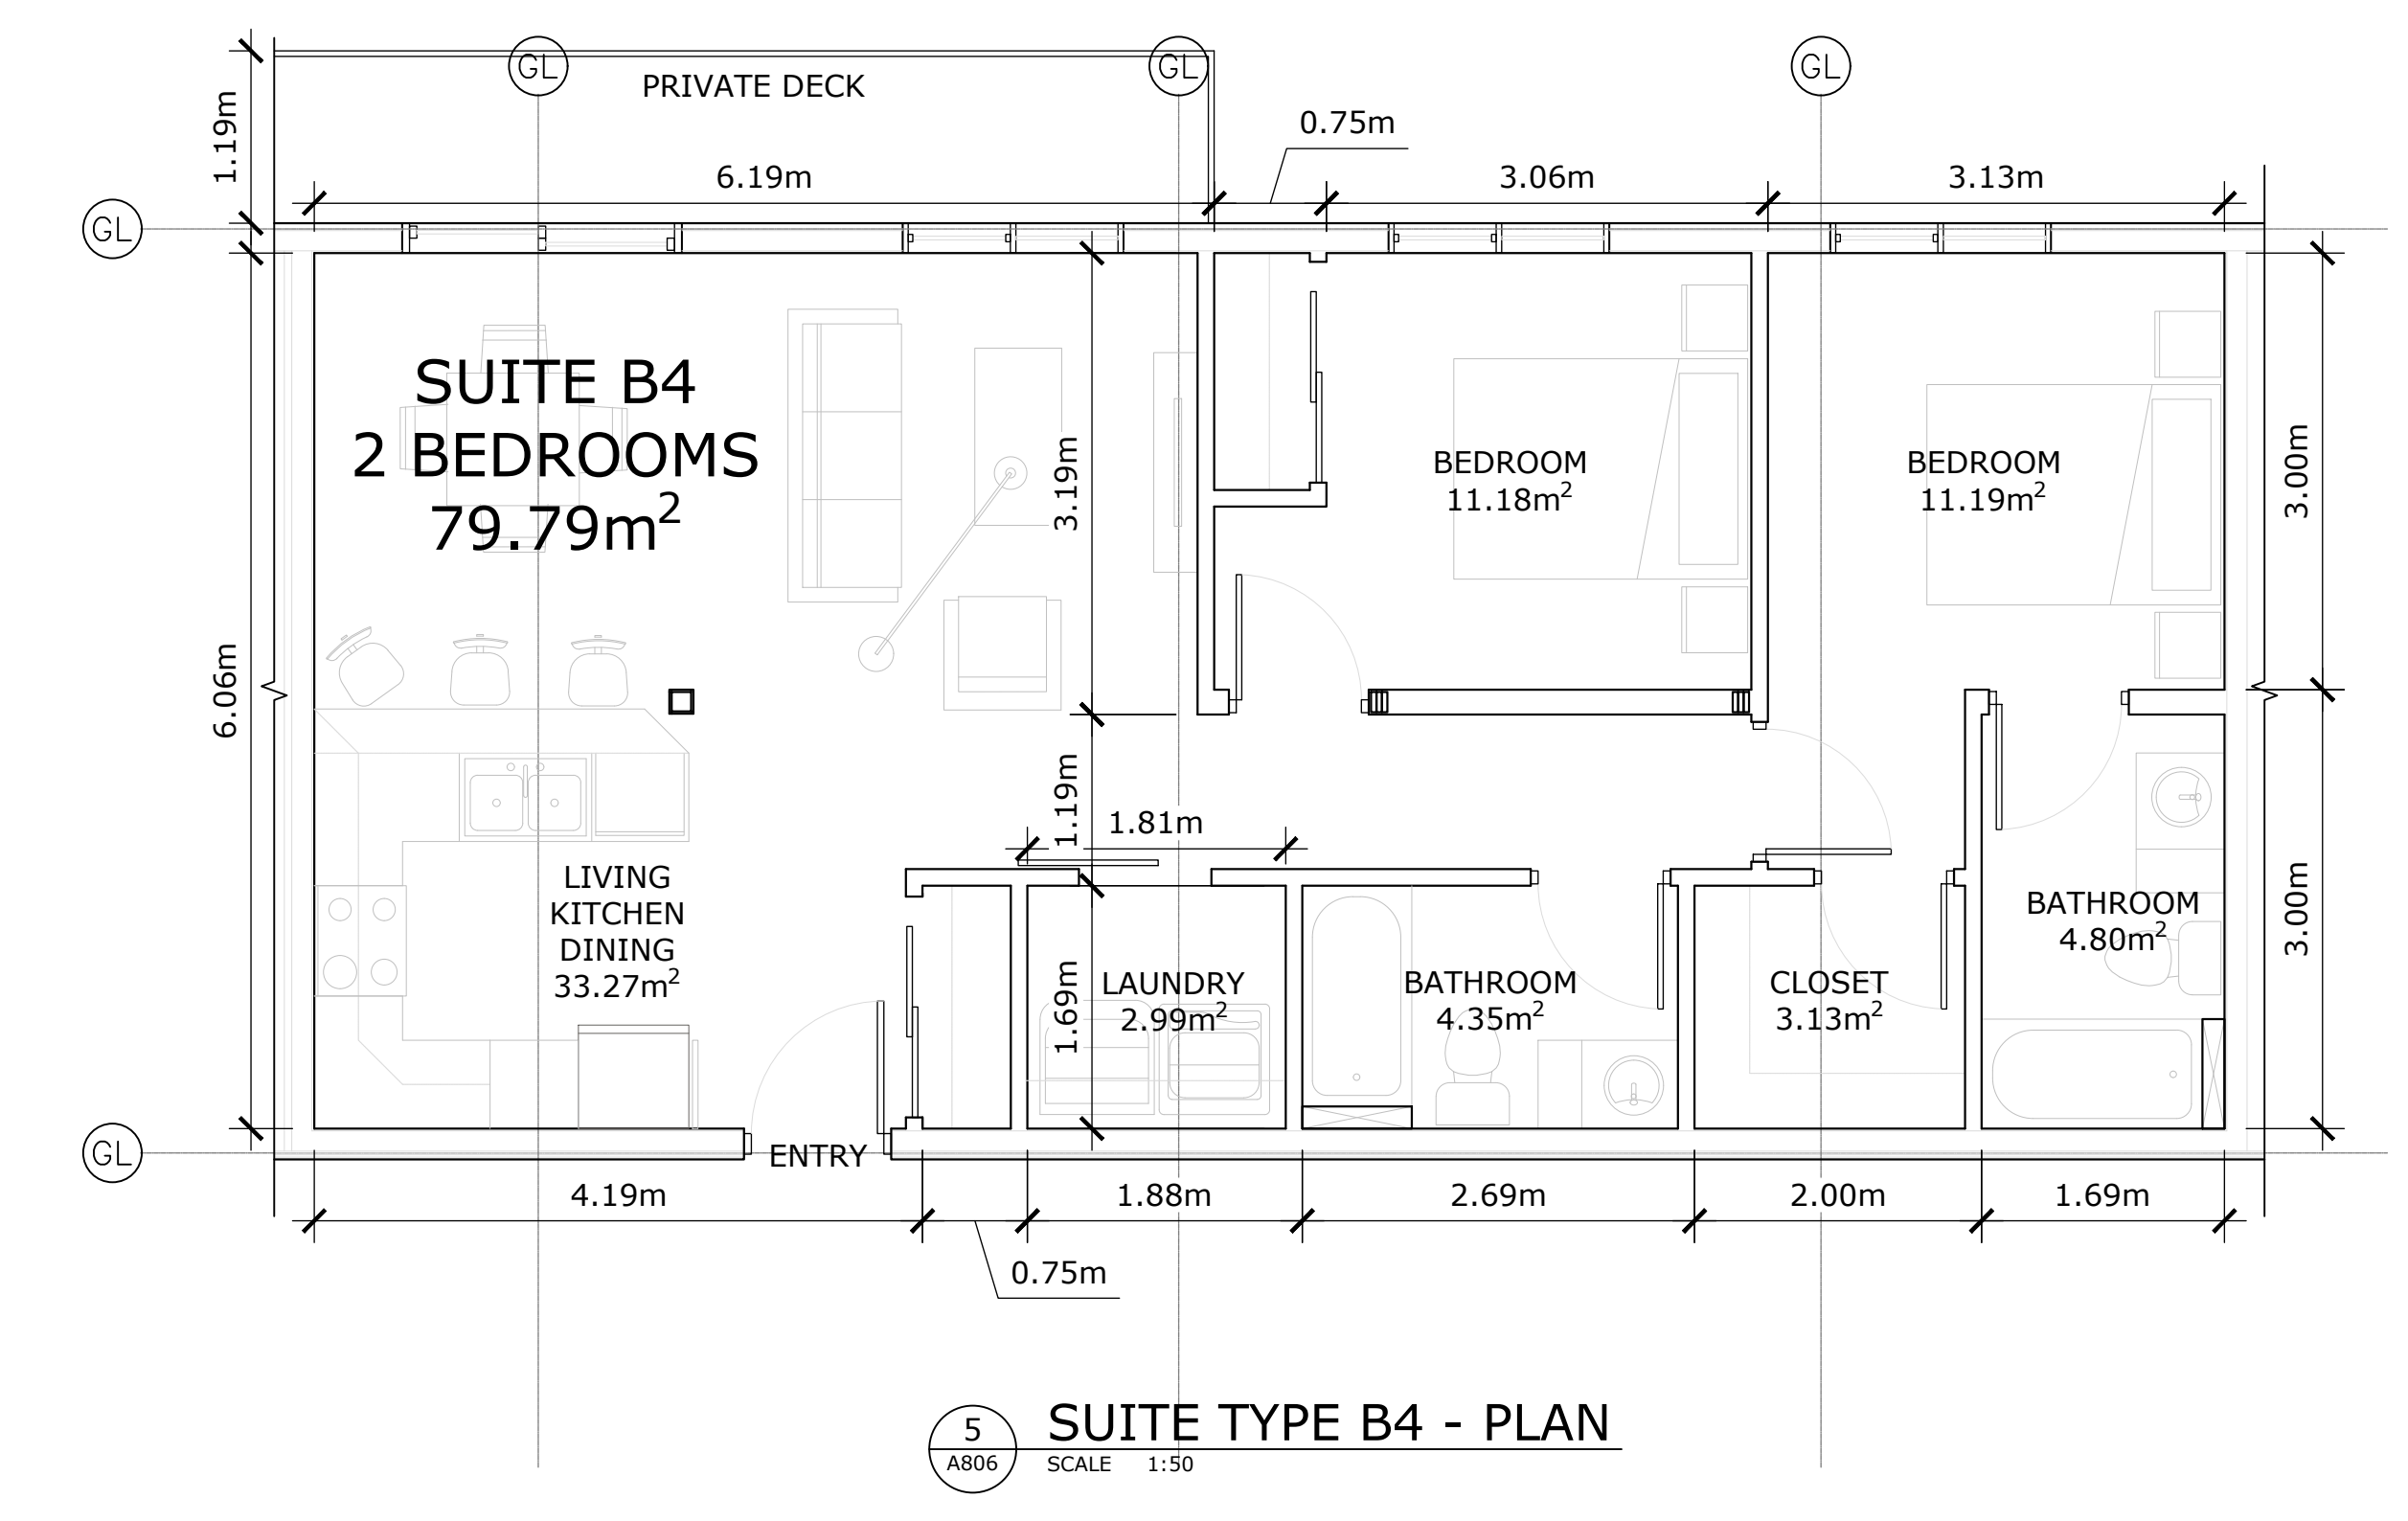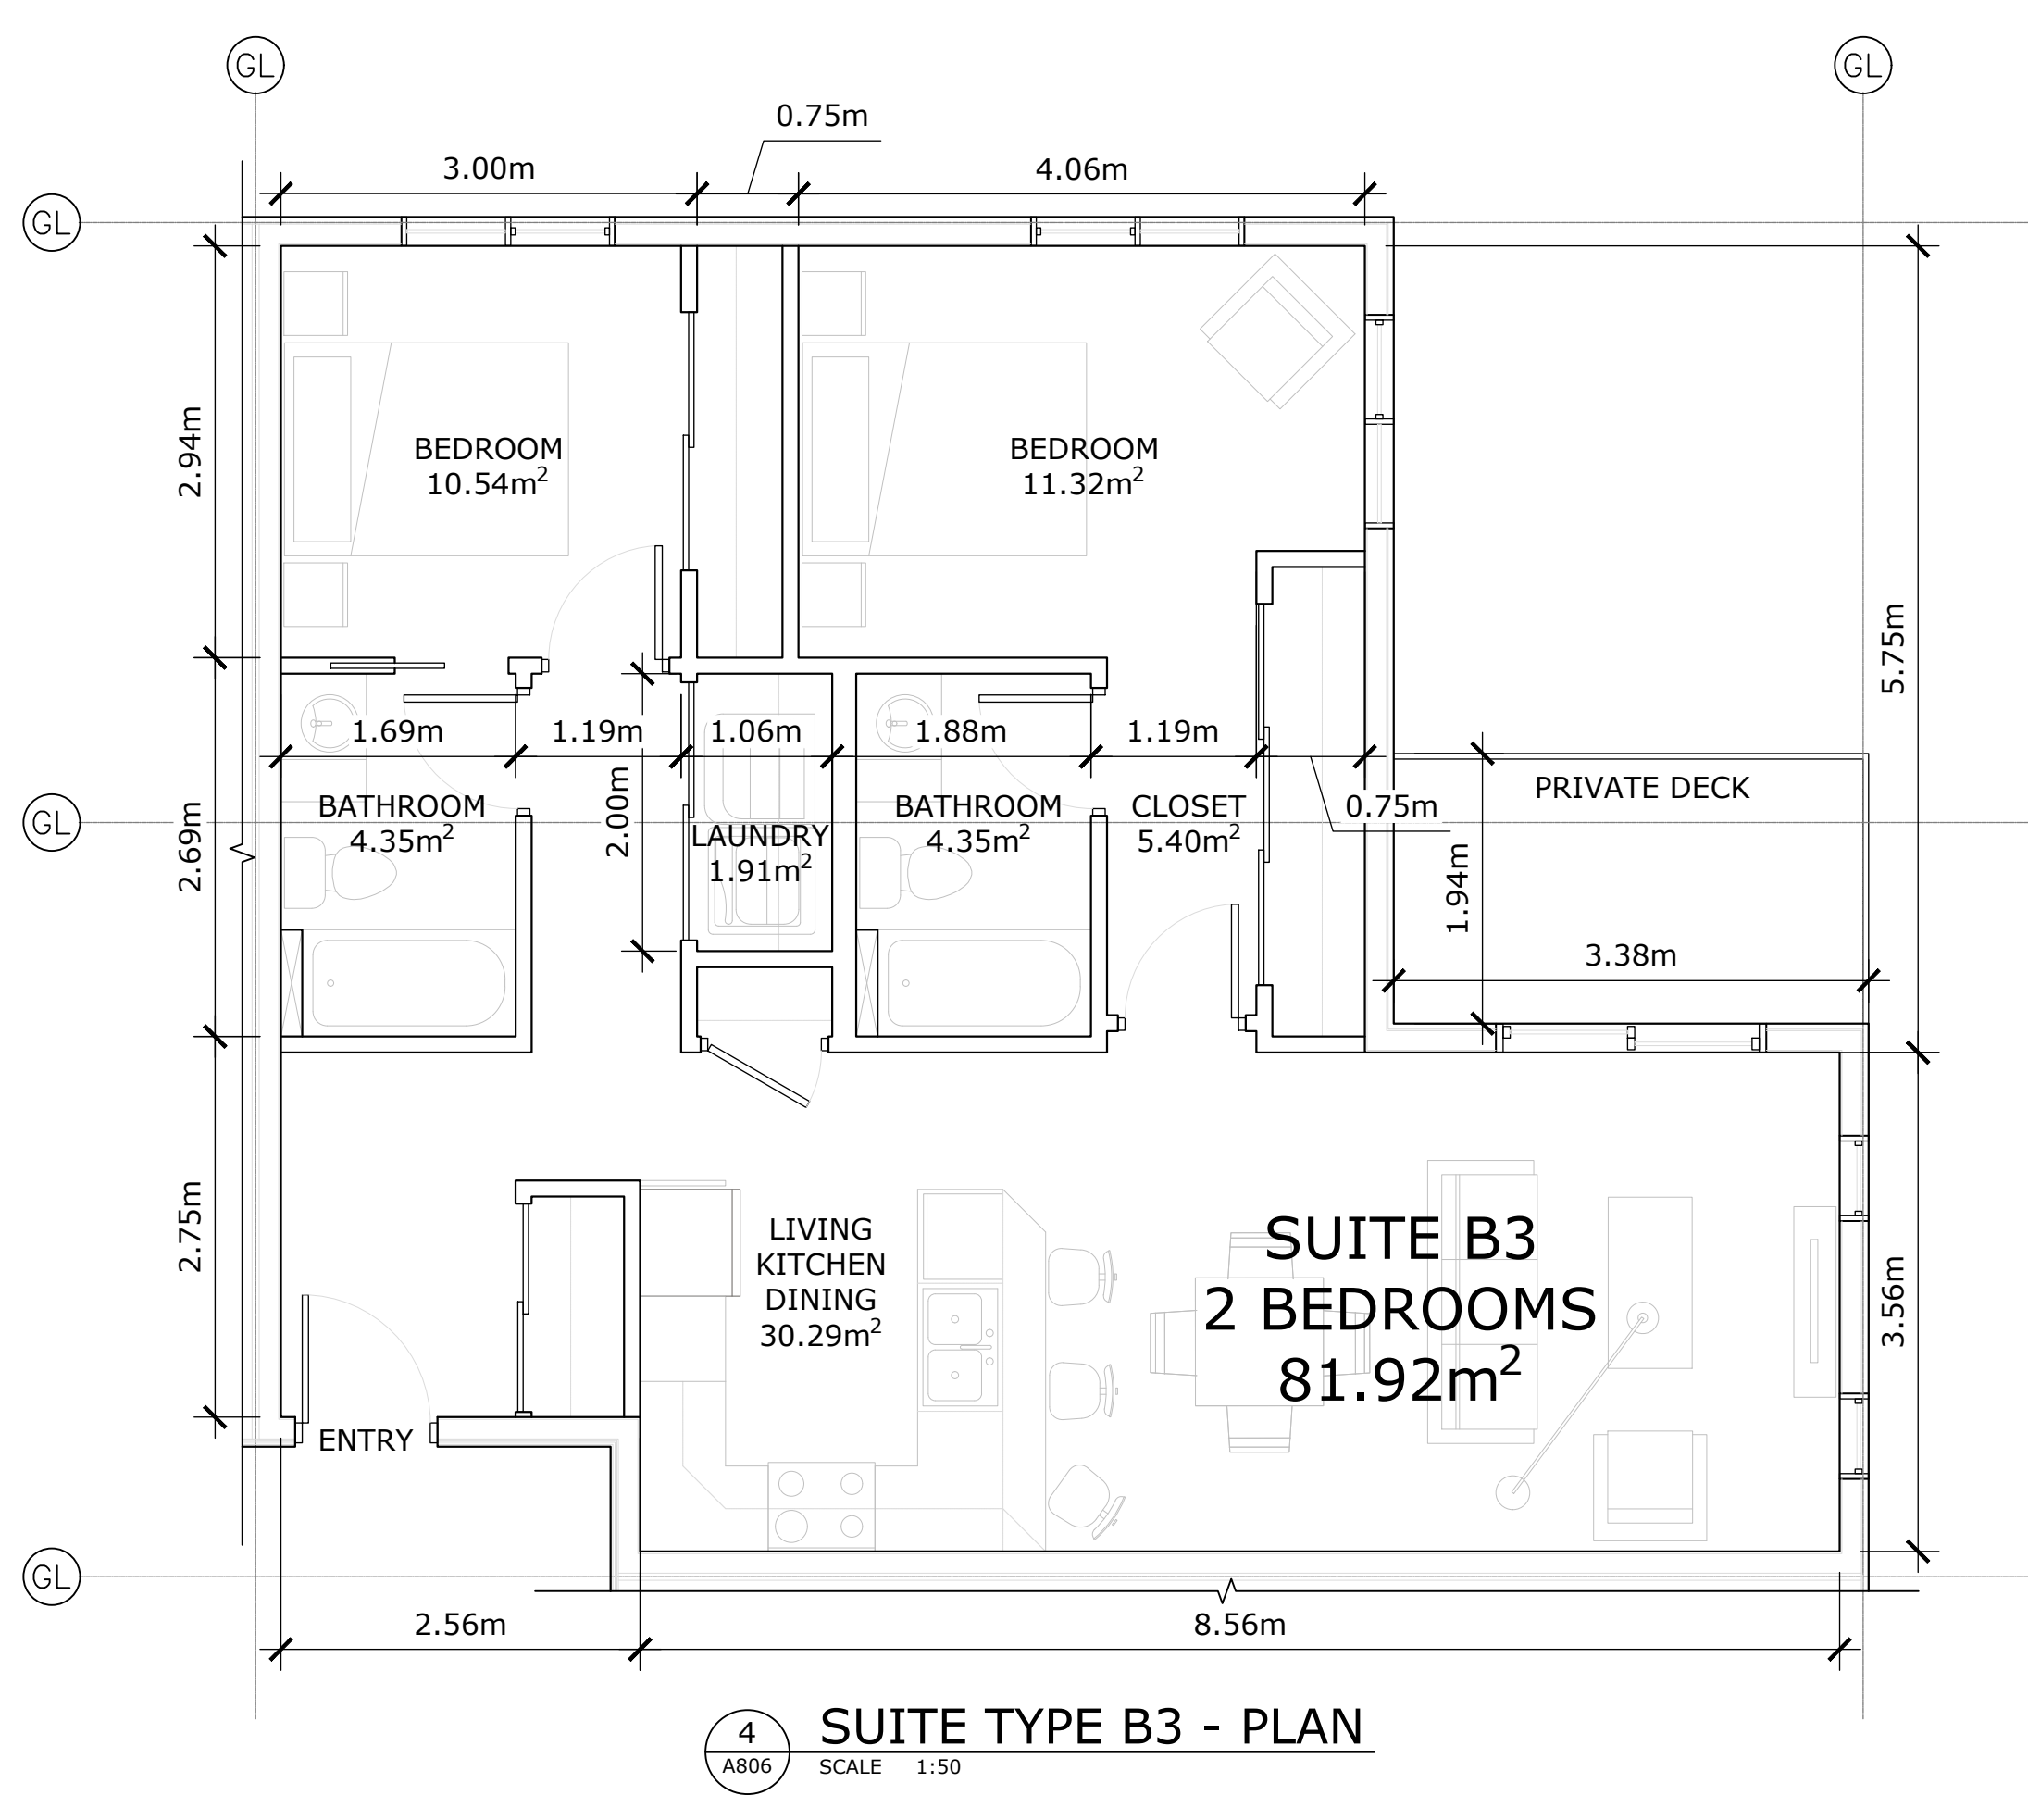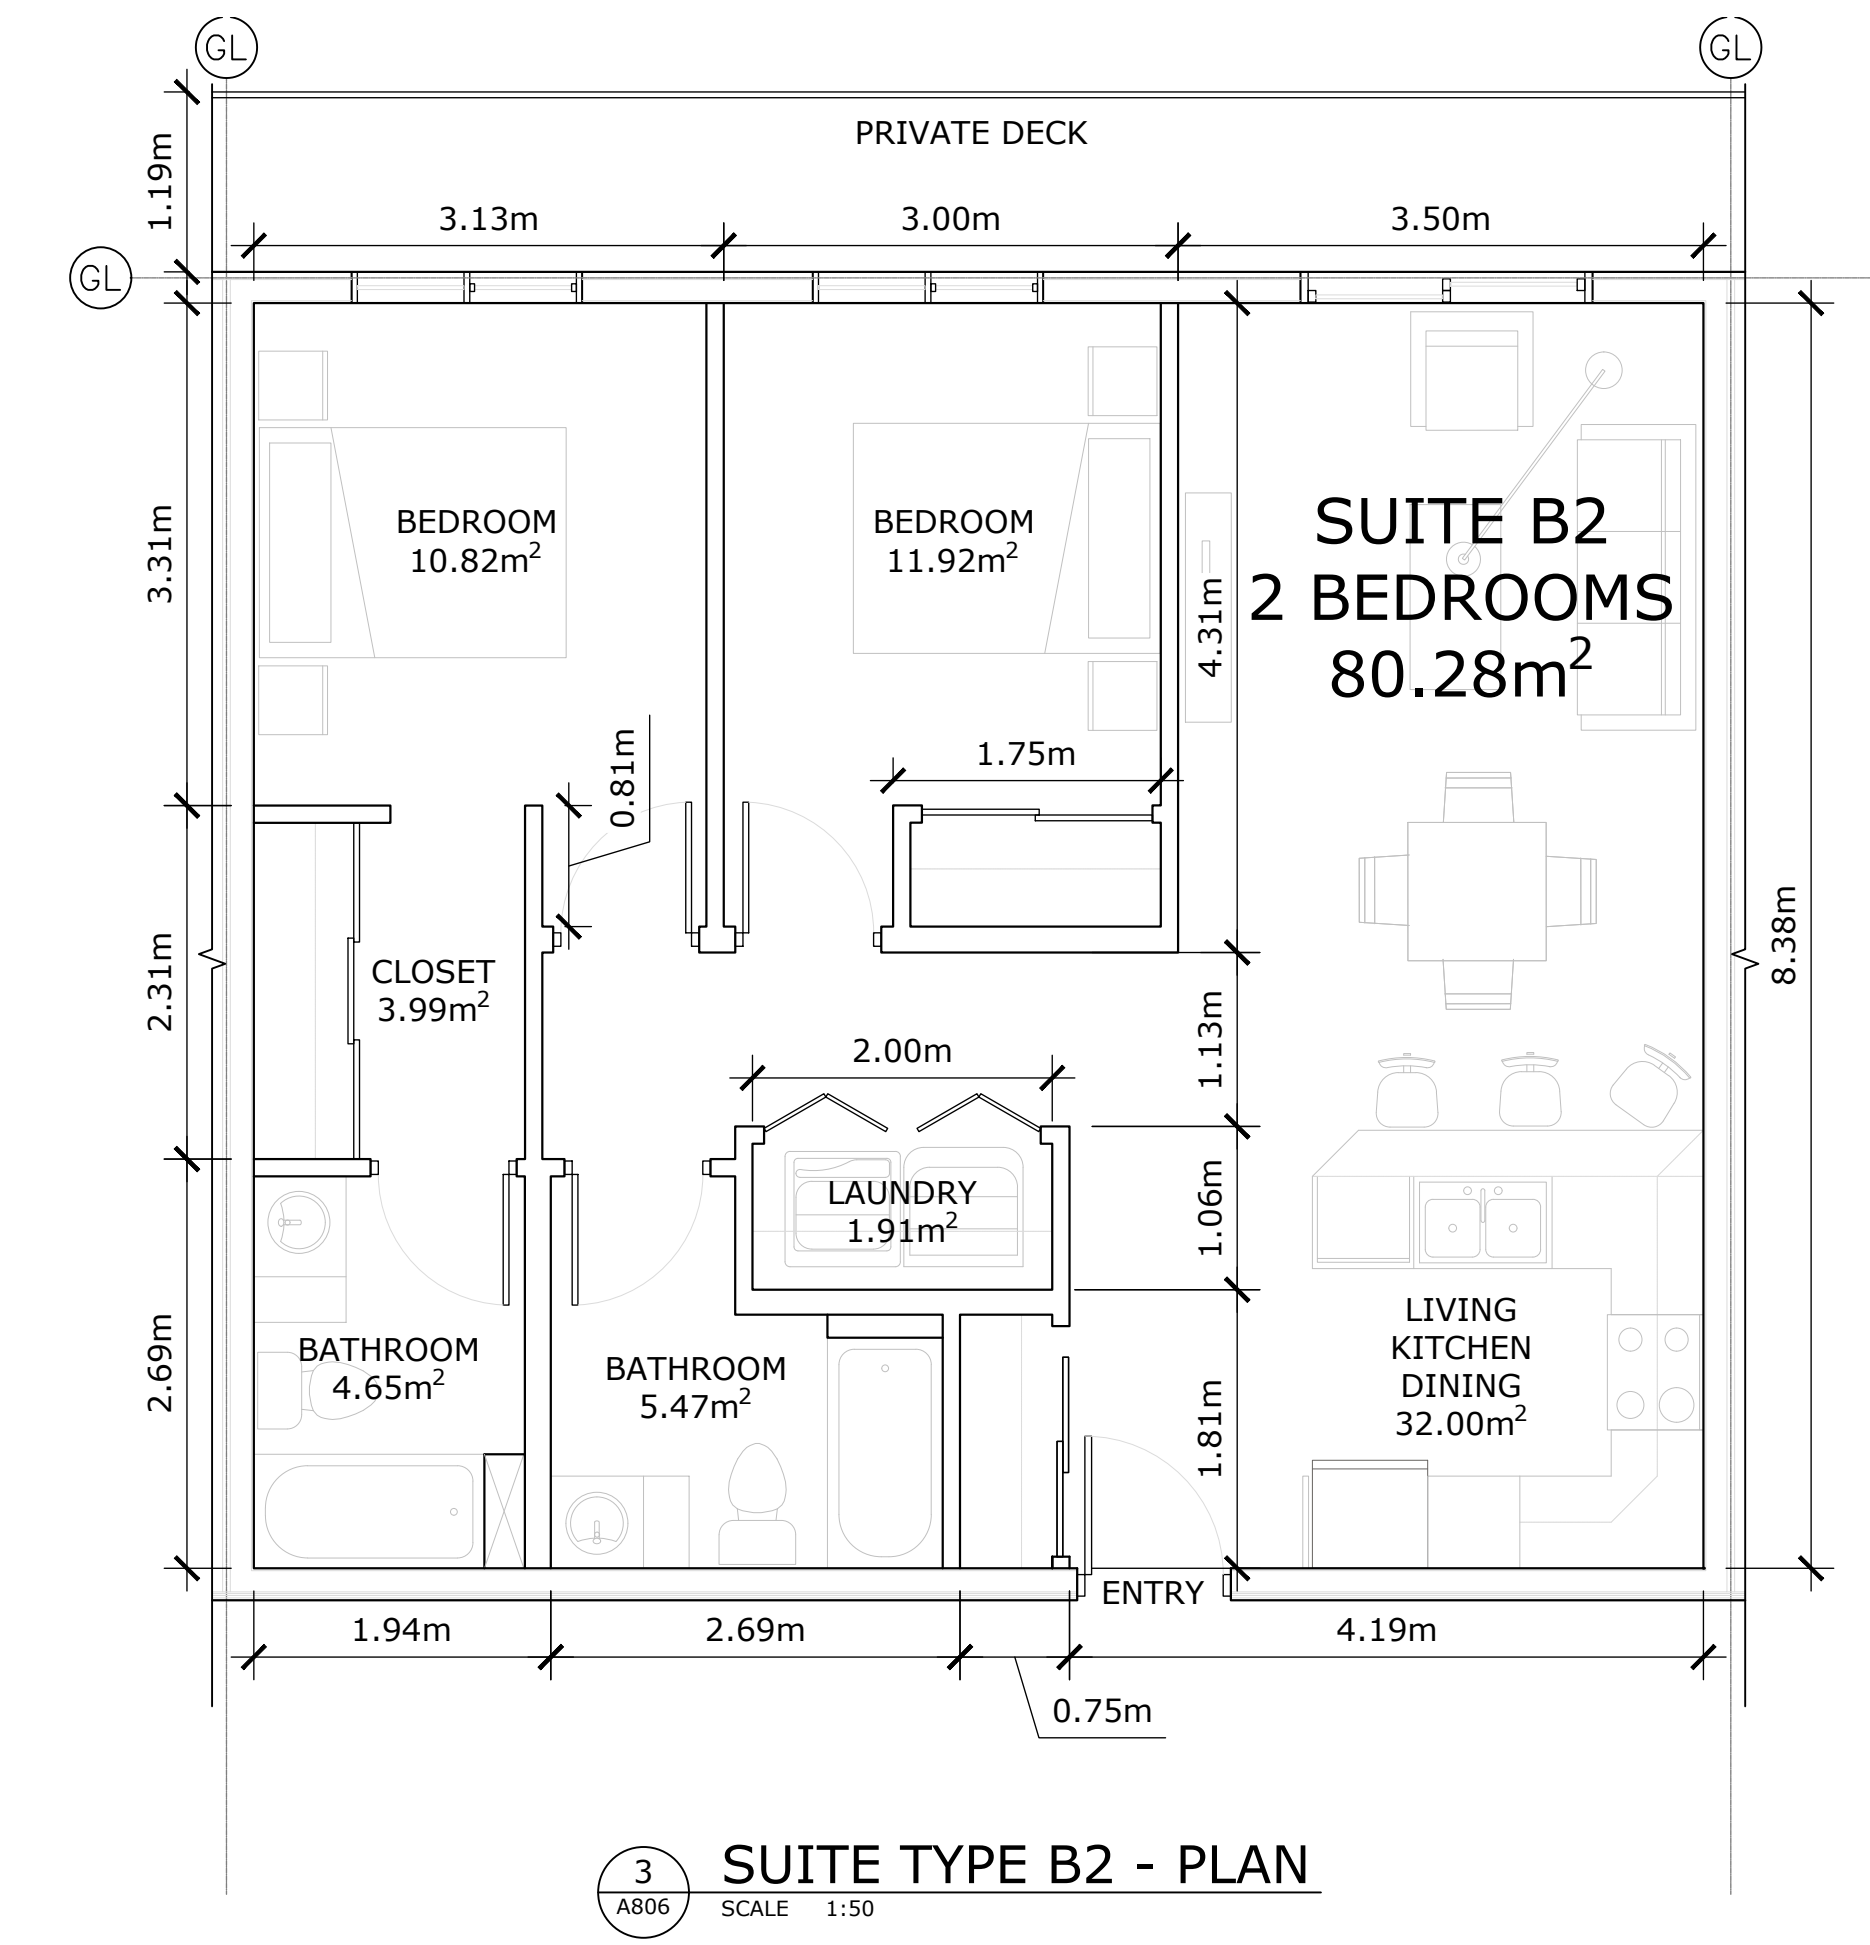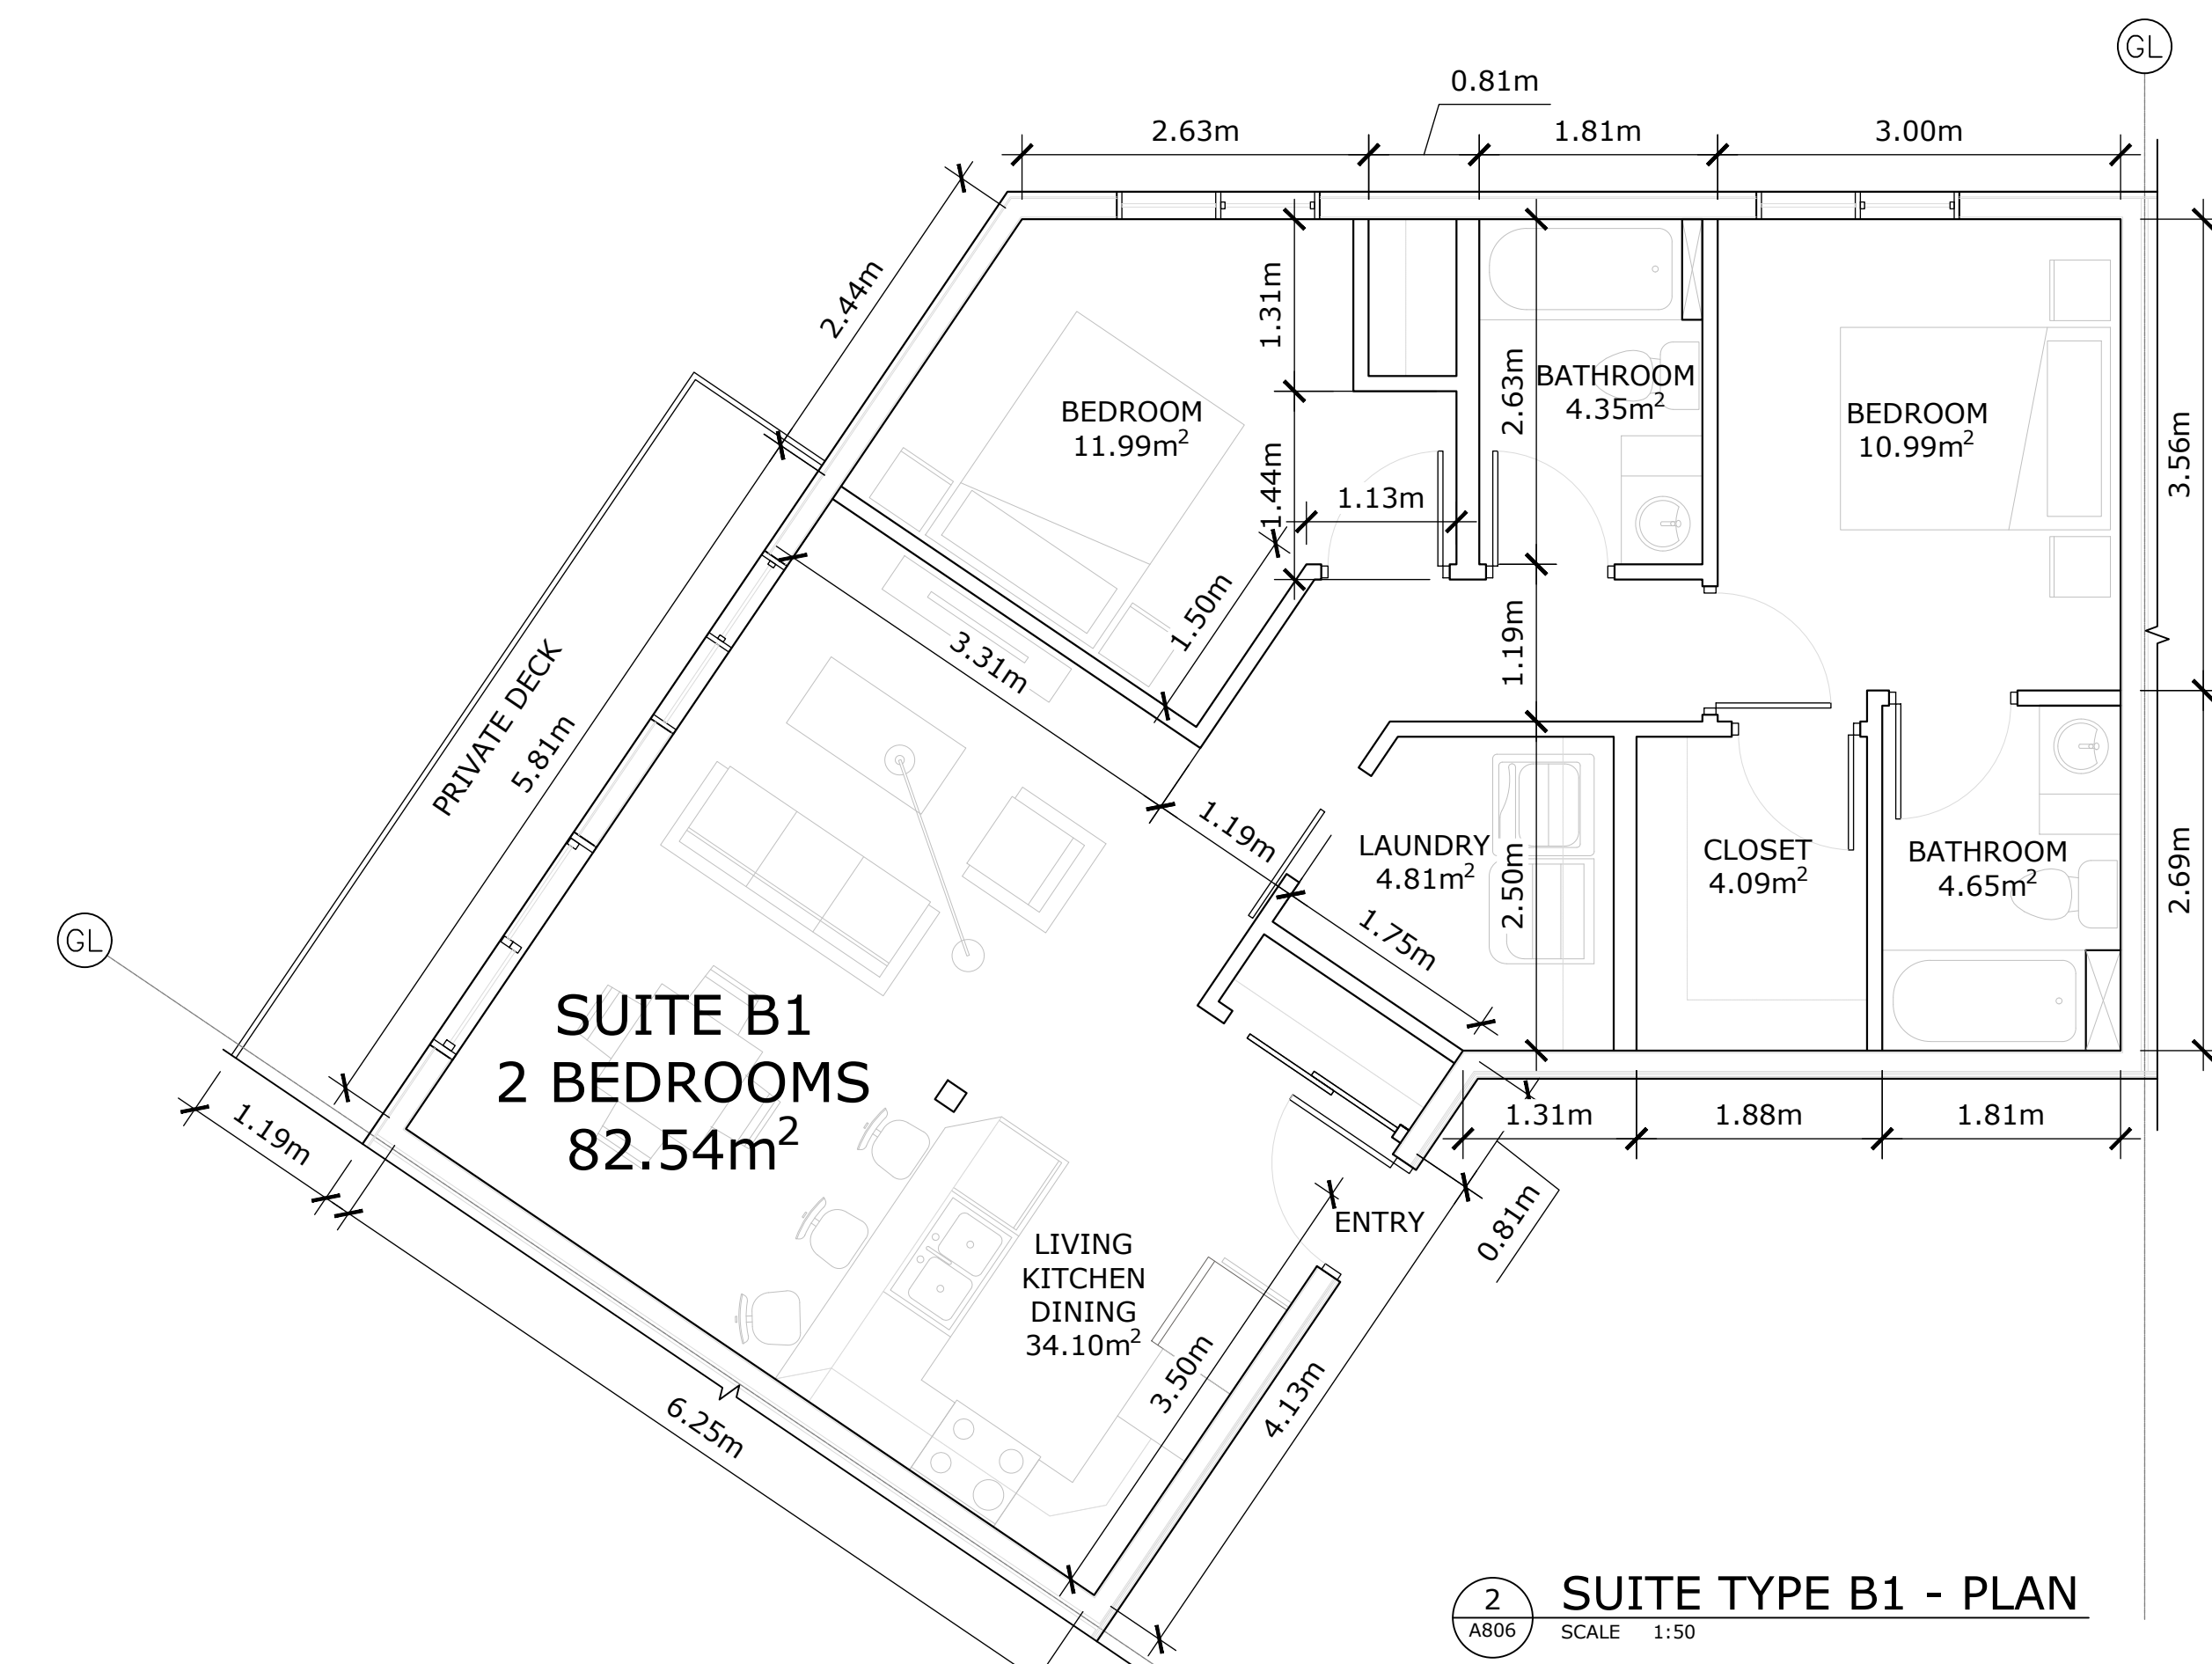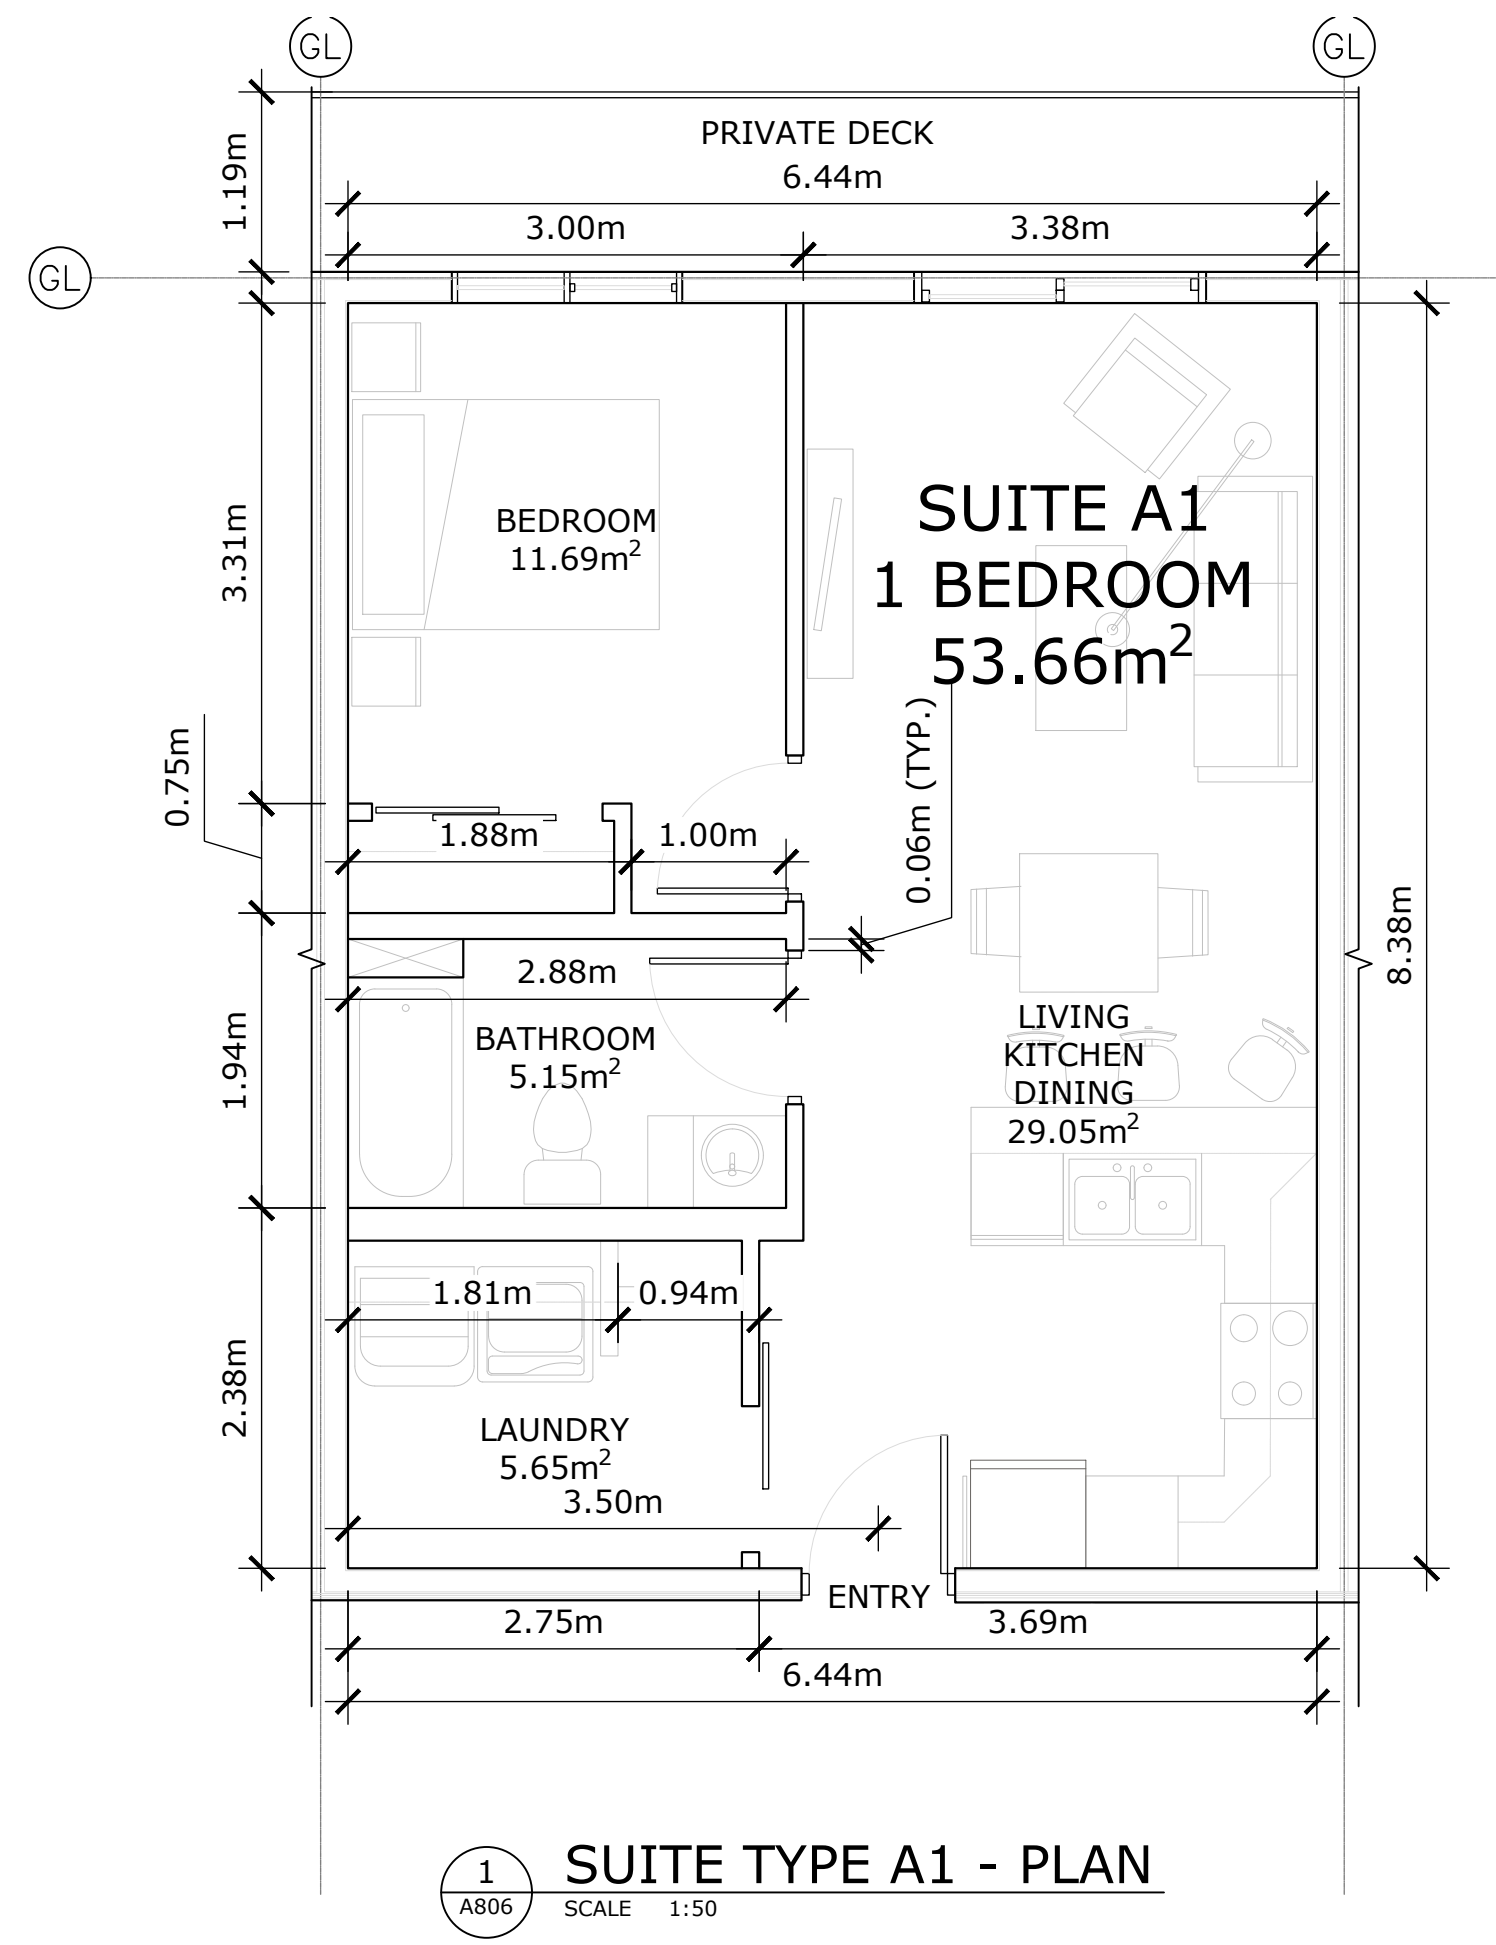

REV #	REVISION DESCRIPTION	DATE

Consultant

ROB GARVEY ARCHITECTURE 77 INC.
 201-57158 SYMINGTON RD 20E
 SPRINGFIELD, MB R2J 4L6
 T: 204-227-8274
 E: RGARVEY@A77.CA

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Stamp

NOT FOR CONSTRUCTION


Project: **MISSION HEIGHTS**
 2241 SPRINGFIELD ROAD
 KELOWNA, BC

Drawing Title: **SUITE PLANS**

Project no. 2135
 Drawn by JC/EB
 Date JULY 22, 2022
 Reference no.

Designed by xx
 Reviewed by xx
 Revision Date
 Scale AS NOTED

Sheet no. **A806** Revision no.

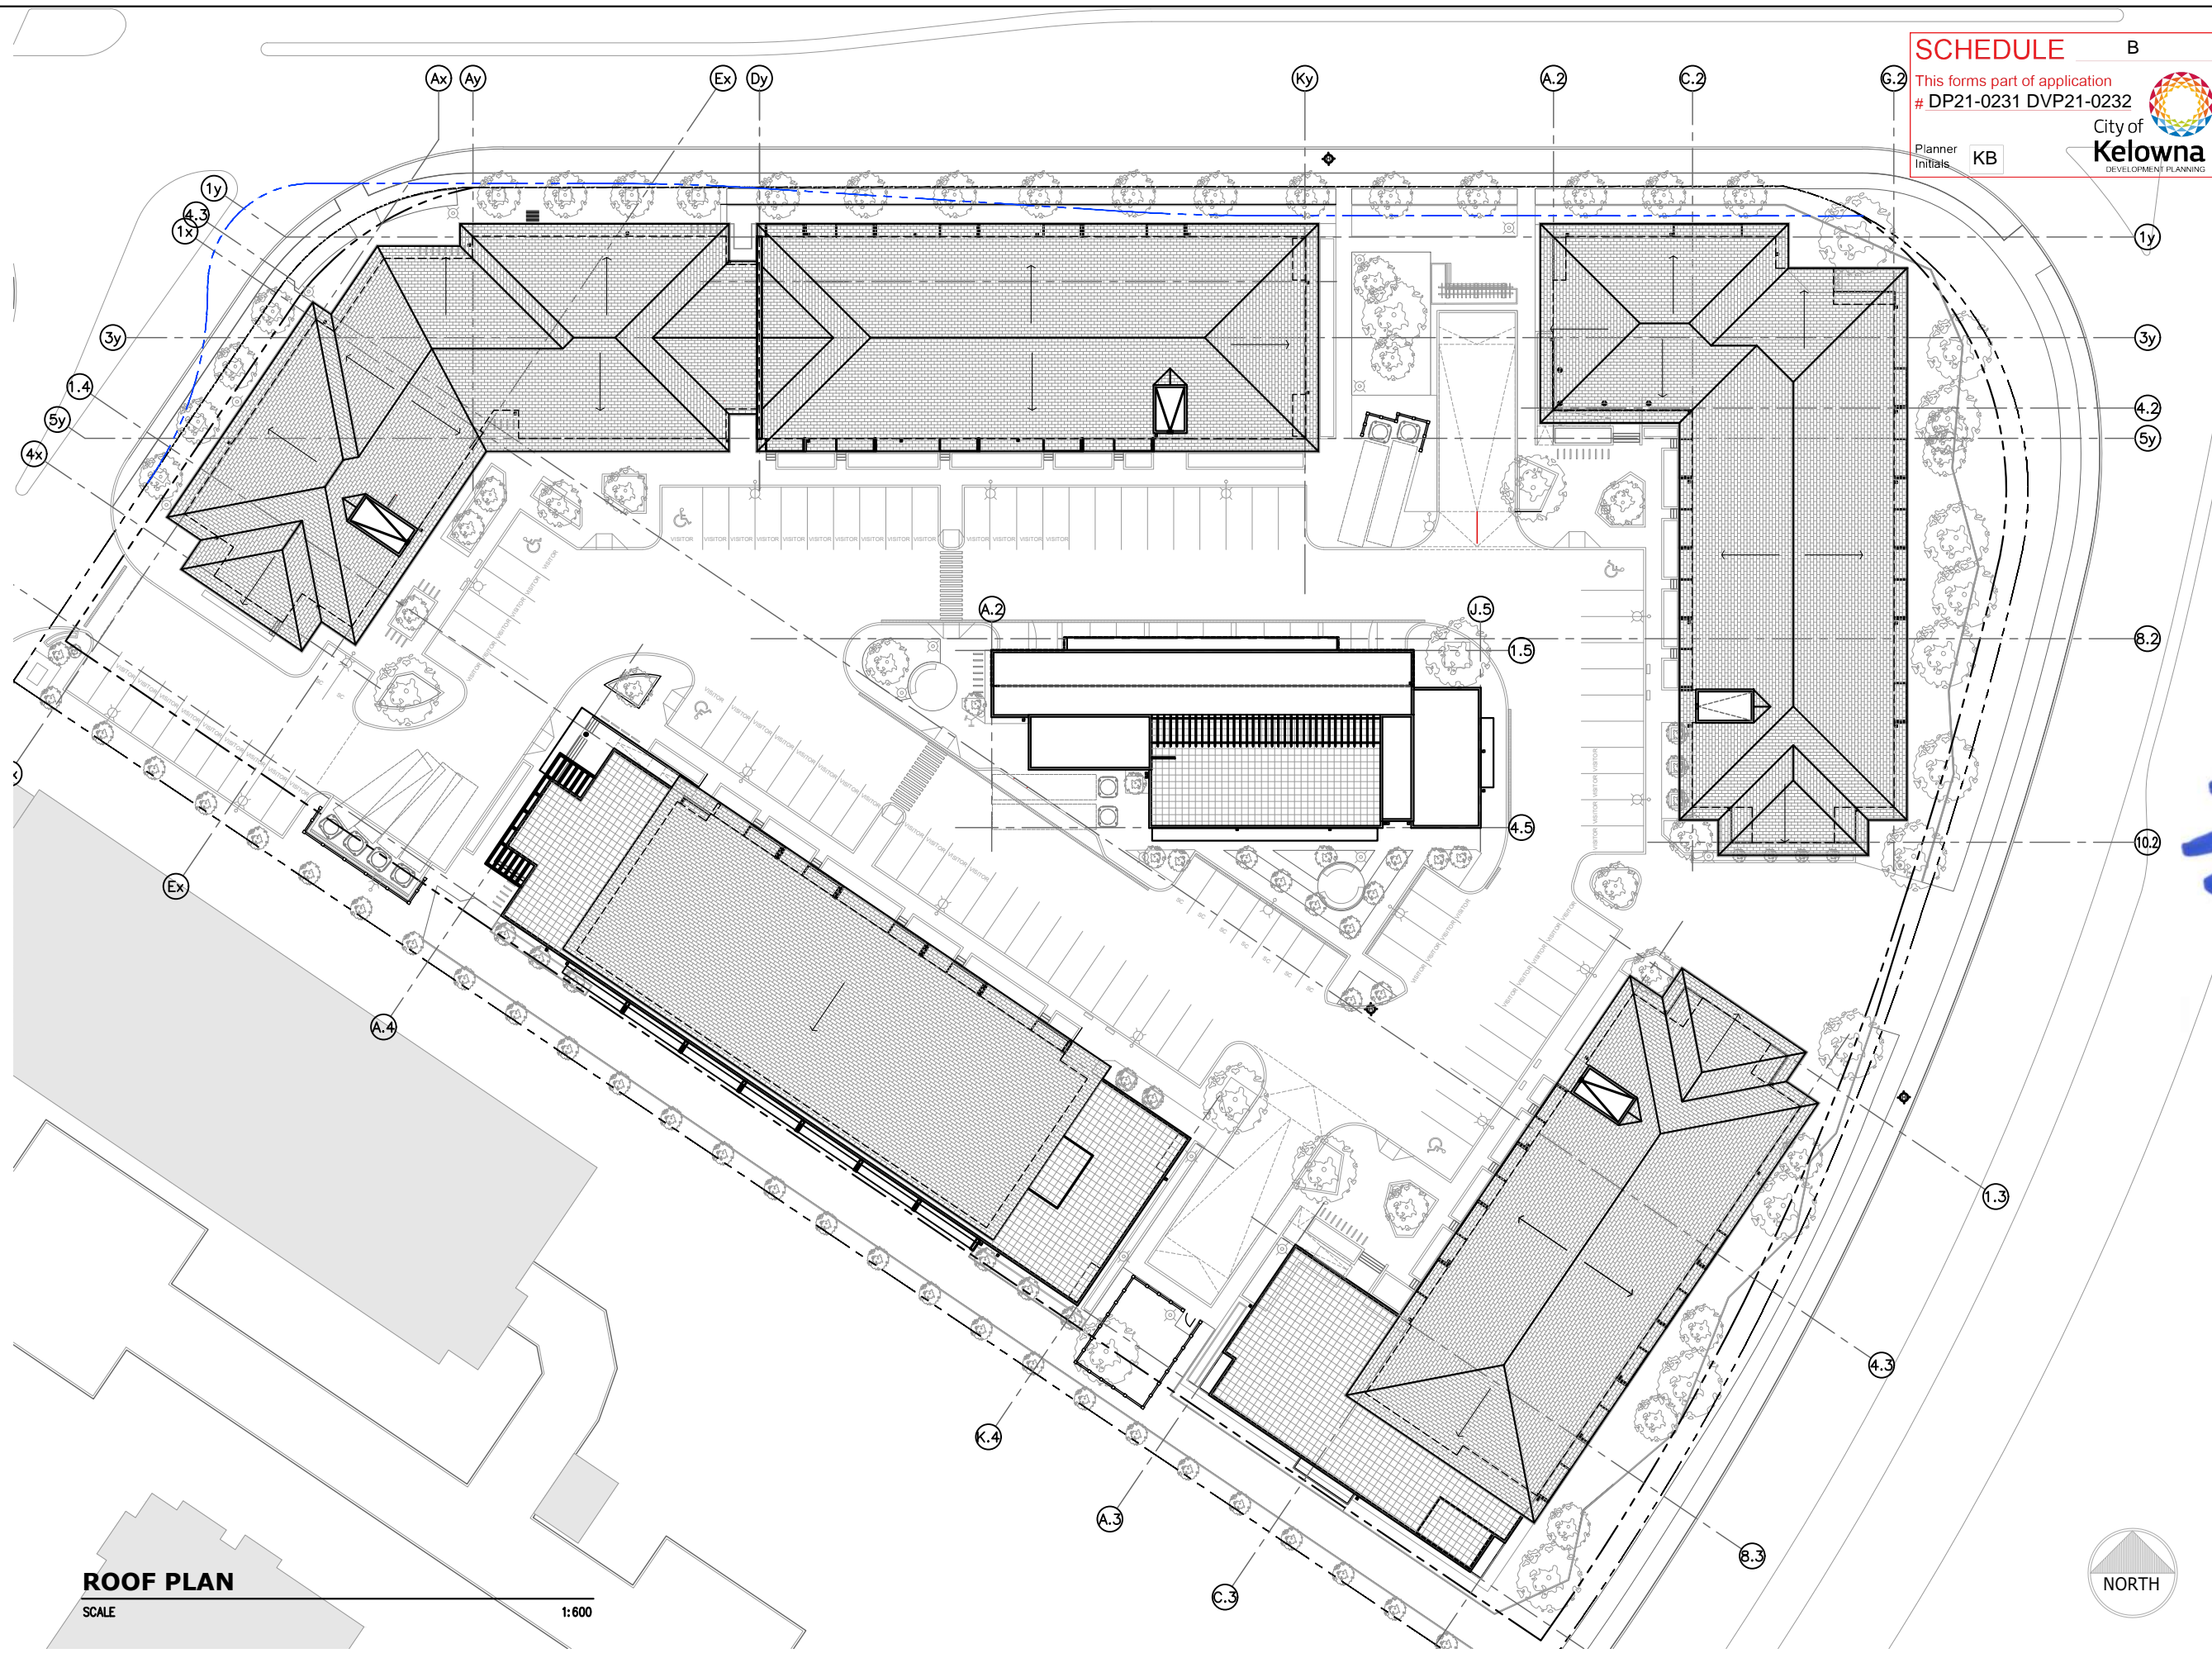

SCHEDULE B

This forms part of application
DP21-0231 DVP21-0232

City of Kelowna
DEVELOPMENT PLANNING

Planner Initials KB

Ironclad Developments Inc.

Project Management
General Contracting
Design/ Build

101-57158
Symington Rd.
Springfield, MB.
R2J 4L6

PH:
204-777-1972


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IRONCLAD DEVELOPMENTS INC.

Consultant

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REV.	DESCRIPTION OF WORK REVISED	DATE

2241 SPRINGFIELD ROAD;
Kelowna BC.

PROPOSED ROOF PLAN

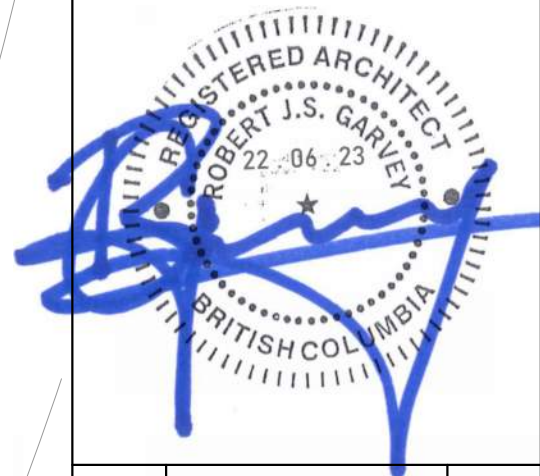Project Number: 2102

04-30-2020	Rev Date 09-30-2020
Drawn By T.THIMM	Designed By T.THIMM
Checked By R.GARVEY	

ESP-4.0

Scale 1:600

ROOF PLAN
SCALE

1:600



WOODEN TRELLIS



METAL LAP SIDING - BLUE



METAL LAP SIDING - CREAM



CEDAR TONE - COMPOSITE



METAL LAP SIDING GREY



HARDIE - SMOOTH WHITE



HARDIE - SMOOTH GREY



BRICK VENEER



METAL SIDING - YELLOW



LEGEND

- (A) HARDIE - SMOOTH (GREY)
- (B) CEDAR TONE COMPOSITE MATERIAL
- (C) BRICK VENEER
- (D) HARDIE - SMOOTH (WHITE)
- (E) METAL LAP SIDING (CREAM)
- (F) METAL LAP SIDING (BLUE)
- (G) METAL LAP SIDING (GREY)
- (H) WOODEN TRELLIS
- (I) ALUMINUM STOREFRONT (BLACK)
- (J) METAL SIDING (YELLOW)
- (K) ALUMINUM RAILING C/W CLEAR TEMPERED GLASS (BLACK)
- (L) PVC FRAMED WINDOWS C/W CLEAR GLASS
- (M) ALUMINUM PICKET RAILING



ALUMINUM RAILING C/W CLEAR TEMPERED GLASS



PVC FRAMED WINDOWS C/W CLEAR GLASS



ALUMINUM PICKET RAILING



ALUMINUM STOREFRONT (BLACK)

Ironclad Developments Inc.



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 General Contracting
 Design/ Build

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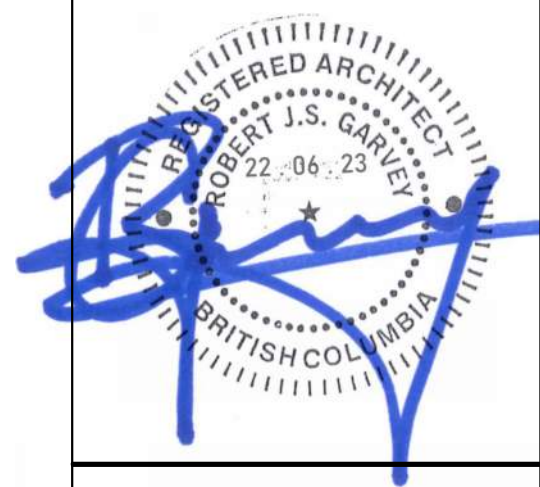
IRONCLAD DEVELOPMENTS INC.

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REV.	DESCRIPTION OF WORK REVISED	DATE

2241 SPRINGFIELD ROAD;
 Kelowna BC.

MATERIAL PALLETTE

Project Number: 2102

04-30-2020	Rev Date 06-06-2022
Drawn By	T.THIMM
Designed By	T.THIMM
Checked By	R.GARVEY

ESP-5.0

Scale NTS

SCHEDULE B
 This forms part of application
 # DP21-0231 DVP21-0232
 City of Kelowna
 DEVELOPMENT PLANNING
 Initials KB

Ironclad Developments Inc.



Project Management
 General Contracting
 Design/ Build

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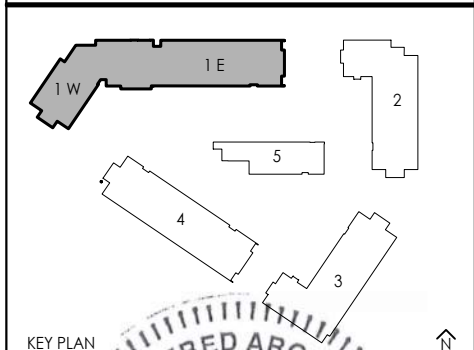
IRONCLAD DEVELOPMENTS INC.

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REV.	DESCRIPTION OF WORK REVISED	DATE

2241 SPRINGFIELD ROAD;
 Kelowna BC.

BUILDING 1 NORTH ELEVATIONS

Project Number: 2102

04-30-2020	Rev Date 06-06-2022
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Drawn By T.THIMM
 Designed By T.THIMM
 Checked By R.GARVEY

ESP-6.10

Scale 1:300



BUILDING 1 (EAST) NORTH ELEVATION
 SCALE 1:300

- LEGEND**
- (A) HARDIE - SMOOTH (GREY)
 - (B) CEDAR TONE COMPOSITE MATERIAL
 - (C) BRICK VENEER
 - (D) HARDIE - SMOOTH (WHITE)
 - (E) METAL LAP SIDING (CREAM)
 - (F) METAL LAP SIDING (BLUE)
 - (G) METAL LAP SIDING (GREY)
 - (H) WOODEN TRELLIS
 - (I) ALUMINUM STOREFRONT (BLACK)
 - (J) METAL SIDING (YELLOW)
 - (K) ALUMINUM RAILING C/W CLEAR TEMPERED GLASS (BLACK)
 - (L) PVC FRAMED WINDOWS C/W CLEAR GLASS
 - (M) ALUMINUM PICKET RAILING



BUILDING 1 (WEST) NORTH ELEVATION
 SCALE 1:300



BUILDING 1 (WEST) SOUTH ELEVATION

SCALE 1:300



BUILDING 1 (EAST) SOUTH ELEVATION

SCALE 1:300

SCHEDULE B
 This forms part of application # DP21-0231 DVP21-0232
 Planner Initials KB
 City of Kelowna DEVELOPMENT PLANNING

LEGEND

- Ⓐ HARDIE - SMOOTH (GREY)
- Ⓑ CEDAR TONE COMPOSITE MATERIAL
- Ⓒ BRICK VENEER
- Ⓓ HARDIE - SMOOTH (WHITE)
- Ⓔ METAL LAP SIDING (CREAM)
- Ⓕ METAL LAP SIDING (BLUE)
- Ⓖ METAL LAP SIDING (GREY)
- Ⓗ WOODEN TRELLIS
- Ⓘ ALUMINUM STOREFRONT (BLACK)
- Ⓢ METAL SIDING (YELLOW)
- Ⓚ ALUMINUM RAILING C/W CLEAR TEMPERED GLASS (BLACK)
- Ⓛ PVC FRAMED WINDOWS C/W CLEAR GLASS
- Ⓜ ALUMINUM PICKET RAILING

Ironclad Developments Inc.



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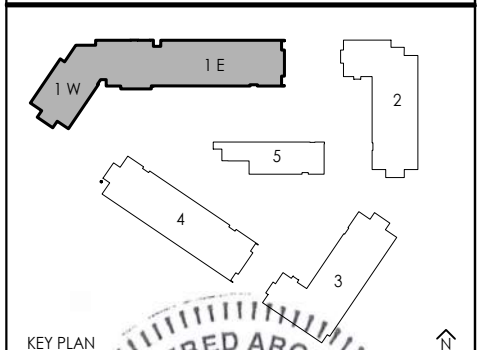
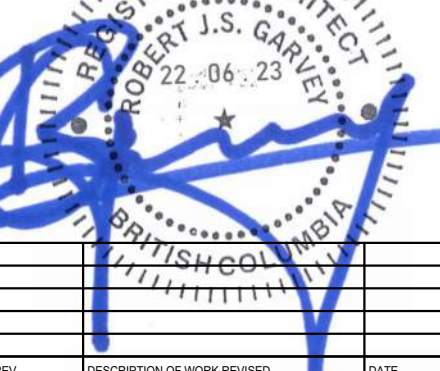
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Consultant



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REV.	DESCRIPTION OF WORK REVISED	DATE

2241 SPRINGFIELD ROAD;
 Kelowna BC.

BUILDING 1 SOUTH ELEVATIONS

Project Number: 2102
04-30-2020 Rev Date 06-06-2022
Drawn By T.THIMM
Designed By T.THIMM
Checked By R.GARVEY

ESP-6.11

Scale 1:300

SCHEDULE B

This forms part of application
DP21-0231 DVP21-0232

Planner Initials **KB**

City of **Kelowna**
DEVELOPMENT PLANNING

Ironclad Developments Inc.



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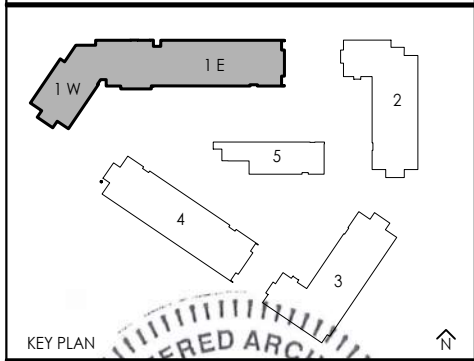
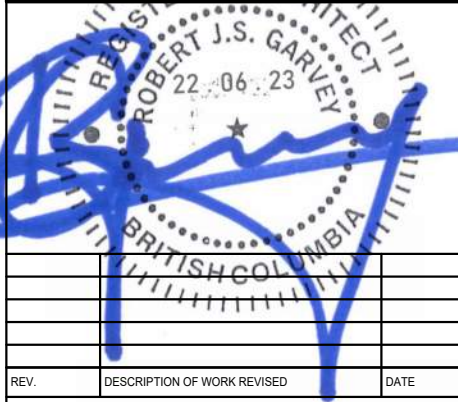
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REV.	DESCRIPTION OF WORK REVISED	DATE

2241 SPRINGFIELD ROAD;
Kelowna BC.

BUILDING 1 ELEVATIONS

Project Number: 2102

04-30-2020	Rev Date 06-06-2022
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Drawn By T.THIMM
Designed By T.THIMM
Checked By R.GARVEY

ESP-6.12

Scale 1:300



BUILDING 1 WEST ELEVATION

SCALE 1:300

- LEGEND**
- (A) HARDIE - SMOOTH (GREY)
 - (B) CEDAR TONE COMPOSITE MATERIAL
 - (C) BRICK VENEER
 - (D) HARDIE - SMOOTH (WHITE)
 - (E) METAL LAP SIDING (CREAM)
 - (F) METAL LAP SIDING (BLUE)
 - (G) METAL LAP SIDING (GREY)
 - (H) WOODEN TRELLIS
 - (I) ALUMINUM STOREFRONT (BLACK)
 - (J) METAL SIDING (YELLOW)
 - (K) ALUMINUM RAILING C/W CLEAR TEMPERED GLASS (BLACK)
 - (L) PVC FRAMED WINDOWS C/W CLEAR GLASS
 - (M) ALUMINUM PICKET RAILING




BUILDING 1 EAST ELEVATION

SCALE 1:300

SCHEDULE B

This forms part of application
DP21-0231 DVP21-0232

Planner Initials **KB**



- LEGEND**
- Ⓐ HARDIE - SMOOTH (GREY)
 - Ⓑ CEDAR TONE COMPOSITE MATERIAL
 - Ⓒ BRICK VENEER
 - Ⓓ HARDIE - SMOOTH (WHITE)
 - Ⓔ METAL LAP SIDING (CREAM)
 - Ⓕ METAL LAP SIDING (BLUE)
 - Ⓖ METAL LAP SIDING (GREY)
 - Ⓗ WOODEN TRELLIS
 - Ⓘ ALUMINUM STOREFRONT (BLACK)
 - Ⓢ METAL SIDING (YELLOW)
 - Ⓚ ALUMINUM RAILING C/W CLEAR TEMPERED GLASS (BLACK)
 - Ⓛ PVC FRAMED WINDOWS C/W CLEAR GLASS
 - Ⓜ ALUMINUM PICKET RAILING

Ironclad Developments Inc.



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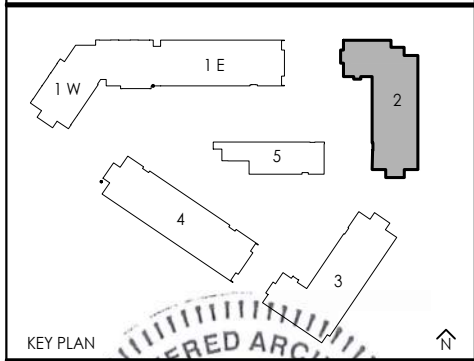
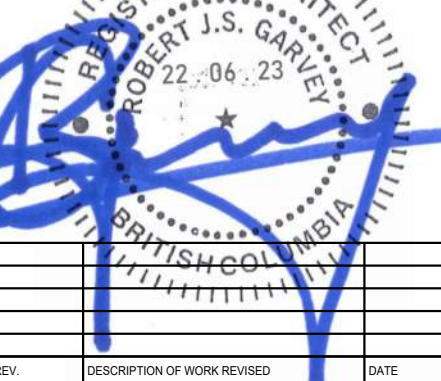
IRONCLAD DEVELOPMENTS INC.

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REV.	DESCRIPTION OF WORK REVISED	DATE

2241 SPRINGFIELD ROAD;
Kelowna BC.

BUILDING 2 ELEVATIONS

Project Number: 2102

04-30-2020	Rev Date 06-06-2022
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Drawn By T.THIMM
Designed By T.THIMM
Checked By R.GARVEY

ESP-6.20

Scale 1:300



BUILDING 2 NORTH ELEVATION
SCALE 1:300



BUILDING 2 SOUTH ELEVATION
SCALE 1:300



BUILDING 2 EAST ELEVATION

SCALE 1:300



BUILDING 2 WEST ELEVATION

SCALE 1:300

LEGEND

- Ⓐ HARDIE - SMOOTH (GREY)
- Ⓑ CEDAR TONE COMPOSITE MATERIAL
- Ⓒ BRICK VENEER
- Ⓓ HARDIE - SMOOTH (WHITE)
- Ⓔ METAL LAP SIDING (CREAM)
- Ⓕ METAL LAP SIDING (BLUE)
- Ⓖ METAL LAP SIDING (GREY)
- Ⓗ WOODEN TRELLIS
- Ⓘ ALUMINUM STOREFRONT (BLACK)
- Ⓢ METAL SIDING (YELLOW)
- Ⓚ ALUMINUM RAILING C/W CLEAR TEMPERED GLASS (BLACK)
- Ⓛ PVC FRAMED WINDOWS C/W CLEAR GLASS
- Ⓜ ALUMINUM PICKET RAILING

SCHEDULE B

This forms part of application # DP21-0231 DVP21-0232
 City of Kelowna DEVELOPMENT PLANNING
 Planner Initials KB

Ironclad Developments Inc.



Project Management
 General Contracting
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101-57158
 Symington Rd.
 Springfield, MB.
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PH:
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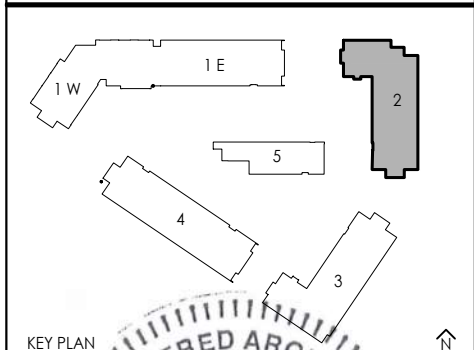
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REV.	DESCRIPTION OF WORK REVISED	DATE

2241 SPRINGFIELD ROAD;
 Kelowna BC.

BUILDING 2 ELEVATIONS

Project Number: 2102

04-30-2020	Rev Date 06-06-2022
Drawn By T.THIMM	
Designed By T.THIMM	
Checked By R.GARVEY	

ESP-6.21

Scale 1:300



BUILDING 3 NORTH ELEVATION

SCALE

1:300



BUILDING 3 SOUTH ELEVATION

SCALE

1:300

SCHEDULE B
 This forms part of application
 # DP21-0231 DVP21-0232
 Planner Initials KB
 City of Kelowna
 DEVELOPMENT PLANNING

LEGEND

- Ⓐ HARDIE - SMOOTH (GREY)
- Ⓑ CEDAR TONE COMPOSITE MATERIAL
- Ⓒ BRICK VENEER
- Ⓓ HARDIE - SMOOTH (WHITE)
- Ⓔ METAL LAP SIDING (CREAM)
- Ⓕ METAL LAP SIDING (BLUE)
- Ⓖ METAL LAP SIDING (GREY)
- Ⓗ WOODEN TRELLIS
- Ⓘ ALUMINUM STOREFRONT (BLACK)
- ⓵ METAL SIDING (YELLOW)
- Ⓚ ALUMINUM RAILING C/W CLEAR TEMPERED GLASS (BLACK)
- Ⓛ PVC FRAMED WINDOWS C/W CLEAR GLASS
- Ⓜ ALUMINUM PICKET RAILING

Ironclad Developments Inc.



Project Management
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101-57158
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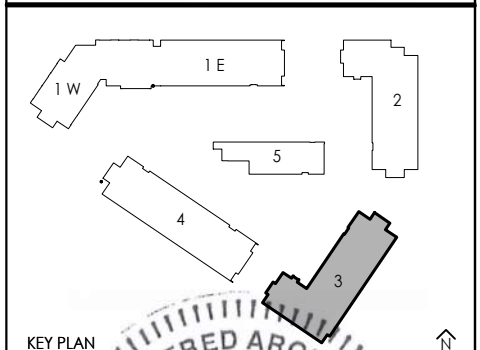
IRONCLAD DEVELOPMENTS INC.

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REV.	DESCRIPTION OF WORK REVISED	DATE

2241 SPRINGFIELD ROAD;
 Kelowna BC.

BUILDING 3 ELEVATIONS

Project Number: 2102

04-30-2020	Rev Date 06-06-2022
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Drawn By T.THIMM
 Designed By T.THIMM
 Checked By R.GARVEY

ESP-6.30

Scale 1:300



BUILDING 3 EAST ELEVATION
SCALE 1:300



BUILDING 3 WEST ELEVATION
SCALE 1:300

LEGEND

- Ⓐ HARDIE - SMOOTH (GREY)
- Ⓑ CEDAR TONE COMPOSITE MATERIAL
- Ⓒ BRICK VENEER
- Ⓓ HARDIE - SMOOTH (WHITE)
- Ⓔ METAL LAP SIDING (CREAM)
- Ⓕ METAL LAP SIDING (BLUE)
- Ⓖ METAL LAP SIDING (GREY)
- Ⓗ WOODEN TRELLIS
- Ⓘ ALUMINUM STOREFRONT (BLACK)
- Ⓢ METAL SIDING (YELLOW)
- Ⓚ ALUMINUM RAILING C/W CLEAR TEMPERED GLASS (BLACK)
- Ⓛ PVC FRAMED WINDOWS C/W CLEAR GLASS
- Ⓜ ALUMINUM PICKET RAILING

SCHEDULE B

This forms part of application # DP21-0231 DVP21-0232

Planner Initials **KB**

City of **Kelowna**
DEVELOPMENT PLANNING

Ironclad Developments Inc.



Project Management
General Contracting
Design/ Build

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Symington Rd.
Springfield, MB.
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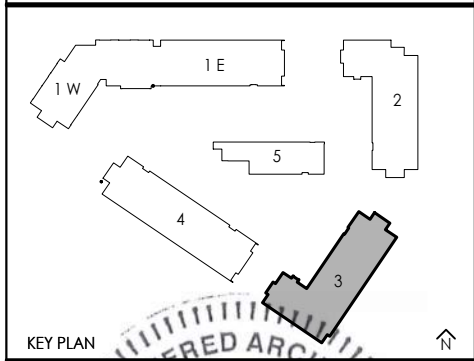
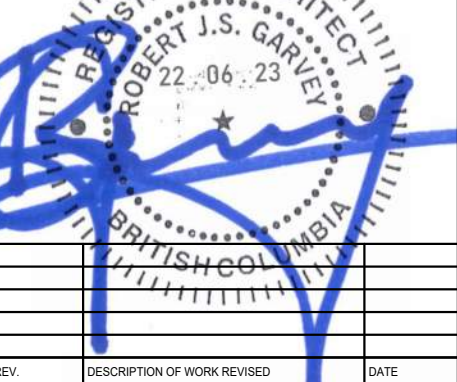
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REV.	DESCRIPTION OF WORK REVISED	DATE

2241 SPRINGFIELD ROAD;
Kelowna BC.

BUILDING 3 ELEVATIONS

Project Number: 2102

04-30-2020	Rev Date 06-06-2022
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Drawn By T.THIMM
Designed By T.THIMM
Checked By R.GARVEY

ESP-6.31

Scale 1:300



BUILDING 4 NORTH ELEVATION

SCALE 1:300



BUILDING 4 SOUTH ELEVATION

SCALE 1:300

LEGEND

- Ⓐ HARDIE - SMOOTH (GREY)
- Ⓑ CEDAR TONE COMPOSITE MATERIAL
- Ⓒ BRICK VENEER
- Ⓓ HARDIE - SMOOTH (WHITE)
- Ⓔ METAL LAP SIDING (CREAM)
- Ⓕ METAL LAP SIDING (BLUE)
- Ⓖ METAL LAP SIDING (GREY)
- Ⓗ WOODEN TRELLIS
- Ⓘ ALUMINUM STOREFRONT (BLACK)
- Ⓢ METAL SIDING (YELLOW)
- Ⓚ ALUMINUM RAILING C/W CLEAR TEMPERED GLASS (BLACK)
- Ⓛ PVC FRAMED WINDOWS C/W CLEAR GLASS
- Ⓜ ALUMINUM PICKET RAILING

SCHEDULE B

This forms part of application # DP21-0231 DVP21-0232

Planner Initials KB

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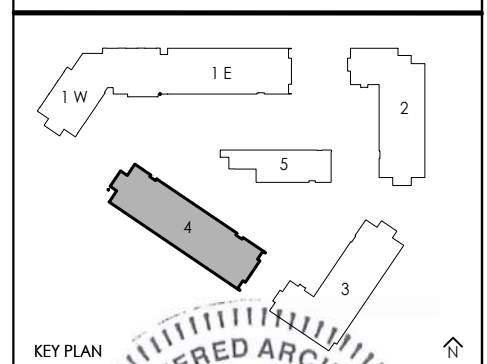
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REV.	DESCRIPTION OF WORK REVISED	DATE


2241 SPRINGFIELD ROAD;
Kelowna BC.

BUILDING 4 ELEVATIONS

Project Number: 2102
04-30-2020 Rev Date 06-06-2022
Drawn By T.THIMM
Designed By T.THIMM
Checked By R.GARVEY


ESP-6.40

Scale 1:300

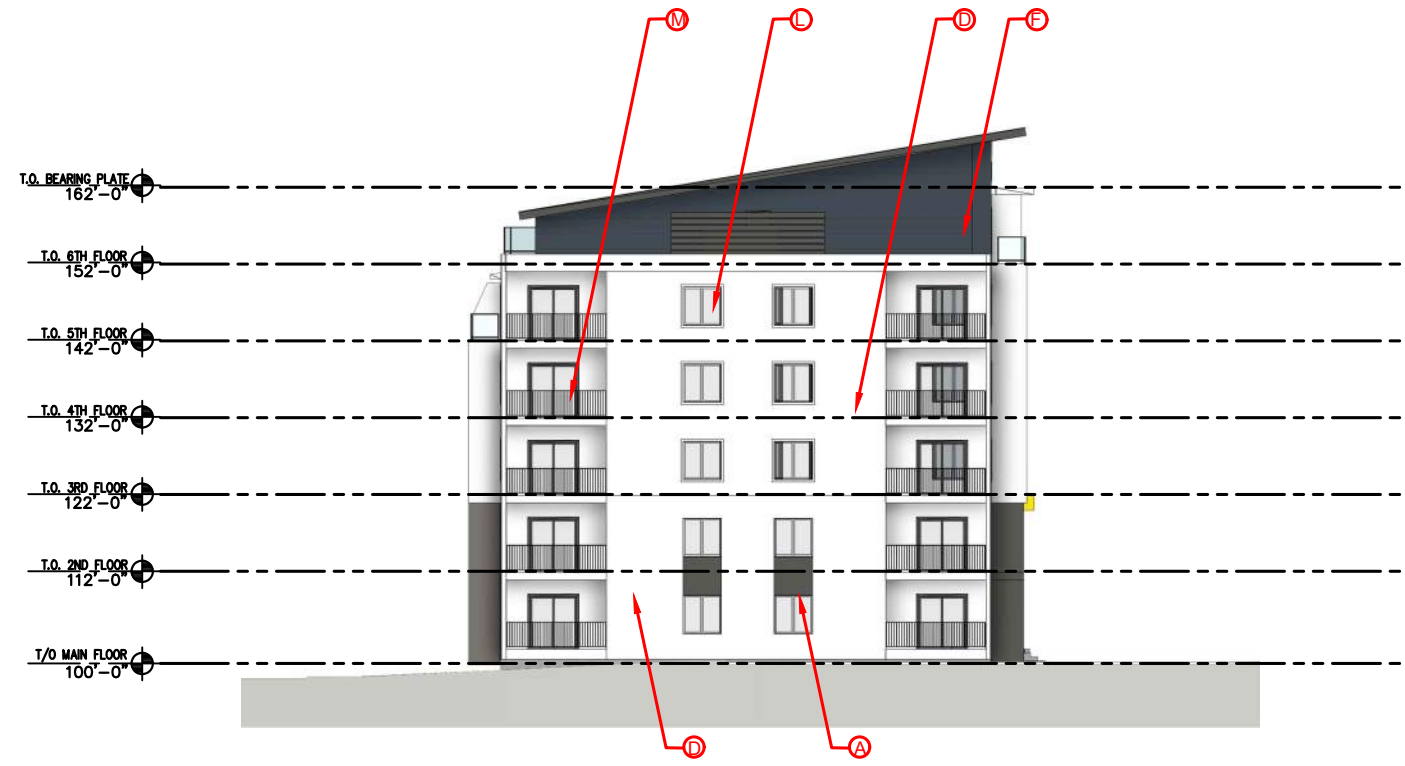

BUILDING 4 EAST ELEVATION

SCALE 1:300

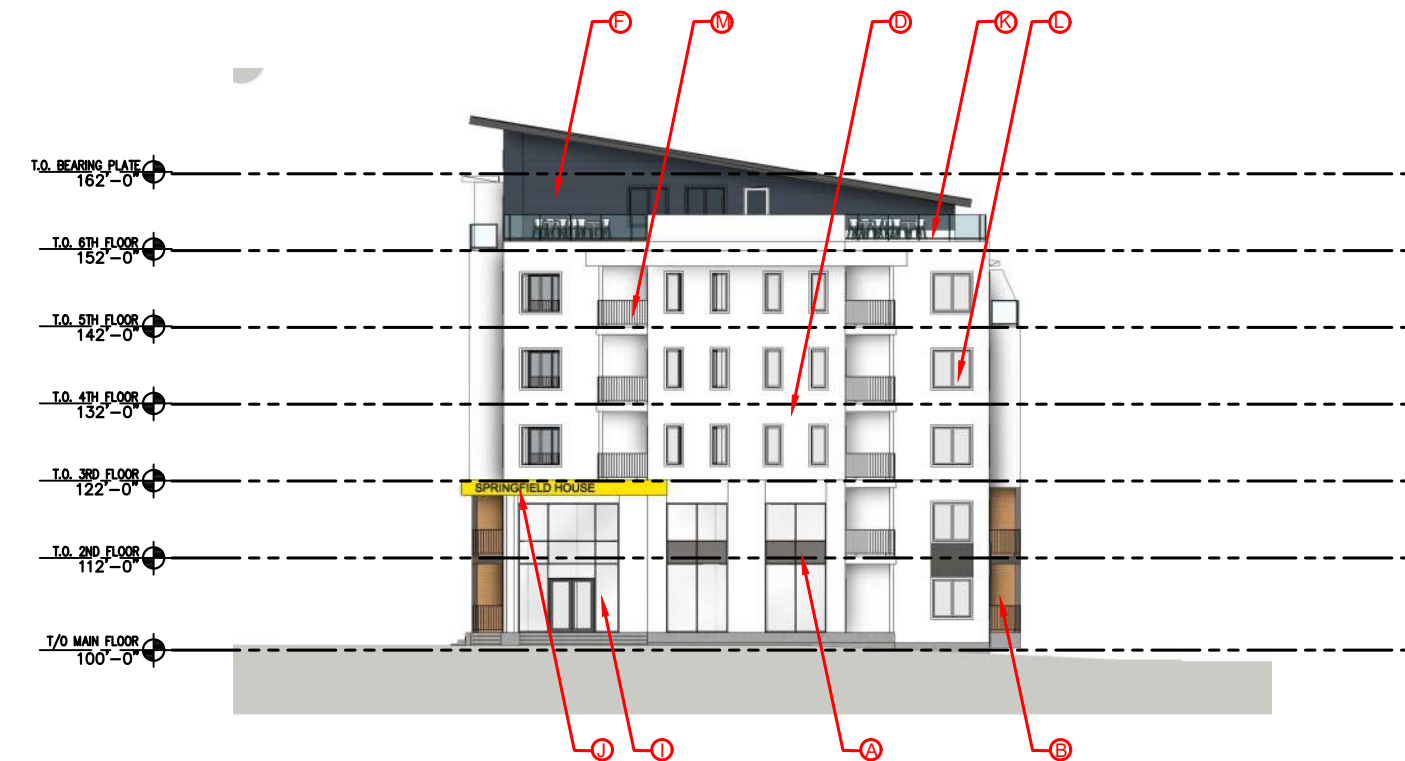

BUILDING 4 WEST ELEVATION

SCALE 1:300

SCHEDULE B

This forms part of application
DP21-0231 DVP21-0232

Planner Initials **KB**

LEGEND

- (A) HARDIE - SMOOTH (GREY)
- (B) CEDAR TONE COMPOSITE MATERIAL
- (C) BRICK VENEER
- (D) HARDIE - SMOOTH (WHITE)
- (E) METAL LAP SIDING (CREAM)
- (F) METAL LAP SIDING (BLUE)
- (G) METAL LAP SIDING (GREY)
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- (I) ALUMINUM STOREFRONT (BLACK)
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- (K) ALUMINUM RAILING C/W CLEAR TEMPERED GLASS (BLACK)
- (L) PVC FRAMED WINDOWS C/W CLEAR GLASS
- (M) ALUMINUM PICKET RAILING

Ironclad Developments Inc.

Project Management
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101-57158
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Springfield, MB.
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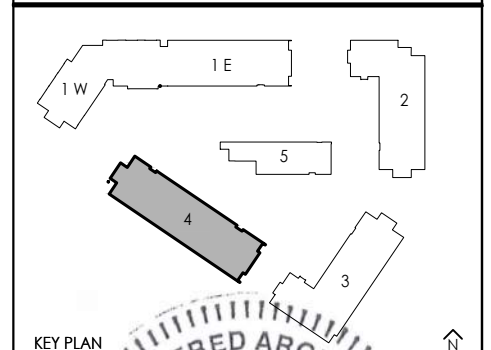
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REV.	DESCRIPTION OF WORK REVISED	DATE

2241 SPRINGFIELD ROAD;
Kelowna BC.

BUILDING 4 ELEVATIONS


Project Number: 2102

04-30-2020	Rev Date 06-06-2022
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Drawn By T.THIMM
Designed By T.THIMM
Checked By R.GARVEY

ESP-6.41

Scale 1:300

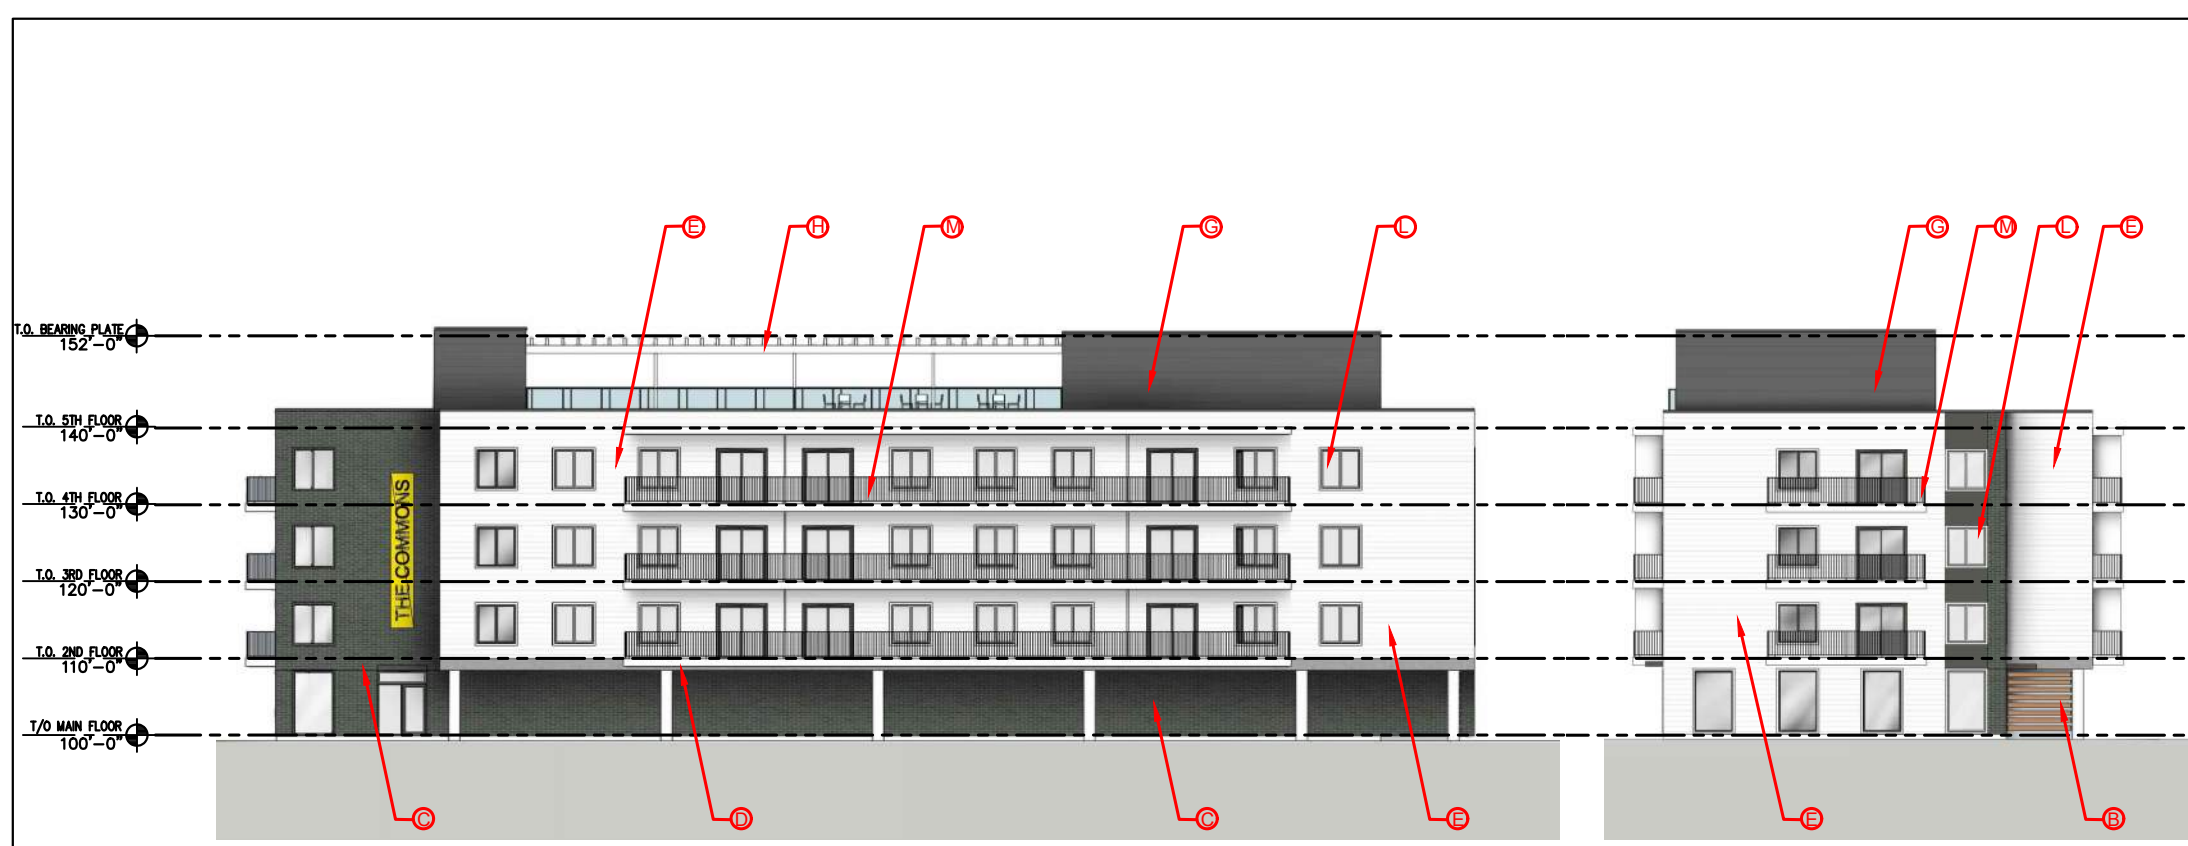

BUILDING 5 NORTH ELEVATION

SCALE 1:300

BUILDING 5 EAST ELEVATION

SCALE 1:300

LEGEND

- Ⓐ HARDIE - SMOOTH (GREY)
- Ⓑ CEDAR TONE COMPOSITE MATERIAL
- Ⓒ BRICK VENEER
- Ⓓ HARDIE - SMOOTH (WHITE)
- Ⓔ METAL LAP SIDING (CREAM)
- Ⓕ METAL LAP SIDING (BLUE)
- Ⓖ METAL LAP SIDING (GREY)
- Ⓗ WOODEN TRELLIS
- Ⓘ ALUMINUM STOREFRONT (BLACK)
- Ⓢ METAL SIDING (YELLOW)
- Ⓚ ALUMINUM RAILING C/W CLEAR TEMPERED GLASS (BLACK)
- Ⓛ PVC FRAMED WINDOWS C/W CLEAR GLASS
- Ⓜ ALUMINUM PICKET RAILING

SCHEDULE B

This forms part of application # DP21-0231 DVP21-0232

Planner Initials **KB**

City of Kelowna
DEVELOPMENT PLANNING

Ironclad Developments Inc.

Project Management
General Contracting
Design/ Build

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R2J 4L6



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BUILDING 5 SOUTH ELEVATION

SCALE 1:300

BUILDING 5 WEST ELEVATION

SCALE 1:300

2241 SPRINGFIELD ROAD;
Kelowna BC.

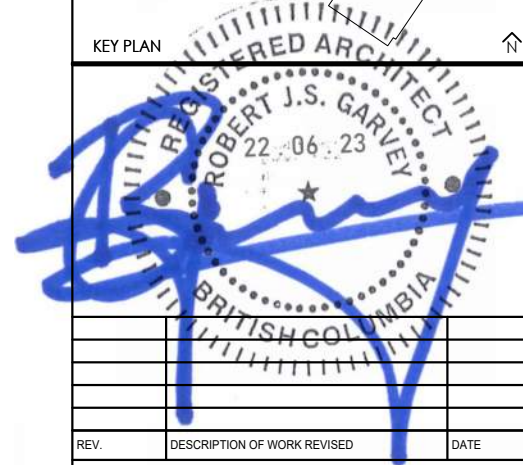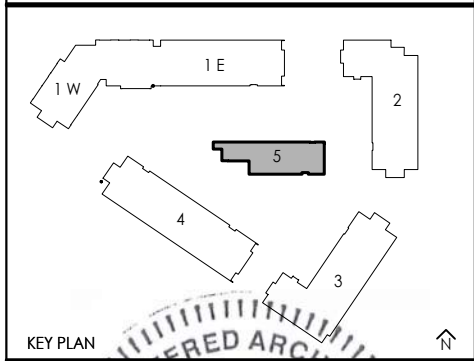BUILDING 5 ELEVATIONS

Project Number: 2102	Rev Date 06-06-2022
04-30-2020	
Drawn By T.THIMM	
Designed By T.THIMM	
Checked By R.GARVEY	

ESP-6.50

Scale 1:300



WEST ARIAL VIEW

SCALE

1:NTS



NORTH ARIAL VIEW

SCALE

1:NTS



EAST ARIAL VIEW

SCALE

1:NTS




SOUTH ARIAL VIEW

SCALE

1:NTS

Ironclad Developments Inc.

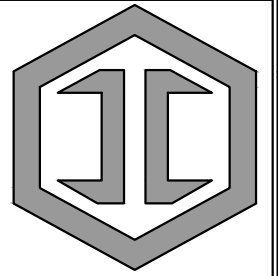

Project Management
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Design/ Build


101-57158
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Springfield, MB.
R2J 4L6

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DEVELOPMENTS INC.

Consultant




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SCHEDULE B

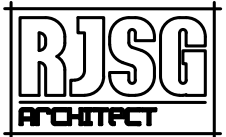This forms part of application
DP21-0231 DVP21-0232

Planner
Initials KB



REV.	DESCRIPTION OF WORK REVISED	DATE

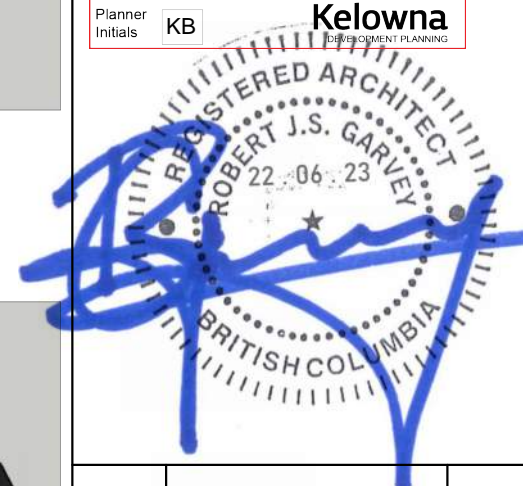2241 SPRINGFIELD ROAD;
Kelowna BC.

3D RENDERINGS

Project Number: 2102

04-30-2020

Rev Date 06-06-2022

Drawn By T.THIMM

Designed By T.THIMM

Checked By R.GARVEY

ESP-7.0

Scale

NTS



PARKING ENTRANCE VIEW

SCALE NTS



BUILDING 3 ROOFTOP PATIO VIEW

SCALE NTS



BUILDING 5 ROOFTOP PATIO VIEW

SCALE NTS



BUILDING 1 PARKING VIEW

SCALE NTS



BUILDING 1 STREET VIEW

SCALE NTS



BUILDING 3 AND 5 VIEW

SCALE NTS

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Design/ Build

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Springfield, MB.
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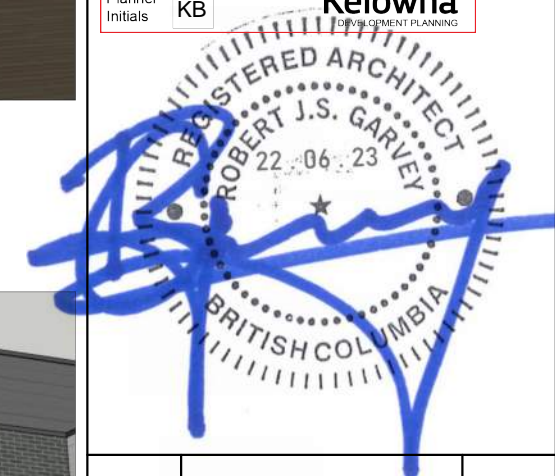
SCHEDULE B

This forms part of application
DP21-0231 DVP21-0232



City of
Kelowna
DEVELOPMENT PLANNING

Planner Initials **KB**



REV.	DESCRIPTION OF WORK REVISED	DATE

2241 SPRINGFIELD ROAD;
Kelowna BC.

3D RENDERINGS

Project Number: 2102

04-30-2020	Rev Date 06-06-2022
Drawn By	T.THIMM
Designed By	T.THIMM
Checked By	R.GARVEY

ESP-7.1

Scale NTS



Springfield Road, Kelowna BC. - Shadow Study
GMT - 0700 20th March - 9 am



Springfield Road, Kelowna BC. - Shadow Study
GMT - 0700 21st June - 9 am



Springfield Road, Kelowna BC. - Shadow Study
GMT - 0700 20th March - 12 pm



Springfield Road, Kelowna BC. - Shadow Study
GMT - 0700 21st June - 12 pm



Springfield Road, Kelowna BC. - Shadow Study
GMT - 0700 20th March - 3 pm



Springfield Road, Kelowna BC. - Shadow Study
GMT - 0700 21st June - 3 pm

SPRING EQUINOX

SUMMER SOLTICE


SHADOW 

SCHEDULE B
This forms part of application
DP21-0231 DVP21-0232
Planner Initials KB
City of Kelowna DEVELOPMENT PLANNING

Ironclad Developments Inc.

Project Management
General Contracting
Design/ Build
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REV.	DESCRIPTION OF WORK REVISED	DATE

2241 SPRINGFIELD ROAD;
Kelowna BC.

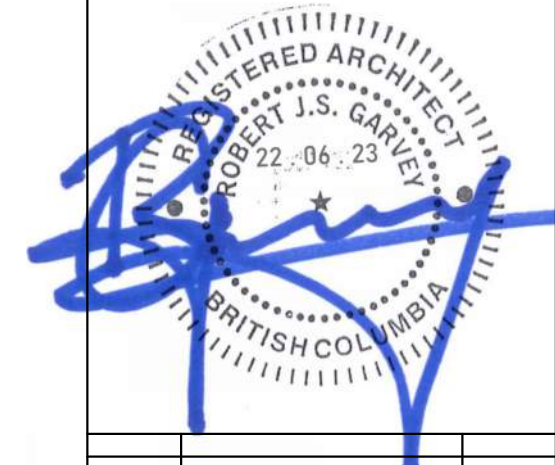SHADOW STUDIES

Project Number: 2102

04-30-2020	Rev Date 06-06-2022
Drawn By	T.THIMM
Designed By	T.THIMM
Checked By	R.GARVEY

ESP-8.0

Scale NTS




Springfield Road, Kelowna BC. - Shadow Study
GMT - 0700 22nd September - 9 am



Springfield Road, Kelowna BC. - Shadow Study
GMT - 0700 21st December - 9 am



Springfield Road, Kelowna BC. - Shadow Study
GMT - 0700 22nd September - 12 pm

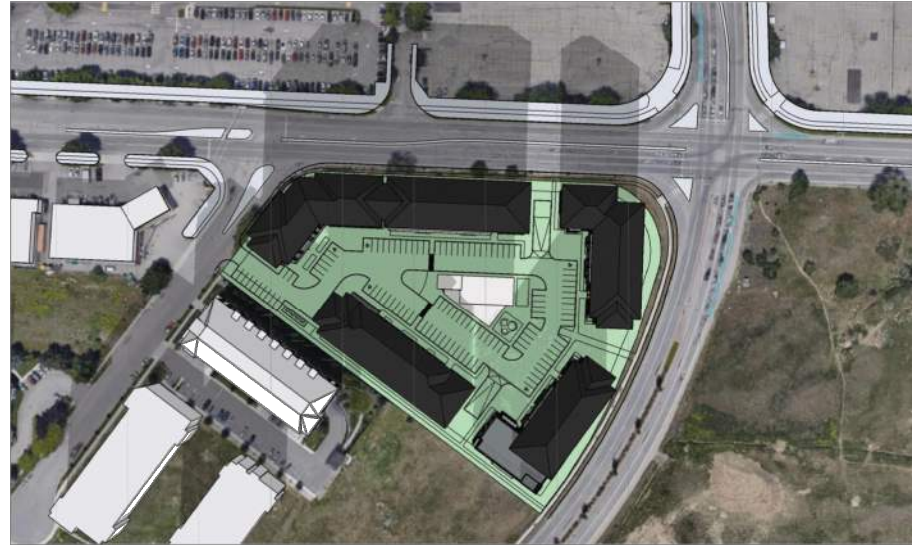

Springfield Road, Kelowna BC. - Shadow Study
GMT - 0700 21st December - 12 pm



Springfield Road, Kelowna BC. - Shadow Study
GMT - 0700 22nd September - 3 pm



Springfield Road, Kelowna BC. - Shadow Study
GMT - 0700 21st December - 3 pm

FALL EQUINOX

WINTER SOLTICE

SHADOW 

SCHEDULE B

This forms part of application
DP21-0231 DVP21-0232

Planner Initials **KB**



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Design/ Build

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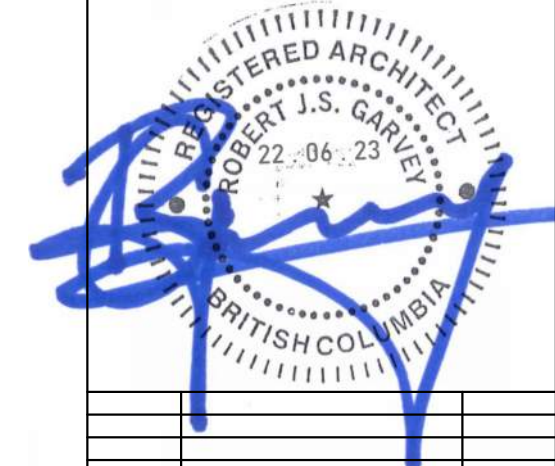
IRONCLAD DEVELOPMENTS INC.

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REV.	DESCRIPTION OF WORK REVISED	DATE


2241 SPRINGFIELD ROAD;
Kelowna BC.

SHADOW STUDIES

Project Number: 2102	
04-30-2020	Rev Date 06-06-2022
Drawn By	T.THIMM
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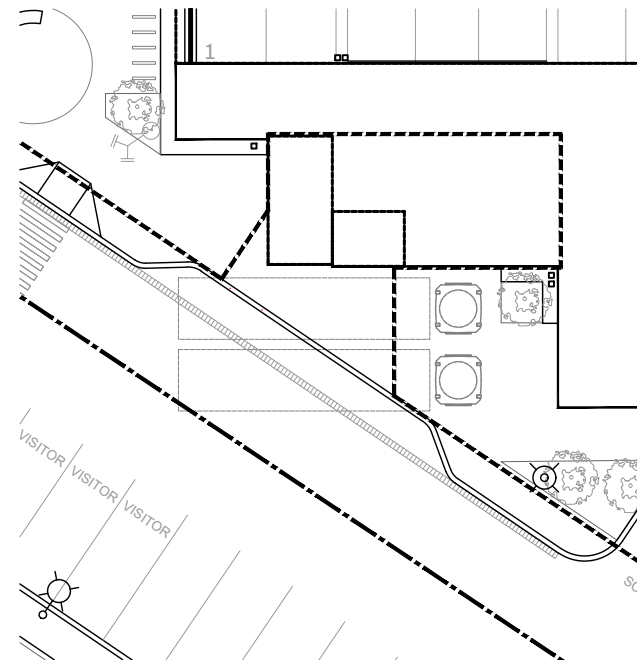
ESP-8.1

Scale NTS

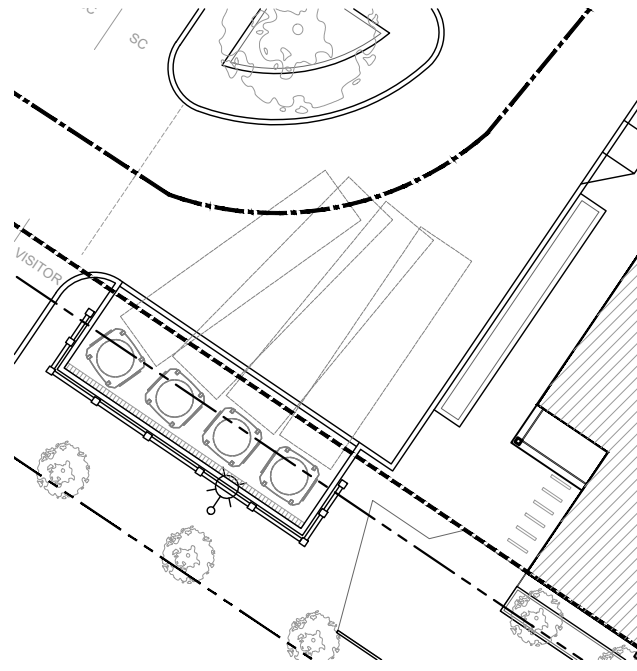


EAST REFUSE PLAN

SCALE 1:300








CENTER REFUSE PLAN

SCALE 1:300

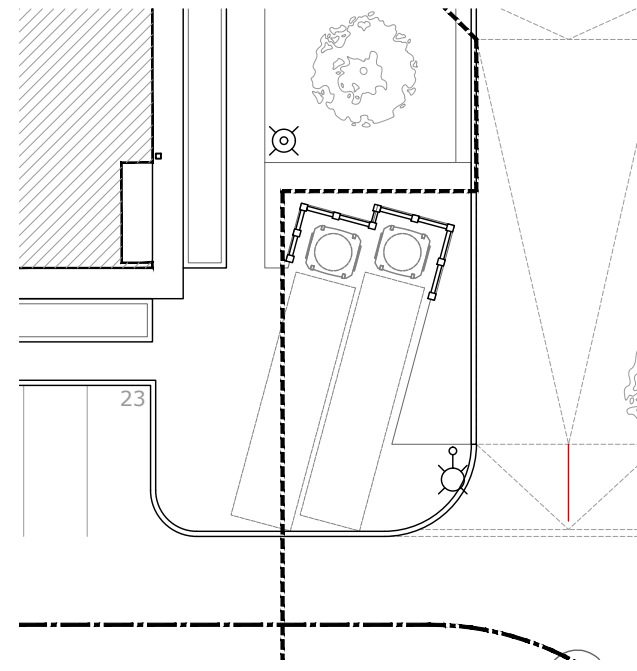

NORTH REFUSE PLAN

SCALE 1:300

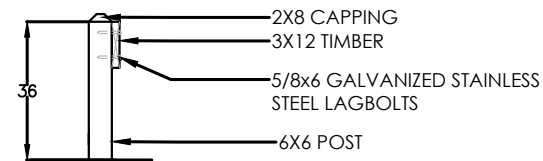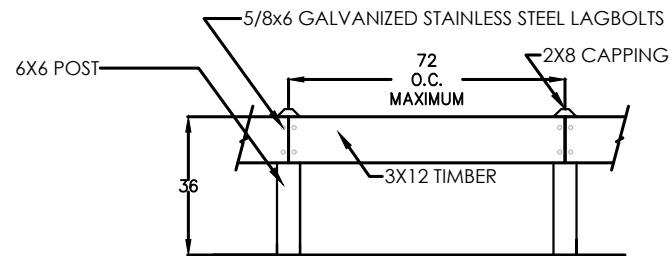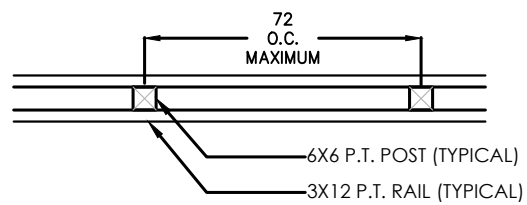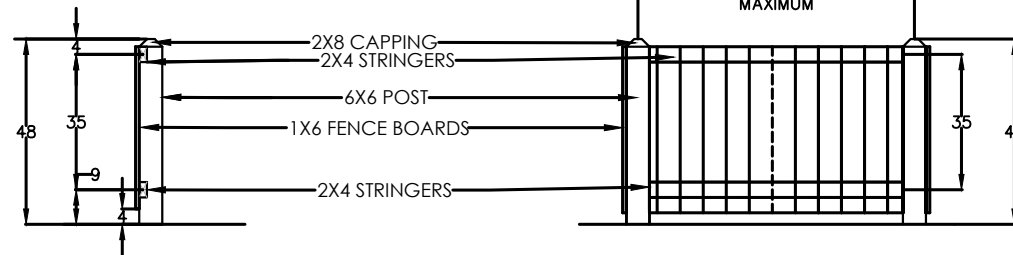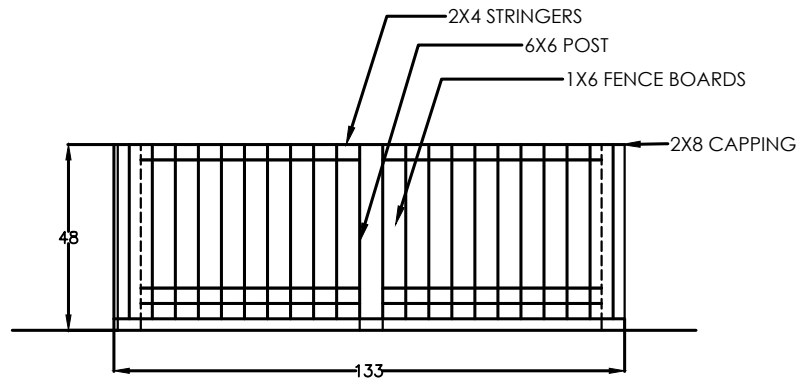

FENCE DETAILS

SCALE 1:50

Ironclad Developments Inc.



Project Management
General Contracting
Design/ Build

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REV.	DESCRIPTION OF WORK REVISED	DATE

2241 SPRINGFIELD ROAD;
Kelowna BC.

REFUSE AND FENCE DETAIL

Project Number: 2102

04-30-2020	Rev Date 06-06-2022
Drawn By T.THIMM	Designed By T.THIMM
Checked By R.GARVEY	

SCHEDULE C


This forms part of application
DP21-0231 DVP21-0232



Planner Initials **KB**

ESP-9.0

Scale AS NOTED

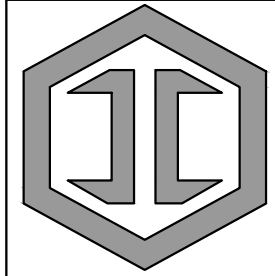

IRONCLAD
DEVELOPMENTS INC.

Consultant

RJSG
ARCHITECT

ROB J.S. GARVEY, ARCHITECT
MAA, AIBC, LEED AP


201-57158 SYMINGTON RD 20E
SPRINGFIELD, MB R2J 4L6
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SCHEDULE C

This forms part of application
DP21-0231 DVP21-0232

City of Kelowna
DEVELOPMENT PLANNING

Planner Initials KB

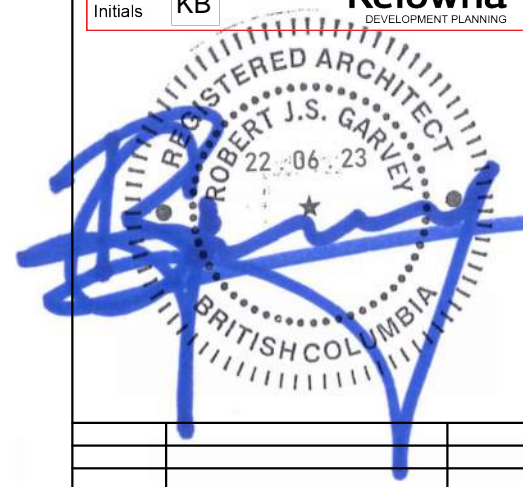

REV.	DESCRIPTION OF WORK REVISED	DATE

2241 SPRINGFIELD ROAD;
Kelowna BC.


EARTH BIN DETAIL

Project Number: 2102

04-30-2020	Rev Date 06-06-2022
Drawn By T.THIMM	
Designed By T.THIMM	
Checked By R.GARVEY	

ESP-9.1

NOTE:
CONTRACTOR TO ENSURE ADEQUATE SPACE TO PHYSICAL BARRIER OR OBSTRUCTION TO ALLOW BIN TO BE PICKED UP.

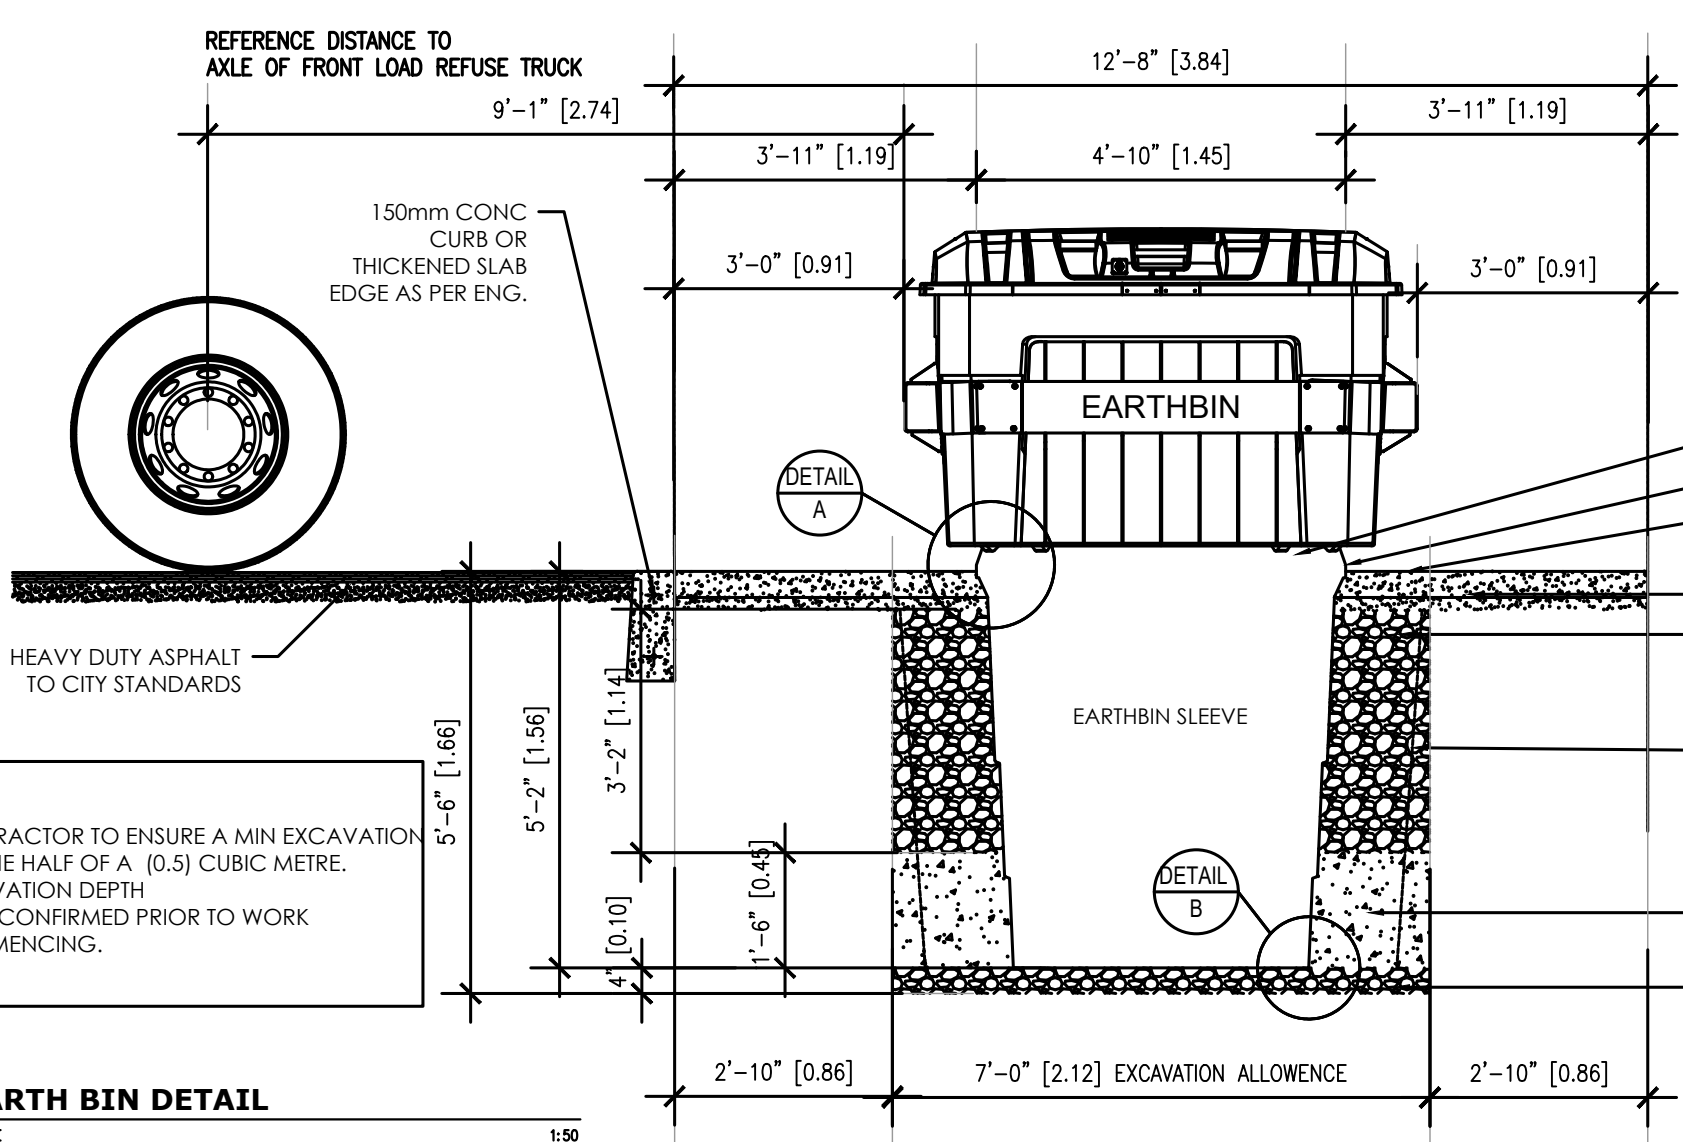

NOTE:
CONTRACTOR TO ENSURE A MIN EXCAVATION OF ONE HALF OF A (0.5) CUBIC METRE. EXCAVATION DEPTH TO BE CONFIRMED PRIOR TO WORK COMMENCING.


EARTH BIN DETAIL

SCALE 1:50

ANCHOR PIN NOTE:
PLACE ANCHOR PINS (X8) IN HOLES AROUND GROUND SLEEVE PRIOR TO POURING CONCRETE. ENSURE THERE IS A MIN 150mm EMBEDMENT FOR ANCHOR PINS. ANCHOR PINS ARE TO HAVE A MIN 100mm OF COVERAGE ABOVE AND BELOW.

NOTE:
DRAWINGS AND SPECS COPIED FROM WEB SITE EARTH-BIN.

NOTE:
THE USE OF SHIMS TO SET SLEEVE PRIOR TO POURING CONCRETE IS ALLOWED.

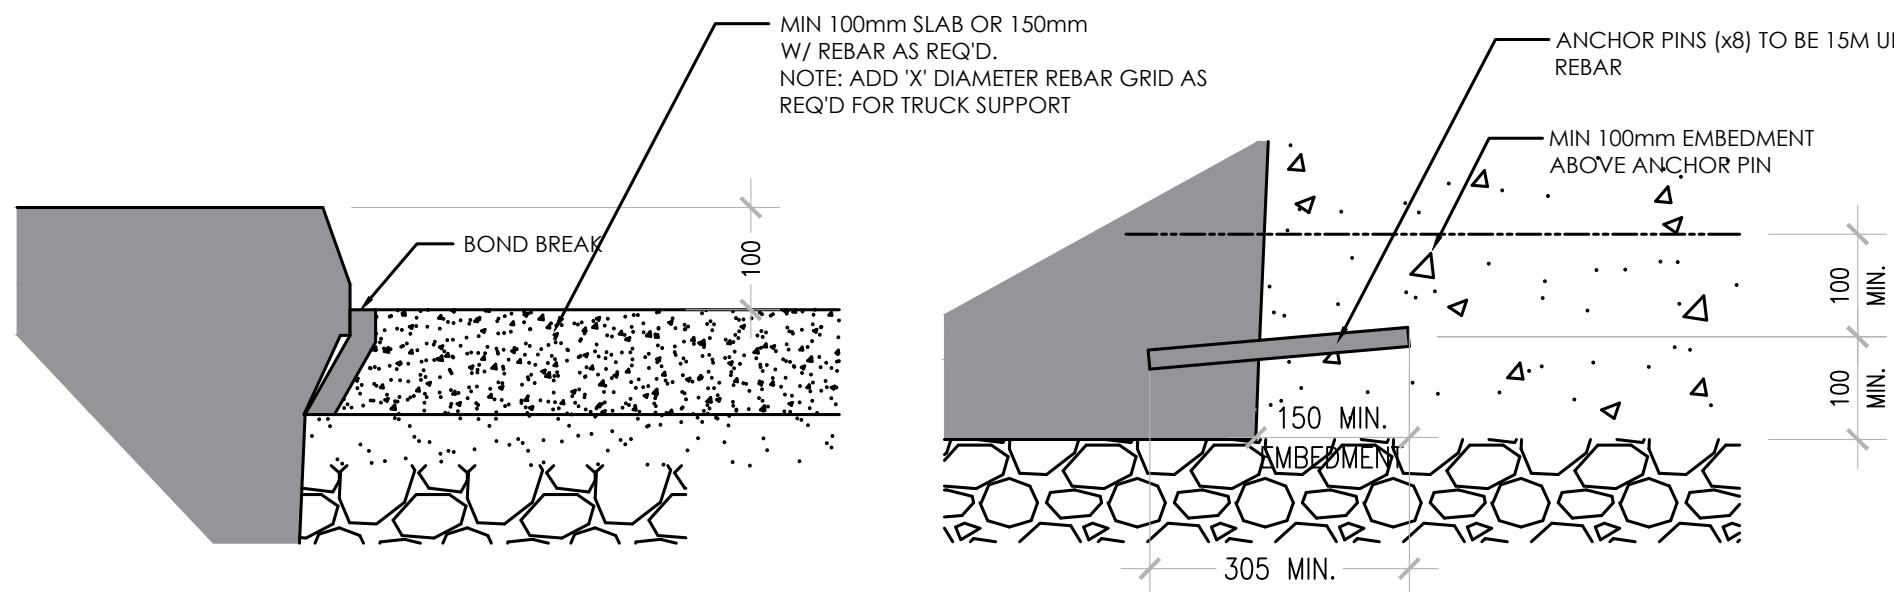

DETAIL A

SCALE 1:10

DETAIL B

SCALE 1:10



LEGEND

- PROPERTY LINES
- UNDERGROUND PARKEAGE
- BRUSH FINISH CONCRETE WALKWAYS - REFER TO CIVIL ENG DWGS
- DECORATIVE PAVING AREAS BRICK UNIT PAVING, EXPOSED AGGREGATE OR STAMPED CONCRETE FINISH - TBD
- DRAIN ROCK c/w 2" x 4" PTW EDGER 200 MM DEPTH MIN TYP. LOCALLY AVAILABLE 3"-6" DIA. WASHED ROUND RIVER ROCK ON APPROVED FILTER FABRIC.
- LAWN = SOD ON 150 MM MIN DEPTH APPROVED GROWING MEDIUM
- PLANTING BED c/w 60 MM OF 3/4" WASHED ROCK GROUND COVER (TYP) ON FILTER FABRIC ON AN APPROVED GROWING MEDIUM. 450 MM MIN DEPTH FOR SHRUBS 700 MM MIN FOR TREES
- 2 METER (6.5') HT. PRESSURE TREATED WOOD PRIVACY FENCE
- 1.5 METER (5') HT. BLACK CHAIN LINK FENCE (DOG RUN)
- 1.2 METER (4') HT. BLACK METAL PICKET FENCE
- PRESSURE TREATED WOOD EDGER LAWN / PLANTING / ROCK SEPARATIONS
- NATURAL ACCENT BOULDERS
- SKYLINE PARK BENCH BY WISHBONE (CURVED & STRAIGHT)
- SINGLE AND MULTI SPACE BIKE RACKS SECURED TO CONCRETE WALKWAY
- BEAR PROOF GARBAGE BIN
- PRESSURE TREATED WOOD PLANTERS WITH OPEN BOTTOM c/w 60 MM DEPTH MULCH ON APPROVED FILTER FABRIC ON 400 mm - 700 mm DEPTH GROWING MEDIUM.
- PRECAST CONCRETE (BLOCK OR CIP) RAISED PLANTER OPEN BOTTOM c/w 60 MM DEPTH MULCH ON APPROVED FILTER FABRIC ON 400 mm - 700 mm DEPTH GROWING MEDIUM.

PROJECT PLANT LIST


SYMBOL	BOTANICAL NAME	COMMON NAME	COUNT	SIZE
TREES				
Am	<i>Amenchier x grandiflora</i>	Autumn Brilliance Serviceberry (multistem)	5	50mm Cal
Am	<i>Acer glabrum</i>	Amur Maple	11	50mm Cal
Aq	<i>Acer ariseum</i>	Paperbark Maple	17	50mm Cal
Fr	<i>Fraxinus sylvatica 'Green Dawyck'</i>	Dawyck Green Sycamore	10	60mm Cal
Pr	<i>Prunus nigra</i>	Black Cherry	1	2m
PrH	<i>Prunus pennsylvanica 'Hoopoe'</i>	Hoopoe Blue Spruce	22	2m
Pr	<i>Prunella americana</i>	Common Blackberry	44	60mm Cal
PrA	<i>Prunus americana</i>	Amanogawa Cherry Tree	48	50mm Cal
Th	<i>Tilia monoeloides 'Harvest Gold'</i>	Harvest Gold Linden	18	60mm Cal
BE	<i>Ulmus americana 'Bronson'</i>	Bronson Elm	10	60mm Cal
SHRUBS				
ABN	<i>Abies balsamea Nana</i>	Dwarf Balsam Fir	175	#2pot
CaK	<i>Cornus sericea 'Kelsey'</i>	Dwarf Kelsey Dogwood	301	#2pot
CaS	<i>Caragana albescens 'Southland'</i>	Southland Caragana	26	#2pot
C	<i>Cotoneaster lucidus/aquifolia</i>	Cotoneaster Hedge	197	#2pot
CC	<i>Caryopteris x clandonensis</i>	Bluebeard, Blue Mist Spirea	32	#2pot
HA	<i>Hydrangea arborescens 'Annabelle'</i>	Annabelle Hydrangea	40	#2pot
HR	<i>Rosa rugosa 'Henry Hudson'</i>	Henry Hudson Rose (White)	55	#2pot
JH	<i>Juniperus horizontalis 'Andromid'</i>	Andromid Juniper	9	#2pot
JH	<i>Juniperus horizontalis 'Blue Draper'</i>	Blue Prince Juniper	22	#2pot
JH	<i>Juniperus communis 'Ezra'</i>	Horizontal Natchez Juniper	31	#2pot
pr	<i>Philadelphus x virginicus 'Dwarf Snowball'</i>	Miniature Snowflake Mock Orange	42	#2pot
Sp	<i>Spiraea x bumalda 'Goldflame'</i>	Goldflame Spirea	195	#2pot
Sh	<i>Sumololcarpos albus</i>	Snowberry	5	#2pot
Y	<i>Yucca filamentosa 'Golden Sword'</i>	Golden Sword Yucca	73	#1pot
Y	<i>Yucca aloecoides</i>	Sword Yucca	67	#1pot
ORNAMENTAL GRASSES				
Ck	<i>Calamagrostis x acutifolia 'Karl Foerster'</i>	Feather Reed Grass	436	#1pot
Dc	<i>Deschampsia cespitosa</i>	Tufted Hairgrass	374	#1pot
H	<i>Helictotrichon sempervirens</i>	Blue Oak Grass	45	#1pot
Sh	<i>Sporobolus heterolepis</i>	Prairie Dropseed	132	#1pot
ka	<i>Koeleria glauca</i>	Blue Hair Grass	60	#1pot
PERENNIALS/GROUNDCOVERS				
A	<i>Allium cepa</i>	Nodding Onion	48	#1pot
C	<i>Clematis jackmani</i>	Jackmani Clematis	7	#1pot
K	<i>Arctostaphylos uva-ursi</i>	Kinnikinnick	17	100mm pot
DS	<i>Perovskia atrorubra 'Little Spire'</i>	Dwarf Russian Sage	36	#1pot
E	<i>Echinacea purpurea</i>	Purple Coneflower	28	#1pot
N	<i>Nepeta x faassenii 'Dronomo'</i>	Dronomo Catmint	42	#1pot
Y	<i>Yucca filamentosa 'Soleil'</i>	Golden Sword Yucca	67	#1pot

SCHEDULE C

This forms part of application # DP21-0231 DVP21-0232

Planner Initials **KB**

NOTE: ALL WORK AND MATERIALS SHALL BE TO CANADIAN LANDSCAPE STANDARDS

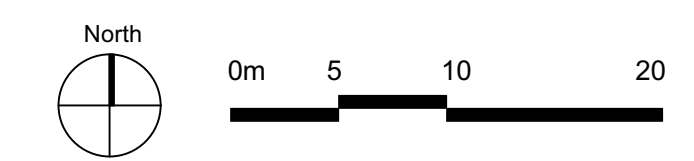

IRONCLAD DEVELOPMENTS INC.

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Date	Revisions	By
Sept 9-21	Progress Review	SD
Sept 13-21	Progress Review	SD
Jun 20 22	Progress Review	SD/LS

LAZZARIN SVISDAHL
LANDSCAPE ARCHITECTS

203-1300 1st Avenue, Prince George B.C. V2L 2Y3
250-563-6158 www.isla-landarch.com

Project
2241 SPRINGFIELD ROAD
KELOWNA, BC

Sheet Title
Landscape Plan

Date
July 05, 2021

Scale
1:350 METERS

Drawn By
SD/LS

Project No.

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Drawing No.


L1

PROPOSED PROJECT TREES



Harvest Gold Linden (Summer & Fall) | Dawyck Gold Beech | Paper Bark Maple | Brandon Elm | Amur Maple | Autumn Brilliance Serviceberry | Colorado Blue Spruce

POTENTIAL BOULEVARD STREETSCAPE TREE OPTIONS

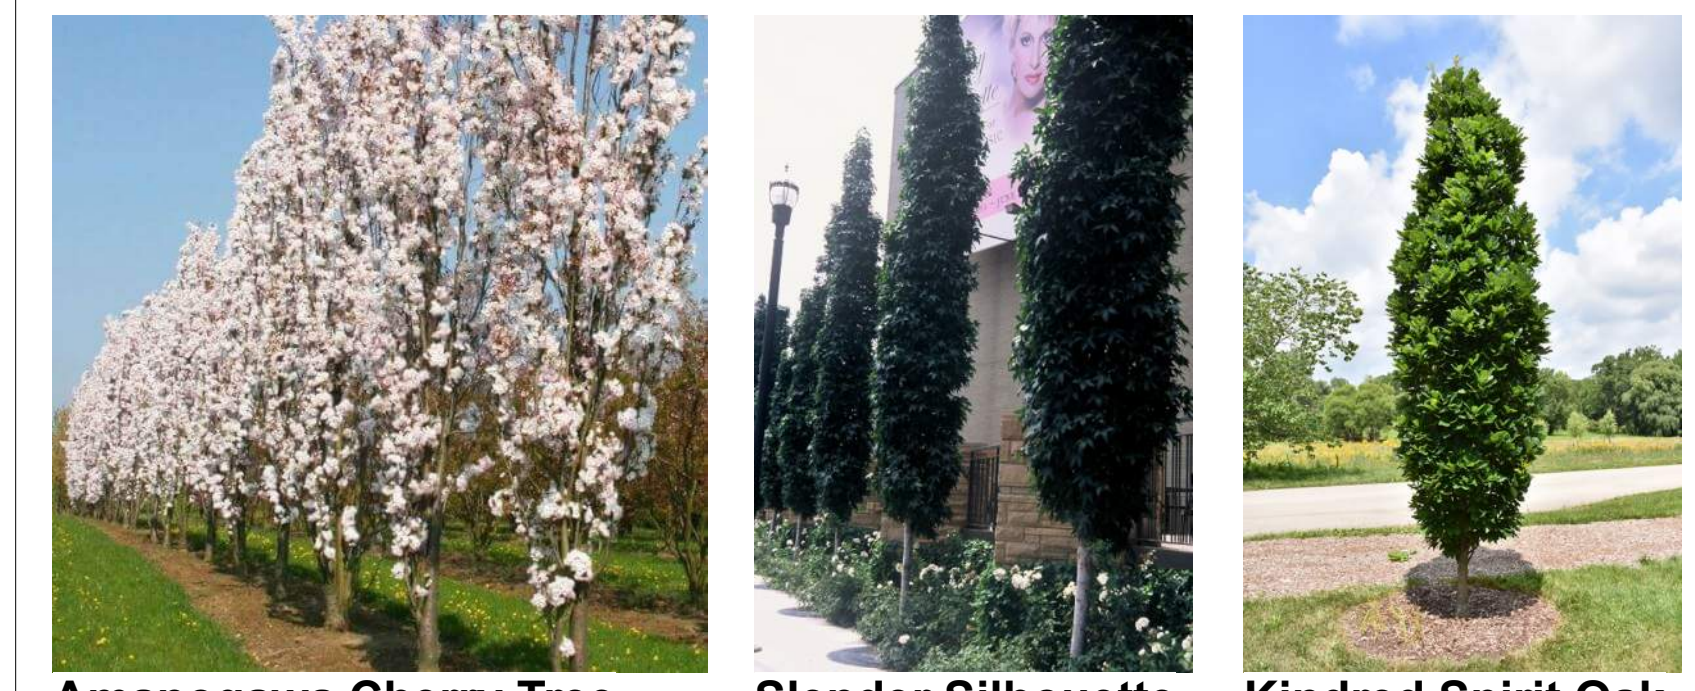


Amanogawa Cherry Tree | Slender Silhouette Sweetgum | Kindred Spirit Oak

SCHEDULE C

This forms part of application
DP21-0231 DVP21-0232

Planner Initials **KB**

City of **Kelowna**
DEVELOPMENT PLANNING

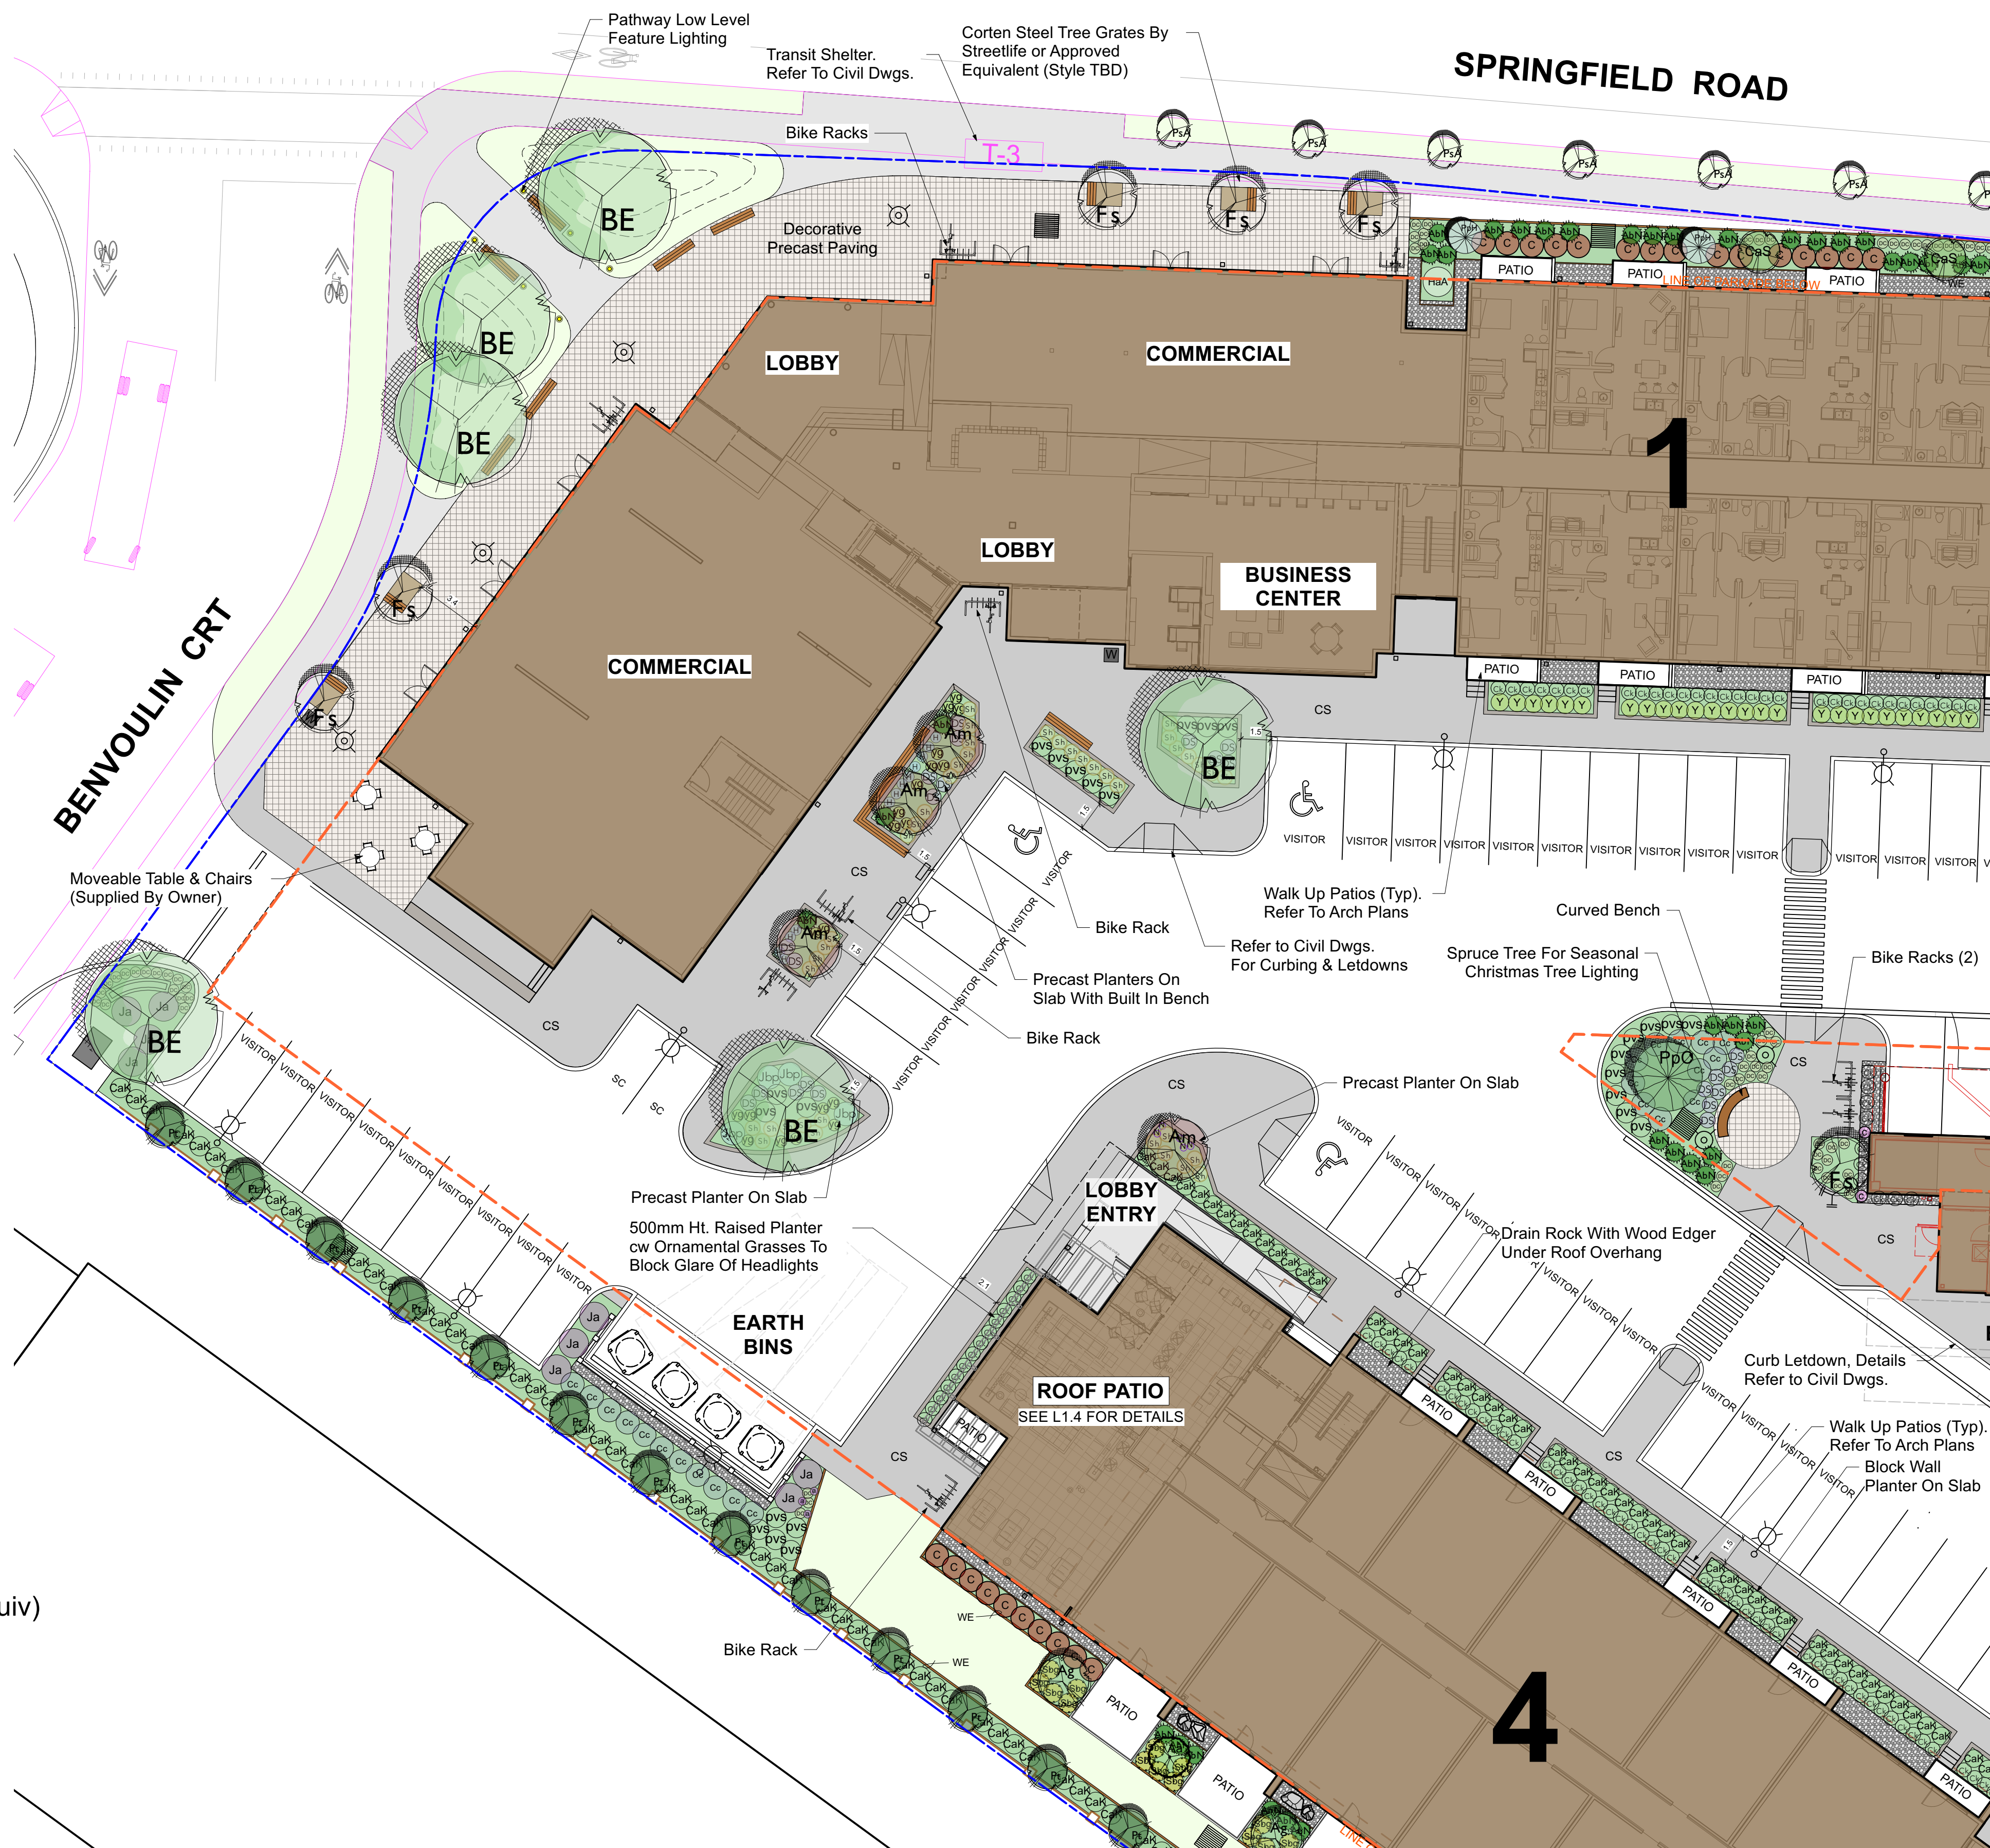

LEGEND

- PROPERTY LINES
- UNDERGROUND PARKADE
- BRUSH FINISH CONCRETE WALKWAYS - REFER TO CIVIL DWGS
- DECORATIVE PAVING AREAS: BRICK UNIT PAVING, EXPOSED AGGREGATE OR STAMPED CONCRETE FINISH - TBD
- DRAIN ROCK CW 2" x 4" PTW EDGER 200 MM DEPTH MIN TYP. LOCALLY AVAILABLE 3"-4" DIA. WASHED ROUND RIVER ROCK ON APPROVED FILTER FABRIC.
- LAWN = SOD ON 150 MM MIN DEPTH APPROVED GROWING MEDIUM
- PLANTING BED CW 60 MM OF 3/4" WASHED ROCK GROUND COVER (TYP) ON FILTER FABRIC ON AN APPROVED GROWING MEDIUM. 450 MM MIN DEPTH FOR SHRUBS 700 MM MIN FOR TREES
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Date	Revisions	By
Jun 20 22	Progress Review	SD/LS

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Project
2241 SPRINGFIELD ROAD
KELOWNA, BC

Sheet Title
**Landscape Plan
Enlargement 1**

Date July 05, 2021

Scale 1:200 METERS

Drawn By SD/LS

Project No.


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L 1.1



TREE GRATE WITH BENCH
PRECEDENT IMAGE FOR TREE GRATE BENCH LAYOUT (SEE PROJECT BENCH NOTED BELOW FOR PROPOSED PRODUCT)

PROJECT BENCHES

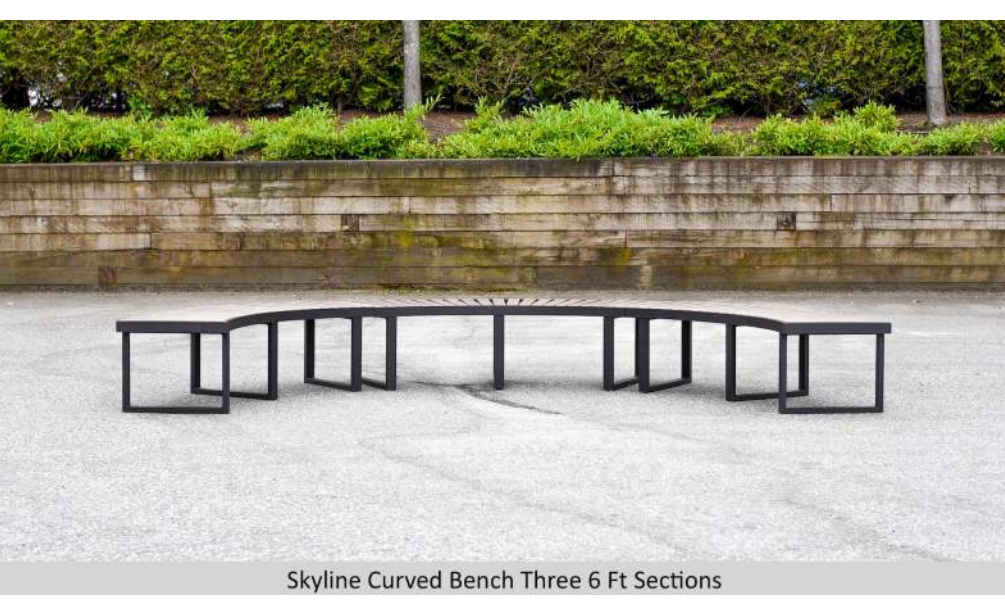

Skyline Curved Park Bench
Model Number: **SLCB-11**
Wishbone Site Furnishings Ltd.(or approved equiv)



Skyline Park Bench
Model Number: **SLB-6**
Wishbone Site Furnishings Ltd.(or approved equiv)


Powder Coated Black Metal Base and Arm Rests
Walnut Colour Plastic Lumbar Seat Boards
Surface Mount To Concrete Walkway with Manufacture Supplied Hardware



PRECAST BLOCK PLANTER
Allan Block Splittfaced Planters On Slab (or Approved Equivalent)



Bike Rack
Cora Bike Rack (or Approved Equivalent)
Powder Coated Aluminim (Colour To Be Determined)

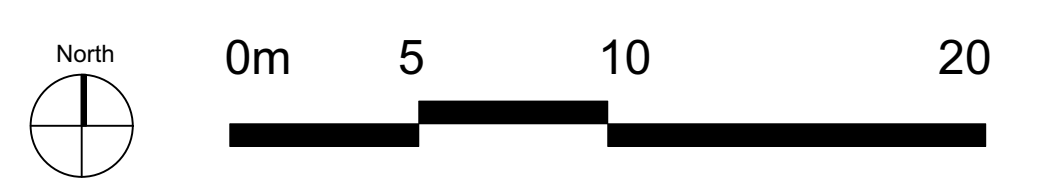

NOTE: ALL WORK AND MATERIALS SHALL BE TO CANADIAN LANDSCAPE STANDARDS



Play Berm with Climbing Features & Fall Surface Artificial Turf
A soft, cushioned play surface with fall zones safety-rated to 16 feet.



PLAY BERM PRECEDENT

LEGEND

- PROPERTY LINES
- UNDERGROUND PARKADE
- BRUSH FINISH CONCRETE WALKWAYS - REFER TO CIVIL ENG DWGS
- DECORATIVE PAVING AREAS BRICK UNIT PAVING, EXPOSED AGGREGATE OR STAMPED CONCRETE FINISH - TBD
- DRAIN ROCK CW 2" x 4" PTW EDGER 200 MM DEPTH MIN TYP. LOCALLY AVAILABLE 3'-6" DIA. WASHED ROUND RIVER ROCK ON APPROVED FILTER FABRIC.
- LAWN = SOD ON 150 MM MIN DEPTH APPROVED GROWING MEDIUM
- PLANTING BED CW 60 MM OF 3/4" WASHED ROCK GROUND COVER (TYP) ON FILTER FABRIC ON AN APPROVED GROWING MEDIUM. 450 MM MIN DEPTH FOR SHRUBS 700 MM MIN FOR TREES
- 2 METER (6.5') HT. PRESSURE TREATED WOOD PRIVACY FENCE
- 1.5 METER (5') HT. BLACK CHAIN LINK FENCE (DOG RUN)
- 1.2 METER (4') HT. BLACK METAL PICKET FENCE
- PRESSURE TREATED WOOD EDGER LAWN / PLANTING / ROCK SEPARATIONS
- NATURAL ACCENT BOULDERS
- SKYLINE PARK BENCH BY WISHBONE (CURVED & STRAIGHT)
- SINGLE AND MULTI SPACE BIKE RACKS SECURED TO CONCRETE WALKWAY
- BEAR PROOF GARBAGE BIN
- PRESSURE TREATED WOOD PLANTERS WITH OPEN BOTTOM CW 60 MM DEPTH MULCH ON APPROVED FILTER FABRIC ON 400 mm - 700 mm DEPTH GROWING MEDIUM.
- PRECAST CONCRETE (BLOCK OR CIP) RAISED PLANTER OPEN BOTTOM CW 60 MM DEPTH MULCH ON APPROVED FILTER FABRIC ON 400 mm - 700 mm DEPTH GROWING MEDIUM.

SCHEDULE C
This forms part of application # DP21-0231 DVP21-0232
City of Kelowna DEVELOPMENT PLANNING
Planner Initials KB

PROJECT BENCHES




Skyline Curved Park Bench
Model Number: **SLCB-11**
Wishbone Site Furnishings Ltd.(or approved equiv)



Skyline Park Bench
Model Number: **SLB-6**
Wishbone Site Furnishings Ltd.(or approved equiv)

Powder Coated Black Metal Base and Arm Rests
Walnut Colour Plastic Lumbar Seat Boards
Surface Mount To Concrete Walkway with Manufacture Supplied Hardware

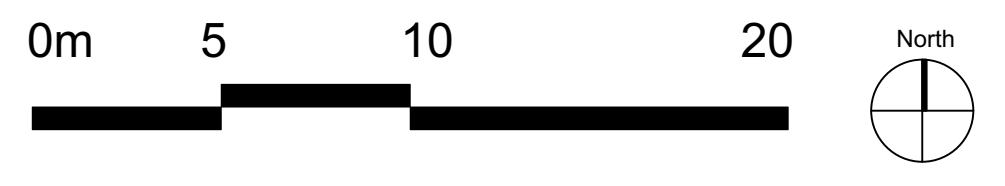

NOTE: ALL WORK AND MATERIALS SHALL BE TO CANADIAN LANDSCAPE STANDARDS



PRECAST BLOCK PLANTER
Allan Block Splittfaced Planters On Slab (or Approved Equivalent)



Bike Rack
Cora Bike Rack (or Approved Equivalent)
Powder Coated Aluminium (Colour To Be Determined)

Courtyard
Courtyard Seating & Planting



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Date	Revisions	By
Jun 20 22	Progress Review	SD/LS

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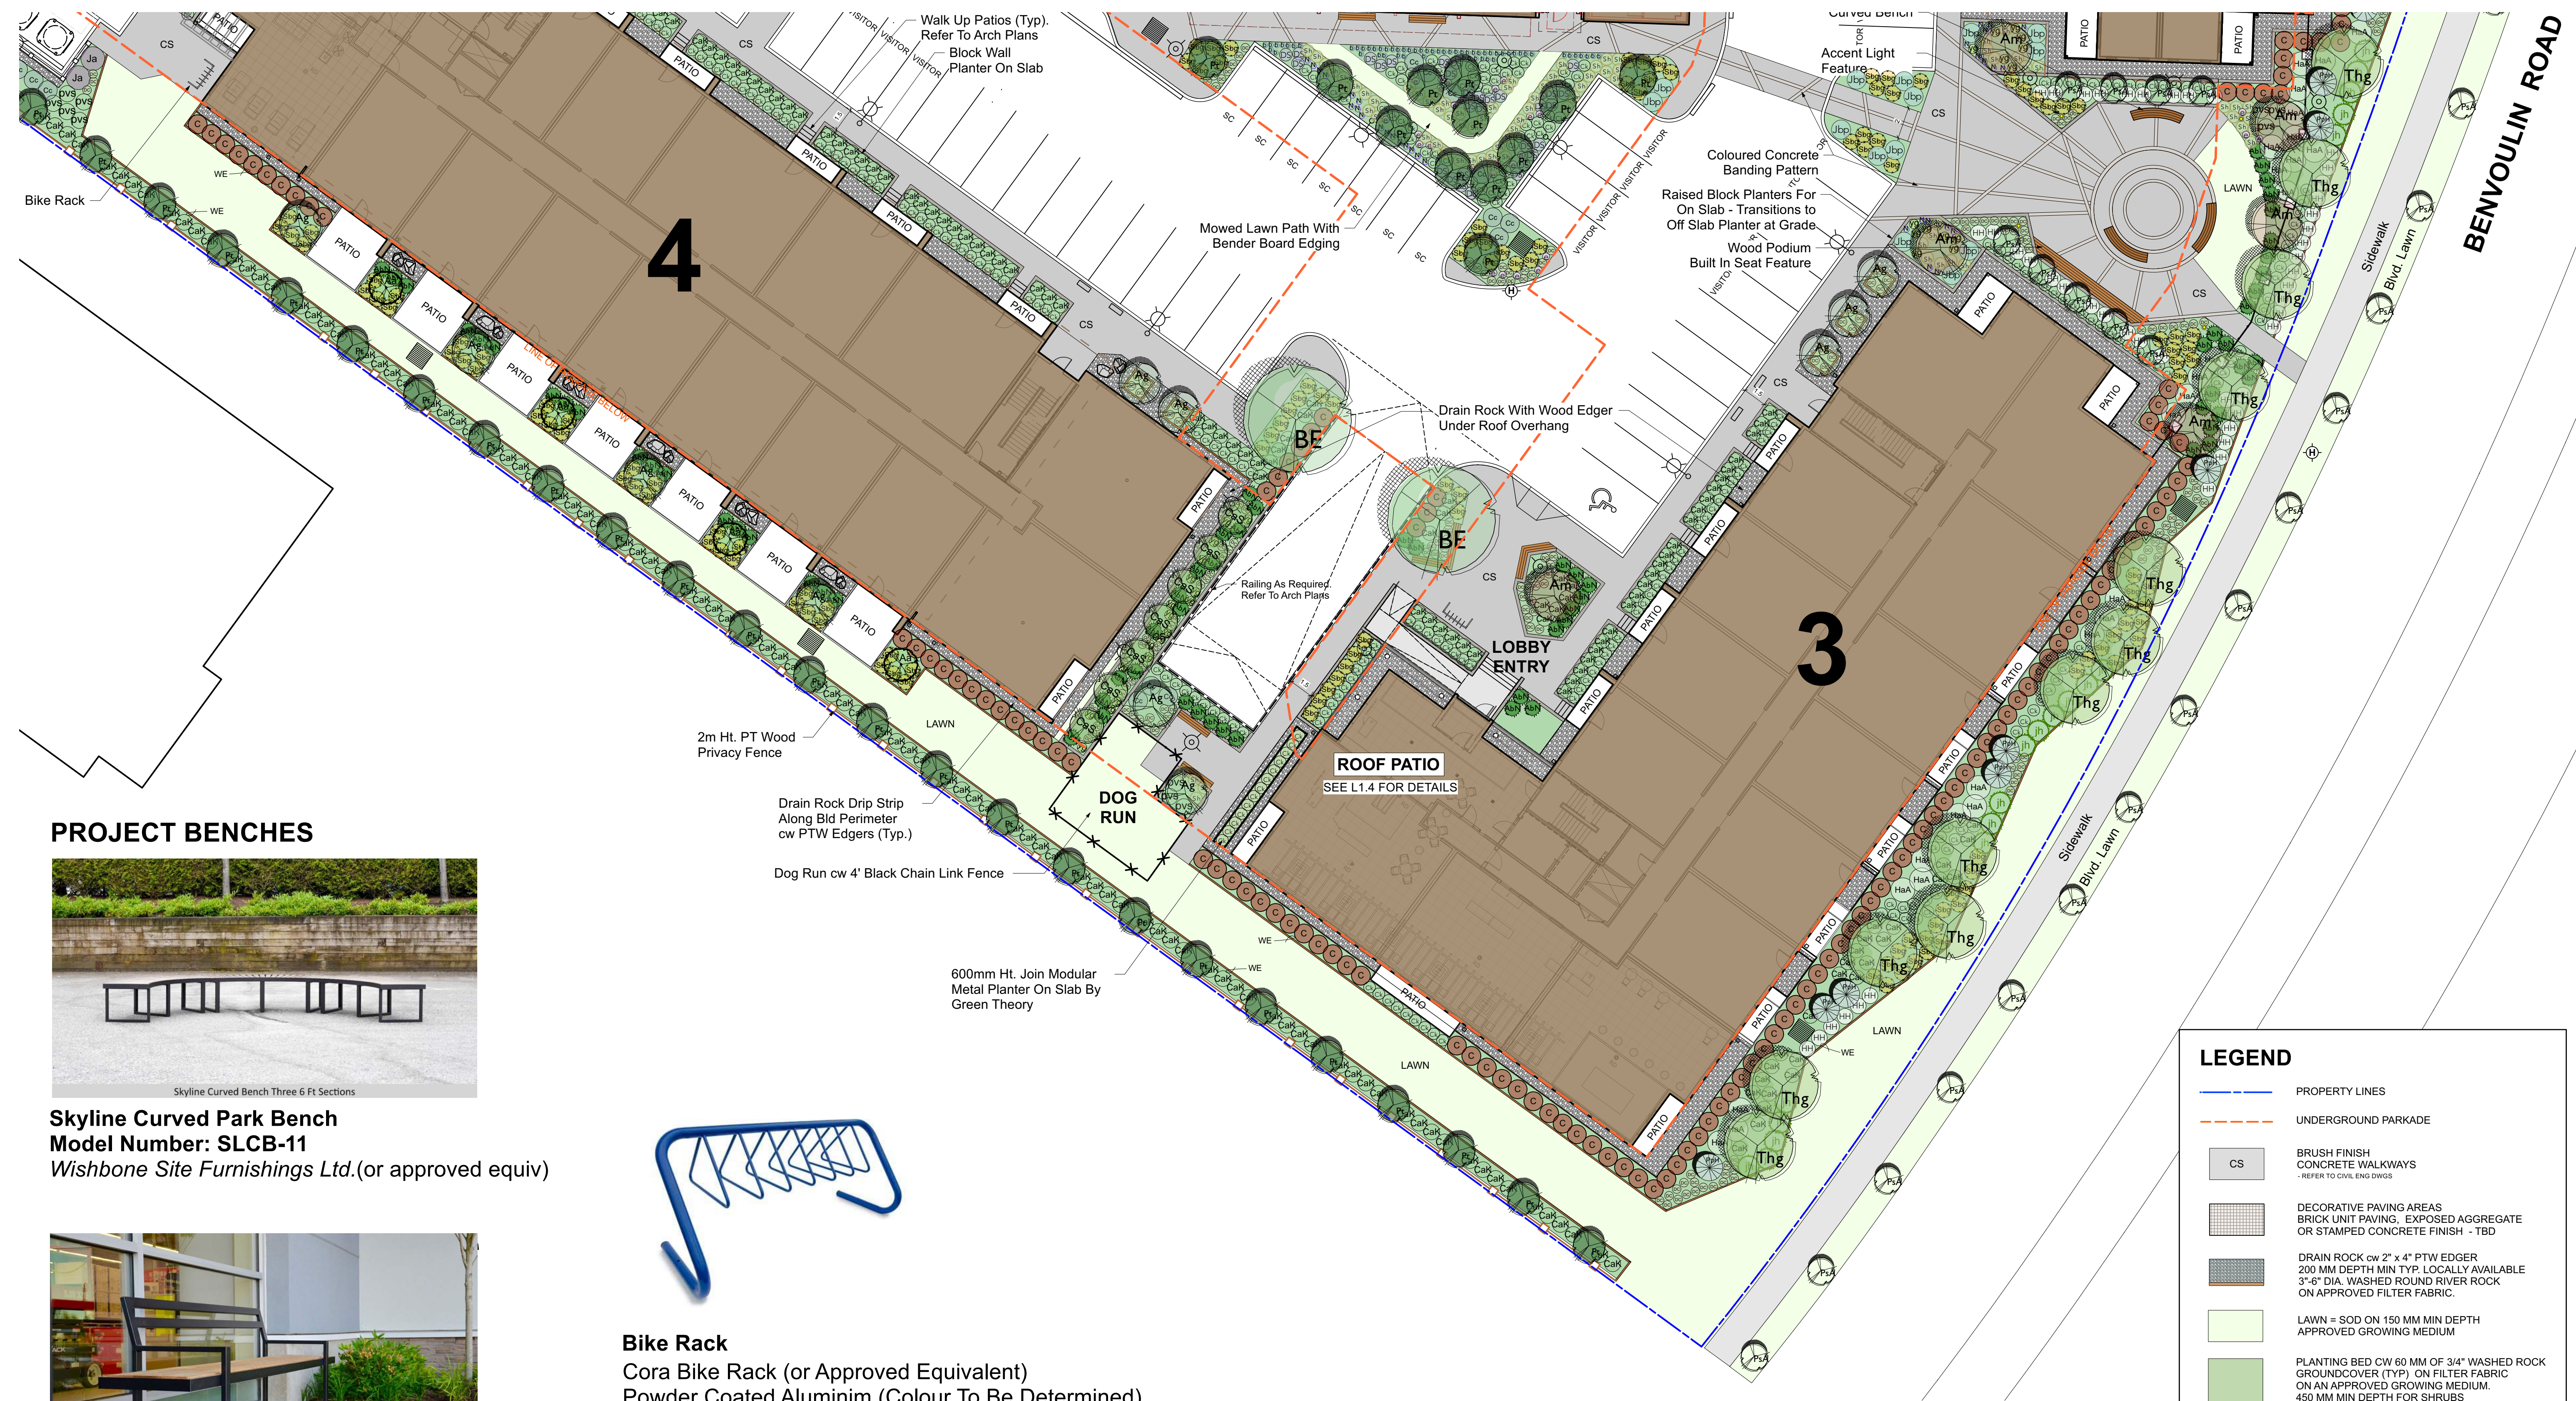
Project
2241 SPRINGFIELD ROAD
KELOWNA, BC

Sheet Title
Landscape Plan Enlargement 2

Date July 05, 2021
Scale 1:200 METERS
Drawn By SD/LS
Project No.

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Drawing No.
L 1.2



PROJECT BENCHES



Skyline Curved Park Bench
Model Number: SLCB-11
 Wishbone Site Furnishings Ltd.(or approved equiv)



Skyline Park Bench
Model Number: SLB-6
 Wishbone Site Furnishings Ltd.(or approved equiv)

Powder Coated Black Metal Base and Arm Rests
 Walnut Colour Plastic Lumbar Seat Boards
 Surface Mount To Concrete Walkway with
 Manufacture Supplied Hardware



Bike Rack
 Cora Bike Rack (or Approved Equivalent)
 Powder Coated Aluminium (Colour To Be Determined)




PRECAST BLOCK PLANTER
 Allan Block Splitfaced Planters On Slab
 (or Approved Equivalent)

LEGEND

- PROPERTY LINES
- UNDERGROUND PARKADE
- BRUSH FINISH CONCRETE WALKWAYS - REFER TO CIVIL ENG DWGS
- DECORATIVE PAVING AREAS BRICK UNIT PAVING, EXPOSED AGGREGATE OR STAMPED CONCRETE FINISH - TBD
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SCHEDULE C
 This forms part of application
 # DP21-0231 DVP21-0232
 Planner Initials **KB**
 City of Kelowna
 DEVELOPMENT PLANNING

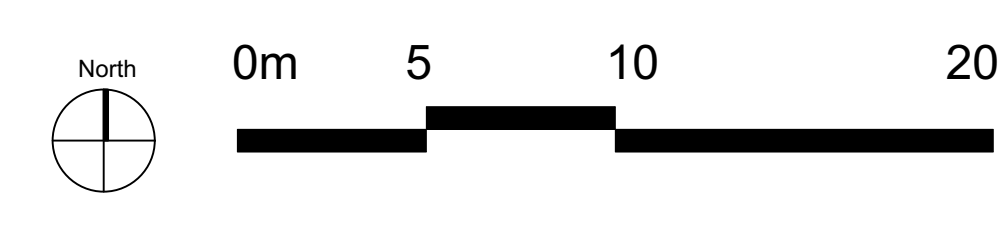

NOTE: ALL WORK AND MATERIALS SHALL BE TO CANADIAN LANDSCAPE STANDARDS

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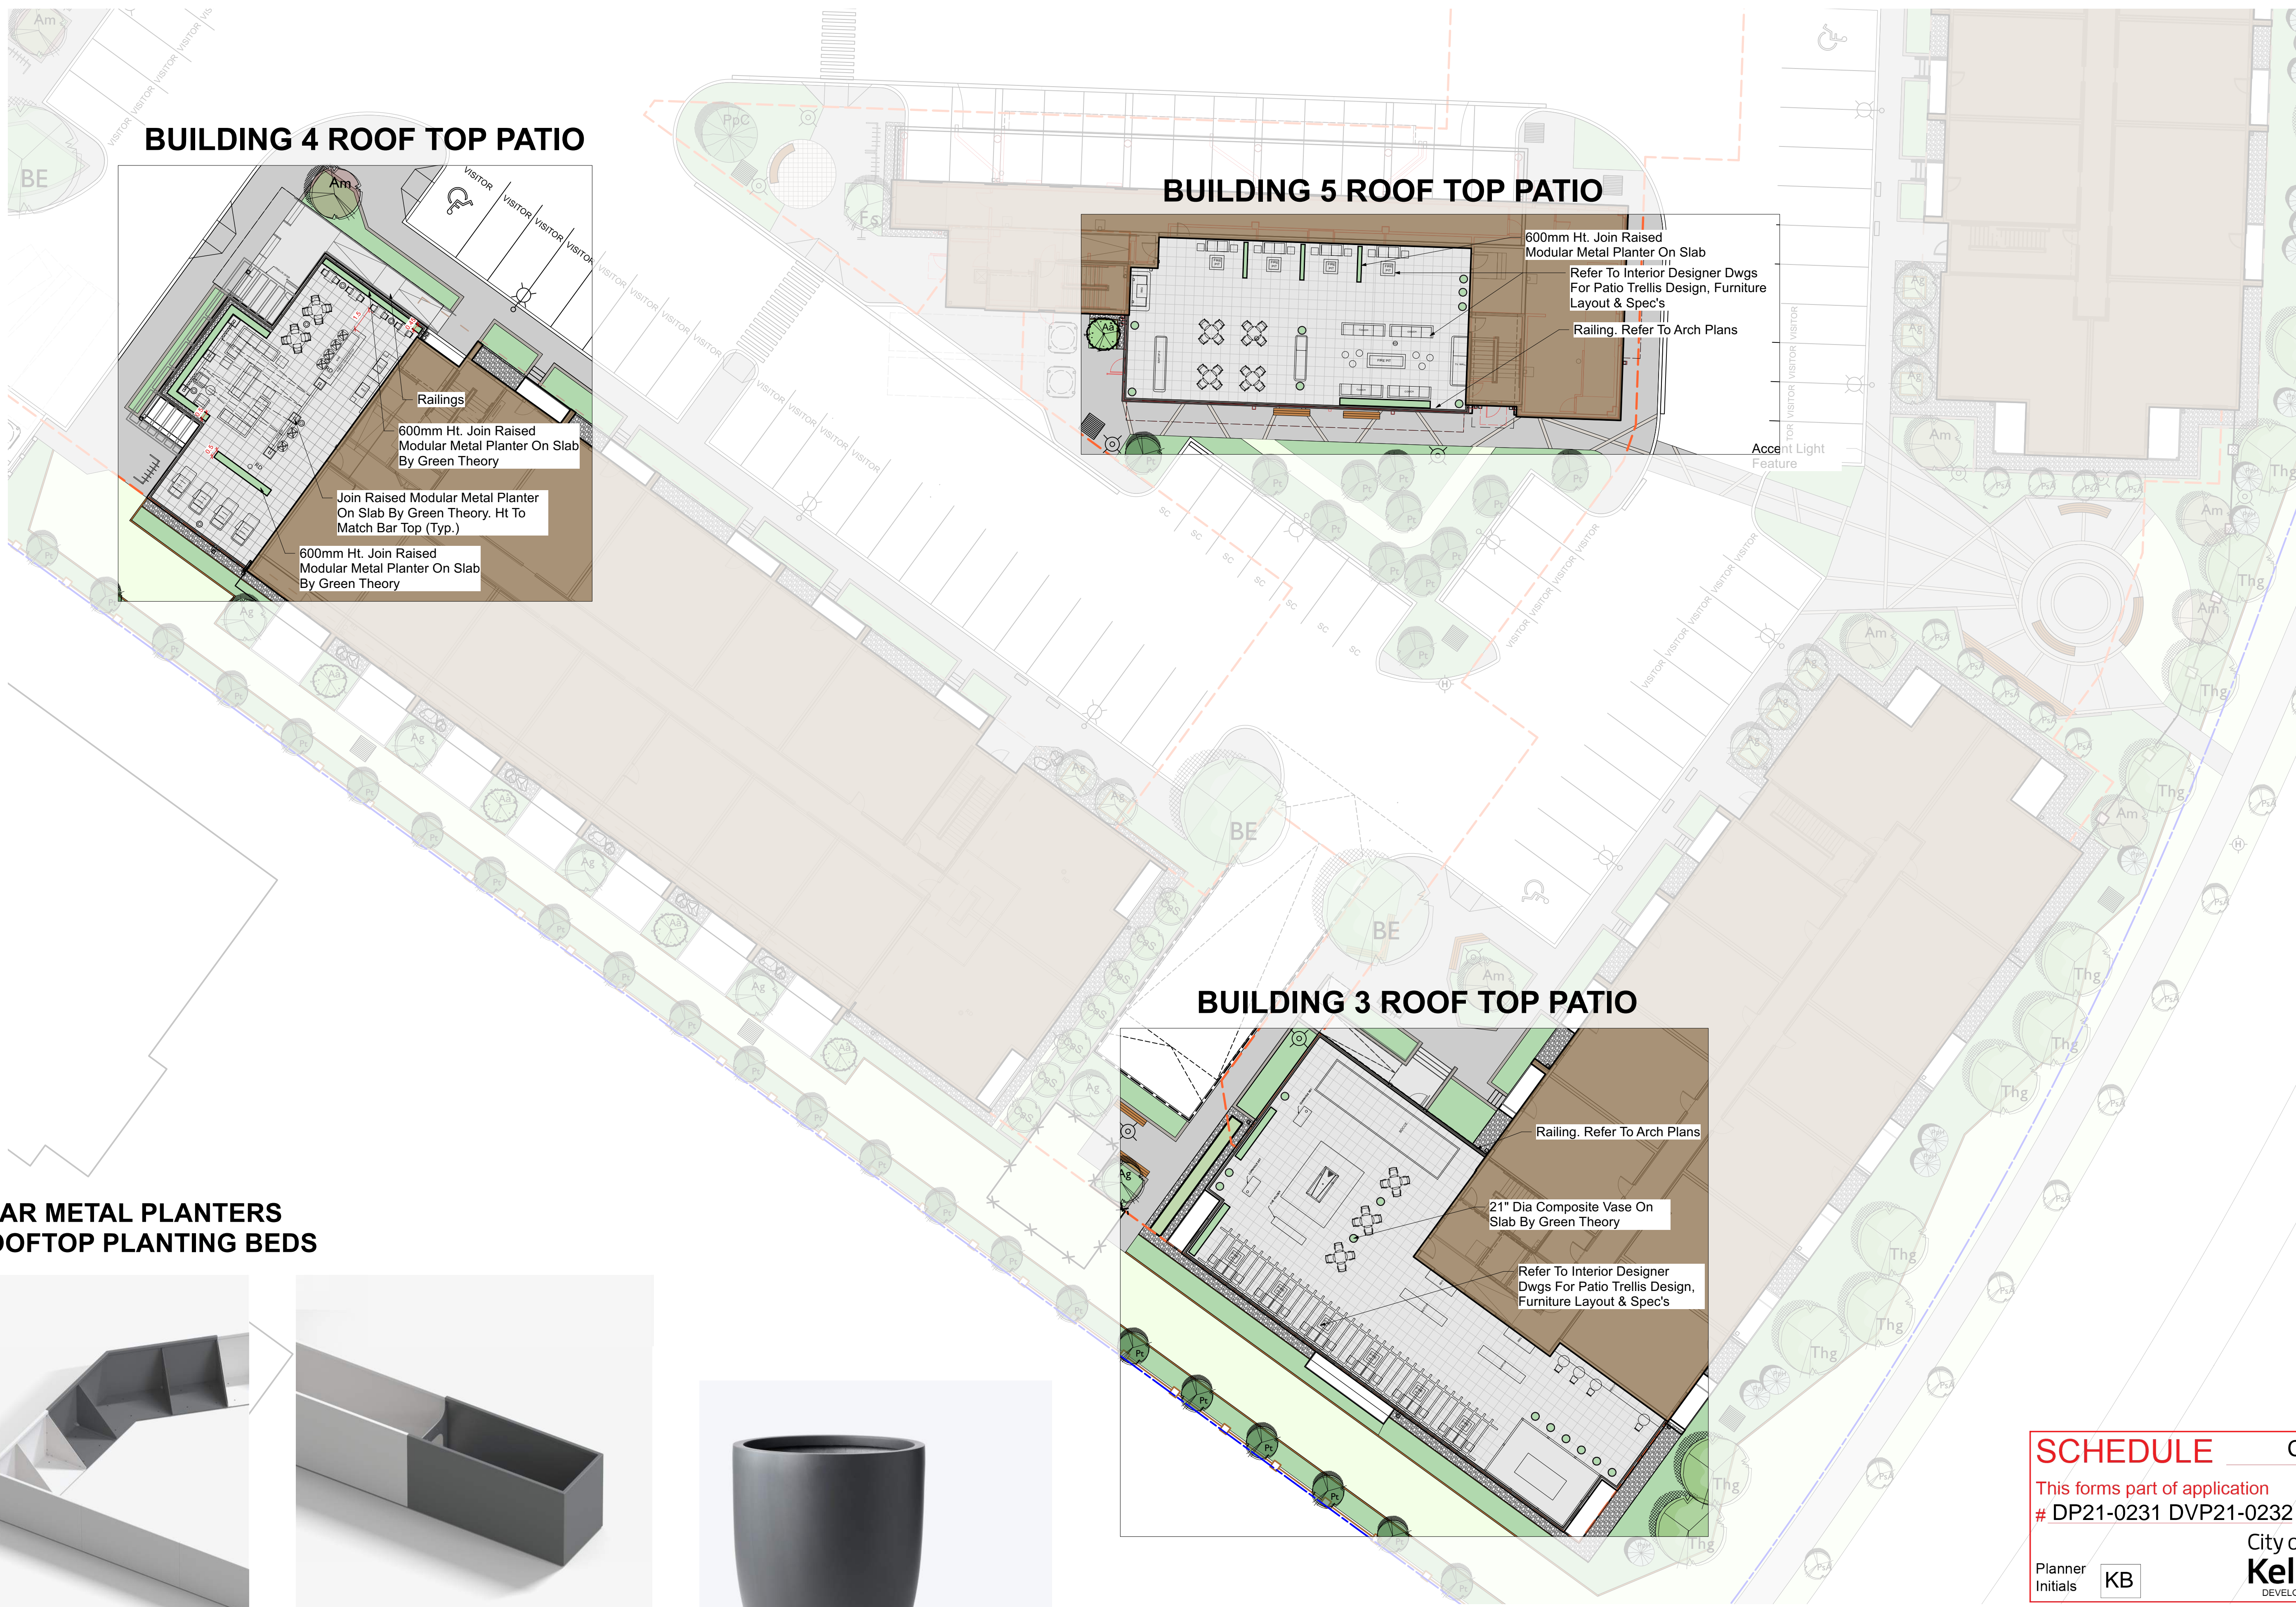
Project
 2241 SPRINGFIELD ROAD
 KELOWNA, BC

Sheet Title
**Landscape Plan
 Enlargement 3**

Date July 05, 2021
 Scale 1:200 METERS
 Drawn By SD/LS
 Project No.

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Drawing No.
L 1.3



BUILDING 4 ROOF TOP PATIO

Railings

600mm Ht. Join Raised Modular Metal Planter On Slab By Green Theory

Join Raised Modular Metal Planter On Slab By Green Theory. Ht To Match Bar Top (Typ.)

600mm Ht. Join Raised Modular Metal Planter On Slab By Green Theory

BUILDING 5 ROOF TOP PATIO

600mm Ht. Join Raised Modular Metal Planter On Slab

Refer To Interior Designer Dwgs For Patio Trellis Design, Furniture Layout & Spec's

Railing. Refer To Arch Plans


BUILDING 3 ROOF TOP PATIO

Railing. Refer To Arch Plans

21" Dia Composite Vase On Slab By Green Theory

Refer To Interior Designer Dwgs For Patio Trellis Design, Furniture Layout & Spec's

MODULAR METAL PLANTERS FOR ROOFTOP PLANTING BEDS

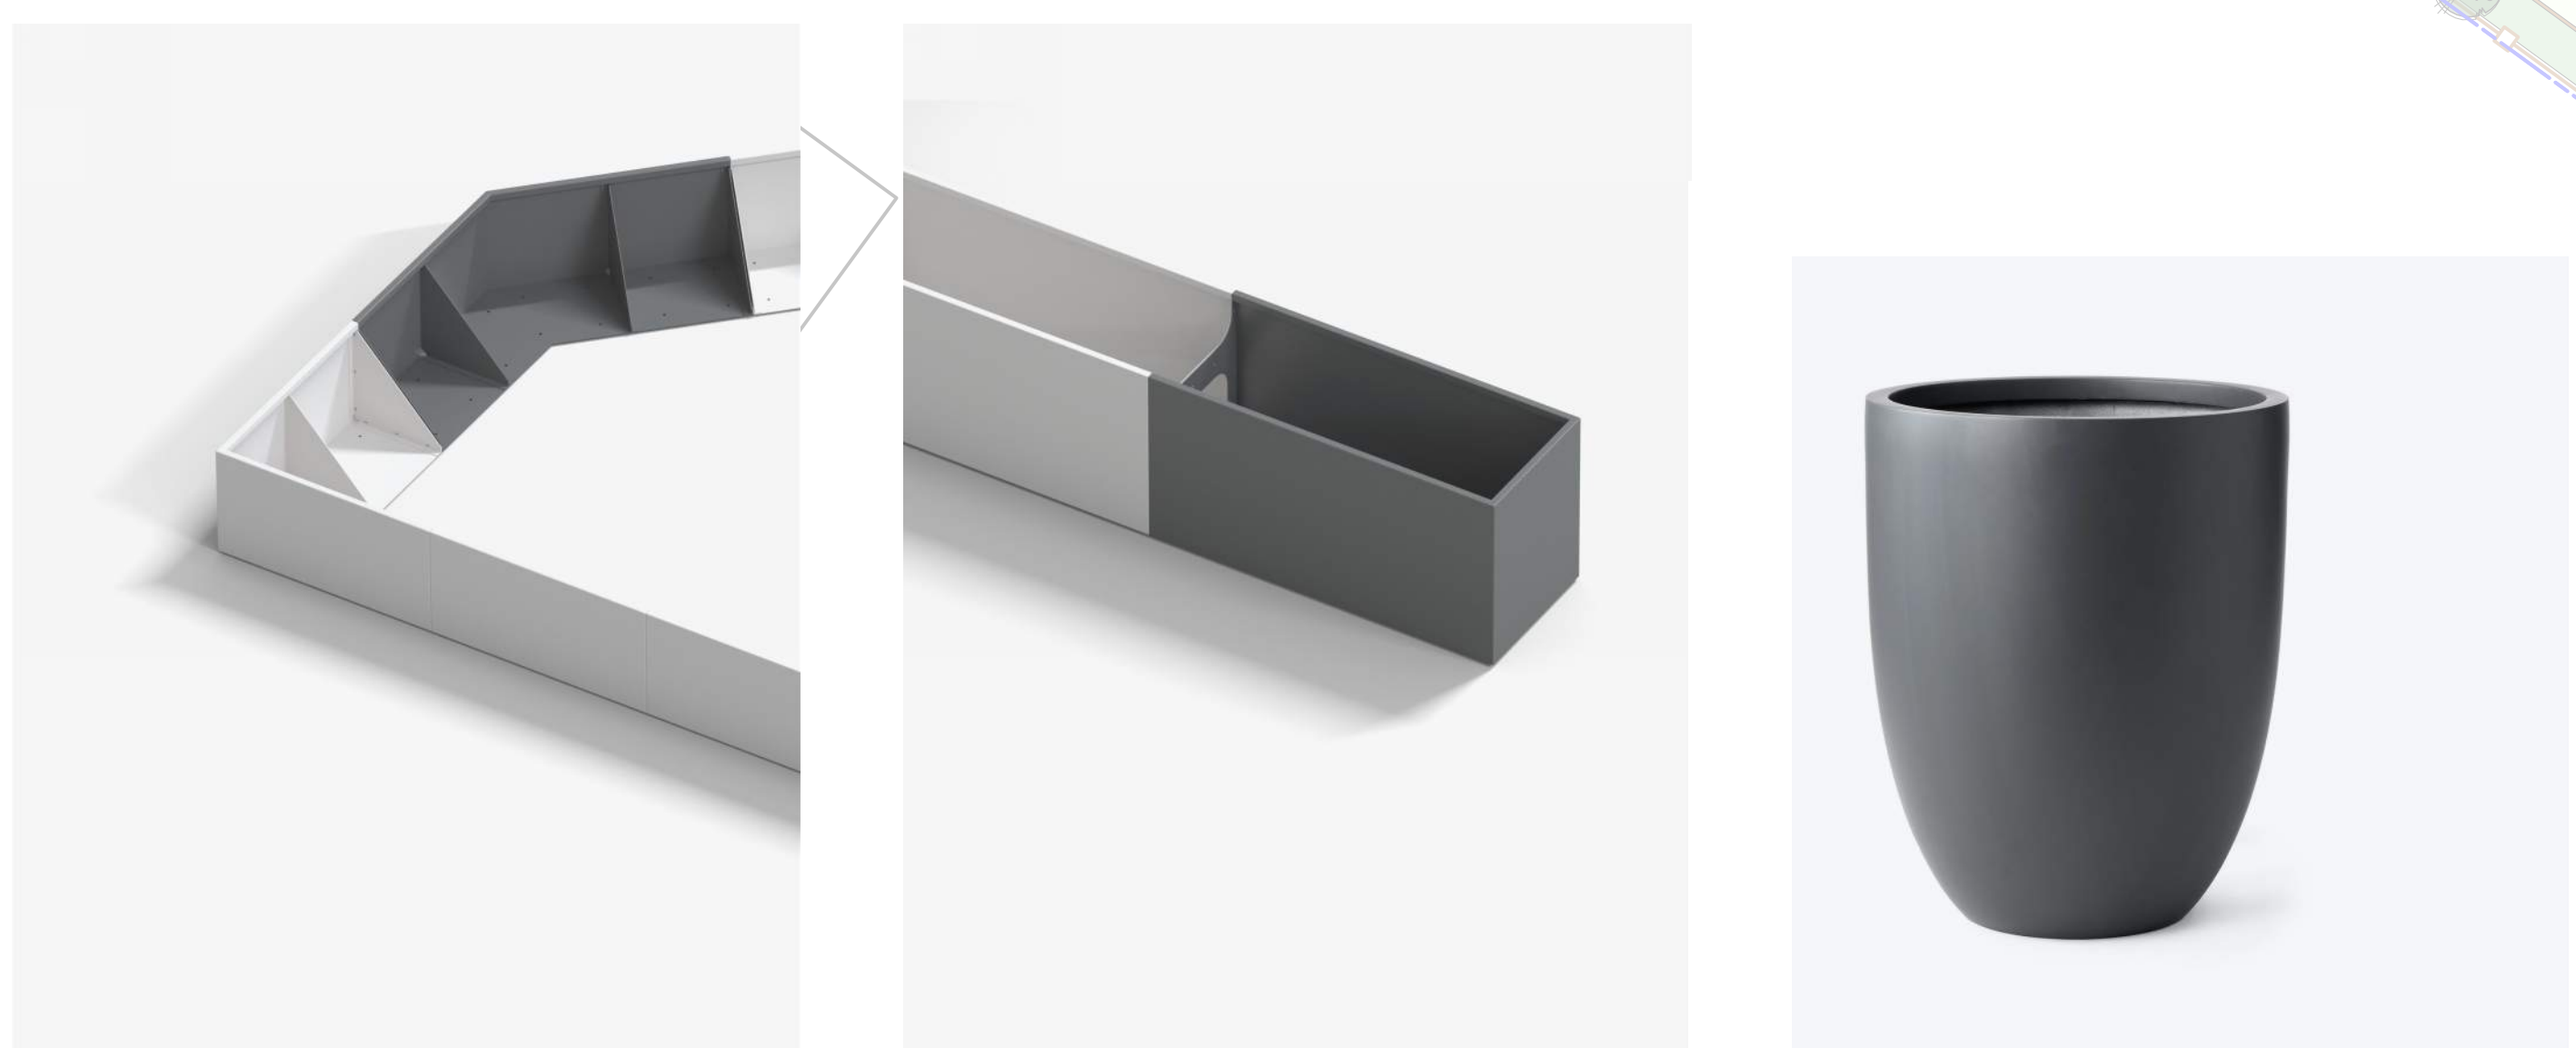

Join Edging Planter. Colour T.B.D.
By Green Theory (or approved equiv)

Join Modular Planter. Colour T.B.D.
By Green Theory (or approved equiv)

Composite Vase Planter
21" Dia x 26" Ht.
By Green Theory (or approved equiv)

IRONCLAD DEVELOPMENTS INC.

Project Management
General Contracting
Design/ Build

101-57158
Symington Rd.
Springfield, MB.
R2J 4L6

Ph: 204-777-1972
info@icdev.ca

Date	Revisions	By
Jun 20 22	Progress Review	SD/LS

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LANDSCAPE ARCHITECTS

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250-563-6158 www.isla-landarch.com

Project

2241 SPRINGFIELD ROAD
KELOWNA, BC

Sheet Title

**Landscape Plan
Roof Terrace**

Date July 05, 2021

Scale 1:200 METERS

Drawn By SD/LS

Project No.

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Drawing No.


L 1.4

SCHEDULE C

This forms part of application
DP21-0231 DVP21-0232

City of Kelowna
DEVELOPMENT PLANNING

Planner Initials KB

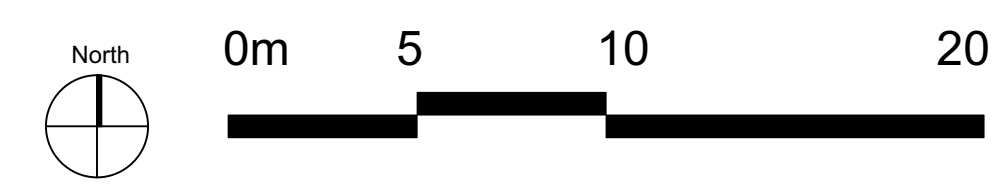

NOTE: ALL WORK AND MATERIALS SHALL BE TO CANADIAN LANDSCAPE STANDARDS



FORM & CHARACTER – DEVELOPMENT PERMIT GUIDELINES

Chapter 2 - The Design Foundations: apply to all projects and provide the overarching principles for supporting creativity, innovation and design excellence in Kelowna.

- Facilitate Active Mobility
- Use Placemaking to Strengthen Neighbourhood Identity
- Create Lively and Attractive Streets & Public Spaces
- Design Buildings to the Human Scale
- Strive for Design Excellence

The General Residential and Mixed Use Guidelines: provide the key guidelines that all residential and mixed use projects should strive to achieve to support the Design Foundations.

- The General Guidelines are supplement by typology-specific guidelines (e.g., Townhouses & Infill on page 18-19, High-Rise Residential and Mixed-Use on page 18-42), which provide additional guidance about form and character.

Chapter 2 - Design Foundations

Apply To All Projects

Page 18-8

Section 2.1 - General Residential and Mixed Use Design Guidelines

Page 18-9

Section 2.2 - Achieving High Performance

Page 18-17

Chapter 3
Townhouses & Infill

Page 18-19

Chapter 4
Low & Mid-Rise
Residential &
Mixed Use

Page 18-34

Chapter 5
High-Rise
Residential &
Mixed Use

Page 18-42

*Note: Refer to the Design Foundations and the Guidelines associated with the specific building typology.

FORM & CHARACTER - DEVELOPMENT PERMIT GUIDELINES

Consideration has been given to the following guidelines as identified in Chapter 18 of the City of Kelowna 2040 Official Community Plan:

RATE PROPOSALS COMPLIANCE TO PERTINENT GUIDELINE <i>(1 is least complying & 5 is highly complying)</i>	N/A	1	2	3	4	5
CHAPTER 4.0: LOW & MID-RISE RESIDENTIAL & MIXED USE						
4.1 Guidelines						
4.1.1 Relationship to the Street						
Lobby area and main building entrance is clearly visible from the fronting street and sidewalk.				✓		
Wherever possible, blank walls at grade are not encouraged.						✓
Enclosed parking garages are located away from street frontages or public open space.						✓
Ground oriented units with entries or glazing have been provided to avoid the blank/dead frontage along the street.						✓
When unavoidable, blank walls have been screened with landscaping or have been incorporated with a patio/café or special materials have been provided to make them visually interesting.						
Commercial & Mixed-use Buildings						
Proposed built form has a continuous active and transparent retail frontage at grade and provides a visual connection between the public and private realm.					✓	
Buildings have been sited using a common 'build to' line at or near the front property line to maintain a continuous street frontage. Some variation (1-3 m maximum) can be accommodated in ground level set backs to support pedestrian and retail activity by, for example, incorporating a recessed entryway, small entry plaza, or sidewalk café.						✓
Frequent entrances (every 15 m maximum) into commercial street frontages have been incorporated to create punctuation and rhythm along the street, visual interest, and support pedestrian activity.				✓		
Residential and Mixed-use Buildings						
Residential buildings at the ground floor have a set back between 3-5 m from the property line to create a semi-private entry or transition zone to individual units and to allow for an elevated front entryway or raised patio.					✓	
A maximum 1.2 m desired height (e.g., 5-6 steps) for front entryways has been provided. Where the water table requires this to be higher, in these cases, larger patio has been provided and parking has been screened with ramps, stairs, and landscaping.						✓
Ground floor units accessible from the fronting street or public open spaces have been provided with individual entrances.		✓				
Buildings are sited and oriented so that windows and balconies are overlooking public streets, parks, walkways, and shared amenity spaces while minimizing views into private residences.						✓

RATE PROPOSALS COMPLIANCE TO PERTINENT GUIDELINE <i>(1 is least complying & 5 is highly complying)</i>	N/A	1	2	3	4	5
4.1.2 Scale and Massing						
Proposed residential building façade has a length of 60 m (40 m length is preferred).		✓				
Buildings over 40 m in length are incorporating significant horizontal and vertical breaks in façade.				✓		
Commercial building facades are incorporating significant break at approximately 35 m intervals.					✓	
Proposed residential building has a maximum width of 24 m.					✓	
4.1.3 Site Planning						
On sloping sites, building floor levels are following the natural grade and avoiding the blank wall situation.	✓					
Buildings are sited to be parallel to the street and have a distinct front-to-back orientation to public street and open spaces and to rear yards, parking, and/or interior courtyards.						✓
Building sides that are interfacing with streets, mid-block connections, and other open spaces (building fronts) are positively framing and activating streets and open spaces and supporting pedestrian activity.					✓	
Larger buildings are broken up with mid-block connections which have public accessibility wherever possible.					✓	
Ground floors adjacent to mid block connections have entrances and windows facing the mid block connection.			✓			
4.1.4 Site Servicing, Access, and Parking						
Vehicular access is provided from the lane.	✓					
Where there is no lane, and where the re-introduction of a lane is difficult or not possible, access is provided from the street, provided: <ul style="list-style-type: none"> • Access is from a secondary street, where possible, or from the long face of the block; • Impacts on pedestrians and the streetscape is minimized; and, • There is no more than one curb cut per property. 						✓
Above grade structure parking should only be provided in instances where the site or high water table does not allow for other parking forms.	✓					

RATE PROPOSALS COMPLIANCE TO PERTINENT GUIDELINE <i>(1 is least complying & 5 is highly complying)</i>	N/A	1	2	3	4	5
When parking cannot be located underground due to the high water table and is to be provided above ground, screen the parking structure from public view as follows: <ul style="list-style-type: none"> On portions of the building that front a retail or main street, line the above ground parking with active retail frontage; On portions of the building that front onto non-retail streets, line the above ground parking with an active residential frontage, such as ground oriented townhouse units; When active frontages are not able to be accommodated, screen parking structures by using architectural or landscaped screening elements; On corner sites, screen the parking structure from public view on both fronting streets using the appropriate strategy listed above. 						✓
Buildings with ground floor residential may integrate half-storey underground parking to a maximum of 1.2 m above grade, with the following considerations: <ul style="list-style-type: none"> Semi-private spaces should be located above to soften the edge and be at a comfortable distance from street activity; and Where conditions such as the high water table do not allow for this condition, up to 2 m is permitted, provided that entryways, stairs, landscaped terraces, and patios are integrated and that blank walls and barriers to accessibility are minimized. 	✓					
4.1.5 Publicly Accessible and Private Open Spaces						
Publicly accessible private spaces (e.g., private courtyards accessible and available to the public) have been integrated with public open areas to create seamless, contiguous spaces.		✓				
Semi-private open spaces have been located to maximize sunlight penetration, minimize noise disruptions, and minimize 'overlook' from adjacent units.				✓		
Outdoor Amenity Areas: design plazas and parks to: <ul style="list-style-type: none"> Contain 'three edges' (e.g., building frontage on three sides) where possible and be sized to accommodate a variety of activities; Be animated with active uses at the ground level; and, Be located in sunny, south facing areas. 				✓		
Internal courtyard design provides: <ul style="list-style-type: none"> amenities such as play areas, barbecues, and outdoor seating where appropriate. a balance of hardscape and softscape areas to meet the specific needs of surrounding residents and/or users. 					✓	
Mid-block connections design includes active frontages, seating, and landscaping.					✓	

RATE PROPOSALS COMPLIANCE TO PERTINENT GUIDELINE <i>(1 is least complying & 5 is highly complying)</i>	N/A	1	2	3	4	5
Rooftop Amenity Spaces						
Shared rooftop amenity spaces (such as outdoor recreation space and rooftop gardens on the top of a parkade) are designed to be accessible to residents and to ensure a balance of amenity and privacy by: <ul style="list-style-type: none"> Limiting sight lines from overlooking residential units to outdoor amenity space areas through the use of pergolas or covered areas where privacy is desired; and Controlling sight lines from the outdoor amenity space into adjacent or nearby residential units. 					✓	
Reduce the heat island effect by including plants or designing a green roof, with the following considerations: <ul style="list-style-type: none"> Secure trees and tall shrubs to the roof deck; and Ensure soil depths and types are appropriate for proposed plants and ensure drainage is accommodated. 		✓				
4.1.6 Building Articulation, Features & Materials						
Articulate building facades into intervals that are a maximum of 15 m wide for mixed-use buildings and 20m wide for residential buildings. Strategies for articulating buildings should consider the potential impacts on energy performance (see 2.2.1), and include: <ul style="list-style-type: none"> Façade Modulation – stepping back or extending forward a portion of the façade to create a series of intervals in the facade; Repeating window patterns at intervals that correspond to extensions and step backs (articulation) in the building facade; Providing a porch, patio, deck, or covered entry for each interval; Providing a bay window or balcony for each interval, while balancing the significant potential for heat loss through thermal bridge connections which could impact energy performance; Changing the roof line by alternating dormers, stepped roofs, gables, or other roof elements to reinforce the modulation or articulation interval; Changing the materials with the change in building plane; and Provide a lighting fixture, trellis, tree, or other landscape feature within each interval. 			✓			
Break up the building mass by incorporating elements that define a building's base, middle and top.						✓
Use an integrated, consistent range of materials and colors and provide variety by, for example, using accent colors.						✓
Articulate the facade using design elements that are inherent to the building as opposed to being decorative. For example, create depth in building facades by recessing window frames or partially recessing balconies to allow shadows to add detail and variety as a byproduct of massing.			✓			
Incorporate distinct architectural treatments for corner sites and highly visible buildings such as varying the roofline (<i>See Figure 41</i>), articulating the facade, adding pedestrian space, increasing the number and size of windows, and adding awnings and canopies.			✓			

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Weather Protection						
Provide weather protection (e.g. awnings, canopies, overhangs, etc.) along all commercial streets and plazas (<i>See Figure 4.2</i>), with particular attention to the following locations: <ul style="list-style-type: none"> • Primary building entrances, • Adjacent to bus zones and street corners where people wait for traffic lights; • Over store fronts and display windows; and • Any other areas where significant waiting or browsing by people occurs. 						✓
Architecturally-integrate awnings, canopies, and overhangs to the building and incorporate architectural design features of buildings from which they are supported.					✓	
Place and locate awnings and canopies to reflect the building's architecture and fenestration pattern.					✓	
Place awnings and canopies to balance weather protection with daylight penetration. Avoid continuous opaque canopies that run the full length					✓	
Signage						
Provides attractive signage on commercial buildings that identifies uses and shops clearly but which is scaled to the pedestrian rather than the motorist. Some exceptions can be made for buildings located on highways and/or major arterials in alignment with the City's Sign Bylaw.					✓	
Avoid the following types of signage: <ul style="list-style-type: none"> • Internally lit plastic box signs; • Pylon (stand alone) signs; and • Rooftop signs. 	✓					
Uniquely branded or colored signs are encouraged to help establish a special character to different neighbourhoods.	✓					