DILWORTH SHOPPING CENTER REDEVELOPMENT

Sheet No. Sheet Name

PHASE 2

Issued for TRS Response

Peterson // Client

Marcus Jaheny
Marcus Jaheny
604.688.4885

IBI Group // Architect

Lauren Macaulay
Lauren.Macaulay@ibigroup.com


LOCI Landscape Architecture + Urban Design // Landscape Architect

Mike Enns, BCSLA, CSLA // Principal mike@locidesign.ca 604.763.2886

Jim Dema-ala // Project Coordinator jim@locidesign.ca 604.694.0053

LANDSCAPE DRAWING INDEX PERMIT

L0.0	PH 2 - COVER SHEET
L0.1	PH 2 – GENERAL NOTES
L0.2	PH 2 – TREE MANAGEMENT PLAN
L0.3	PH 2 - OVERALL LANDSCAPE PLAN
L1.0	PH 2 - MATERIALS + LAYOUT PLAN - WEST
L1.1	PH 2 - MATERIALS + LAYOUT PLAN - EAST
L1.2	PH 2 - GRADING PLAN - WEST
L1.3	PH 2 - GRADING PLAN - EAST
L1.4	PH 2 - TREE PLANTING PLAN - WEST
L1.5	PH 2 - TREE PLANTING PLAN - EAST
L1.6	PH 2 - SHRUB PLANTING PLAN - WEST
L1.7	PH 2 - SHRUB PLANTING PLAN - EAST
L1.8	PH 2 - HYDROZONE PLAN - WEST
L1.9	PH 2 - HYDROZONE PLAN - EAST
L1.10	PH 2 - LIGHTING SCHEMATIC PLAN - WEST
L1.11	PH 2 - LIGHTING SCHEMATIC PLAN - EAST
L1.12	PH 2 - FENCE + GATE LOCATION PLAN - WEST
L1.13	PH 2 - FENCE + GATE LOCATION PLAN - EAST
L2.0	PH 2 - SECTIONS
L2.1	PH 2 - SECTIONS
L2.2	PH 2 - SECTIONS
L3.0	PH 2 - PLANT LIST
L3.1	PH 2 - PLANT IMAGES
L4.0	PH 2 - PRECEDENT IMAGES
L4.1	PH 2 - PRECEDENT IMAGES
L5.0	PH 2 - HARDSCAPE DETAIL - PAVING
L5.1	PH 2 - HARDSCAPE DETAIL - PAVING
L5.2	PH 2 - HARDSCAPE DETAIL - STAIRS AND RAMPS
L5.3	PH 2 - HARDSCAPE DETAIL - CURBS AND WALLS
L5.4	PH 2 - SITE FURNISHING DETAIL - FENCES
L5.5	PH 2 - SITE FURNISHING DETAIL - BENCHES AND SEATING
L5.6	PH 2 - SOFTSCAPE DETAIL - ON-GRADE PLANTING
L5.7	PH 2 - SOFTSCAPE DETAIL - ON-GRADE PLANTING
L5.8	PH 2 - SOFTSCAPE DETAIL - ON SLAB PLANTING
L5.9	PH 2 - SOFTSCAPE DETAIL - ON SLAB PLANTING
L6.0	PH 2 - APPENDIX A - HYDROZONE CALCULATIONS

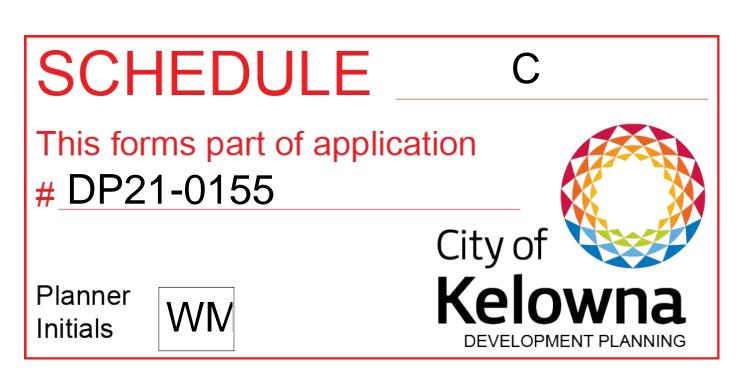



AND URBAN DESIGN. USE OR REPRODUCTION
PROHIBITED WITH PRIOR WRITTEN CONSENT.



Project Stamp



legue

No. Description

F Issued for Development Permit 21-05-30

G Re-Issued for Development 21-12-23
Permit

H Issued for TRS Response 22-02-03

Project Info

20168

Dilworth Center Mixed Use 2339 Highway 97N

Project Team

Kelowna, BC

Peterson

Architect

IBI Group

Landscape Architect

LOCI Landscape Architecture + Urban Design

JD

Checked By

PH 2 - COVER SHEET

L0.0

GENERAL TREE MANAGEMENT NOTES:


- 1. ALL COMPONENTS AND WORKMANSHIP TO CONFORM TO BCLNA STANDARDS TYPICAL.
- 2. POSITION TREE STAKES INTO DIRECTION OF PREVAILING WINDS IF MINIMUM UTILITY SETBACKS PERMIT.
- 3. ALL TREE STAKES TO HAVE A MINIMUM 1.0m CLEARANCE FROM ALL U/G POWER, TELEPHONE AND GAS ALIGNMENTS.
- 4. ALL ROOTBALL HOLES TO BE DUG BY HAND WHEN CLOSER TO 1.0M (40") TO U/G POWER, TELEPHONE AND GAS ALIGNMENTS. FOR TREES WITH DRIPLINES FROM FROM 3M 5M (9' 15') FROM CONSTRUCTION ACTIVITY;
- 5. PLACE STANDARD 'SAFETY ORANGE' SNOWFENCE MIN. OF 4.5M (14'8") FROM TREE TRUNK. EXACT SIZE/SHAPE TO BE DETERMINED ON SITE
- 6. FOR EXCAVATION WITHIN 1-3M (3' 9') OF ANY TREE'S DRIPLINE, ROOT PRUNING REQUIRED TO A DEPTH OF 500MM (20"). IMMEDIATELY AFTER EXCAVATION, PRUNE ALL EXPOSED ROOTS FLUSH WITH THE EXCAVATION WALL.
- 7. A MAXIMUM OF 25% OF ANY TREE'S ROOTS AT THE DRIPLINE SHOULD BE IMPACTED BY EXCAVATION IF THE TREE IS EXPECTED TO SURVIVE.
- 8. INSTALL AND MAINTAIN HOARDING IN CLEAN AND SAFE CONDITION THROUGHOUT CONSTRUCTION PROCESS.
- 9. HOARDING REQUIREMENTS ARE ON ALL EXISTING TREES THROUGHOUT CONSTRUCTION. ALL EQUIPMENT, SOIL, BUILDING MATERIAL AND OTHER DEBRIS SHALL BE KEPT OUTSIDE THE HOARDING.
- 10. IF HOARDING IS PUNCTURED AND DAMAGE OCCURS TO HOARDED TREE(S), NOTIFY LANDSCAPE ARCHITECT.
- 11. THE BEST METHOD TO AVOID SOIL COMPACTION IS TO KEEP OFF. THIS INCLUDES RESTRICTING ALL TRAFFIC BOTH VEHICULAR AND PEDESTRIAN FROM CROSSING OVER THE ROOT ZONES, AND RESTRICTING EVEN TEMPORARY MATERIAL STORAGE UNDER TREES.
- 12. EXCAVATION AROUND TREES WITHIN DRIP LINE OF TREES ONLY WHERE INDICATED ON PLANS AND AS DIRECTED BY THE CONSULTANT.
- 13. DURING ANY EXCAVATION WITHIN THE DRIP LINE OF A TREE THE CONTRACTOR SHALL EXCAVATE AROUND TREE ROOTS AS DIRECTED BY THE CONSULTANT. DO NOT CUT TREE ROOTS UNLESS DIRECTED BY THE CONSULTANT.
- 14. TREES AND OTHER DESIRABLE VEGETATION TO BE TOTALLY FENCED. FENCING TO BE MAINTAINED FOR THE DURATION OF THE PROJECT.
- 15. EXCAVATION FOR NEW CONSTRUCTION WITHIN THE DRIP LINES OF TREES: HAND EXCAVATE TO MINIMIZE DAMAGE TO ROOT SYSTEMS
- 16. USE NARROW TINE SPADING FORKS TO PROBE AND COMB SOIL TO EXPOSE ROOTS;
- 17. RELOCATE ROOTS INTO BACKFILL AREAS WHENEVER POSSIBLE. IF LARGE MAIN LATERAL ROOTS ARE ENCOUNTERED, EXPOSE BEYOND EXCAVATION LIMITS AS REQUIRED TO BEND AND RELOCATE WITHOUT BREAKING.
- 18. UTILITY TRENCHING WITHIN THE DRIP LINES OF TREES: TUNNEL UNDER AND AROUND ROOTS BY HAND DIGGING;
- 19. DO NOT CUT MAIN LATERAL ROOTS;
- 20. CUTTING OF SMALLER ROOTS THAT INTERFERE WITH INSTALLATION OF NEW WORK SHALL BE DONE WITH CLEAN SHARP TREE PRUNING TOOLS;
- 21. ROOTS THAT ARE ENCOUNTERED IMMEDIATELY ADJACENT TO THE LOCATION OF NEW CONSTRUCTION AND ARE TOO DIFFICULT TO RELOCATE SHALL BE CUT 150MM (6") BACK FROM NEW CONSTRUCTION. USE CLEAN SHARP TREE PRUNING TOOLS;
- 22. PROTECTION OF EXPOSED ROOTS: DO NOT ALLOW EXPOSED ROOTS TO DRY OUT PRIOR TO PLACEMENT OF PERMANENT COVER.
- 23. PROVIDE ONE OF THE FOLLOWING TEMPORARY REMEDIAL MEASURES:
- 24. A. PROVIDE TEMPORARY EARTH COVER. MAINTAIN MOISTURE.

 B. PACK WITH WET PEAT MOSS. MAINTAIN MOISTURE.

 C. PACK WITH FOUR LAYERS OF WET UNTREATED BURLAP. MAINTAIN MOISTURE.
- 25. TEMPORARILY SUPPORT AND PROTECT EXPOSED ROOTS FROM DAMAGE UNTIL PERMANENTLY RELOCATED AND COVERED WITH BACKFILL.
- 26. WATER PUDDLE BACKFILL AROUND ROOTS TO ELIMINATE VOIDS AND AIR POCKETS

TREE MANAGEMENT PLAN



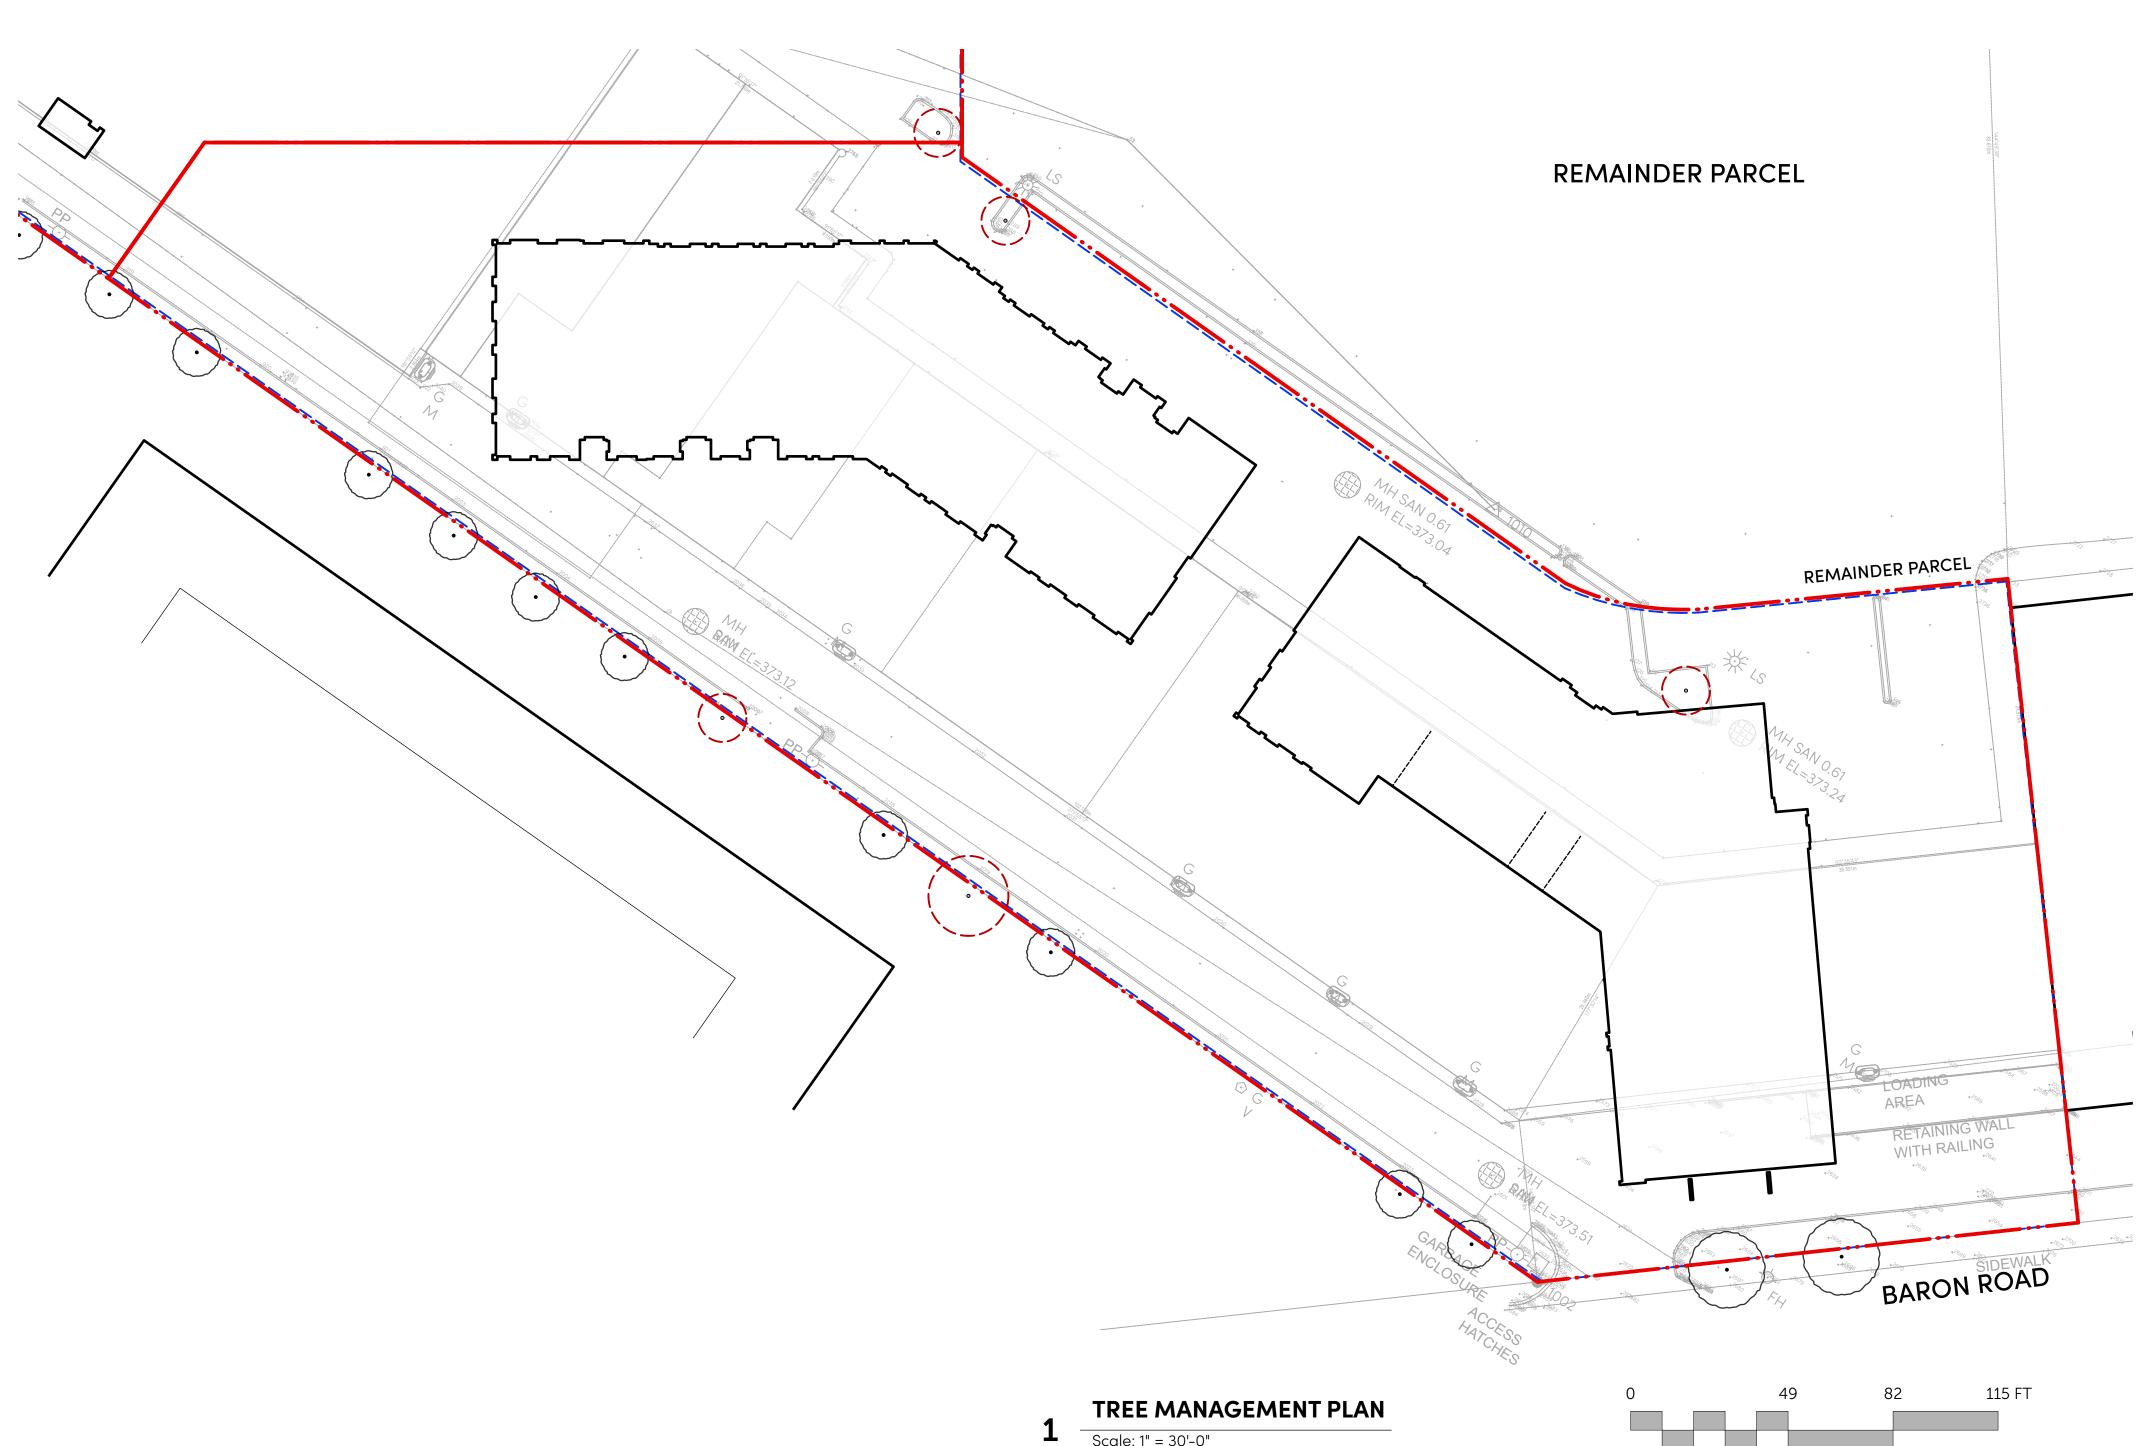



1738 KINGSWAY, VANCOUVER, BC V5N 2S3 www.locidesign.ca // 604.694.0053

ALL RIGHTS RESERVED.

PROPERTY OF LOCI LANDSCAPE ARCHITECTURE
AND URBAN DESIGN. USE OR REPRODUCTION

PROHIBITED WITH PRIOR WRITTEN CONSENT.



Peterson

Project Stamp



....

No.	Description	Date
F	Issued for Development Permit	21-05-30
G	Re-Issued for Development Permit	21-12-23
Н	Issued for TRS Response	22-02-03

Project Info

20168

Dilworth Center
Mixed Use
2339 Highway 97N
Kelowna, BC

Project Team

Peterson

Architect IBI Group

Landscape Architect

LOCI Landscape Architecture + Urban Design

Checked By

JD

PH 2 - TREE MANAGEMENT PLAN

LO.2



- A BARON ROAD ENTRY DRIVE + PLAZA
- 1 GATHERING NODE WITH FEATURE PAVING, SEATING, POSSIBLE PUBLIC ART
- 2 COMMERCIAL RETAIL FRONTAGE SHADE TREES + SEATING
- 3 NEW TREE-LINED INTERNAL ROAD
- B INTERNAL STREETS + BUILDING FRONTAGE
- 4 COMMERCIAL RETAIL FRONTAGE SHADE TREES + SEATING
- 5 STREETSIDE PARKING AND PLANTED BOULEVARD + TREES

PEDESTRIAN CROSSINGS AT KEY BUILDING ENTRIES

- 7 PARKADE ENTRY
- PRIVATE PATIOS + UNIT WALK-UPS (RAISED) WITH BUFFER PLANTING

- POCKET PARK + PLAYGROUND (PUBLIC ACCESS)
- PIP RUBBER SURFACE + PLAY EQUIPMENT (5-12 YEARS OLD)
- WITH SEATING + SHADE CANOPY
- MULTI-USE PUBLIC PATH (7'-0" WIDE)
- SOUTH AMENITY DECK
- 11 SOCIAL AREA WITH OUTDOOR LOUNGE AREAS
- 12 GAMES AREA BOCCE, PING PONG, ETC.
- RAISED POOL DECK + HOT TUB WITH PERIMETER SEATING
- 4 OUTDOOR KITCHEN/BAR COVERED AREA
- 15 STAIRS + RAMP



1738 KINGSWAY, VANCOUVER, BC V5N 2S3 www.locidesign.ca // 604.694.0053

ALL RIGHTS RESERVED.

AND URBAN DESIGN. USE OR REPRODUCTION

PROHIBITED WITH PRIOR WRITTEN CONSENT.



Peterson

Project Stam



Issue

No. Description [F Issued for Development Permit 21-05]

G Re-Issued for Development 21-1
Permit

22-02-03

H Issued for TRS Response

Project Info

20168

Dilworth Center

Mixed Use 2339 Highway 97N Kelowna, BC

Project Team

Client Peterson

Architect IBI Group

Louis de como Amelia de

Landscape Architect


LOCI Landscape Architecture + Urban Design


Drawn By Checked By


ID MF

PH 2 - OVERALL LANDSCAPE PLAN

103

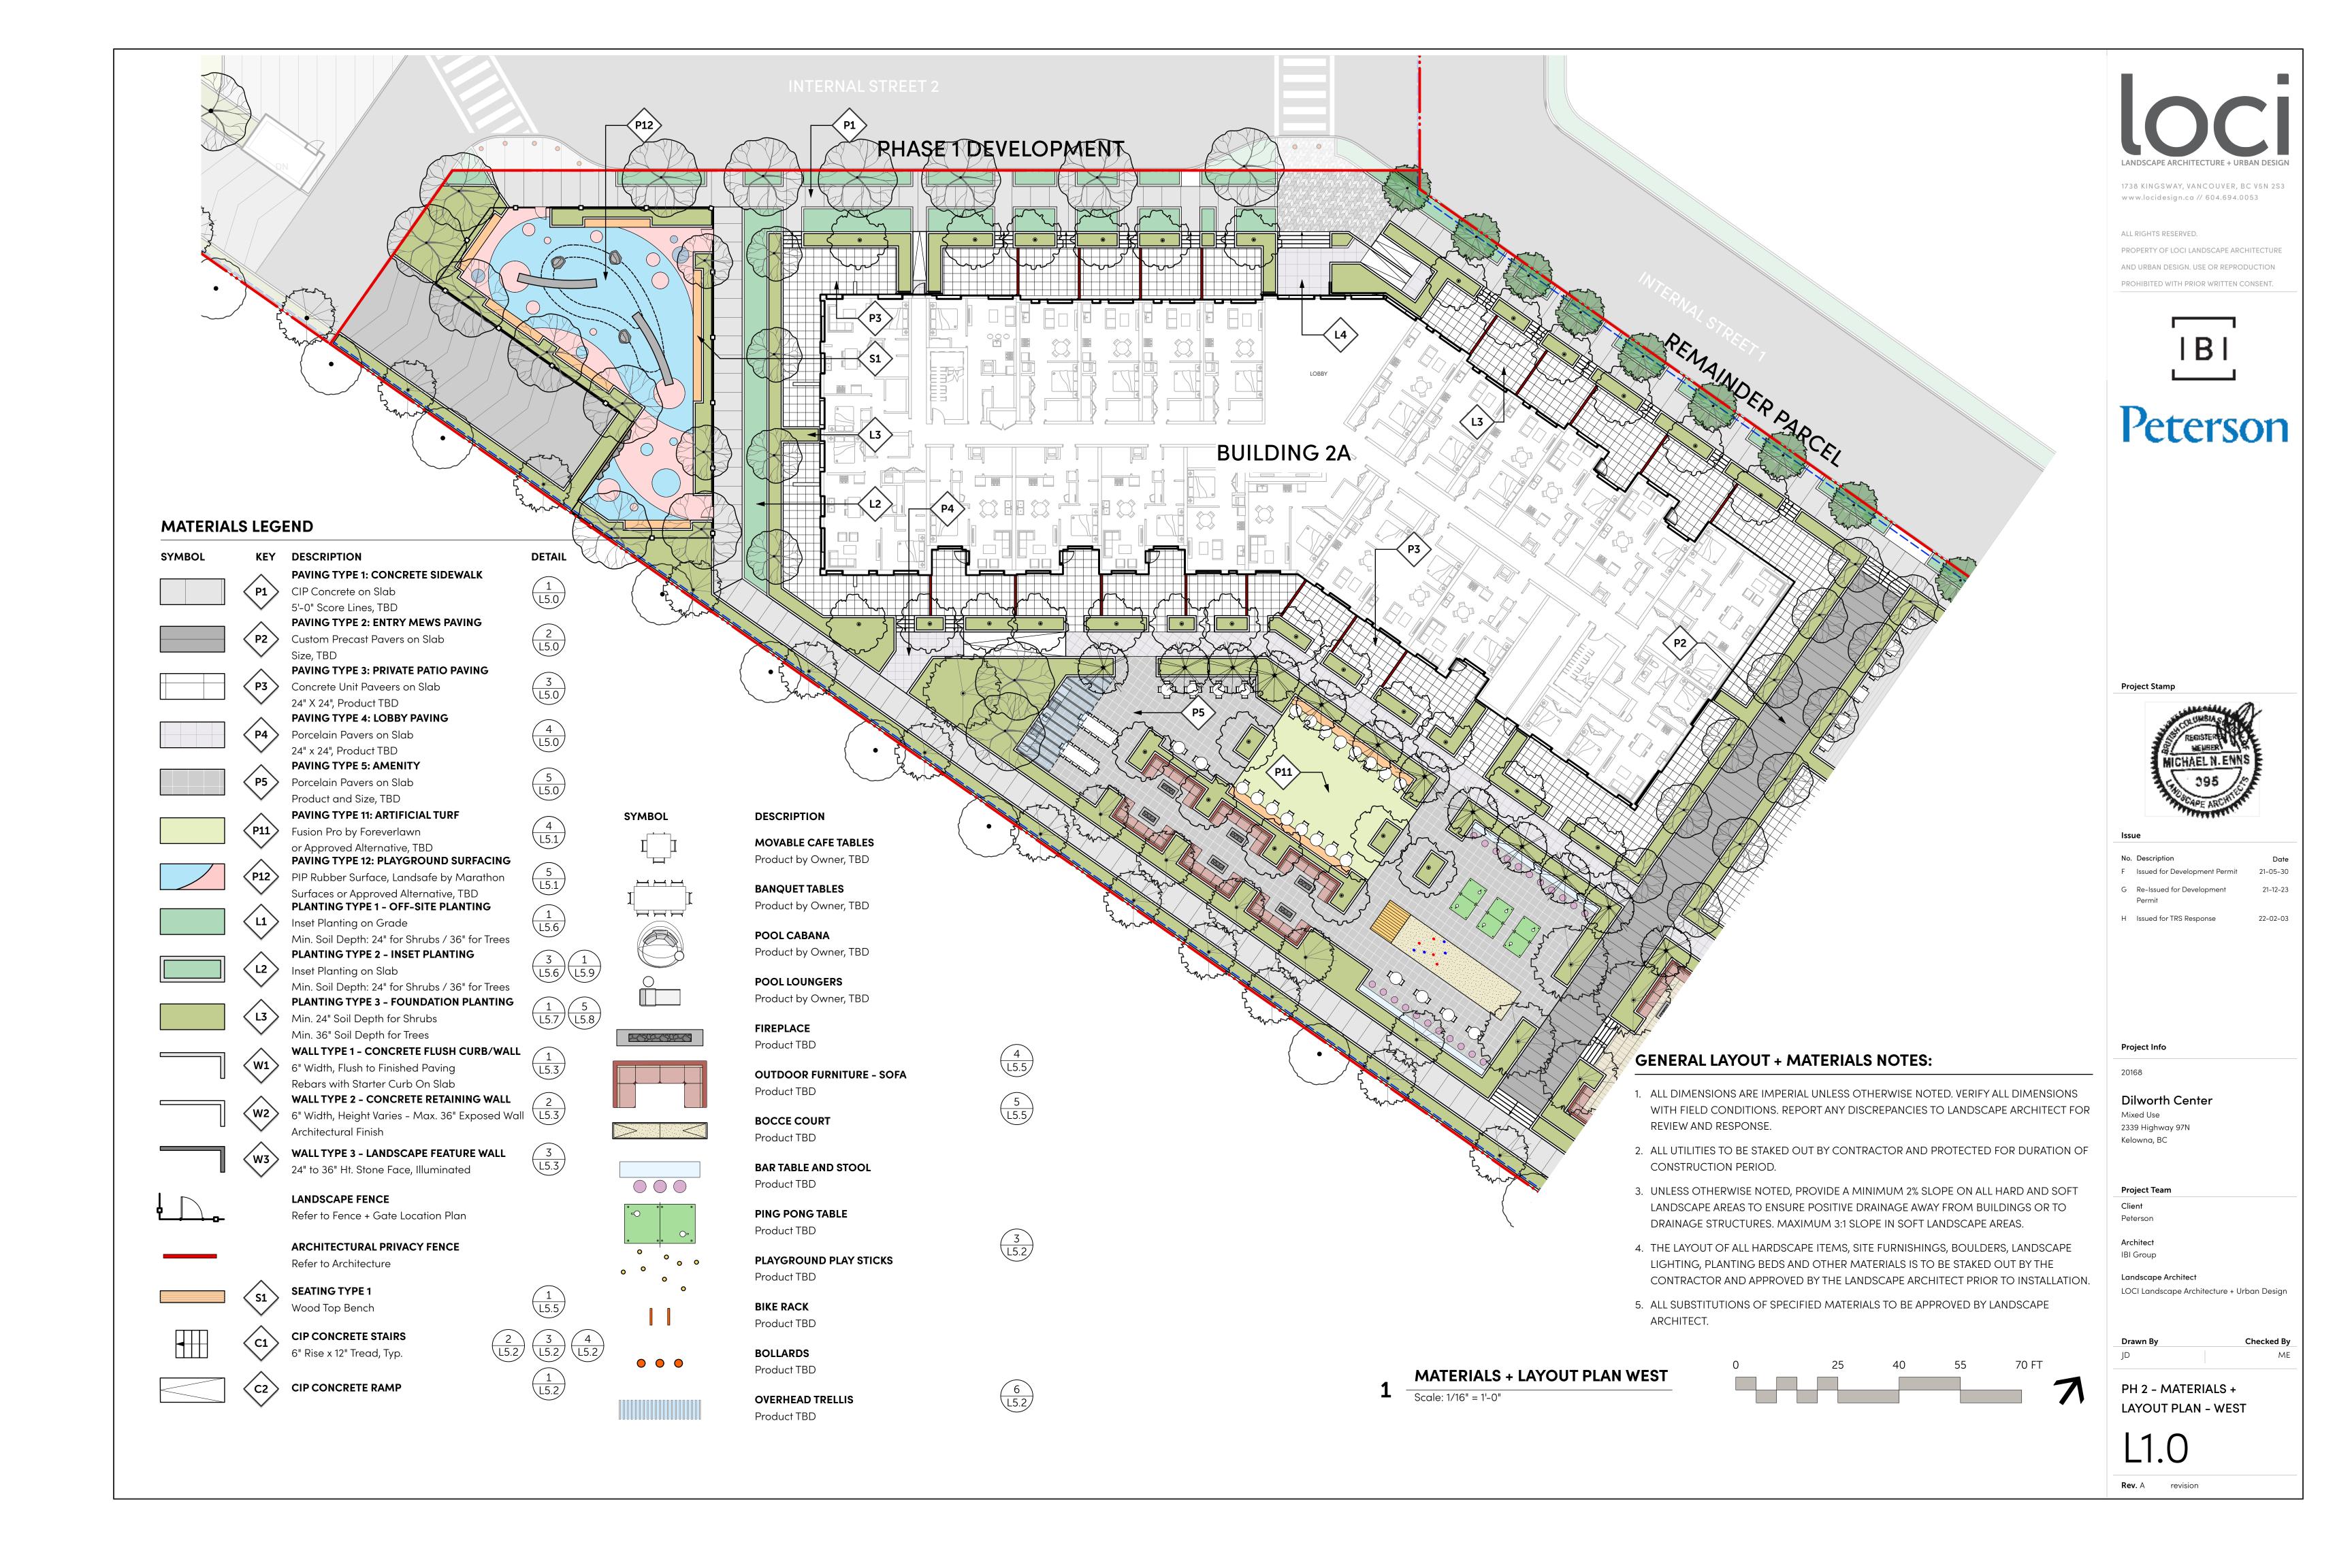

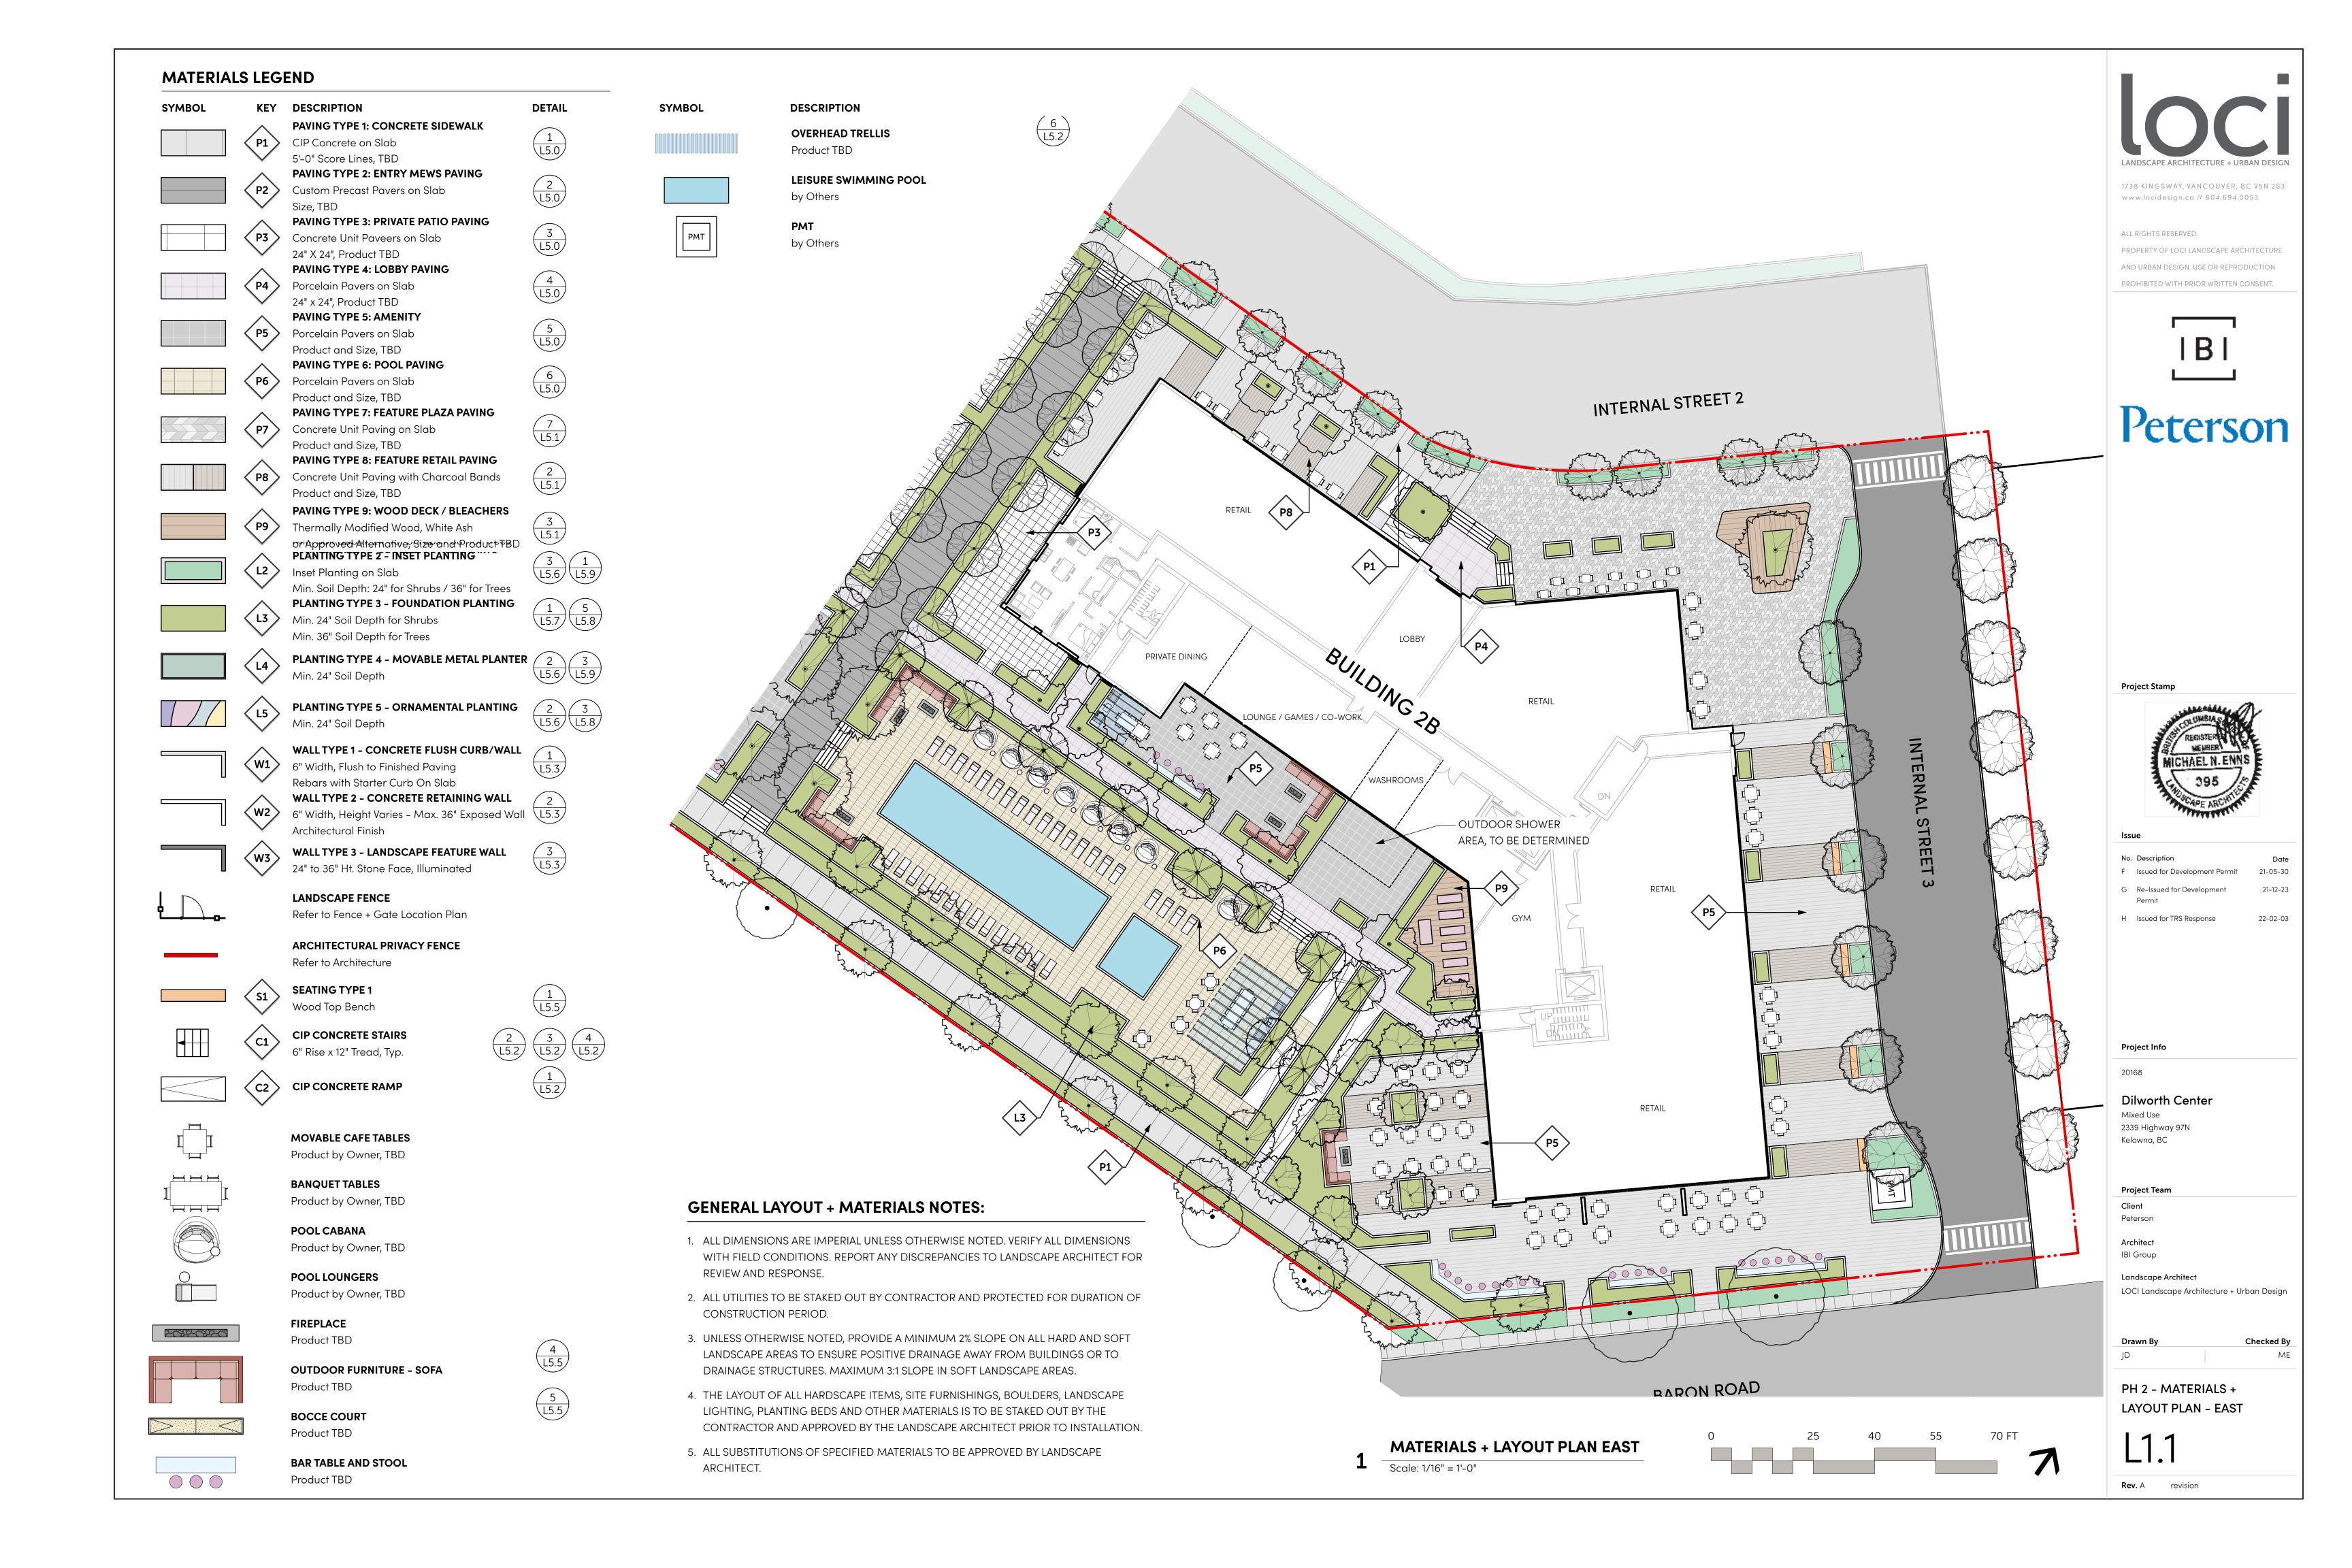

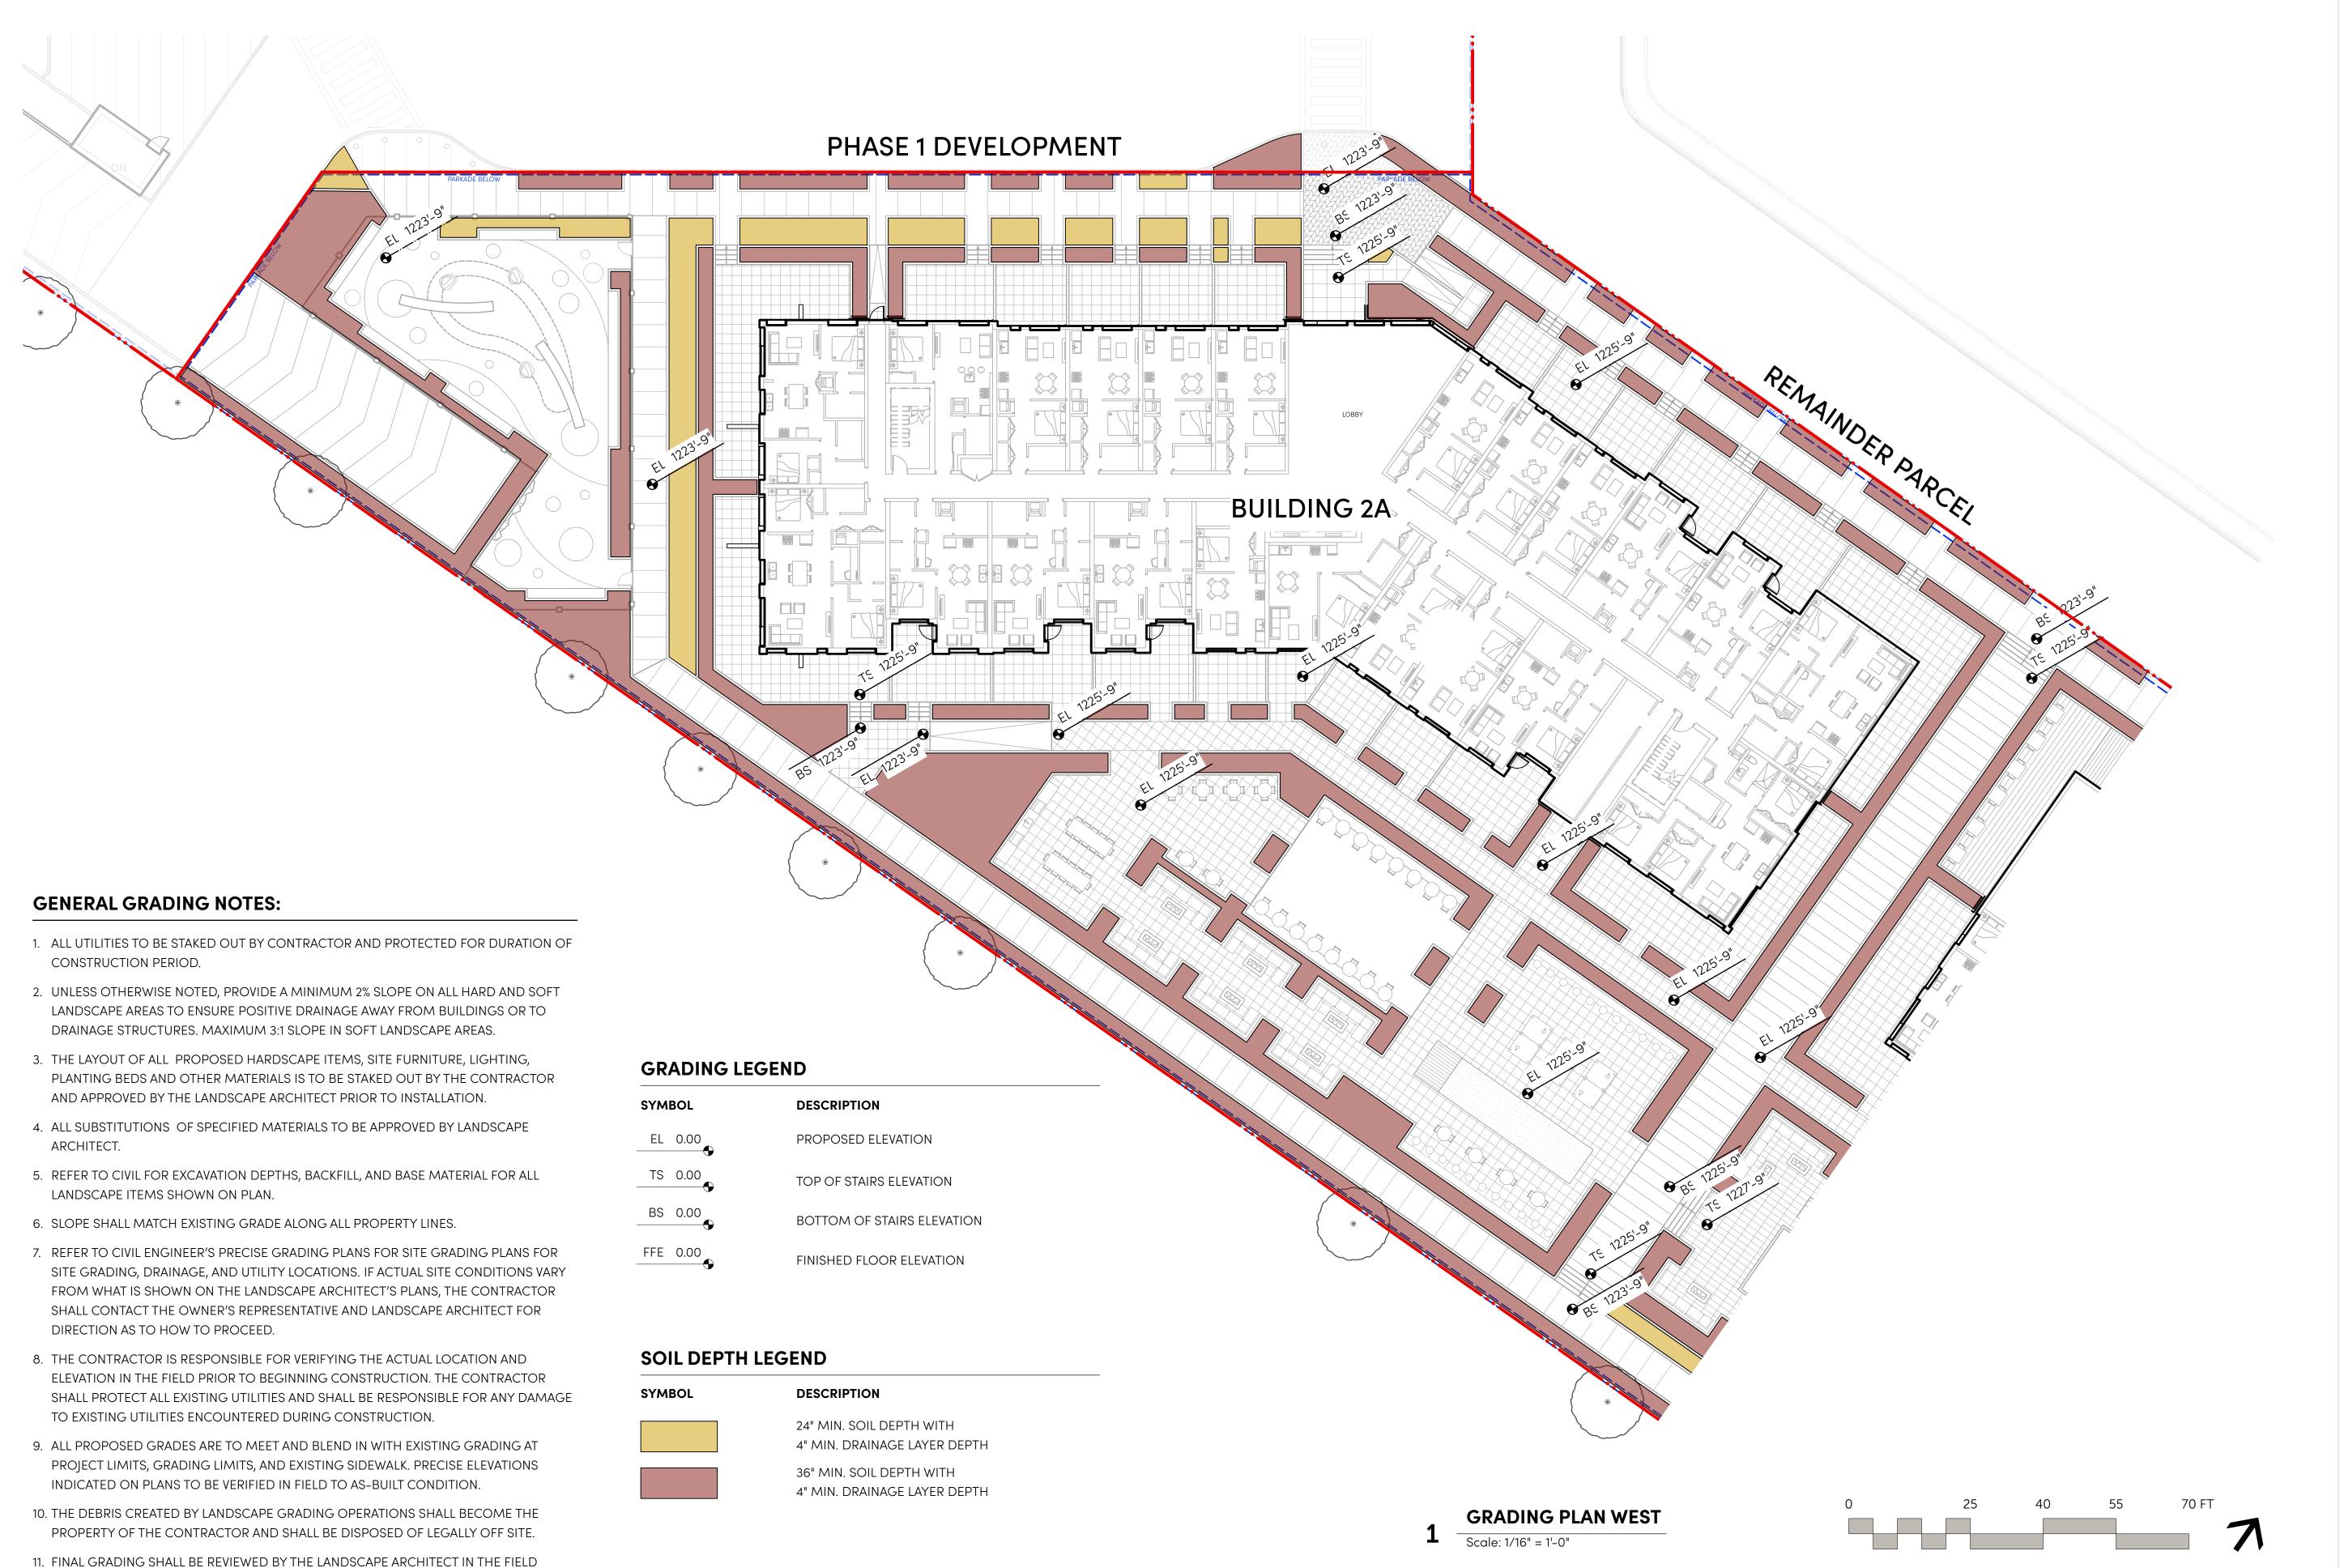

PRIOR TO INSTALLATION OF PLANTING.



1738 KINGSWAY, VANCOUVER, BC V5N 2S3 www.locidesign.ca // 604.694.0053

ALL RIGHTS RESERVED.

PROPERTY OF LOCI LANDSCAPE ARCHITECTURE
AND URBAN DESIGN. USE OR REPRODUCTION

PROHIBITED WITH PRIOR WRITTEN CONSENT.



Peterson

Project Stam



legue

No.	Description	Da
F	Issued for Development Permit	21-05-3
G	Re-Issued for Development Permit	21-12-2

22-02-03

H Issued for TRS Response

Project Info

20168

Dilworth Center

Mixed Use 2339 Highway 97N

Project Team

Kelowna, BC

Client Peterson

Architect IBI Group

Landscape Architect

LOCI Landscape Architecture + Urban Design

Drawn By Checked By

ID MF

PH 2 - GRADING PLAN -

WEST

GENERAL GRADING NOTES:

- ALL UTILITIES TO BE STAKED OUT BY CONTRACTOR AND PROTECTED FOR DURATION OF CONSTRUCTION PERIOD.
- 2. UNLESS OTHERWISE NOTED, PROVIDE A MINIMUM 2% SLOPE ON ALL HARD AND SOFT LANDSCAPE AREAS TO ENSURE POSITIVE DRAINAGE AWAY FROM BUILDINGS OR TO DRAINAGE STRUCTURES. MAXIMUM 3:1 SLOPE IN SOFT LANDSCAPE AREAS.
- 3. THE LAYOUT OF ALL PROPOSED HARDSCAPE ITEMS, SITE FURNITURE, LIGHTING, PLANTING BEDS AND OTHER MATERIALS IS TO BE STAKED OUT BY THE CONTRACTOR AND APPROVED BY THE LANDSCAPE ARCHITECT PRIOR TO INSTALLATION.
- 4. ALL SUBSTITUTIONS OF SPECIFIED MATERIALS TO BE APPROVED BY LANDSCAPE ARCHITECT.
- 5. REFER TO CIVIL FOR EXCAVATION DEPTHS, BACKFILL, AND BASE MATERIAL FOR ALL LANDSCAPE ITEMS SHOWN ON PLAN.
- 6. SLOPE SHALL MATCH EXISTING GRADE ALONG ALL PROPERTY LINES.
- 7. REFER TO CIVIL ENGINEER'S PRECISE GRADING PLANS FOR SITE GRADING PLANS FOR SITE GRADING, DRAINAGE, AND UTILITY LOCATIONS. IF ACTUAL SITE CONDITIONS VARY FROM WHAT IS SHOWN ON THE LANDSCAPE ARCHITECT'S PLANS, THE CONTRACTOR SHALL CONTACT THE OWNER'S REPRESENTATIVE AND LANDSCAPE ARCHITECT FOR DIRECTION AS TO HOW TO PROCEED.
- 8. THE CONTRACTOR IS RESPONSIBLE FOR VERIFYING THE ACTUAL LOCATION AND ELEVATION IN THE FIELD PRIOR TO BEGINNING CONSTRUCTION. THE CONTRACTOR SHALL PROTECT ALL EXISTING UTILITIES AND SHALL BE RESPONSIBLE FOR ANY DAMAGE TO EXISTING UTILITIES ENCOUNTERED DURING CONSTRUCTION.
- 9. ALL PROPOSED GRADES ARE TO MEET AND BLEND IN WITH EXISTING GRADING AT PROJECT LIMITS, GRADING LIMITS, AND EXISTING SIDEWALK. PRECISE ELEVATIONS INDICATED ON PLANS TO BE VERIFIED IN FIELD TO AS-BUILT CONDITION.
- 10. THE DEBRIS CREATED BY LANDSCAPE GRADING OPERATIONS SHALL BECOME THE PROPERTY OF THE CONTRACTOR AND SHALL BE DISPOSED OF LEGALLY OFF SITE.
- 11. FINAL GRADING SHALL BE REVIEWED BY THE LANDSCAPE ARCHITECT IN THE FIELD PRIOR TO INSTALLATION OF PLANTING.


GRADING LEGEND

SYMBOL	DESCRIPTION
EL 0.00	PROPOSED ELEVATION
TS 0.00	TOP OF STAIRS ELEVATION
BS 0.00	BOTTOM OF STAIRS ELEVATION
FFE 0.00	FINISHED FLOOR ELEVATION

SOIL DEPTH LEGEND

SYMBOL

DESCRIPTION

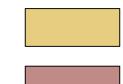

24" MIN. SOIL DEPTH WITH

4" MIN. DRAINAGE LAYER DEPTH

36" MIN. SOIL DEPTH WITH
4" MIN. DRAINAGE LAYER DEPTH





1738 KINGSWAY, VANCOUVER, BC V5N 2S3 www.locidesign.ca // 604.694.0053

ALL RIGHTS RESERVED.

PROPERTY OF LOCI LANDSCAPE ARCHITECTURE

AND URBAN DESIGN. USE OR REPRODUCTION

PROHIBITED WITH PRIOR WRITTEN CONSENT.



Peterson

Project Stam



Issue

No.	Description	Date
F	Issued for Development Permit	21-05-30
G	Re-Issued for Development Permit	21-12-23

22-02-03

H Issued for TRS Response

Project Info

20168

Dilworth Center

Mixed Use 2339 Highway 97N Kelowna, BC

Project Team

Client

Peterson

Architect

IBI Group

Landscape Architect

LOCI Landscape Architecture + Urban Design

Checked By

PH 2 - GRADING PLAN -EAST

113



10. INSTALL TREE PROTECTION FENCING AROUND ALL EXISTING TREES TO THE CITY STANDARDS. INSTALL TREE PROTECTION FENCING ON NEW PLANTING IF PHASED

11. ALL PLANTING BEDS TO RECEIVE AUTOMATIC DRIP IRRIGATION

INSTALLATION IS REQUIRED.

LANDSCAPE ARCHITECTURE + URBAN DESIGN

1738 KINGSWAY, VANCOUVER, BC V5N 2S3 www.locidesign.ca // 604.694.0053

ALL RIGHTS RESERVED.

PROPERTY OF LOCI LANDSCAPE ARCHITECTURE
AND URBAN DESIGN. USE OR REPRODUCTION

PROHIBITED WITH PRIOR WRITTEN CONSENT.



Peterson

Project Stamp



legue

No.	Description	Dat
F	Issued for Development Permit	21-05-3
G	Re-Issued for Development Permit	21-12-2

22-02-03

H Issued for TRS Response

Project Info

20168

Dilworth Center

Mixed Use 2339 Highway 97N Kelowna, BC

Project Team

Client Peterson

IBI Group

Architect

Landscape Architect

LOCI Landscape Architecture + Urban Design

Drawn By Checked By

DU A TREE DI ANTIN

PH 2 - TREE PLANTING PLAN - WEST

L1.4



TREE PLANTING PLAN EAST

1738 KINGSWAY, VANCOUVER, BC V5N 2S3 www.locidesign.ca // 604.694.0053

PROPERTY OF LOCI LANDSCAPE ARCHITECTURE

AND URBAN DESIGN. USE OR REPRODUCTION

PROHIBITED WITH PRIOR WRITTEN CONSENT.

IBI

Peterson

F Issued for Development Permit

21-12-23

22-02-03

G Re-Issued for Development

H Issued for TRS Response

Project Info

Dilworth Center

2339 Highway 97N

Kelowna, BC

Project Team

Peterson

Architect

IBI Group

Landscape Architect

PLAN - EAST

Rev. A revision

LOCI Landscape Architecture + Urban Design

PH 2 - TREE PLANTING


Checked By


20168


ALL RIGHTS RESERVED.

GENERAL PLANTING NOTES:

- 1. ALL PLANTING SHALL BE IN ACCORDANCE WITH BC LANDSCAPE STANDARD, LATEST EDITION
- 2. ALL TREE AND SHRUB AREAS TO BE MULCHED WITH 50MM (2") OF MEDIUM FINE MULCH, LESS THAN 50MM (2") DIAMETER.
- 3. ROOTZONE TO REST ON TAMPED PLANTING SOIL
- 4. SHRUBS: PREPARE PLANTING HOLES AS SPECIFIED. PLANT AT THE SAME GRADE AS NURSERY. WATER AND FERTILIZE AS SPECIFIED. ENSURE POSITIVE DRAINAGE THROUGHOUT PLANTING BED
- 5. TREE SIZE AND SPACING TO BE AS PER CITY OF VANCOUVER ARBORIST
- 6. TREE: PREPARE PLANTING HOLES AS SPECIFIED INSTALL TOP OF ROOTZONE 6" ABOVE FINISHED GRADE OF GROWING MEDIUM. WATER AND FERTILIZE AS SPECIFIED BY NURSERY.
- 7. FINAL SOFTSCAPE AND GRADING LAYOUTS AS WELL AS LOCATION SPACING TO BE APPROVED BY LANDSCAPE ARCHITECTS IN THE FIELD PRIOR TO INSTALLATION
- 8. IN CASE OF A DISCREPANCY BETWEEN PLANT INFORMATION ON THE LIST AND ON THE PLAN, THE LATTER SHALL PREVAIL
- 9. ALL PLANT MATERIAL TO BE MANUALLY WATERED FROM START OF INSTALLATION THROUGH THE END OF THE WARRANTY PERIOD
- 10. INSTALL TREE PROTECTION FENCING AROUND ALL EXISTING TREES TO THE CITY STANDARDS. INSTALL TREE PROTECTION FENCING ON NEW PLANTING IF PHASED INSTALLATION IS REQUIRED.
- 11. ALL PLANTING BEDS TO RECEIVE AUTOMATIC DRIP IRRIGATION

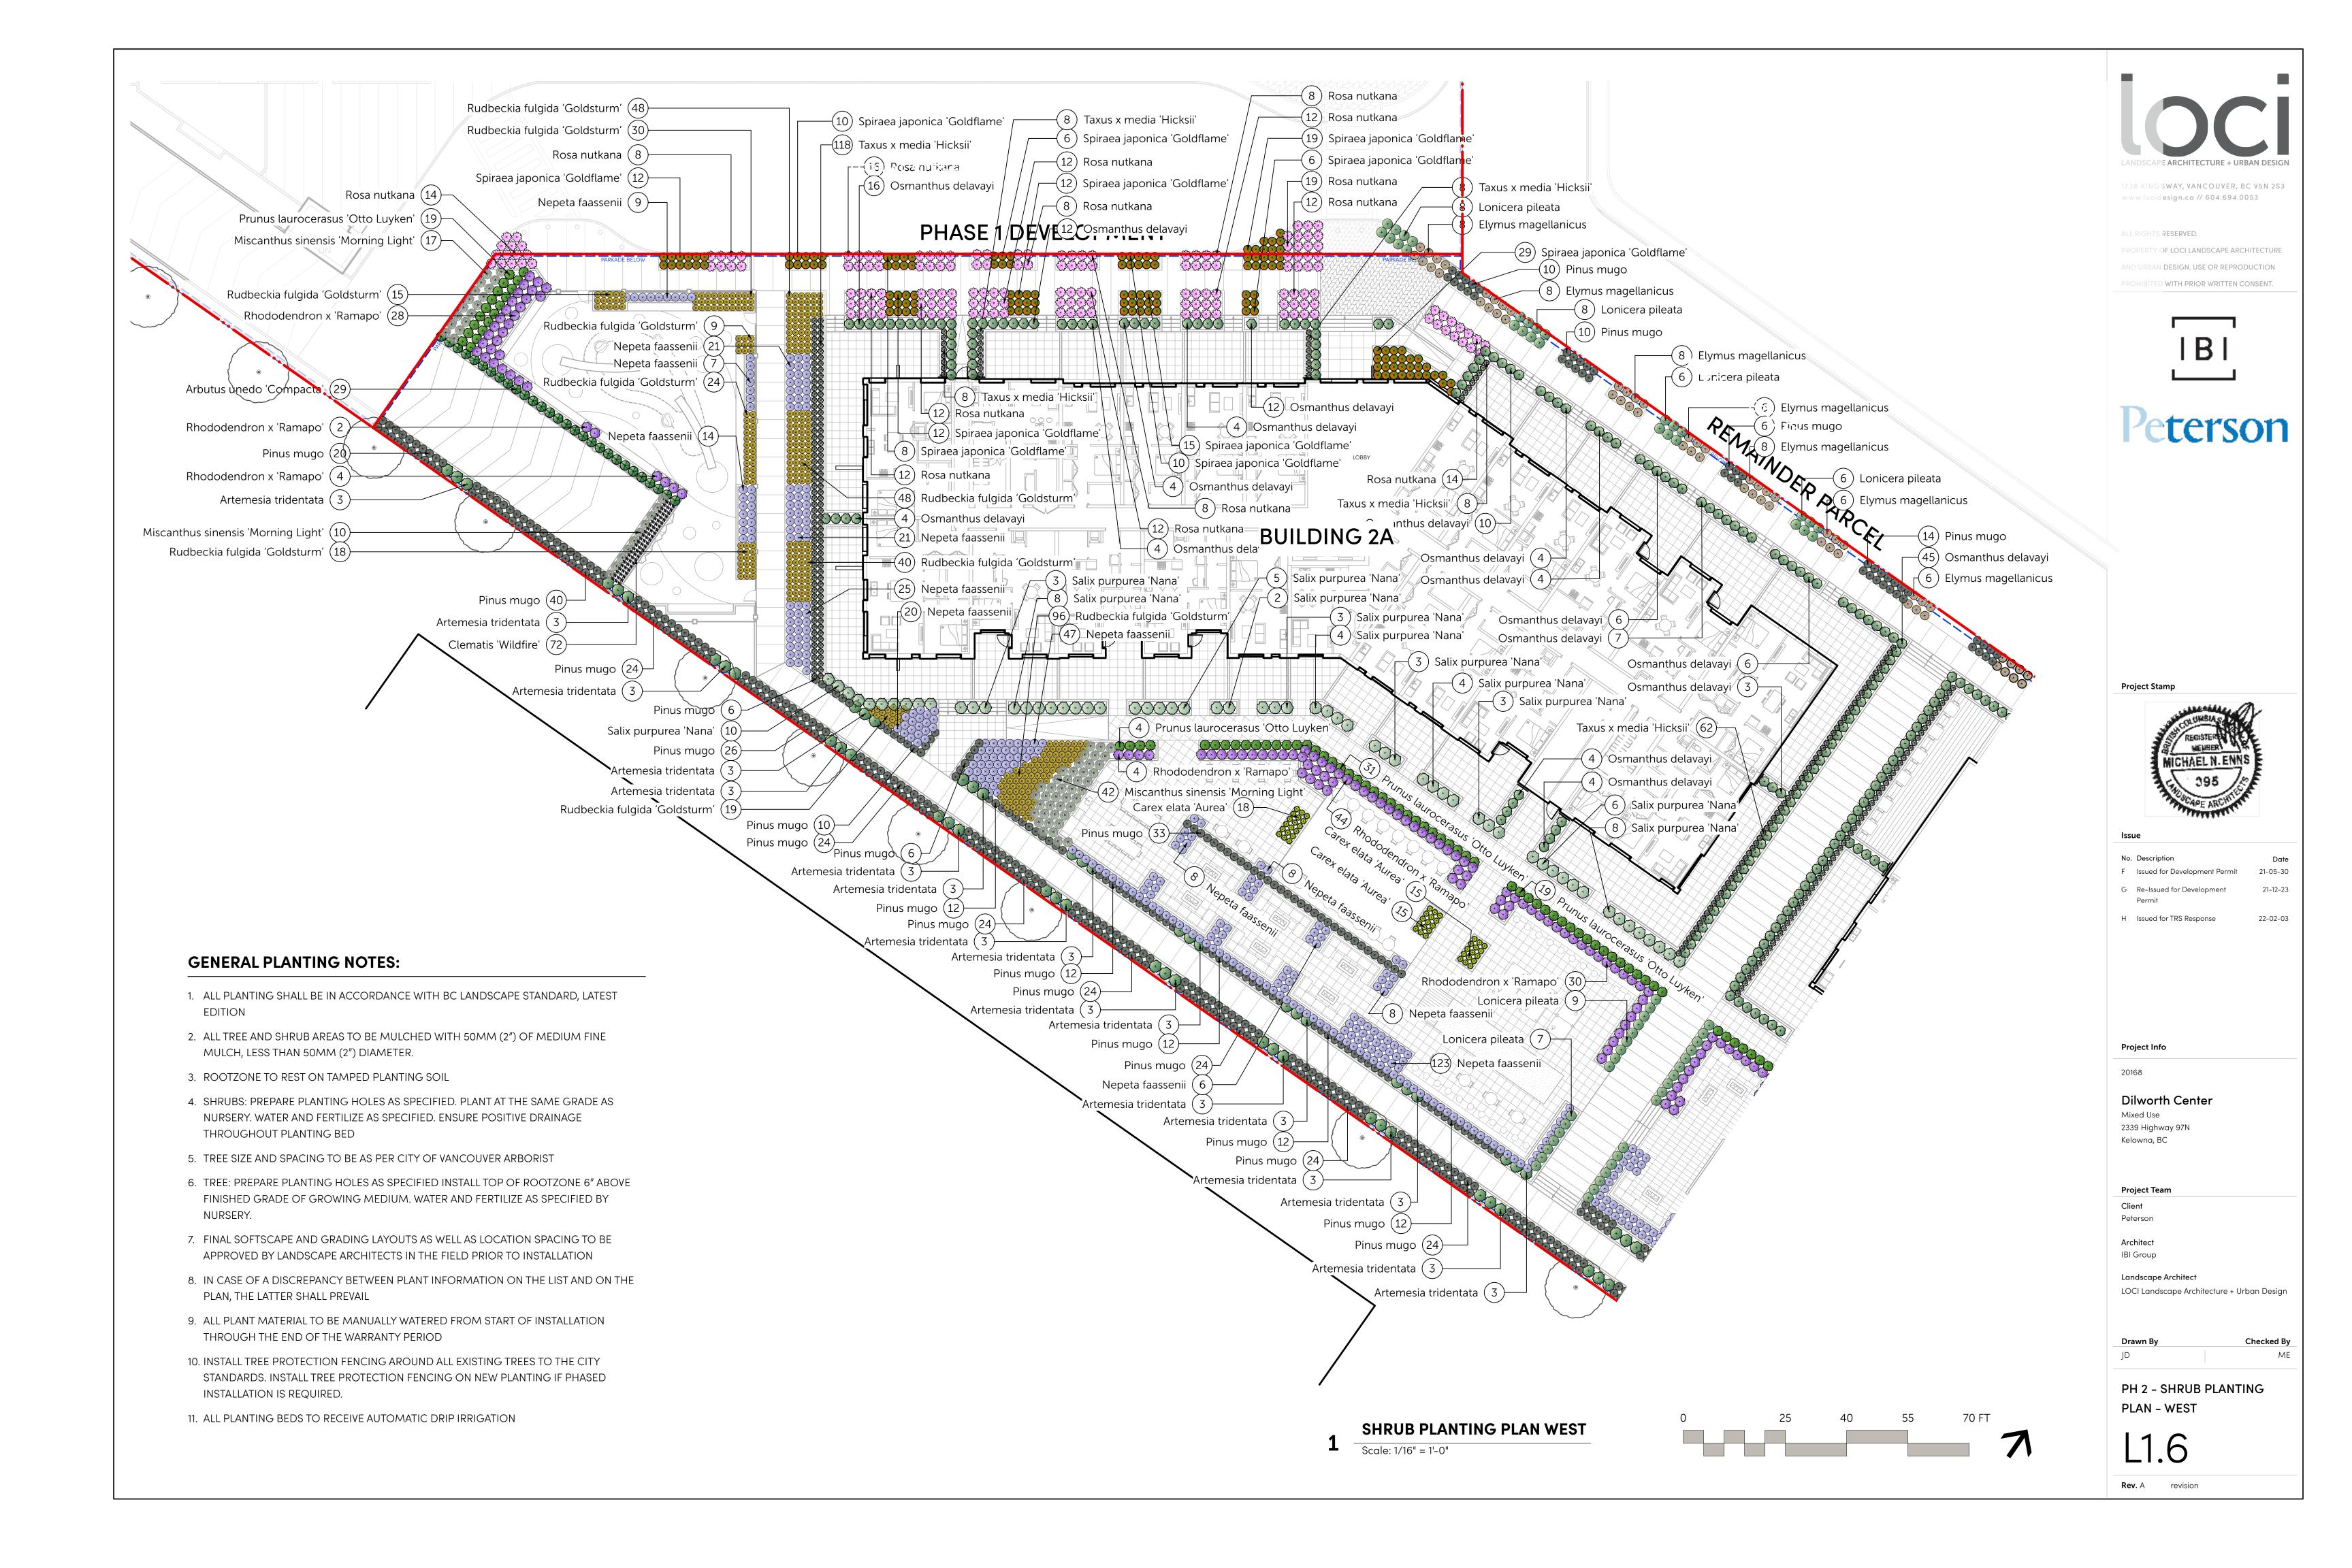

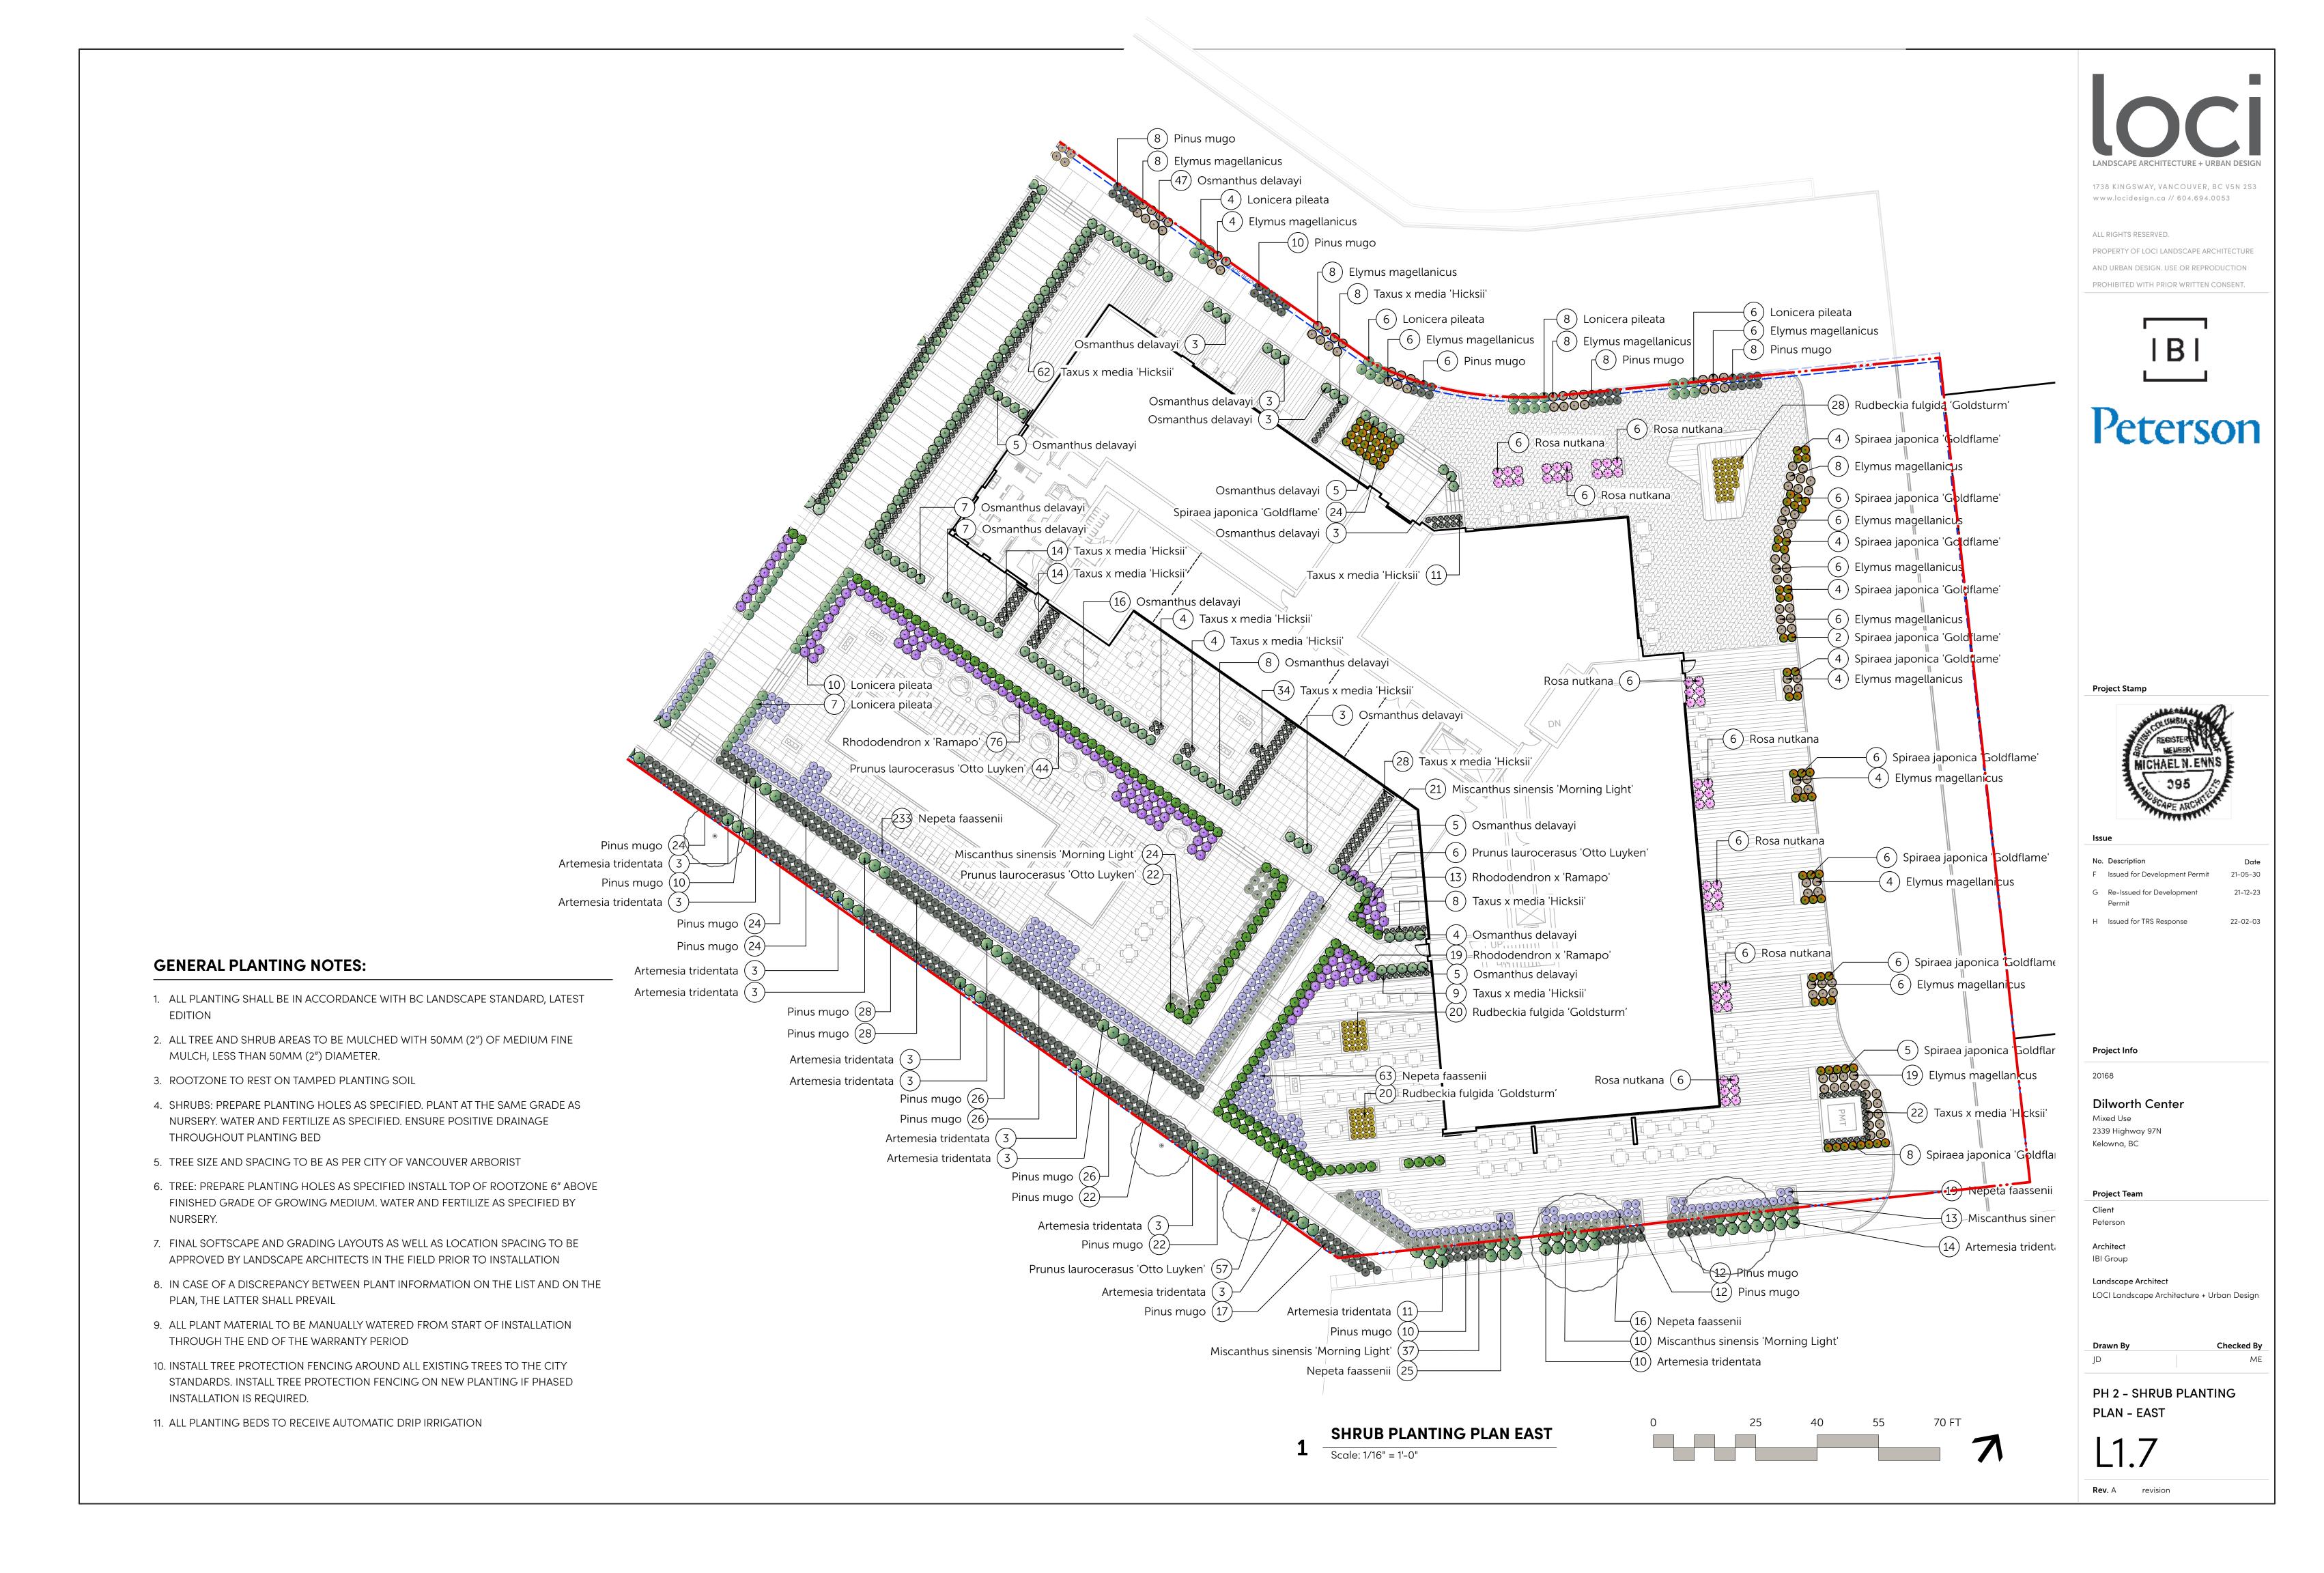

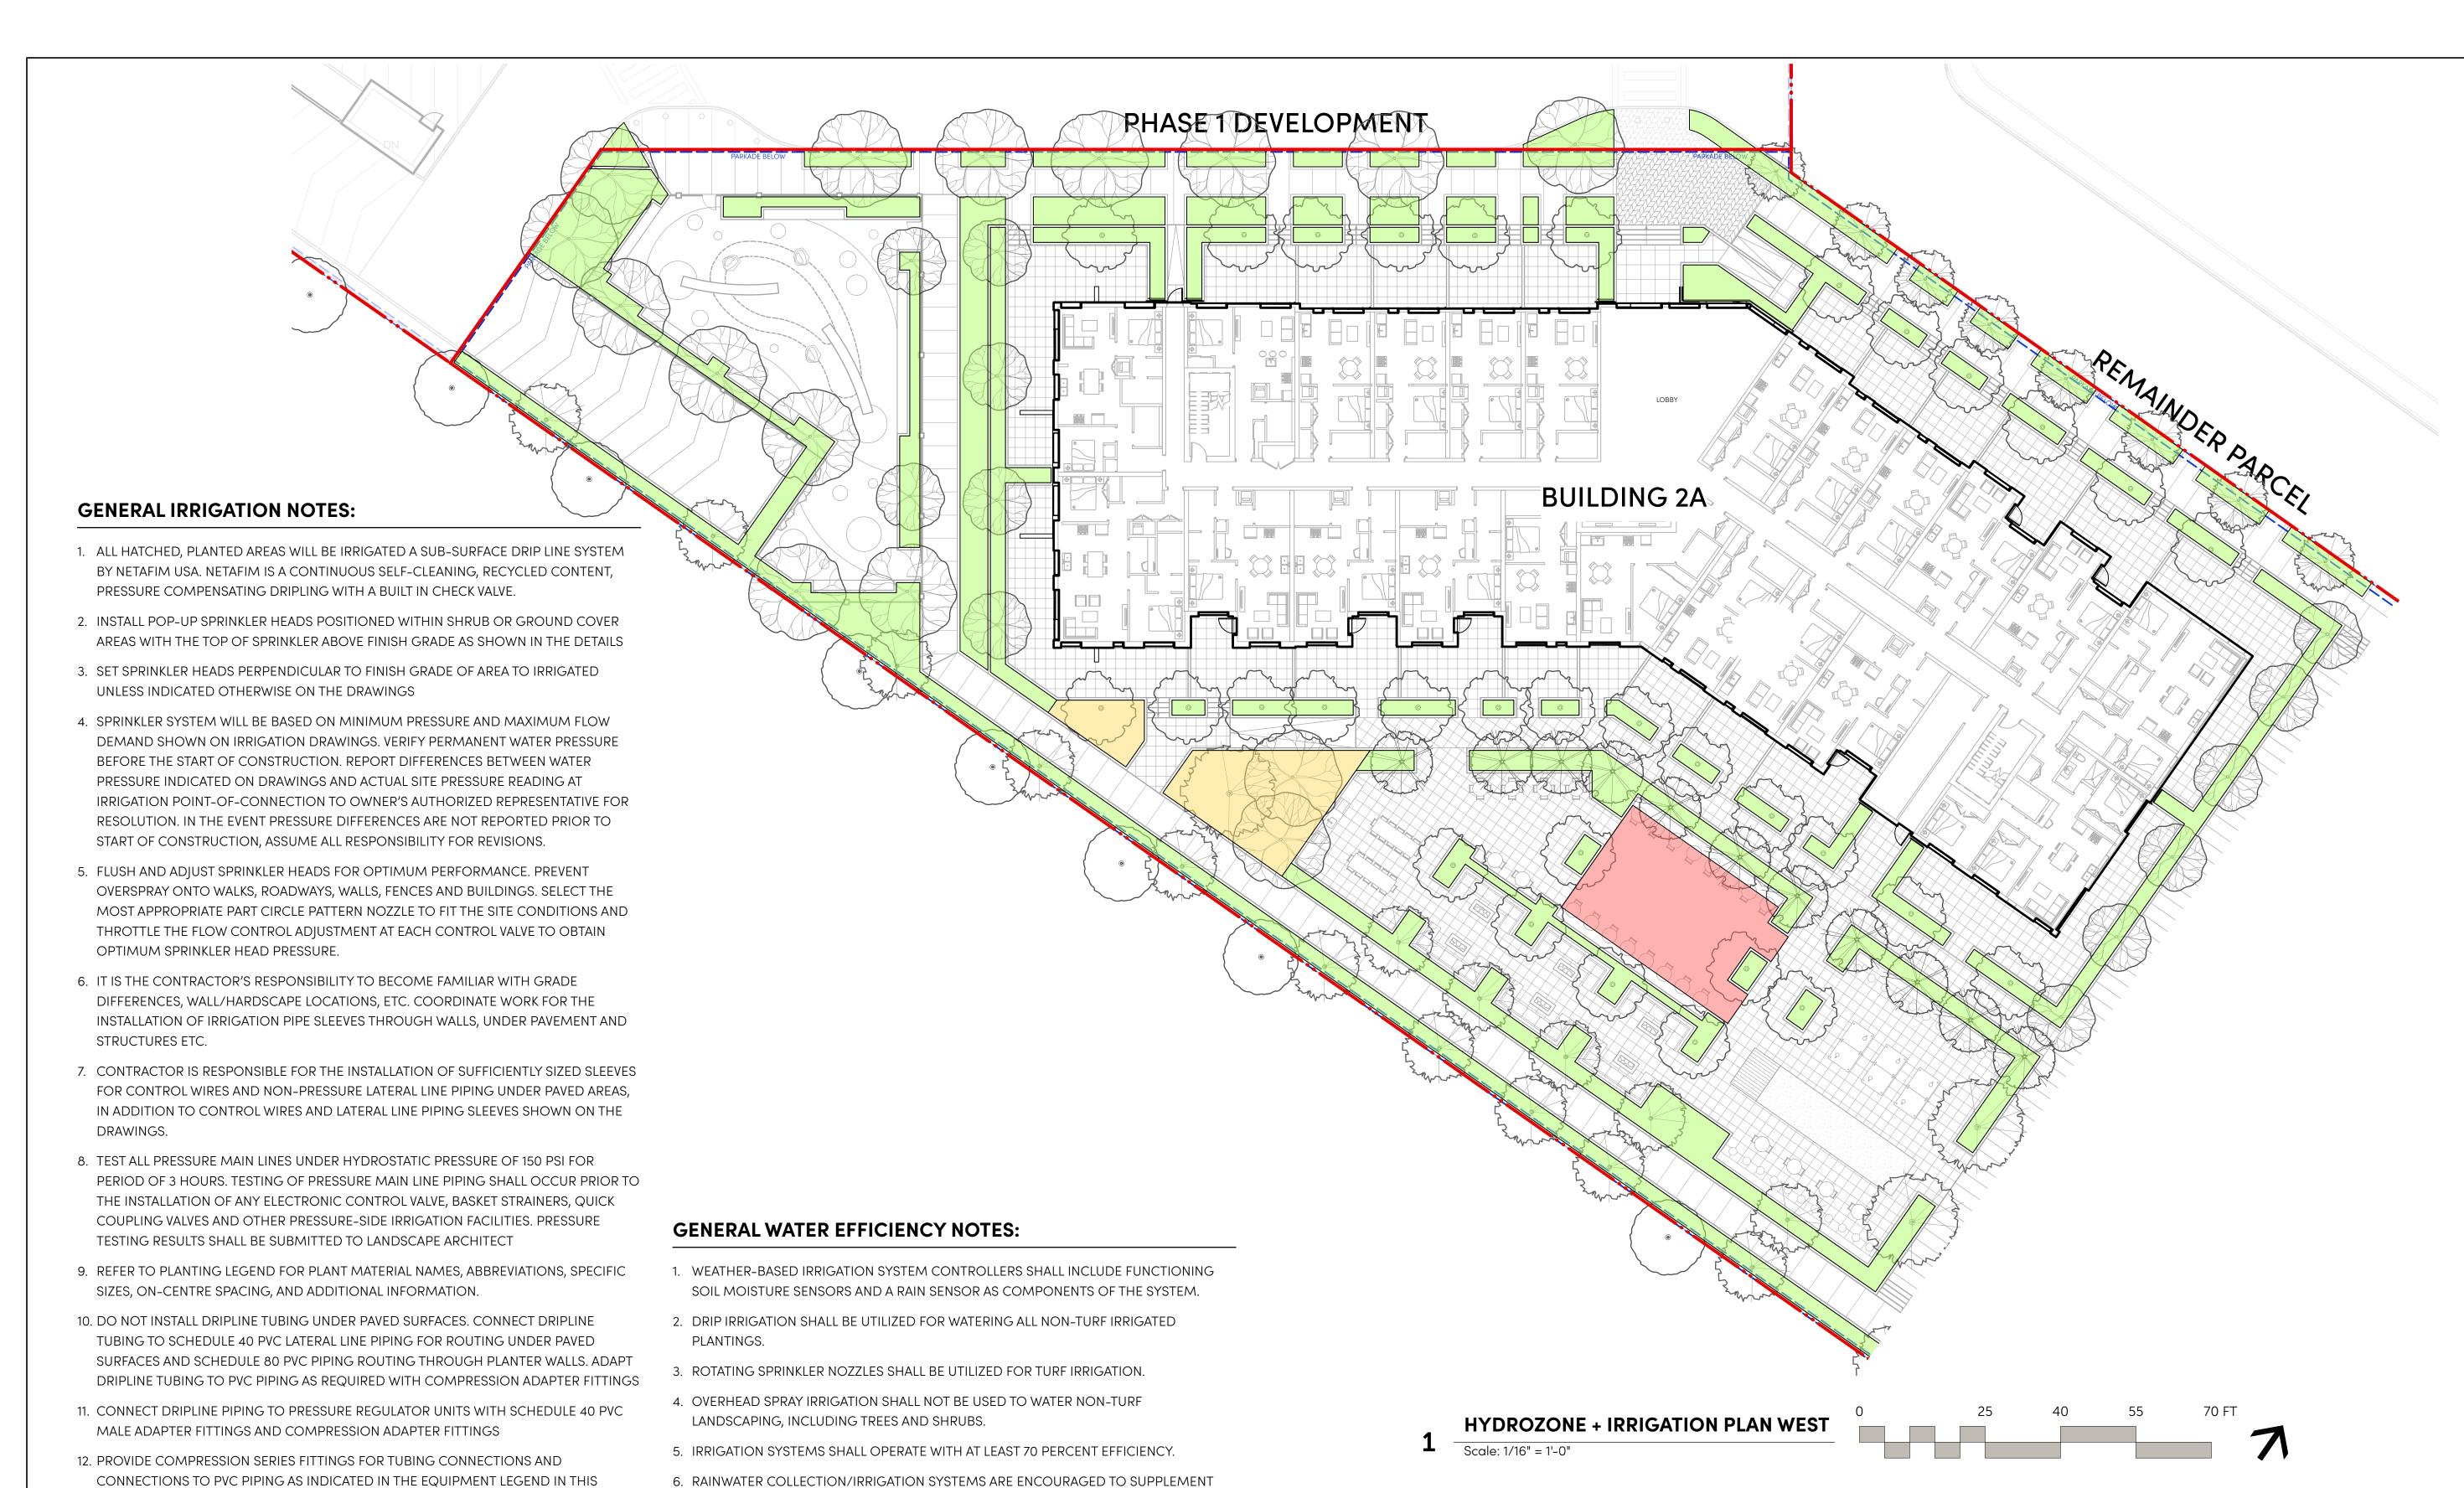

IRRIGATION FOR NEW LANDSCAPING. NEW STRUCTURES SHALL BE ENCOURAGED TO

INCLUDE ONE OR MORE RAINWATER CISTERNS AND A SYSTEM TO PROVIDE AT LEAST 75

PERCENT OF EXTERIOR IRRIGATION DURING NORMAL RAINFALL YEARS. SYSTEMS MUST

7. GREYWATER COLLECTION/IRRIGATION SYSTEMS ARE ENCOURAGED TO SUPPLEMENT

IRRIGATION FOR NEW LANDSCAPING. SYSTEMS MUST BE COMPLIANT WITH LOCAL

8. ALL SITES UTILIZING A GREYWATER REUSE SYSTEM SHALL INSTALL AND MAINTAIN A

9. THE IMPLEMENTATION OF WATER CONSERVATION BEST MANAGEMENT PRACTICIES

CATCHMENT SYSTEM STANDARDS, INCLUDING MONTEREY COUNTY DEPARTMENT OF

BACKFLOW PREVENTION DEVICE AS REQUIRED BY ANY WATER DISTRIBUTION SYSTEM

SHALL BE INTEGRATED INTO CONSTRUCTION AND OPERATION OF THE PROJECT TO THE

BE COMPLIANT WITH LOCAL CATCHMENT SYSTEM STANDARDS.

ENVIRONMENTAL HEALTH.

EXTENT POSSIBLE.

OPERATOR THAT SUPPLIES WATER TO THE SITE.

HYDROZONES LEGEND			
SYMBOL	DESCRIPTION	PLANT FACTOR	IRRIGATION EFFICIENCY
	LOW WATER USE AREA WITH DRIP IRRIGATION	0.3	0.9
	MEDIUM WATER USE AREA WITH DRIP IRRIGATION	0.5	0.9
	WATERED TURF AREA WITH SPRAY IRRIGATION	1.0	0.7
	SWIMMING POOL AREA	1.0	1.0
	IMPERVIOUS AREA + BUILDING FOOTPRINT	N/A	N/A

SYMBOL	DESCRIPTION	PLANT	IRRIGATION
	LOW WATER USE AREA WITH DRIP IRRIGATION	FACTOR 0.3	0.9
	MEDIUM WATER USE AREA WITH DRIP IRRIGATION	0.5	0.9
	WATERED TURF AREA WITH SPRAY IRRIGATION	1.0	0.7
	SWIMMING POOL AREA	1.0	1.0
	IMPERVIOUS AREA + BUILDING FOOTPRINT	N/A	N/A

NOTE: REFER TO LANDSCAPE WATER USE APPLICATION AND IRRIGATION APPLICATION FORMS FOR HYDROZONE AREA CALCULATIONS

1738 KINGSWAY, VANCOUVER, BC V5N 2S3

www.locidesign.ca // 604.694.0053

ALL RIGHTS RESERVED.

PROPERTY OF LOCI LANDSCAPE ARCHITECTURE AND URBAN DESIGN. USE OR REPRODUCTION



PROHIBITED WITH PRIOR WRITTEN CONSENT.

Peterson



No.	Description	Date
F	Issued for Development Permit	21-05-30
G	Re-Issued for Development Permit	21-12-23

22-02-03

H Issued for TRS Response

20168

Project Info

Dilworth Center

Mixed Use 2339 Highway 97N Kelowna, BC

Project Team

Peterson

Architect

IBI Group

Landscape Architect LOCI Landscape Architecture + Urban Design

Checked By

PH 2 - HYDROZONE PLAN WEST

Rev. A revision

16. ALL PIPE TO BE SCHEDULE 40.

MECHANICAL ROOM.

SHEET.

WORK.

17. IRRIGATION CONTROLLER TO BE INSTALLED IN VANDAL RESISTANT METAL LOCK BOX.

13. SYSTEM TO BE DESIGN BUILD. CONTRACTOR SHALL REFER TO SPECIFICATIONS FOR ALL

14. CONTRACTOR SHALL BE RESPONSIBLE FOR PROVIDING AS-BUILT DRAWINGS FOR ALL

15. IRRIGATION COMMAND CONTROLLER WITH RAIN SENSOR SYSTEM TO BE MOUNTED IN

COMPLETED WORK ONCE APPROVED BY LANDSCAPE ARCHITECT.

- 18. INSTALL PRECISION SOIL SENSOR ON SYSTEM
- 19. ALL PIPING RUNS ARE DIAGRAMMATIC, AVOID TRENCHING NEAR EXISTING TREE DRIP LINE.

HYDROZONES LEGEND

SYMBOL	DESCRIPTION	PLANT FACTOR	IRRIGATION EFFICIENCY
	LOW WATER USE AREA WITH DRIP IRRIGATION	0.3	0.9
	MEDIUM WATER USE AREA WITH DRIP IRRIGATION	0.5	0.9
	WATERED TURF AREA WITH SPRAY IRRIGATION	1.0	0.7
	SWIMMING POOL AREA	1.0	1.0
	IMPERVIOUS AREA + BUILDING FOOTPRINT	N/A	N/A

NOTE: REFER TO LANDSCAPE WATER USE APPLICATION AND IRRIGATION APPLICATION FORMS FOR HYDROZONE AREA CALCULATIONS

GENERAL IRRIGATION NOTES:

- 1. ALL HATCHED, PLANTED AREAS WILL BE IRRIGATED A SUB-SURFACE DRIP LINE SYSTEM BY NETAFIM USA. NETAFIM IS A CONTINUOUS SELF-CLEANING, RECYCLED CONTENT, PRESSURE COMPENSATING DRIPLING WITH A BUILT IN CHECK VALVE.
- 2. INSTALL POP-UP SPRINKLER HEADS POSITIONED WITHIN SHRUB OR GROUND COVER AREAS WITH THE TOP OF SPRINKLER ABOVE FINISH GRADE AS SHOWN IN THE DETAILS
- 3. SET SPRINKLER HEADS PERPENDICULAR TO FINISH GRADE OF AREA TO IRRIGATED UNLESS INDICATED OTHERWISE ON THE DRAWINGS
- 4. SPRINKLER SYSTEM WILL BE BASED ON MINIMUM PRESSURE AND MAXIMUM FLOW DEMAND SHOWN ON IRRIGATION DRAWINGS. VERIFY PERMANENT WATER PRESSURE BEFORE THE START OF CONSTRUCTION. REPORT DIFFERENCES BETWEEN WATER PRESSURE INDICATED ON DRAWINGS AND ACTUAL SITE PRESSURE READING AT IRRIGATION POINT-OF-CONNECTION TO OWNER'S AUTHORIZED REPRESENTATIVE FOR RESOLUTION. IN THE EVENT PRESSURE DIFFERENCES ARE NOT REPORTED PRIOR TO START OF CONSTRUCTION, ASSUME ALL RESPONSIBILITY FOR REVISIONS.
- 5. FLUSH AND ADJUST SPRINKLER HEADS FOR OPTIMUM PERFORMANCE. PREVENT OVERSPRAY ONTO WALKS, ROADWAYS, WALLS, FENCES AND BUILDINGS. SELECT THE MOST APPROPRIATE PART CIRCLE PATTERN NOZZLE TO FIT THE SITE CONDITIONS AND THROTTLE THE FLOW CONTROL ADJUSTMENT AT EACH CONTROL VALVE TO OBTAIN OPTIMUM SPRINKLER HEAD PRESSURE.
- 6. IT IS THE CONTRACTOR'S RESPONSIBILITY TO BECOME FAMILIAR WITH GRADE DIFFERENCES, WALL/HARDSCAPE LOCATIONS, ETC. COORDINATE WORK FOR THE INSTALLATION OF IRRIGATION PIPE SLEEVES THROUGH WALLS, UNDER PAVEMENT AND STRUCTURES ETC.
- 7. CONTRACTOR IS RESPONSIBLE FOR THE INSTALLATION OF SUFFICIENTLY SIZED SLEEVES FOR CONTROL WIRES AND NON-PRESSURE LATERAL LINE PIPING UNDER PAVED AREAS, IN ADDITION TO CONTROL WIRES AND LATERAL LINE PIPING SLEEVES SHOWN ON THE DRAWINGS.
- 8. TEST ALL PRESSURE MAIN LINES UNDER HYDROSTATIC PRESSURE OF 150 PSI FOR PERIOD OF 3 HOURS. TESTING OF PRESSURE MAIN LINE PIPING SHALL OCCUR PRIOR TO THE INSTALLATION OF ANY ELECTRONIC CONTROL VALVE, BASKET STRAINERS, QUICK COUPLING VALVES AND OTHER PRESSURE-SIDE IRRIGATION FACILITIES. PRESSURE TESTING RESULTS SHALL BE SUBMITTED TO LANDSCAPE ARCHITECT
- 9. REFER TO PLANTING LEGEND FOR PLANT MATERIAL NAMES, ABBREVIATIONS, SPECIFIC SIZES, ON-CENTRE SPACING, AND ADDITIONAL INFORMATION.
- 10. DO NOT INSTALL DRIPLINE TUBING UNDER PAVED SURFACES. CONNECT DRIPLINE TUBING TO SCHEDULE 40 PVC LATERAL LINE PIPING FOR ROUTING UNDER PAVED SURFACES AND SCHEDULE 80 PVC PIPING ROUTING THROUGH PLANTER WALLS. ADAPT DRIPLINE TUBING TO PVC PIPING AS REQUIRED WITH COMPRESSION ADAPTER FITTINGS
- 11. CONNECT DRIPLINE PIPING TO PRESSURE REGULATOR UNITS WITH SCHEDULE 40 PVC MALE ADAPTER FITTINGS AND COMPRESSION ADAPTER FITTINGS
- 12. PROVIDE COMPRESSION SERIES FITTINGS FOR TUBING CONNECTIONS AND CONNECTIONS TO PVC PIPING AS INDICATED IN THE EQUIPMENT LEGEND IN THIS SHEET.
- 13. SYSTEM TO BE DESIGN BUILD. CONTRACTOR SHALL REFER TO SPECIFICATIONS FOR ALL WORK.
- 14. CONTRACTOR SHALL BE RESPONSIBLE FOR PROVIDING AS-BUILT DRAWINGS FOR ALL COMPLETED WORK ONCE APPROVED BY LANDSCAPE ARCHITECT.
- 15. IRRIGATION COMMAND CONTROLLER WITH RAIN SENSOR SYSTEM TO BE MOUNTED IN MECHANICAL ROOM.

OPERATOR THAT SUPPLIES WATER TO THE SITE.

EXTENT POSSIBLE.

9. THE IMPLEMENTATION OF WATER CONSERVATION BEST MANAGEMENT PRACTICIES

SHALL BE INTEGRATED INTO CONSTRUCTION AND OPERATION OF THE PROJECT TO THE

- 16. ALL PIPE TO BE SCHEDULE 40.
- 17. IRRIGATION CONTROLLER TO BE INSTALLED IN VANDAL RESISTANT METAL LOCK BOX.
- 18. INSTALL PRECISION SOIL SENSOR ON SYSTEM
- 19. ALL PIPING RUNS ARE DIAGRAMMATIC, AVOID TRENCHING NEAR EXISTING TREE DRIP LINE.



IBI

21-12-23

22-02-03

Checked By

PH 2 - HYDROZONE PLAN

EAST





1738 KINGSWAY, VANCOUVER, BC V5N 2S3 www.locidesign.ca // 604.694.0053

ALL RIGHTS RESERVED.

AND URBAN DESIGN. USE OR REPRODUCTION



Peterson



F Issued for Development Permit G Re-Issued for Development 21-12-23

22-02-03

H Issued for TRS Response

Dilworth Center


Project Team

LOCI Landscape Architecture + Urban Design


Checked By

PH 2 - FENCE + GATE LOCATION PLAN - WEST

FENCE + GATE PLAN WEST **1** Scale: 1/16" = 1'-0"

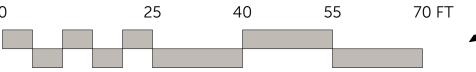




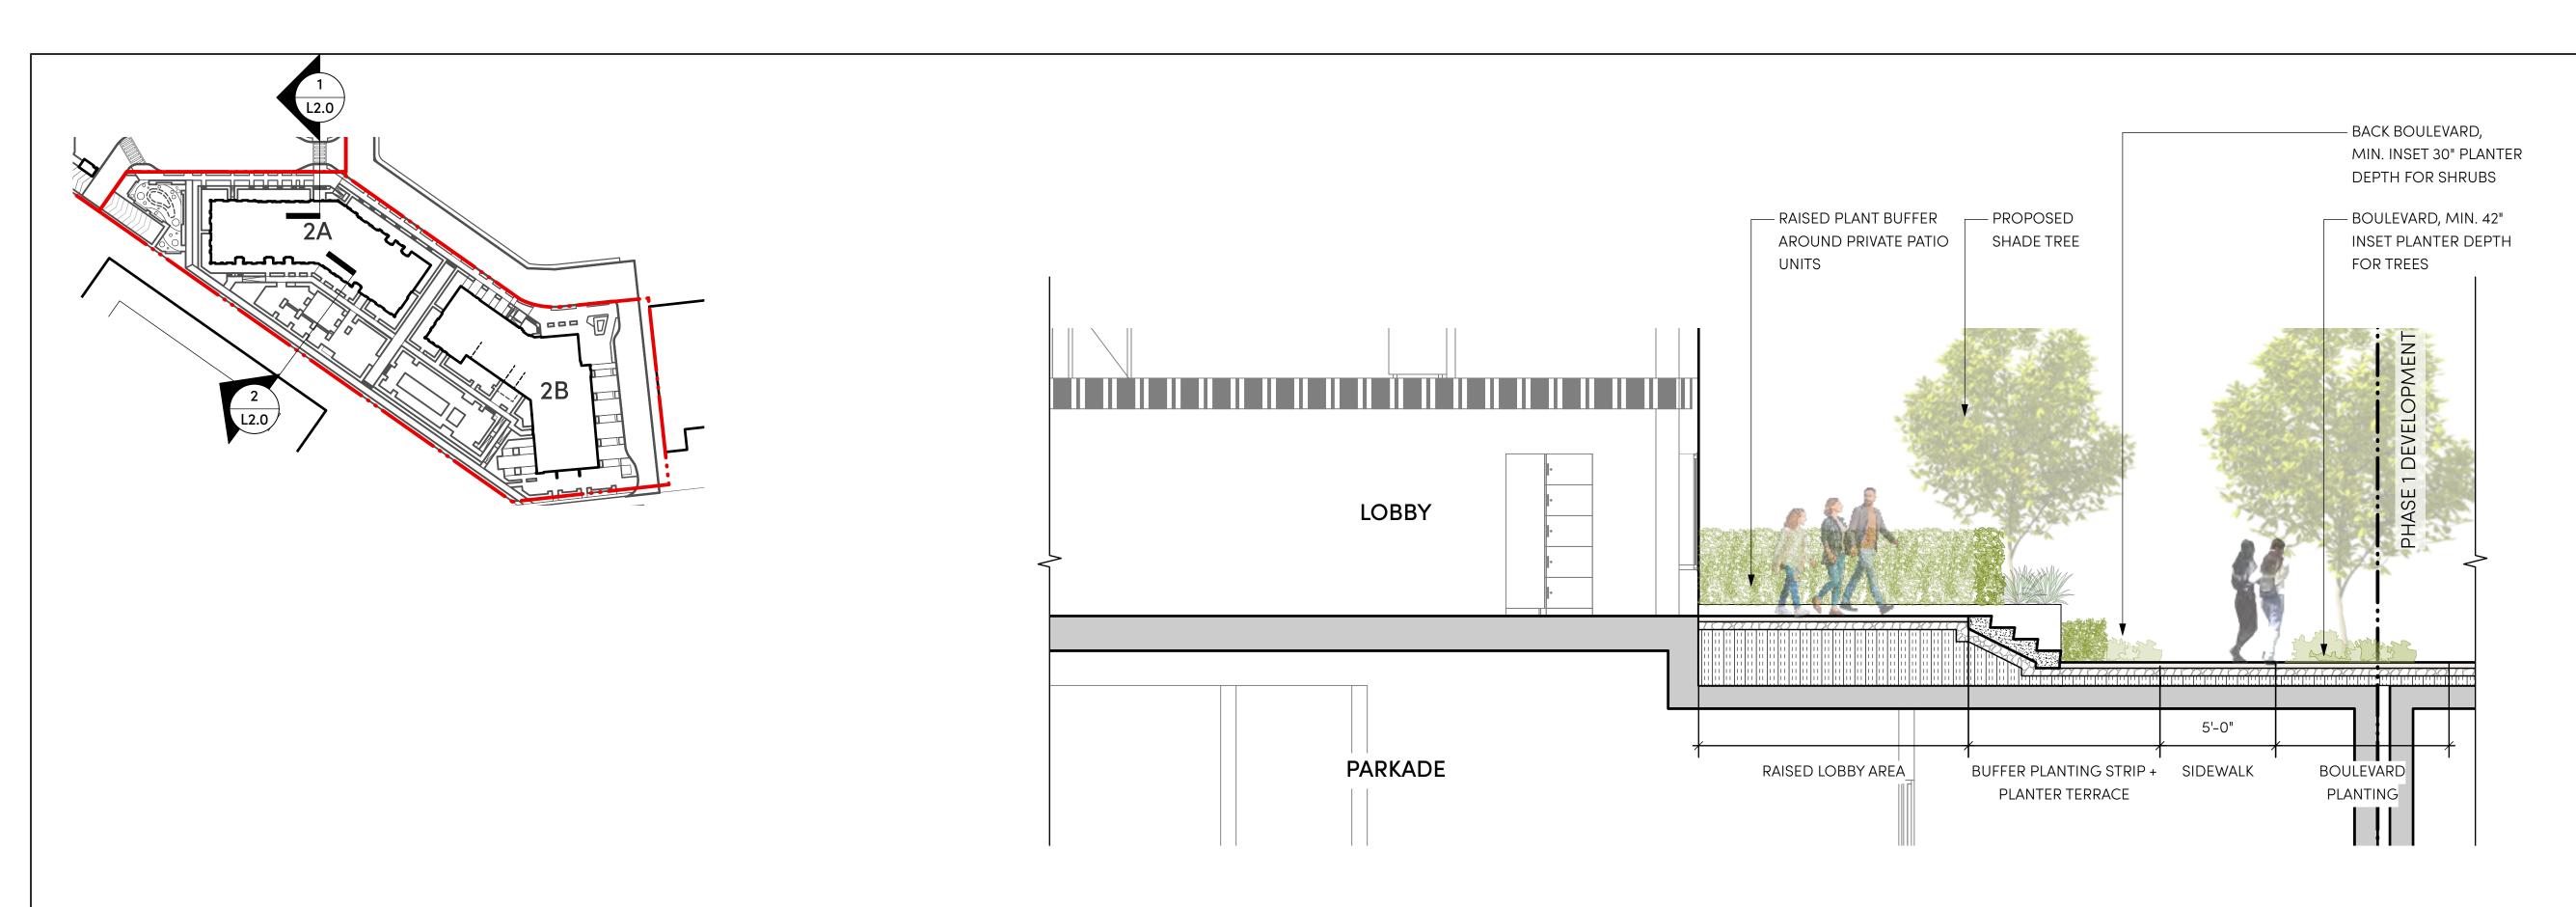

BUILDING 2A - BUILDING ENTRY LOOKING WEST

Scale: 1/4" = 1'-0"

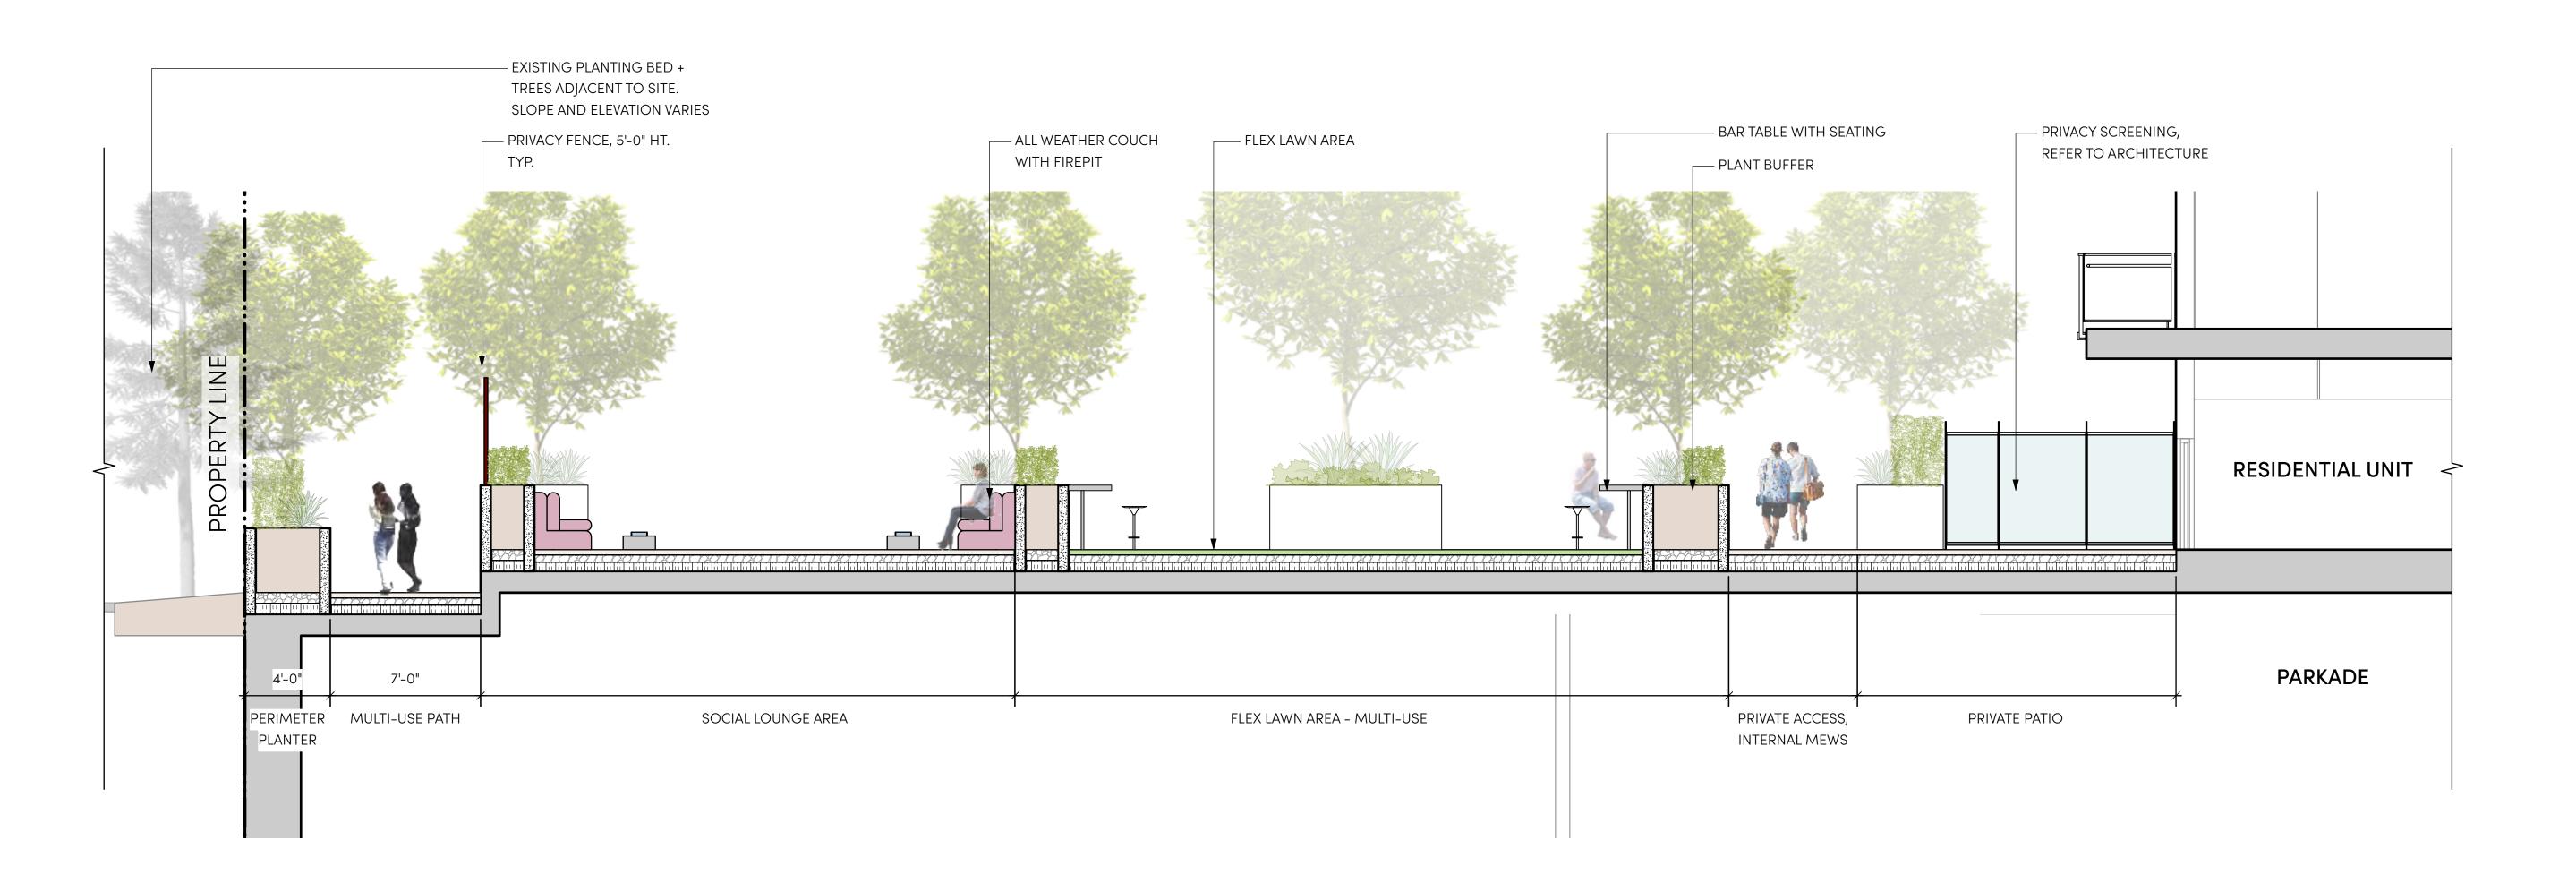

BUILDING 2A - AMENITY SECTION LOOKING WEST

Scale: 1/4" = 1'-0"



1738 KINGSWAY, VANCOUVER, BC V5N 2S3 www.locidesign.ca // 604.694.0053

ALL RIGHTS RESERVED.

PROPERTY OF LOCI LANDSCAPE ARCHITECTURE AND URBAN DESIGN. USE OR REPRODUCTION PROHIBITED WITH PRIOR WRITTEN CONSENT.



Peterson

Project Stamp



No. Description F Issued for Development Permit G Re-Issued for Development 21-12-23

22-02-03

Project Info

H Issued for TRS Response

20168

Dilworth Center Mixed Use

2339 Highway 97N Kelowna, BC

Project Team Client

Peterson


Architect IBI Group

Landscape Architect

LOCI Landscape Architecture + Urban Design

Checked By

PH 2 - SECTIONS

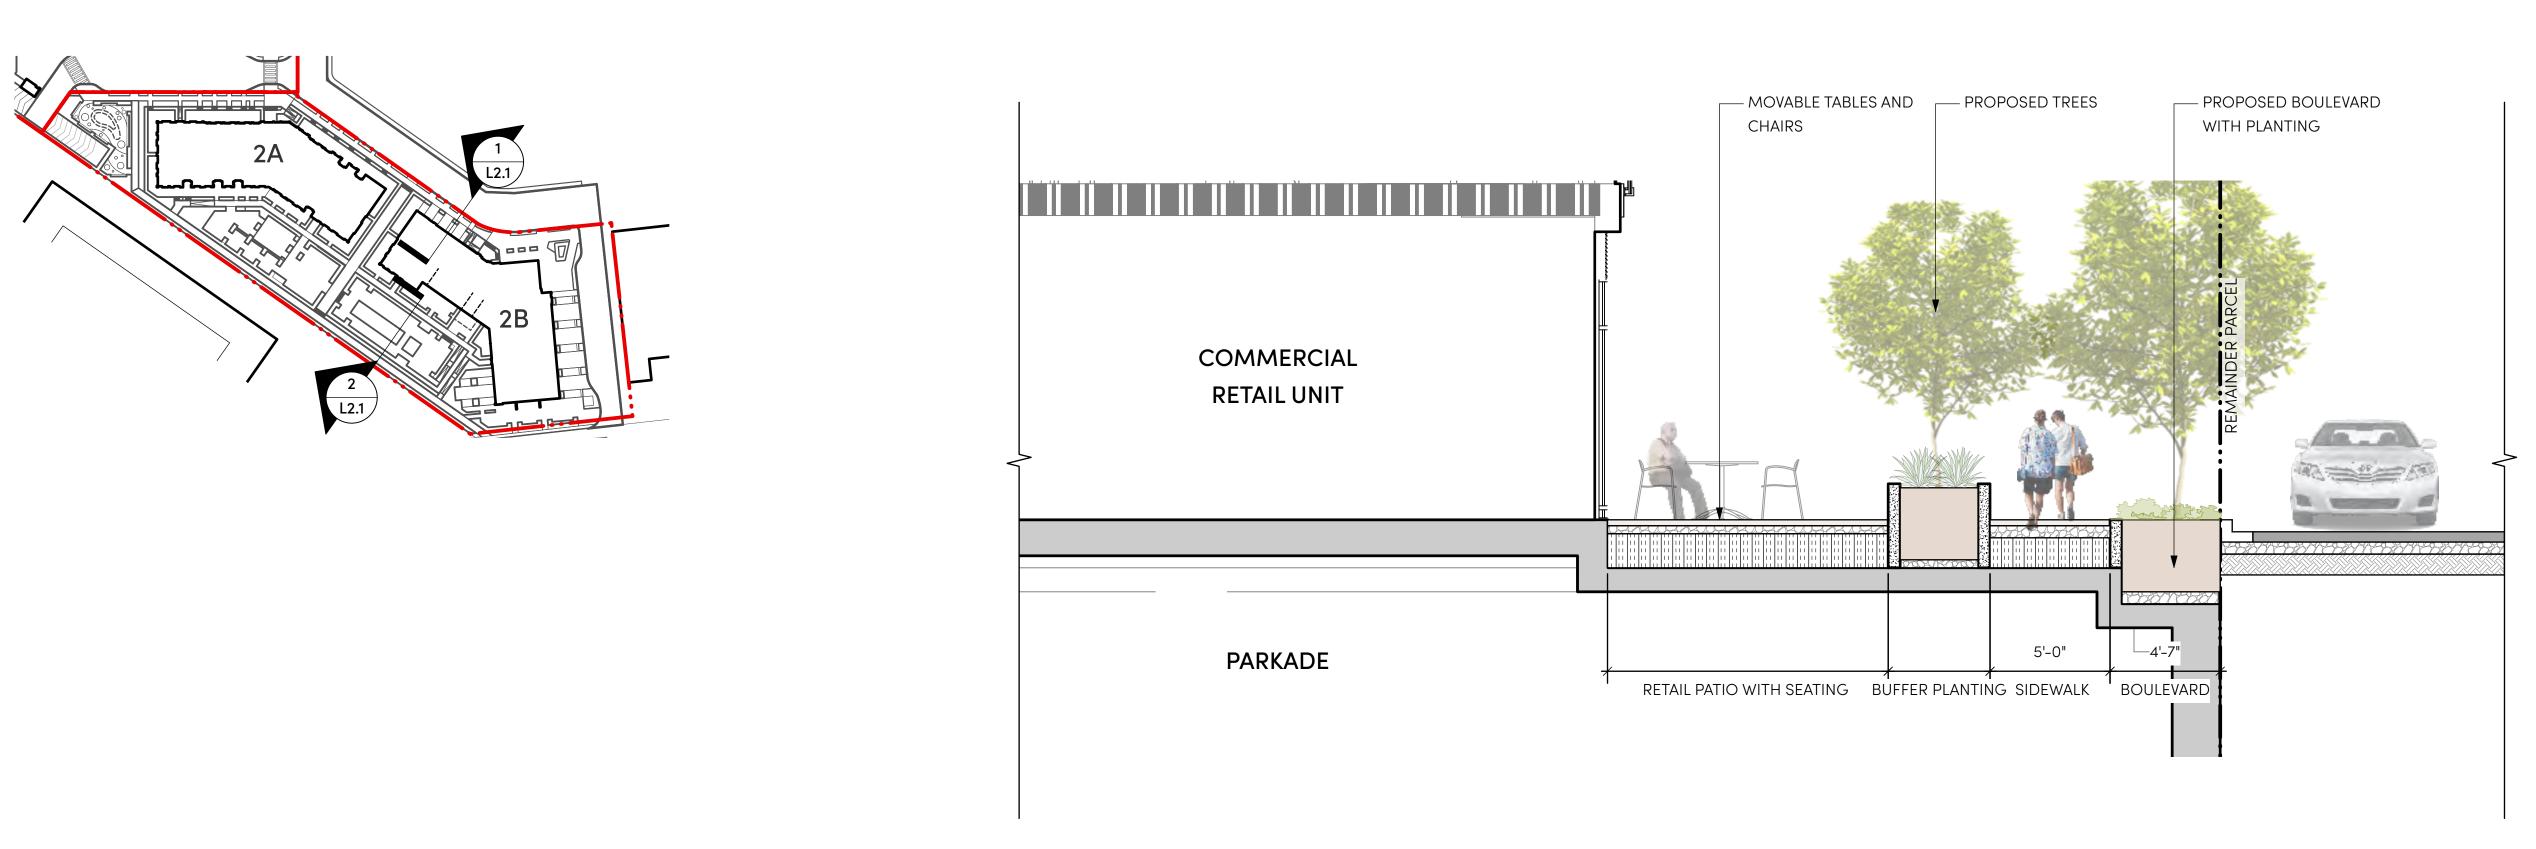


BUILDING 2B - COMMERCIAL RETAIL FRONTAGE LOOKING WEST

Scale: 1/4" = 1'-0"

BUILDING 2B - AMENITY POOL SECTION LOOKING WEST

Scale: 1/4" = 1'-0"

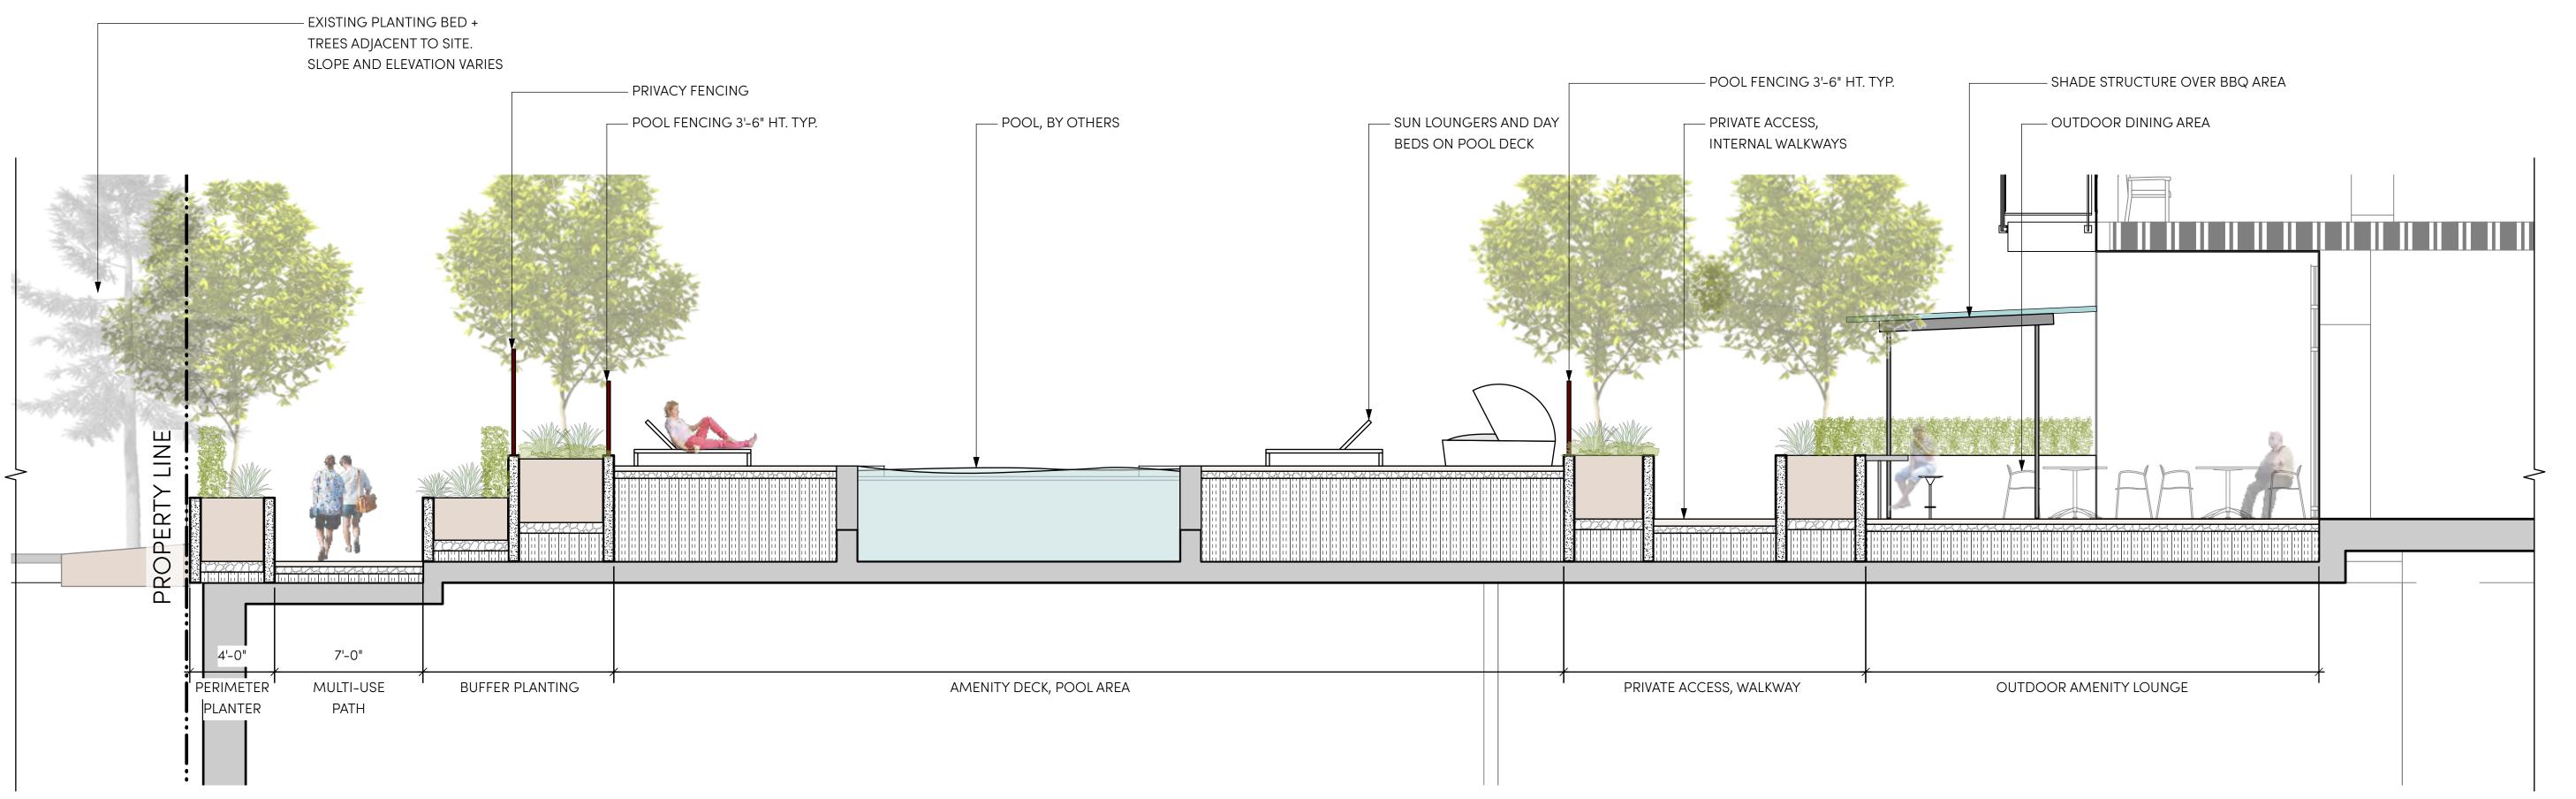

LANDSCAPE ARCHITECTURE + URBAN DESIGN

1738 KINGSWAY, VANCOUVER, BC V5N 2S3 www.locidesign.ca // 604.694.0053

ALL RIGHTS RESERVED.

PROPERTY OF LOCI LANDSCAPE ARCHITECTURE
AND URBAN DESIGN. USE OR REPRODUCTION

PROHIBITED WITH PRIOR WRITTEN CONSENT.



Peterson

Project Stamp



Issue

No.	Description	Date
F	Issued for Development Permit	21-05-30
G	Re-Issued for Development Permit	21-12-23
Н	Issued for TRS Response	22-02-03

Project Info

Dilworth Center

Mixed Use 2339 Highway 97N Kelowna, BC

Project Team

Client Peterson


Architect IBI Group


Landscape Architect
LOCI Landscape Architecture + Urban Design

Drawn By Checked By

PH 2 - SECTIONS

L2.

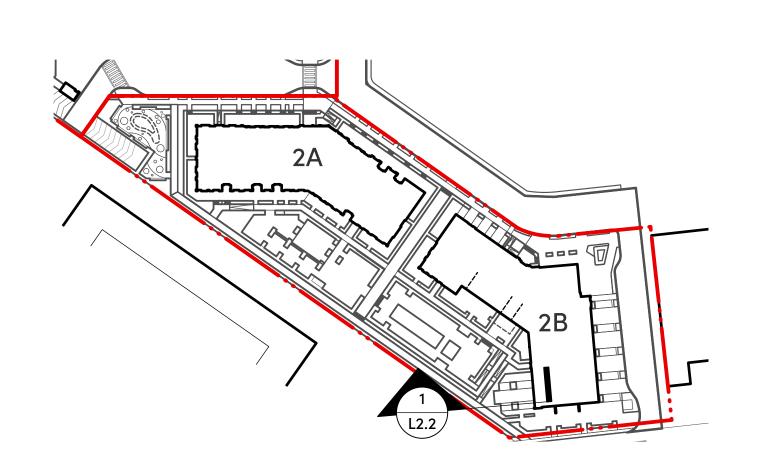

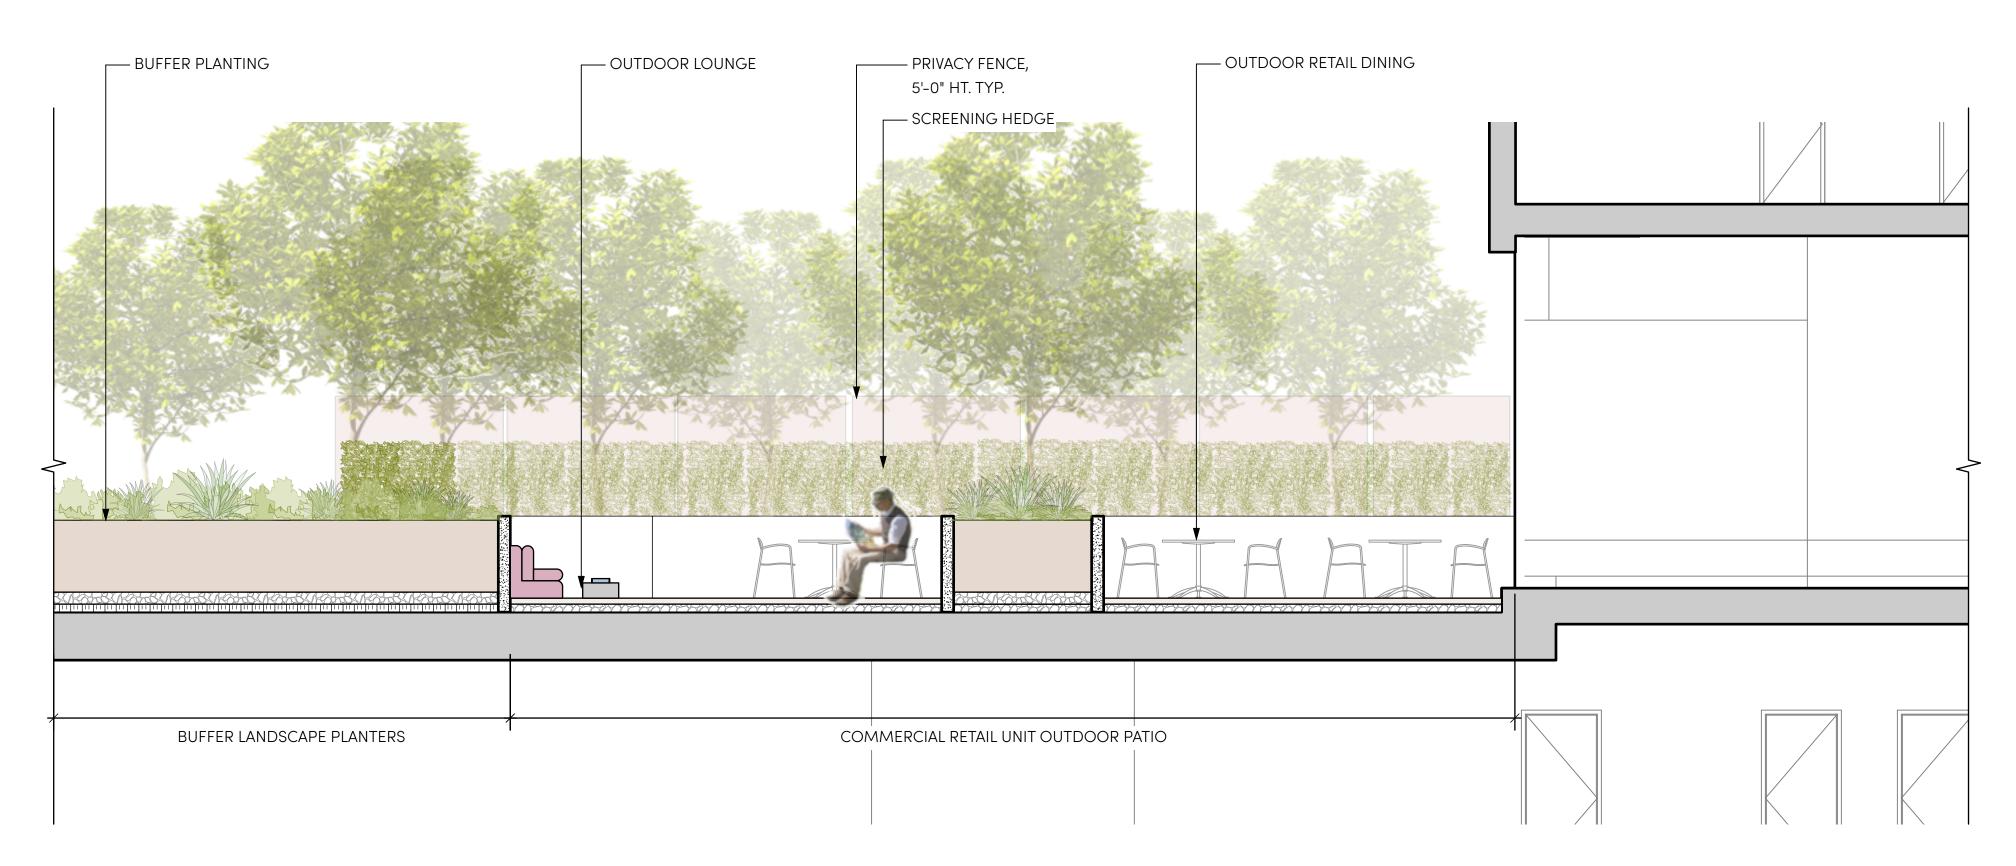

BUILDING 2B - COMMERCIAL PATIO LOOKING NORTH

Scale: 1/4" = 1'-0"



1738 KINGSWAY, VANCOUVER, BC V5N 2S3 www.locidesign.ca // 604.694.0053

ALL RIGHTS RESERVED.

PROPERTY OF LOCI LANDSCAPE ARCHITECTURE AND URBAN DESIGN. USE OR REPRODUCTION PROHIBITED WITH PRIOR WRITTEN CONSENT.



Peterson



No.	Description	Dat
F	Issued for Development Permit	21-05-3
G	Re-Issued for Development Permit	21-12-2

22-02-03

Checked By

H Issued for TRS Response

Project Info

20168

Dilworth Center Mixed Use

2339 Highway 97N Kelowna, BC

Project Team

Peterson Architect

IBI Group

Landscape Architect

LOCI Landscape Architecture + Urban Design

PH 2 - SECTIONS

OVERALL PLANT LIST

18	Symbol DECIDUOUS T	_	Latin Name	Common Name	Scheduled Size	Spacing	Notes
1 Colobo speciale Northern Catalign 10th cal As Shown 86B Specimen 14 Cercidiphyllum japonicum Katsura Tree Arm cal As Shown 86B Seb Praxinus Autumn Applause* White Ash 7cm cal As Shown 86B Seb Praxinus Autumn Applause* White Ash 7cm cal As Shown 86B Seb Praxinus Autumn Applause* White Ash 7cm cal As Shown 86B Seb Praxinus Autumn Applause* Kabus Magkinelia 7cm cal As Shown 86B Seb		18	Acer griseum	Paperbark Maple	6cm cal.	As Shown	B&B
14 Cercidicity um_japonicum		15	Acer rubrum 'Morgan'	Morgan Red Maple	7cm cal.	As Shown	B&B
29		1	Catalpa speciosa	Northern Catalpa	10cm cal.	As Shown	B&B Specimen
21 Magnalia kabus Kabus Magknalia 7cm, cal. As Shown BBB 5 Nyssa sylvatica Black Tupello 7cm, cal. As Shown BBB 6 9 Prunus xyedoensis Yoshino Cherry 6cm, cal. As Shown BBB 11 Pyrus calleryana Chanticleer! Callery Pear 6cm, cal. As Shown BBB 17 Zelkava serrata "Musashina" Columnar Sawleaf Zelkava 6cm, cal. As Shown Columnar/upright 17 Zelkava serrata "Musashina" Columnar Sawleaf Zelkava 6cm, cal. As Shown Columnar/upright 18 Arternesia tridentata Big Sagebrush #3 Pol 26° a.c. 19 Arbutus unedo "Compacta" Compact Strawbarry Bush #3 Pol 3°0° a.c. 10 Arternesia tridentata Big Sagebrush #3 Pol 3°0° a.c. 10 Arternesia tridentata Box-leaf Haneysuckle #3 Pol 2°0° a.c. 10 Arternesia tridentata Box-leaf Haneysuckle #3 Pol 2°0° a.c. 10 Arternesia tridentata Box-leaf Haneysuckle #3 Pol 2°0° a.c. 10 Arternesia tridentata Box-leaf Haneysuckle #3 Pol 2°0° a.c. 10 Arternesia tridentata Box-leaf Haneysuckle #3 Pol 2°0° a.c. 10 Arternesia tridentata Box-leaf Haneysuckle #3 Pol 2°0° a.c. 10 Arternesia tridentata Box-leaf Haneysuckle #3 Pol 2°0° a.c. 11 Arternesia tridentata Box-leaf Haneysuckle #3 Pol 2°0° a.c. 12 Arternesia tridentata Box-leaf Haneysuckle #3 Pol 2°0° a.c. 13 Arternesia tridentata Box-leaf Haneysuckle #3 Pol 3°0° a.c. 14 Carex elata Aurea Box-leaf Galden Sedge #1 por 1°0° a.c. 15 Arternesia tridentata Box-leaf Galden Sedge #1 por 1°0° a.c. 15 Arternesia tridentata Box-leaf Galden Sedge #1 por 1°0° a.c. 16 Arternesia tridentata Box-leaf Galden Sedge #1 por 1°0° a.c. 17 Arternesia tridentata Box-leaf Galden Sedge #1 por 1°0° a.c. 18 Carex elata Aurea Box-leaf Galden Sedge #1 por 1°0° a.c. 19 Arternesia tridentata Box-leaf Galden Sedge #1 por 1°0° a.c. 19 Arternesia tridentata Box-leaf Haney		14	Cercidiphyllum japonicum	Katsura Tree	7cm cal.	As Shown	B&B
5 Nyssa sylvatica Black Tupelo 7cm cat. As Shown B&B 9 Prunus x yedioensis Yashino Cherry 6cm cat. As Shown B&B 41 Pyrus calleryano 'Chorticleer' Callery Pear Gcm cat. As Shown B&B 17 Zelkova serrata 'Musashino' Calumnar Sowleaf Zelkova 6cm cat. As Shown Calumnar/upright f CONIFERS: SHRUBS: 29 Arbutus unedo 'Compacto' Campact Strawberry Bush 4/3 Pat 2/6" o.c. 116 Artemesia tridentata Big Sagebrush 4/3 Pat 2/6" o.c. 117 Artemesia tridentata Box-leaf Haneysuckle 4/3 Pat 2/6" o.c. 118 Artemesia tridentata Box-leaf Haneysuckle 4/3 Pat 2/6" o.c. 119 Artemesia tridentata Box-leaf Haneysuckle 4/3 Pat 2/6" o.c. 120 Prunus lauraceraus 'Otto Luyken' Cherry Laurel 4/3 Pat 2/6" o.c. 120 Prunus fauraceraus 'Otto Luyken' Cherry Laurel 4/3 Pat 2/6" o.c. 121 Rosa nutkana Noolka Rose 4/2 Pat 2/6" o.c. 122 Rhadodendron x 'Ramapo' Ramapo Rhadodendron 4/3 Pat 2/6" o.c. 123 Saix purpurea 'Nana' Dworf Arctic Willow 4/3 Pat 2/6" o.c. 124 Spiraeo japonica 'Goldfarno' Japonese Spiraa 4/2 Pat 2/6" o.c. 125 Spiraeo japonica 'Goldfarno' Japonese Spiraa 4/2 Pat 2/6" o.c. 126 Carse elata 'Murea' Bowles Golden Sedge 4/1 pat 1/6" o.c. PERENNIALS, GRASSES, GROUNDCOVER: 48 Carse elata 'Murea' Bowles Golden Sedge 4/1 pat 1/6" o.c. PERENNIALS, GRASSES, GROUNDCOVER:		29	Fraxinus 'Autumn Applause'	White Ash	7cm cal.	As Shown	B&B
9 Prunus x yedoonele Yoshino Chorry 6cm cal. As Shown BBB 41 Pyrus calleryana 'Chanticleer' Callery Pear 6cm cal. As Shown BBB 17 Zelkova serrota 'Musashino' Columnar Sawleaf Zelkova 6cm cal. As Shown Calumnar/upright f CONIFERS: SHRUBS: 29 Arbutus unado 'Compacta' Compact Strawbarry Bush #3 Pat 2'6' o.c. 116 Artemesia tridentata Hig Sagebrush #3 Pat 2'6' o.c. 85 Lonicara pileata Box-leaf Haneysuckle #3 Pat 2'6' o.c. 760 Pinus mugo Mugo Pine #3 Pat 2'6' o.c. 760 Pinus mugo Mugo Pine #2 Pat 2'6' o.c. 202 Prunus lauracerasus 'Cho Luyken' Cherry Laurel #3 Pat 2'6' o.c. 215 Roso nutlkana Nootka Rose #2 Pat 2'6' o.c. 216 Spiraeo japanica 'Ramapo' Ramapo Rhadadendron #3 Pat 2'6' o.c. 217 Solix purpurea Nana Nootka Rose #2 Pat 2'6' o.c. 218 Spiraeo japanica 'Galaffame' Japanese Spirea #2 Pat 2'6' o.c. PERENNIALS, GRASSES, GROUNDCOVER: 48 Carex elan 'Aureo' Bowles Galden Sedge #1 pat 16' o.c. PERENNIALS, GRASSES, GROUNDCOVER: 48 Carex elan 'Aureo' Bowles Galden Sedge #1 pat 16' o.c. PERENNIALS, GRASSES, GROUNDCOVER: 48 Carex elan 'Aureo' Bowles Galden Sedge #1 pat 16' o.c. PERENNIALS, GRASSES, GROUNDCOVER: 48 Carex elan 'Aureo' Bowles Galden Sedge #1 pat 16' o.c. PERENNIALS, GRASSES, GROUNDCOVER: 48 Carex elan 'Aureo' Bowles Galden Sedge #1 pat 16' o.c. PERENNIALS, GRASSES, GROUNDCOVER: 48 Carex elan 'Aureo' Bowles Galden Sedge #1 pat 16' o.c. PERENNIALS, GRASSES, GROUNDCOVER: 48 Carex elan 'Aureo' Bowles Galden Sedge #1 pat 16' o.c. PERENNIALS, GRASSES, GROUNDCOVER: 48 Carex elan 'Aureo' Bowles Galden Sedge #1 pat 16' o.c. PERENNIALS, GRASSES, GROUNDCOVER: 48 Carex elan 'Aureo' Bowles Galden Sedge #1 pat 16' o.c. PERENNIALS, GRASSES, GROUNDCOVER: 49 Carex elan 'Aureo' Bowles Galden Grass #2 Pat 2'8' o.c.		21	Magnolia kobus	Kobus Magknolia	7cm. cal.	As Shown	B&B
41 Pyrus colleryana 'Chanticleer' Collery Pear 6cm col. As Shown B&B 17 Zelkova serrota 'Musashino' Columnar Sawleaf Zelkova 6cm col. As Shown Columnar/Upright f CONFERS: SHRUBS: 28 Arbutus unedo 'Compacta' Compact Strawberry Bush #3 Pot 2'6' o.c. 116 Artemesia tridentata Big Sagebrush #3 Pot 30' o.c. 85 Lonicera pileata Box-leaf Haneysuckle #3 Pot 2'6' o.c. 273 Osmanthus delavayi Sweet Olive #3 Pot 2'6' o.c. 760 Pirus muga Muga Pine #2 Pot 2'9' o.c. 202 Prunus laurocerasus 'Otto Luyken' Cherry Laurel #3 Pot 2'6' o.c. 216 Resa nutkana Noatka Rase #2 Pot 2'6' o.c. 217 Rododendron x Ramapo' Ramapo Rhadodendron #3 Pot 2'6' o.c. 218 Spiraea japonica 'Galdiflame' Dwarf Arctic Willow #3 Pot 2'0' o.c. 219 Spiraea japonica 'Galdiflame' Japanese Spirea #2 Pot 2'0' o.c. 41 Taxus x media 'Hicksii' Hick's Yew 1.25m. htt. 1'6' o.c. PERENNIALS, GRASSES, GROUNDCOYER: 42 Carex elata 'Aurea' Bowles Galden Sedge #1 pot 1'6' o.c. 43 Elymus magellanicus Biue Wheat Grass #2 Pot 2'6' o.c.		5	Nyssa sylvatica	Black Tupelo	7cm cal.	As Shown	B&B
CONIFERS: SHRUBS: 29 Arbutus unedo 'Compacta' Compact Strawberry Bush #3 Pot 26' o.c. 116 Artemesia tridentata Big Sagebrush #3 Pot 26' o.c. 85 Lonicera pileata Box-leaf Honeysuckle #3 Pot 26' o.c. 273 Ozmanthus delavayi Sweet Olive #3 Pot 26' o.c. 760 Pinus mugo Mugo Pine #2 Pot 20' o.c. 202 Prunus laurocerasus 'Otto Luyken' Cherry Lourel #3 Pot 26' o.c. 203 Rhododendron x 'Ramapo' Ramapo Rhododendron #3 Pot 26' o.c. 204 Pot 205 o.c. 205 Salix purpurea 'Nana' Dwarf Arctic Willow #3 Pot 30' o.c. 215 Rosa nutkana Naotka Rose #2 Pot 26' o.c. 216 Spiraea japonica 'Goldflame' Japonese Spirea #2 Pot 20' o.c. 217 Taxus x media 'Hicksi' Hicksi' Hick's Yew 1.25m. ht. 16' o.c. PERENNIALS, GRASSES, GROUNDCOVER: 48 Carex elata 'Aurea' Bowles Golden Sedge #1 pot 16' o.c. 174 Miscanthus sinensis 'Morning Light' Silver Grass #2 Pot 26' o.c. 310 Silver Grass #2 Pot 26' o.c.		9	Prunus x yedoensis	Yoshino Cherry	6cm cal.	As Shown	B&B
CONIFERS: SHRUBS: 29 Arbutus unedo 'Compacta' Compact Strawberry Bush #3 Pot 2'6' o.c. 116 Artemesia tridentata Big Sagebrush #3 Pot 2'6' o.c. 85 Lonicera pileata Box-leaf Honeysuckle #3 Pot 2'6' o.c. 273 Osmanthus delavayi Sweet Olive #3 Pot 2'6' o.c. 760 Pinus mugo Mugo Pine #2 Pot 2'0' o.c. 202 Prunus laurocerasus 'O'lto Luyken' Cherry Laurel #3 Pot 2'6' o.c. 220 Rhododendron x 'Ramapo' Ramapo Rhododendron #3 Pot 2'6' o.c. 215 Rosa nutkana Nootka Rose #2 Pot 2'6' o.c. 59 Salix purpurea 'Nana' Dwarf Arctic Willow #3 Pot 3'0' o.c. 218 Spiraea japonica 'Goldflame' Japanese Spirae #2 Pot 2'0' o.c. 430 Taxus x media 'Hicksii' Hick's Yew 1.25m. ht. 16' o.c. PERENNIALS, GRASSES, GROUNDCOVER: 48 Carex elata 'Aure		41	Pyrus calleryana 'Chanticleer'	Callery Pear	6cm cal.	As Shown	B&B
SHRUBS: 29 Arbutus unedo 'Compacta' Compact Strawberry Bush #3 Pot 26" o.c. 116 Arternesia tridentata Big Sagebrush #3 Pot 30" o.c. 85 Lonicera pileata Box-leaf Honeysuckle #3 Pot 26" o.c. 273 Osmanthus delavayi Sweet Olive #3 Pot 26" o.c. 760 Pinus mugo Mugo Pine #2 Pot 2"0" o.c. 202 Prunus laurocerasus 'Otto Luyken' Cherry Laurel #3 Pot 2"6" o.c. 220 Rhododendron x 'Ramapo' Ramapa Rhododendron #3 Pot 2"6" o.c. 215 Rosa nutkana Nootka Rose #2 Pot 2"6" o.c. 59 Salix purpurea 'Nana' Dwarf Arctic Willow #3 Pot 2"6" o.c. 218 Spiraea japonica 'Goldflame' Japanese Spirea #2 Pot 2"0" o.c. 430 Taxus x medla 'Hicksli' Hick's Yew 1.25m, ht, 16" o.c. PERENNIALS, GRASSES, GROUNDCOVER: 48 Carex elata 'Aurea' Bowles Golden Sedge #1 pot		17	Zelkova serrata 'Musashino'	Columnar Sawleaf Zelkova	6cm cal.	As Shown	Columnar/upright form.
SHRUBS: 29 Arbutus unedo 'Compacta' Compact Strowberry Bush #3 Pot 2'6" o.c. 116 Artemesia tridentata Big Sagebrush #3 Pot 3'0" o.c. 85 Lonicera pileata Box-leaf Honeysuckle #3 Pot 2'6" o.c. 273 Osmanthus delavayi Sweet Olive #3 Pot 2'6" o.c. 760 Pinus mugo Mugo Pine #2 Pot 2'0" o.c. 202 Prunus laurocerasus 'Otto Luyken' Cherry Laurel #3 Pot 2'6" o.c. 220 Rhododendron x 'Ramapo' Ramapo Rhododendron #3 Pot 2'6" o.c. 215 Rosa nutkana Naotka Rose #2 Pot 2'6" o.c. 59 Salix purpurea 'Nana' Dwarf Arctic Willow #3 Pot 3'0" o.c. 218 Spiraea japonica 'Goldflame' Japanese Spirea #2 Pot 2'0" o.c. 430 Taxus x media 'Hicksii' Hick's Yew 1.25m. hl. 16" o.c. PERENNIALS, GRASSES, GROUNDCOVER: 48 Carex elata 'Aurea' Bowles Golden Sedge #1	CONIFERS:						
29 Arbutus unedo 'Compacta' Compact Strawberry Bush #3 Pot 2:6' o.c. 116 Artemesia tridentata Big Sagebrush #3 Pot 3:0" o.c. 85 Lonicera pileata Box-leaf Honeysuckle #3 Pot 2:6' o.c. 273 Osmanthus delavayi Sweet Olive #3 Pot 2:6' o.c. 760 Pinus mugo Mugo Pine #2 Pot 2:0" o.c. 202 Prunus laurocerasus 'Otto Luyken' Cherry Laurel #3 Pot 2:6' o.c. 215 Rosa nutkana Nootka Rose #2 Pot 2:6' o.c. 59 Sollx purpurea 'Nana' Dwarf Arctic Willow #3 Pot 3:0" o.c. 218 Spiraea japonica 'Goldflame' Japanese Spirea #2 Pot 2:0" o.c. PERENNIALS, GRASSES, GRUNDCOVER: 48 Carex elata 'Aurea' Bowles Golden Sedge #1 pot 1'6' o.c. 153 Elymus magellanicus Blue Wheat Grass #2 Pot 2:6' o.c.							
85 Lonicera pileata Box-leaf Honeysuckle #3 Pot 2'6" o.c. 273 Osmanthus delavayi Sweet Olive #3 Pot 2'6" o.c. 760 Pinus mugo Mugo Pine #2 Pot 2'0" o.c. 202 Prunus laurocerasus 'Otto Luyken' Cherry Laurel #3 Pot 2'6" o.c. 215 Rosa nutkana Nootka Rose #2 Pot 2'6" o.c. 215 Rosa nutkana Nootka Rose #2 Pot 2'6" o.c. 216 Spiraea japonica 'Goldflame' Japanese Spirea #2 Pot 2'0" o.c. 218 Spiraea japonica 'Goldflame' Hick's Yew 1.25m. ht. 1'6" o.c. PERENNIALS, GRASSES, GROUNDCOVER: 48 Carex elata 'Aurea' Bowles Golden Sedge #1 pot 1'6" o.c. 153 Elymus magellanicus Blue Wheat Grass #2 Pot 2'6" o.c. 174 Miscanthus sinensis 'Morning Light' Silver Grass #2 Pot 2'6" o.c.		29	Arbutus unedo 'Compacta'	Compact Strawberry Bush	#3 Pot	2'6" o.c.	
273 Osmanthus delavayi Sweet Olive #3 Pot 2'6" o.c. 760 Pinus mugo Mugo Pine #2 Pot 2'0" o.c. 202 Prunus laurocerasus 'Otto Luyken' Cherry Laurel #3 Pot 2'6" o.c. 220 Rhododendron x 'Ramapo' Ramapo Rhododendron #3 Pot 2'6" o.c. 215 Rosa nutkana Nootka Rose #2 Pot 2'6" o.c. 59 Salix purpurea 'Nana' Dwarf Arctic Willow #3 Pot 3'0" o.c. 218 Spiraea japonica 'Goldflame' Japanese Spirea #2 Pot 2'0" o.c. 430 Taxus x media 'Hicksii' Hick's Yew 1.25m. ht. 1'6" o.c. PERENNIALS, GRASSES, GROUNDCOVER: 48 Carex elata 'Aurea' Bowles Golden Sedge #1 pot 1'6" o.c. 153 Elymus magellanicus Blue Wheat Grass #2 Pot 2'6" o.c.		116	Artemesia tridentata	Big Sagebrush	#3 Pot	3'0" o.c.	
760 Pinus mugo Mugo Pine #2 Pot 2'0" o.c. 202 Prunus laurocerasus 'Otto Luyken' Cherry Laurel #3 Pot 2'6" o.c. 220 Rhododendron x 'Ramapo' Ramapo Rhododendron #3 Pot 2'6" o.c. 215 Rosa nutkana Nootka Rose #2 Pot 2'6" o.c. 59 Salix purpurea 'Nana' Dwarf Arctic Willow #3 Pot 3'0" o.c. 218 Spiraea japonica 'Goldflame' Japanese Spirea #2 Pot 2'0" o.c. 430 Taxus x media 'Hicksii' Hick's Yew 1.25m. ht. 1'6" o.c. PERENNIALS, GRASSES, GROUNDCOVER: 48 Carex elata 'Aurea' Bowles Golden Sedge #1 pot 1'6" o.c. 153 Elymus magellanicus Blue Wheat Grass #2 Pot 2'6" o.c. 174 Miscanthus sinensis 'Morning Light' Silver Grass #2 Pot 2'6" o.c.		85	Lonicera pileata	Box-leaf Honeysuckle	#3 Pot	2'6" o.c.	
Prunus laurocerasus 'Otto Luyken' Cherry Laurel #3 Pot 2'6" o.c. 220 Rhododendron x 'Ramapo' Ramapo Rhododendron #3 Pot 2'6" o.c. 215 Rosa nutkana Nootka Rose #2 Pot 2'6" o.c. 59 Salix purpurea 'Nana' Dwarf Arctic Willow #3 Pot 3'0" o.c. 218 Spiraea japonica 'Goldflame' Japanese Spirea #2 Pot 2'0" o.c. 430 Taxus x media 'Hicksii' Hick's Yew 1.25m. ht. 1'6" o.c. PERENNIALS, GRASSES, GROUNDCOVER: 48 Carex elata 'Aurea' Bowles Golden Sedge #1 pot 1'6" o.c. 153 Elymus magellanicus Blue Wheat Grass #2 Pot 2'6" o.c. 174 Miscanthus sinensis 'Morning Light' Silver Grass #2 Pot 2'6" o.c.		273	Osmanthus delavayi	Sweet Olive	#3 Pot	2'6" o.c.	
220 Rhododendron x 'Ramapo' Ramapo Rhododendron #3 Pot 2'6" o.c. 215 Rosa nutkana Nootka Rose #2 Pot 2'6" o.c. 59 Salix purpurea 'Nana' Dwarf Arctic Willow #3 Pot 3'0" o.c. 218 Spiraea japonica 'Goldflame' Japanese Spirea #2 Pot 2'0" o.c. 430 Taxus x media 'Hicksii' Hick's Yew 1.25m. ht. 1'6" o.c. PERENNIALS, GRASSES, GROUNDCOVER: 48 Carex elata 'Aurea' Bowles Golden Sedge #1 pot 1'6" o.c. 153 Elymus magellanicus Blue Wheat Grass #2 Pot 2'6" o.c. 174 Miscanthus sinensis 'Morning Light' Silver Grass #2 Pot 2'6" o.c.	Ŏ	760	Pinus mugo	Mugo Pine	#2 Pot	2'0" o.c.	
215 Rosa nutkana Nootka Rose #2 Pot 2'6" o.c. 59 Salix purpurea 'Nana' Dwarf Arctic Willow #3 Pot 3'0" o.c. 218 Spiraea japonica 'Goldflame' Japanese Spirea #2 Pot 2'0" o.c. 430 Taxus x media 'Hicksii' Hick's Yew 1.25m. ht. 1'6" o.c. PERENNIALS, GRASSES, GROUNDCOVER: 48 Carex elata 'Aurea' Bowles Golden Sedge #1 pot 1'6" o.c. 153 Elymus magellanicus Blue Wheat Grass #2 Pot 2'6" o.c. 174 Miscanthus sinensis 'Morning Light' Silver Grass #2 Pot 2'6" o.c.		202	Prunus laurocerasus 'Otto Luyken'	Cherry Laurel	#3 Pot	2'6" o.c.	
215 Rosa nutkana Nootka Rose #2 Pot 2'6" o.c. 59 Salix purpurea 'Nana' Dwarf Arctic Willow #3 Pot 3'0" o.c. 218 Spiraea japonica 'Goldflame' Japanese Spirea #2 Pot 2'0" o.c. 430 Taxus x media 'Hicksii' Hick's Yew 1.25m. ht. 1'6" o.c. PERENNIALS, GRASSES, GROUNDCOVER: 48 Carex elata 'Aurea' Bowles Golden Sedge #1 pot 1'6" o.c. 153 Elymus magellanicus Blue Wheat Grass #2 Pot 2'6" o.c. 174 Miscanthus sinensis 'Morning Light' Silver Grass #2 Pot 2'6" o.c.		220	Rhododendron x 'Ramapo'	Ramapo Rhododendron	#3 Pot	2'6" o.c.	
59 Salix purpurea 'Nana' Dwarf Arctic Willow #3 Pot 3'0" o.c. 218 Spiraea japonica 'Goldflame' Japanese Spirea #2 Pot 2'0" o.c. 430 Taxus x media 'Hicksii' Hick's Yew 1.25m. ht. 1'6" o.c. PERENNIALS, GRASSES, GROUNDCOVER: 48 Carex elata 'Aurea' Bowles Golden Sedge #1 pot 1'6" o.c. 153 Elymus magellanicus Blue Wheat Grass #2 Pot 2'6" o.c. 174 Miscanthus sinensis 'Morning Light' Silver Grass #2 Pot 2'6" o.c.		215	Rosa nutkana	Nootka Rose	#2 Pot	2'6" o.c.	
430 Taxus x media 'Hicksii' Hick's Yew 1.25m. ht. 1'6" o.c. PERENNIALS, GRASSES, GROUNDCOVER: 48 Carex elata 'Aurea' Bowles Golden Sedge #1 pot 1'6" o.c. 153 Elymus magellanicus Blue Wheat Grass #2 Pot 2'6" o.c. 174 Miscanthus sinensis 'Morning Light' Silver Grass #2 Pot 2'6" o.c.	Õ	59	Salix purpurea 'Nana'	Dwarf Arctic Willow	#3 Pot	3'0" o.c.	
PERENNIALS, GRASSES, GROUNDCOVER: 48 Carex elata 'Aurea' Bowles Golden Sedge #1 pot 1'6" o.c. 153 Elymus magellanicus Blue Wheat Grass #2 Pot 2'6" o.c. 174 Miscanthus sinensis 'Morning Light' Silver Grass #2 Pot 2'6" o.c.		218	Spiraea japonica 'Goldflame'	Japanese Spirea	#2 Pot	2'0" o.c.	
48 Carex elata 'Aurea' Bowles Golden Sedge #1 pot 1'6" o.c. 153 Elymus magellanicus Blue Wheat Grass #2 Pot 2'6" o.c. 174 Miscanthus sinensis 'Morning Light' Silver Grass #2 Pot 2'6" o.c.	Survey Survey	430	Taxus x media 'Hicksii'	Hick's Yew	1.25m. ht.	1'6" o.c.	
48 Carex elata 'Aurea' Bowles Golden Sedge #1 pot 1'6" o.c. 153 Elymus magellanicus Blue Wheat Grass #2 Pot 2'6" o.c. 174 Miscanthus sinensis 'Morning Light' Silver Grass #2 Pot 2'6" o.c.	PERENNIALS,	GRASSES, G	ROUNDCOVER:				
153 Elymus magellanicus Blue Wheat Grass #2 Pot 2'6" o.c. 174 Miscanthus sinensis 'Morning Light' Silver Grass #2 Pot 2'6" o.c.	***			Bowles Golden Sedge	#1 pot	1'6" o.c.	
		153	Elymus magellanicus	Blue Wheat Grass	#2 Pot	2'6" o.c.	
673 Nepeta faassenii 'Cat's Meow' Catmint #1 Pot 2'0" o.c.		174	Miscanthus sinensis 'Morning Light'	Silver Grass	#2 Pot	2'6" o.c.	
		673	Nepeta faassenii	'Cat's Meow' Catmint	#1 Pot	2'0" o.c.	
415 Rudbeckia fulgida 'Goldsturm' Black-Eyed Susan #1 Pot 1'6" o.c.	Ŏ	415	Rudbeckia fulgida 'Goldsturm'	Black-Eyed Susan	#1 Pot	1'6" o.c.	

- 1. ALL PLANT MATERIAL AND LANDSCAPING PRACTICES SHALL BE COMPLIANT WITH THE LATEST EDITION OF THE BCLNA NURSERY STANDARD.
- 2. IN CASE OF DISCREPANCY BETWEEN PLANT INFORMATION ON THE LIST AND ON THE PLAN, THE LATTER SHALL PREVAIL.
- 3. FINAL SOFTSCAPE AND GRADING LAYOUTS AS WELL AS LOCATION AND SPACING TO BE APPROVED BY LANDSCAPE ARCHITECT IN THE FIELD PRIOR TO INSTALLATION.
- 4. ALL PLANT MATERIAL TO BE MANUALLY WATERED FROM START OF INSTALLATION THROUGH THE END OF THE WARRANTY PERIOD.
- 5. INSTALL TREE PROTECTION FENCING AROUND ALL EXISTING TREES TO CITY STANDARDS, INSTALL TREE PROTECTION FENCING ON NEW PLANTING IF PHASED INSTALLATION IS REQUIRED. E FINAL LOCATION OLIANTITY TREE SPECIES TO THE SATISFACTION OF THE CLIENT AND THE LANDSCAPE ARCHITECT

1738 KINGSWAY, VANCOUVER, BC V5N 2S3 www.locidesign.ca // 604.694.0053

ALL RIGHTS RESERVED.

PROPERTY OF LOCI LANDSCAPE ARCHITECTURE AND URBAN DESIGN. USE OR REPRODUCTION PROHIBITED WITH PRIOR WRITTEN CONSENT.





No.	Description	Date
F	Issued for Development Permit	21-05-30
G	Re-Issued for Development Permit	21-12-23

H Issued for TRS Response

Project Info

Dilworth Center 2339 Highway 97N

Project Team

Kelowna, BC

Peterson

Architect IBI Group

Landscape Architect

LOCI Landscape Architecture + Urban Design

PH 2 - PLANT LIST

PHASE 2 PLANT IMAGES

TREES

Acer griseum Paperbark Maple



Acer rubrum 'Morgan' Morgan Red Maple



Catalpa speciosa Northern Catalpa



Cercidiphyllum japonicum Katsura Tree



Fraxinus 'Autumn Applause' White Ash



Ginkgo bilboa 'Princeton Sentry' Magnolia kobus **Princeton Sentry** Maidenhair Tree



Kobus Magknolia



Nyssa Sylvatica **Black Tupelo**



Prunus x Yedoensis Yoshino Cherry

Pyrus calleryana 'Chanticleer' Pseudosuga menziesii **Callery Pear**



Douglas Fir



Arbutus unedo 'Compacta' **Compact Strawberry Bush**



Artemesia tridentata **Big Safebrush**



Berberis thunbergii 'Atropurpurea' Japanese Barberry




Cornus sericea 'Kelseyi' **Dwarf Red Osier Dogwood**



Juniperus communis Common Juniper



Box-leaf Honeysuckle

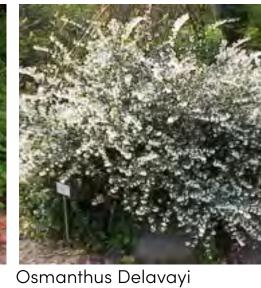

Sweet Olive



Pinus mugo Mugo pine



Potentilla fruticosa **Bush Cinquefoil**



Prunus laurocerasus 'Otto Luyken' **Cherry Laurel**

SHRUBS



Rhododendron x 'Ramapo' Ramapo Rhododendron



Ribes sanguineum Flowering Red Currant



Rosa nootkatensis Nookta Rose



Rosa rugosa 'John Cabot' **Red Climbing Rose**



Salix purpurea 'Nana' **Dwarf Arctic Willow**



Spiraea bumalda 'Goldflame' Taxus x media 'Hicksii" 'Goldflame' Spiraea



'Hick's' Yew

GROUNDCOVERS FERNS PERENNIALS GRASSES



Elymus magellanicus **Blue Wheat Grass**



Miscanthus sinensis 'Morning Light' **Chinese Silver Grass**



Nepeta faassenii Cat's Meow Catmint



Rudbeckia fulgida 'Goldstrum' **Blackeyed Susan**



1738 KINGSWAY, VANCOUVER, BC V5N 2S3 www.locidesign.ca // 604.694.0053

IBI

Peterson

ALL RIGHTS RESERVED.

		-,	* *
sue			

H Issued for TRS Response

No. Description Date F Issued for Development Permit G Re-Issued for Development 21-12-23

22-02-03

Project Info 20168

> Dilworth Center Mixed Use 2339 Highway 97N

Project Team

Kelowna, BC


Peterson Architect

IBI Group Landscape Architect

LOCI Landscape Architecture + Urban Design

Checked By

PH 2 - PLANT IMAGES

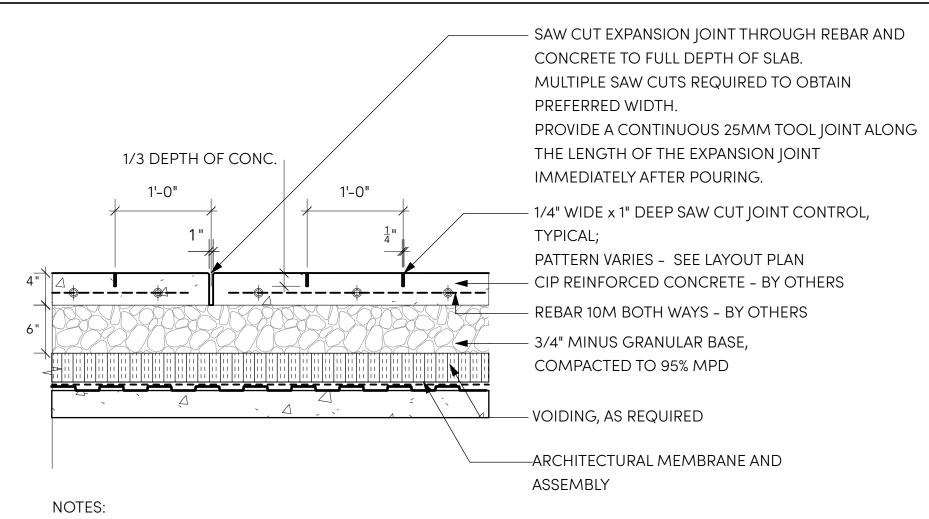

- 1. TROWEL WITH LIGHT SANDBLAST
- 2. SEE TYPICAL LAYOUT PLAN FOR JOINT PATTERN AND BAND WIDTH
- 3. EXP. JOINTS 20'-0" O.C. MAX (@ CURB, BUILDING EDGE CUT LINES, CHANGES IN MATERIALS.
- SPACING TO COINCIDE W/ PATTERN)
- 4. CONTROL JOINTS @ 5'-0" O.C. MAX
- 5. FINAL LOCATIONS TO BE CONFIRMED ON SITE
- 6. STRUCTURAL ENGINEER TO CONFIRM DEPTH AND REINFORCEMENT









BROOM FINISH


LIGHT SANDBLAST FINISH HEAVY SANDBLAST


PAVING TYPE 1: CIP CONCRETE PAVING, TYP.

Scale: 1" = 1'-0"

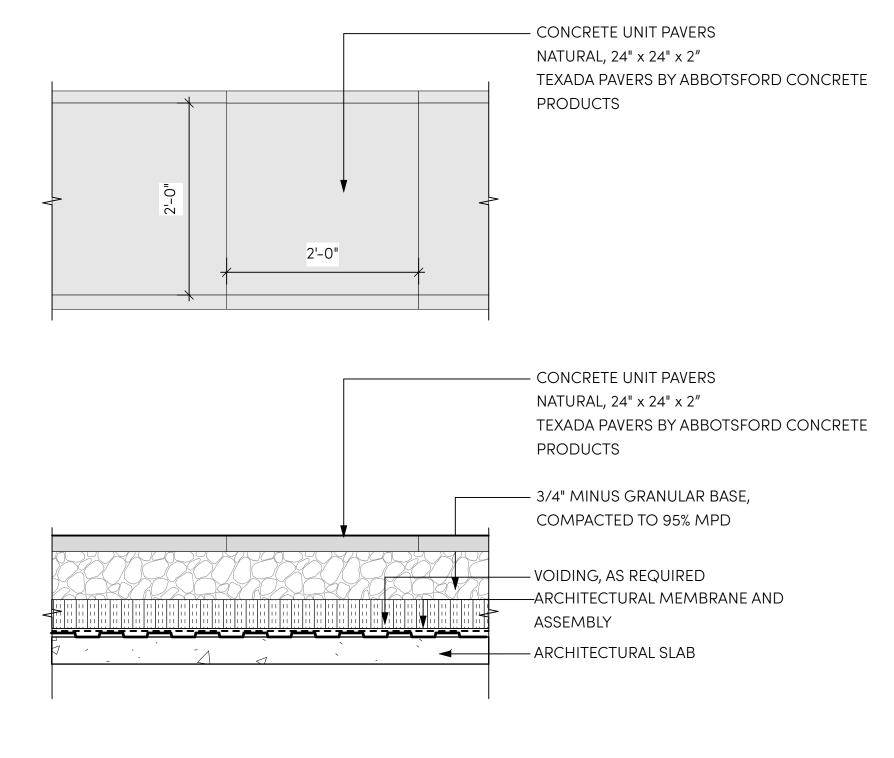

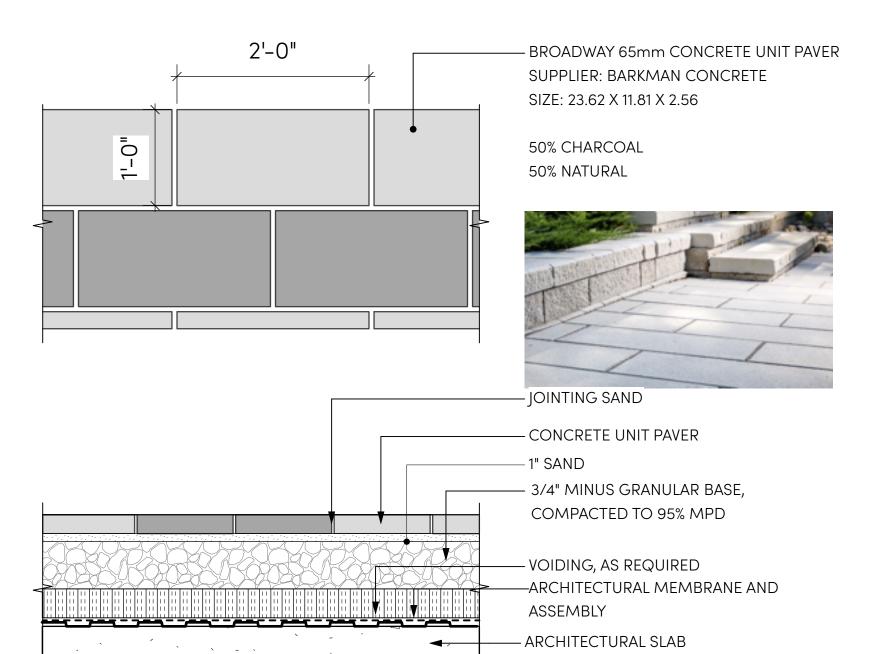


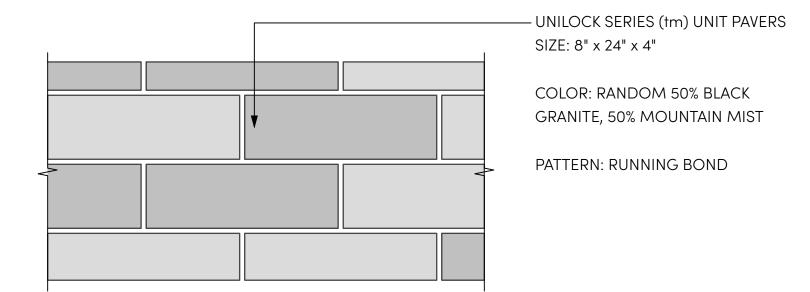

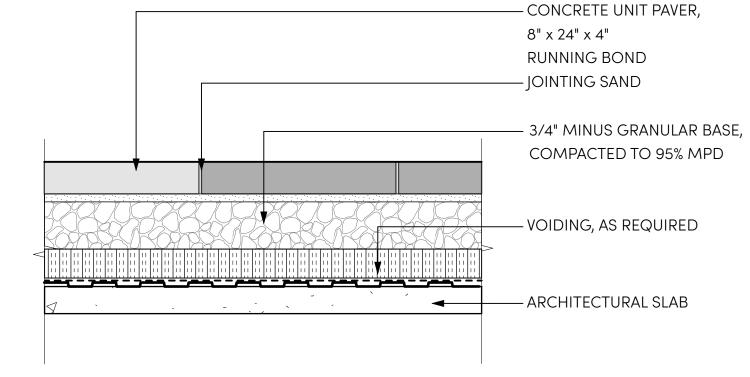



PAVING TYPE 2: ENTRY MEWS PAVING, TYP.

Scale: 1" = 1'-0" 4'-0"

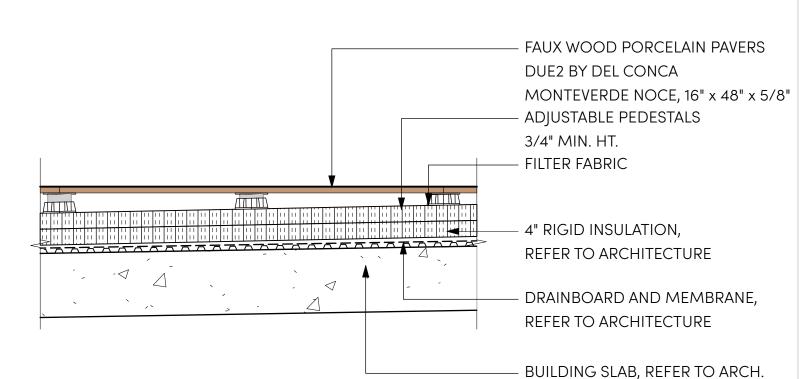



PAVING TYPE 6: POOL DECK PORCELAIN PAVERS 16" x 48", TYP. Scale: 1" = 1'-0"

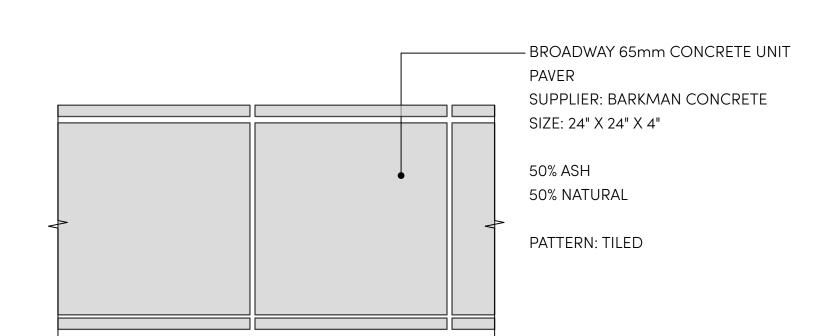

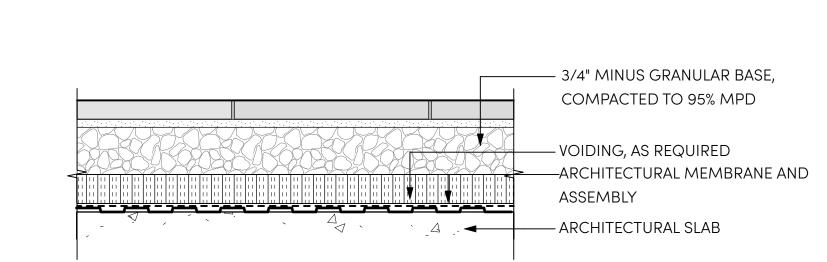

PAVING TYPE 3: PRIVATE PATIO PAVING, TYP.

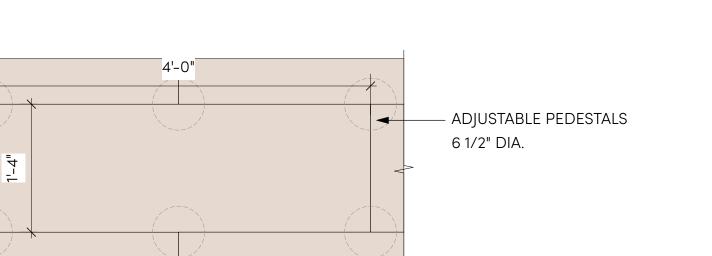

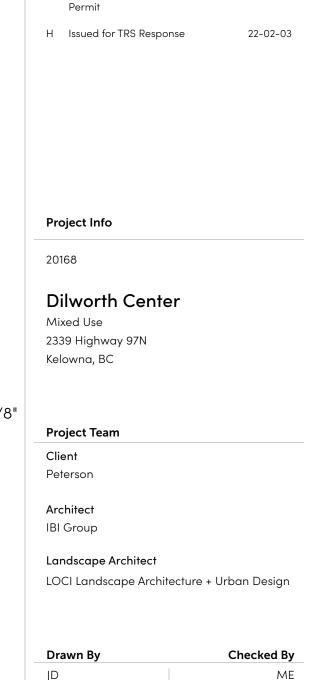

PH 2 - HARDSCAPE DETAIL

1738 KINGSWAY, VANCOUVER, BC V5N 2S3

PROPERTY OF LOCI LANDSCAPE ARCHITECTURE

AND URBAN DESIGN. USE OR REPRODUCTION

PROHIBITED WITH PRIOR WRITTEN CONSENT.

IBI

Peterson

www.locidesign.ca // 604.694.0053

ALL RIGHTS RESERVED.

Project Stamp

No. Description

F Issued for Development Permit

21-12-23


G Re-Issued for Development

PAVING TYPE 5: AMENITY PAVING, TYP.

- PAVING

Rev. A revision

PAVING TYPE 4: LOBBY PAVING, TYP. Scale: 1" = 1'-0"

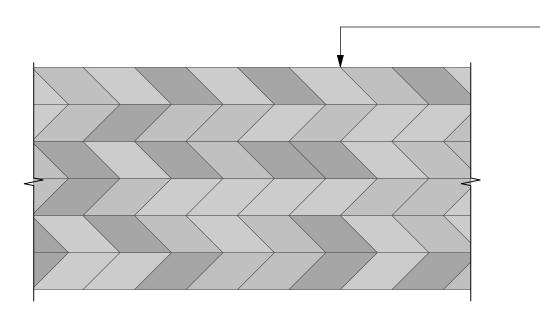

TYPE A TYPE B

PAVING TYPE 7: FEATURE PLAZA PAVING, TYP.

TYPE C

Scale: 1" = 1'-0"

– DIAMOND CONCRETE UNIT PAVER DIAMOND SMOOTH BY TECHO BLOC, OR APPROVED ALTERNATIVE

SIZE: 12 5/16" x 7 1/8" x 3 15/16" PATTERN: 02 CHEVRON PATTERN COLOUR: RANDOM MIX - 50% SHALE GREY, 25% GREYE NICKEL, 25% CHARCOAL

– JOINTING SAND

- 1" SAND

ASSEMBLY

- CONCRETE UNIT PAVER


- VOIDING, AS REQUIRED

– ARCHITECTURAL SLAB

- 6" MIN. OF GRAVEL COMPACTED TO


95% MODIFIED PROCTOR DENSITY

-ARCHITECTURAL MEMBRANE AND

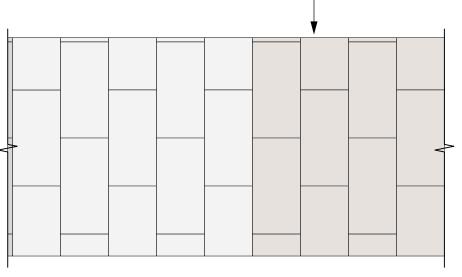

- CONCRETE UNIT PAVERS TEXADA HYDRAPRESSED SLABS BY ABBOTSFOR OR APPROVED ALTERNATIVE

PATTERN: RUNNING BOND COLOUR: 90% NATURAL + 10% DARK, RANDOM

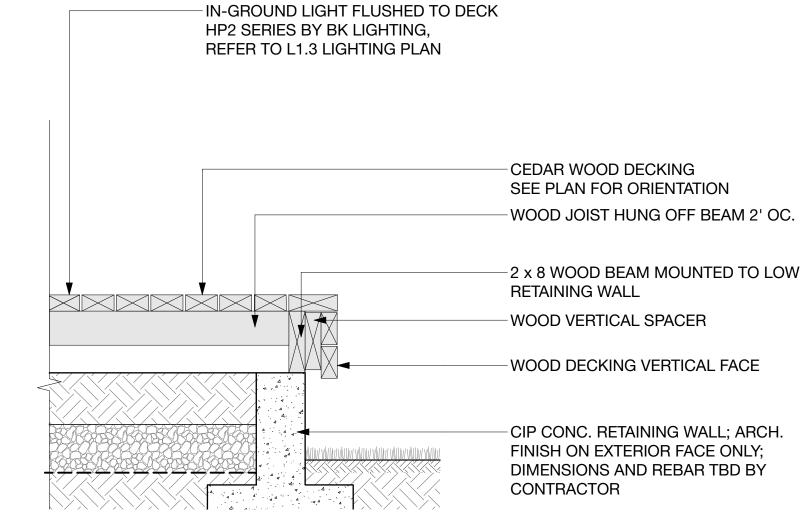

PAVING TYPE 9: WOODEN DECKING, TYP.

1738 KINGSWAY, VANCOUVER, BC V5N 2S3 www.locidesign.ca // 604.694.0053

ALL RIGHTS RESERVED.

PROPERTY OF LOCI LANDSCAPE ARCHITECTURE AND URBAN DESIGN. USE OR REPRODUCTION

PROHIBITED WITH PRIOR WRITTEN CONSENT.



Peterson

Project Stamp



No. Description F Issued for Development Permit G Re-Issued for Development 21-12-23

22-02-03

H Issued for TRS Response

Project Info

20168

Dilworth Center

Mixed Use 2339 Highway 97N Kelowna, BC

Project Team

Peterson

Architect IBI Group

Landscape Architect

LOCI Landscape Architecture + Urban Design


Checked By

PH 2 - HARDSCAPE DETAIL


- PAVING

Rev. A revision


SIZE: 6" x 12" x 2" – JOINTING SAND

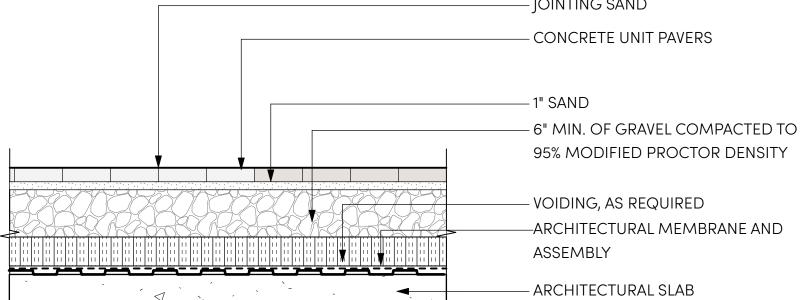


PAVING TYPE 8: RETAIL FRONTAGE PAVING, TYP.

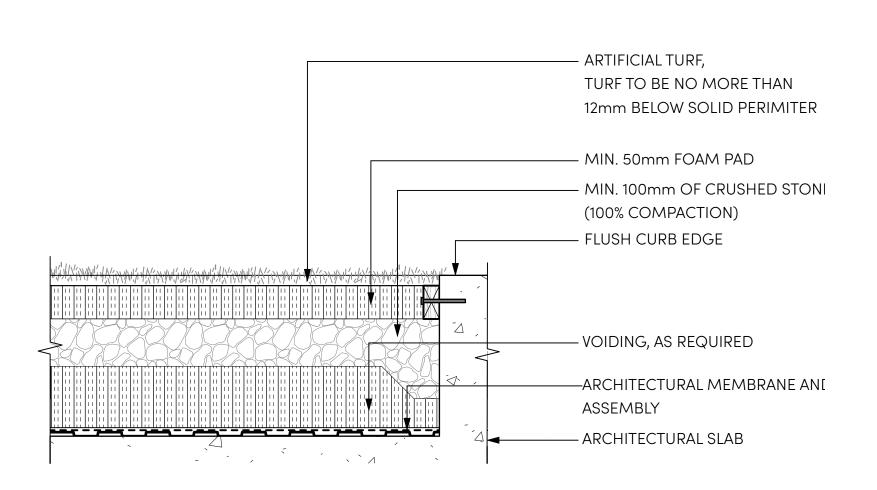


PAVING TYPE 11: ARTIFICIAL TURF Scale: 1" = 1'-0"

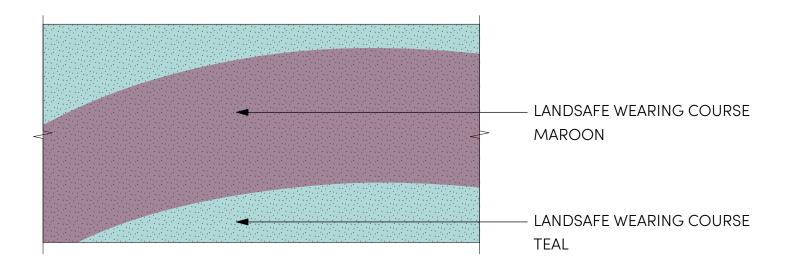

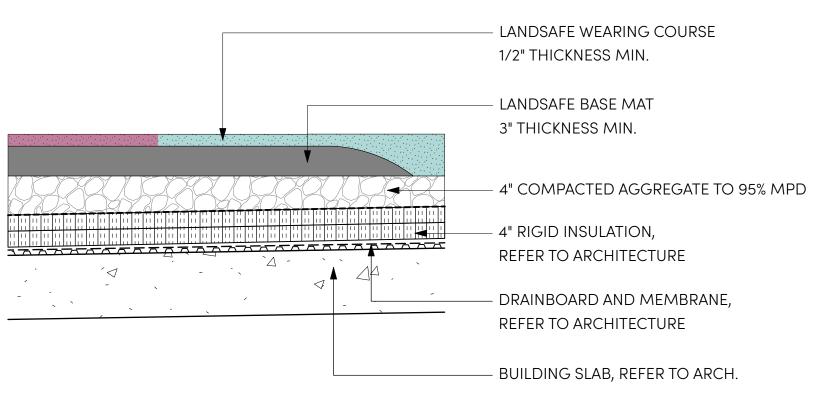


PAVING TYPE 12: PIP RUBBER SURFACE

Scale: 1" = 1'-0"

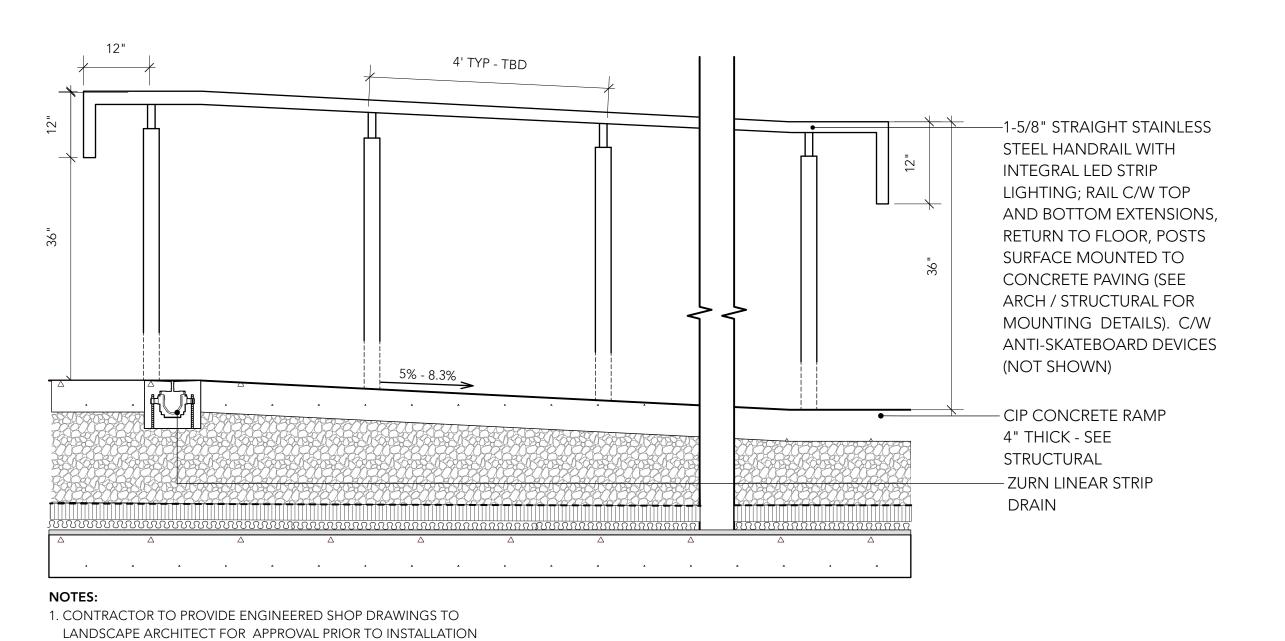


CONCRETE LANDSCAPE RAMP ON SLAB, TYP

Scale: 1" = 1'-0"

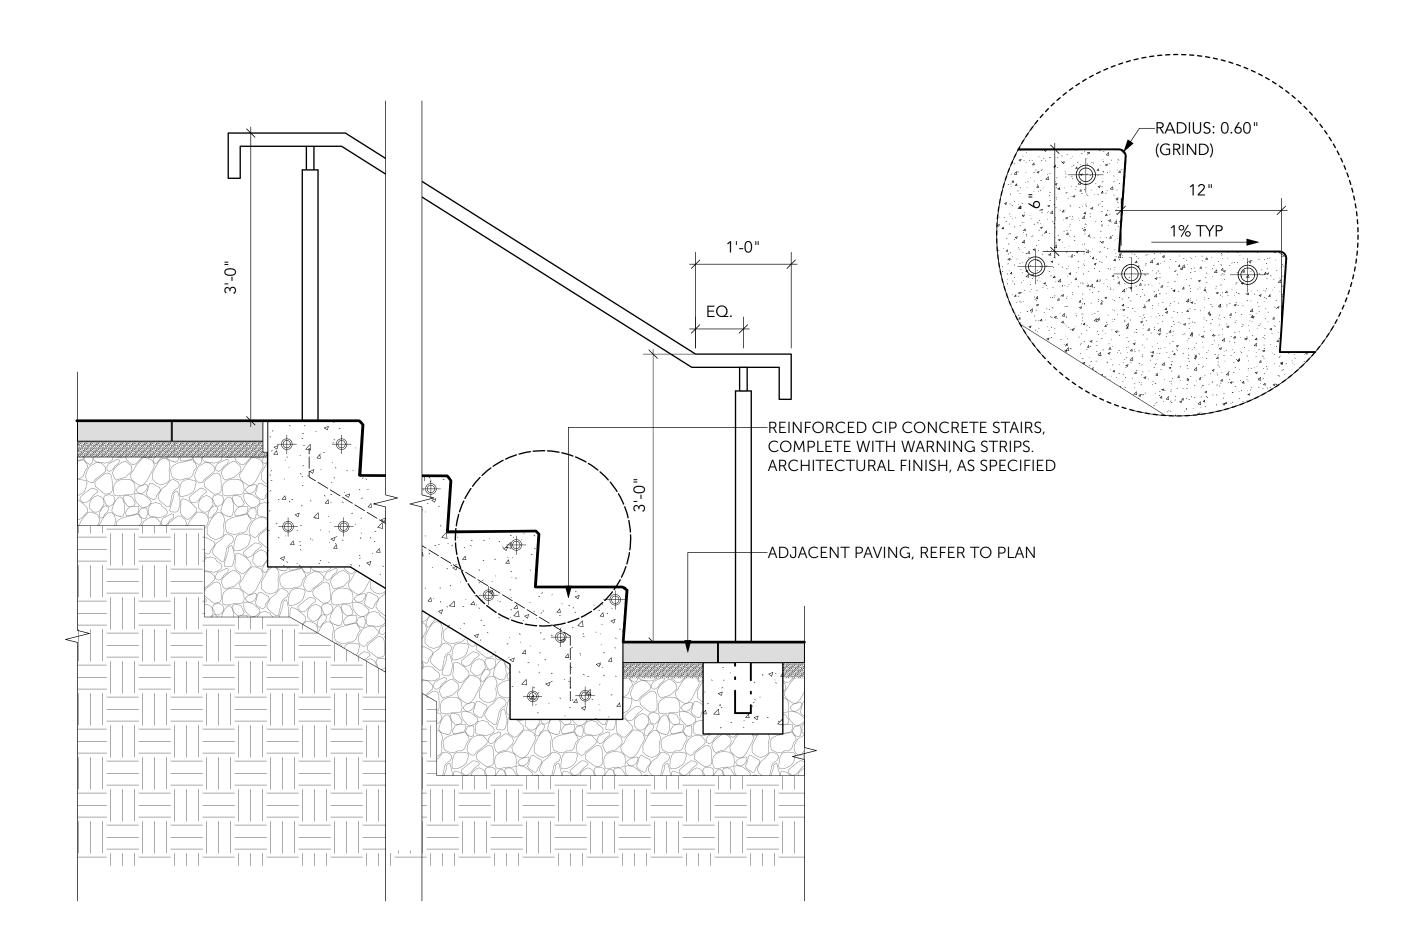


CIP CONCRETE STAIRS AT GRADE

Scale: 1" = 1'-0"

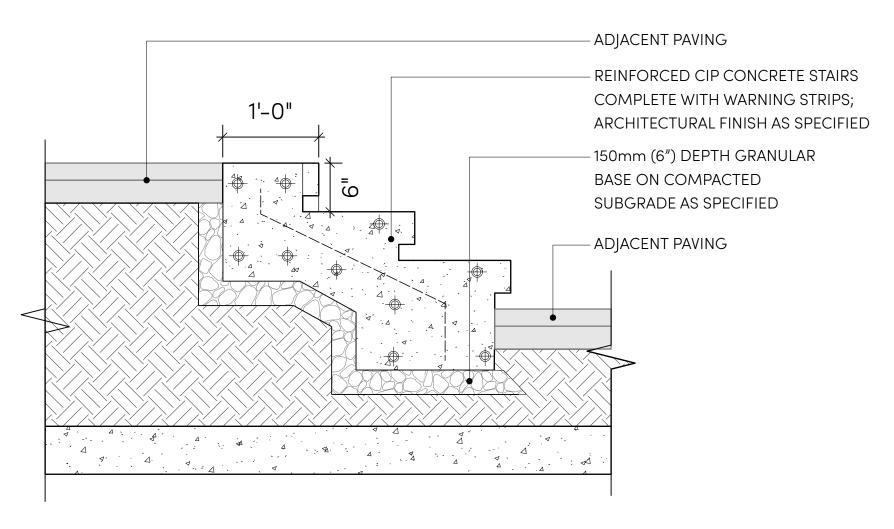

TYPICAL STAIR DETAIL

Scale: 1" = 1'-0

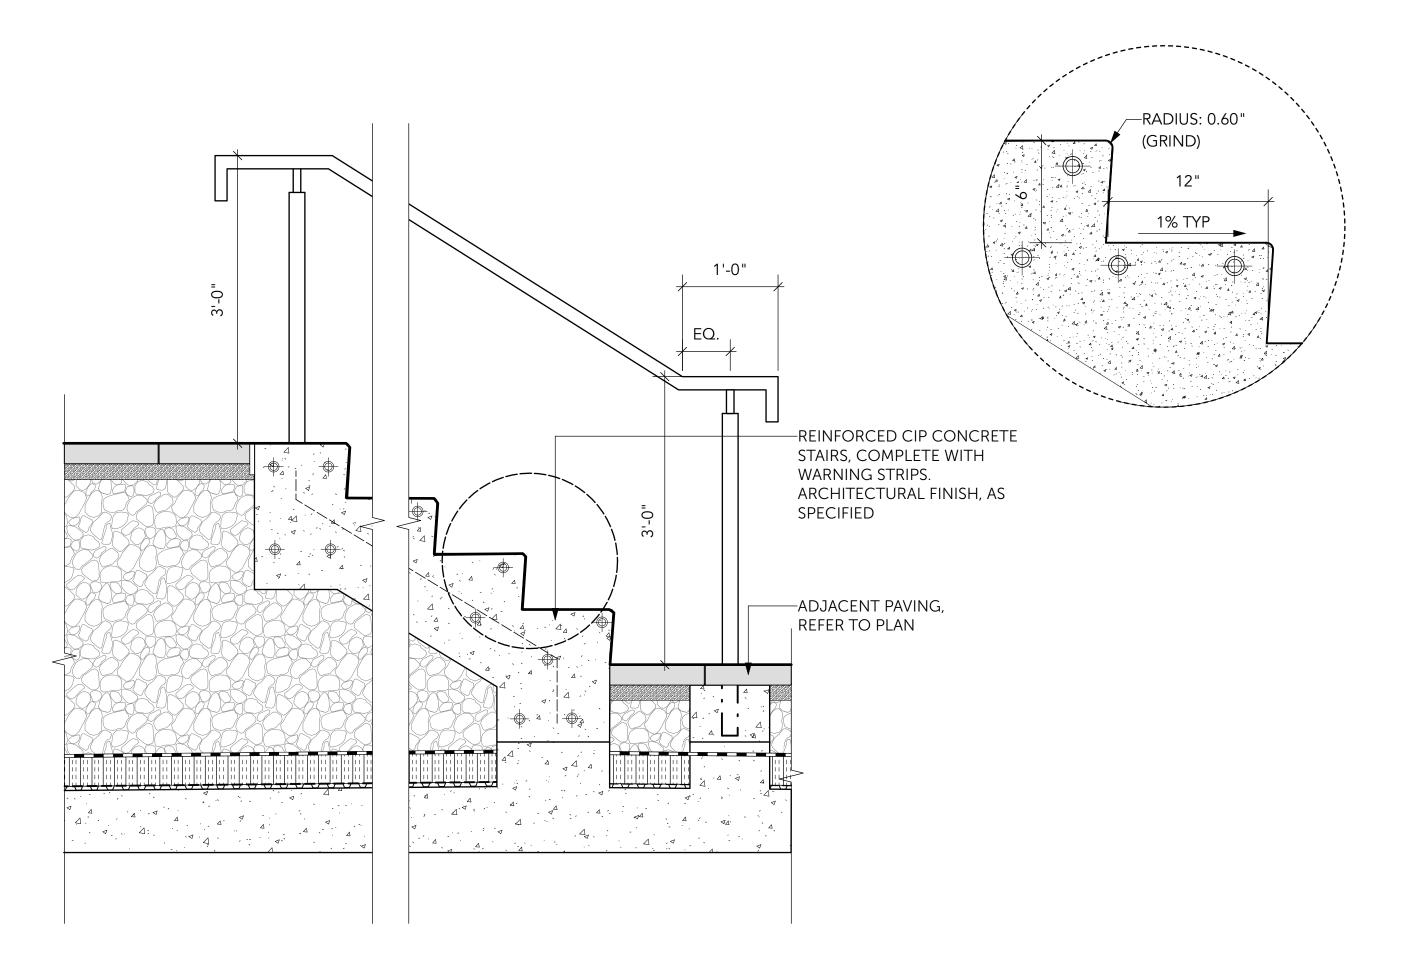

CIP CONCRETE STAIRS ON SLAB

Scale: 1" = 1'-0"



1738 KINGSWAY, VANCOUVER, BC V5N 2S3 www.locidesign.ca // 604.694.0053

ALL RIGHTS RESERVED.

PROPERTY OF LOCI LANDSCAPE ARCHITECTURE

AND URBAN DESIGN. USE OR REPRODUCTION

PROHIBITED WITH PRIOR WRITTEN CONSENT.

IBI

Peterson

Project Stamp



legue

No. Description Date

F Issued for Development Permit 21-05-30

G Re-Issued for Development 21-12-23
Permit

22-02-03

H Issued for TRS Response

20168

Project Info

Dilworth Center Mixed Use 2339 Highway 97N

Kelowna, BC

Project Team
Client

Peterson

Architect

IBI Group


Landscape Architect
LOCI Landscape Architecture + Urban Design

LOCI Lanascape Architecture + 0

wn By Checked By
ME


PH 2 - HARDSCAPE DETAIL
- STAIRS AND RAMPS

L5.2

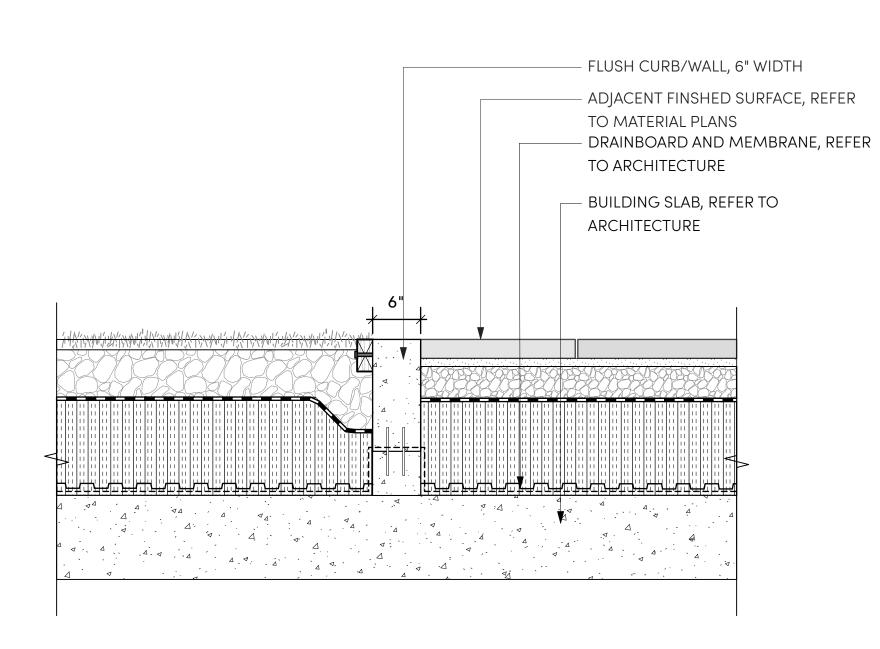

CONCRETE FLUSH CURB/WALL, TYP.


Scale: 1" = 1'-0"

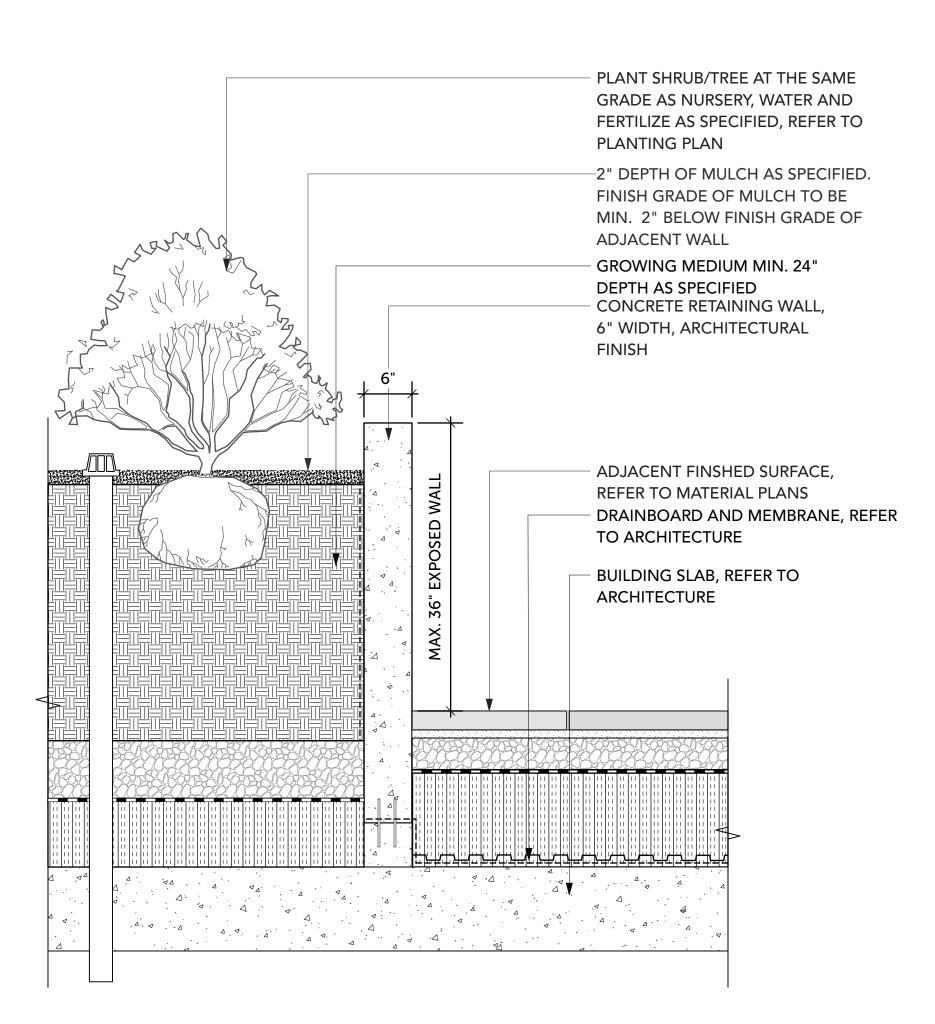


WALL TYPE 1: CONCRETE RETAINING PLANTER WALL ON SLAB, TYP.

ADJACENT PLANTING, REFER TO PLANTING PLAN -2" DEPTH OF MULCH AS SPECIFIED. FINISH GRADE OF MULCH TO BE MIN. 2" BELOW FINISH GRADE OF ADJACENT WALL 6" CIP CONCRETE RETAINING WALL, BOARDFORM OR ARCHITECTURAL FINISH NO -CHAMFER AS SPECIFIED - SEE STRUCTURAL FOR REINFORCEMENT, REFER TO MATERIAL PLANS FOR FINISH FOR REINFORCING AND SIZE OF REBAR - REFER TO STRUCTURAL DRAIN ROCK WRAPPED IN GEOTEXTILE FABRIC AS SPECIFIED 4" DIAMETER PERFORATED PVC PIPE TO ATTACH TO PERIMETER DRAINAGE ADJACENT PAVING / PLANTING MATERIAL -**REFER TO PLAN** COMPACTED GRANULAR BASE AS PER STRUCTURAL ENGINEER SPECIFICATIONS

WALL TYPE 1: CONCRETE RETAINING PLANTER WALL ON GRADE, TYP.

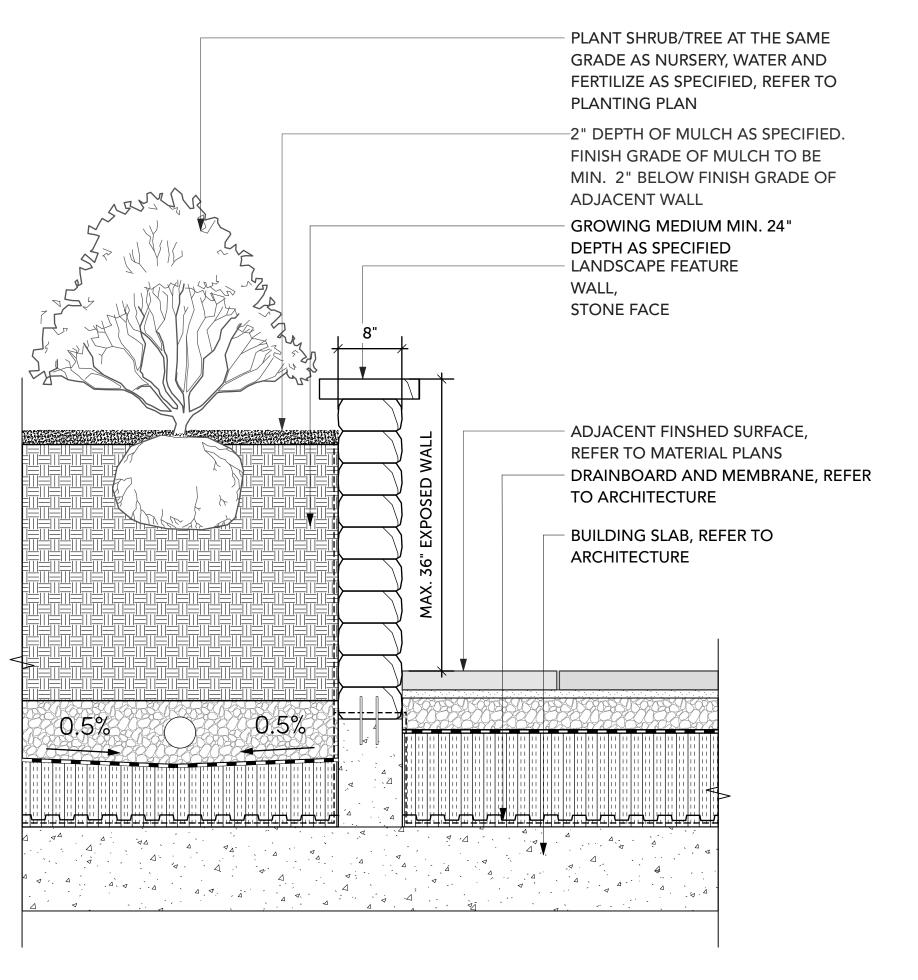

WALL TYPE 1 (OPTION): UNIT BLOCK WALL ON SLAB, TYP.

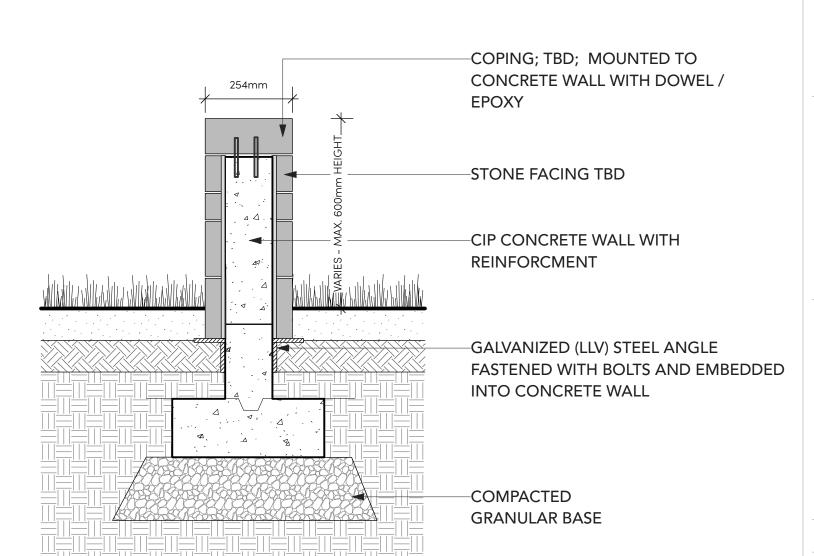

WALL TYPE 2: LANDSCAPE FEATURE WALL, TYP.

1738 KINGSWAY, VANCOUVER, BC V5N 2S3 www.locidesign.ca// 604.694.0053

ALL RIGHTS RESERVED.

PROPERTY OF LOCI LANDSCAPE ARCHITECTURE AND URBAN DESIGN. USE OR REPRODUCTION

PROHIBITED WITH PRIOR WRITTEN CONSENT.

ΙB

Peterson

Project Stamp



No. Description F Issued for Development Permit 21-12-23 G Re-Issued for Development H Issued for TRS Response 22-02-03

Project Info

20168

Dilworth Center Mixed Use

2339 Highway 97N

Kelowna, BC

Project Team

Peterson Architect


Landscape Architect

LOCI Landscape Architecture + Urban Design

Checked By

PH 2 - HARDSCAPE DETAIL - CURBS AND WALLS

L5.3

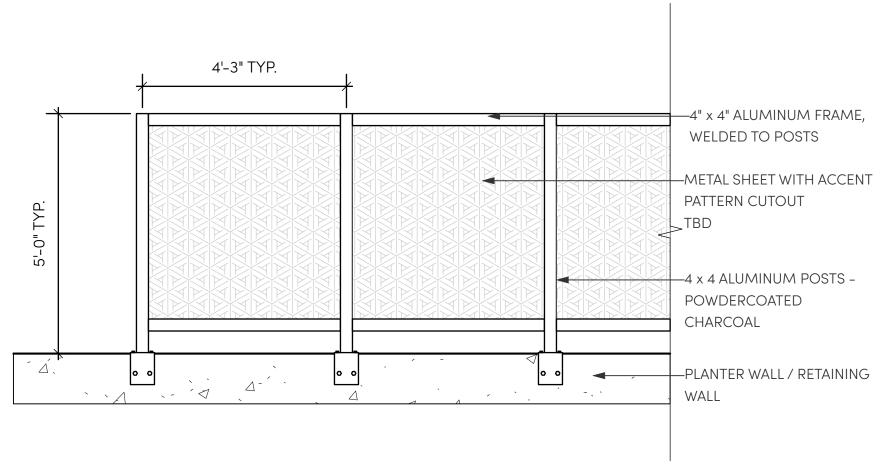

KALEIDOSCOPE

SECTION


1. ARCHITECTURE AND STRUCTURAL TO COORDINATE FINAL LOCATION AND DETAILING



PRECEDENT IMAGE

FENCE TYPE 1: 5'-0" HT. PERIMETER FENCE, TYP.


Scale: 1/2" = 1'-0"

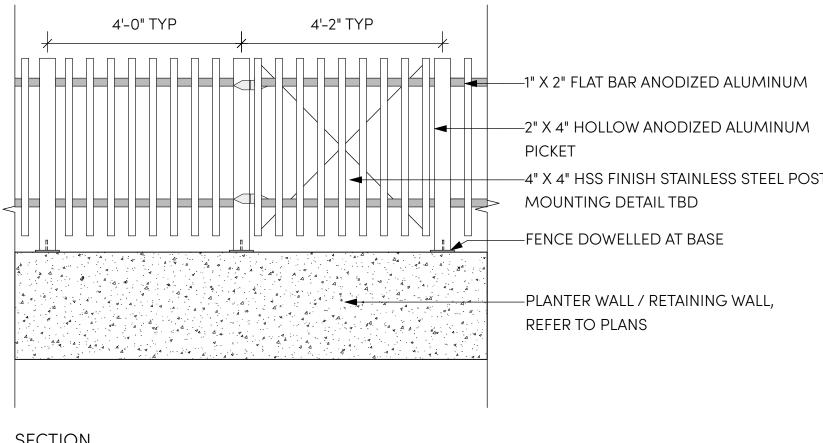




PRECEDENT IMAGE

FENCE TYPE 2 / 3 / 5: PRIVATE PATIO FENCE AND GATE, TYP. Scale: 1/2" = 1'-0"

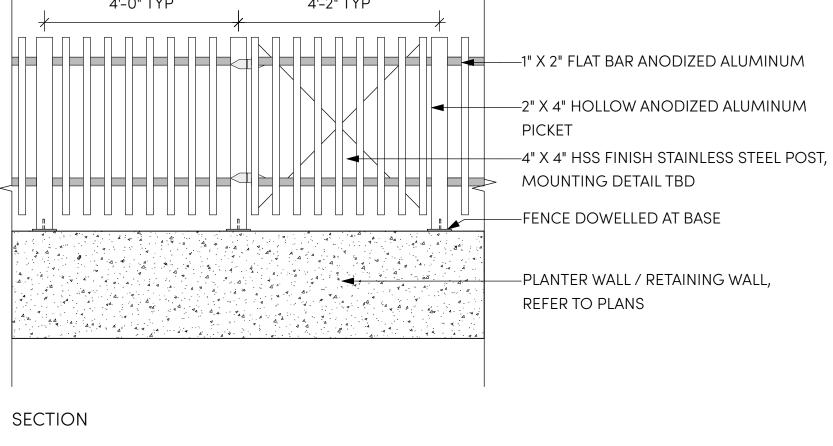

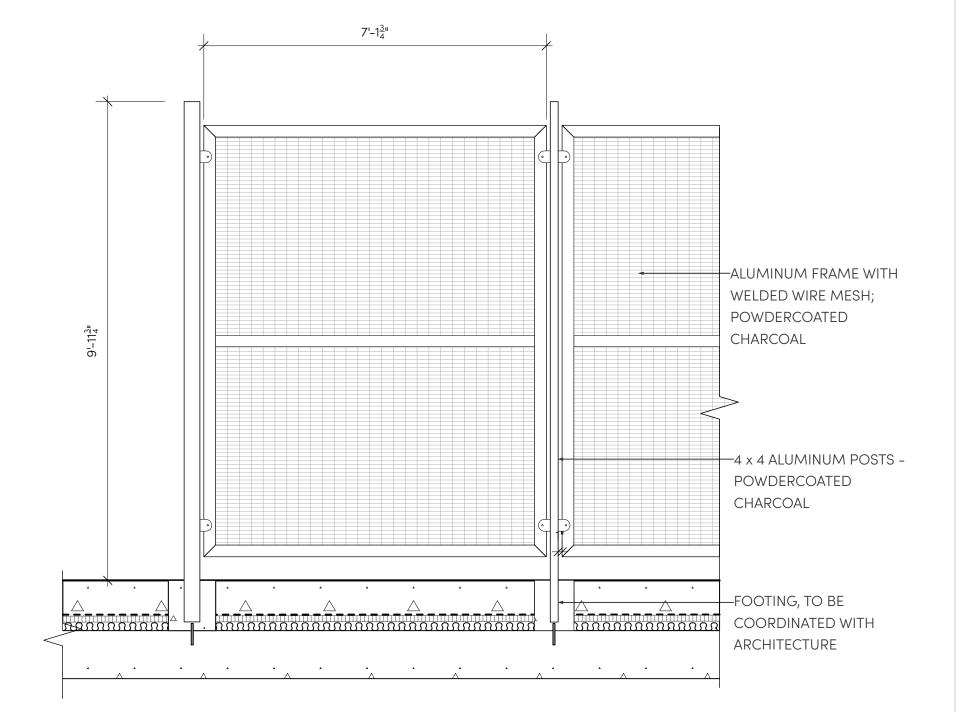

1. ARCHITECTURE AND STRUCTURAL TO COORDINATE FINAL LOCATION AND DETAILING OF HIGH FENCES

FENCE TYPE 4: HIGH SPORT COURT FENCE, TYP.

Scale: 1/2" = 1'-0"

1738 KINGSWAY, VANCOUVER, BC V5N 2S3 www.locidesign.ca // 604.694.0053

ALL RIGHTS RESERVED.

PROPERTY OF LOCI LANDSCAPE ARCHITECTURE AND URBAN DESIGN. USE OR REPRODUCTION PROHIBITED WITH PRIOR WRITTEN CONSENT.



Peterson

Project Stamp



No. Description F Issued for Development Permit G Re-Issued for Development 21-12-23

22-02-03

H Issued for TRS Response

Project Info

Dilworth Center

Mixed Use 2339 Highway 97N Kelowna, BC

20168

Project Team

Peterson

Architect IBI Group


Landscape Architect


LOCI Landscape Architecture + Urban Design

Checked By

PH 2 - SITE FURNISHING DETAIL - FENCES

L5.4

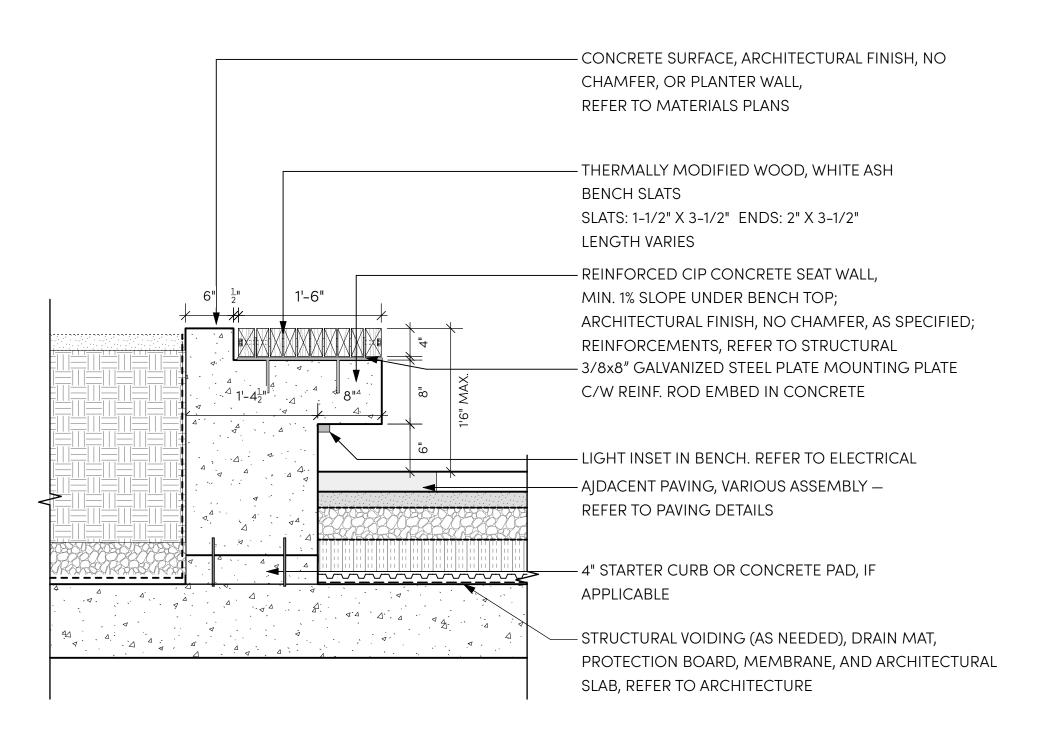


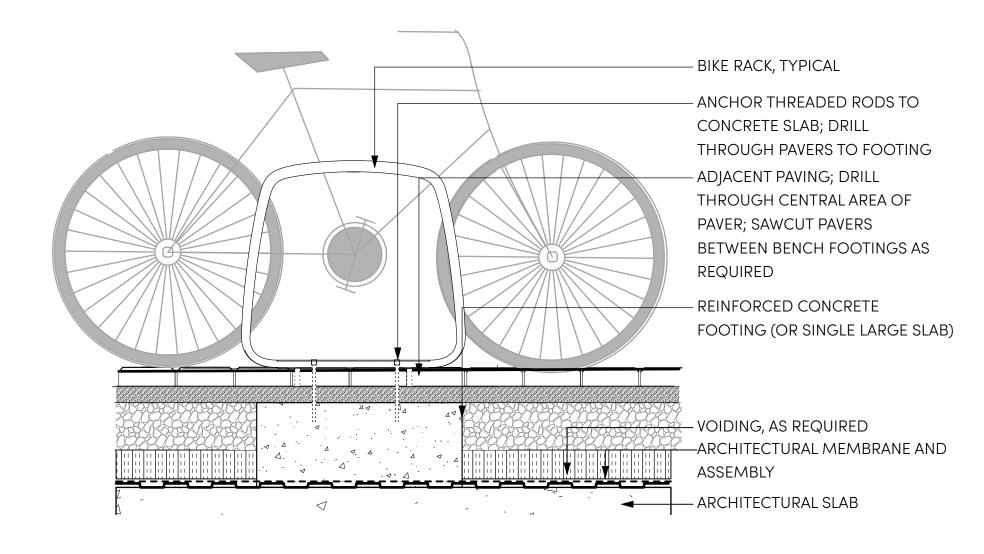

WOOD TOP BENCH ON CONC WALL, TYP.

BIKE RACK DETAIL, TYP.



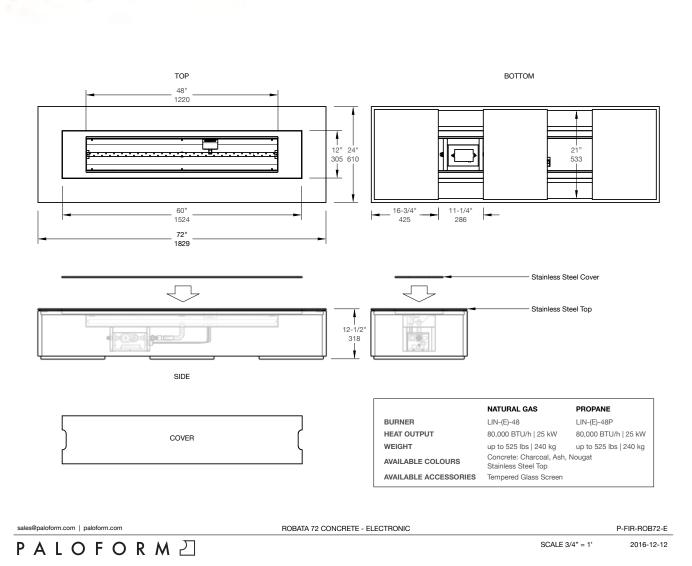





SECTIONAL SOFA (CHARACTER IMAGE)



ALUMINUM TRELLIS STRUCTURE - FOR REFERENCE ONLY

Scale: NTS

LANDSCAPE ARCHITECTURE + URBAN DESIGN

1738 KINGSWAY, VANCOUVER, BC V5N 2S3 www.locidesign.ca // 604.694.0053

ALL RIGHTS RESERVED.

PROPERTY OF LOCI LANDSCAPE ARCHITECTURE


AND URBAN DESIGN. USE OR REPRODUCTION

PROHIBITED WITH PRIOR WRITTEN CONSENT.

IBI

Peterson

Project Stamp

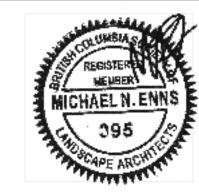

Issue

No. Description

E Issued for Master Development 21-05-28
Permit

F Issued for Development Permit 21-05-30

H Issued for TRS Response 22-02-03

Project Info

20168

Dilworth Center
Mixed Use
2339 Highway 97N
Kelowna, BC

Project Team

Client Peterson

Architect IBI Group


Landscape Architect
LOCI Landscape Architecture + Urban Design

LOCI Landscape Architecture + Urban Desig

awn By Checked By


PH 2 - SITE FURNISHING
DETAIL - BENCHES AND
SEATING

L5.5

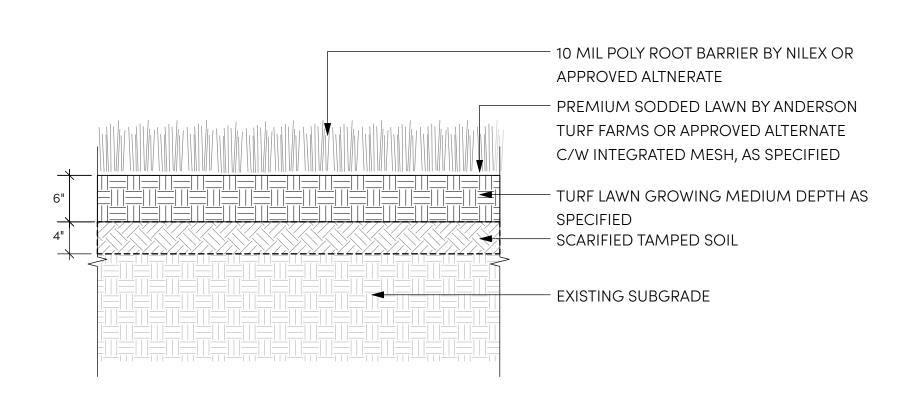

SODDED LAWN ON GRADE, TYP.

Scale: 1" = 1'-0

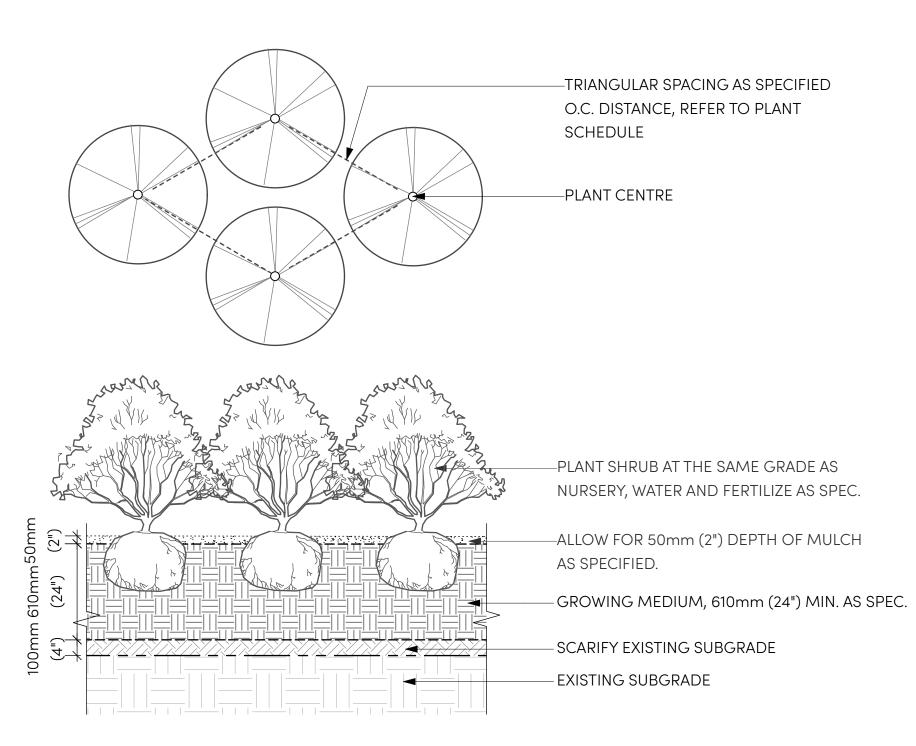


NOTES:

- 1. TRIANGULAR SPACING FOR IRREGULAR SHAPED PLANTERS AS SPECIFIED O.C. DISTANCE; ENSURE PERIMETER ROW.
- 2. REFER TO PLANT SCHEDULE AND PLANTING PLAN
- 3. FINISH GRADE OF MULCH TO BE 50mm (2") BELOW FINISH GRADE OF ADJACENT WALL OR PAVING


TRIANGULAR PLANTING ON GRADE, TYP.

Scale: 1/2" = 1'-0"

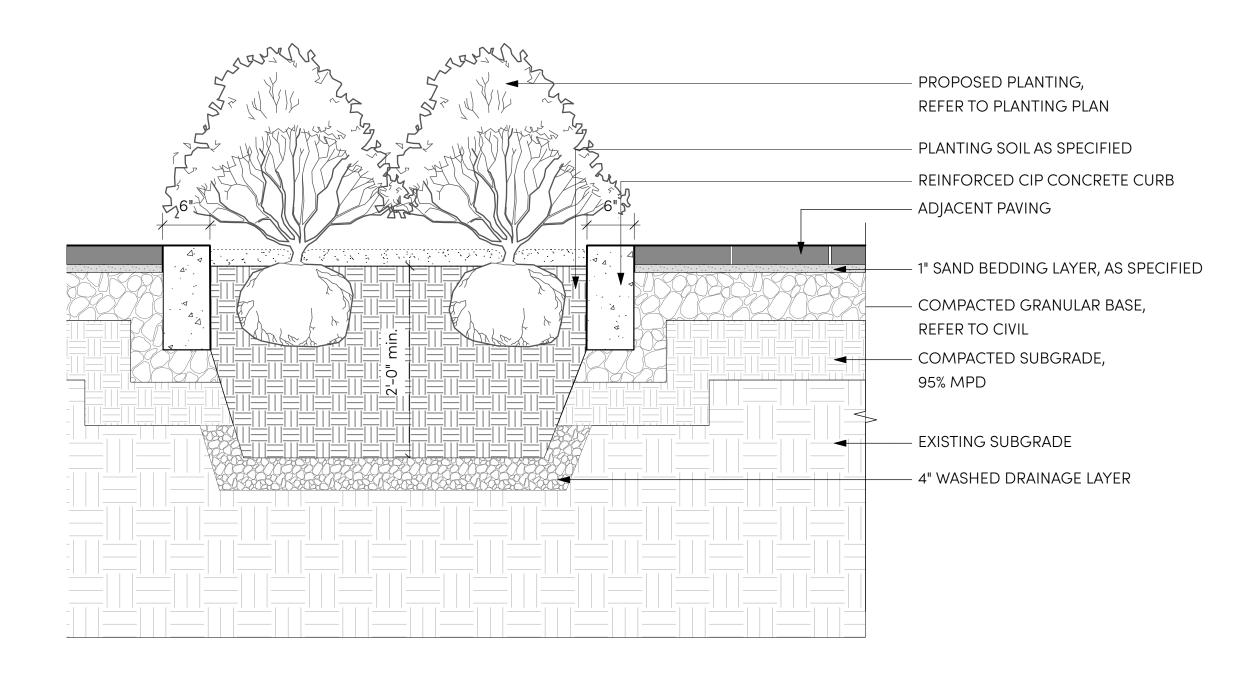

INSET PLANTING WITH CURB ON GRADE, TYP.

Scale: 1" = 1'-0"

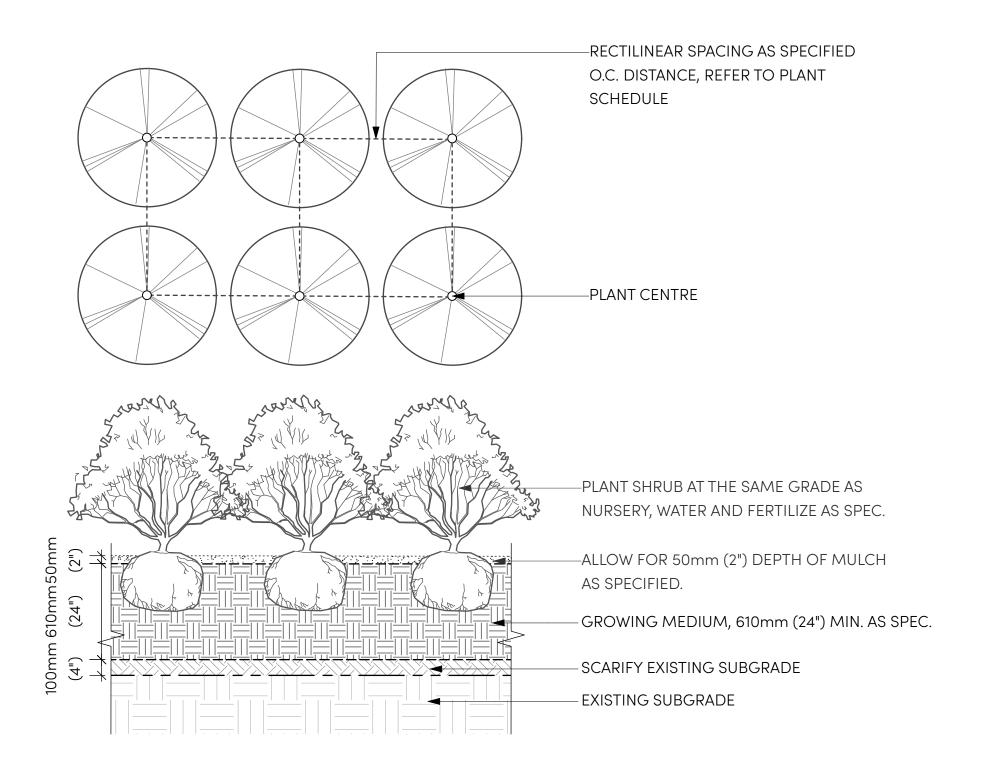

NOTES:

- 1. RECTILINEAR SPACING FOR REGULAR SHAPED PLANTERS AS SPECIFIED O.C. DISTANCE; ENSURE PERIMETER ROW. GRID SPACING FOR RECTLINEAR PLANTERS.
- 2. REFER TO PLANT SCHEDULE AND PLANTING PLAN
- 3. FINISH GRADE OF MULCH TO BE 50mm (2") BELOW FINISH GRADE OF ADJACENT WALL OR PAVING

RECTILINEAR PLANTING ON GRADE, TYP

Scale: 1/2" = 1'-0"



1738 KINGSWAY, VANCOUVER, BC V5N 2S3 www.locidesign.ca // 604.694.0053

ALL RIGHTS RESERVED.

PROPERTY OF LOCI LANDSCAPE ARCHITECTURE
AND URBAN DESIGN. USE OR REPRODUCTION



PROHIBITED WITH PRIOR WRITTEN CONSENT.

Peterson

Project Stamp



Issue

No.DescriptionDateFIssued for Development Permit21-05-30GRe-Issued for Development
Permit21-12-23

22-02-03

H Issued for TRS Response

Project Info

20168

Dilworth Center Mixed Use 2339 Highway 97N

Project Team

Kelowna, BC

Project Team

Peterson

Architect IBI Group


Landscape Architect

LOCI Landscape Architecture + Urban Design

Drawn By Checked By


PH 2 - SOFTSCAPE DETAIL
- ON-GRADE PLANTING

L5.6

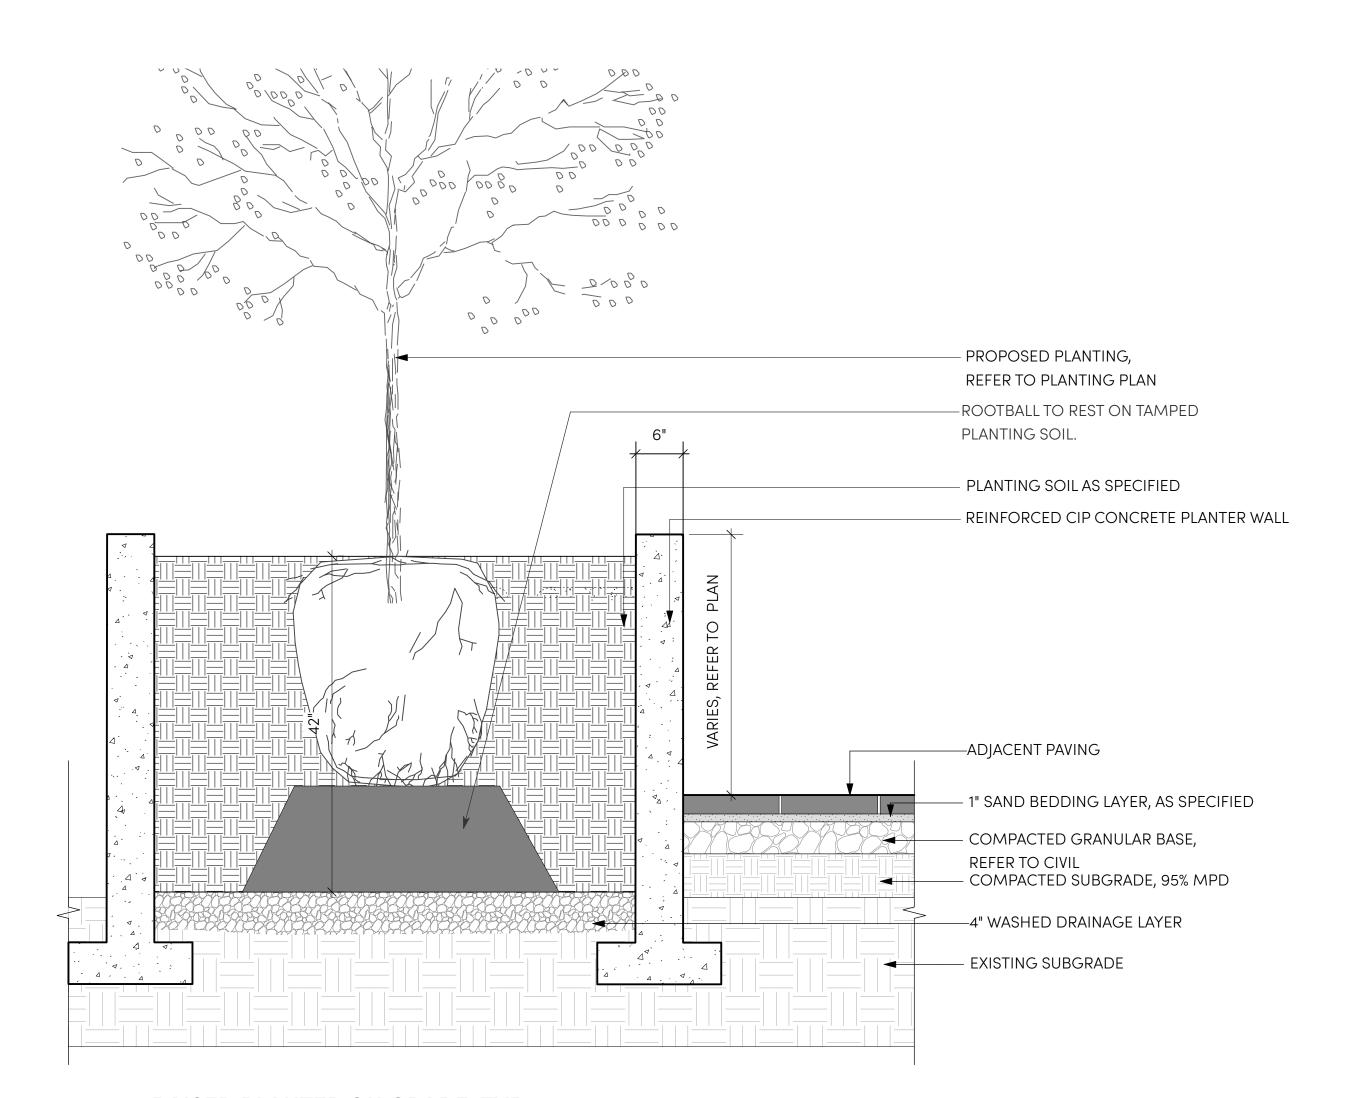

1 RAISED PLANTER ON GRADE, TYP.

Scale: 1" = 1'-0"

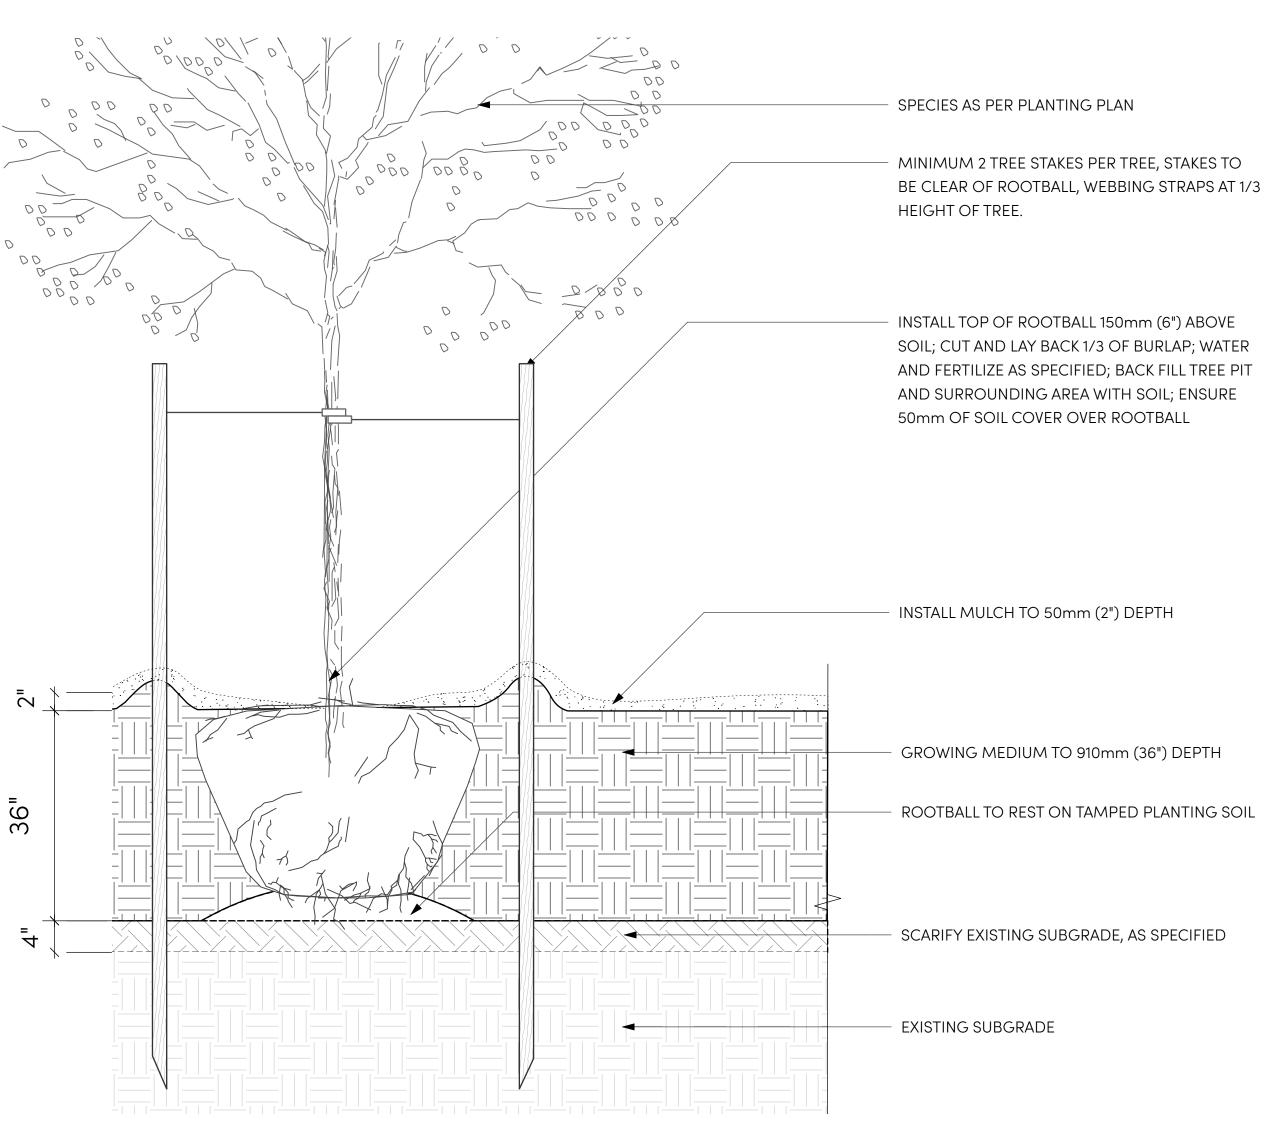

TREE PLANTING ON GRADE, TYP.

Scale: 1" = 1'-0"

LANDSCAPE ARCHITECTURE + URBAN DESIGN

1738 KINGSWAY, VANCOUVER, BC V5N 2S3 www.locidesign.ca // 604.694.0053

ALL RIGHTS RESERVED.

PROPERTY OF LOCI LANDSCAPE ARCHITECTURE
AND URBAN DESIGN. USE OR REPRODUCTION

PROHIBITED WITH PRIOR WRITTEN CONSENT.



Peterson

Project Stamp



Issue

No. Description

F Issued for Development Permit 21-05-30

G Re-Issued for Development 21-12-23

Permit

22-02-03

H Issued for TRS Response

Project Info

20168

Dilworth Center
Mixed Use
2339 Highway 97N

Kelowna, BC

Project Team

Client Peterson

Architect IBI Group

Landscape Architect


LOCI Landscape Architecture + Urban Design

Drawn By

Checked By


PH 2 - SOFTSCAPE DETAIL
- ON-GRADE PLANTING

L5.7

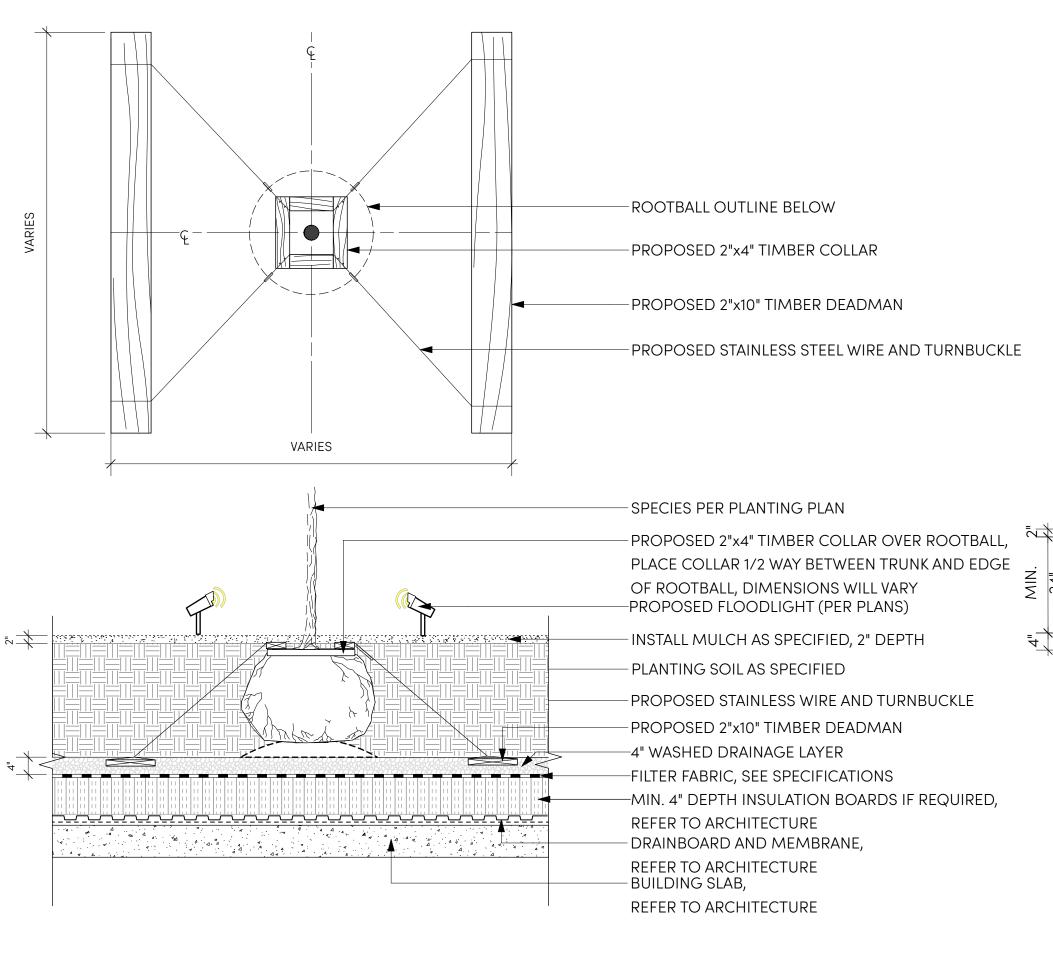


TREE PLANTER ON SLAB, TYP.

Scale: 1/2" = 1'-0"

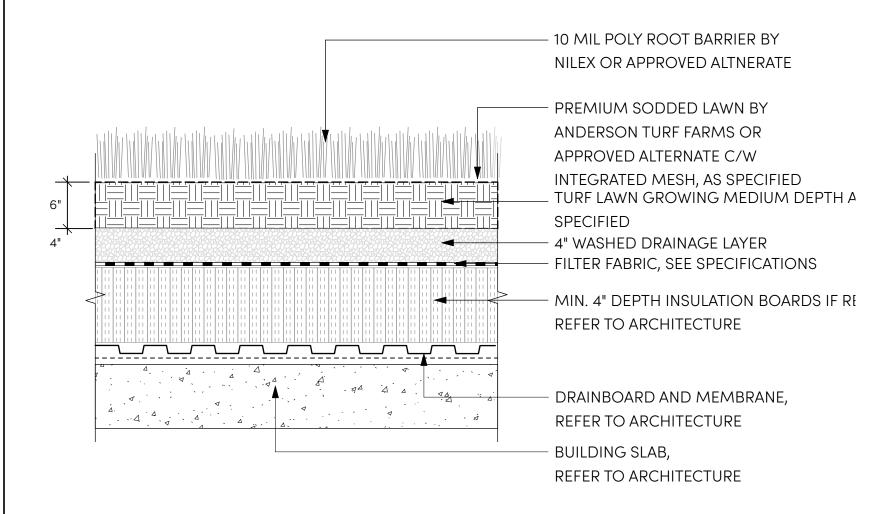

SODDED LAWN ON SLAB, TYP.

Scale: 1" = 1'-0"

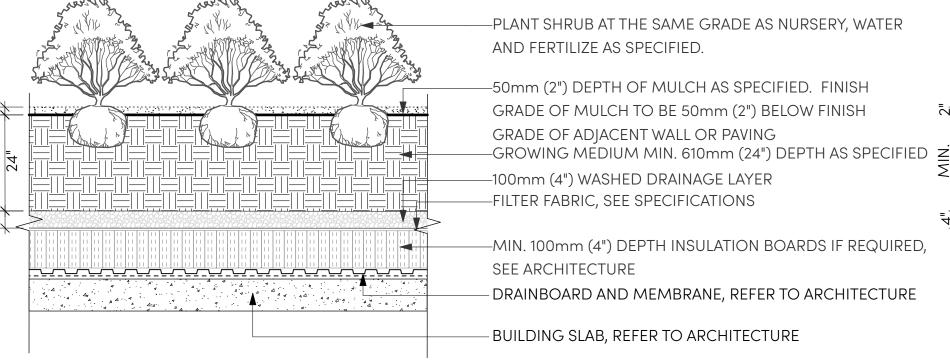


NOTES:

- 1. MIN. 610mm (24") PLANTING SOIL DEPTH + 50mm (2") MULCH DEPTH FOR SHRUBS ON SLAB.
- 2. FINISHED GRADE OF MULCH TO BE MIN. 25mm (1")
 BELOW ADJACENT PAVING, WALL OR STAIR.


TRANGULAR PLANTING ON SLAB, TYP.

Scale: 1/2" = 1'-0"

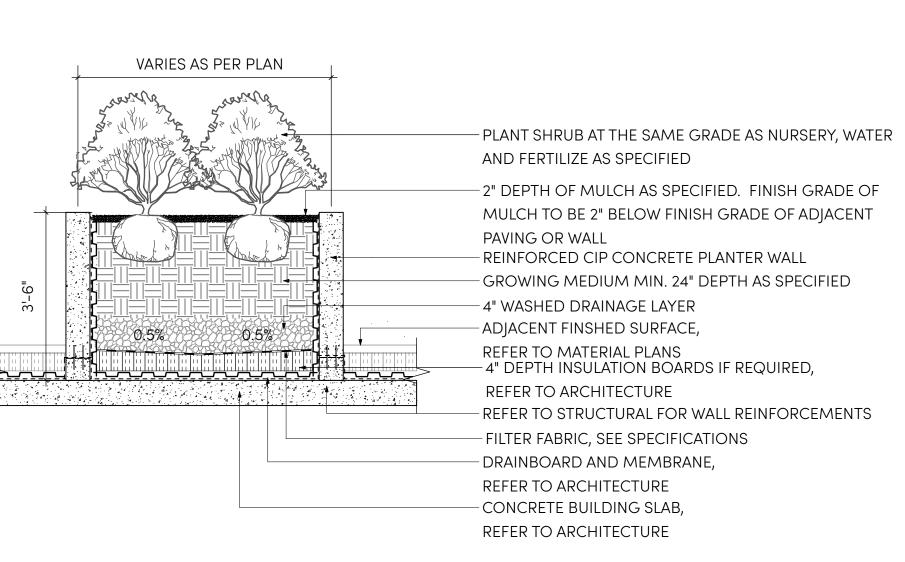

RAISED CONCRETE PLANTER ON SLAB (42" PLANTER DEPTH), TYP.

Scale: 1/2" = 1'-0"

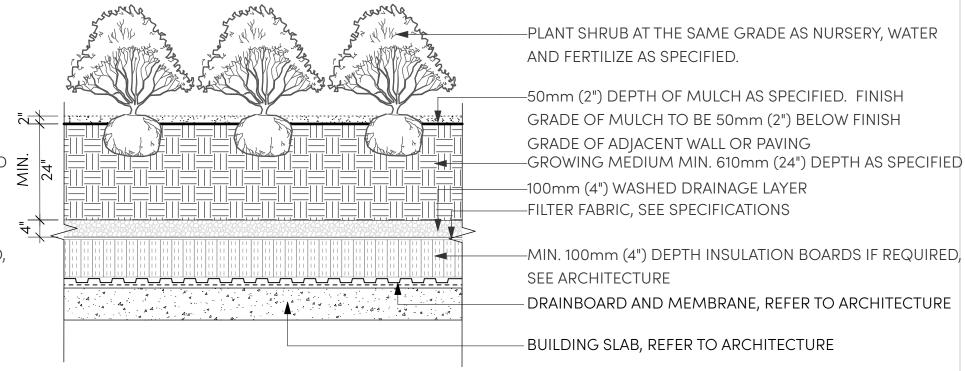


NOTES:

- MIN. 610mm (24") PLANTING SOIL DEPTH + 50mm (2")
 MULCH DEPTH FOR SHRUBS ON SLAB.
- 2. FINISHED GRADE OF MULCH TO BE MIN. 25mm (1")
 BELOW ADJACENT PAVING, WALL OR STAIR.

RECTILINEAR PLANTING ON SLAB, TYP.

Scale: 1/2" = 1'-0"

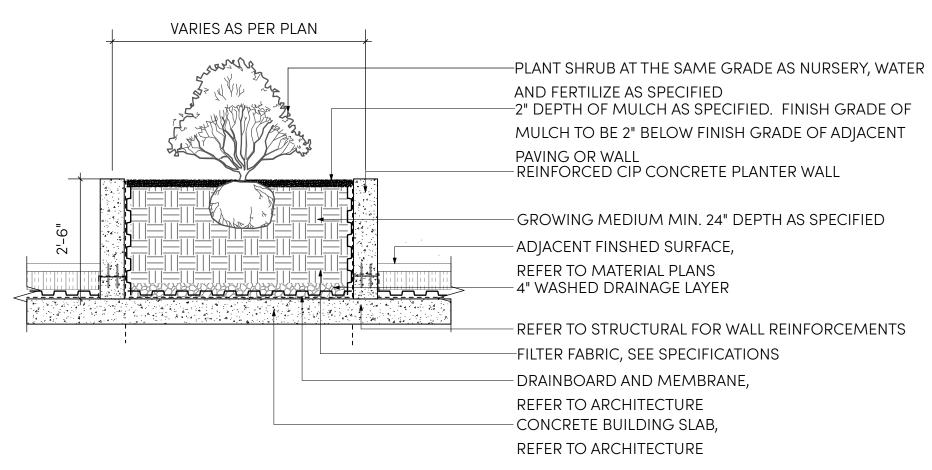

RAISED CONCRETE PLANTER ON SLAB (30" PLANTER DEPTH), TYP.

Scale: 1/2" = 1'-0"

LANDSCAPE ARCHITECTURE + URBAN DESIGN

1738 KINGSWAY, VANCOUVER, BC V5N 2S3 www.locidesign.ca // 604.694.0053

ALL RIGHTS RESERVED.

PROPERTY OF LOCI LANDSCAPE ARCHITECTUR
AND URBAN DESIGN. USE OR REPRODUCTION

PROHIBITED WITH PRIOR WRITTEN CONSENT.

IBI

Peterson

Project Stamp



legue

No. Description Date
F Issued for Development Permit 21-05-30
G Re-Issued for Development 21-12-23
Permit

22-02-03

H Issued for TRS Response

Project Info

20168

Dilworth Center

Mixed Use 2339 Highway 97N Kelowna, BC

Project Team

Client Peterson

Architect IBI Group

Landscape Architect

LOCI Landscape Architecture + Urban Design


Drawn By Checked By

ID MF


PH 2 - SOFTSCAPE DETAIL

- ON SLAB PLANTING

L5.8

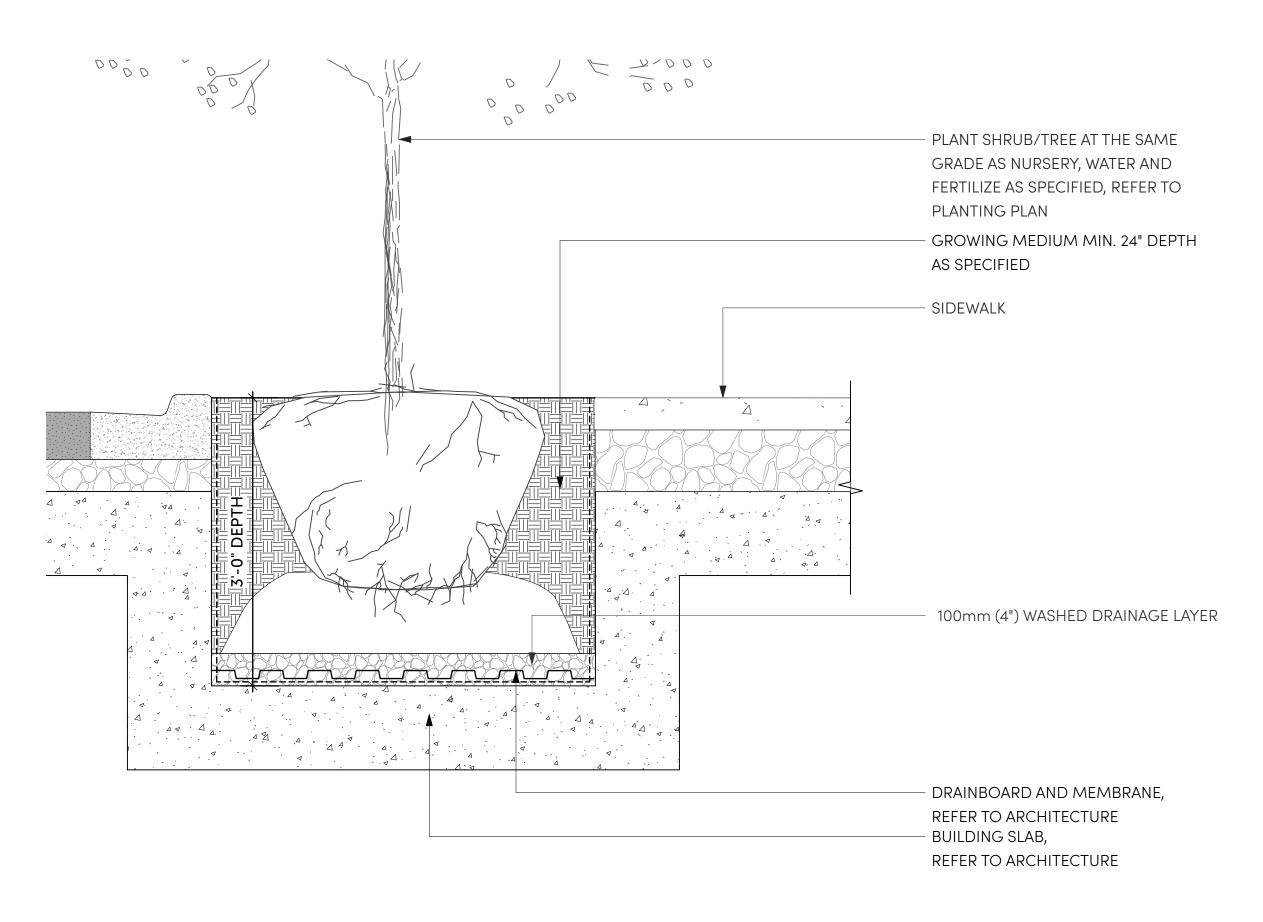

1 Scale: 1" = 1'-0"

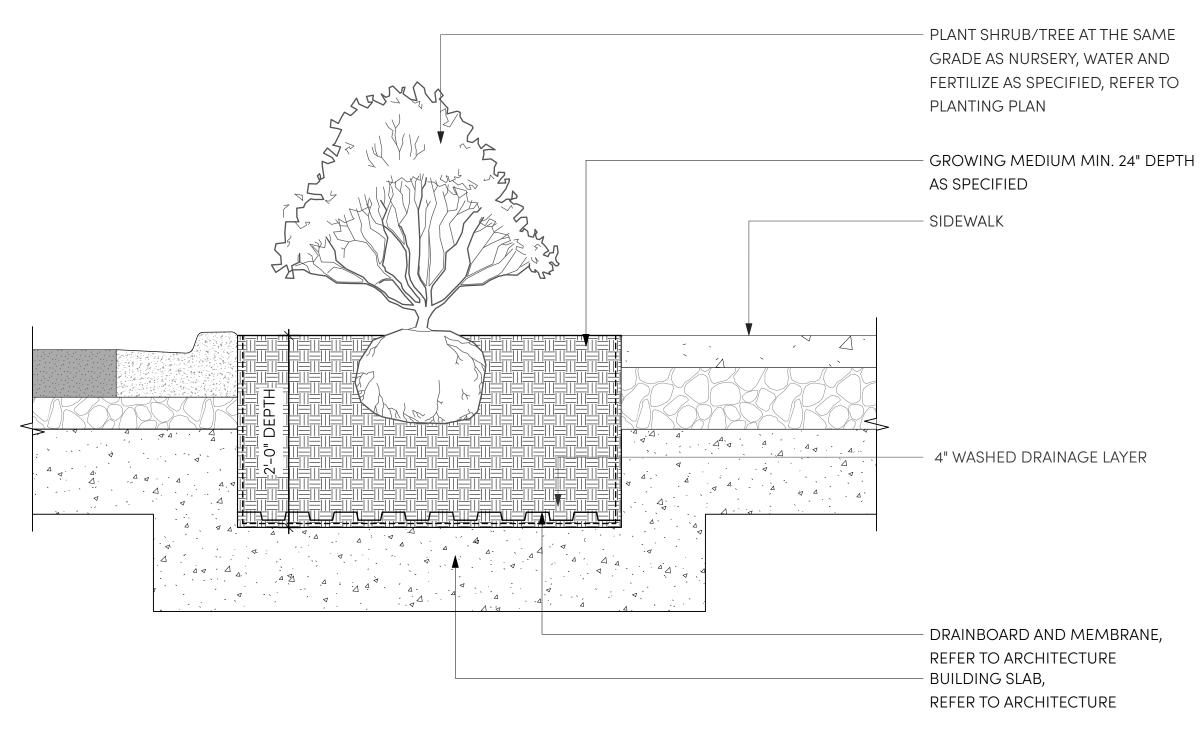

INSET PLANTER (24" DEPTH) ON SLAB, TYP.

Scale: 1" = 1'-0"



1738 KINGSWAY, VANCOUVER, BC V5N 2S3 www.locidesign.ca // 604.694.0053

ALL RIGHTS RESERVED.

PROPERTY OF LOCI LANDSCAPE ARCHITECTURE

AND URBAN DESIGN. USE OR REPRODUCTION

PROHIBITED WITH PRIOR WRITTEN CONSENT.



Peterson

Project Stamp



Issue

No. Description

F Issued for Development Permit 21-05-30

G Re-Issued for Development 21-12-23
Permit

H Issued for TRS Response 22-02-03

Project Info

20168

Dilworth Center
Mixed Use
2339 Highway 97N

Kelowna, BC

Project Team

Peterson

Client

Architect IBI Group

Landscape Architect

LOCI Landscape Architecture + Urban Design

Drawn By Checked By

PH 2 - SOFTSCAPE DETAIL

- ON SLAB PLANTING

L5.9

		HYDROZONE W	ATER BUDGE	T WORKSHEET		
Project Address: 2339 High	nway 97N (Phase 2)					
Project Location: Kelowna,	ВС					
Evapotranspiration (ETo)	39.37	in/year	1000mm/yr	City of Kelowna		
Effective Precipitation (EP)	27.818	in/year	EP = (ET(o) - 2)	28)×0.75		
WATER BUDGET						
WB = (ETo - EP) x (0.62) x	[(0.55 x LA)+((1-0.55) x S	SLA)]		Conversion Factor	(CF) - Acre Inch to Gallon	0.62
			,	I		
Total Irrigated Landscape			I			
	Planting Area + Other		17026.53	_		
	Special Landscape Ar	ea (SLA)	C			
	TOTAL (sq.ft.)		17026.53			
WB (Gal/yr) =	67074.355					
	LICE					
ESTIMATED TOTAL WATER		1				
$ETWU = (ETo - EP) \times (0.62)$	X [((PF X HA) / 1E)+ SLA					
Plant Water Use Type			Plant Factor	Irrigation Type		Irrigation Efficiency (IE)
Low			0.3	Low Efficiency (Spray or Rotor)		0.7
Medium			0.5	High Efficiency (D	·	0.9
High			0.7	,		
Other: Lawn Area / Swimr	ning Pool		1			
Hydrozone	Planting WU Type (PF)	Irrigation Efficiency (IE)	Area (HA)	PF	IE	ETWU (gal/y
	1 Low	High	14436	0.3	0.9	34466.1
	Low	Low	C	0.3	0.7	
3	Moderate Moderate	High	811	0.5	0.9	3227.12
	Moderate	Low	C	0.5	0.7	
	High	High	C	0.7	0.9	
6	High	Low	С	0.7	0.7	
	Watered Mown Lawn	Low	939	1	0.7	9608.04
	Swimming Pool		840.53		1	6020.33
	·	1	1	1	1	



1738 KINGSWAY, VANCOUVER, BC V5N 2S3 www.locidesign.ca // 604.694.0053

ALL RIGHTS RESERVED.

PROPERTY OF LOCI LANDSCAPE ARCHITECTURE

AND URBAN DESIGN. USE OR REPRODUCTION

PROHIBITED WITH PRIOR WRITTEN CONSENT.



Peterson

Project Stami



leeu

No.	Description	De
F	Issued for Development Permit	21-05-
G	Re-Issued for Development Permit	21-12-

22-02-03

H Issued for TRS Response

Project Info

20168

Dilworth Center Mixed Use 2339 Highway 97N

Kelowna, BC

Project Team

Client

Peterson

Architect

IBI Group

Landscape Architect

LOCI Landscape Architecture + Urban Design

Drawn By

Checked By

PH 2 - APPENDIX A -HYDROZONE

CALCULATIONS

L6.C