GENERAL NOTES: GENERAL ALL DIMENSIONS ARE MADE FROM EXTERIOR FACE OF WALL SHEATHING TO CENTER OF PARTY WALLS AND INTERIOR WALLS UNLESS NOTED OTHERWISE ON PLANS. OUTSIDE EDGE OF EXTERIOR WALL SHEATHING TO BE FLUSH WITH FOUNDATION WALL BELOW. DO NOT SCALE DRAWINGS. THE GENERAL CONTRACTOR IS TO CHECK ALL DIMENSIONS AND CONFIRM ALL PROPERTY LINE BEARINGS AND DIMENSIONS WITH LEGAL SURVEY. IN THE CASE OF DISCREPANCY, THE ARCHITECT IS TO BE NOTIFIED BEFORE WORK CAN COMMENCE. COMMENCEMENT OF CONSTRUCTION SHALL CONSTITUTE ACCEPTANCE OF CONDITIONS AS SATISFACTORY. REFER TO MECHANICAL DRAWINGS FOR FINAL PLUMBING AND HVAC LAYOUT AND SPECIFICATIONS. REFER TO LANDSCAPE DRAWINGS FOR FINAL LANDSCAPE LAYOUT. ASSURANCE / COMPLIANCE REQUIREMENTS THESE DRAWINGS. ALL CONSTRUCTION MATERIALS AND PROCEDURES SHALL CONFIRM TO THESE ALL WORK TO CONFORM TO LOCAL BYLAWS AND DEVELOPMENT PERMIT REQUIREMENTS. STRUCTURAL, MECHANICAL, ELECTRICAL, AND LANDSCAPE DRAWINGS AS APPLICABLE. ALL WORK WILL BE SUBJECT TO FIELD REVIEW BY THE ARCHITECT AND OR OTHER REGISTERED

MUNICIPAL LETTERS OF ASSURANCE / COMPLIANCE REQUIREMENTS.

PROFESSIONAL CONSULTANTS FIELD REVIEW REQUIREMENTS.

WORKERS COMPENSATION BOARD.

CONSTRUCTION OF THE PROJECT

INSPECTION SLIPS.

THE SUB-CONTRACTORS ARE RESPONSIBLE FOR SITE SAFETY AND TO MEET ALL REQUIREMENTS OF THE

ALL SUB-CONTRACTORS WILL BE REQUIRE TO ACKNOWLEDGE COMPLIANCE WITH ABOVE CONDITIONS BY

GENERAL CONTRACTOR IS TO KEEP RECORD AND PROVIDE ARCHITECT WITH COPIES OF MUNICIPAL

THE CONTRACTOR / CLIENT IS TO INFORM THE ARCHITECT IN WRITING 24 HOURS PRIOR TO STARTING

THE SUB-CONTRACTOR IS TO CHECK ALL DIMENSIONS AFFECTING HIS TRADE AND IN THE CASE OF

THE CONTRACTOR IS TO NOTIFY THE ARCHITECT 24 HOURS PRIOR TO A REQUIRED INSPECTION.

SIGNING A COPY OF THESE REQUIREMENTS WHICH MUCH ACCOMPANY THEIR QUOTATION.

DISCREPANCY THE CONTRACTOR IS TO BE NOTIFIED BEFORE WORK CAN COMMENCE.

LOCATION OF SECTION DRAWING **DETAIL** REFER TO ELECTRICAL DRAWINGS FOR FINAL LIGHT, OUTLETS AND ELECTRICAL PANEL LOCATIONS AND REFER TO CIVIL DRAWINGS FOR OFFSITE CONSTRUCTION AND FINAL. SITE DRAINAGE LAYOUT AND SPEC. - DETAIL NUMBER LOCATION OF DETAIL DRAWING REFER TO STRUCTURAL DRAWINGS FOR FINAL WALL/FLOOR/ROOF/COLUMN LAYOUT AND SPECIFICATIONS. DETAIL NUMBER THE CURRENT BCBC 2018, IT'S REQUIREMENTS AND ALL AGENDA, SHALL FORM AN INTEGRAL PART OF SCALE: 1/8" = 1'-0" ALL DRAWINGS ARE TO BE READ AS A COMPLETE SET IN CONJUNCTION WITH SPECIFICATIONS AND CIVIL, LOCATION OF DETAIL DRAWING

- LOCATION OF FIRST OCCURANCE PROFESSIONAL AND BY THE CONSULTING ENGINEERS NAMED ON THESE DRAWINGS TO MEET THE ALL WORK MUST MEET THE APPROVAL OF THE PROFESSIONAL CONSULTANTS. Door Tags ALL WORK MUST MEET THE STANDARDS OF THE BC TRADE ASSOCIATIONS GOVERNING EACH TRADE 0' - 0" x 0' - 0" DOOR SIZE STARTING WORK ON THIS PROJECT BY ANY SUB-CONTRACTOR MEANS THAT THE ABOVE REQUIREMENTS HAVE BEEN REVIEWED AND NO EXTRA CLAIM FOR COST WILL BE PUT FORWARD TO MEET THE Window Tags

> SEE WINDOW DETAILS **Assembly Tags** ASSEMBLY TYPE -SEE CONSTRUCTION SCHEDULE

WINDOW TYPE -

SYMBOL LEGEND:

BUILDING SECTION

LOCATION OF SECTION DRAWING

SECTION NUMBER

WALL SECTION

SECTION NUMBER

GRADE ELEVATION: BUILDING HEIGHT: 3 STOREY **FACING NO. OF STREETS:** 2 STREETS **SPRINKLERS:** NONSPRINKLERED BASIC CODE CLASSIFICATION: 3.2.2.53 GROUP C, UP TO 3 STORIES, NONSPRINKLERED 3 STOREYS - MAX. AREA 750m² IF 3 STOREYS COMBUSTIBLE OR NON-COMBUSTIBLE - FLOORS, MEZZANINES, AND LOADBEARING: (45 MIN. FRR) FIRE ALARM REQUIRED: 3.2.4.1 **CENTRAL MONITORING: 3.2.4.7.(4)** STANDPIPE REQUIRED: **HIGH RISE BUILDING: SMOKE CONTROL MEASURES: EMERGENCY GENERATOR REQUIRED: EMERGENCY POWER SUPPLY DURATION:** 1/2 Hrs **EMERGENCY LIGHTING: 3.2.7.3** YES **EXIT SIGNS REQUIRED: 3.4.5.1** FIRE PUMPS REQUIRED: MINOR RELAXATION/EQUIVALENCIES REQUIRED: MINOR RELAXATION/EQUIVALENCIES ACCEPTED: N/A **INTERCONNECTED FLOOR SPACE: 3.2.8.2.(6)** BCBC 2018 3.4.2.5. MAX. TRAVEL DISTANCE 30m EXISTING ZONING = RU6 16 UNITS x 1.25 STALLS = 20 STALLS PROPOSED ZONING = RM3r 2 UNITS x 1.50 STALLS = 3 STALLS 18 UNITS x 0.14 = 3 VISITOR STALLS

PART 3

346.18m

CODE ANALYSIS / ZONING:

B.C. BUILDING CODE (2018) ANALYSIS

MAJOR OCCUPANCY CLASSIFICATION:

GOVERNING CODE PART:

SITE AREA = 1,299.1m² - 10% STALLS (RENTAL) - 5 STALLS (BONUS-BIKE PARKING) F.A.R. = 0.75TOTAL = 18 STALLS PARKING BONUS F.A.R. = 0.05 TOTAL = $0.80 \times 1,299.1 \text{m}^2$ **BIKE PARKING** $= 1,039.2m^2 (11,185.9ft^2)$ REQ'D SHORT-TERM = 6 STALLS PROVIDED = 6 STALLS PROPOSED = 1,021.0m² (10,990.0ft²) REQ'D BONUS LONG-TERM = 20 STALLS PROVIDED = 24 STALLS BUILDING SITE COVERAGE = 49% (ALLOWABLE = 50% w/ AMENITY BONUS)

TOTAL REQUIRED = 319m² MAX. HEIGHT = 10m OR 3 STOREYS TOTAL PROVIDED = 371m² ACTUAL HEIGHT = 10m AND 3 STOREYS OVERALL SITE COVERAGE = 58%

SETBACKS FRONT = 4.5m; SIDE = 4.0m; REAR = 3.0m (ALLOWABLE = 60%) **ILLUSTRATION:**



DRAWING INDEX: **CONSULTANTS:**

ARCHITECTURAL NOVATION ARCHITECTURE LTD. 302-2237 LECKIE ROAD KELOWNA, BC V1X 6Y5 TEL. (236) 420-4144 CWMM CONSULTING ENGINEERS LTD. 1854 KIRSCHNER ROAD KELOWNA, BC V1Y 4N6 TEL. (250) 868-2308 **MECHANICAL FALCON ENGINEERING LTD** 210-1715 DICKSON AVENUE KELOWNA, BC V1Y 9G6

ELECTRICAL SPARQ INDUSTRIES & AUTOMATION 2960 OKANAGAN AVENUE EAST #150 SALMON ARM, BC V1E 1T6 TEL. (250) 681-0179

TEL. (250) 762-9993

BUILDING ENVELOPE LANDMARK 6, 700-1631 DICKSON AVE KELOWNA, BC V1Y 0B5 TEL. (250) 980-5500

ENERGY MODELLING REINBOLD ENGINEERING GROUP 301-1664 RICHTER STREET KELOWNA, BC V1Y 8N3 (250) 763-1049

GEOTECHNICAL INTERIOR TESTING SERVICES LTD. 1965 MOSS COURT UNIT 1 KELOWNA, BC V1Y 9L3 (250) 860-6540

APLIN & MARTIN CONSULTANTS LTD. 1258 ELLIS STREET KELONWA, BC V1Y 1Z4 TEL. (250) 448-0157

ECORA ENGINEERING & RESOURCE GROUP LTD. 2045 ENTERPRISE WAY KELOWNA, BC V1Y 9T5

TEL. (250) 469-9757

ARCHITECTURAL DRAWING LIST

NAME A0.00 **COVER SHEET** A1.00 SITE PLAN A2.00 **FOUNDATION PLAN** A2.01 MAIN FLOOR PLAN A2.02 SECOND FLOOR PLAN A2.03 THIRD FLOOR PLAN A2.04 **ROOF PLAN** A3.00 **EXTERIOR ELEVATIONS** A3.01 **EXTERIOR ELEVATIONS** A3.02 **EXTERIOR ELEVATIONS** A4.00 **BUILDING SECTIONS** A5.00 DOOR & WINDOW SCHEDULE



CONTEXT SITE PLAN:





© Copyright Reserved. This drawing and design is, and at all

302 - 2237 LECKIE ROAD KELOWNA BC V1X 6Y5

ISSUED FOR REVIEW

REVISIONS

20210816

20210430

DATE

RE-ISSUED FOR DEVELOPMENT

DESCRIPTION

ISSUED FOR DEVELOPMENT

RICHTER COMMONS

875 RICHTER STREET, KELOWNA, BRITISH COLUMBIA, V1Y 2N1 PLAN KAP4495 LOT B DISTRICT LOT 138


COVER SHEET

ect no. 2128


Project File Name and Location: BIM 360://1875 Richter Street/1875 Richter Street.rvt

1" = 1'-0"


2022-03-01 12:39:35 PM

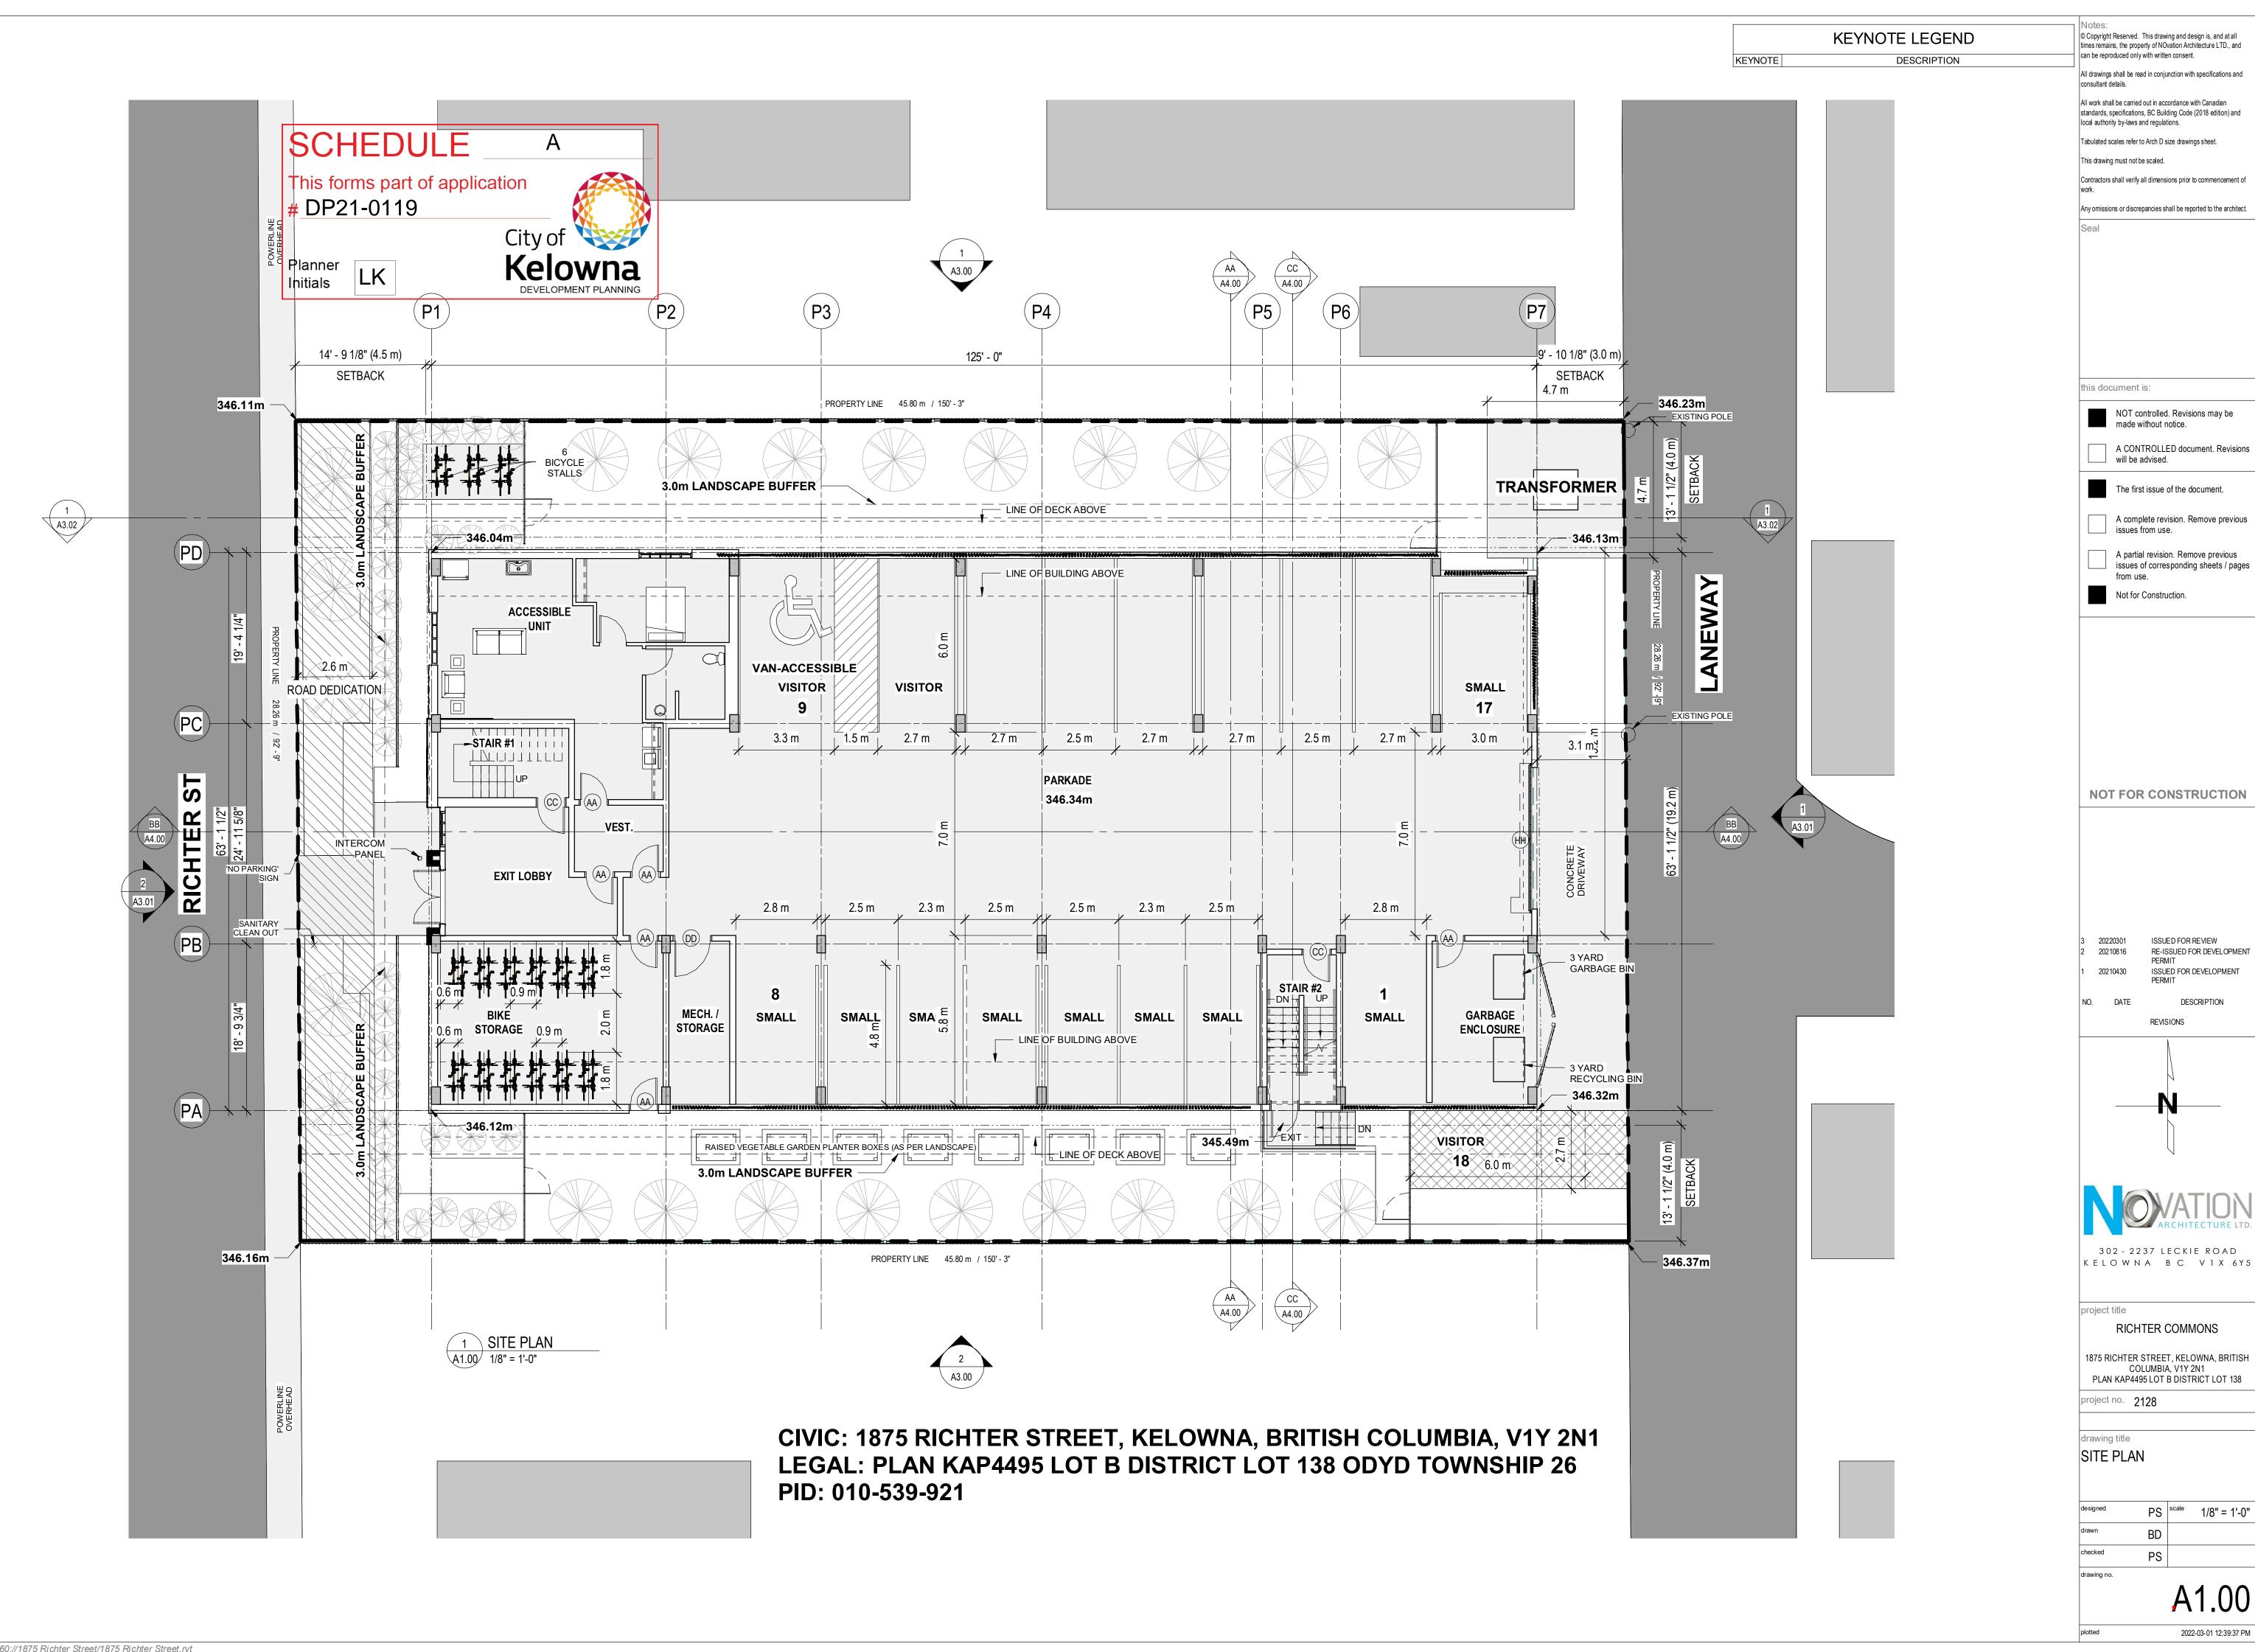

Project File Name and Location: BIM 360://1875 Richter Street/1875 Richter Street.rvt

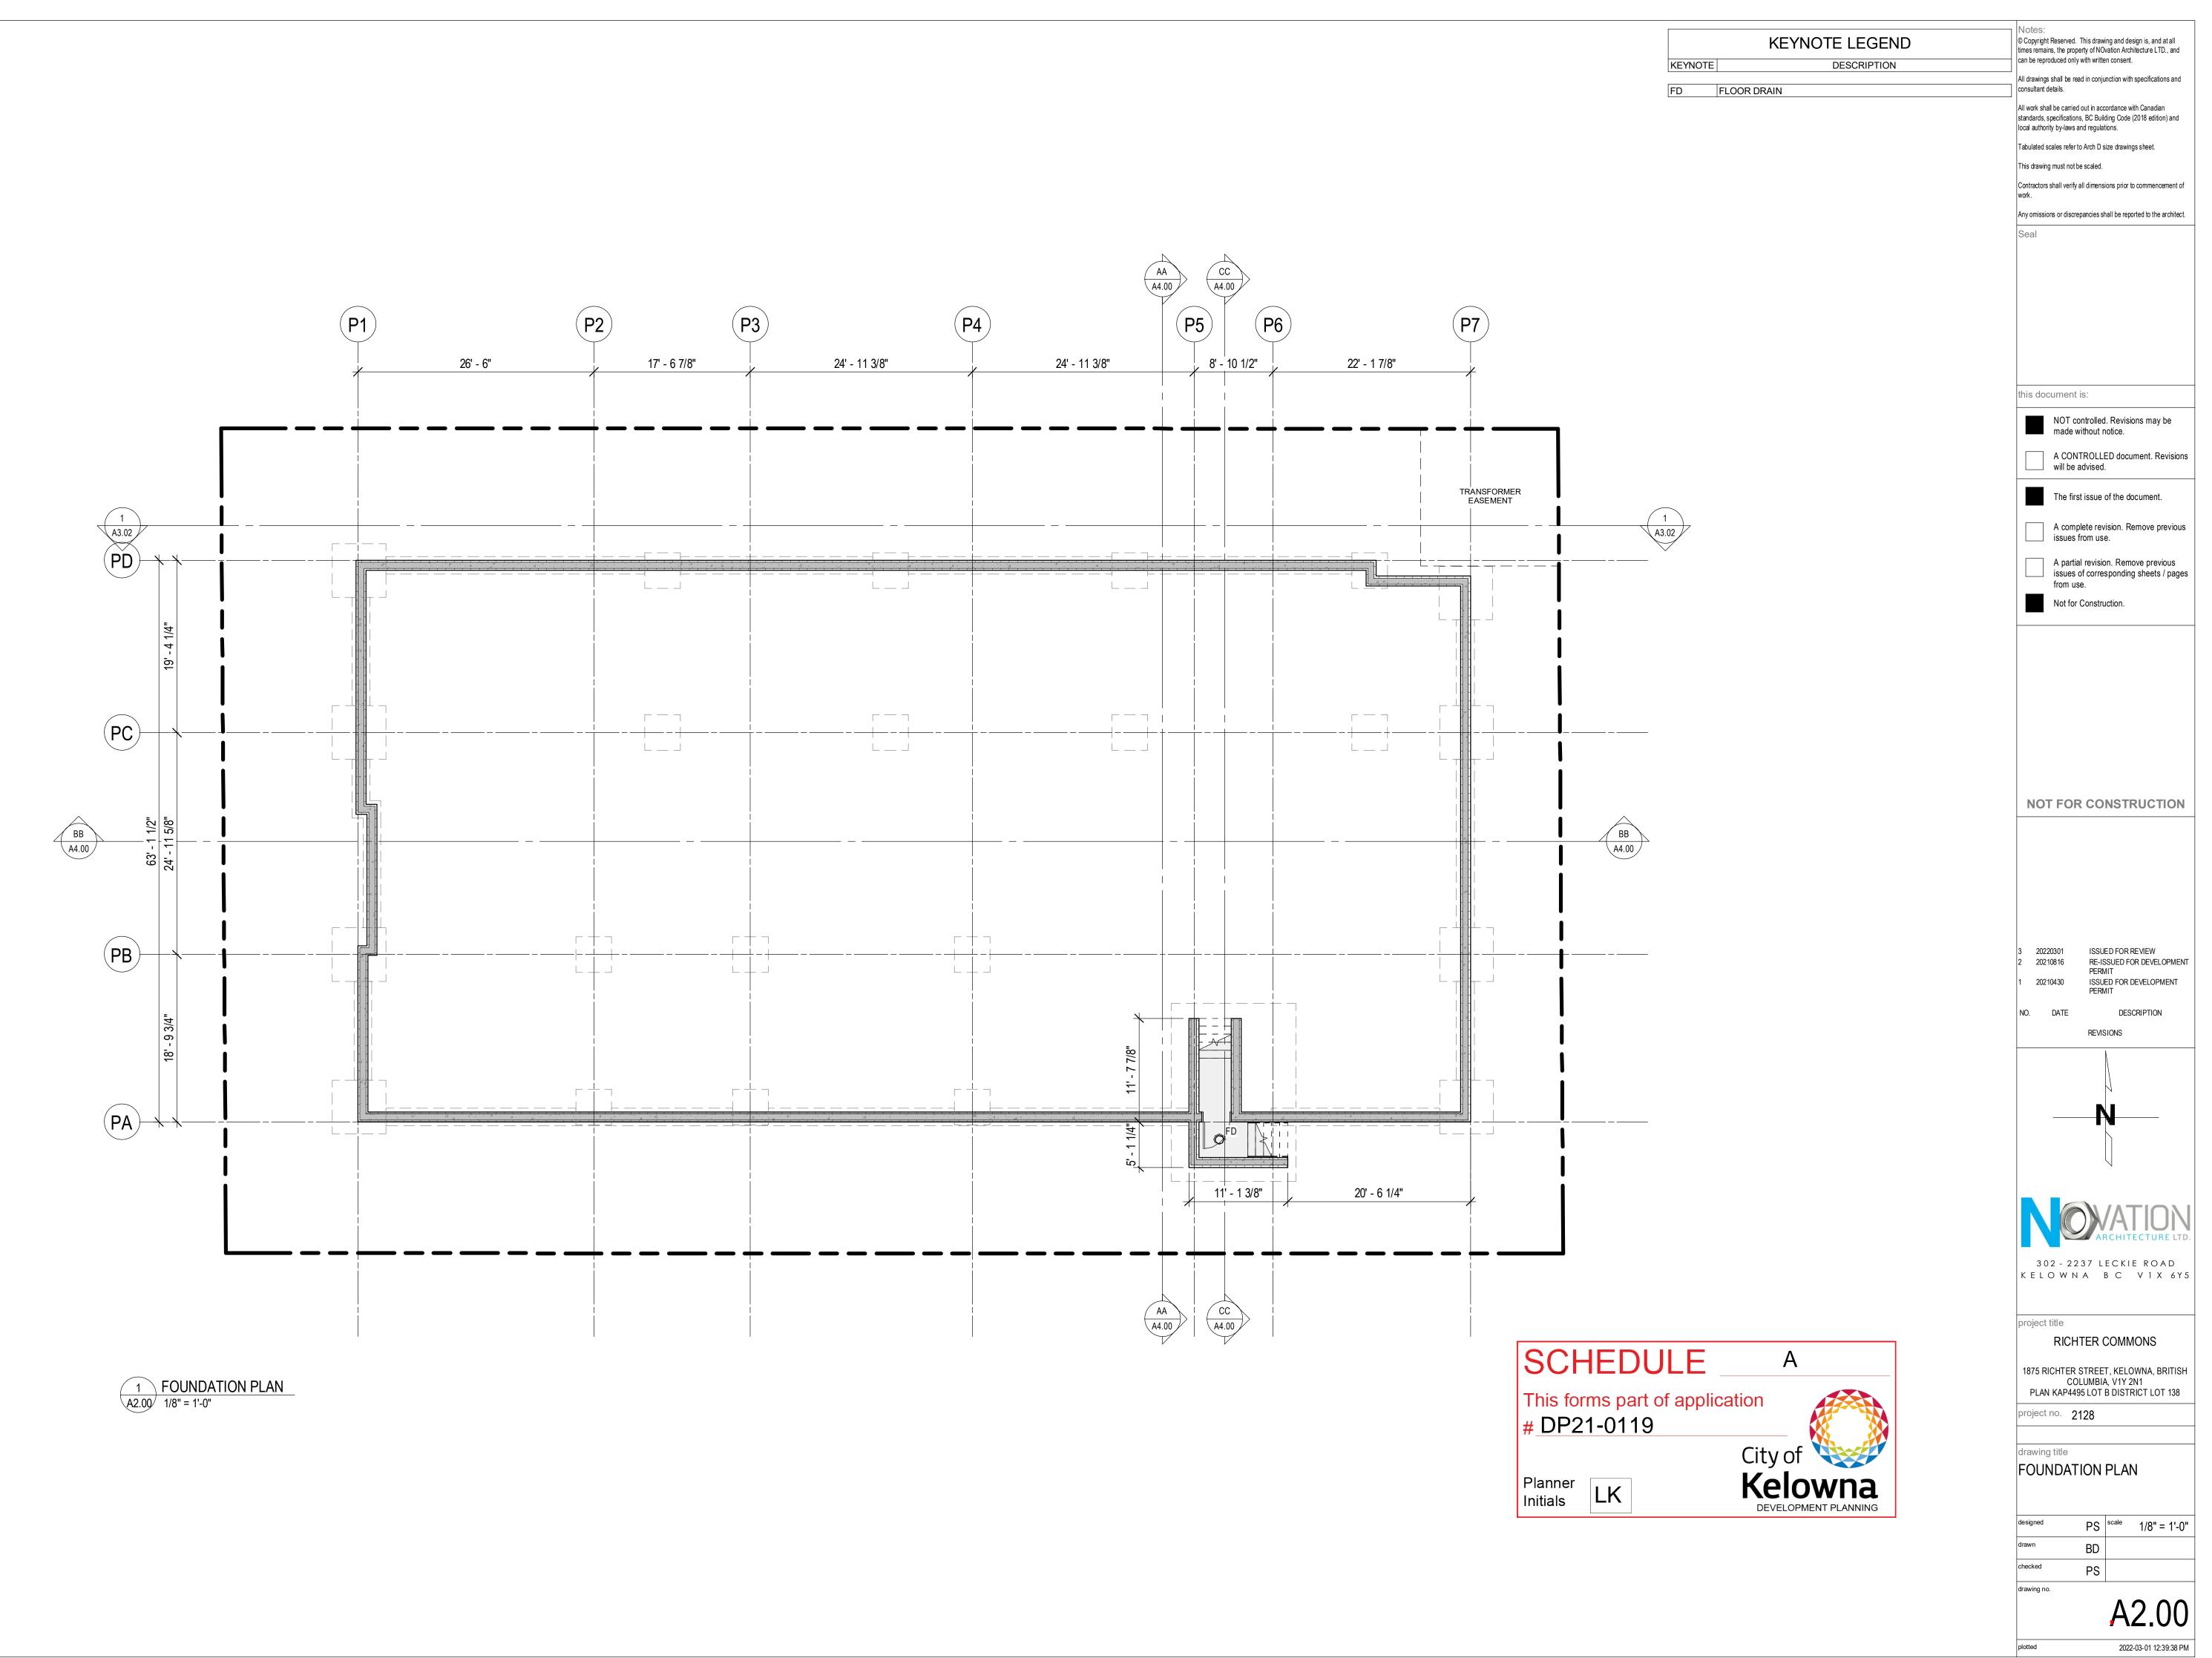

Project File Name and Location: BIM 360://1875 Richter Street/1875 Richter Street.rvt

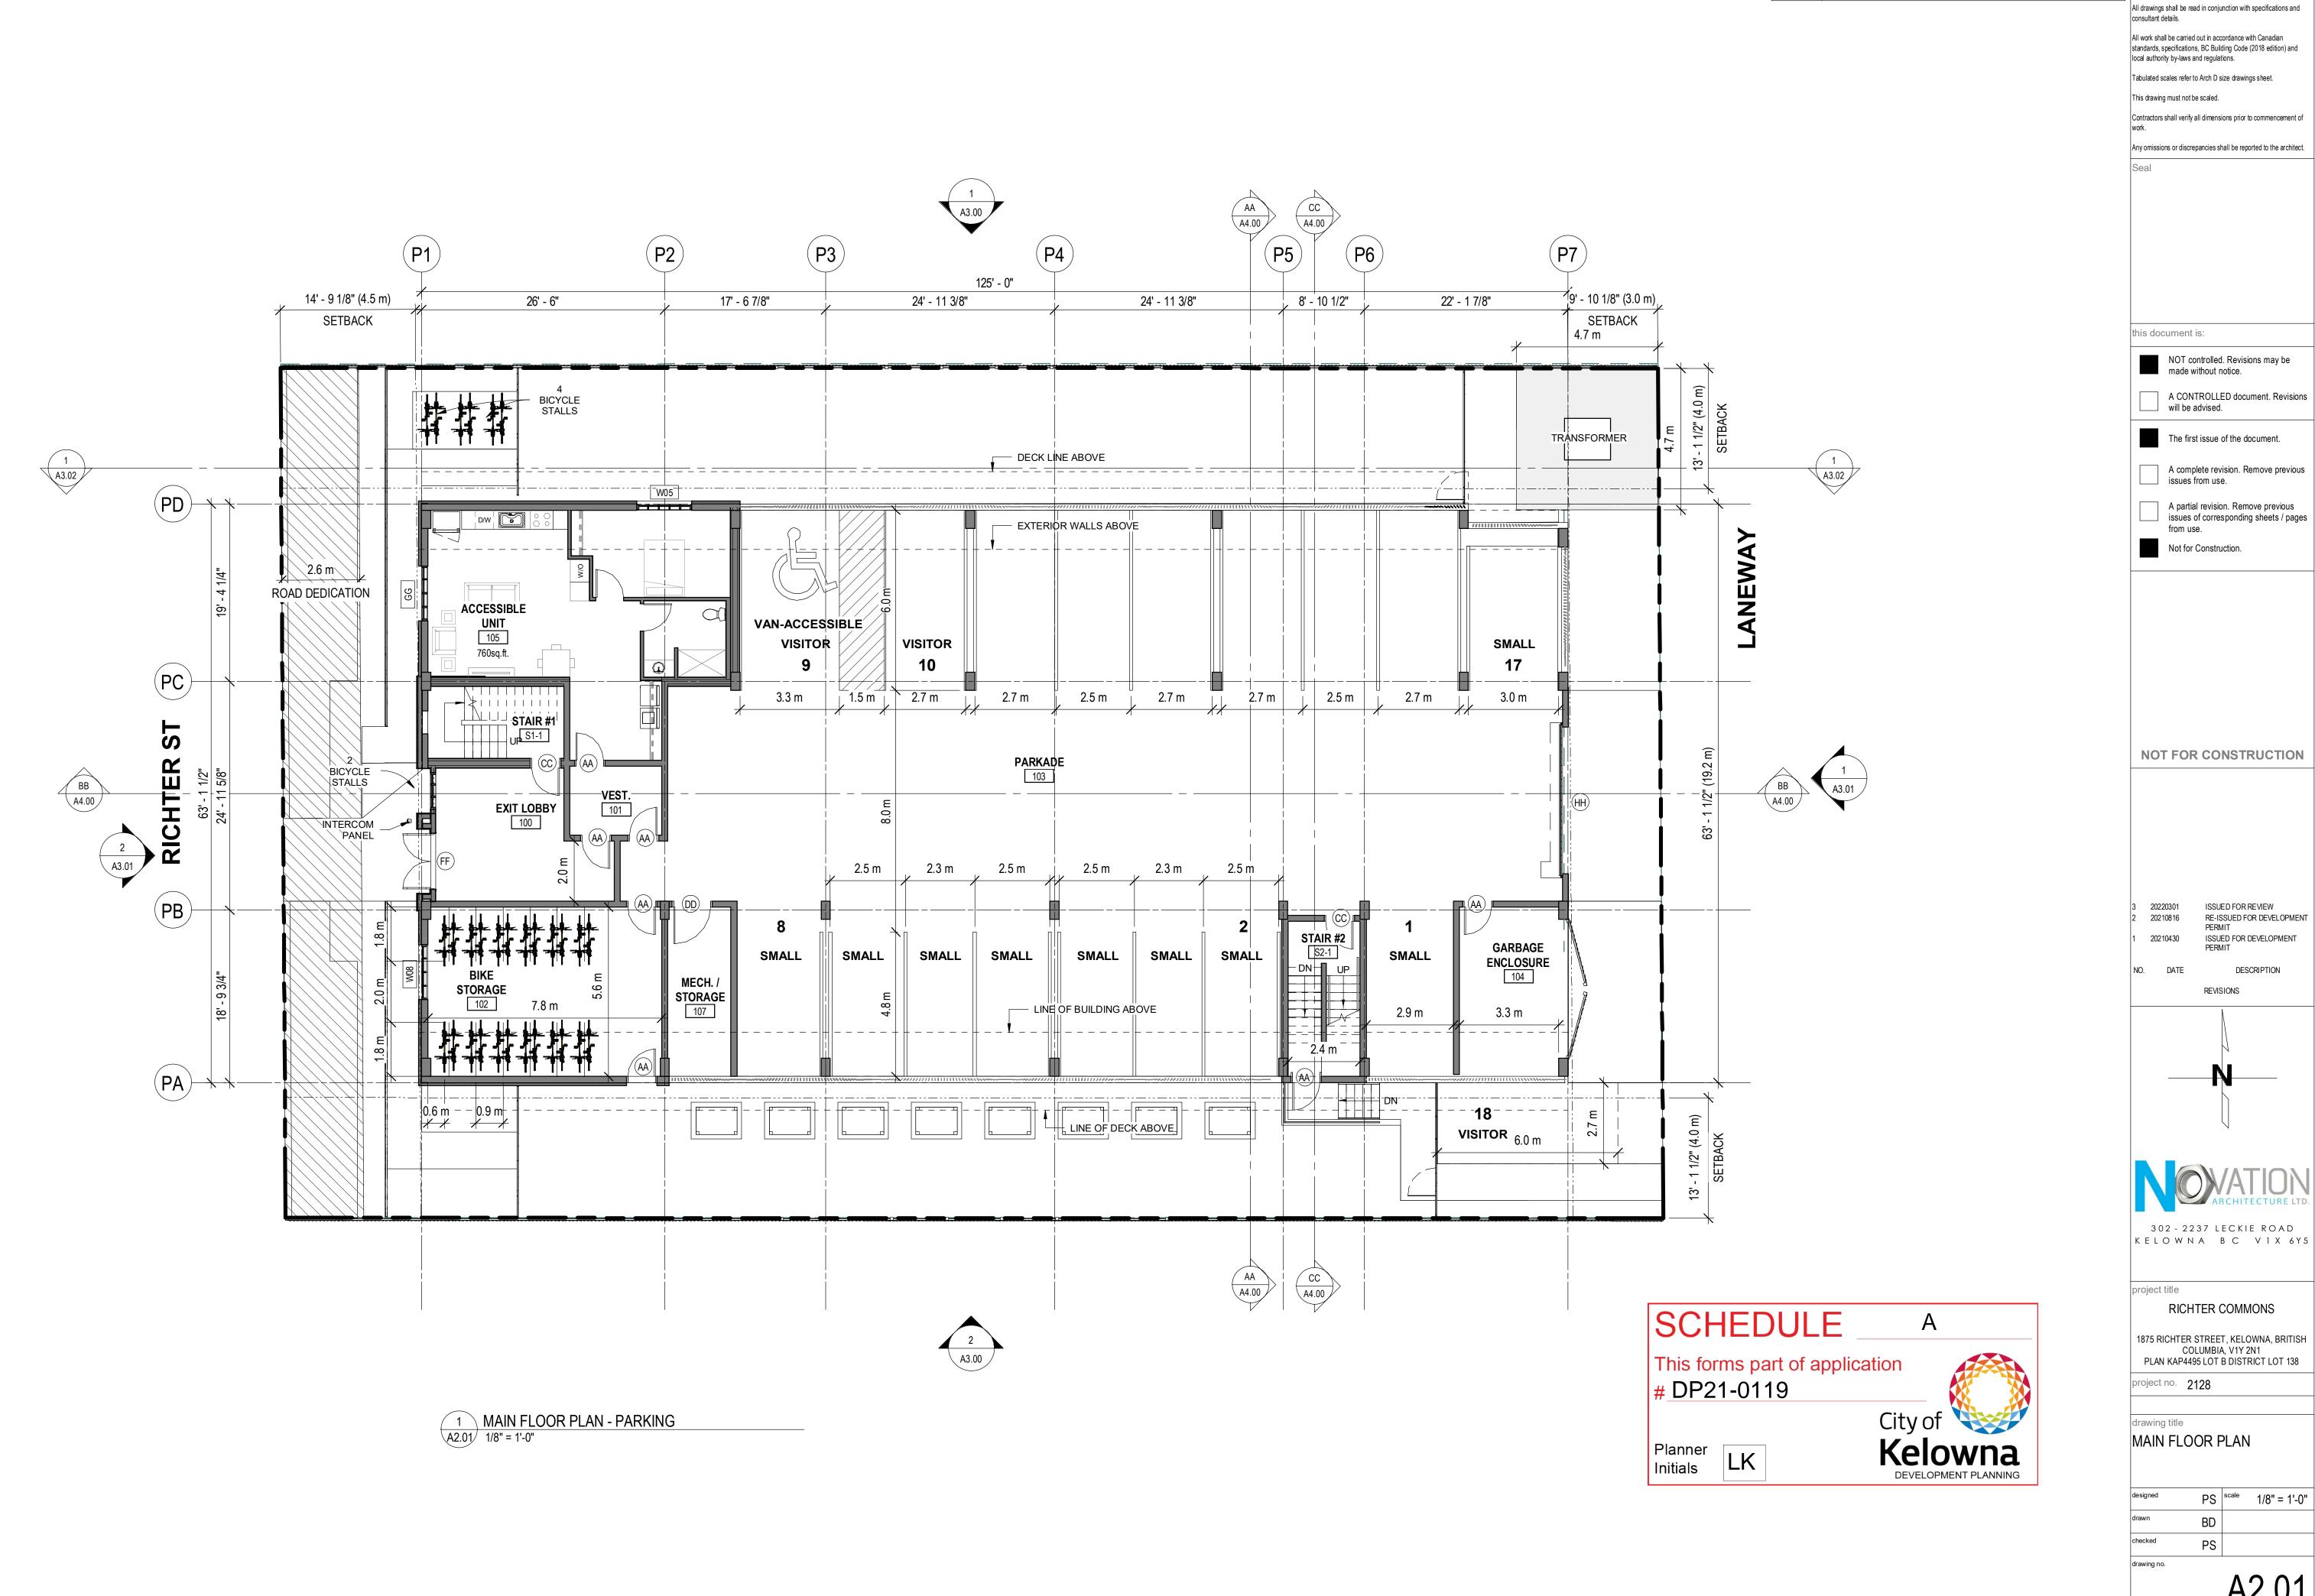

© Copyright Reserved. This drawing and design is, and at all times remains, the property of NOvation Architecture LTD., and

KEYNOTE LEGEND

KEYNOTE

DESCRIPTION

can be reproduced only with written consent.

All drawings shall be read in conjunction with specifications and


standards, specifications, BC Building Code (2018 edition) and

Any omissions or discrepancies shall be reported to the architect.

A CONTROLLED document. Revisions

RE-ISSUED FOR DEVELOPMENT


DESCRIPTION

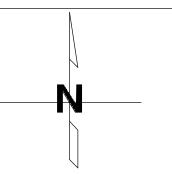

1875 RICHTER STREET, KELOWNA, BRITISH COLUMBIA, V1Y 2N1

A2.01

2022-03-01 12:39:39 PM

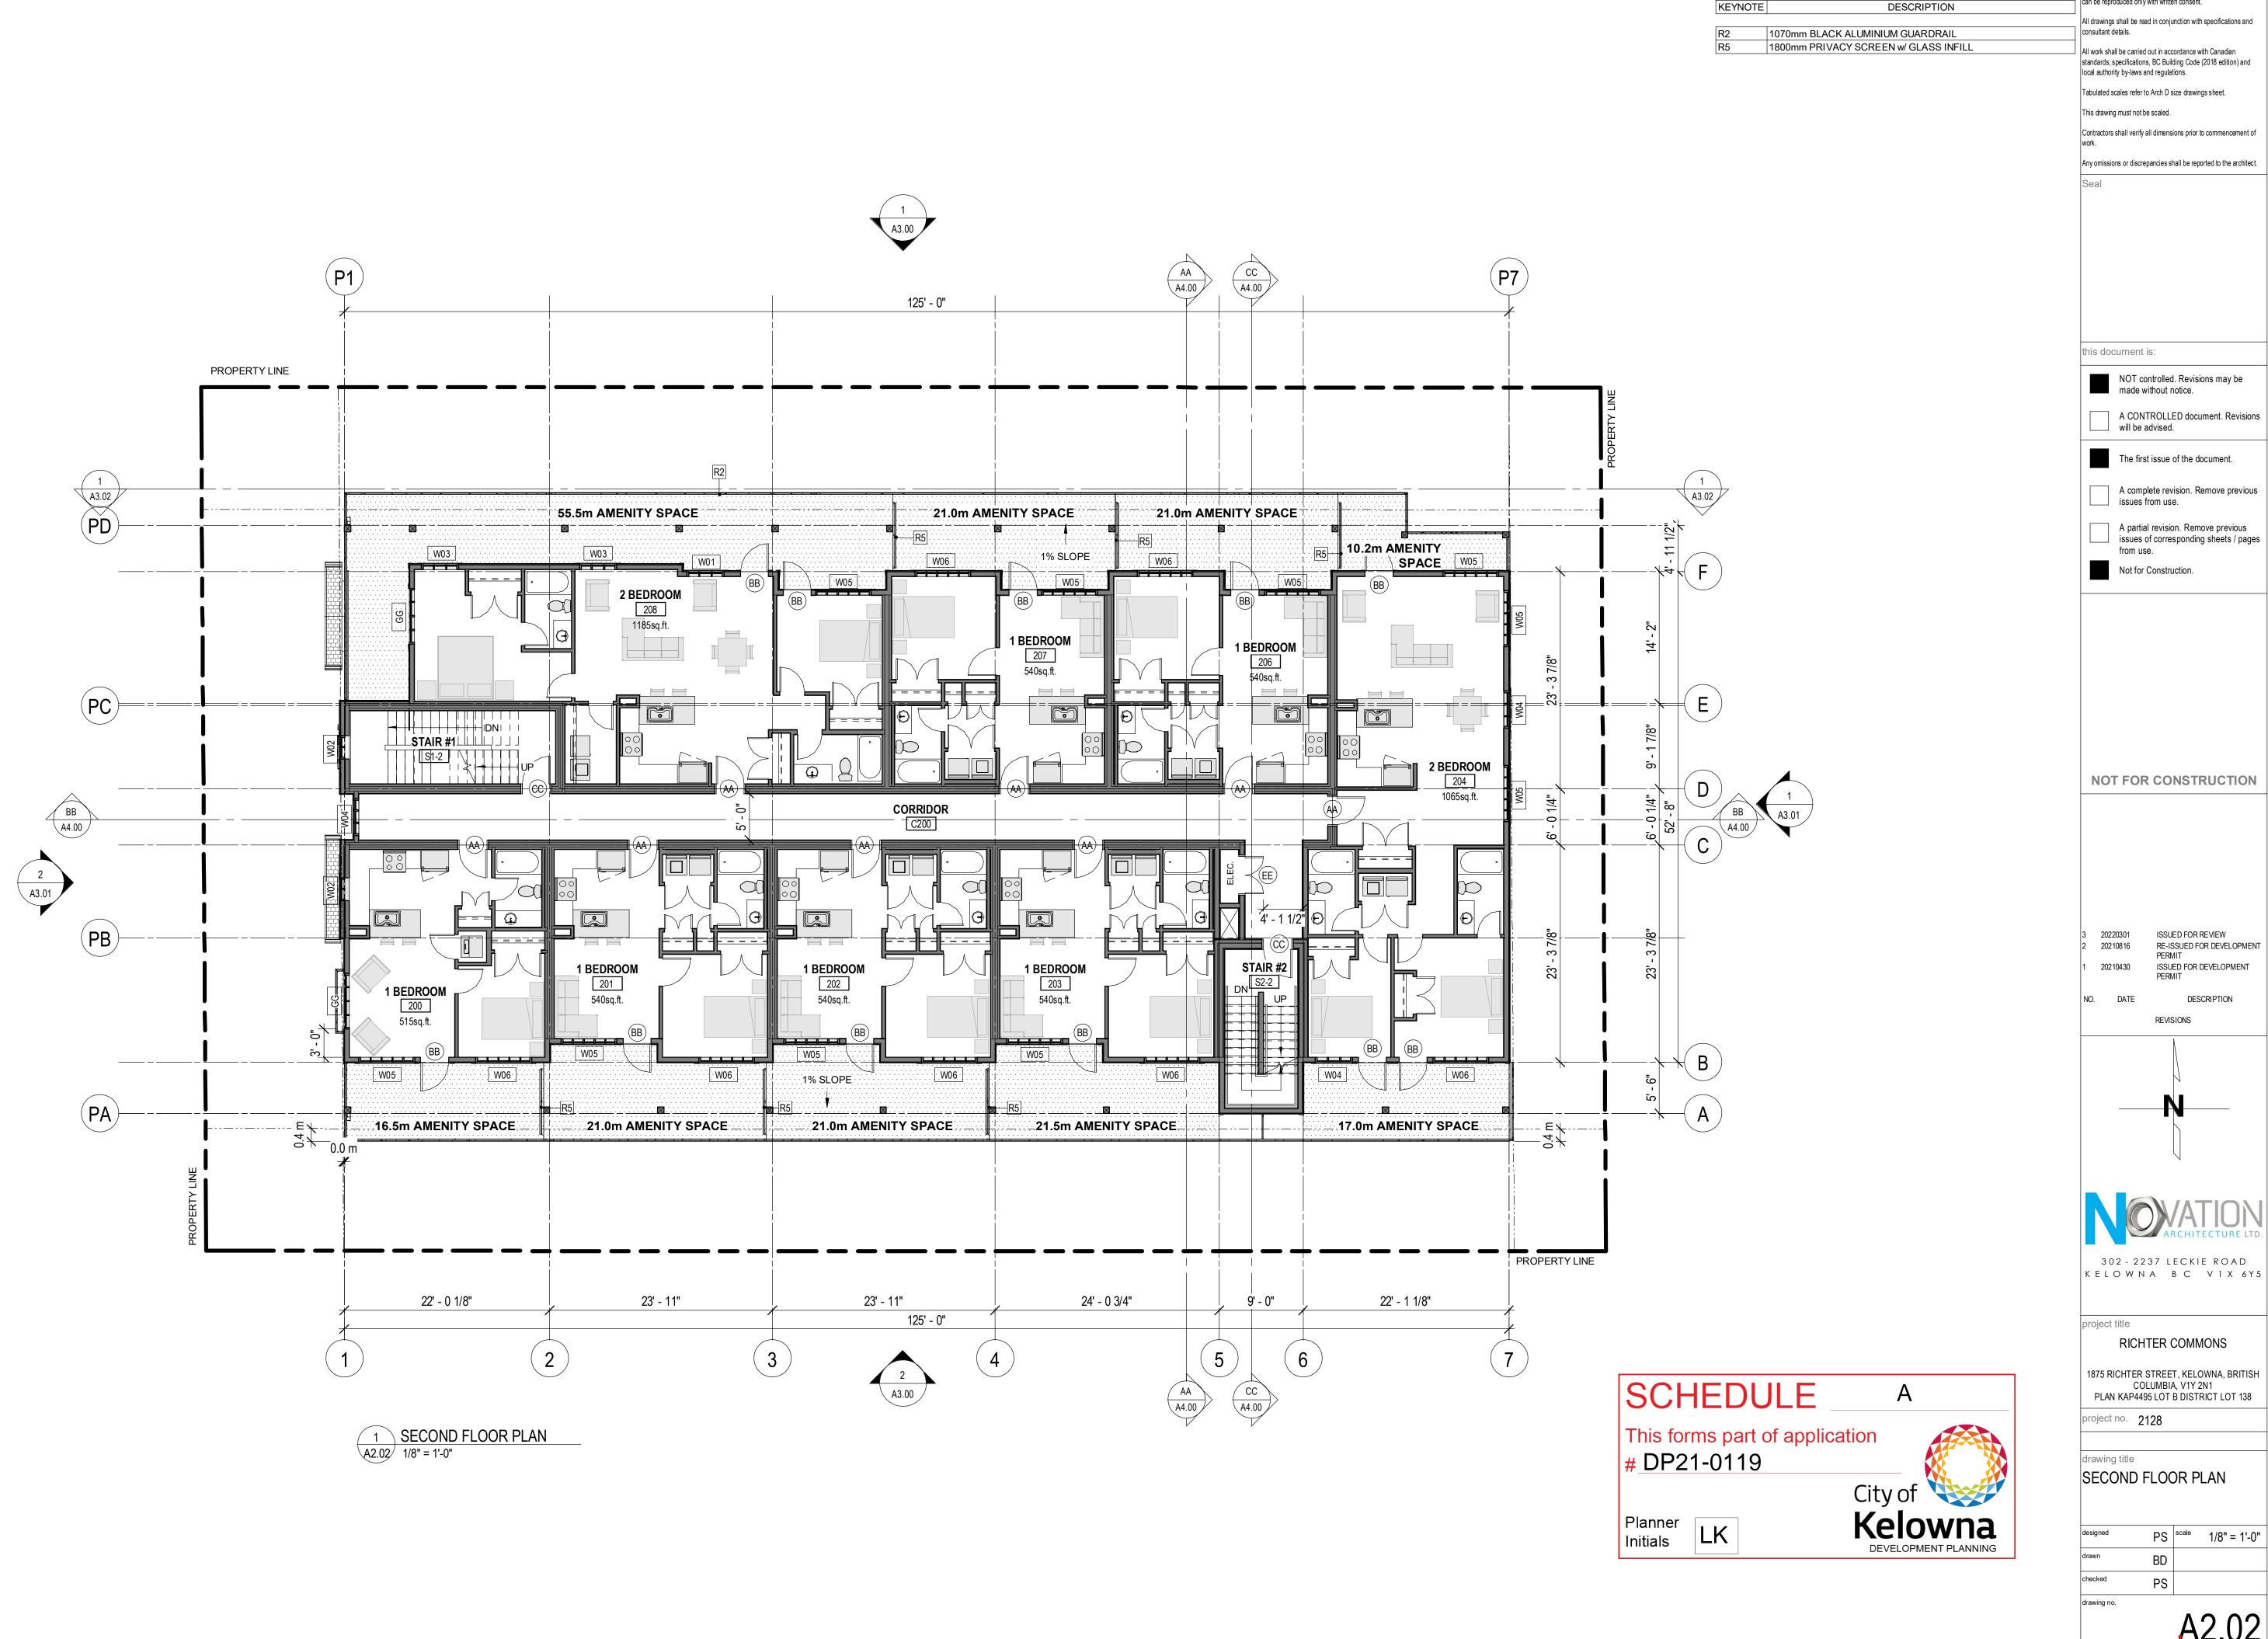


© Copyright Reserved. This drawing and design is, and at all times remains, the property of NOvation Architecture LTD., and

KEYNOTE LEGEND

can be reproduced only with written consent.


2022-03-01 12:39:43 PM

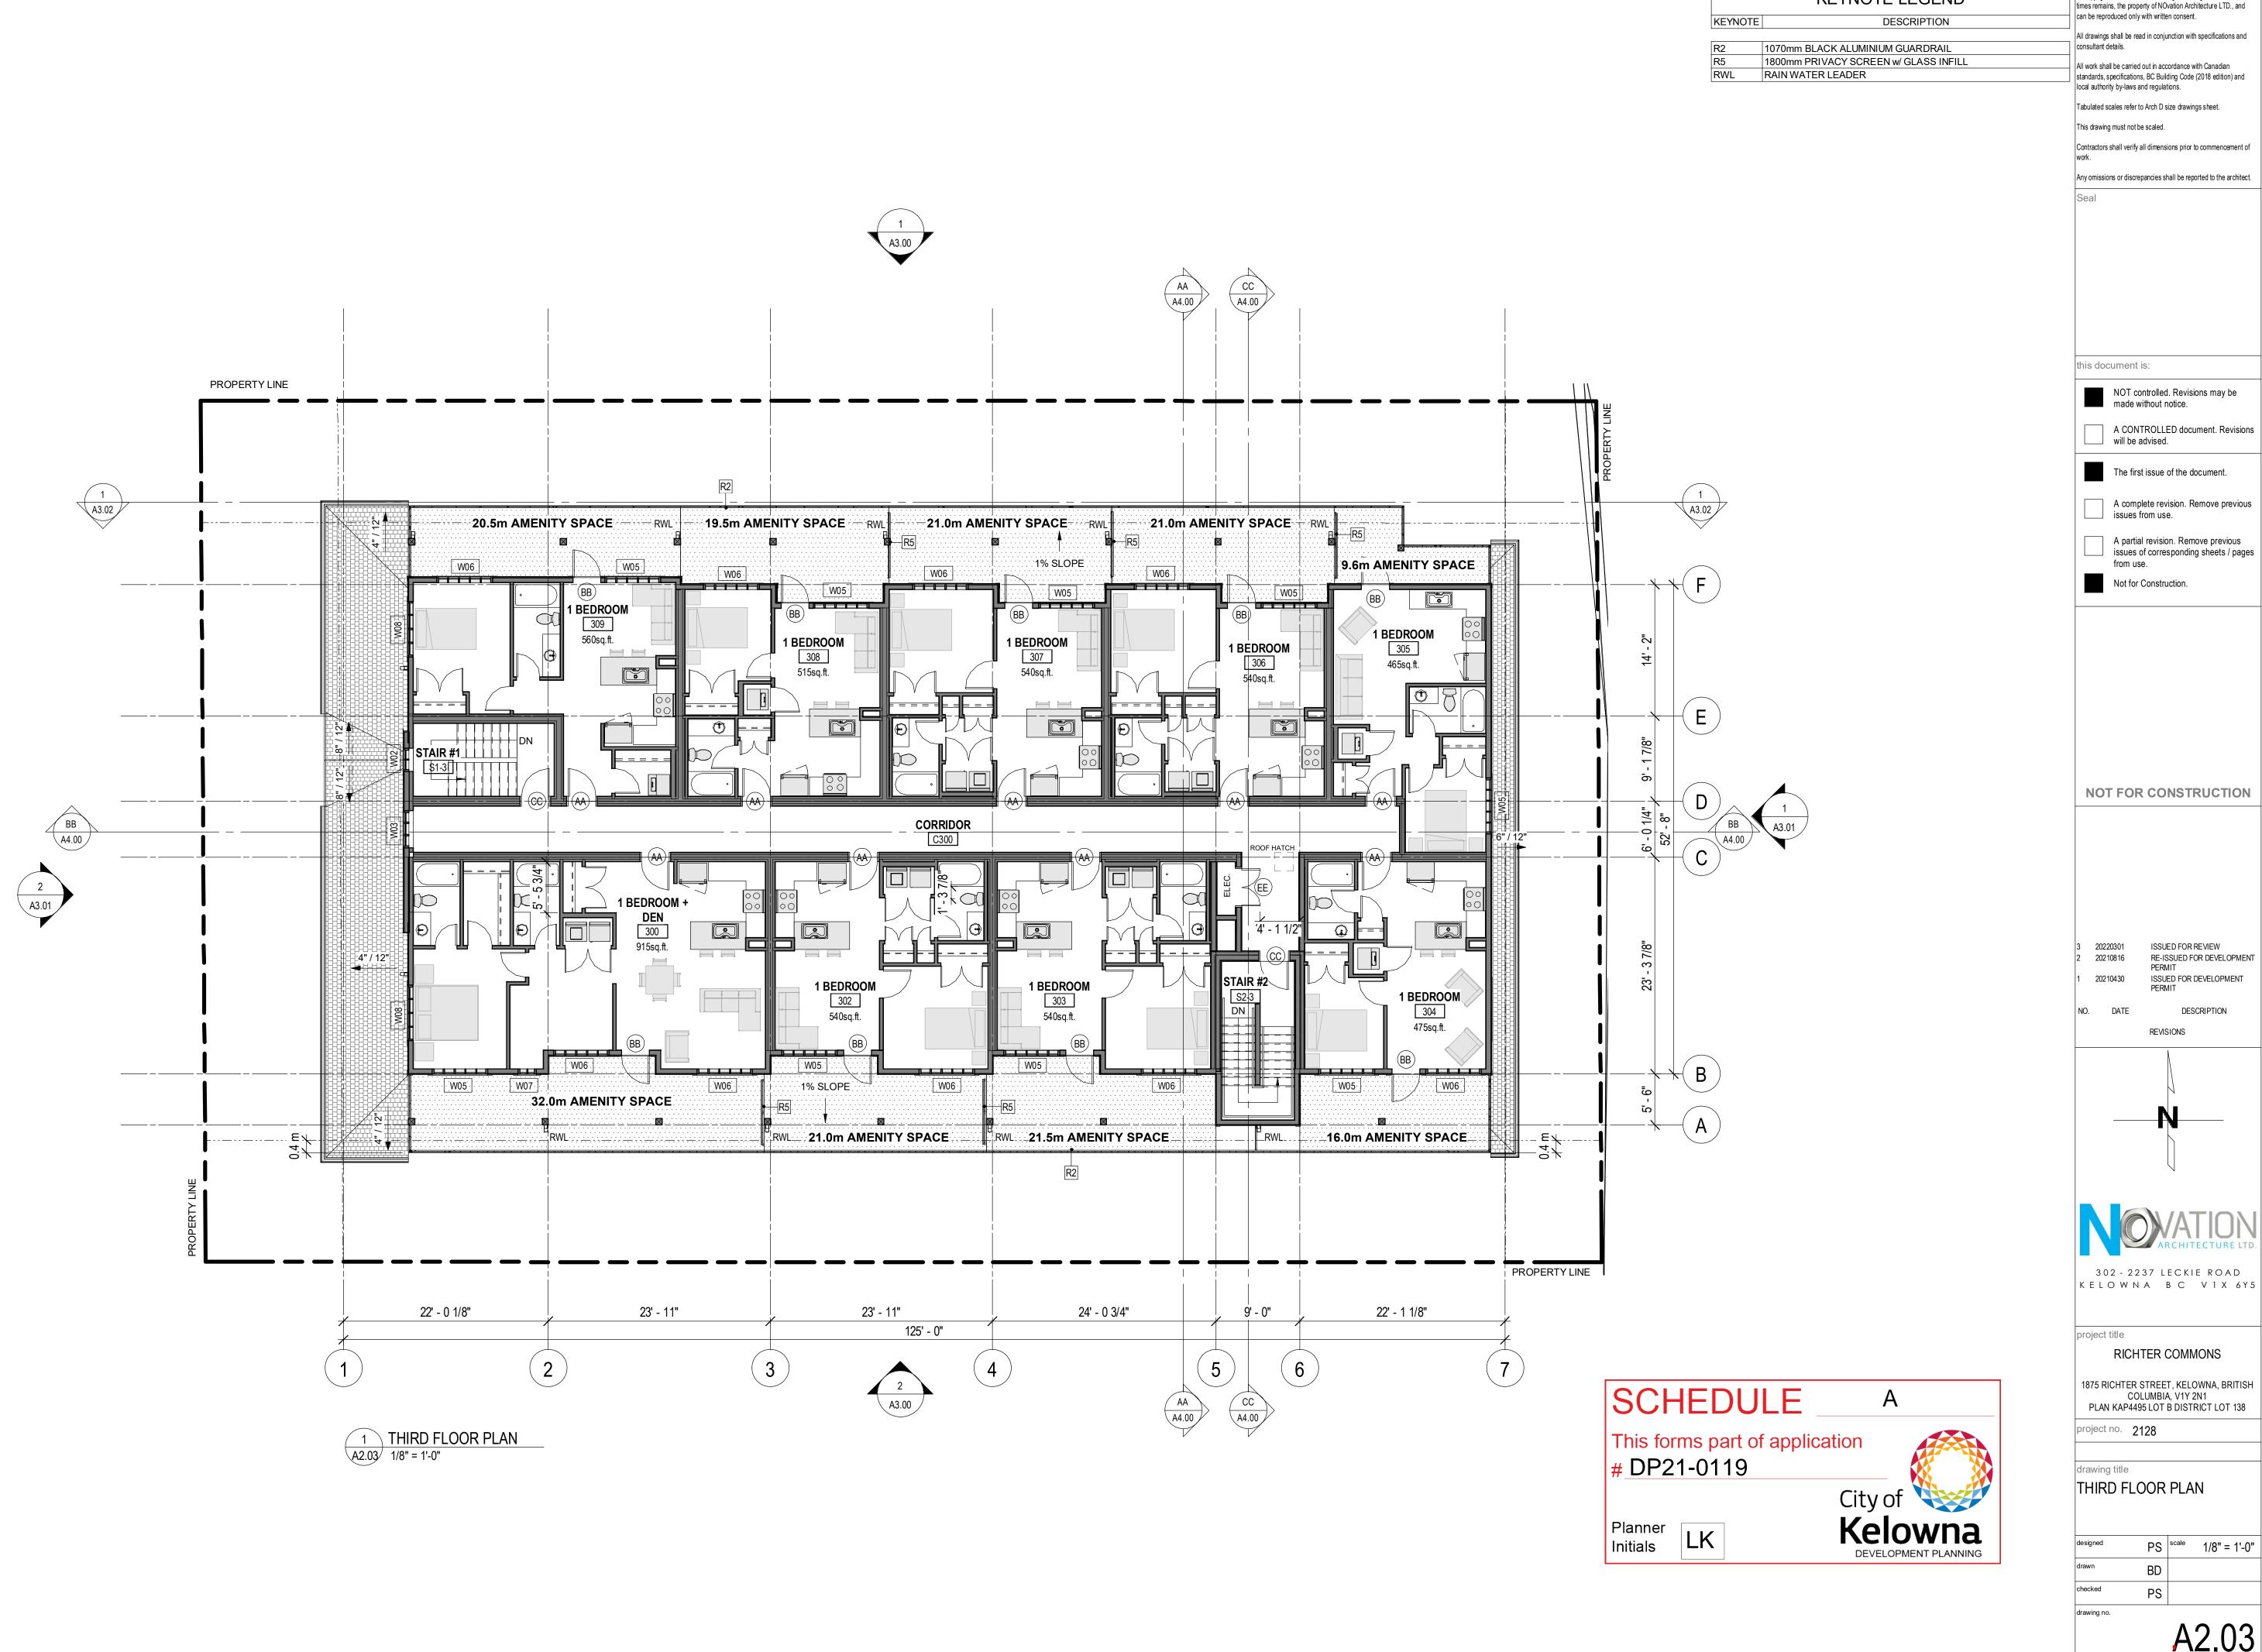

KEYNOTE LEGEND © Copyright Reserved. This drawing and design is, and at all times remains, the property of NOvation Architecture LTD., and



2022-03-01 12:39:47 PM

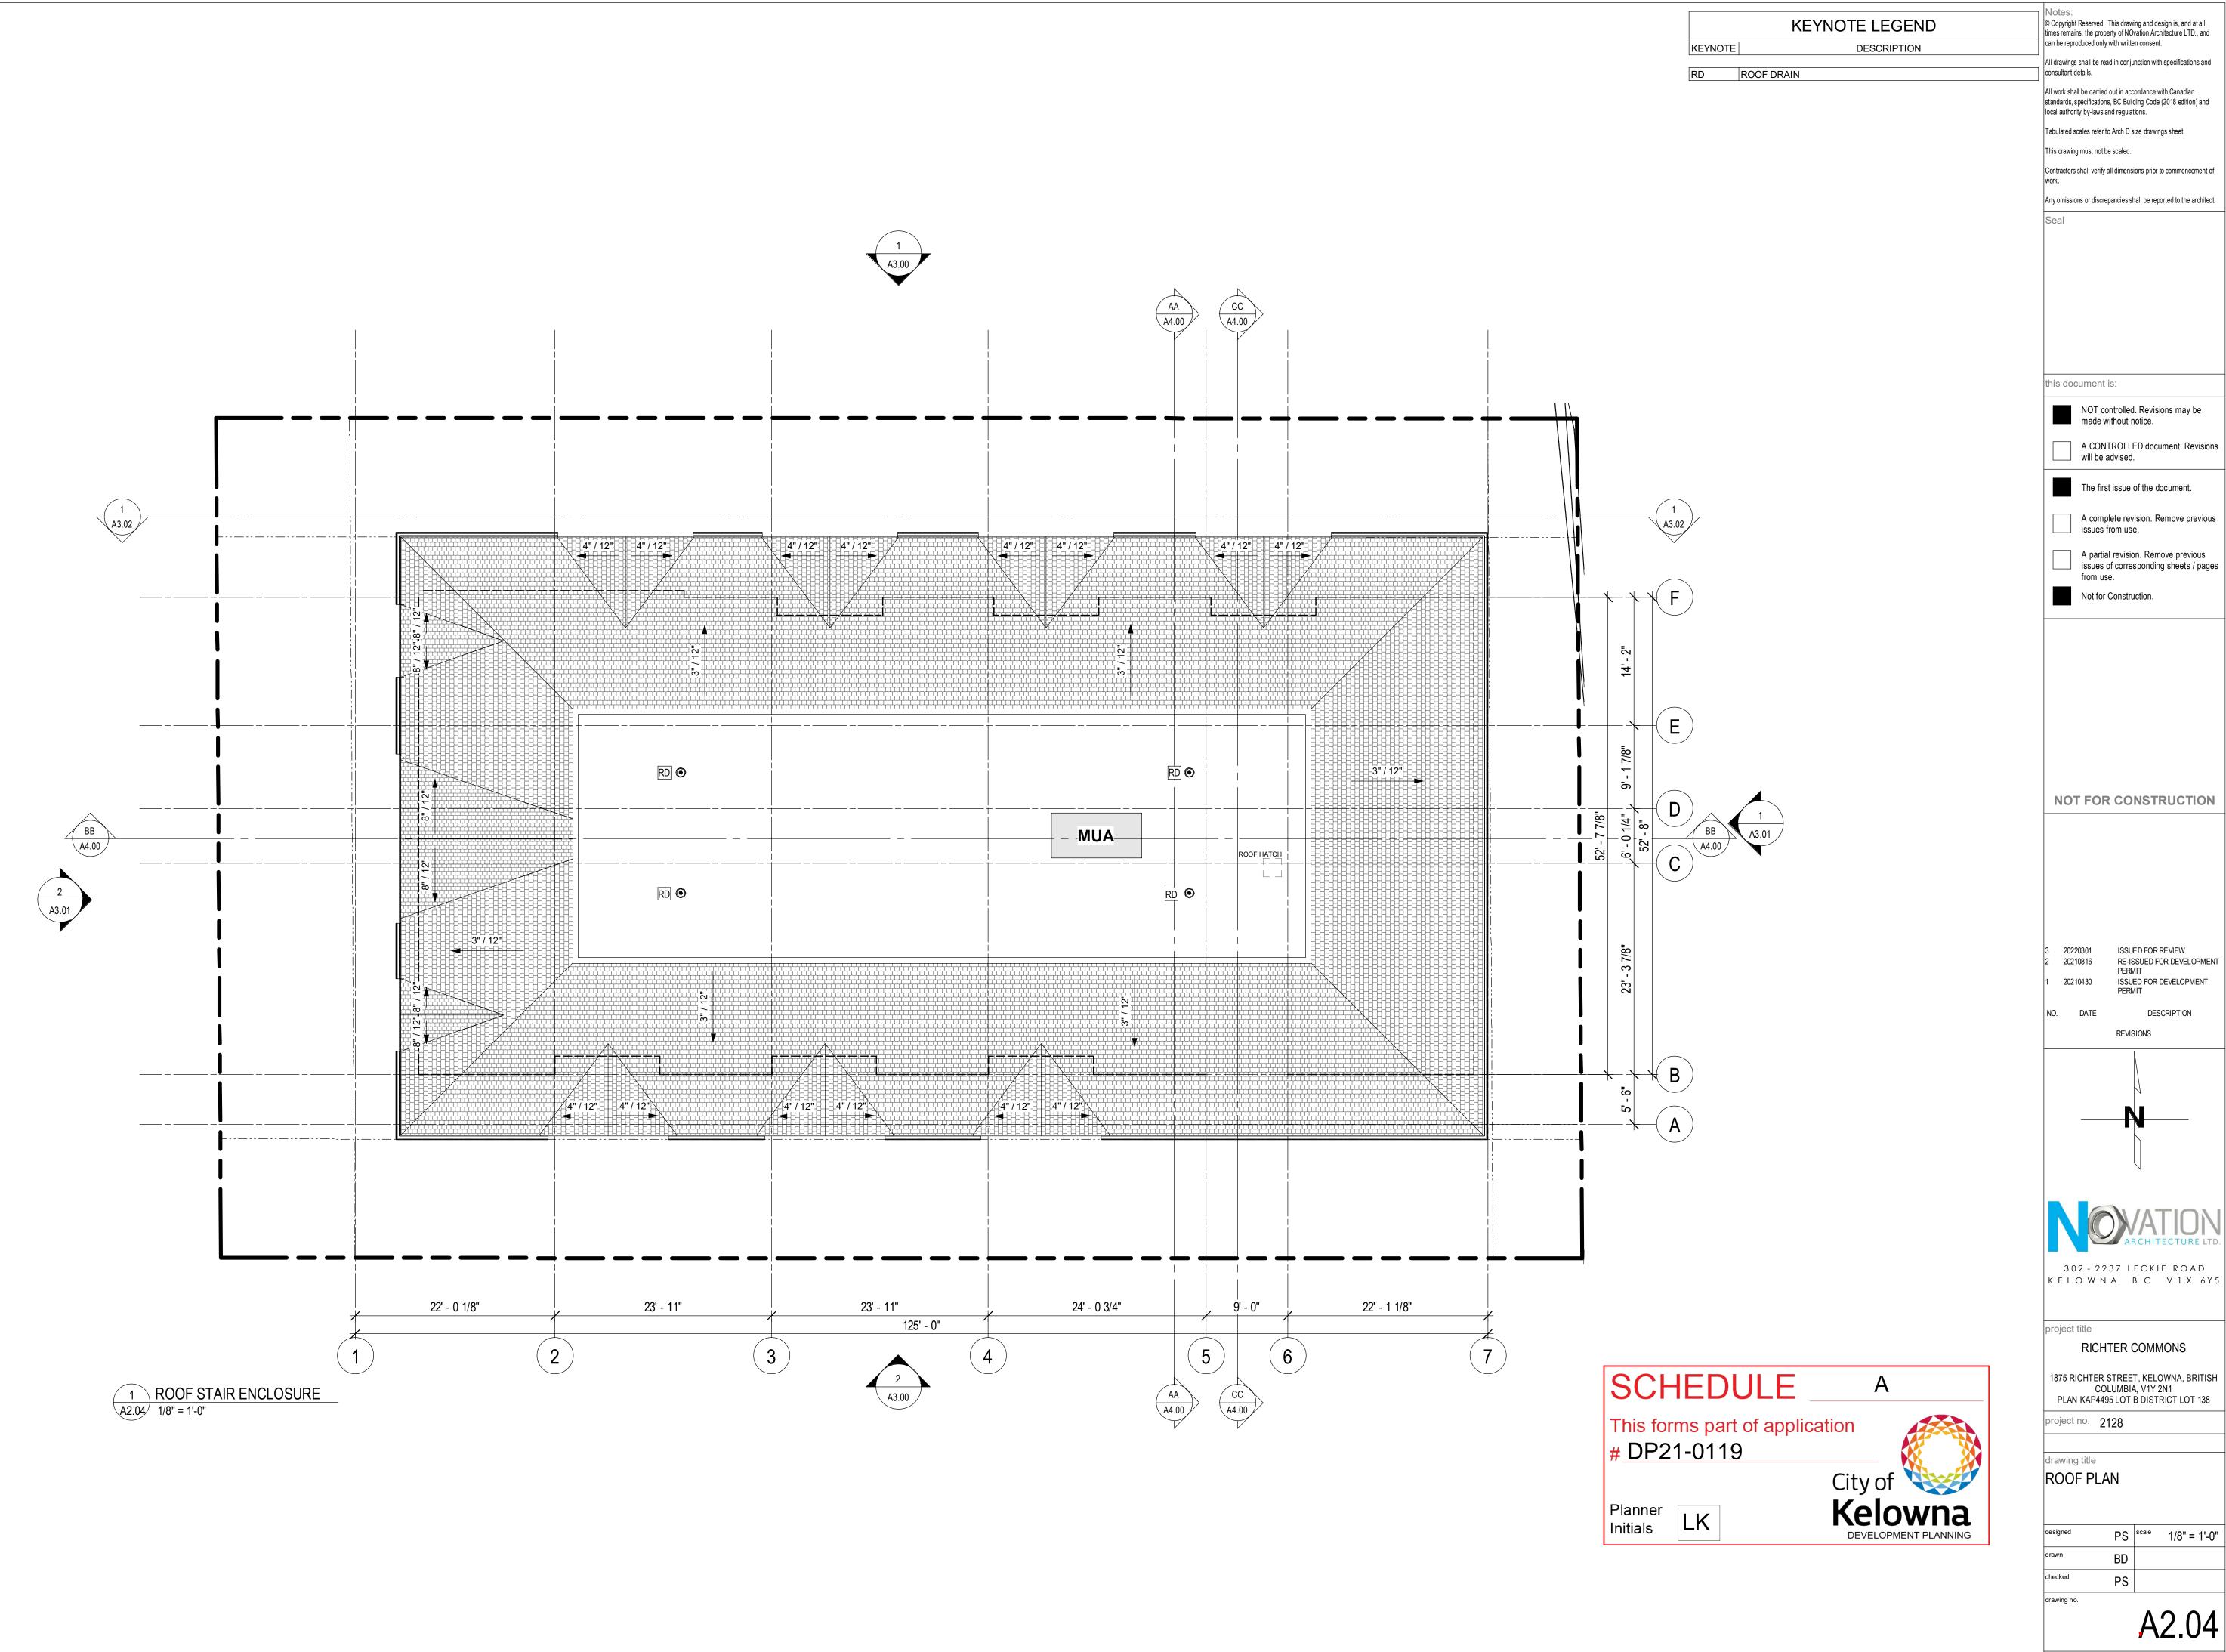

Project File Name and Location: BIM 360://1875 Richter Street/1875 Richter Street.rvt

2022-03-01 12:39:48 PM









KEYNOTE	KEYNOTE LEGEND DESCRIPTION	Notes: © Copyright Reserved. This drawing and design is, and at all times remains, the property of NOvation Architecture LTD., and can be reproduced only with written consent.
1	HARDIPLANK SIDING (COBBLE STONE)	All drawings shall be read in conjunction with specifications and consultant details.
2	STUCCO SIDING (EVERGREEN FOG)	All work shall be carried out in accordance with Canadian
	MASONRY VENEER (SIENNA) ASPHALT SHINGLES	standards, specifications, BC Building Code (2018 edition) and local authority by-laws and regulations.
5	WHITE ALUMINIUM	Tabulated scales refer to Arch D size drawings sheet.
6 7	CLEAR GLAZING EXPOSED CONCRETE	This drawing must not be scaled.
10	WOOD PRIVACY SCREEN	Contractors shall verify all dimensions prior to commencement
11	OVERHEAD SECURITY GRILLE	work.
15 R2	ELECTRICAL TRANSFORMER 1070mm BLACK ALUMINIUM GUARDRAIL	Any omissions or discrepancies shall be reported to the archite
R5 RWL	1800mm PRIVACY SCREEN w/ GLASS INFILL RAIN WATER LEADER	Seal
		this document is: NOT controlled. Revisions may be made without notice. A CONTROLLED document. Revision will be advised. The first issue of the document. A complete revision. Remove previous issues from use. A partial revision. Remove previous issues of corresponding sheets / pagfrom use. Not for Construction.
(MATERIAL LEGEND CONCRETE HARDIEPLANK SIDING (COBBLE STONE)	NOT FOR CONSTRUCTION
.000000000	STUCCO (EVERGREEN FOG)	
N	MASONRY VENEER	3 20220301 ISSUED FOR REVIEW
		2 20210816 RE-ISSUED FOR DEVELOPME PERMIT 1 20210430 ISSUED FOR DEVELOPMENT PERMIT NO. DATE DESCRIPTION
		REVISIONS



project title
RICHTER COMMONS

S DIQUITED OTDEST 1/51 OMAIA

1875 RICHTER STREET, KELOWNA, BRITISH COLUMBIA, V1Y 2N1
PLAN KAP4495 LOT B DISTRICT LOT 138

project no. 2128

drawing title

EXTERIOR ELEVATIONS


designed PS scale 1/8" = 1'-0"
drawn BD

PS

rawing no

A3.01

2022-03-01 12:40:06 PM

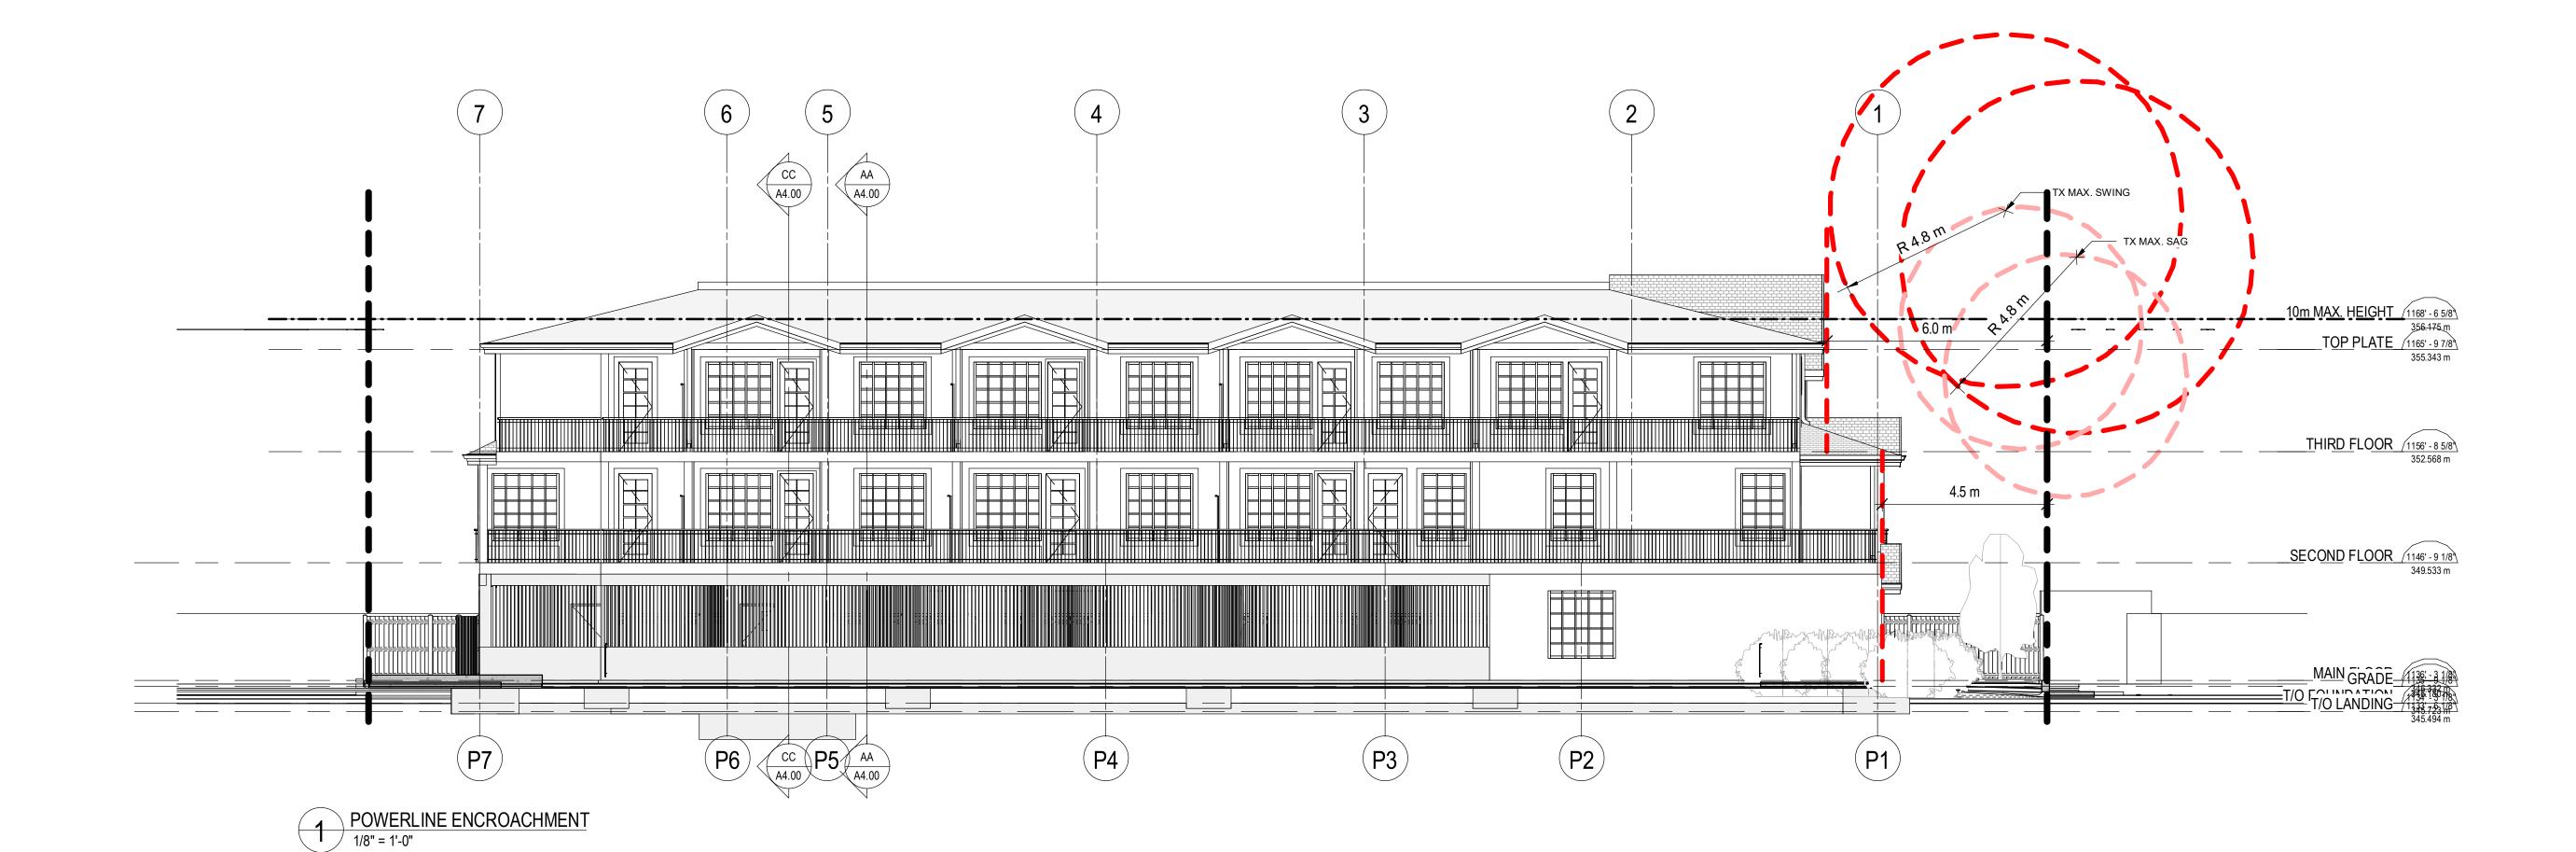



© Copyright Reserved. This drawing and design is, and at all times remains, the property of NOvation Architecture LTD., and can be reproduced only with written consent. All drawings shall be read in conjunction with specifications and All work shall be carried out in accordance with Canadian standards, specifications, BC Building Code (2018 edition) and local authority by-laws and regulations. Tabulated scales refer to Arch D size drawings sheet. This drawing must not be scaled. Contractors shall verify all dimensions prior to commencement of Any omissions or discrepancies shall be reported to the architect. this document is: NOT controlled. Revisions may be made without notice. A CONTROLLED document. Revisions will be advised. The first issue of the document. A complete revision. Remove previous issues from use. A partial revision. Remove previous issues of corresponding sheets / pages from use. Not for Construction. NOT FOR CONSTRUCTION 20220301 ISSUED FOR REVIEW DESCRIPTION REVISIONS



RICHTER COMMONS

1875 RICHTER STREET, KELOWNA, BRITISH COLUMBIA, V1Y 2N1 PLAN KAP4495 LOT B DISTRICT LOT 138

project no. 2128

drawing title


EXTERIOR ELEVATIONS

BD PS


A3.02

2022-03-01 12:40:08 PM

Project File Name and Location: BIM 360://1875 Richter Street/1875 Richter Street.rvt

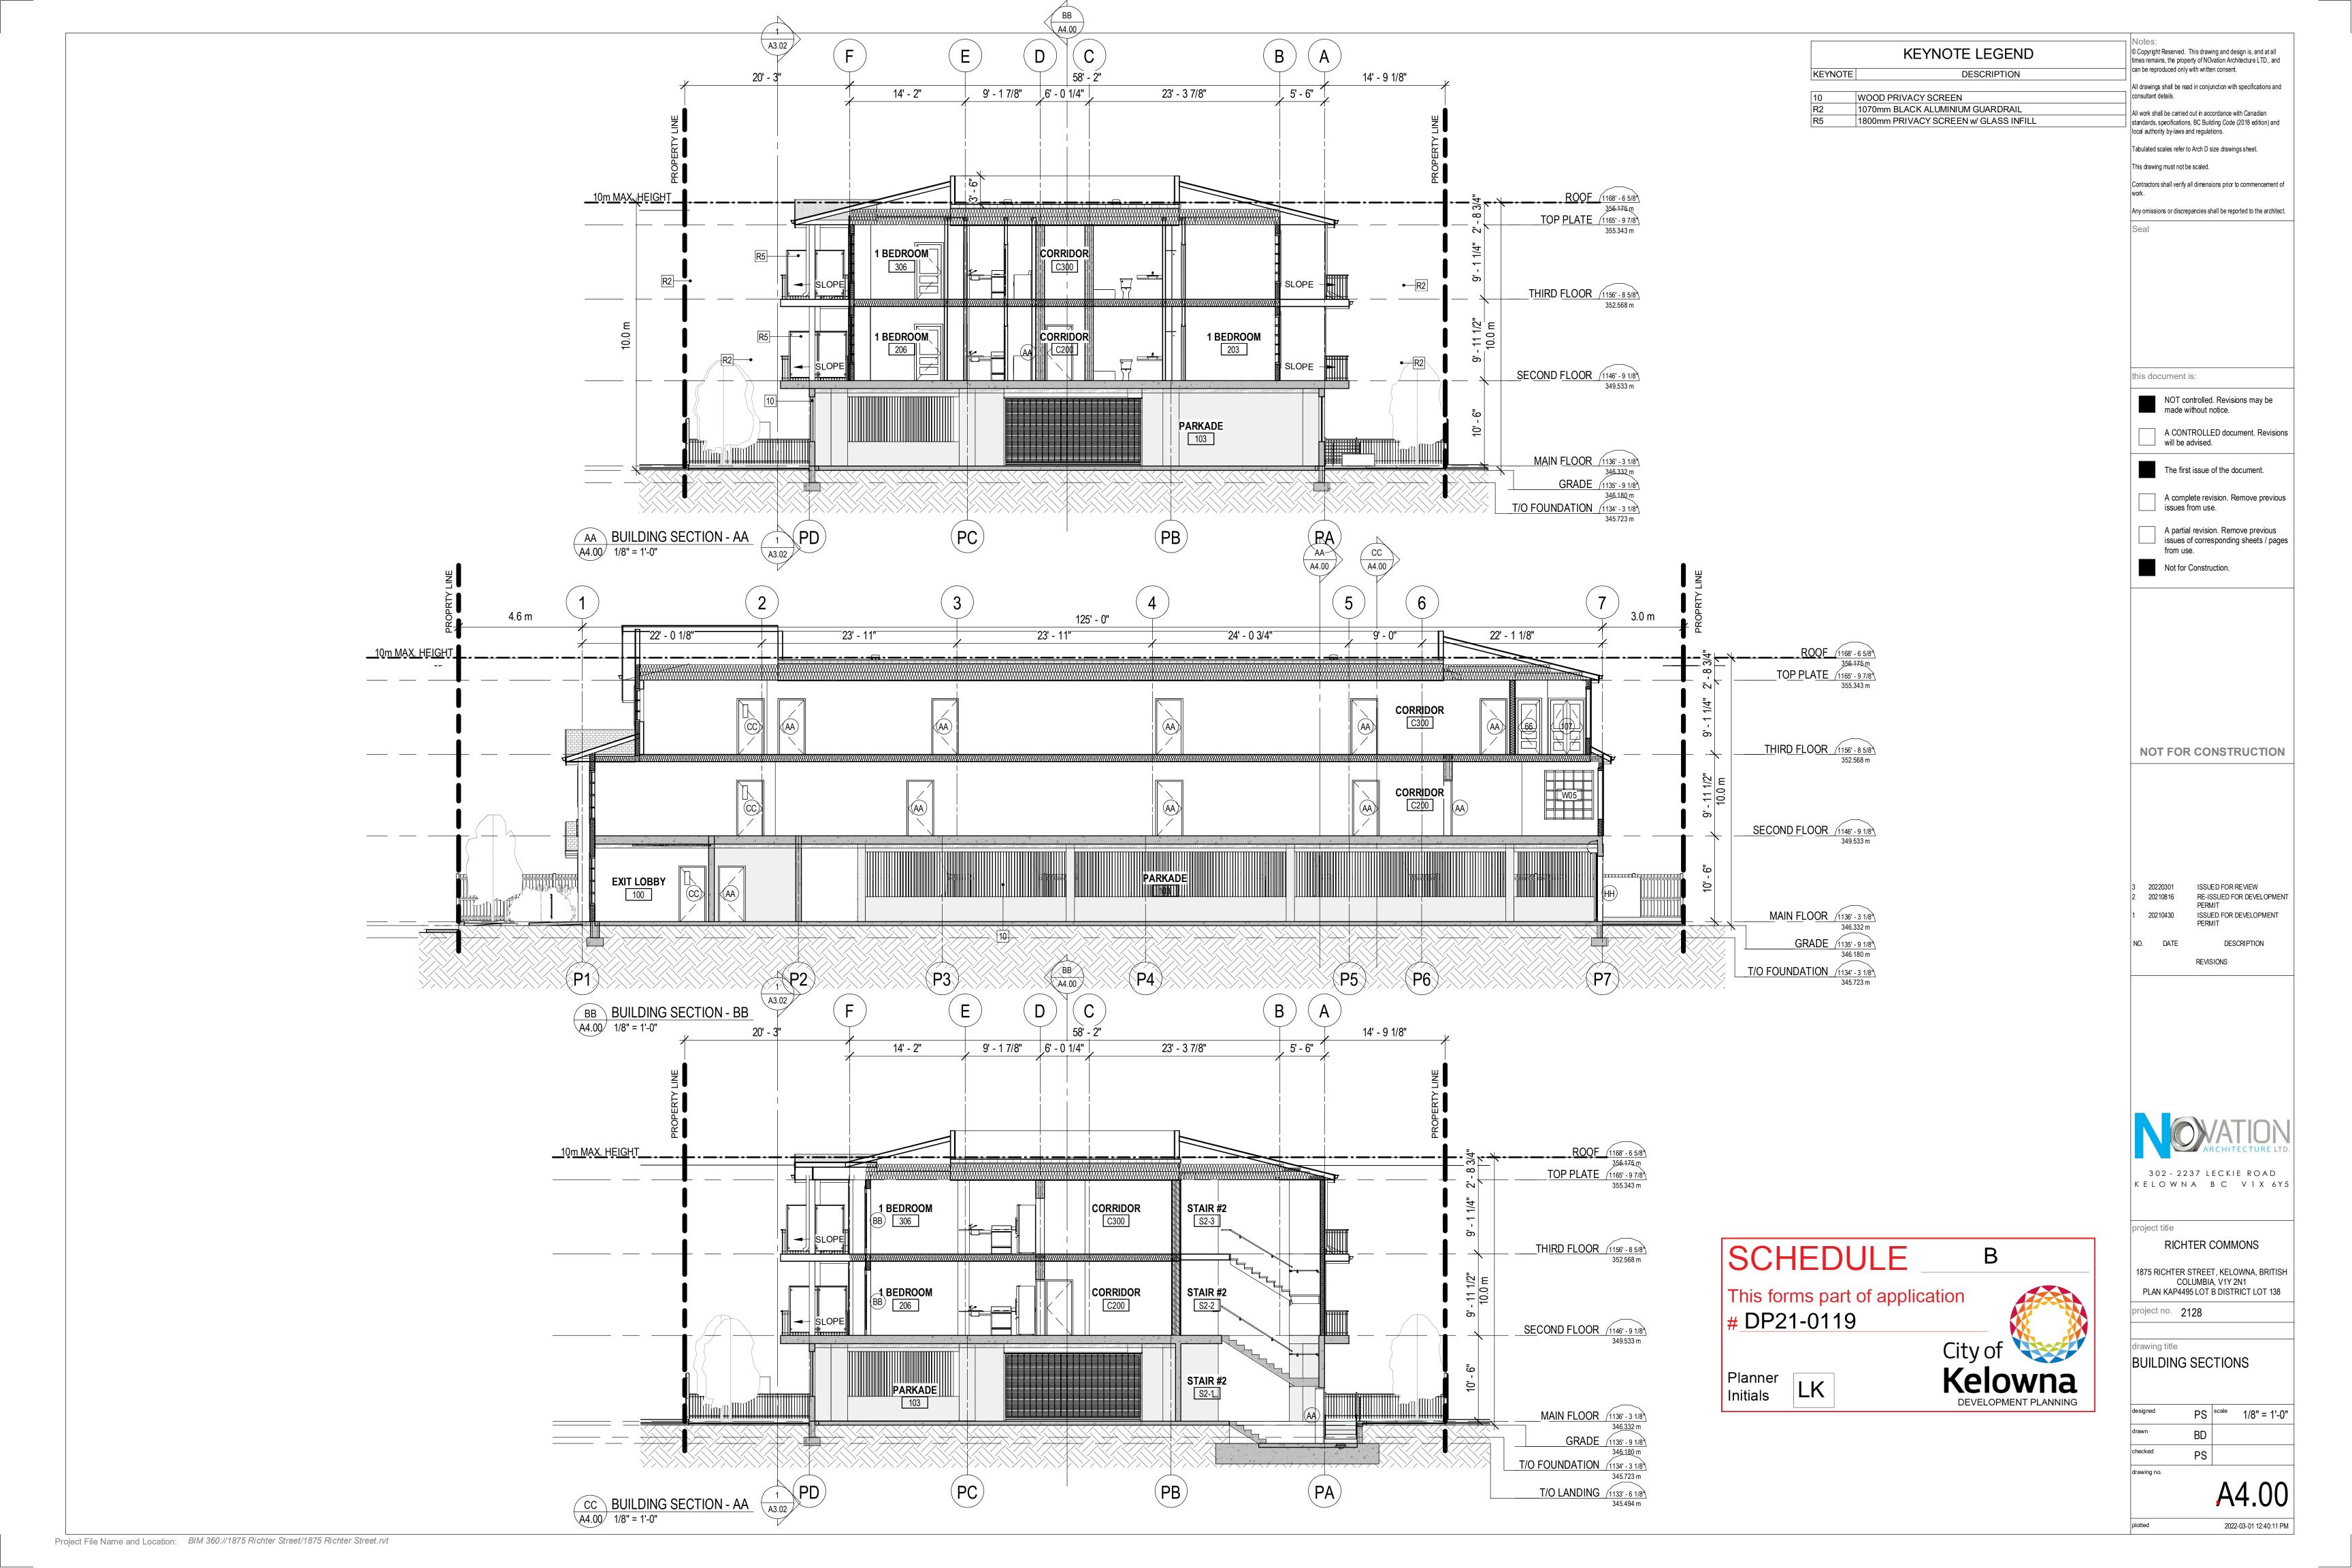

0 5 10 15 20 25 M

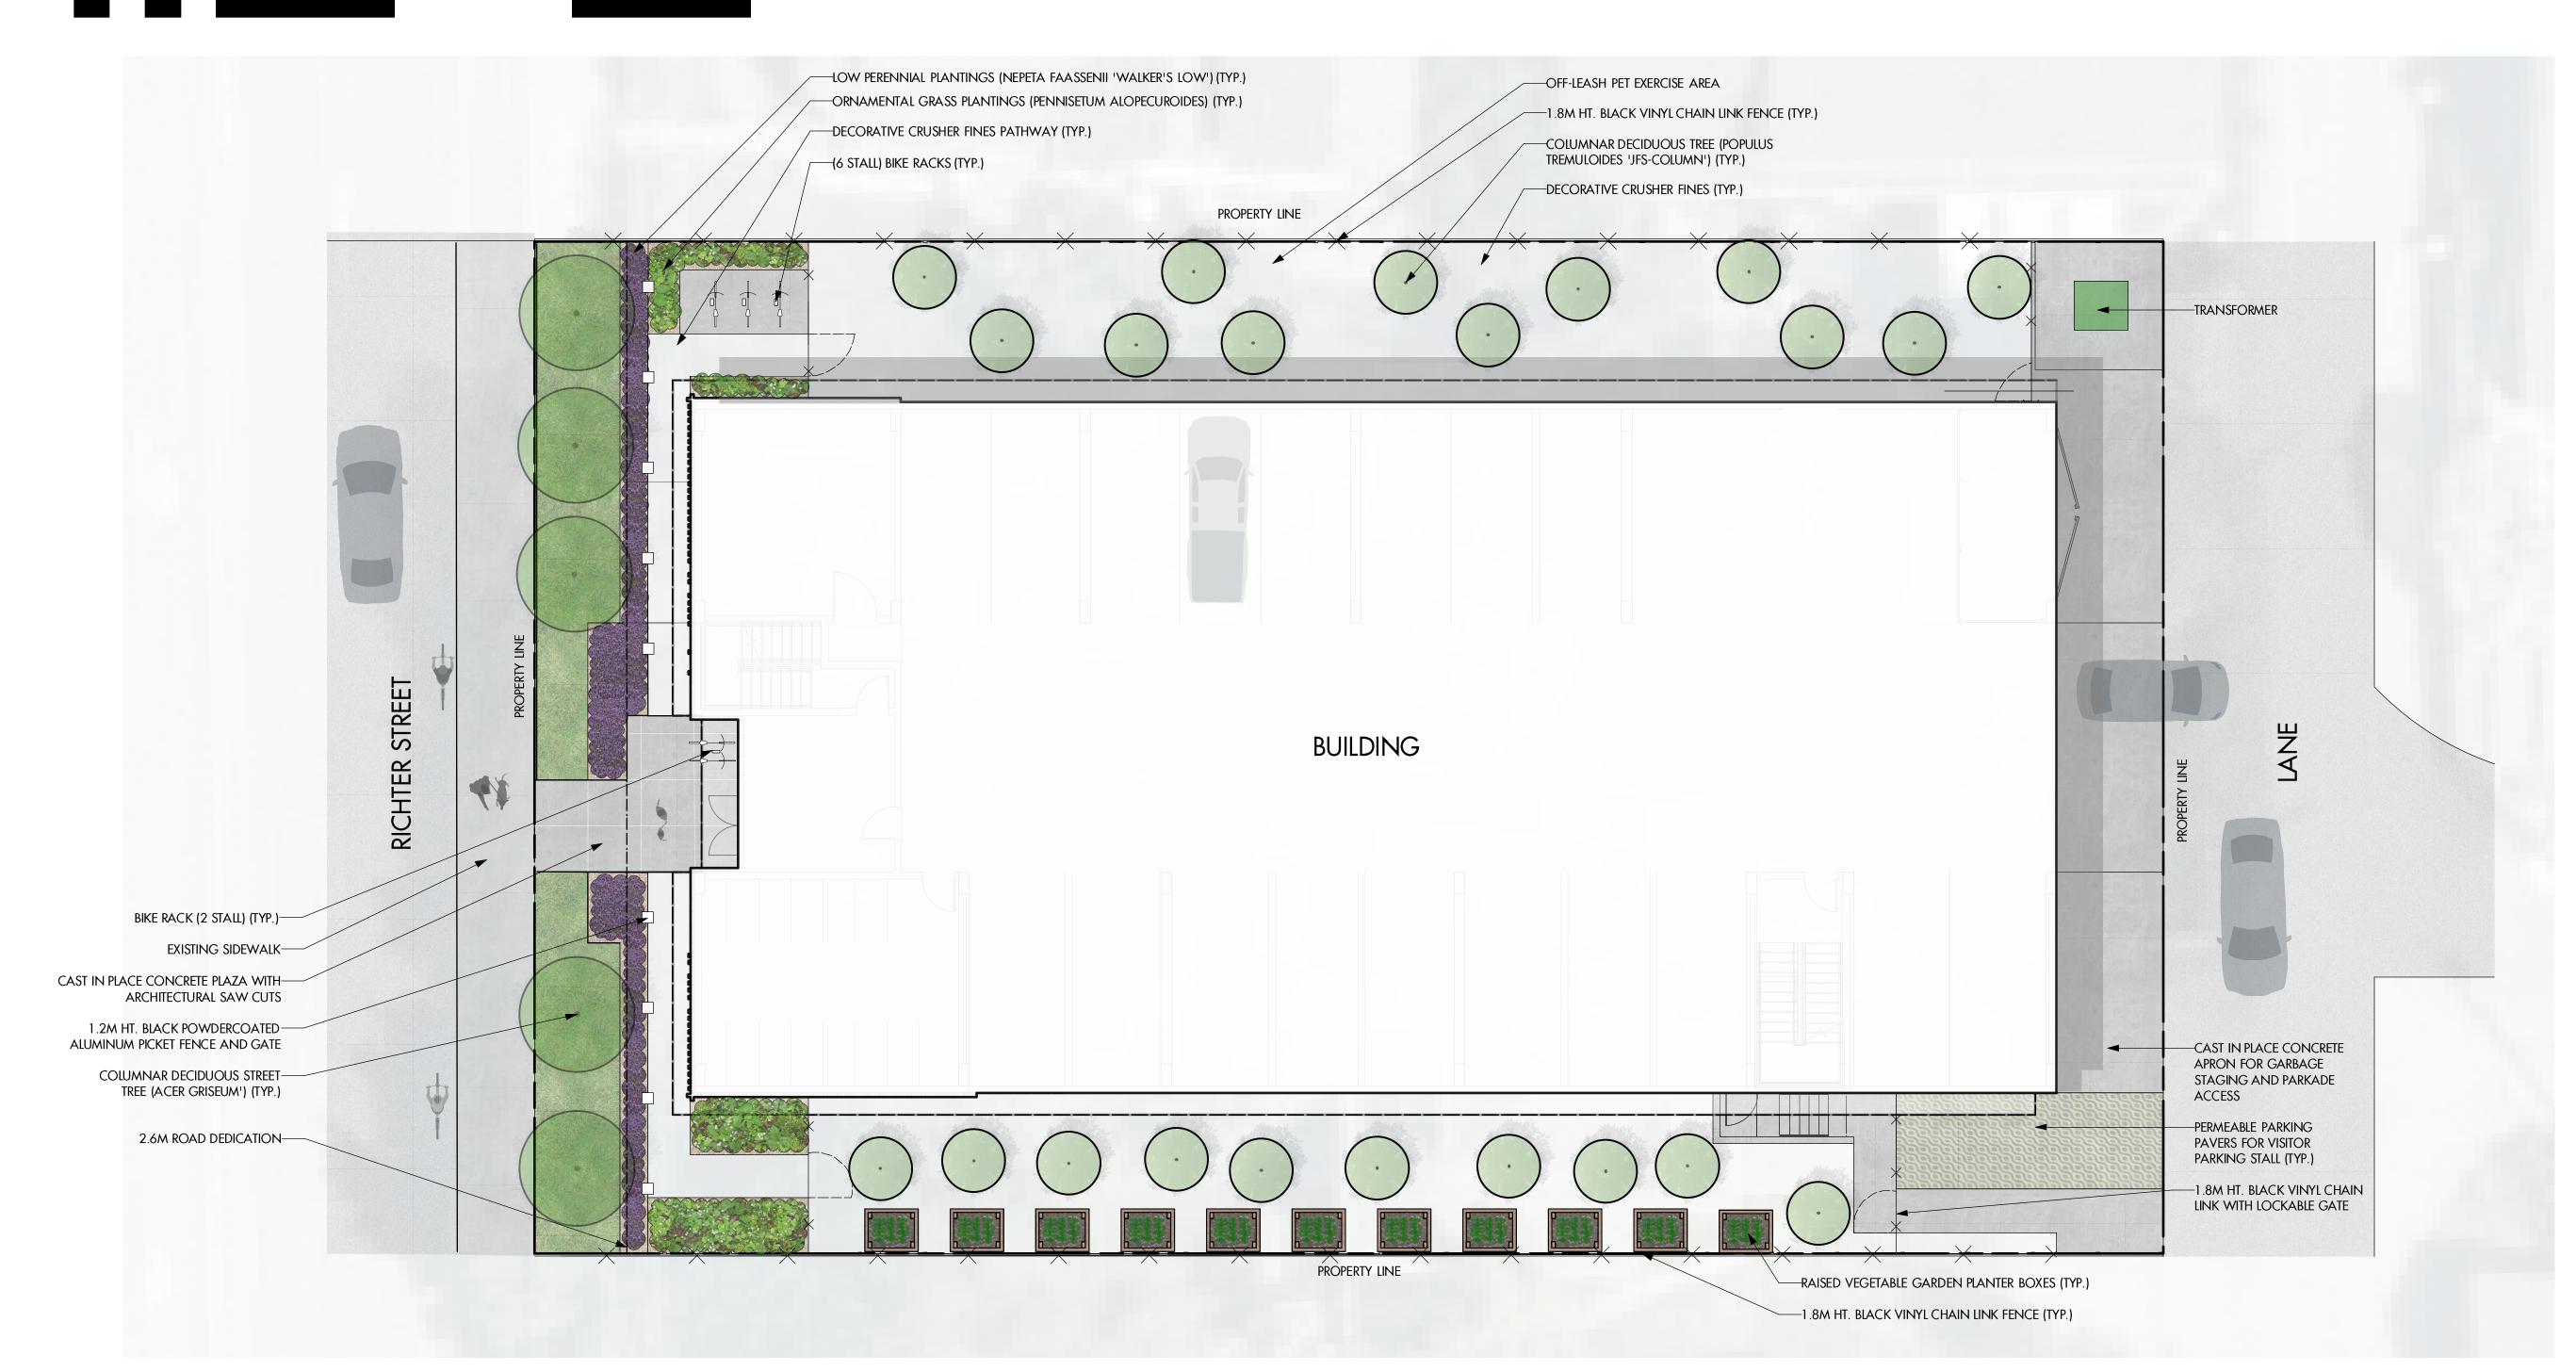

NOTES

- 1. PLANT MATERIAL AND CONSTRUCTION METHODS SHALL MEET OR EXCEED THE CANADIAN LANDSCAPE STANDARD.
- 2. ALL SOFT LANDSCAPE AREAS SHALL BE WATERED BY A FULLY AUTOMATIC TIMED UNDERGROUND IRRIGATION SYSTEM.
- 3. TREE AND SHRUB BEDS TO BE DRESSED IN A MINIMUM 75mm DOUGLAS RED FIR MULCH, AS SHOWN IN PLANS. TREES IN PITS REQUIRE A MINIMUM OF 9 cu.m OF GROWING MEDIUM. DO NOT PLACE WEED MAT UNDERNEATH TREE AND SHRUB BEDS.
- 4. TREE AND SHRUB BEDS TO RECEIVE A MINIMUM 300mm DEPTH TOPSOIL PLACEMENT.
- 5. TURF AREAS FROM SOD SHALL BE NO. 1 GRADE GROWN FROM CERTIFIED SEED OF IMPROVED CULTIVARS REGISTERED FOR SALE IN B.C. AND SHALL BE TOLERANT OF DROUGHT CONDITIONS. A MINIMUM OF 150mm DEPTH OF GROWING MEDIUM IS REQUIRED BENEATH TURF AREAS. TURF AREAS SHALL MEET EXISTING GRADES AND HARD SURFACES FLUSH.
- 6. SITE GRADING AND DRAINAGE WILL ENSURE THAT ALL STRUCTURES HAVE POSITIVE DRAINAGE AND THAT NO WATER OR LOOSE IMPEDIMENTS WILL BE DISCHARGED FROM THE LOT ONTO ADJACENT PUBLIC, COMMON, OR PRIVATE PROPERTIES.

PLANT LIST			
BOTANICAL NAME	COMMON NAME	QTY	SIZE/SPACING & REMARKS
TREES			
ACER GRISEUM	Paperbark maple	5	6cm CAL.
POPULUS TREMULOIDES 'JFS-COLUMN'	MOUNTAIN SENTINEL ASPEN	22	6cm CAL.
PERENNIALS, GRASSES & GROUNDCOVERS			
NEPETA FAASSENII 'WALKER'S LOW'	CATMINT	14	#01 CONT. /0.60M O.C. SPACING
PENNISETUM ALOPECUROIDES	FOUNTAIN GRASS	10	#01 CONT. /1.0M O.C. SPACING





303-590 KLO Road Kelowna, BC V1Y 7S2 T (250) 868-9270 www.outlanddesign.ca



PROJECT TITLE

1875 RICHTER STREET DEVELOPMENT

Kelowna, BC

DRAWING TITLE

CONCEPTUAL LANDSCAPE PLAN

	ISSL	ied for / revision	
	1	21.04.06	Review
	2	21.04.14	Review
	3	21.08.13	Review
	4	22.02.17	Review
	5		

PROJECT NO	21-045
DESIGN BY	FB
DRAVVN BY	MC
CHECKED BY	FB
DATE	FEB. 1 <i>7</i> , 2022
SCALE	1:100
PAGE SIZE	24"x36"

SEA



DRAWING NUMBER

L 1/2

ISSUED FOR REVIEW ONLY

Copyright Reserved. This drawing is the property of Outland Design Landscape Architecture Limited and shall not be reproduced, resold, or tendered without permission.

Development Permit DP21-0119





This permit relates to land in the City of Kelowna municipally known as

1875 Richter St

and legally known as

for Lot 1 District Lot 138 ODYD Plan EPP117925

and permits the land to be used for the following development:

RM3r - Low Density Multiple Housing (Residential Rental Tenure Only)

The present owner and any subsequent owner of the above described land must comply with any attached terms and conditions.

<u>Date of Council Decision</u> April 11, 2022

Decision By: COUNCIL

<u>Development Permit Area:</u> Form and Character DPA

Existing Zone: RM3r – Low Density Multiple Housing (Residential Rental Tenure Only)

Future Land Use Designation: C-NHD – Core Area Neighbourhood

This is NOT a Building Permit.

In addition to your Development Permit, a Building Permit may be required prior to any work commencing. For further information, contact the City of Kelowna, Development Services Branch.

NOTICE

This permit does not relieve the owner or the owner's authorized agent from full compliance with the requirements of any federal, provincial or other municipal legislation, or the terms and conditions of any easement, covenant, building scheme or agreement affecting the building or land.

Owner: 1243978 BC LTD., Inc. No. BC1243978

Applicant: Novation Architecture LTD

Planner: Lydia Korolchuk

Terry Barton	Date	
Community Planning Department Manager		
Planning & Development Services		

SCOPE OF APPROVAL

This Development Permit applies to and only to those lands within the Municipality as described above, and any and all buildings, structures and other development thereon.

This Development Permit is issued subject to compliance with all of the Bylaws of the Municipality applicable thereto, except as specifically varied or supplemented by this permit, noted in the Terms and Conditions below.

The issuance of a permit limits the permit holder to be in strict compliance with regulations of the Zoning Bylaw and all other Bylaws unless specific variances have been authorized by the Development Permit. No implied variances from bylaw provisions shall be granted by virtue of drawing notations that are inconsistent with bylaw provisions and that may not have been identified as required Variances by the applicant or Municipal staff.

2. CONDITIONS OF APPROVAL

- a) The dimensions and siting of the building to be constructed on the land be in accordance with Schedule "A";
- b) The exterior design and finish of the building to be constructed on the land be in accordance with Schedule "B";
- c) Landscaping to be provided on the land be in accordance with Schedule "C"; and
- d) The applicant be required to post with the City a Landscape Performance Security deposit in the form of a "Letter of Credit" in the amount of 125% of the estimated value of the landscaping, as determined by a Registered Landscape Architect.

This Development Permit is valid for two (2) years from the date of approval, with no opportunity to extend.

3. PERFORMANCE SECURITY

As a condition of the issuance of this Permit, Council is holding the security set out below to ensure that development is carried out in accordance with the terms and conditions of this Permit. Should any interest be earned upon the security, it shall accrue to the Developer and be paid to the Developer or his or her designate if the security is returned. The condition of the posting of the security is that should the Developer fail to carry out the development hereby authorized, according to the terms and conditions of this Permit within the time provided, the Municipality may enter into an agreement with the property owner of the day to have the work carried out, and any surplus shall be paid over to the property owner of the day. Should the Developer carry out the development permitted by this Permit within the time set out above, the security shall be returned to the Developer or his or her designate. There is filed accordingly:

a) An Irrevocable Letter of Credit **OR** certified cheque in the amount of \$43,125.29

Before any bond or security required under this Permit is reduced or released, the Developer will provide the City with a statutory declaration certifying that all labour, material, workers' compensation and other taxes and costs have been paid.

5. INDEMNIFICATION

Upon commencement of the works authorized by this Permit the Developer covenants and agrees to save harmless and effectually indemnify the Municipality against:

a) All actions and proceedings, costs, damages, expenses, claims, and demands whatsoever and by whomsoever brought, by reason of the Municipality said Permit.

All costs, expenses, claims that may be incurred by the Municipality where the construction, engineering or other types of works as called for by the Permit results in damages to any property owned in whole or in part by the Municipality or which the Municipality by duty or custom is obliged, directly or indirectly in any way or to any degree, to construct, repair, or maintain.

The PERMIT HOLDER is the <u>CURRENT LAND OWNER</u>. Security shall <u>ONLY</u> be returned to the signatory of the Landscape Agreement or their designates.

FORM & CHARACTER - DEVELOPMENT PERMIT GUIDELINES

Chapter 2 - The Design Foundations : apply to all projects and provide the overarching principles for supporting creativity, innovation and design excellence in Kelowna.

- Facilitate Active Mobility
- Use Placemaking to Strengthen Neighbourhood Identity
- Create Lively and Attractive Streets & Public Spaces
- Design Buildings to the Human Scale
- Strive for Design Excellence

The General Residential and Mixed Use Guidelines: provide the key guidelines that all residential and mixed use projects should strive to achieve to support the Design Foundations.

 The General Guidelines are supplement by typology-specific guidelines (e.g., Townhouses & Infill on page 18-19, High-Rise Residential and Mixed-Use on page 18-42), which provide additional guidance about form and character.

Chapter 2 - Design Foundations Apply To All Projects Page 18-8

Section 2.1 - General Residential and Mixed Use Design Guidelines
Page 18-9

Section 2.2 - Achieving High Performance Page 18-17

Chapter 3
Townhouses & Infill

Page 18-10

Chapter 4 Low & Mid-Rise Residential & Mixed Use

Page 18-34

Chapter 5 High-Rise Residential & Mixed Use

Page 18-42

ATTACHMENT

This forms part of application
DP21-0119

City of

Planner Initials

LK

City of

*Note: Refer to the Design Foundations and the Guidelines associated with the specific building typology.

FORM & CHARACTER - DEVELOPMENT PERMIT GUIDELINES

Consideration has been given to the following guidelines as identified in Chapter 18 of the City of Kelowna 2040 Official Community Plan:

RATE PROPOSALS COMPLIANCE TO PERTINENT	GUIDELINE	N/A	1	2	3	4	5
(1 is least complying & 5 is highly complying) CHAPTER 4.0: LOW & MID-RISE RESIDENTIAL & N	MIXED LISE						
4.1 Guidelines	MIXED OSE						
4.1.1 Relationship to the Street							
Lobby area and main building entrance is clearly visib street and sidewalk.	ole from the fronting						✓
Wherever possible, blank walls at grade are not enco	uraged.					√	
Enclosed parking garages are located away from stre public open space.	et frontages or						√
Ground oriented units with entries or glazing have be avoid the blank/dead frontage along the street.						√	
When unavoidable, blank walls have been screened with landscaping or have been incorporated with a patio/café or special materials have been provided to make them visually interesting. Residential and Mixed-use Buildings						~	
				'			
Residential buildings at the ground floor have a set bath from the property line to create a semi-private entry individual units and to allow for an elevated front ent patio.	or transition zone to						✓
A maximum 1.2m desired height (e.g., 5-6 steps) for for the been provided. Where the water table requires this to cases, larger patio has been provided and parking has with ramps, stairs, and landscaping.	be higher, in these						✓
Ground floor units accessible from the fronting street or public open			✓				
spaces have been provided with individual entrances. Buildings are sited and oriented so that windows and balconies are overlooking public streets, parks, walkways, and shared amenity spaces while minimizing views into private residences.				✓			
4.1.2 Scale and Massing							
Proposed residential building façade has a length of 6 preferred).	Som (40m length is						✓
Buildings over 40m in length are incorporating signifi vertical breaks in façade.	cant horizontal and	√					
Commercial building facades are incorporating signif approximately 35m intervals.	icant break at	√					
Proposed residential building has a maximum width o	of 24m.						✓
4.1.3 Site Planning	ATTACHMEN	VT	В	1			I

This forms part of application # DP21-0119

Planner LK

Initials

Page 2

RATE PROPOSALS COMPLIANCE TO PERTINENT GUIDELINE	N/A	1	2	3	4	5
(1 is least complying & 5 is highly complying)						
On sloping sites, building floor levels are following the natural grade and avoiding the blank wall situation.	~					
Buildings are sited to be parallel to the street and have a distinct front-to-					✓	
back orientation to public street and open spaces and to rear yards,						
parking, and/or interior courtyards.						
Building sides that are interfacing with streets, mid-block connections,				✓		
and other open spaces (building fronts) are positively framing and						
activating streets and open spaces and supporting pedestrian activity.						
Larger buildings are broken up with mid-block connections which have	✓					
public accessibility wherever possible.						
Ground floors adjacent to mid block connections have entrances and				✓		
windows facing the mid block connection.						
4.1.4 Site Servicing, Access, and Parking		1	1	1	1	1
Vehicular access is provided from the lane.						✓
Where there is no lane, and where the re-introduction of a lane is difficult	✓					
or not possible, access is provided from the street, provided:						
 Access is from a secondary street, where possible, or from the 						
long face of the block;						
 Impacts on pedestrians and the streetscape is minimized; and, 						
There is no more than one curb cut per property.						
Above grade structure parking should only be provided in instances						✓
where the site or high water table does not allow for other parking forms.						
When parking cannot be located underground due to the high water					✓	
table and is to be provided above ground, screen the parking structure						
from public view as follows:						
On portions of the building that front a retail or main street,						
line the above ground parking with active retail frontage;						
On portions of the building that front onto non-retail streets, line the above ground and in a with an action would not in.						
line the above ground parking with an active residential						
frontage, such as ground oriented townhouse units;When active frontages are not able to be accommodated,						
screen parking structures by using architectural or						
landscaped screening elements;						
On corner sites, screen the parking structure from public view						
on both fronting streets using the appropriate strategy listed						
above.				1		



RATE PROPOSALS COMPLIANCE TO PERTINENT GUIDELINE	N/A	1	2	3	4	5
(1 is least complying & 5 is highly complying)	✓					
Buildings with ground floor residential may integrate half-storey	'					
underground parking to a maximum of 1.2m above grade, with the						
following considerations:						
Semi-private spaces should be located above to soften the edge						
and be at a comfortable distance from street activity; and						
 Where conditions such as the high water table do not allow for 						
this condition, up to 2m is permitted, provided that entryways,						
stairs, landscaped terraces, and patios are integrated and that						
blank walls and barriers to accessibility are minimized.						
4.1.6 Building Articulation, Features & Materials						
Articulate building facades into intervals that are a maximum of 15m					✓	
wide for mixed-use buildings and 20m wide for residential buildings.						
Strategies for articulating buildings should consider the potential						
impacts on energy performance (see 2.2.1), and include:						
 Façade Modulation – stepping back or extending forward a 						
portion of the façade to create a series of intervals in the facade;						
 Repeating window patterns at intervals that correspond to 						
extensions and step backs (articulation) in the building facade;						
 Providing a porch, patio, deck, or covered entry for each interval; 						
 Providing a bay window or balcony for each interval, while 						
balancing the significant potential for heat loss through thermal						
bridge connections which could impact energy performance;						
 Changing the roof line by alternating dormers, stepped roofs, 						
gables, or other roof elements to reinforce the modulation or						
articulation interval;						
Changing the materials with the change in building plane; and						
Provide a lighting fixture, trellis, tree, or other landscape feature						
within each interval.						
Break up the building mass by incorporating elements that define a					✓	
building's base, middle and top.						
Use an integrated, consistent range of materials and colors and provide					✓	
variety by, for example, using accent colors.						
Articulate the facade using design elements that are inherent to the				✓		
building as opposed to being decorative. For example, create depth in						
building facades by recessing window frames or partially recessing						
balconies to allow shadows to add detail and variety as a byproduct of						
massing.						
Incorporate distinct architectural treatments for corner sites and highly				✓		
visible buildings such as varying the roofline (See Figure 41), articulating						
the facade, adding pedestrian space, increasing the number and size of						
windows, and adding awnings and canopies.						
Weather Protection ATTACHMENT		В				

This forms part of application
DP21-0119

City of

Planner Initials

LK

RELOWNA

DEVELOPMENT PLANNING

RATE PROPOSALS COMPLIANCE TO PERTINENT GUIDELINE	N/A	1	2	3	4	5
(1 is least complying & 5 is highly complying)						
Provide weather protection (e.g. awnings, canopies, overhangs, etc.) along all commercial streets and plazas (See Figure 42), with particular					√	
attention to the following locations:						
 Primary building entrances, 						
 Adjacent to bus zones and street corners where people wait for traffic lights; 						
 Over store fronts and display windows; and 						
 Any other areas where significant waiting or browsing by people 						
occurs.						
Architecturally-integrate awnings, canopies, and overhangs to the					✓	
building and incorporate architectural design features of buildings from						
which they are supported.						
Place and locate awnings and canopies to reflect the building's	✓					
architecture and fenestration pattern.						
Place awnings and canopies to balance weather protection with daylight						
penetration. Avoid continuous opaque canopies that run the full length						

