

Development Permit No. DP21-0139



This permit relates to land in the City of Kelowna municipally known as

165 Dougall Road South

and legally known as

Lot 11 Block B Section 23 Township 26 Osoyoos Division Yale District Plan 4740

and permits the land to be used for the following development:

Mixed-use residential and commercial

The present owner and any subsequent owner of the above described land must comply with any attached terms and conditions.

<u>Date of Council Decision</u> February 7, 2022

Decision By: COUNCIL

<u>Development Permit Area:</u> Form and Character Development Permit Area

Existing Zone: C4 – Urban Centre Commercial

Future Land Use Designation: UC – Urban Centre

This is NOT a Building Permit.

In addition to your Development Permit, a Building Permit may be required prior to any work commencing. For further information, contact the City of Kelowna, Development Services Branch.

NOTICE

This permit does not relieve the owner or the owner's authorized agent from full compliance with the requirements of any federal, provincial or other municipal legislation, or the terms and conditions of any easement, covenant, building scheme or agreement affecting the building or land.

Owner: Forever Destiny Homes Ltd., Inc.No. 0903896

Applicant: New Town Architecture and Engineering Inc.

Planner: K. Brunet

Terry Barton Date
Community Planning Department Manager
Planning & Development Services



1. SCOPE OF APPROVAL

This Development Permit applies to and only to those lands within the Municipality as described above, and any and all buildings, structures and other development thereon.

This Development Permit is issued subject to compliance with all of the Bylaws of the Municipality applicable thereto, except as specifically varied or supplemented by this permit, noted in the Terms and Conditions below.

The issuance of a permit limits the permit holder to be in strict compliance with regulations of the Zoning Bylaw and all other Bylaws unless specific variances have been authorized by the Development Permit. No implied variances from bylaw provisions shall be granted by virtue of drawing notations that are inconsistent with bylaw provisions and that may not have been identified as required Variances by the applicant or Municipal staff.

2. CONDITIONS OF APPROVAL

- a) The dimensions and siting of the building to be constructed on the land be in accordance with Schedule "A";
- b) The exterior design and finish of the building to be constructed on the land be in accordance with Schedule "B";
- c) Landscaping to be provided on the land be in accordance with Schedule "C";
- d) The applicant be required to post with the City a Landscape Performance Security deposit in the form of a "Letter of Credit" in the amount of 125% of the estimated value of the landscaping, as determined by a Registered Landscape Architect; and
- e) Payment-in-lieu of parking be provided for two (2) stalls according to Schedule "A" of Bylaw No. 8125;

This Development Permit is valid for two (2) years from the date of approval, with no opportunity to extend.

3. PERFORMANCE SECURITY

As a condition of the issuance of this Permit, Council is holding the security set out below to ensure that development is carried out in accordance with the terms and conditions of this Permit. Should any interest be earned upon the security, it shall accrue to the Developer and be paid to the Developer or his or her designate if the security is returned. The condition of the posting of the security is that should the Developer fail to carry out the development hereby authorized, according to the terms and conditions of this Permit within the time provided, the Municipality may enter into an agreement with the property owner of the day to have the work carried out, and any surplus shall be paid over to the property owner of the day. Should the Developer carry out the development permitted by this Permit within the time set out above, the security shall be returned to the Developer or his or her designate. There is filed accordingly:

a) An Irrevocable Letter of Credit OR certified cheque in the amount of \$74,346.84

Before any bond or security required under this Permit is reduced or released, the Developer will provide the City with a statutory declaration certifying that all labour, material, workers' compensation and other taxes and costs have been paid.

4. PARKING CASH-IN-LIEU BYLAW

Parking Cash-in-Lieu in the amount of **\$19,000.00** required for two (2) stalls as part of the proposed development within the Rutland Urban Centre (Rate of **\$9,500.00** per off street parking space).



5. INDEMNIFICATION

Upon commencement of the works authorized by this Permit the Developer covenants and agrees to save harmless and effectually indemnify the Municipality against:

a) All actions and proceedings, costs, damages, expenses, claims, and demands whatsoever and by whomsoever brought, by reason of the Municipality said Permit.

All costs, expenses, claims that may be incurred by the Municipality where the construction, engineering or other types of works as called for by the Permit results in damages to any property owned in whole or in part by the Municipality or which the Municipality by duty or custom is obliged, directly or indirectly in any way or to any degree, to construct, repair, or maintain.

The PERMIT HOLDER is the <u>CURRENT LAND OWNER</u>. Security shall <u>ONLY</u> be returned to the signatory of the Landscape Agreement or their designates.

DOUGALL RD MIXED-USE

REV. ISSUE FOR DP, 2021-11-02



ALL CONTRACTORS ARE REQUIRED TO PERFORM THEIR WORK AND SUPPLY THEIR PRODUCTS IN COMPLIANCE WITH ALL BUILDING CODES AND LAWS OF THE PROVINCE OF BRITISH COLUMBIA This drawing is an instrument of service and the property of New Town Services. The use of this drawing shall be restricted to the original site for which it was prepared and publication thereof is expressly limited to such use.

Verify all dimensions and datums prior to





Revi	sions	
No.	DATE	DESCRIPTION
1	2021-05-28	ISSUED FOR DP
2	2021-11-02	REV. ISSUE FOR DP

OUTLAND LANDSCAPE ARCHITECTURE 303-590 KLO ROAD KELOWNA, BC V1Y 7S2

OFFISTE PLAN:
L1/2 OFFSITE LANDSCAPE PLAN
L2/2 OFFSITE IRRIGATION PLAN

ARCHITECTURAL

NEW TOWN ARCHITECTURE & ENGINEERING 200-1464 ST. PAUL STREET KELOWNA, BC V1Y 2E6 e: roman@newtownservices.net t: (250) 860-8185

A0.01D ZONING & BYLAW

A1.01D SITE PLAN & LEVEL 1 FLOOR PLAN
A3.01D LEVEL 2 & 3 FLOOR PLANS

A3.02D LEVEL 4 FLOOR & ROOF PLAN A4.01D BUILDING ELEVATIONS

A4.02D BUILDING ELEVATIONS A4.11D MATERIALS

A9.01D RENDERINGS

LANDSCAPE

e: fiona@outlanddesign.ca t: (250) 868-9270

DEVELOPMENT PLANS:

L1/2 CONCEPTUAL LANDSCAPE DESIGN
L2/2 WATER CONSERVATION/IRRIGATION PLAN

DOUGALL MIXED-USE project address 165 DOUGALL RD S, KELOWNA, BC project no.

drawing title		
COVE	ER	PAG

4154

PROJECT NAME

ADDRESS: 165 DOUGALL RD S, KELOWNA, BRITISH COLUMBIA, CANADA

LEGAL ADDRESS:
Plan: KAP4740 Lot: 11 Block: B

REQUIRED:

GRADES:
EXISTING: FLAT PROPOSED: FLAT

NUMBER OF BUILDINGS:
1 BUILDING
5 x 2-BED TOWNHOMES

75m² COMMERCIAL UNIT ON MAIN LEVEL

ZONING ANALYSIS

EXISTING: PROPOSED: C4 - URBAN COMMERCIAL C4 - URBAN COMMERCIAL

C4 ZONING REQUIREMENTS

REQUIRED:	PROPOSED:
SITE AREA (m²) 460.00m²	567m²
SITE WIDTH (m) 13.0m (40.0m WITH NO ABUTTING LANE)	15.2m
SITE DEPTH (m) 30.0m	36.6m
MAXIMUM SITE COVERAGE FOR BUILDINGS (%) 75%	73.8%

PROPOSED:

N/A 5 (1x CASH IN LIEU)

DEVELOPMENT REQUIREMENTS

TOTAL NUMBER & TYPES OF UNITS:	5x 2-BEDROOM TOWNHOUSES
FLOOR AREA (GFA/NFA)(m²): 737.1m² MAXIMUM	737.1m²

FLOOR AREA RATIO:
1.3

BUILDING HEIGHT (m):
15.0m or 4 STOREYS

14.0m (4 STOREYS)

 SETBACKS (m):

 FRONT (SOUTH)
 0.0m
 3.20m

 SIDE A (WEST)
 0.0m
 1.15m

 SIDE B (EAST)
 0.0m
 0.15m

 BACK (NORTH)
 0.0m
 2.15m

 PRIVATE OPEN SPACE (m²):

 UNIT 1 (<1 BED)</td>
 15.0m²
 69.78m²

 UNIT 2 (<1 BED)</td>
 15.0m²
 54.11m²

 UNIT 3 (<1 BED)</td>
 15.0m²
 54.11m²

 UNIT 4 (<1 BED)</td>
 15.0m²
 54.11m²

 UNIT 5 (<1 BED)</td>
 15.0m²
 91.26m²

 TOTAL
 75.0m²
 323.37m²

UNIT 5 (<1 BED) 15.0m²

TOTAL 75.0m²

PARKING STALLS (COMMERCIAL):

REGULAR 1 (1.3 PER 100m² GFA)

SMALL N/A

TOTAL 6

BIKE STALLS (COMMERCIAL):
REGULAR (LONG TERM) 1 (1 PER 500m² GFA)
REGULAR (SHORT TERM) 2 (2 PER ENTRY)

REGULAR (SHORT TERM) 2 (2 PER ENTRY)

BIKE STALLS (RESIDENTIAL):
REGULAR (LONG TERM) 4 (0.75 PER 2-BED)
REGULAR (SHORT TERM) 6 (6 PER ENTRY)

FAR SCHEDULE

No.	NAME	AREA (SF)	AREA (SM)	COMMENTS
LEVEL 1				
101	CRU	804 SF	74.66 m²	COMMERCIAL
LEVEL 2				
201	UNIT 1	435 SF	40.44 m²	RES - UNIT 1
202	UNIT 2	618 SF	57.42 m²	RES - UNIT 2
203	UNIT 3	618 SF	57.42 m²	RES - UNIT 3
204	UNIT 4	618 SF	57.42 m²	RES - UNIT 4
205	UNIT 5	571 SF	53.09 m ²	RES - UNIT 5
LEVEL 3 301	UNIT 1	741 SF	68.88 m²	RES - UNIT 1
302	UNIT 2	618 SF	57.37 m²	RES - UNIT 2
303	UNIT 3	618 SF	57.42 m²	RES - UNIT 3
304	UNIT 4	618 SF	57.42 m ²	RES - UNIT 4
305	UNIT 5	571 SF	53.09 m ²	RES - UNIT 5
LEVEL 4				
402	UNIT 2	183 SF	17.02 m²	RES - UNIT 2
403	UNIT 3	182 SF	16.9 m²	RES - UNIT 3
404	UNIT 4	184 SF	17.08 m²	RES - UNIT 4
405	UNIT 1	135 SF	12.54 m²	RES - UNIT 1
406	UNIT 5	47 SF	4.32 m²	RES - UNIT 5
Grand total		7562 SF	702.5 m ²	





EXISTING NORTH WEST VIEW



EXISTING WEST VIEW





MUST FOR CONSTR

project title

DOUGALL MIXED-USE

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DESCRIPTION

1 2021-05-28 ISSUED FOR DP

2 | 2021-11-02 | REV. ISSUE FOR DP

project address

165 DOUGALL RD S,
KELOWNA, BC

project no.

4154

file no.

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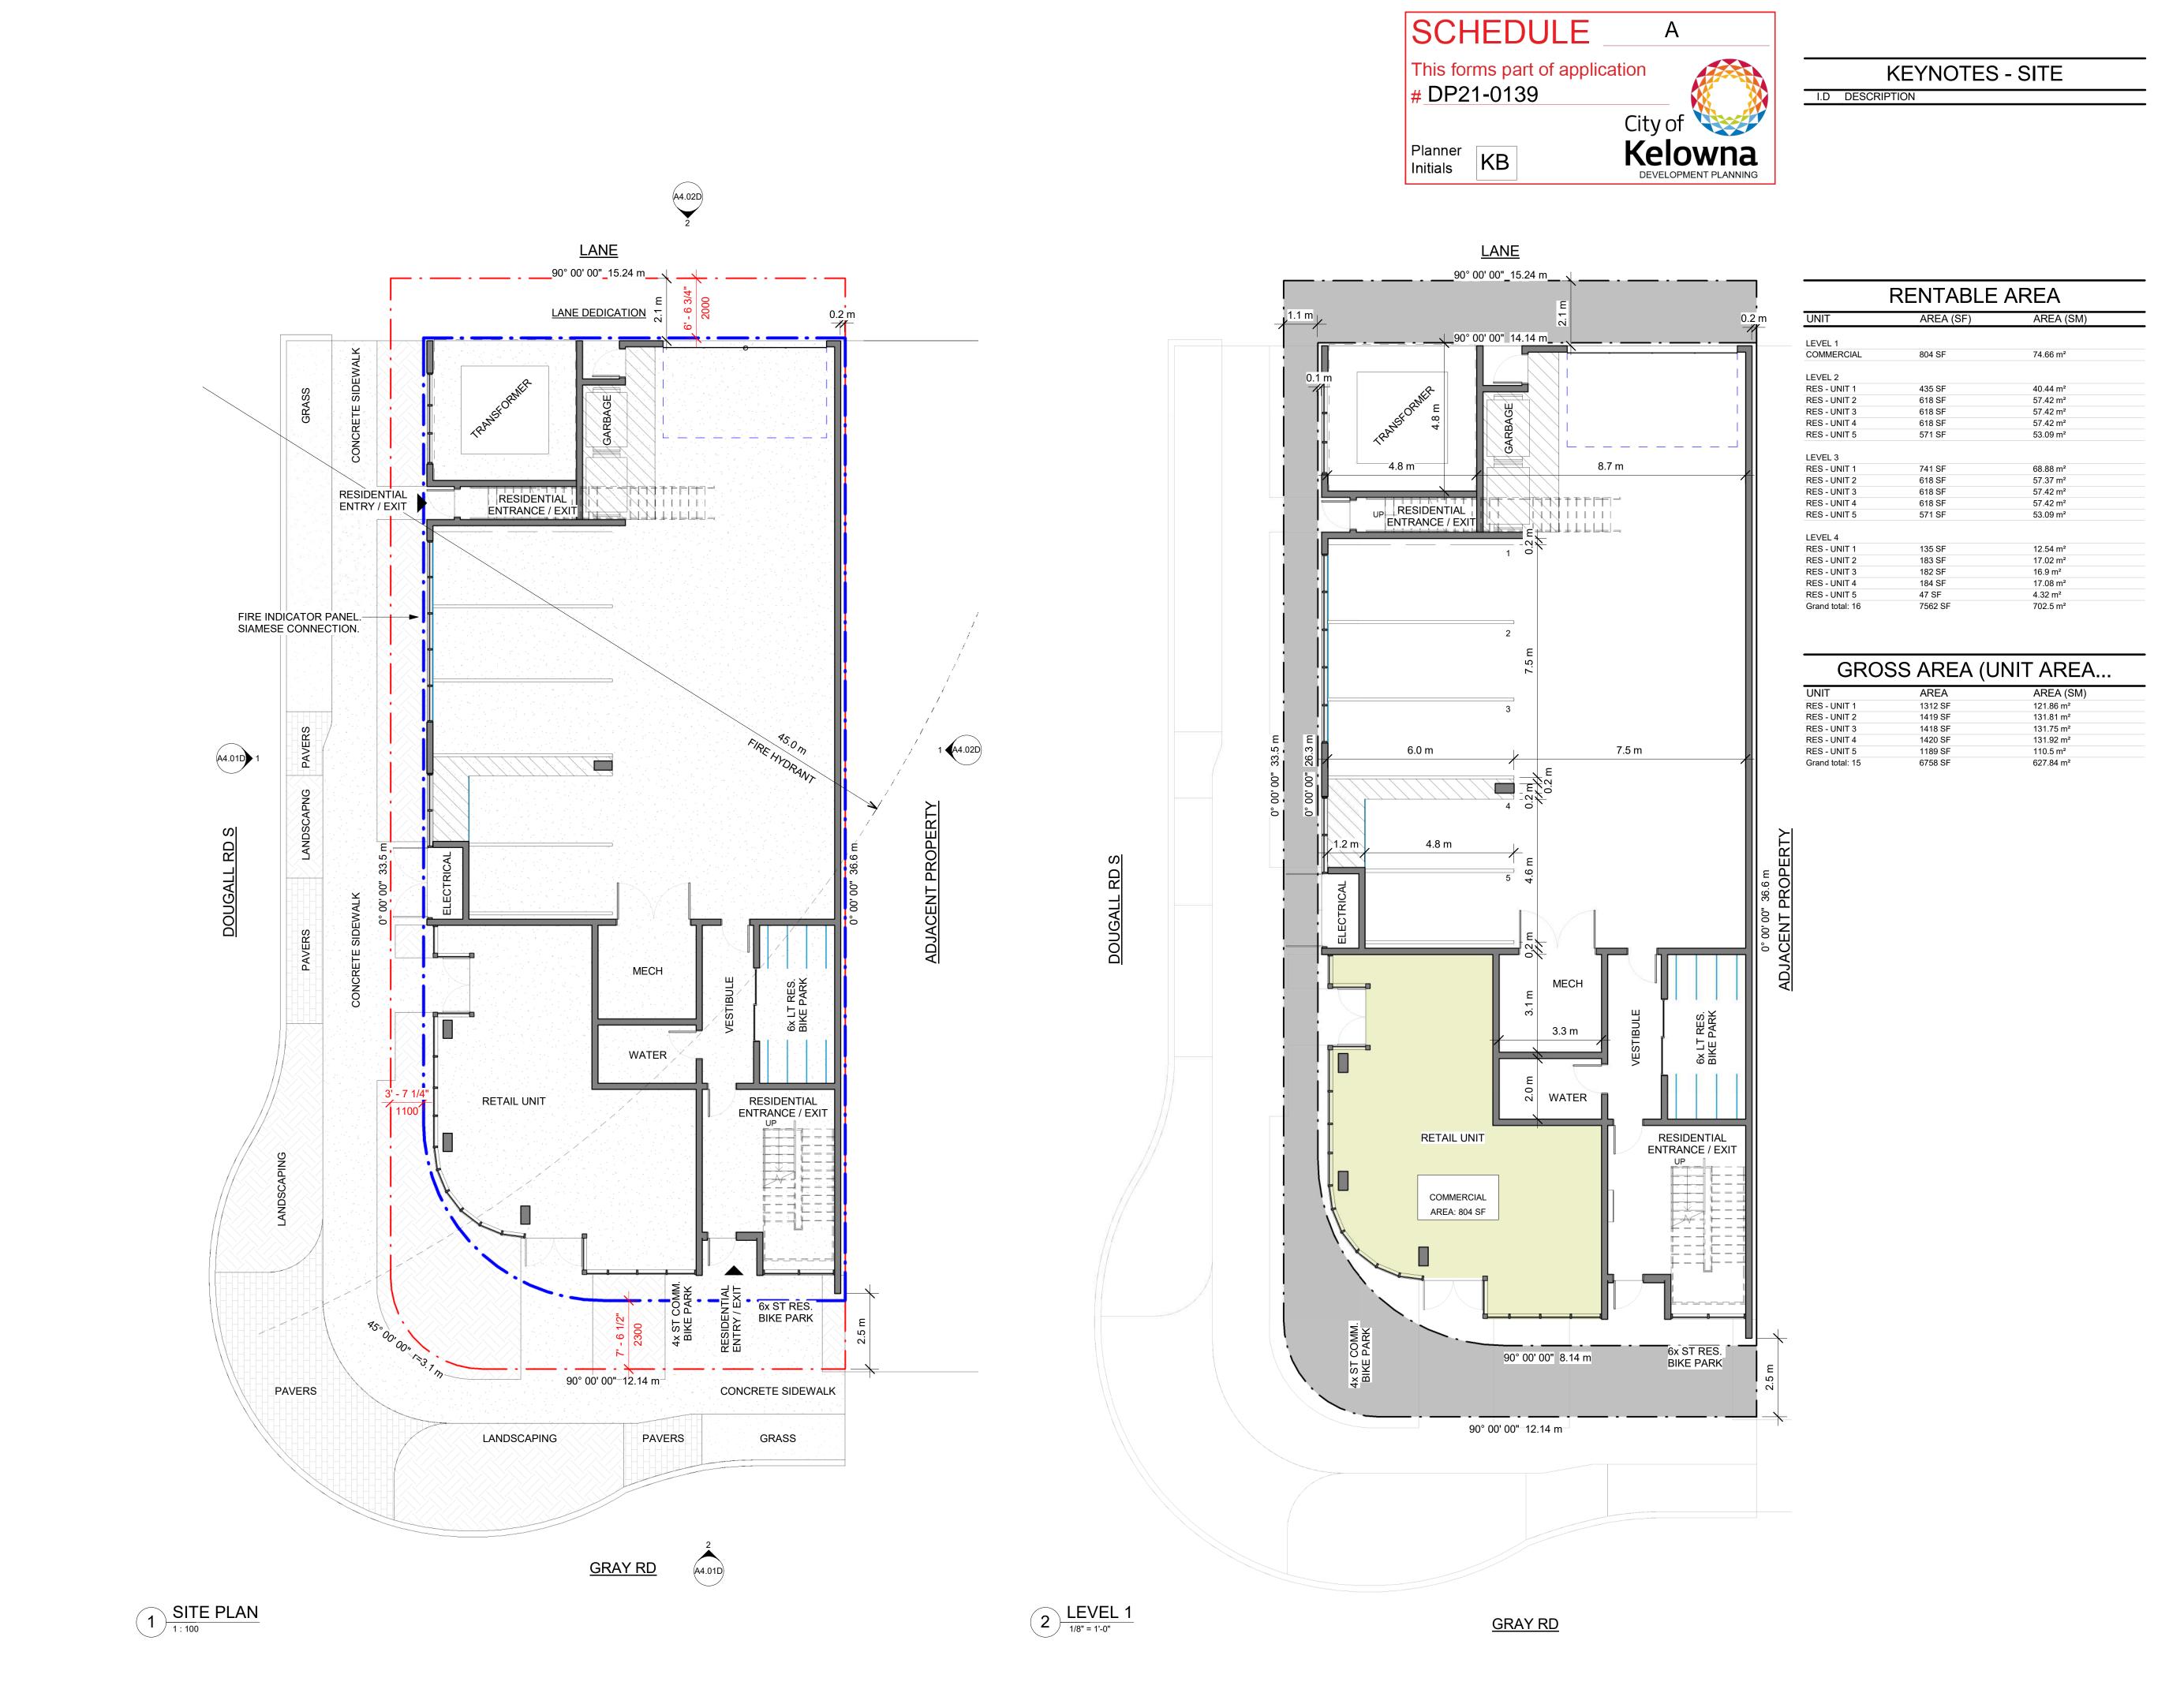
drawing title


ZONING &

BYLAW

designed RY scale 1 : drawn Find the checked

A0.01



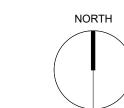

Revisions No. DATE DESCRIPTION 1 2021-05-28 ISSUED FOR DP 2 | 2021-11-02 | REV. ISSUE FOR DP

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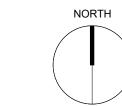
project address 165 DOUGALL RD S, KELOWNA, BC


4154

drawing title SITE PLAN & LEVEL 1 FLOOR **PLAN**

SCHEDULE В This forms part of application # DP21-0139 Kelowna DEVELOPMENT PLANNING Planner Initials KB

KEYNOTES - FLOOR PLAN I.D DESCRIPTION



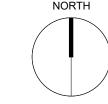



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RENTABLE AREA				
UNIT	AREA (SF)	AREA (SM)		
LEVEL 1				
COMMERCIAL	804 SF	74.66 m²		
LEVEL 2				
RES - UNIT 1	435 SF	40.44 m²		
RES - UNIT 2	618 SF	57.42 m²		
RES - UNIT 3	618 SF	57.42 m²		
RES - UNIT 4	618 SF	57.42 m²		
RES - UNIT 5	571 SF	53.09 m²		
I E) (E) 0				
LEVEL 3	744.05	CO 00 2		
RES - UNIT 1 RES - UNIT 2	741 SF	68.88 m² 57.37 m²		
RES - UNIT 2	618 SF 618 SF	57.37 m² 57.42 m²		
RES - UNIT 3	618 SF	57.42 m²		
RES - UNIT 5	571 SF	57.42 m² 53.09 m²		
KES - UNIT 3	5/15F	55.09 111-		
LEVEL 4				
RES - UNIT 1	135 SF	12.54 m²		
RES - UNIT 2	183 SF	17.02 m²		
RES - UNIT 3	182 SF	16.9 m²		
RES - UNIT 4	184 SF	17.08 m²		
RES - UNIT 5	47 SF	4.32 m²		
Grand total: 16	7562 SF	702.5 m ²		

GROS	SS AREA (UNIT AREA	
IIT	AREA	AREA (SM)	
S - UNIT 1	1312 SF	121.86 m²	
S - UNIT 2	1419 SF	131.81 m²	
S - UNIT 3	1418 SF	131.75 m²	
S - UNIT 4	1420 SF	131.92 m²	
S - UNIT 5	1189 SF	110.5 m²	
ind total: 15	6758 SF	627.84 m²	

OPENING/S ALTERNATE SOLUTION REQUIRED RES - UNIT 2 AREA: 618 SF RES - UNIT 3 AREA: 618 SF 3.9 m RES - UNIT 4 AREA: 618 SF RES - UNIT 5 AREA: 571 SF

90° 00' 00" 12.14 m

__90° 00' 00"_15.24 m__

RES - UNIT 1 AREA: 741 SF

1 LEVEL 2
1/8" = 1'-0"

__90° 00' 00"_15.24 m___

RES - UNIT 1 AREA: 435 SF

UP

90° 00' 00" 12.14 m

RES - UNIT 2 AREA: 618 SF

RES - UNIT 3 AREA: 618 SF

AREA: 618 SF

PATIO

PATIO

PATIO

3.9 m

1.5 m



DOUGALL MIXED-USE

project address 165 DOUGALL RD S, KELOWNA, BC


4154 drawing title **LEVEL 2 & 3** FLOOR PLANS


SCHEDULE This forms part of application #_DP21-0139 Planner Initials KB Initials

3.8 m

KEYNOTES - FLOOR PLAN I.D DESCRIPTION



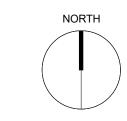

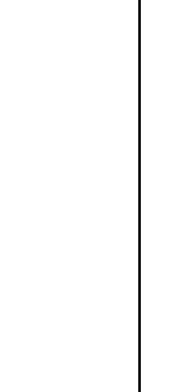

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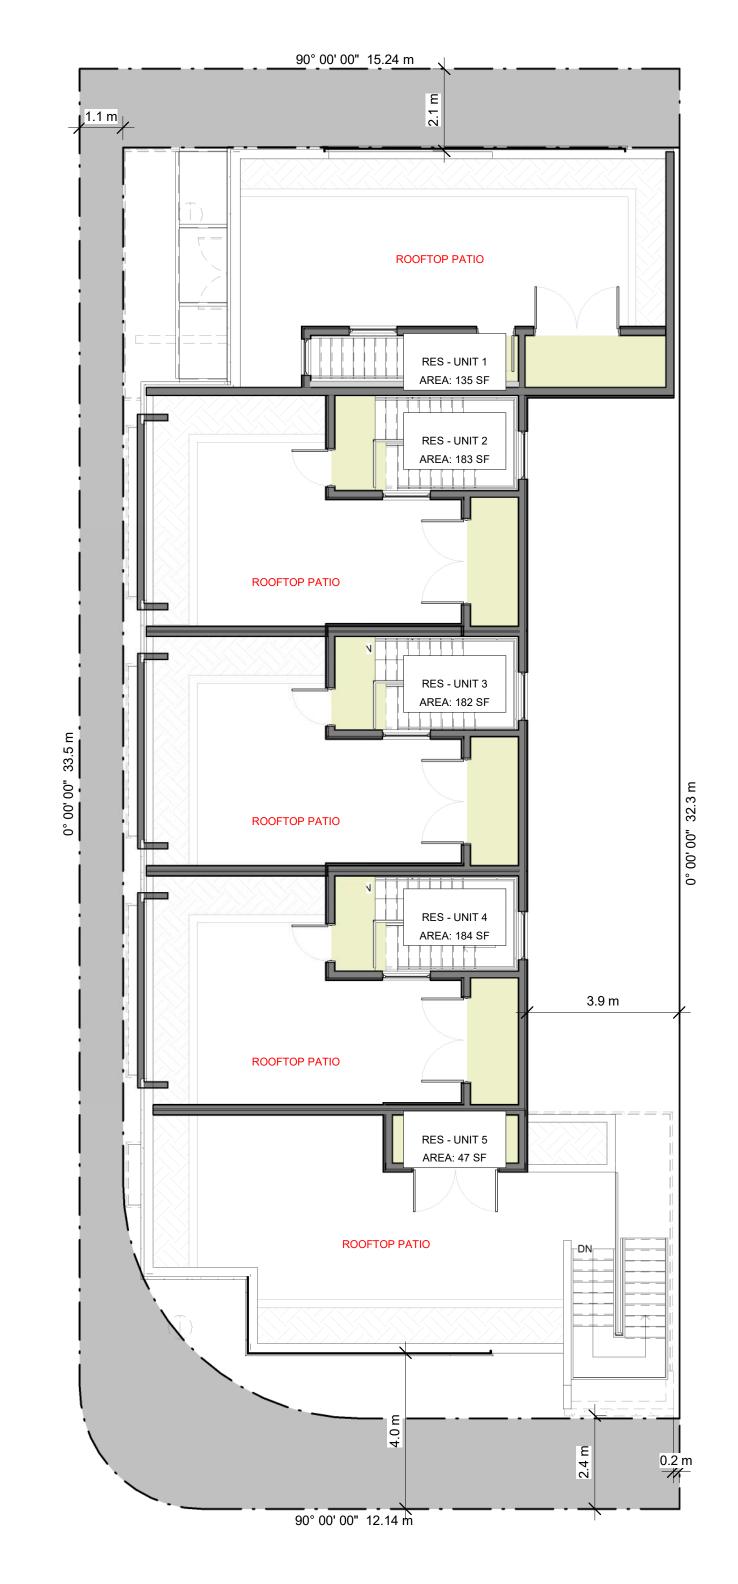
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and total: 15	6758 SF	627.84 m²	



1 LEVEL 4
1/8" = 1'-0"



90° 00' 00" 12.14 m

DOUGALL MIXED-USE

project address 165 DOUGALL RD S, KELOWNA, BC

4154
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LEVEL 4 FLOOR & ROOF PLAN

designed		scale	
-	RY		1/8" = 1
drawn			
checked			





PARAPET 42' - 11 1/4"

LEVEL 4 33' - 0 3/8"

LEVEL 3 23' - 1 1/2"

LEVEL 2 13' - 1 1/2"

KEYNOTES - ELEVATION I.D DESCRIPTION

MATERIAL LEGEND

- 1. ARCHITECTURAL CONCRETE
- BRICK VENEER PANEL
- 3. STUCCO COFFEE BROWN
- BUILT-UP CORNICES / MOLDINGS COLOR GREY
- 5. PICKET RAILING
- 6. STOREFRONT / WINDOWS ANODIZED ALUMINUM
- 7. VINYL AWNINGS
- OVERHEAD GARAGE DOORS BROWN
- 9. STEEL CANOPIES

project title DOUGALL MIXED-USE

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DESCRIPTION

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4154



I.D DESCRIPTION

KEYNOTES - ELEVATION

MATERIAL LEGEND

PARAPET 42' - 11 1/4"

LEVEL 4 33' - 0 3/8"

LEVEL 3 23' - 1 1/2"

LEVEL 2 13' - 1 1/2"

LEVEL 1 0 m

This forms part of application

В

Kelowna DEVELOPMENT PLANNING

SCHEDULE

DP21-0139

Planner Initials KB

- 1. ARCHITECTURAL CONCRETE
- 2. BRICK VENEER PANEL
- 3. STUCCO COFFEE BROWN
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TEOR CONSTRUCT

project title
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DESCRIPTION

1 2021-05-28 ISSUED FOR DP 2 2021-11-02 REV. ISSUE FOR DP

roject address

project address

165 DOUGALL RD S,
KELOWNA, BC

project no.

project no. 4154

file no. C:\Users\drafter\Desktop\4154 - Dougell Rd S_NT_Dale_nt

drawing title

BUILDING

ELEVATIONS

designed RY Scale As indice drawn checked

checked RY drawing no.

COLOUR & CODE: OLD CHICAGO I.D NUMBER:

T.B.C

BLACK

N/A

STOREFRONT

BRAMPTON BRICK

HISTORIC

MANUFACTURER:

MANUFACTURER:

COLOUR & CODE:

PRODUCT:

I.D NUMBER:


PRODUCT:

MANUFACTURER: PRODUCT: COLOUR & CODE: I.D NUMBER:

CONCRETE EXPOSED/CLEAR SEALED

MANUFACTURER: PRODUCT: COLOUR & CODE: I.D NUMBER:

N/A STUCCO COFFEE BROWN N/A

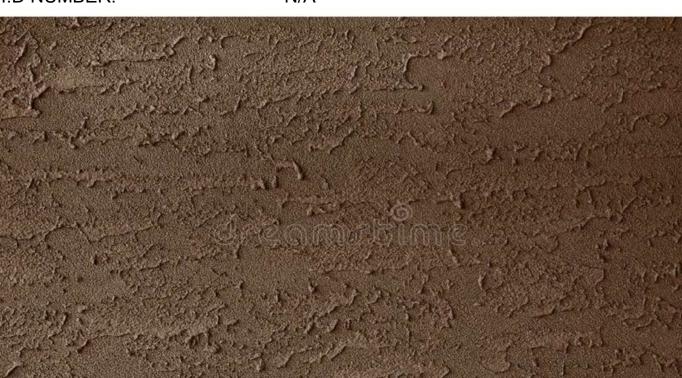

SAMPLE FOR COLOUR

PURPOSES ONLY

MANUFACTURER: PRODUCT: COLOUR & CODE: I.D NUMBER:

BALUSTRADE **BLACK** N/A



SAMPLE FOR COLOUR **PURPOSES ONLY**

> MANUFACTURER: PRODUCT: COLOUR & CODE:

I.D NUMBER:

URBAN RACKS URBAN CORAAL STAINLESS STEEL N/A



SAMPLE FOR COLOUR **PURPOSES ONLY**

SAMPLE FOR COLOUR

PURPOSES ONLY

MANUFACTURER: PRODUCT: COLOUR & CODE: I.D NUMBER:

SCHEDULE

This forms part of application

Planner Initials

DP21-0139



В

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DOUGALL MIXED-USE

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4154 project no. C:\Users\drafter\Desktop\4154 - Dougall Rd S_NT_Dale.rvt drawing title MATERIALS

SAMPLE FOR COLOUR PURPOSES ONLY



GREY STREET VIEW - DAY



SOUTH WEST STREET VIEW - NIGHT



NORTH WEST STREET VIEW - DAY



NORTH WEST AERIAL VIEW - DAY



Planner Initials KB

City of Kelowna

DEVELOPMENT PLANNING

project title

project address

project no.

drawing title

DOUGALL MIXED-USE

165 DOUGALL RD S, KELOWNA, BC

RENDERINGS

A9.01D

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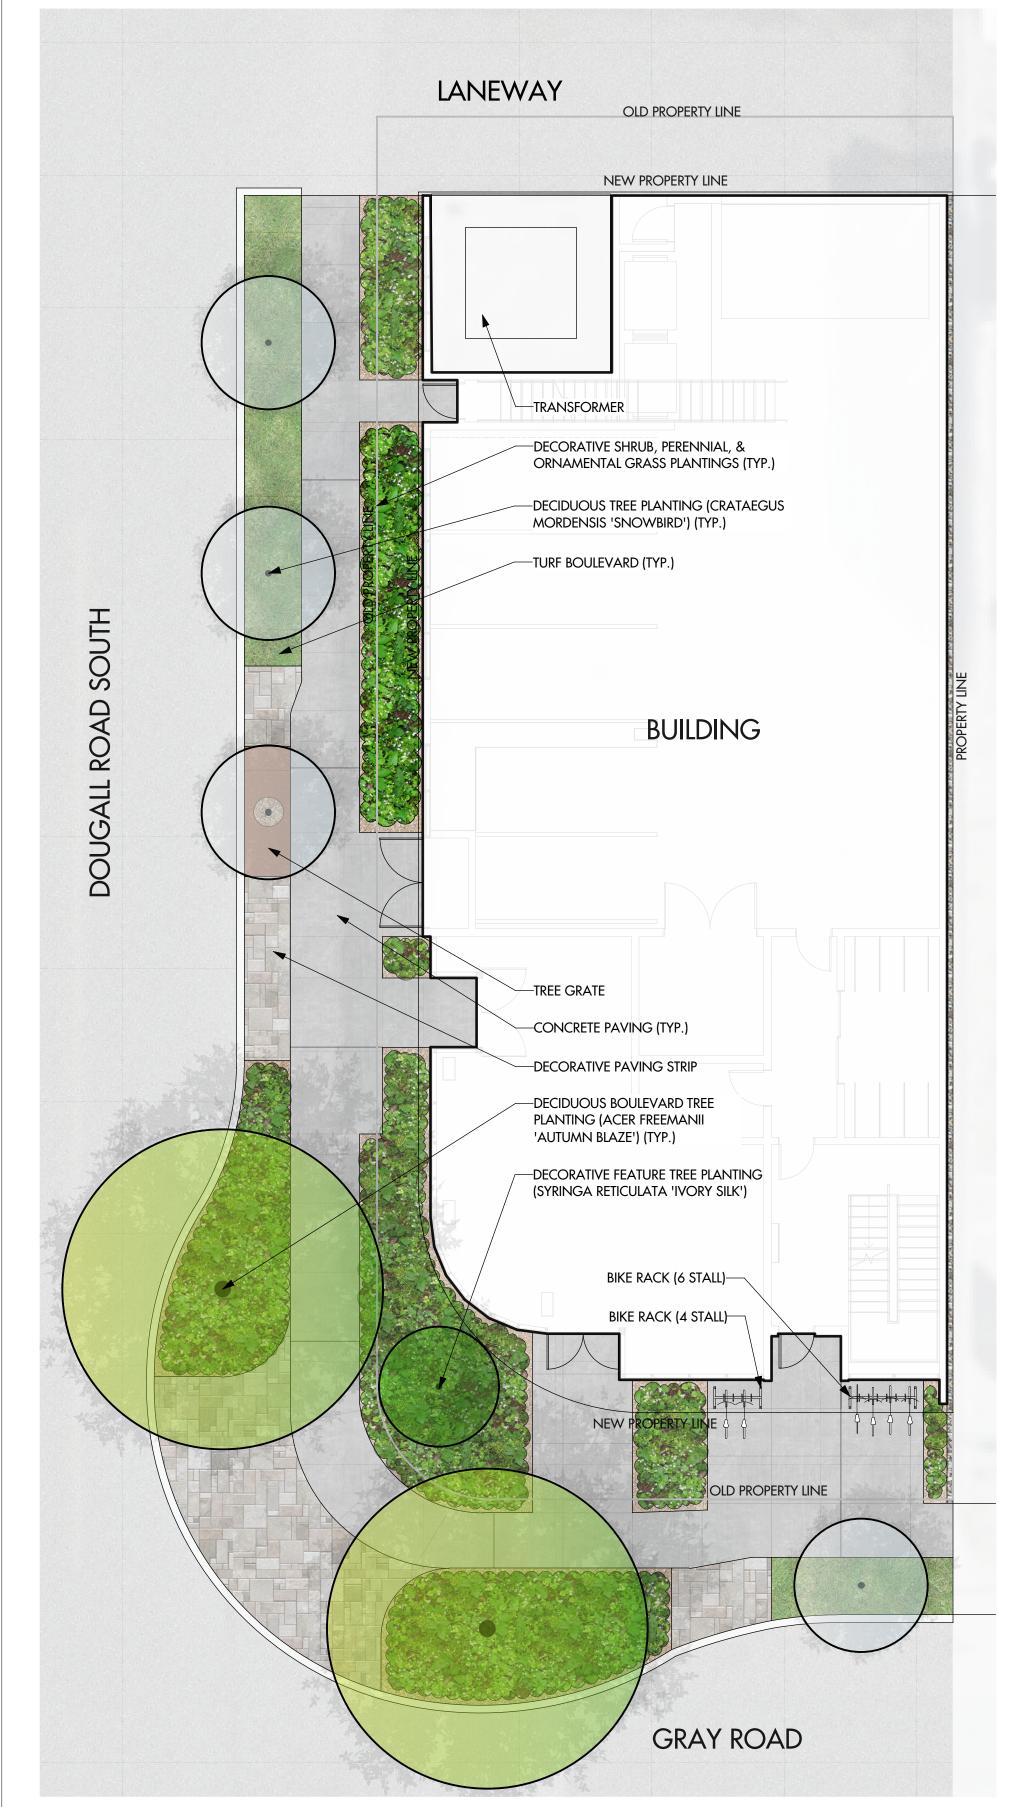
Report all errors and omissions to the Architect.


NEW TOWN

URBAN PLANNING CIVIL ENGINEERING www.newtownservices.ca

DESCRIPTION

1 2021-05-28 ISSUED FOR DP 2 | 2021-11-02 | REV. ISSUE FOR DP 25 M



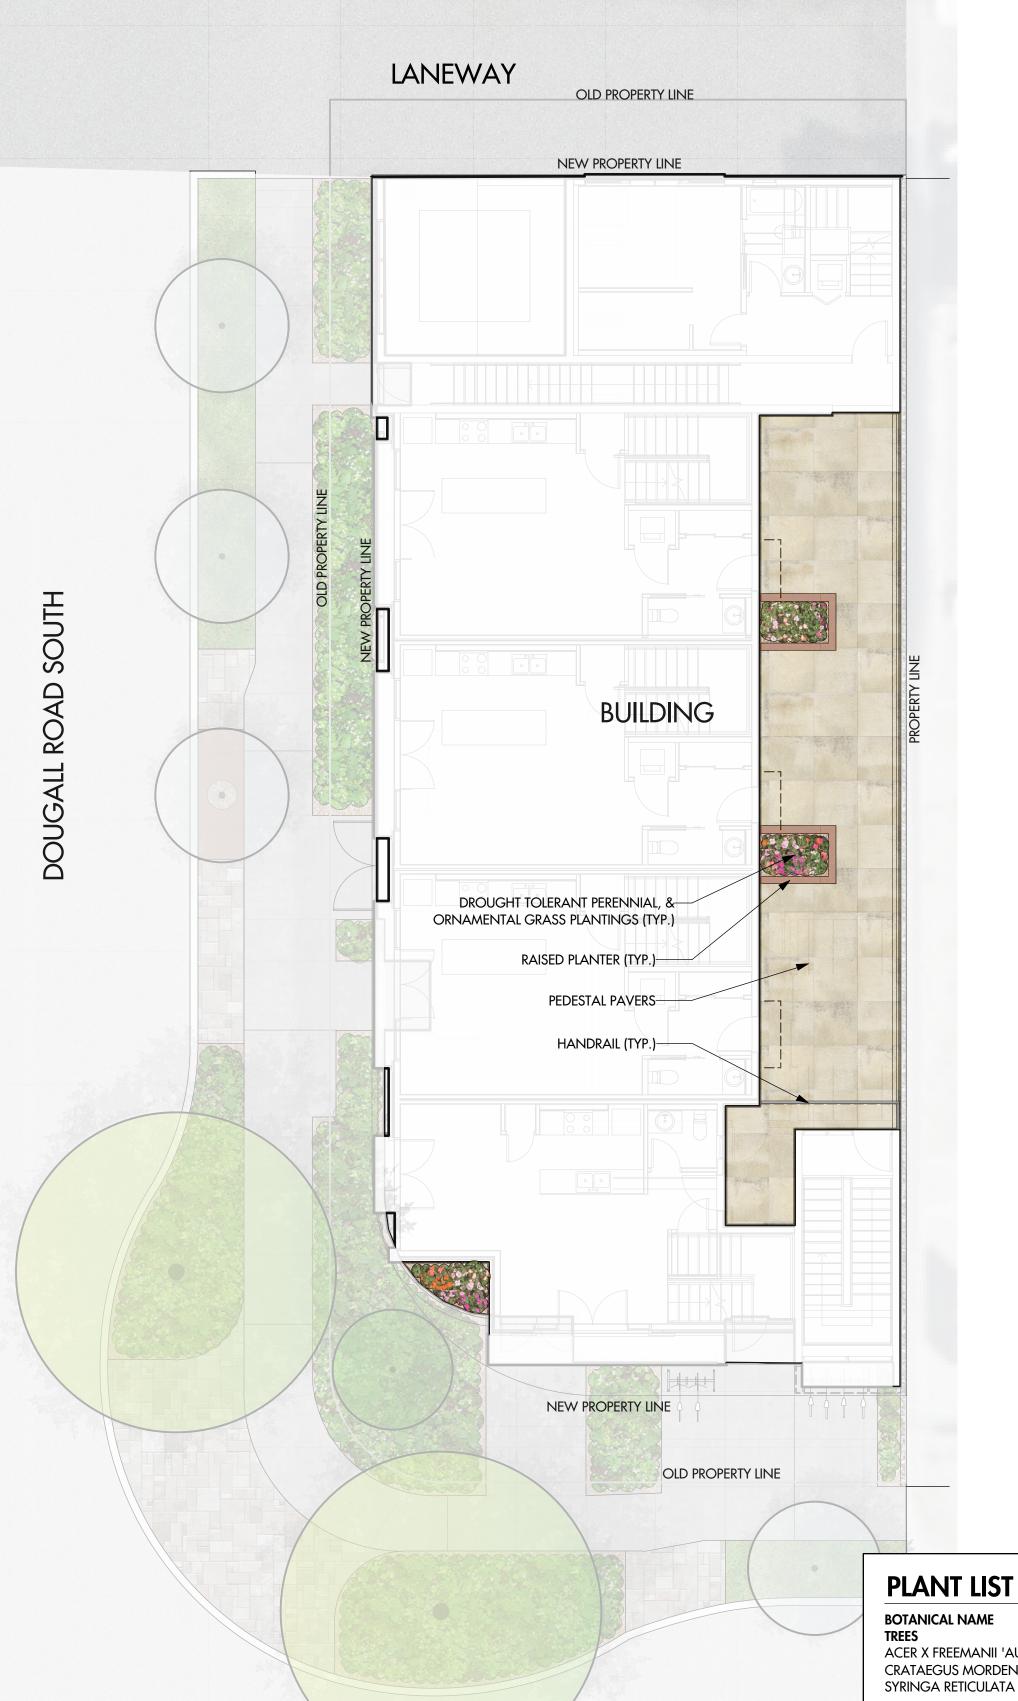

SCHEDULE This forms part of application # DP21-0139 Kelowna DEVELOPMENT PLANNING Planner Initials KB



303-590 KLO Road Kelowna, BC V1Y 7S2 T (250) 868-9270 www.outlanddesign.ca



PROJECT TITLE

DOUGALL MIXED USE 165 DOUGALL ROAD SOUTH

Kelowna, BC

DRAWING TITLE

ISSUED FOR / REVISION

CONCEPTUAL LANDSCAPE PLAN

1	21.05.26	Review
2	21.10.15	Review
3	21.10.29	Review
4		
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PROJECT NO	21-079
DESIGN BY	KM
DRAWN BY	MC/TR
CHECKED BY	FB
DATE	OCT. 29, 2021
SCALE	1:100
PAGE SIZE	24"x36"



DRAWING NUMBER

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NOTES

1. PLANT MATERIAL AND CONSTRUCTION METHODS SHALL MEET OR EXCEED THE CANADIAN NURSERY LANDSCAPE ASSOCIATION STANDARDS. ALL OFFSITE LANDSCAPE WORKS TO MEET CITY OF KELOWNA BYLAW 7900 STANDARDS.

2. ALL SOFT LANDSCAPE AREAS SHALL BE WATERED BY A FULLY AUTOMATIC TIMED UNDERGROUND IRRIGATION SYSTEM.

3. TREE AND SHRUB BEDS TO BE DRESSED IN A MINIMUM 75mm BLACK WOOD MULCH OR DECORATIVE ROCK MULCH, AS SHOWN IN PLANS. DO NOT PLACE WEED MAT UNDERNEATH TREE AND SHRUB BEDS IN WOOD MULCH AREAS.

4. TREE AND SHRUB BEDS TO RECEIVE A MINIMUM 300mm DEPTH TOPSOIL PLACEMENT.

5. TURF AREAS FROM SOD SHALL BE NO. 1 GRADE GROWN FROM CERTIFIED SEED OF IMPROVED CULTIVARS REGISTERED FOR SALE IN B.C. AND SHALL BE TOLERANT OF DROUGHT CONDITIONS. A MINIMUM OF 150mm DEPTH OF GROWING MEDIUM IS REQUIRED BENEATH TURF AREAS. TURF AREAS SHALL MEET EXISTING GRADES AND HARD SURFACES FLUSH.

6. SITE GRADING AND DRAINAGE WILL ENSURE THAT ALL STRUCTURES HAVE POSITIVE DRAINAGE, AND THAT NO WATER OR LOOSE IMPEDIMENTS WILL BE DISCHARGED FROM THE LOT ONTO ADJACENT PUBLIC, COMMON, OR PRIVATE PROPERTIES.

GRAY ROAD

BOTANICAL NAME
TREES
ACER X FREEMANII 'AUTUMN BLAZE'
CRATAEGUS MORDENSIS 'SNOWBIRD'
SYRINGA RETICULATA 'IVORY SILK'

SHRUBS BUXUS 'GREEN GEM' CORNUS SERICEA 'KELSEYI' HYDRANGEA PANICULATA 'JAN' PINUS ABIES 'NIDIFORMIS' SPIREA BULMALDA 'ANTHONY WATERER'

PERENNIALS, GRASSES & GROUNDCOVERS

GREEN GEM BOXWOOD KELSEY DOGWOOD LITTLE LIME HYDRANGEA NEST SPRUCE

COMMON NAME

AUTUMN BLAZE MAPLE

SNOWBIRD HAWTHORN

IVORY SILK TREE LILAC

SUMMER PASTELS YARROW SILVER MOUND ARTEMISIA

ANTHONY WATERER SPIREA

RUBY STELLA DAYLILY

FOUNTAIN GRASS

ACHILLEA MILLEFOLIUM 'SUMMER PASTELS' ARTEMISIA SCHMIDTIANA 'SILVER MOUND' HEMEROCALLIS 'RUBY STELLA' PENNISETUM ALOPECUROIDES SEDUM SPECTABILE 'AUTUMN JOY'

AUTUMN JOY STONECROP

#01 CONT. /0.9M O.C. SPACING #01 CONT. /0.6M O.C. SPACING #01 CONT. /0.6M O.C. SPACING #01 CONT. /1.0M O.C. SPACING #01 CONT. /0.6M O.C. SPACING

SIZE/SPACING & REMARKS

#02 CONT. /0.9M O.C. SPACING

#02 CONT. /1.0M O.C. SPACING

#02 CONT. /1.5M O.C. SPACING

#02 CONT. /1.5M O.C. SPACING

#02 CONT. /1.2M O.C. SPACING

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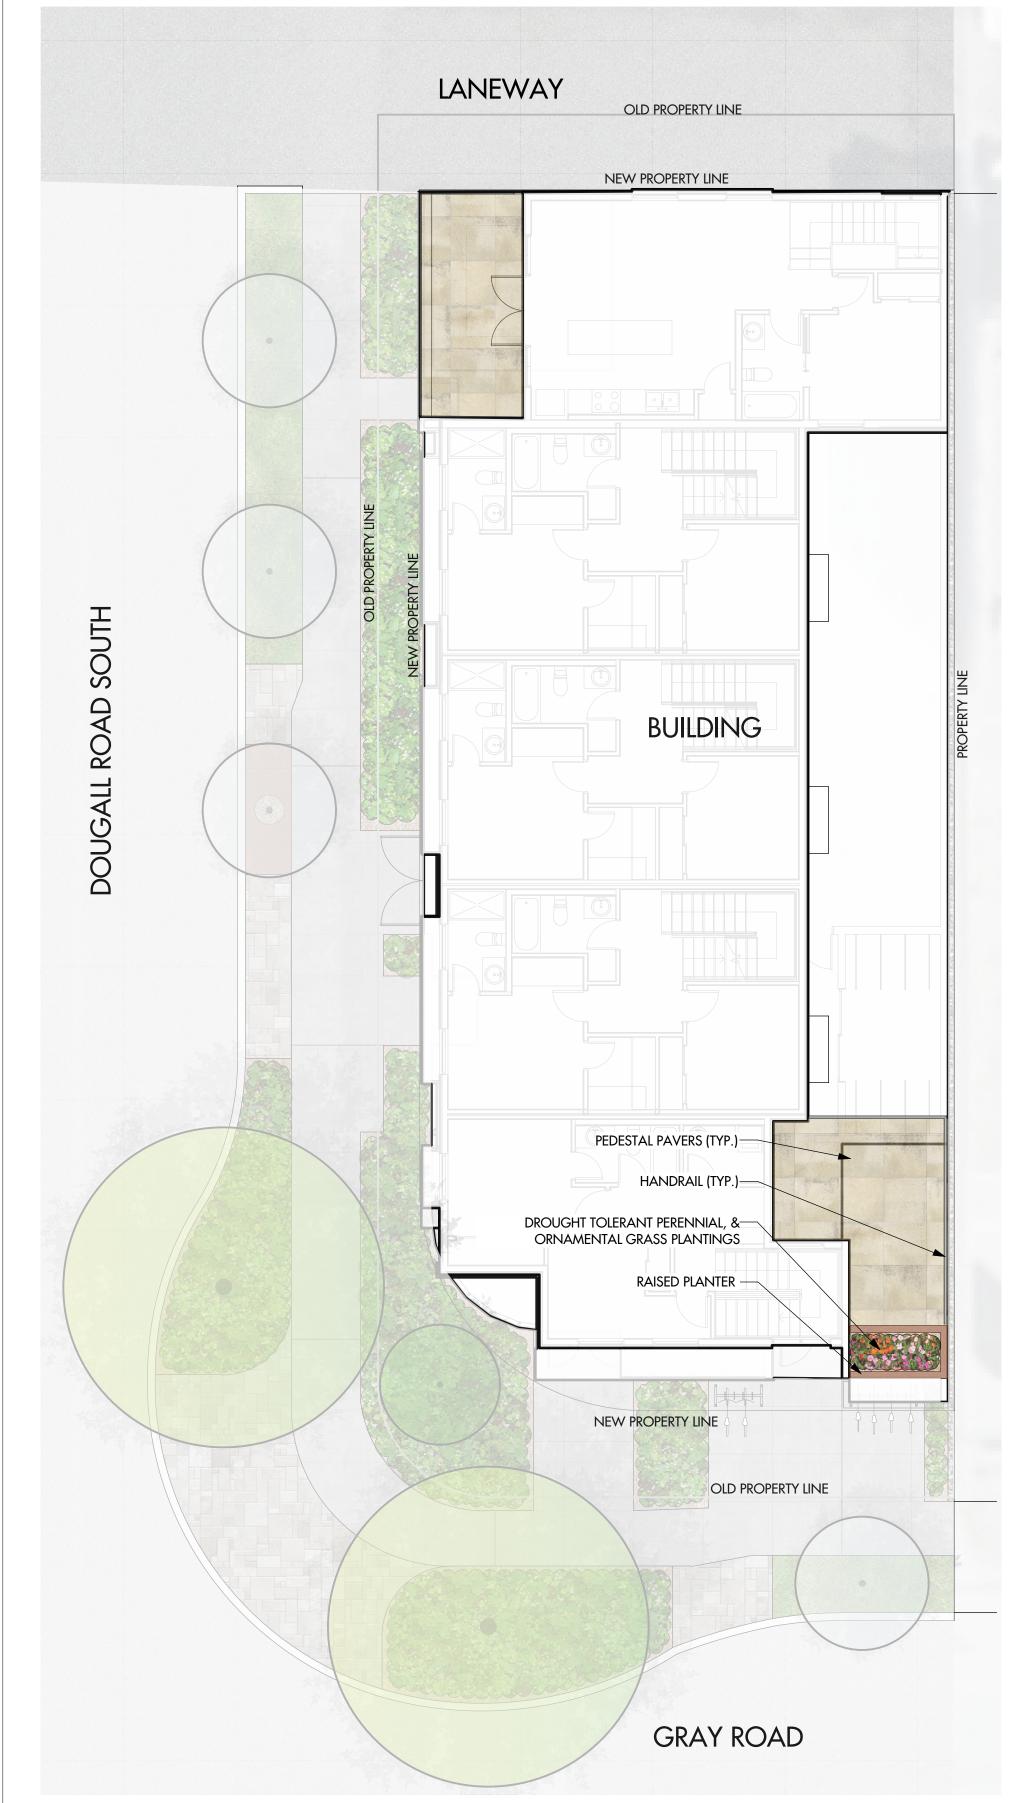
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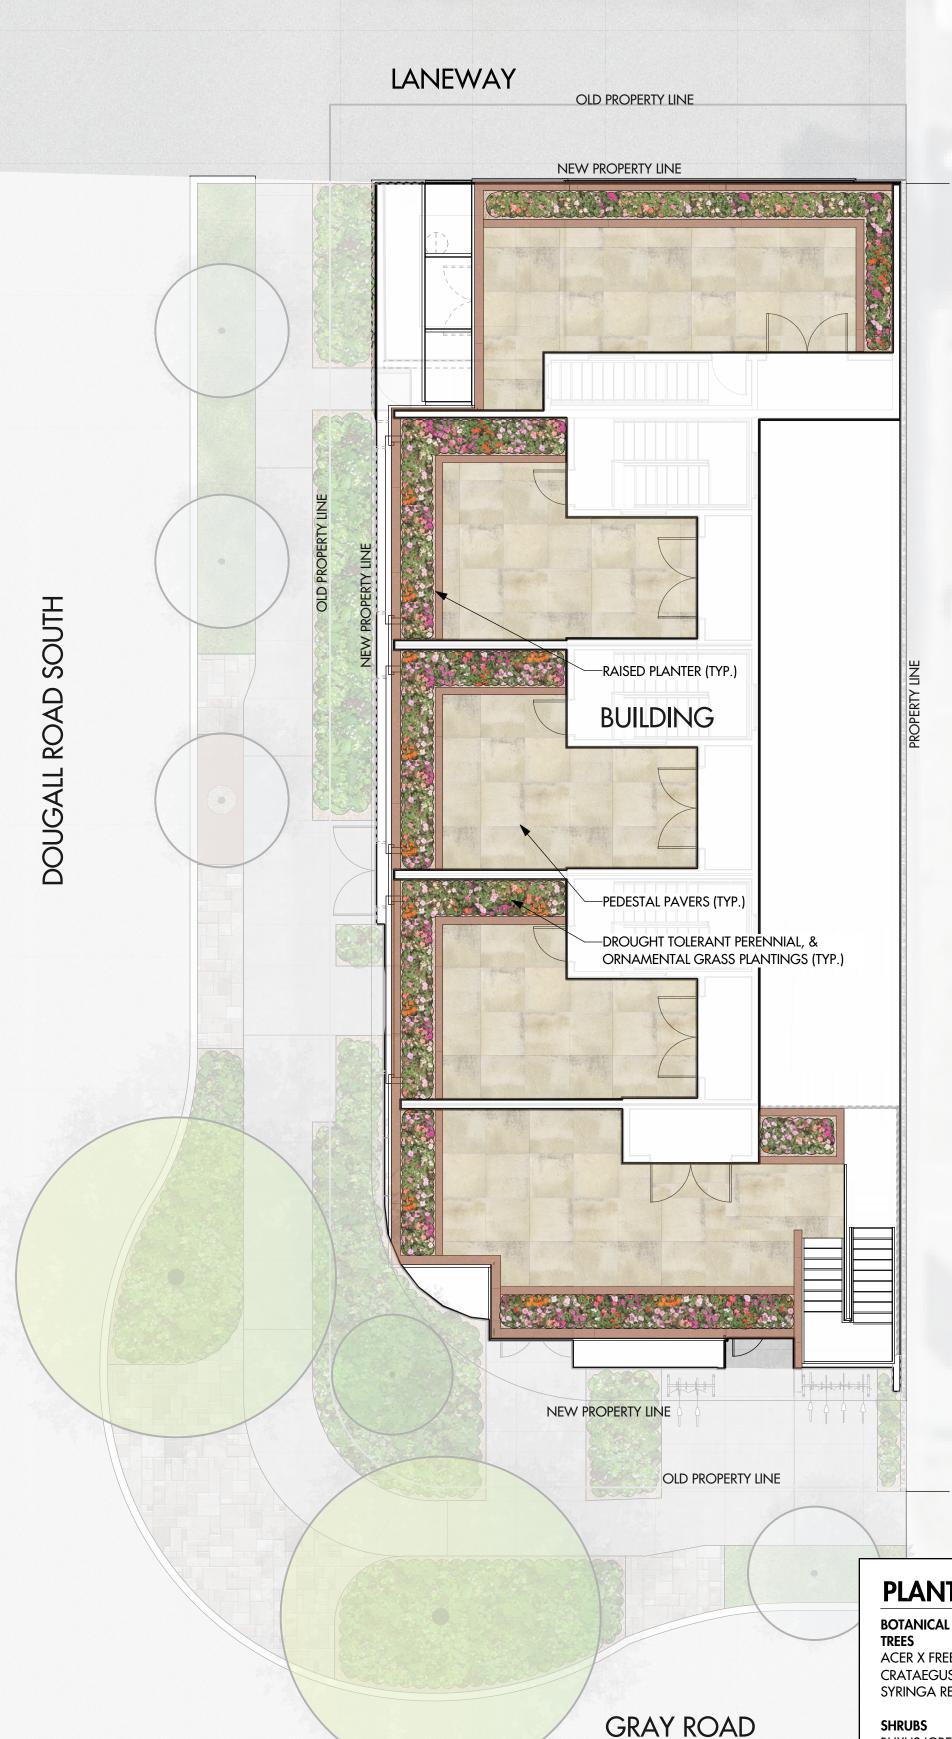
LEVEL 1

LEVEL 2

25 M



LEVEL 3



SCHEDULE

This forms part of application # DP21-0139

Planner Initials

City of Kelowna DEVELOPMENT PLANNING

C

OUTLAND DESIGN LANDSCAPE ARCHITECTURE

303-590 KLO Road Kelowna, BC V1Y 7S2 T (250) 868-9270 www.outlanddesign.ca

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SIZE/SPACING & REMARKS

#02 CONT. /0.9M O.C. SPACING

#02 CONT. /1.0M O.C. SPACING

#02 CONT. /1.5M O.C. SPACING

#01 CONT. /0.6M O.C. SPACING

6cm CAL..

6cm CAL.

6cm CAL.

PLANT LIST

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SHRUBS BUXUS 'GREEN GEM'

CORNUS SERICEA 'KELSEYI' HYDRANGEA PANICULATA 'JAN' PINUS ABIES 'NIDIFORMIS' SPIREA BULMALDA 'ANTHONY WATERER'

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GREEN GEM BOXWOOD KELSEY DOGWOOD LITTLE LIME HYDRANGEA NEST SPRUCE

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NOTES

AUTUMN JOY STONECROP

ANTHONY WATERER SPIREA SUMMER PASTELS YARROW

SILVER MOUND ARTEMISIA

#02 CONT. /1.5M O.C. SPACING #02 CONT. /1.2M O.C. SPACING #01 CONT. /0.9M O.C. SPACING #01 CONT. /0.6M O.C. SPACING RUBY STELLA DAYLILY #01 CONT. /0.6M O.C. SPACING FOUNTAIN GRASS #01 CONT. /1.0M O.C. SPACING



PROJECT TITLE

DOUGALL MIXED USE 165 DOUGALL ROAD SOUTH

Kelowna, BC

DRAWING TITLE

ISSUED FOR / REVISION

CONCEPTUAL LANDSCAPE PLAN

2	21.10.15	Review
3	21.10.29	Review
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PROJECT NO	21-079
DESIGN BY	KM
DRAVVN BY	MC/TR
CHECKED BY	FB
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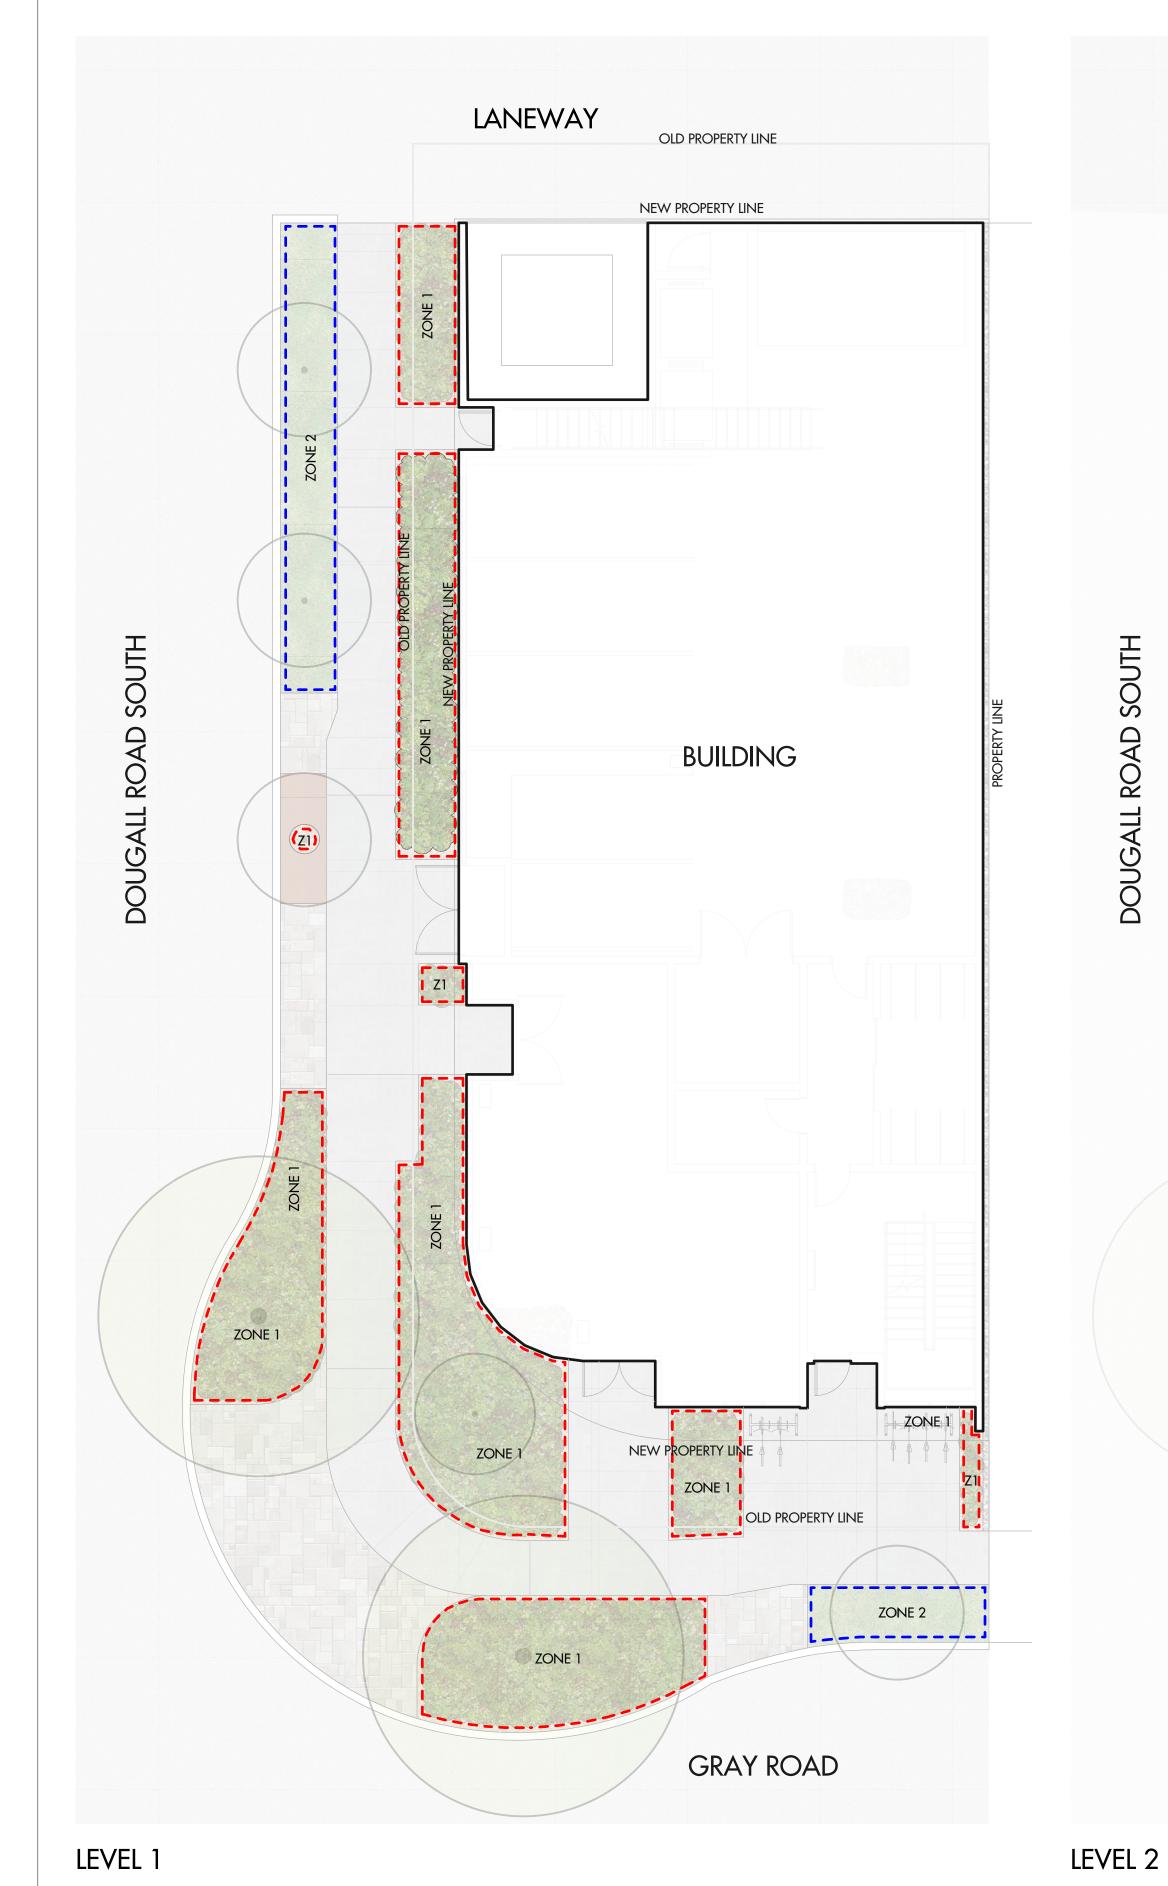
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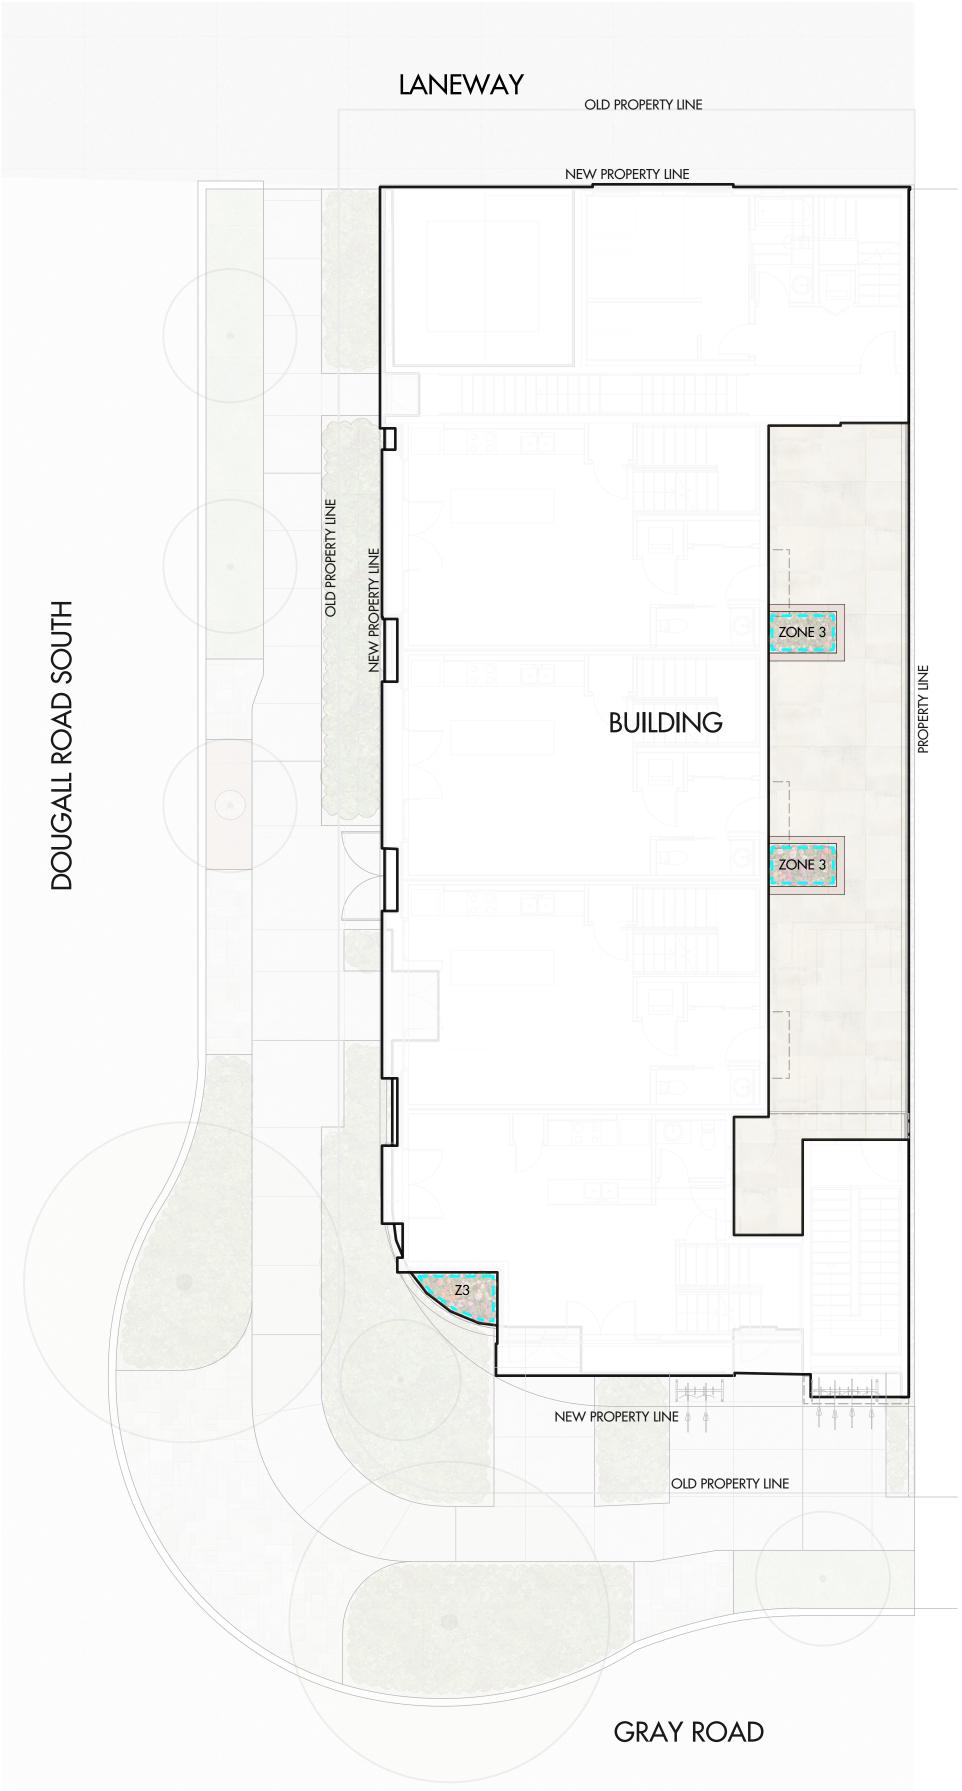
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LEVEL 4









WATER CONSERVATION CALCULATIONS

LANDSCAPE MAXIMUM WATER BUDGET (WB) = 120 cu.m. / year ESTIMATED LANDSCAPE WATER USE (WU) = 80 cu.m. / year

WATER BALANCE = 40 cu.m. / year

*REFER ATTACHED IRRIGATION APPLICATION FOR DETAILED CALCULATIONS

IRRIGATION NOTES

1. IRRIGATION PRODUCTS AND INSTALLATION METHODS SHALL MEET OR EXCEED THE REQUIREMENTS OF THE WATER USE REGULATION BYLAW NO. 10480 AND THE SUPPLEMENTARY SPECIFICATIONS IN THE CITY OF KELOWNA BYLAW 7900 (PART 6, SCHEDULE 5).

2. THE IRRIGATION SYSTEM SHALL MEET THE REQUIREMENTS, REGULATIONS, AND BYLAWS OF THE WATER PURVEYOR.

3. THE IRRIGATION SYSTEM SHALL BE EQUIPPED WITH AN APPROVED BACKFLOW PREVENTION DEVICE, WATER METER, AND SHUT OFF VALVE LOCATED OUTSIDE THE BUILDING ACCESSIBLE TO THE CITY.

4. AN APPROVED SMART CONTROLLER SHALL BE INSTALLED. THE IRRIGATION SCHEDULING TIMES SHALL UTILIZE A MAXIMUM ET VALUE OF 7" / MONTH (KELOWNA JULY ET), TAKING INTO CONSIDERATION SOIL TYPE, SLOPE, AND MICROCLIMATE.

5. DRIP LINE AND EMITTERS SHALL INCORPORATE TECHNOLOGY TO LIMIT ROOT INTRUSION.

6. IRRIGATION SLEEVES SHALL BE INSTALLED TO ROUTE IRRIGATION LINES UNDER HARD SURFACES AND FEATURES.

7. IRRIGATION PIPE SHALL BE SIZED TO ALLOW FOR A MAXIMUM FLOW OF $1.5\mathrm{m}$ /SEC.

8. A FLOW SENSOR AND MASTER VALVE SHALL BE CONNECTED TO THE CONTROLLER AND PROGRAMMED TO STOP FLOW TO THE SYSTEM IN CASE OF AN IRRIGATION WATER LEAK.

IRRIGATION LEGEND

ZONE #1: HIGH EFFICIEN
PLANTING AREAS
TOTAL AREA: 116 sq.m.

ZONE #1: HIGH EFFICIENCY SUBSURFACE DRIP IRRIGATION FOR MODERATE WATER USE PLANTING AREAS

MICROCLIMATE: SOUTH EXPOSURE, PARTIALLY SHADED BY TREES ESTIMATED ANNUAL WATER USE: 39 cu.m.

ZONE #2: LOW VOLUME POP-UP SPRAYHEADS FOR TURF AREAS TOTAL AREA: 26 sq.m.
MICROCLIMATE: WESTERN EXPOSURE, PARTIALLY SHADED BY TREES ESTIMATED ANNUAL WATER USE: 22 cu.m.

ZONE #3: HIGH EFFICIENCY SUBSURFACE DRIP IRRIGATION FOR MODERATE WATER USE PLANTING AREAS

TOTAL AREA: 6 sq.m.
MICROCLIMATE: SOUTH EXPOSURE, PARTIALLY SHADED BY THE BUILDING
ESTIMATED ANNUAL WATER USE: 2 cu.m.


ZONE #4: HIGH EFFICIENCY SUBSURFACE DRIP IRRIGATION FOR MODERATE
WATER USE PLANTING AREAS
TOTAL AREA: 2 sq.m.
MICROCLIMATE: SOUTH EXPOSURE, PARTIALLY SHADED BY THE BUILDING

ESTIMATED ANNUAL WATER USE: 1 cu.m.

70NIE #5: HIGH EFFICIENICY SUBSUIDEACE DRIP IRRIGATION FOR MODERATE

ZONE #5: HIGH EFFICIENCY SUBSURFACE DRIP IRRIGATION FOR MODERATE WATER USE PLANTING AREAS TOTAL AREA: 50 sq.m.

MICROCLIMATE: SOUTH EXPOSURE, PARTIALLY SHADED BY THE BUILDING ESTIMATED ANNUAL WATER USE: 17 cu.m.

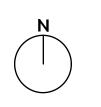

PROJECT TITLE

165 DOUGALL ROAD SOUTH

OUTLAND DESIGN

LANDSCAPE ARCHITECTURE

303-590 KLO Road Kelowna, BC V1Y 7S2

T (250) 868-9270 www.outlanddesign.ca

Kelowna, BC

DRAWING TITLE

WATER CONSERVATION/IRRIGATION PLAN

1	JED FOR / REVISION	D .
	21.05.26	Review
2	21.10.15	Review
3	21.10.29	Review
4		
5		

PROJECT NO	21-079	
DESIGN BY	KM	
DRAWN BY	MC/TR	
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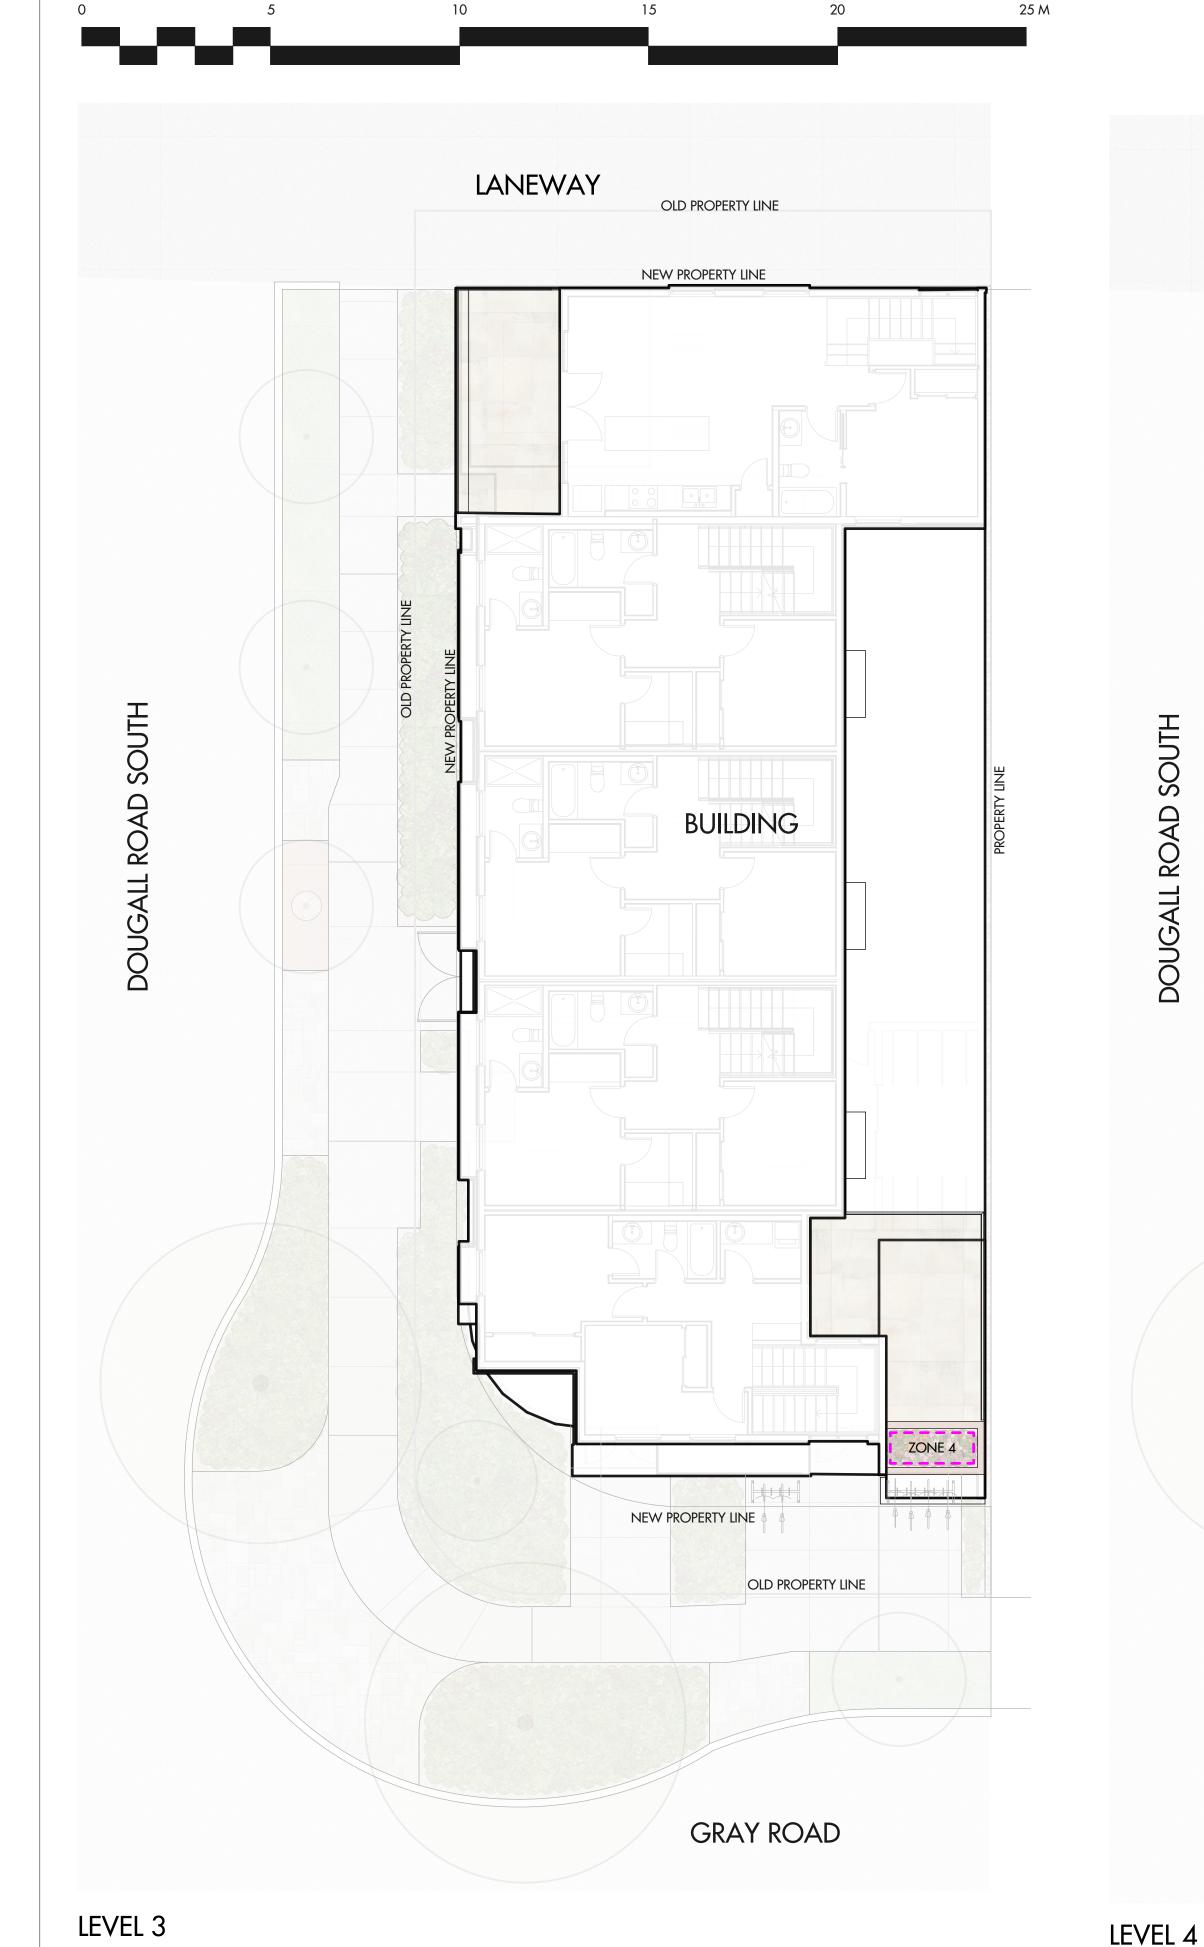



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SCHEDULE

Planner

Initials

This forms part of application # DP21-0139

Kelowna

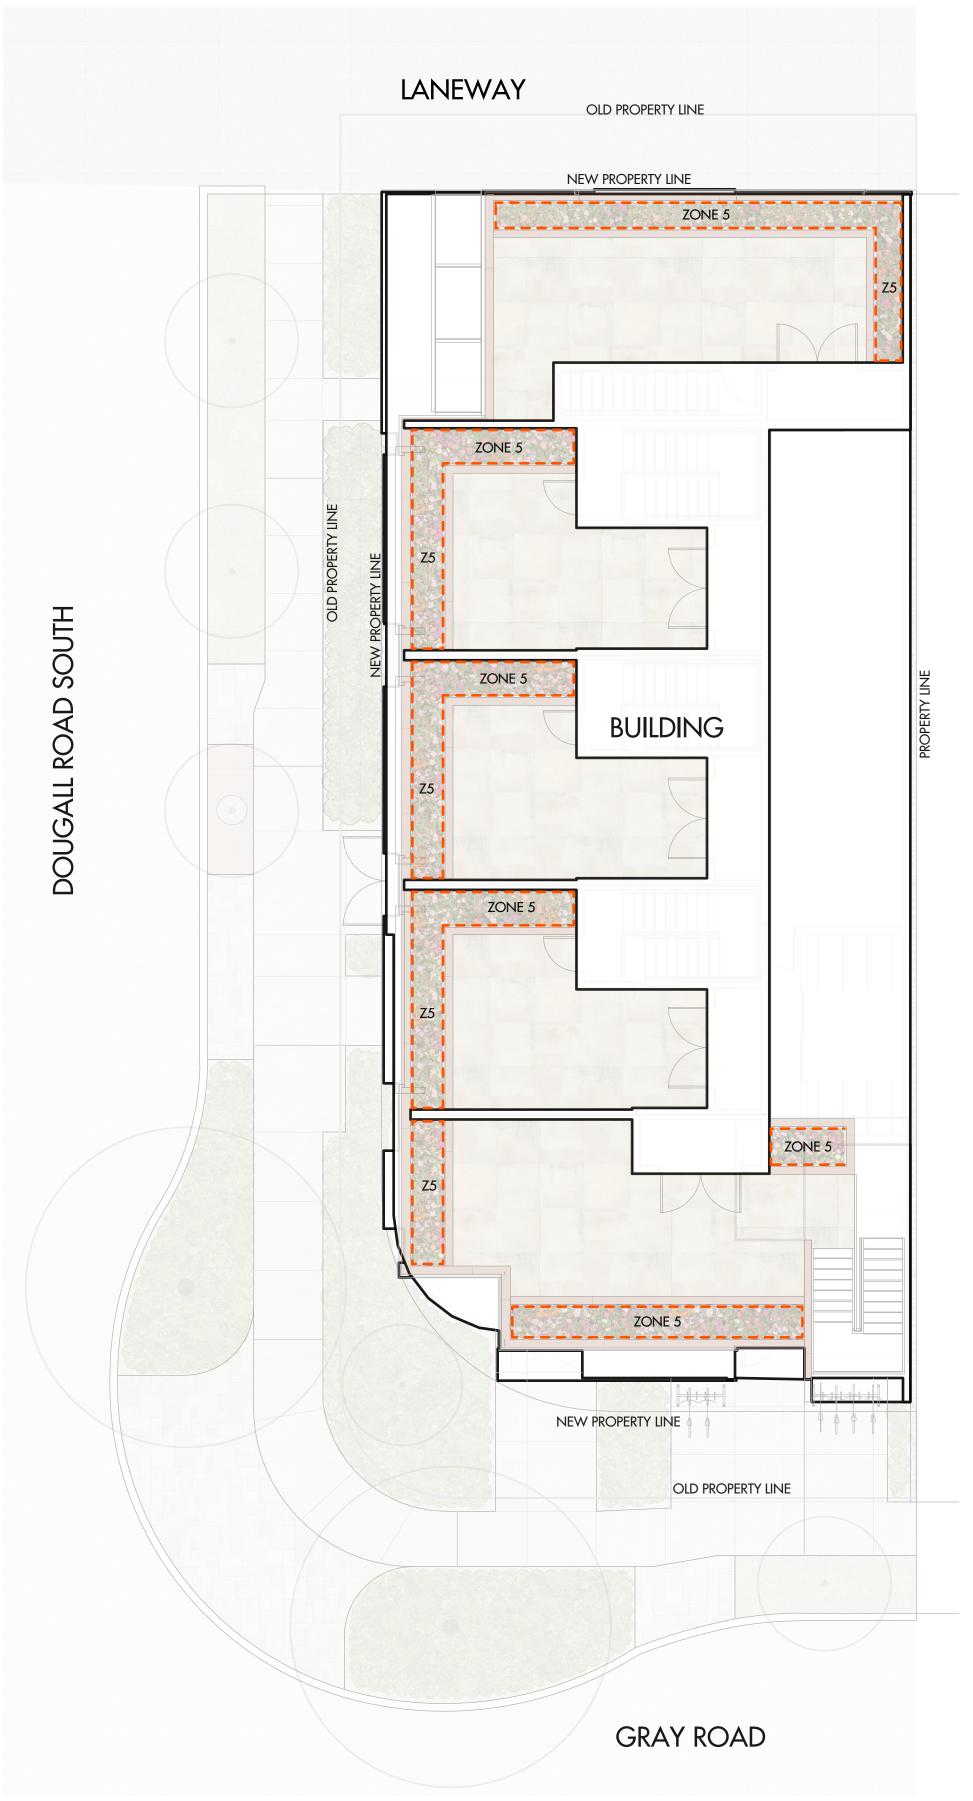OUTLAND DESIGN LANDSCAPE ARCHITECTURE

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IRRIGATION LEGEND

PLANTING AREAS TOTAL AREA: 116 sq.m.

ZONE #1: HIGH EFFICIENCY SUBSURFACE DRIP IRRIGATION FOR MODERATE WATER USE

MICROCLIMATE: SOUTH EXPOSURE, PARTIALLY SHADED BY TREES ESTIMATED ANNUAL WATER USE: 39 cu.m.

ZONE #2: LOW VOLUME POP-UP SPRAYHEADS FOR TURF AREAS TOTAL AREA: 26 sq.m. MICROCLIMATE: WESTERN EXPOSURE, PARTIALLY SHADED BY TREES

ESTIMATED ANNUAL WATER USE: 22 cu.m.

ZONE #3: HIGH EFFICIENCY SUBSURFACE DRIP IRRIGATION FOR MODERATE WATER USE PLANTING AREAS

TOTAL AREA: 6 sq.m. MICROCLIMATE: SOUTH EXPOSURE, PARTIALLY SHADED BY THE BUILDING ESTIMATED ANNUAL WATER USE: 2 cu.m.

ZONE #4: HIGH EFFICIENCY SUBSURFACE DRIP IRRIGATION FOR MODERATE WATER USE PLANTING AREAS TOTAL AREA: 2 sq.m. 1----

ESTIMATED ANNUAL WATER USE: 1 cu.m.

MICROCLIMATE: SOUTH EXPOSURE, PARTIALLY SHADED BY THE BUILDING

ZONE #5: HIGH EFFICIENCY SUBSURFACE DRIP IRRIGATION FOR MODERATE WATER USE PLANTING AREAS

ESTIMATED ANNUAL WATER USE: 17 cu.m.

TOTAL AREA: 50 sq.m. MICROCLIMATE: SOUTH EXPOSURE, PARTIALLY SHADED BY THE BUILDING



PROJECT TITLE

165 DOUGALL ROAD SOUTH

Kelowna, BC

DRAWING TITLE

WATER CONSERVATION/ **IRRIGATION PLAN**

1	JED FOR / REVISION 21.05.26	Review
	21.03.20	Keview
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CITY OF KELOWNA

MEMORANDUM

Date: June 21, 2021

File No.: DP21-0139

To: Suburban and Rural Planning (KB)

From: Development Engineering Manager (RO)

Subject: 165 Dougall Rd S Form and Character

The Development Engineering Branch has the following requirements related to this Development Permit application for the form and character of a mixed-use building (commercial and five residential units) which will be applicable at time of Building Permit. The Development Technician for this file is Sarah Kelly, (skelly@kelowna.ca).

1. General

- a. The following requirements are valid for two (2) years from the reference date of this memo, or until the application has been closed, whichever occurs first. The City of Kelowna reserves the rights to update/change some or all items in this memo once these time limits have been reached.
- b. These Development Engineering comments/requirements are subject to the review and requirements from the Ministry of Transportation and Infrastructure (MoTI).
- c. This proposed development/subdivision may require the installation of centralized mail delivery equipment. Please contact Arif Bhatia, Delivery Planning Officer, Canada Post Corporation, 530 Gaston Avenue, Kelowna, BC, V1Y 2K0, (250) 859-0198, arif.bhatia@canadapost.ca to obtain further information and to determine suitable location(s) within the development.
- d. There is a possibility of a high water table or surcharging of storm drains during major storm events. This should be considered in the design of the onsite system.

2. Domestic Water and Fire Protection

- a. The subject lots are located within the Rutland Waterworks District (RWD) service area. The Developer is required to make satisfactory arrangements with RWD for all water and fire protection-related issues. All charges for service connection(s) and upgrading costs, as well as any costs to decommission existing services, shall be the responsibility of the Developer.
- b. The Developer's Consulting Mechanical Engineer will determine the fire protection requirements of this proposed development and establish hydrant requirements and service needs. All fire flow calculations approved by RWD are to be shared with the Development Engineering Branch upon submittal of off-site civil engineering drawings.

Page 2 of 5

2. <u>Sanitary Sewer System</u>

- a. Our records indicate that the subject lots are currently each serviced with a 150-mm diameter sanitary sewer service off Gray Rd. The Applicant's Consulting Mechanical Engineer will determine the requirements of the proposed development and establish the service needs. Only one service is permitted. If required, the applicant will arrange for the removal and disconnection of the existing service and the installation of one new larger service at the applicants cost.
- b. If existing service is to be utilized, it must be completed with an inspection chamber (c/w Brooks Box) as per SS-S7.

3. Storm Drainage

- a. The property is located within the City of Kelowna drainage service area. The City Engineer may permit use of individual ground water disposal systems, where soils are suitable. For on-site disposal of drainage water, a hydrogeotechnical report will be required complete with a design for the disposal method (i.e. trench drain / rock pit). The Lot Grading Plan must show the design and location of these systems for each lot.
- b. The developer must engage a consulting civil engineer to provide a storm water management plan for this site which meets the requirements of the City Subdivision Development and Servicing Bylaw 7900. The storm water management plan must also include provision of lot grading plans, minimum basement elevations (MBE), if applicable, and provision of a storm drainage service and recommendations for onsite drainage containment and disposal systems.
- c. Provide the following drawings:
 - i. A detailed Lot Grading Plan (indicate on the Lot Grading Plan any slopes that are steeper than 30% and areas that have greater than 1.0 m of fill);
 - ii. A detailed Stormwater Management Plan for this development that is based off the original grading plan of the subdivision; and,
 - iii. An Erosion and Sediment Control Plan is to be prepared by a Professional Engineer proficient in the field of erosion and sediment control. The plan is to be prepared as per section 3.14 of Schedule 4 of Bylaw 7900. If a line item for ESC is not included in the Engineer's cost estimate for off-site work, then an additional 3% will be added to the performance security based on the total off-site construction estimate.
- d. As per Bylaw 7900, Schedule 4, Section 3.1.3 Climate Change, the capacity of storm works will include an additional 15 percent (15%) upward adjustment and applied to the rainfall intensity curve stage (IDF) in Section 3.7.2.
- e. Where structures are designed or constructed below the proven high groundwater table, permanent groundwater pumping will not be permitted to discharge to the storm system. The City will approve designs that include provisions for eliminating groundwater penetration into the structure, while addressing buoyancy concerns. These design aspects must be reviewed and approved by the City Engineer.

Page 3 of 5

4. Road Improvements

- a. Gray Rd must be upgraded to a full urban standard (SS-R5) along the full frontage of the subject property; including curb and gutter, sidewalk, LED street lighting, landscaped and irrigated boulevard, storm drainage system, pavement removal and replacement and relocation or adjustment of utility appurtenances if required to accommodate the upgrading construction.
- b. Dougall Rd must be upgraded to a full urban standard (SS-R5) along the full frontage of the subject property; including curb and gutter, sidewalk, LED street lighting, landscaped and irrigated boulevard, storm drainage system, pavement removal and replacement and re-location or adjustment of utility appurtenances if required to accommodate the upgrading construction.
- c. North lane fronting the property must be upgraded to a full commercial lane standard (SS-R2) along the full frontage; including road fillet paving, storm drainage, and relocation or adjustment of existing utility appurtenances if required to accommodate the upgrading construction.
- d. Landscaped and irrigated boulevard required with design and inspection by a Qualified Professional registered with the BCSLA and the IIABC. Landscape and irrigation plans require approval by the Development Engineering Branch at the same time as other "issued for construction" drawings.
- e. Streetlights must be installed on all public roads. All streetlighting plans are to include photometric calculations demonstrating Bylaw 7900 requirements are met and approval by the Development Engineering Branch at the same time as other "issued for construction" drawings.

5. Electric Power and Telecommunication Services

- a. The electrical and telecommunication services to this building/property must be installed in an underground duct system, and the building must be connected by an underground service. It is the developer's responsibility to make a servicing application with the respective electric power, telephone, and cable transmission companies to arrange for these services, which would be at the applicant's cost.
- b. Provide all necessary Statutory Rights-of-Way for any utility corridors as required.

9. <u>Geotechnical Report</u>

- a. Provide a comprehensive geotechnical report, prepared by a Professional Engineer competent in the field of hydro-geotechnical engineering to address the items below:

 NOTE: The City is relying on the Geotechnical Engineer's report to prevent any damage to property and/or injury to persons from occurring as a result of problems with soil slippage or soil instability related to this proposed subdivision.
- b. The Geotechnical report must be submitted prior to submission of Engineering drawings or application for subdivision approval.
 - i. Area ground water characteristics, including any springs and overland surface drainage courses traversing the property. Identify any monitoring required.
 - ii. Site suitability for development.

Page 4 of 5

- iii. Site soil characteristics (i.e. fill areas, sulphate content, unsuitable soils such as organic material, etc.).
- iv. Any special requirements for construction of roads, utilities, and building structures.
- v. Recommendations for items that should be included in a Restrictive Covenant.
- vi. Recommendations for roof drains and perimeter drains.
- vii. Recommendations for erosion and sedimentation controls for water and wind.
- viii. Any items required in other sections of this document.
- c. Should any on-site retaining walls surpass the following limits, an Over Height Retaining Wall Permit will be required:

"Retaining walls on all lots, except those required as a condition of subdivision approval, must not exceed a height of 1.2 m measured from natural grade on the lower side, and must be constructed so that any retaining walls are spaced to provide a 1.2 m horizontal separation between tiers. The maximum number of tiers is two with a maximum total height of 2.4 m. Any multi-tier structure more than 2 tiers must be designed and constructed under the direction of a qualified professional engineer."

The design of all retaining walls is to conform with Engineer & Geoscientists British Columbia's Professional Practice Guidelines for Retaining Wall Design. Submission requirements for the Over Height Retaining Wall Permit include Engineer of Record documents (Appendix A of Retaining Wall Design Guideline) and any necessary independent reviews (as per EGBC's Documented Independent Review of Structural Designs).

6. Road Dedication / Subdivision Requirements

- a. A dedication of approximately 1.6 m along the full frontage of the north lane is required to achieve a 7.6 m commercial laneway as per SS-R2.
- b. A dedication of approximately 1.1 m along the full frontage of the Dougall Rd is required to achieve a 20.0 m road ROW as per SS-R5.
- c. A dedication of approximately 2.3 m along the full frontage of the Gray Rd is required to achieve a 20.0 m road ROW as per SS-R5.
- d. A 6.0 m corner rounding will be required on the south west corner of the subject lot.
- e. Access to this development must be off the lane.

7. Design and Construction

- a. Design, construction supervision and inspection of all off-site civil works and site servicing must be performed by a Consulting Civil Engineer and all such work is subject to the approval of the City Engineer. Drawings must conform to City standards and requirements.
- b. Engineering drawing submissions are to be in accordance with the City's "Engineering Drawing Submission Requirements" Policy. Please note the number of sets and drawings required for submissions.

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- c. Quality Control and Assurance Plans must be provided in accordance with the Subdivision, Development & Servicing Bylaw No. 7900 (Part 5 and Schedule 3).
- d. A "Consulting Engineering Confirmation Letter" (City document 'C') must be completed prior to submission of any designs.
- e. Before any construction related to the requirements of this subdivision application

commences, design drawings prepared by a professional engineer must be submitted to the City's Development Engineering Department. The design drawings must first be "Issued for Construction" by the City Engineer. On examination of design drawings, it may be determined that rights-of-way are required for current or future needs.

8. Servicing Agreements for Works and Services

- a. A Servicing Agreement is required for all offsite works and services on City lands in accordance with the Subdivision, Development & Servicing Bylaw No. 7900. The applicant's Engineer, prior to preparation of Servicing Agreements, must provide adequate drawings and estimates for the required works. The Servicing Agreement must be in the form as described in Schedule 2 of the bylaw.
- b. Part 3, "Security for Works and Services", of the Bylaw, describes the Bonding and Insurance requirements of the Owner. The liability limit is not to be less than \$5,000,000 and the City is to be named on the insurance policy as an additional insured.

10. Charges and Fees

- a. Development Cost Charges (DCC's) are payable.
- b. Fees per the "Development Application Fees Bylaw" include:
 - i. Survey Monument Fee: \$50.00 per newly created lot (GST exempt).
 - ii. Survey Monument, Replacement Fee: \$1,200.00 (GST exempt) only if
 - iii. Engineering and Inspection Fee: 3.5% of offsite construction value (plus GST).

Ryan O'Sullivan

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Development Engineering Manager

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