

### CITY OF KELOWNA

### **MEMORANDUM**

**Date:** May 25, 2021

**File No.:** DP21-0112

To: Suburban and Rural Planning (AT)

From: Development Engineering Manager (RO)

Subject: 155 Bryden Rd

Form and Character

The Development Engineering Branch has the following comments and requirements associated with this Development Permit application for the form and character of a multiple dwelling housing development. All road and utility upgrades outlined in this report will be required at time of Building Permit. The Development Engineering Technician for this project is Sarah Kelly (skelly@kelowna.ca).

### 1. GENERAL

- a. This proposed development may require the installation of centralized mail delivery equipment. Please contact Arif Bhatia, Delivery Planning Officer, Canada Post Corporation, 530 Gaston Avenue, Kelowna, BC, V1Y 2K0, (250) 859-0198, arif.bhatia@canadapost.ca to obtain further information and to determine suitable location within the development.
- b. The following requirements are valid for two (2) years from the reference date of this memo, or until the application has been closed, whichever occurs first. The City of Kelowna reserves the rights to update/change some or all items in this memo once these time limits have been reached.
- c. These offsite infrastructure and services upgrading requirements are in addition to those previously identified in the Development Engineering Report for rezoning under file number Z18-0027. Offsite civil design drawings which were Issued for Construction on May 17, 2019 are to be reviewed for any necessary revisions.
- d. There is a possibility of a high water table or surcharging of storm drains during major storm events. This should be considered in the design of the onsite system.
- e. These Development Engineering comments/requirements are subject to the review and requirements from the Ministry of Transportation and Infrastructure (MoTI).

### 2. DOMESTIC WATER AND FIRE PROTECTION

- a. The property is located within the Black Mountain Irrigation District (BMID) service area. The developer is required to make satisfactory arrangements with BMID for all water and fire protection-related issues. All charges for service connection and upgrading costs, as well as any costs to decommission existing services, shall be the responsibility of the developer.
- b. The Developer's Consulting Mechanical Engineer will determine the fire protection requirements of this proposed development and establish hydrant requirements and service needs. All fire flow calculations approved by BMID are to be shared with the



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Development Engineering Branch upon submittal of off-site civil engineering drawings.

c. The water system must be capable of supplying the domestic and fire flow demands of the project in accordance with the Subdivision, Development, & Servicing Bylaw No. 7900. Provide water flow calculations for this development to confirm bylaw conformance (150 L/s for apartments/townhouses). Ensure building site is located at an elevation that ensures water pressure is within the bylaw pressure limits. Note: Private pumps are not acceptable for addressing marginal pressure.

### 3. SANITARY SEWER

a. Our records indicate the subject lot currently has three service connections. Only one service will be permitted for each legal lot additional services must be removed. The developer's consulting mechanical engineer will determine the development requirements of this proposed development and establish the service needs. The applicant, at their cost, will arrange for the removal and disconnection of the existing services and installation of one new larger service, if necessary.

### 4. STORM DRAINAGE

- a. The property is located within the City of Kelowna drainage service area. The City Engineer may permit use of individual ground water disposal systems, where soils are suitable. For on-site disposal of drainage water, a hydrogeotechnical report will be required complete with a design for the disposal method (i.e. trench drain / rock pit). The Lot Grading Plan must show the design and location of these systems for each lot.
- b. Provide the following drawings:
  - (i) A detailed Lot Grading Plan (indicate on the Lot Grading Plan any slopes that are steeper than 30% and areas that have greater than 1.0 m of fill);
  - (ii) A detailed Stormwater Management Plan for this subdivision; and,
  - (iii) An Erosion and Sediment Control Plan is to be prepared by a Professional Engineer proficient in the field of erosion and sediment control. The plan is to be prepared as per section 3.14 of Schedule 4 of Bylaw 7900. If a line item for ESC is not included in the Engineer's cost estimate for off-site work, then an additional 3% will be added to the performance security based on the total off-site construction estimate.
- c. On-site detention systems are to be compliant with Bylaw 7900, Schedule 4, Section 3.11.1 Detention Storage.
- d. As per Bylaw 7900, Schedule 4, Section 3.1.3 Climate Change, the capacity of storm works will include an additional 15 percent (15%) upward adjustment and applied to the rainfall intensity curve stage (IDF) in Section 3.7.2.
- e. Register right of ways on private properties for all the storm water infrastructure carrying, conveying, detaining and/or retaining storm water that is generated from the public properties, public road right of ways, and golf course lands.



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f. Where structures are designed or constructed below the proven high groundwater table, permanent groundwater pumping will not be permitted to discharge to the storm system. The City will approve designs that include provisions for eliminating groundwater penetration into the structure, while addressing buoyancy concerns. These design aspects must be reviewed and approved by the City Engineer.

### 5. ROAD IMPROVEMENTS AND SITE ACCESS

- a. Bryden Road must be upgraded to an urban standard (SS-R5) along the full frontage of the subject property; including curb and gutter, sidewalk, fillet paving, LED street lighting, landscaped and irrigated boulevard, storm drainage system, pavement removal and replacement and re-location or adjustment of utility appurtenances if required to accommodate the upgrading construction.
- b. Highway 33 must be upgraded consistent with boulevard to the east along the full frontage of the subject property; including separated 1.8m wide sidewalk, LED street lighting, landscaped and irrigated boulevard, removal of existing driveway letdown, and re-location or adjustment of utility appurtenances if required to accommodate the upgrading construction.
- c. A new concrete wheelchair letdown, design as per City of Vancouver Standard Detail C8.3, is to be installed for east-west crossing at corner of Bryden Rd & Highway 33 with construction of new sidewalk.
- d. Existing mature trees within Highway 33 boulevard are not to be removed and will require tree protection barriers and signage as per Municipal Properties Tree Bylaw No. 8042 for entire duration of construction.
- e. All Landscape and Irrigation plans require design and inspection by a Qualified Professional registered with the BCSLA and the IIABC. Landscape and irrigation plans require approval by the Development Engineering Branch at the same time as other "issued for construction" drawings.
- f. Streetlights must be installed on all roads. All streetlighting designs are to be approved by the Development Engineering Branch at the same time as other "issued for construction" drawings.
- g. The City requests that the Developer arrange for the design and construction of upgrades to 1010-1012 HWY 33 W, including curb and gutter and fillet paving along the Bryden Rd frontage. Based on the developer's Consulting Civil Engineers cost estimate, the City will agree to pay for these frontage upgrades. Please contact the Development Technician, Sarah Kelly (skelly@kelowna.ca), for more information.

### 6. POWER AND TELECOMMUNICATION SERVICES

- a. All proposed service connections are to be installed underground. It is the developer's responsibility to make a servicing application with the respective electric power, telephone and cable transmission companies to arrange for these services, which would be at the applicant's cost.
- b. If any road dedication or closure affects lands encumbered by a Utility right-of-way (such as Hydro, Telus, Gas, etc.) please obtain the approval of the utility. Any works required by the utility as a consequence of the road dedication or closure must be incorporated in the construction drawings submitted to the City's Development Manager.



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### 7. <u>GEOTECHNICAL REPORT</u>

a. The Development Engineering Branch has received a copy of the *Kelowna Christian Centre Condos Geotechnical Assessment Report* prepared by Ecora and dated November 8th, 2018. If any further or amended version of this report has been created or is required, please share these reports with the Development Engineering Branch.

### 8. DESIGN AND CONSTRUCTION

- a. Design, construction supervision and inspection of all off-site civil works and site servicing must be performed by a Consulting Civil Engineer and all such work is subject to the approval of the City Engineer. Drawings must conform to City standards and requirements.
- Engineering drawing submissions are to be in accordance with the City's "Engineering Drawing Submission Requirements" Policy. Please note the number of sets and drawings required for submissions.
- c. Quality Control and Assurance Plans must be provided in accordance with the Subdivision, Development & Servicing Bylaw No. 7900 (refer to Part 5 and Schedule 3).
- d. A "Consulting Engineering Confirmation Letter" (City document 'C') must be completed prior to submission of any designs.
- e. Before any construction related to the requirements of this subdivision application commences, design drawings prepared by a professional engineer must be submitted to the City's Works & Utilities Department. The design drawings must first be "Issued for Construction" by the City Engineer. On examination of design drawings, it may be determined that rights-of-way are required for current or future needs.

### 9. SERVICING AGREEMENT FOR WORKS AND SERVICES

- a. A Servicing Agreement is required for all works and services on City lands in accordance with the Subdivision, Development & Servicing Bylaw No. 7900. The applicant's Engineer, prior to preparation of Servicing Agreements, must provide adequate drawings and estimates for the required works. The Servicing Agreement must be in the form as described in Schedule 2 of the bylaw.
- b. Part 3, "Security for Works and Services", of the Bylaw, describes the Bonding and Insurance requirements of the Owner. The liability limit is not to be less than \$5,000,000 and the City is to be named on the insurance policy as an additional insured.
- c. A Servicing Agreement was executed in May 2019. The applicant's Consulting Civil Engineer will be required to submit a new official estimate of total offsite construction cost to reflect current costs for review by the Development Engineering Branch, at which time it will be determined whether additional security or fee payments are required.



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### 10. CHARGES, FEES, AND SECURITIES

- a. Development Cost Charges (DCC's) are payable.
- b. Fees per the "Development Application Fees Bylaw" include:
  (i) Street Marking/Traffic Sign Fees: at cost (to be determined after design).
  (ii) Survey Monument Replacement Fee (if disturbed): \$1,200.00 (GST exempt)
  (iv) Engineering and Inspection Fee: 3.5% of construction value (plus GST)

Ryan O'Sullivan Development Engineering Manager

SK





ATTACHMENT B This forms part of application # DP21-0112 DVP21-0113 City of Planner Initials KB DEVELOPMENT PLANNING

March 8, 2021

Community Planning City of Kelowna 1435 Water Street Kelowna, BC V1Y 1J4

Dear Mr. Thibault,

THUJA

architecture studio Ltd

RE: Development Permit Application - 155 Bryden Road

Please find attached the application for a multiple unit Development Permit for a residential development consisting of two 6-storey apartment buildings with 192 purpose-built market rental units. The proposed project is located on approximately 2.52 acres within the Rutland Urban Center of Kelowna, at Bryden Road and Highway 33. The buildings will be comprised of one-, two- and three-bedroom units in a variety of sizes and floor plans to provide a long term cost-effective housing solution to Rutland residents while adding population density in the Urban Centre.

The buildings have a bold west-coast design, combining white-washed cedar and dark wood-coloured cement-fiber board paneling, and finished with a dramatic butterfly roofline and accented siding and trim. The siting of the buildings on the lot has been planned to maximize open space and outdoor recreational areas. The landscaping has been designed both to facilitate pedestrian access throughout the site, and to present pleasing, well-treed street frontages. With their high-quality design and landscaping, the buildings will act as a positive visual landmark for the neighborhood, adding aesthetic appeal and diversity to the neighborhood.

Providing housing within the Rutland Urban Centre is a mandate of the present Council, and the proposed infill project will provide efficient use of land, while contributing to a healthy housing mix. The project will increase population density within easy access of public transportation services, and within close distance of parks, schools, restaurants, events, and community amenities, to promote walking and biking. The development is steps away from Ben Lee Park, a fabulous amenity for residents. The proposed project strongly supports the Official Community Plan (OCP).

To maximize alignment to policy, a textual amendment to the current zoning was suggested by the Kelowna staff to ament the current zone (RM5 – Medium Density Multiple Housing) to RM5r – Medium Density Multiple Housing (Residential Rental Tenure Only) since our application is for purpose-built rental. The zoning amendment application was submitted February, 2021.

The benefit of the residential rental tenure zone, is that the parking requirements can be reduced by 20% through a development permit variance request. Through this development permit application, we request that our parking requirement be reduced as it will enable a landscape plan that prioritizes pedestrian safety and dramatically increases the amount of open green space available for recreation purposes.

The current zoning allows for a maximum height as the 'lesser of 18m or 4.5 storeys'. We are requesting a variance in height from 4.5 storeys to 6 storeys. Through effective design, the buildings will be able to embody 6 stories without significantly increasing the allowable measured height of the buildings, which are

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Architect AIBC,

LEED AP

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Squamish BC, V8B 0Y7



projected to stand at 18.45 and 18.8 m. Through this variance, the compact design provides a more efficient use of land and aligns to the scale of the neighborhood. Recent residential developments in the Hwy 33 corridor reflect increased density, including Aurora Crescent, Cambridge House, and Central Green. Beyond these recent buildings, there are also pre-existing 4, 5, & higher-storey structures within the residential block of this location.

Overall, the project supports the objectives of the OCP. It will also be a benefit to the community and residents by providing a pleasant streetscape. The location will allow residents to enjoy close community amenities, walkable activities, and everything the Rutland area offers. The proposed development aligns also to the Multiple Unit Development Permit Area design guidelines. Specific details on form and character, signage, siting, landscaping and screening, lighting and parking included in our proposal are as follows:

### A. Form and Character

The form and character of the development is consistent with the development permit guidelines for this area by providing a varying scale throughout the development by way of varying building massing and form typologies. The buildings utilize similar high-quality materials to create a cohesive development, although the juxtaposition and variation of these materials creates visual interest and eliminates any monotony. The design and finish of the proposed buildings is compatible with the existing neighbourhood through the use of complementary colours and materials, in a natural 'west-coast' palette. The buildings have clearly defined entry points, enhanced with accented siding and protruding canopies to identify their location. The buildings also have plentiful balconies and windows overlooking the sidewalks and open areas to engage the public realm and increase public safety through 'natural surveillance'.

### B. Signage

The signage for the development will be located directly on the building facade to identify the building. Lighting will be directed to only illuminate the signage when required. All signage will be consistent with the architectural style of the development.

### C. Siting, Landscaping and Screening

The project will create a pedestrian-friendly landscape that is both safe and enjoyable. The building footprints have been minimized to maximum the open, recreational green space on the property. The building placement addresses neighbouring sites, solar paths and view corridors along the site, as well as access to the development and vehicular movement within the site. Multiple sidewalks allow for easy pedestrian passage throughout the site and increase pedestrian safety. There is only one clearly-marked vehicle entrance to the small surface parking lot and underground parkade, limiting vehicle passage within the site itself.

Enjoying the pleasant outdoor climate of the Okanagan is a priority for planning in this development. Each unit will be accessible from a common entryway and vestibule and will have private amenity space in the form of a balcony or patio. Additionally, rooftop public amenity space is planned for both buildings, with views toward Okanagan Lake and Okanagan Mountain Park. Other lifestyle amenities contemplated include a fitness area, dog park and pet recreation, dog wash, relaxation areas, and resident storage. Planning for the development is aimed at a lifestyle for long-term rental residents.

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THUJA architecture studio Ltd TANIS FRAME Architect AIBC, LEED AP 41289 Horizon Dr Squamish BC, V8B 0Y7 250.650.7901



The landscaping and screening has been designed by a registered Landscape Architect, which incorporates appropriate plant species and locations for the area of the development. The refuse service area will be hidden by landscaping, to mitigate impacts on public view and noise pollution. The design and layout of the proposed development incorporates many elements of CPTED (Crime Prevention Through Environmental Design), including natural surveillance, access control, territorial reinforcement and maintenance. Security cameras, secure tenant access, generous lighting, and activated building faces have all been contemplated. An active property manager and welcoming lobby environment will also add to the comfort of all residents within the development.

### D. Lighting

All lighting will be full cut off luminaries. The building will have soffit lighting that operates on a solar activated lens, and provides a warm glow to the underside of the roof line. Lighting will be provided at the entry canopies of the apartment by way of solar activated soffit lighting. The parking area will be lit with full cut off light standards providing security and safety at night.

### E. Parking

The parking within the development consists of one large underground parkade, as well as a small surface lot. Short term bicycle parking is located at bike racks outside, while long term secure bicycle parking is provided within the underground parkade. Handicap and visitor stalls are provided as required, as well as stalls dedicated to electric vehicles. The parkade also houses the electrical and mechanical rooms.

The proposed project generally conforms to the zoning and development permit bylaws, though specific variances have been requested, as previously described, which will enhance the development. The project will help fulfill the goals for the Rutland Urban Centre outlined in the OCP, and contribute towards a vibrant neighbourhood. Should you require and further information or clarification, please do not hesitate to contact me.

Sincerely,

Tanks Frame Architect AIBC, LEED AP

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TANIS FRAME Architect AIBC, LEED AP 41289 Horizon Dr
 Squamish BC, V8B 0Y7
 250.650.7901



### Development Permit & Development Variance Permit No. DP21-0112 DVP21-0113

This permit relates to land in the City of Kelowna municipally known as

### 155 Bryden Road

and legally known as

### LOT A SECTION 27 TOWNSHIP 26 OSOYOOS DIVISION YALE DISTRICT PLAN EPP85221

and permits the land to be used for the following development:

**Multiple Dwelling Housing** 

The present owner and any subsequent owner of the above described land must comply with any attached terms and conditions.

Date of Council Decision	November 16, 2021
Decision By:	COUNCIL
Development Permit Area:	Comprehensive and Revitilization Development Permit Areas
Existing Zone:	RM5r - Medium Density Multiple Housing (Residential Rental Tenure Only)
Future Land Use Designation:	MRM – Multiple Unit Residential (Medium Density)

### This is NOT a Building Permit.

In addition to your Development Permit, a Building Permit may be required prior to any work commencing. For further information, contact the City of Kelowna, Development Services Branch.

### NOTICE

This permit does not relieve the owner or the owner's authorized agent from full compliance with the requirements of any federal, provincial or other municipal legislation, or the terms and conditions of any easement, covenant, building scheme or agreement affecting the building or land.

Owner: 1297889 BC LTD., INC.NO. BC1297889

Applicant: WestUrban Developments Ltd.

**Community Planning Department Manager** 

Planning & Development Services

Planner: K. Brunet

Terry Barton

Date

Development Planning Department 1435 Water Street Kelowna BC V1Y 1J4 <u>planninginfo@kelowna.ca</u> 250 469 8626

#### 1. SCOPE OF APPROVAL



This Development Permit applies to and only to those lands within the Municipality as described above, land all buildings prevent structures and other development thereon.

This Development Permit is issued subject to compliance with all of the Bylaws of the Municipality applicable thereto, except as specifically varied or supplemented by this permit, noted in the Terms and Conditions below.

The issuance of a permit limits the permit holder to be in strict compliance with regulations of the Zoning Bylaw and all other Bylaws unless specific variances have been authorized by the Development Permit. No implied variances from bylaw provisions shall be granted by virtue of drawing notations that are inconsistent with bylaw provisions and that may not have been identified as required Variances by the applicant or Municipal staff.

#### 2. CONDITIONS OF APPROVAL

- a) The dimensions and siting of the building to be constructed on the land be in accordance with Schedule "A";
- b) The exterior design and finish of the building to be constructed on the land be in accordance with Schedule "B";
- c) Landscaping to be provided on the land be in accordance with Schedule "C"; and
- d) The applicant be required to post with the City a Landscape Performance Security deposit in the form of a "Letter of Credit" in the amount of 125% of the estimated value of the landscaping, as determined by a Registered Landscape Architect.

AND THAT variances to the following section of the Zoning Bylaw No. 8000 be granted:

#### Section 13.11.6(c): RM5 – Medium Density Multiple Housing Development Regulations

To vary the required maximum height from 18.0 m or 4.5 storeys permitted to 18.8 m or 6 storeys proposed.

#### This Development Permit is valid for two (2) years from the date of approval, with no opportunity to extend.

#### 3. PERFORMANCE SECURITY

As a condition of the issuance of this Permit, Council is holding the security set out below to ensure that development is carried out in accordance with the terms and conditions of this Permit. Should any interest be earned upon the security, it shall accrue to the Developer and be paid to the Developer or his or her designate if the security is returned. The condition of the posting of the security is that should the Developer fail to carry out the development hereby authorized, according to the terms and conditions of this Permit within the time provided, the Municipality may enter into an agreement with the property owner of the day to have the work carried out, and any surplus shall be paid over to the property owner of the day. Should the Developer carry out the development permitted by this Permit within the time set out above, the security shall be returned to the Developer or his or her designate. There is filed accordingly:

a) An Irrevocable Letter of Credit OR certified cheque in the amount of \$484,479.19

Before any bond or security required under this Permit is reduced or released, the Developer will provide the City with a statutory declaration certifying that all labour, material, workers' compensation and other taxes and costs have been paid.

### 5. INDEMNIFICATION

Upon commencement of the works authorized by this Permit the Developer covenants and agrees to save harmless and effectually indemnify the Municipality against:

a) All actions and proceedings, costs, damages, expenses, claims, and demands whatsoever and by whomsoever brought, by reason of the Municipality said Permit.

All costs, expenses, claims that may be incurred by the Municipality where the construction, engineering or other types of works as called for by the Permit results in damages to any property owned in whole or in part by the Municipality or which the Municipality by duty or custom is obliged, directly or indirectly in any way or to any degree, to construct, repair, or maintain.

The PERMIT HOLDER is the <u>CURRENT LAND OWNER</u>. Security shall <u>ONLY</u> be returned to the signatory of the Landscape Agreement or their designates.



# **RUTLAND APARTMENTS KELOWNA, BC**

## PREPARED BY THUJA ARCHITECTURE STUDIO LTD.

## **SEPTEMBER 2021**

SET NO.

## **ISSUED FOR DEVELOPMENT PERMIT**





## **CONTEXT PHOTOS**








**LOCATION PLAN** N.T.S.

SITE LOCATION

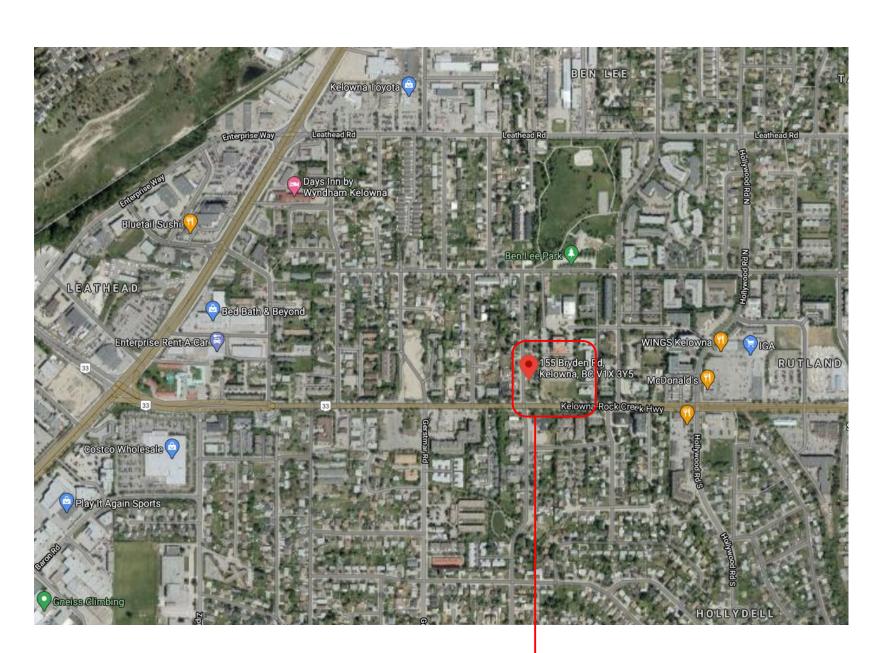











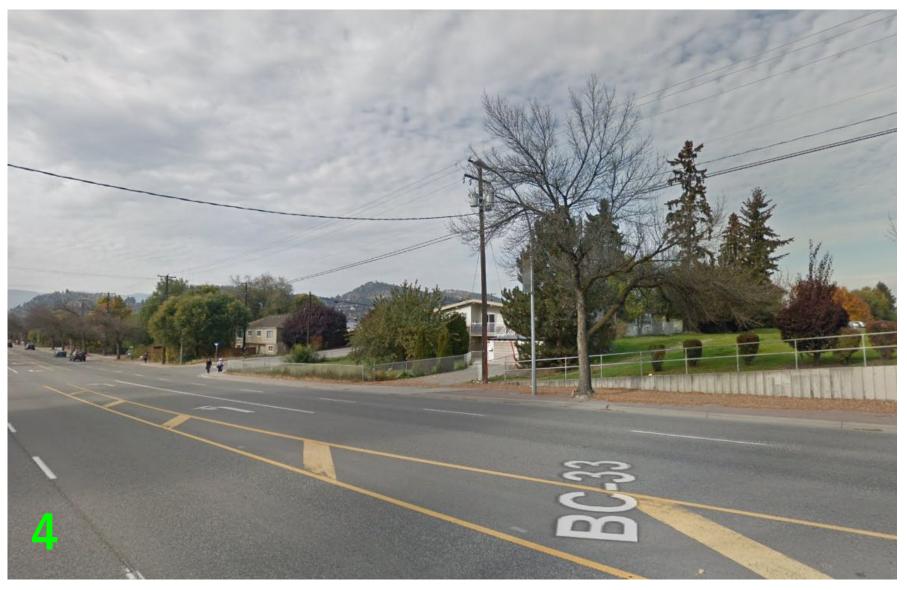

CONTRACTOR TO VERIFY ALL LINES, LEVELS, SURVEYS, DIMENSIONS, LOCATION OF BUILDING ON SITE AND LOCATION OF ALL SERVICES PRIOR TO CONSTRUCTION. ALL WORK TO BE DONE IN ACCORDANCE WITH THE B.C. BUILDING CODE, CURRENT EDITION AND ALL LOCAL BUILDING BYLAWS.

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Tanis Frame Architect AIBC LEED AP PO Box 1326 Cumberland BC VOR 1S0 T: 250.650.7901 E:info@thujaarchitecture.ca

SSUED FOR REVIEW	MAR. 2 2021
SSUED FOR DP	APR. 06 2021
REVISED FOR DP	AUG. 13 2021
REVISED	AUG. 25 2021
REISSUED FOR DP	SEPT. 22 2021

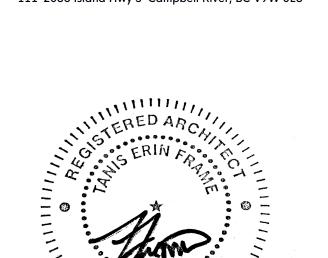RUTLAND APARTMENT 155 BRYDEN RD, KELOWNA

PROJECT

LOCATION / CONTEXT PHOTOS

SCALE	AS NOTED	PROJECT NO	
DATE		DRAWN BY	TF <i>j</i> SW



	EAT	D 41	
PROJ	ECI	DA	IA

LEGAL ADDRESS: PLAN EPP85221 LOT A SECTION 27 TOWNSHIP 26

CIVIC ADDRESS: 155 BRYDEN, RUTLAND, BC

ZONING:

RM5R - MEDIUM DENSITY MULTIPLE HOUSING (RENTAL)

LOT SIZE 10,239 SQ.M.

PARKADE AREA:

FLOOR AREAS:

MAIN

SECOND

THIRD

FIFTH

SIXTH

TOTAL

TOTAL (NET)

COMMON (MAIN)

COMMON (SECOND)

COMMON (FOURTH)

COMMON (THIRD)

COMMON (FIFTH)

COMMON (SIXTH)

TOTAL (GROSS)

FOURTH

**BUILDING AREA:** PROPOSED FOOTPRINT: 1355.6 SQ.M.(\*2) = 2711.2 SQ.M.

4505.5 SQ.M.

1021.2 SQ.M.

1021.2 SQ.M.

1021.2 SQ.M.

1021.2 SQ.M.

1021.2 SQ.M.

<u>1021.2 SQ.M.</u>

240.0 SQ.M.

240.0 SQ.M.

240.0 SQ.M.

240.0 SQ.M.

240.0 SQ.M.

240.0 SQ.M.

6127.2 SQ.M. EXCLUDING PARKADE

UNIT COUNTS PER B	LDG : MAIN	2NI	D-6TH	В
STUDIO BEDROOM ONE BEDROOM TWO BEDROOM THREE BEDROOM TOTAL	1 7 7 1 16	7 7 1	(*5) (*5) (*5) (*5) (*5)	6 42 42 6 96
TOTAL UNITS BOTH B	LDGS: 32	160		192
SETBACKS FRONT (WEST) REAR (EAST) SIDE (NORTH) SIDE (SOUTH)	REQUIRED 6.0M 9.0M 7.0M 6.0M	<b>BLDG A</b> 47.8M 9.7M - 6.62M	BLDG B 9.0M 12.74M 7.59M -	
1.0 1.2 1.4	9 PER BACHELO 0 PER 1 BED UN 25 PER 2 BED UI 50 PER 3 BED UI 14 PER UNIT	IT (*84) NIT (*84)	) 10.8 84 105 18 <u>27</u> <b>244.8</b> <b>195.84</b>	
VAN- AC SMALL ( TOTAL	ARD: SIBLE STALLS CESSIBLE STAL CAR (50% ALLOV		98 5 1 98 <b>196</b>	
1.0	75 PER 2 BED UN ) PER 3 BED OR <u>6 PER BLDG +</u>	MORE (*12)		135 12 <u>22</u> <b>169</b>
PROVIDED:	LONG TERM (IN WALL MOUNT ( GROUND ANCH	@ REG PKG	STALL:	73 74

FLOOR AREA RATIO: MAXIMUM: 1.3 PROPOSED: 1.2

DENSITY: PROPOSED: 192 UNITS

SITE COVERAGE: ALLOWABLE: 40% PROPOSED: 26.5%

PARKING AREAS / DRIVE AISLES: 1553.2 SQ.M

### SITE COVERAGE INCL. PARKING & DRIVEWAYS: ALLOWABLE: 65% PROPOSED: 41.6%


AMENITY SPACE:	
7.5 SQ.M. FOR STUDIO (*12) =	90 SQ.M.
15 SQ.M. FOR 1 BEDROOMS (*84) =	1260 SQ.M.
<u>25 SQ.M. FOR 1+ BEDROOM (*96) =</u>	2400 SQ.M.
TOTAL REQ'D AMENITY SPACE:	3750 SQ.M.


### **TOTAL PROVIDED:**

DECKS / PATIOS:	1134 SQ.M.
INDOOR AMENTY SPACE:	
225 SQ.M. (*2) =	450 SQ.M.
OUTDOOR AMENITY SPACE: +/-	2780 SQ.M.
TOTAL:	4364 SQ.M.

### **BUILDING HEIGHT:**

ALLOWABLE: LESSER OF 18M OR 4.5 STOREYS PROPOSED: (TO BE CONFIRMED) BUILDING A: 18.8M BUILDING B: 18.45M

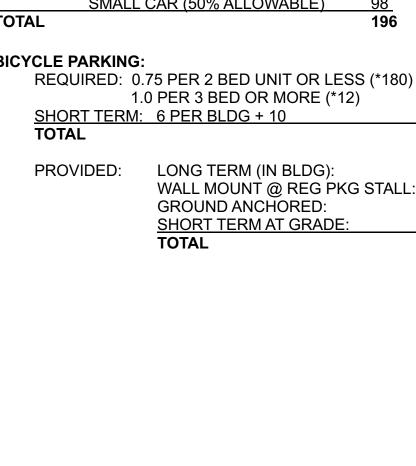

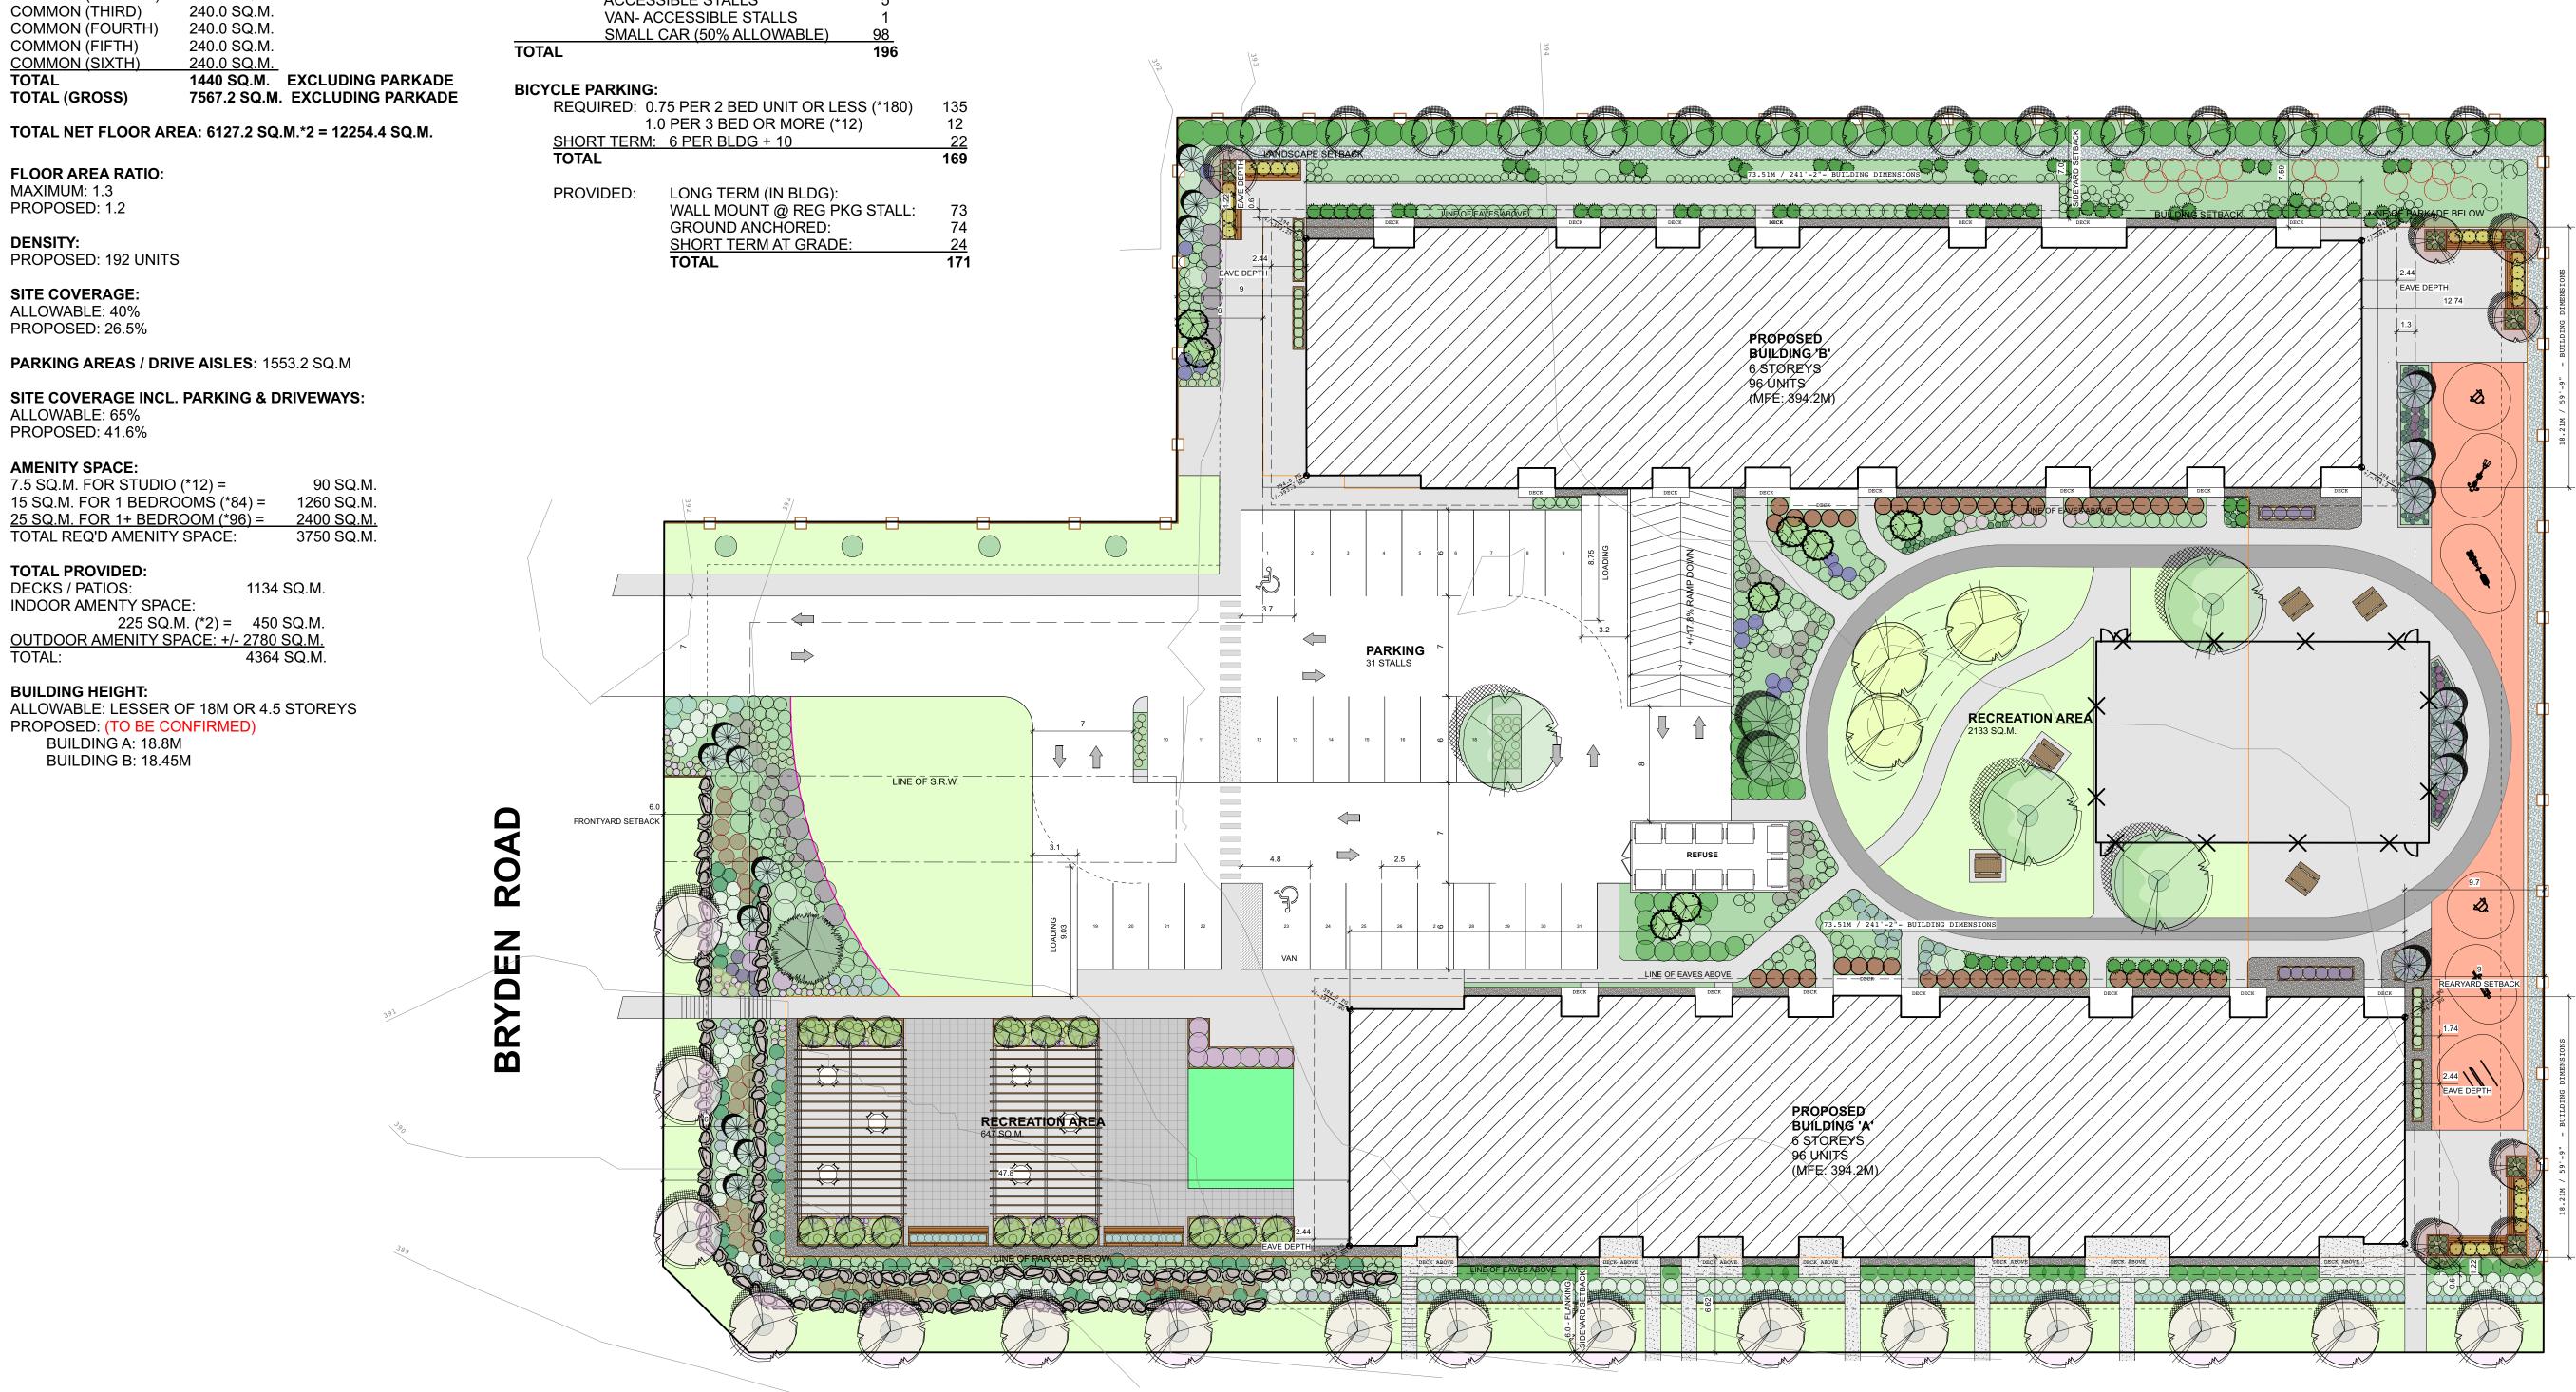



### CONSULTANT LIST

THUJA ARCHITECTURE STUDIO LTD. Tanis Frame, Architect AIBC, LEED AP

PO Box 1326 Cumberland BC VOR 1S0

LAZZARIN SVISDAHL LANDSCAPE ARCHITECTS

202-1300 St Ave, Prince George BC, V2L 2Y3

ARCHITECT

250.650.7901

Laurelin Svisdahl

250.563.6158

info@thujaarchitecture.ca

LANDSCAPE ARCHITECT

laurelin.la@outlook.com

### BUILDING

DEVELOPER/OWNER WESTURBAN DEVELOPMENTS LTD. Sean Roy, CEO 111-2036 South Island Hwy, Campbell River, BC V9W 0E8 250.914.8485 sroy@westurban.ca

## **DRAWING INDEX**

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PR5	UNIT PLANS
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PR7	BUILDING B ELEVATION
PR8	MATERIALS

### **KELOWNA - ROCK CREEK HWY**

Γ ΡΗΟΤΟS DATA

F PLAN


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PROJECT


DRAWING


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SCHEMATIC SITE PLAN

SCALE AS NOTED	PROJECT NO.
DATE	DRAWN BY TFSW

**PR2** 

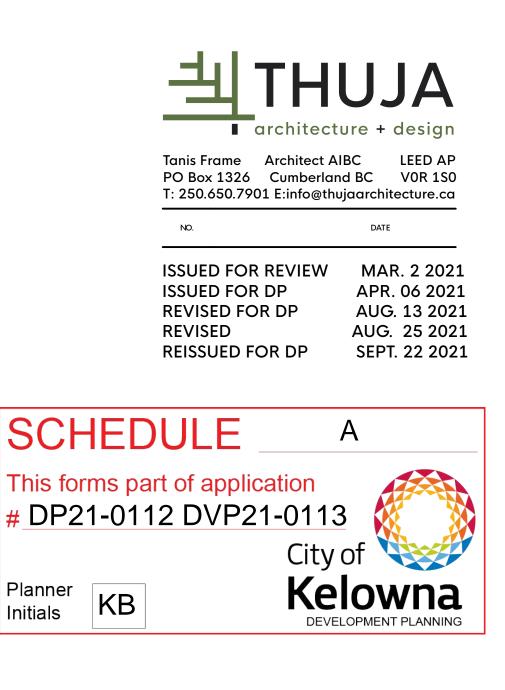

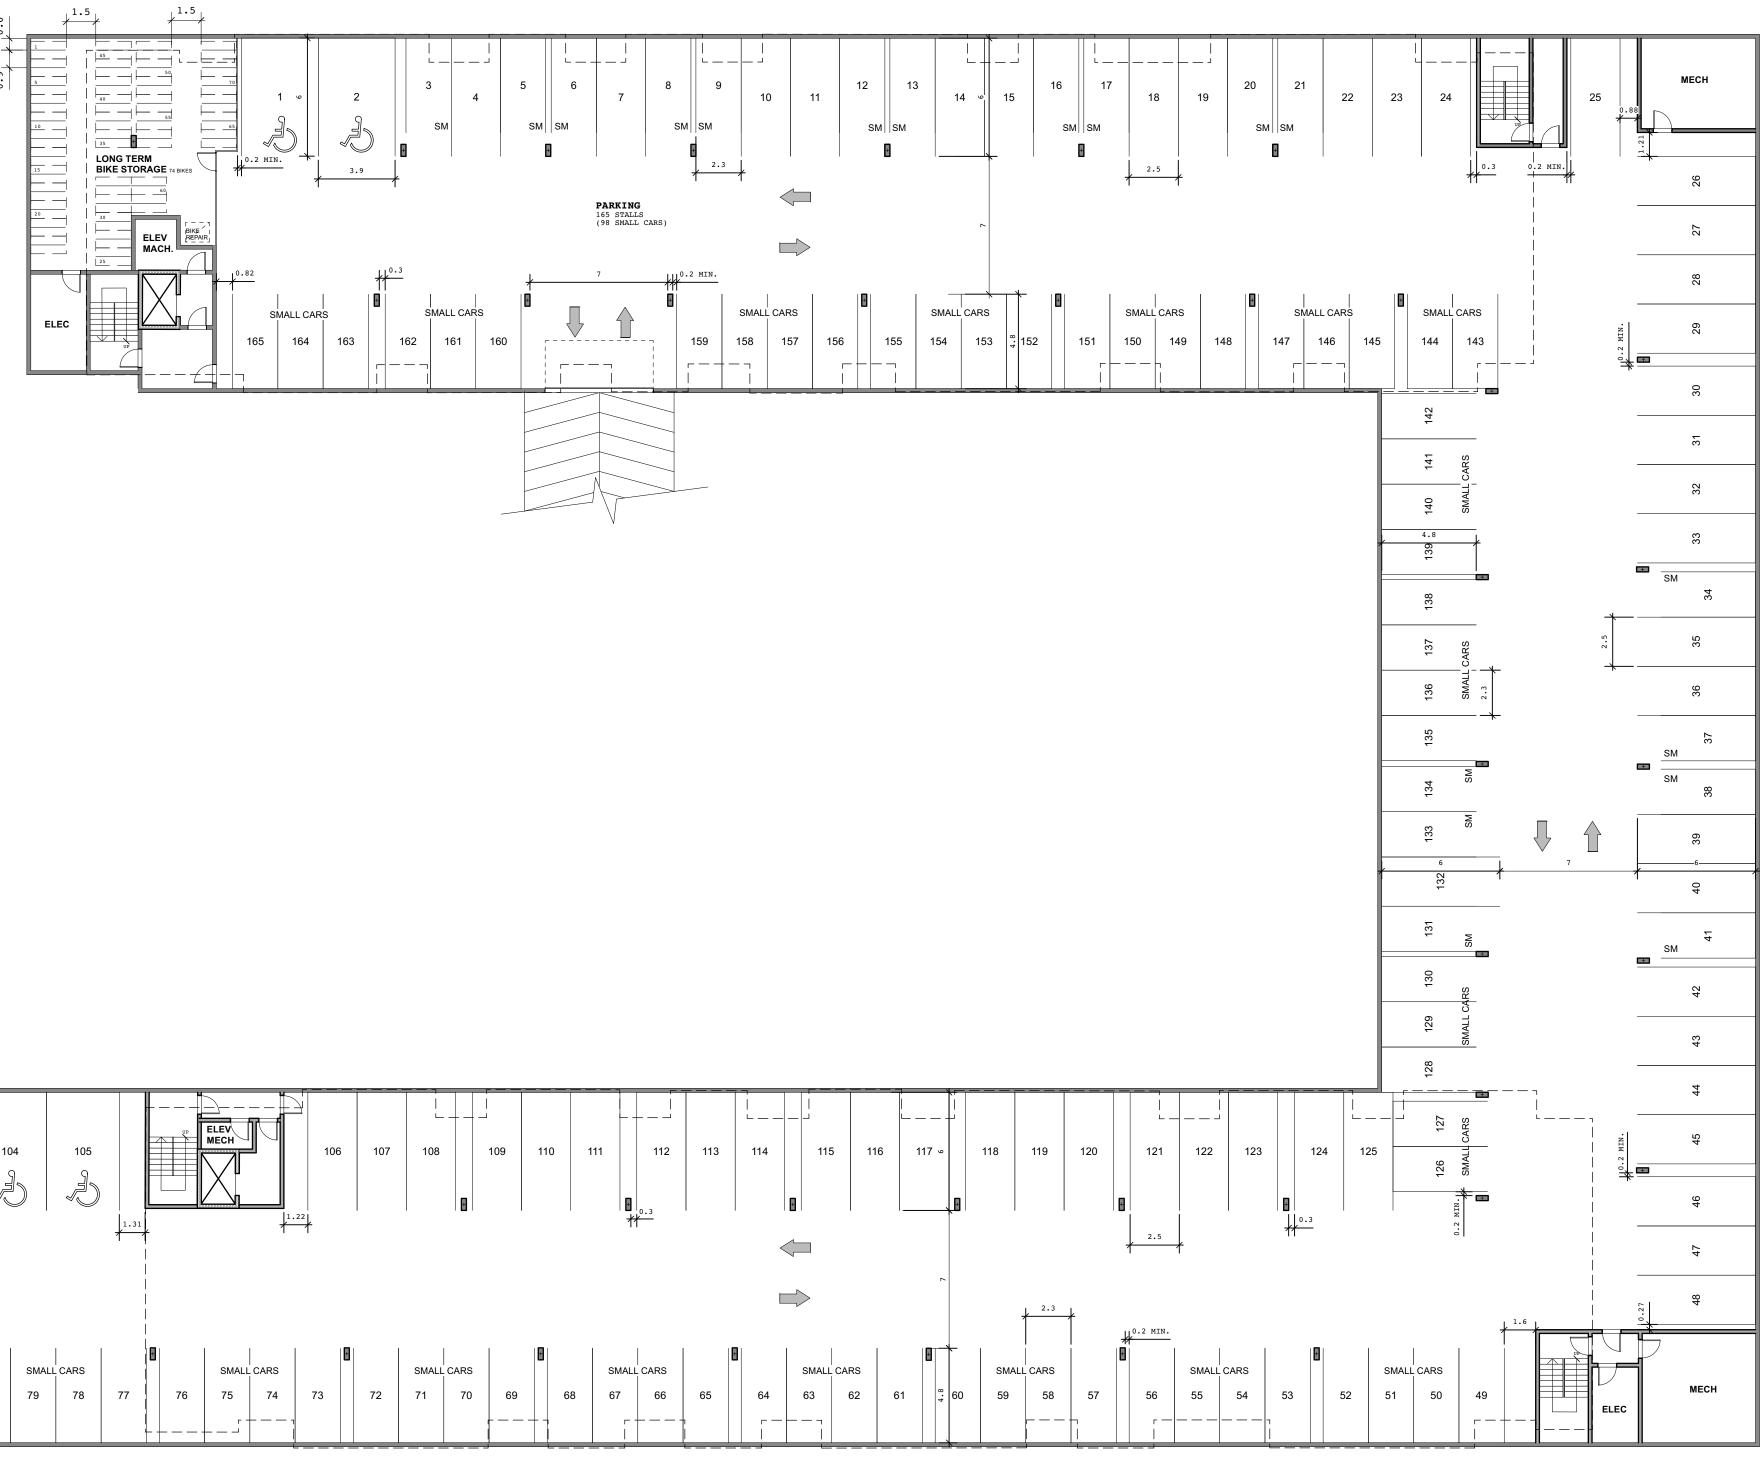

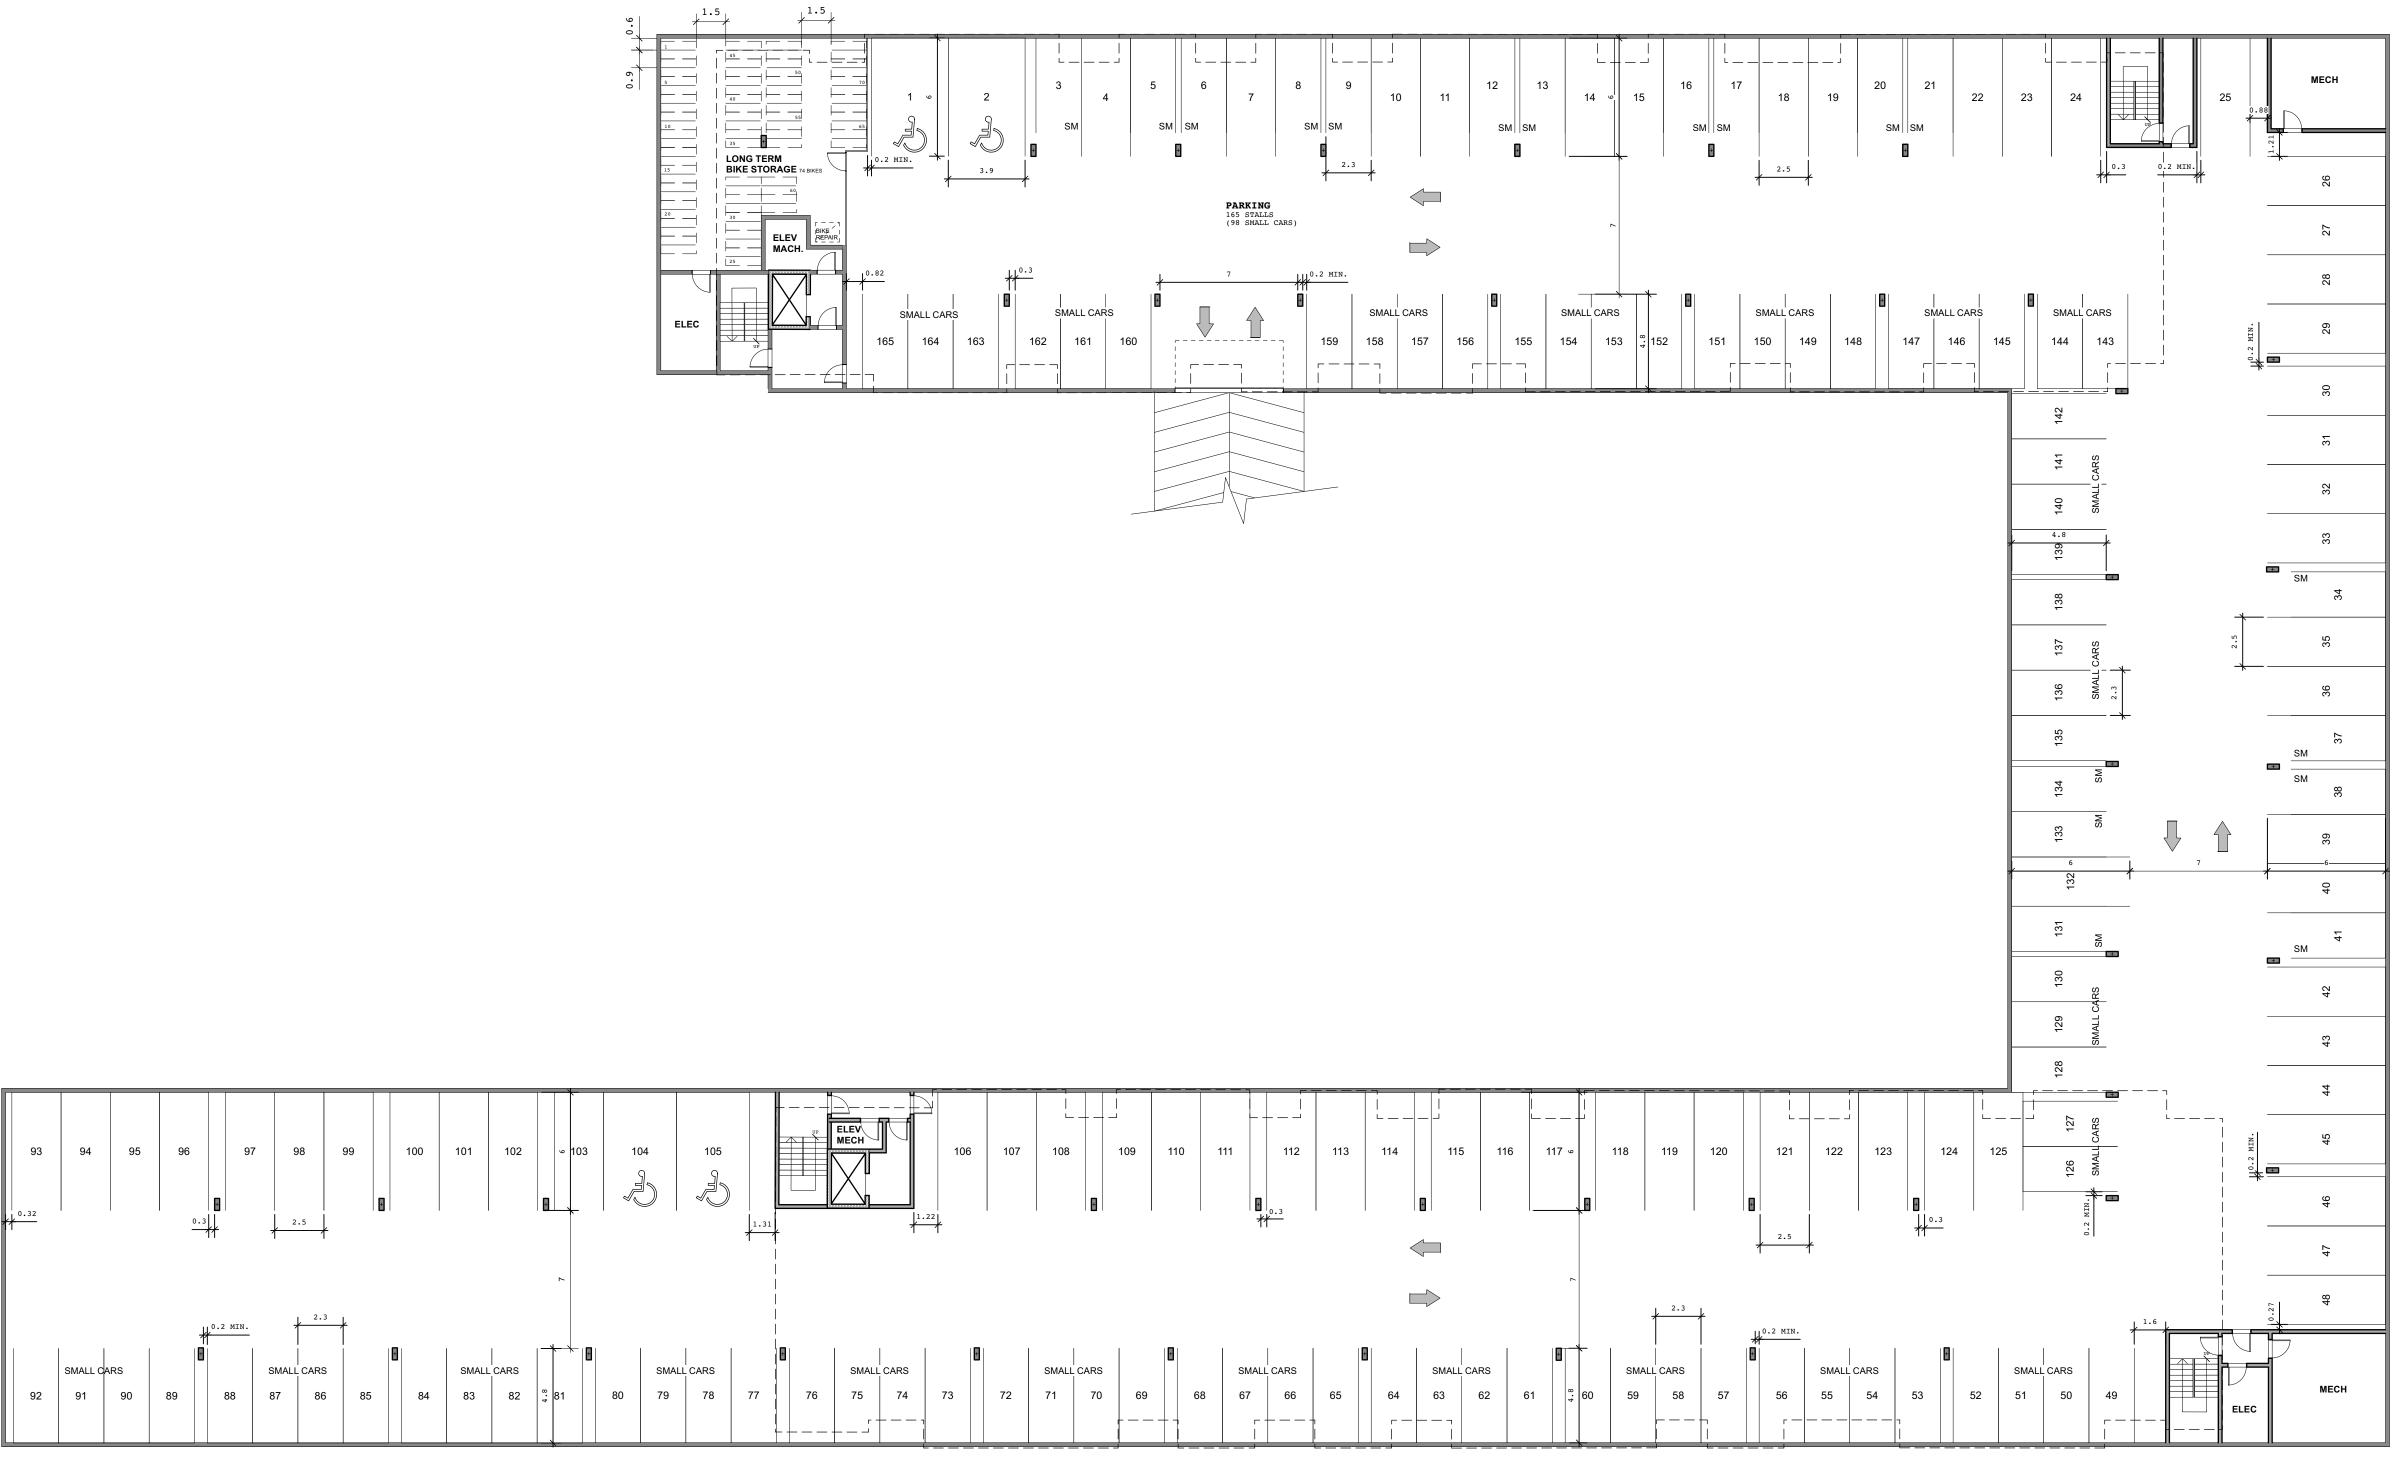
PARKADE PLAN SCALE: 1/16"=1'-0"

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PROJECT

DRAWING PARKADE PLAN

SCALE	AS NOTED	PROJECT NO	
DATE		DRAWN BY	TF <i>j</i> SW
SHEET			



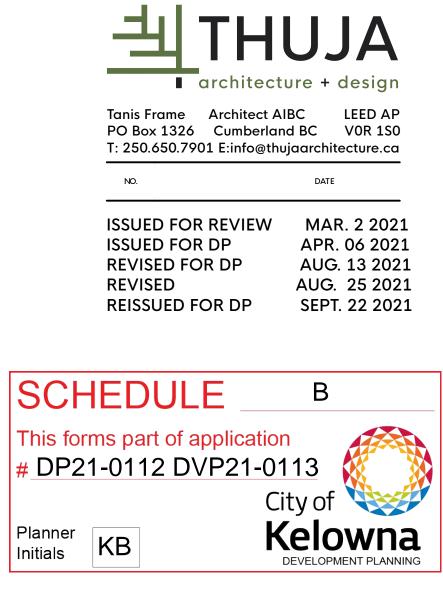









### 241'-2" BUILDING DIMENSION

241'-2" BUILDING DIMENSION

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REVISED

PROJECT

**REVISED FOR DP** 

ISSUED FOR REVIEW MAR. 2 2021 APR. 06 2021 AUG. 13 2021 AUG. 25 2021 REISSUED FOR DP SEPT. 22 2021

DATE




RUTLAND APARTMENT 155 BRYDEN RD, KELOWNA

DRAWING FLOOR PLANS


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DATE		DRAWN BY	TF <i>j</i> SW
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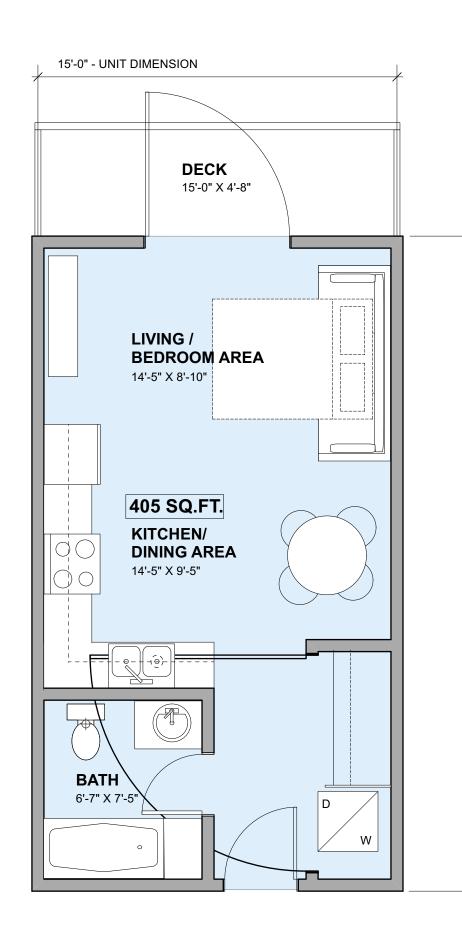
## THREE BEDROOM - "C"



## **ONE BEDROOM - "A"**

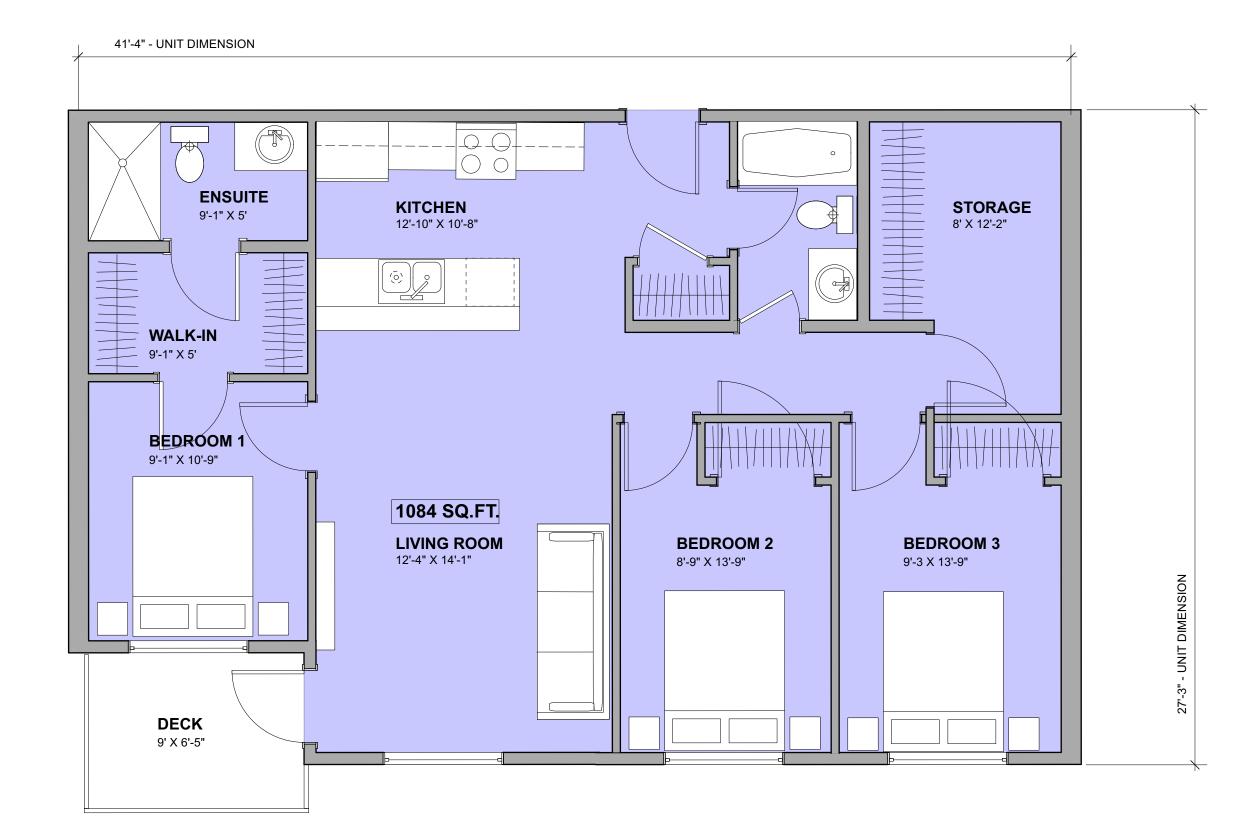


## STUDIO - "D"

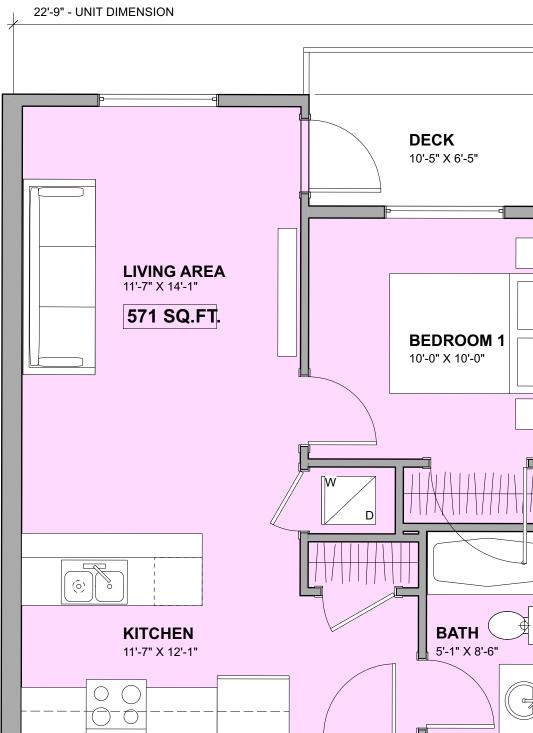

## **TWO BEDROOM - "B"**



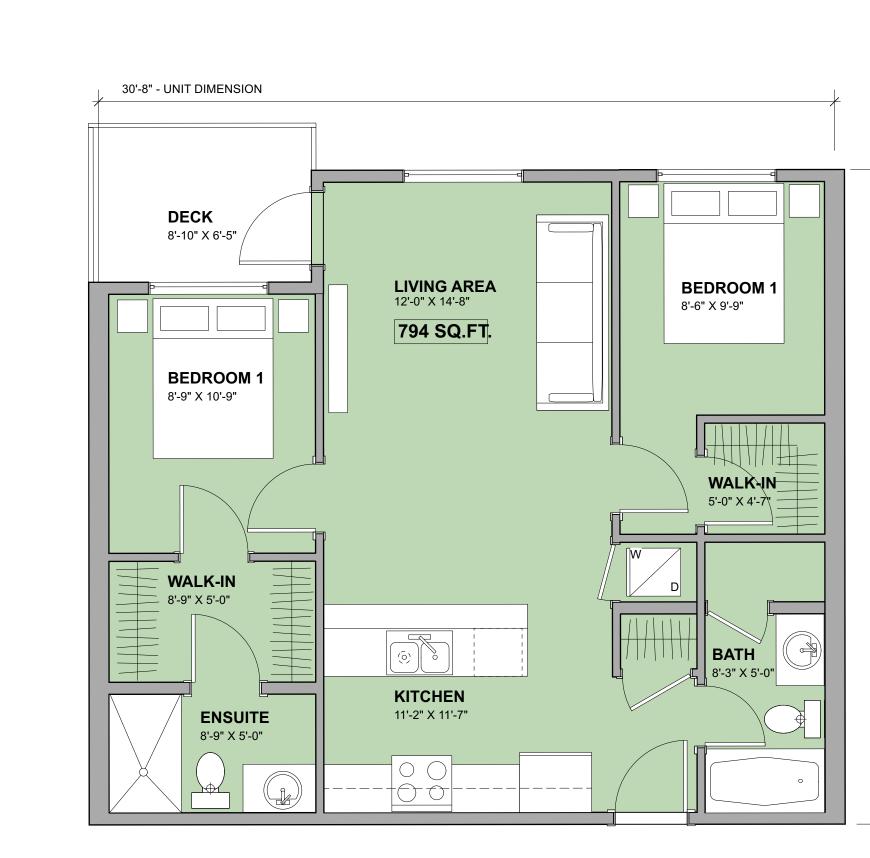

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RUTLAND APARTMENT 155 BRYDEN RD, KELOWNA

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PROJECT

TYPICAL UNIT PLANS

PROJECT NO. SCALE AS NOTED DRAWN BY TF/SW DATE SHEET

PR5

SIXTH FLOR T.O PLY 407.95	
SIXTH FLOR T.O PLY	
FIFTH FLOOR T. 0. PLY     Image: Angle in the image: Angle i	
FOURTH FLOOR T.O. PLY         Image: Construction of the plane between the plane	
399.7 Second FLOR T.O. PLY 396.95	
PARKADE SLAB 391.3	



### **NORTH ELEVATION**

PARKADE SLAB

TOP OF 413.79         ROOF	8	$ \begin{array}{cccccccccccccccccccccccccccccccccccc$	5	7 6	
$ \begin{array}{c}                                     $					
$ \bigoplus \frac{\text{SIXTH FLOOR T.0 PLY}}{407.95} $ $ \bigoplus \frac{\text{FIFTH FLOOR T.0 PLY}}{405.2} $					
FOURTH FLOOR T.O. PLY					- YPPROX. BUILDIN
ECOND FLOOR T.O. PLY <u>SECOND FLOOR T.O. PLY</u> <u>399.7</u>					
MAIN FLOOR T.O. PLY 394.2					

TOP OF ROOF 413.79			
<b>V</b> 413.79			•
SIXTH FLOOR T.O.W.			
SIXTH FLOOR T.O.W. 410.7			
SIXTH FLOOR T. O. PLY			
SIXTH FLOOR T.O PLY 407.95			
FIFTH FLOOR T.O PLY			
FIFTH FLOOR T.O PLY 405.2			
FOURTH FLOOR T.O. PLY			
FOURTH FLOOR T.O. PLY 402.45			
THIRD FLOOR T. O. PLY			
THIRD FLOOR T.O. PLY     399.7			
SECOND FLOOR T.O. PLY			
SECOND FLOOR T.O. PLY			
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a televisi televisi televisi			
MAIN FLOOR T.O. PLY			
MAIN FLOOR T.O. PLY 394.2			
	394:0 NG		*
	*1		4V <sub>G</sub>
PARKADE SLAB			
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CONTRACTOR TO VERIFY ALL LINES, LEVELS, SURVEYS, DIMENSIONS, LOCATION OF BUILDING ON SITE AND LOCATION OF ALL SERVICES PRIOR TO CONSTRUCTION. ALL WORK TO BE DONE IN ACCORDANCE WITH THE B.C. BUILDING CODE, CURRENT EDITION AND ALL LOCAL BUILDING BYLAWS.

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### MATERIAL LEGEND

412.25 MID-POINT OF ROOF

+/-393.45 +/- AVG. NAT. GRADE

2 7 5 4

11 3

- 1 FIBRE CEMENT LAP SIDING -TRUE GRAIN SERIES 'WEATHERED WOOD'
- (2) FIBRE CEMENT LAP SIDING -
- TRUE GRAIN SERIES 'NIGHT RIDER'
- (3) FIBRE CEMENT LAP SIDING -TRUE GRAIN SERIES 'SHOU SUGI BAN'
- (4) SOFFIT BLACK PERFORATED ALUMINUM
- **(5)** FASCIA BLACK FIBRE CEMENT
- (6) RAILINGS BLACK ALUMINUM
- (7) VINYL WINDOWS BLACK
- 8 WOOD POST & BEAM BLACK
- (9) FIBRE CEMENT LAP SIDING ACCENT IN 'COUNTRY LANE RED'
- 10 FIBRE CEMENT LAP SIDING ACCENT IN 'DEEP OCEAN'
- (11) FIBRE CEMENT PANELS IN IRON GREY
- (12) ROOFING SBS 2 PLY MEMBRANE BLACK

### **ᅴTHUJA** architecture + design

Tanis Frame Architect AIBC LEED AP PO Box 1326 Cumberland BC VOR 1S0 T: 250.650.7901 E:info@thujaarchitecture.ca

NO.

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	City of 🛛 💓
Planner Initials KB	Kelowna DEVELOPMENT PLANNING

RUTLAND APARTMENT 155 BRYDEN RD, KELOWNA

PROJECT

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PROPOSED ELEVATIOI BUILDING A	۷S

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### NORTH ELEVATION

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<u>TOP OF ROOF</u> 413.79	8		3			 	(5)	12	0.	) 	(7)	( <b>6</b> )	 (5)		2	( <b>11</b> )	( <u>1</u> )	
SIXTH FLOOR T.O.W.						• •	• •		× >				<u></u>					· · · ·
ELETH FLOOR T.O. PLY				• 3														
FOURTH FLOOR T.O. PLY FOURTH FLOOR T.O. PLY 402.45																		
THIRD FLOOR T.O. PLY																		
SECOND FLOOR T.O. PLY																		
MAIN FLOOR T.O. PLY 394.2	294 0 2 100 *1-554 2 100												APP	ROX. EXISTING GRADE	e prop.			
PARKADE SLAB																		





LOOR <u>T.O.W.</u> 410.7	SIXTH FLOOR T.O.W.		
OOR T.0 PLY 407.95	SIXTH FLOOR T.O PLY		
$\frac{\text{DOR}}{405.2} \underbrace{\text{T.O PLY}}_{405.2}$	FIFTH FLOOR T.O PLY		
DR T.O. PLY 402.45	FOURTH FLOOR T.O. PLY		
OR T.O. PLY 399.7	THIRD FLOOR T.O. PLY 399.7		
OR T.O. PLY 396.95	SECOND FLOOR T.O. PLY 396.95		
OR T.O. PLY 394.2	MAIN FLOOR T.O. PLY 394.2	339.5 A 2 VG	
ARKADE SLAB 391.3	PARKADE SLAB	EAST ELEVA	

TOP OF ROOF 413.79 **(5) (7)** 

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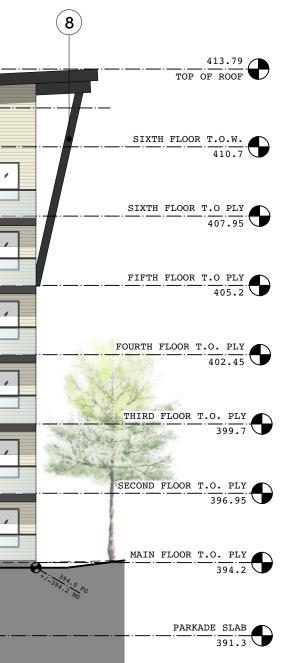
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MATERIAL LEGEND

- (1) FIBRE CEMENT LAP SIDING -
- TRUE GRAIN SERIES 'WEATHERED WOOD'
- (2) FIBRE CEMENT LAP SIDING -
- TRUE GRAIN SERIES 'NIGHT RIDER'
- (3) FIBRE CEMENT LAP SIDING -
- TRUE GRAIN SERIES 'SHOU SUGI BAN'
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- 5 FASCIA BLACK FIBRE CEMENT
- 6 RAILINGS BLACK ALUMINUM
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SSUED FOR DP	APR. 06 2021
REVISED FOR DP	AUG. 13 2021
REVISED	AUG. 25 2021
REISSUED FOR DP	SEPT. 22 2021

DATE

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Planner Initials	KB	Kelowna DEVELOPMENT PLANNING

PROJECT

RUTLAND APARTMENT 155 BRYDEN RD, KELOWNA

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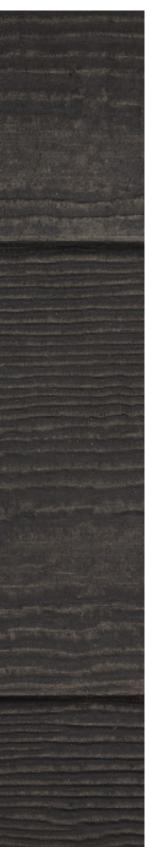
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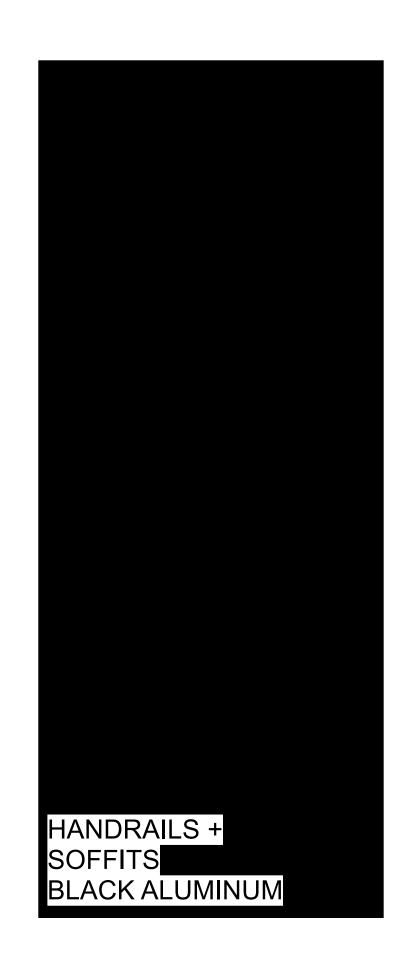




FIBRE CEMENT

LAPPED SIDING IN WEATHERED WOOD







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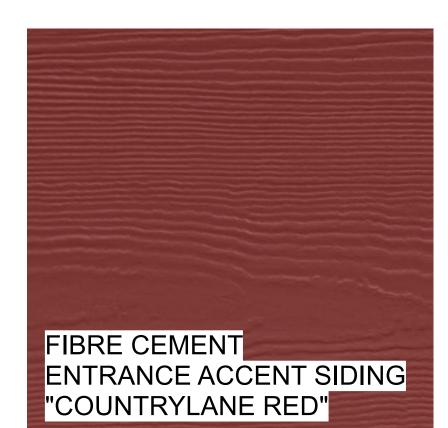
RUTLAND APARTMENT 155 BRYDEN RD, KELOWNA

PROJECT

DRAWING MATERIALS

PROJECT NO. SCALE AS NOTED DRAWN BY TF/SW DATE SHEET









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	City of
Planner Initials KB	Kelowna DEVELOPMENT PLANNING

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RUTLAND APARTMENT 155 BRYDEN RD, KELOWNA

PROJECT

drawing RENDERINGS


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DATE		DRAWN BY	TF <i>j</i> SW
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### **PROJECT PLANT LIST**

YMBOL	BOTANICAL NAME	COMMON NAME	COUNT	SIZE
	TREES			
Aa	Amelanchier x grandiflora	Autumn Brilliance Serviceberry (multistem)	10	2m Ht WB
Am	Acer ginnala	Amur Maple	7	#5pot
В	Betula jacquemontii	Himalayan Birch (multistem)	3	2m Ht WB
WS	Chamaecyparis lawsoniana	Wissel's Saguaro	7	2m Ht WB
BE	Ulmus americana ' Brandon'	Brandon Elm	4	6cm Cal.
Fs	Fagus sylvatica 'Red Obelisk'	Red Obelsik Beech	15	6cm Cal.
LI	Larix laricina	Tamarack	2	6cm Cal.
PG	Picea glauca	White Spruce	1	2m
Ррс	Picea pungens	Green Colorado Spruce	2	2m
PpH	Picea pungens 'Hoopsii'	Hoopsii Blue Spruce	11	2m
PvS	Prunus virginiana schubert	Shubert Chokecherry	4	6cm Cal.
Sr	Syringa reticulata	Japanese Lilac	16	6cm Cal.
	SHRUBS			
AaN	Amelanchier alnifolia 'Northline'	Northline Saskatoon	27	#2pot
AbN	Abies balsamea Nana	Dwarf Balsam Fir	78	#2pot
Brg	Berberis thunbergii 'Rose Glow'	Rose Glow Barberry	39	#2pot
CaB	Cornus alba 'Bailhalo'	Ivory Halo - Variegated	13	#2pot
CaK	Cornus sericea 'Kelseyi'	Dwarf Kelsey Dogwood	11	#2pot
CsF	Cornus sericea ' Farrow'	Artic Fire Dogwood (Dwarf)	40	#2pot
CaS	Caragana arborescens 'Southerland'	Southerland Caragana	15	#2pot
Cs	Cornus stolonifera	Red Twig Dogwood	15	#2pot
С	Cotoneaster lucidus/acutifolia	Cotoneaster Hedge	49	#2pot
HaA	Hydrangea arborescens 'Annabelle'	Annabelle Hydrangea	13	#2pot
HH	Rosa rugosa 'Henry Hudson'	Henry Hudson Rose (White)	136	#2pot
Ja	Juniperus horizontalis 'Andorra'	Andorra Juniper	14	#2pot
Jbp	Juniperus horizontalis 'Blue Prince'	Blue Prince Juniper	5	#2pot
Mr	Mahonia repens	Creeping Oregon Grape	48	#2pot
Jscc	Juniperus sabina 'Calgary Carpet'	Calgary Carpet Juniper	7	#2pot
Pm	Pinus mugo pumilio	Dwarf Mugo Pine	41	#2pot
Pv	Philadelphus x virginalis	Mock Orange	5	#2pot
pvs	Philadelphus x virginalis 'Dwarf Snowflake'	Miniature Snowflake Mock Orange	48	#2pot
pod	Physocarpus opulifolius 'Donna May'	Little Devil Ninebark	15	#2pot
Ra	Ribes alpinum	Alpine Currant	48	#2pot
Rp	Rhododendron PJM	PJM Rhododendron	14	#2pot
sjlp	Spiraea japonica 'Little Princess'	Little Princess Spirea	9	#2pot
Sgf	Spiraea x bumalda 'Goldflame'	Goldflame Spirea	24	#2pot
Sb	Symphoricarpos albus	Snowberry	50	#2pot
SxB	Syringa meyeri 'Boomerang'	Boomerang Lilac	11	#2pot
	ORNAMENTAL GRASSES	Fasther Deed Oreas	454	#4
<u>Ck</u>	Calamagrostis x acutifolia 'Karl Foerster'	Feather Reed Grass	154	#1pot
Dc	Deschampia cespitosa	Tufted Hairgrass	116	#1pot
<u>H</u>	Helictotrichon sempervirens	Blue Oat Grass	153	#1pot
b	Ophiopogon planiscapus	Black mondo grass Prairie Dropseed	206 50	#1pot #1pot

	PERENNIALS/GROUNDCOVERS	
Al	Allium	F
DS	Perovskia atriplicaifolia 'Little Spire'	[
е	Echinacea purpurea	F
Hh	Hemmerocallis hybrid	[
Hfd	Hosta 'Fragrant Dream'	F
k	Arctostaphyllos uva-ursi	ł
Ν	Nepeta x faassenii 'Dropmore'	[
sr	Smilacina racemosa	F
0	Matteuccia struthiopteris	(
Y	Yucca filamentosa 'Golden Sword'	(



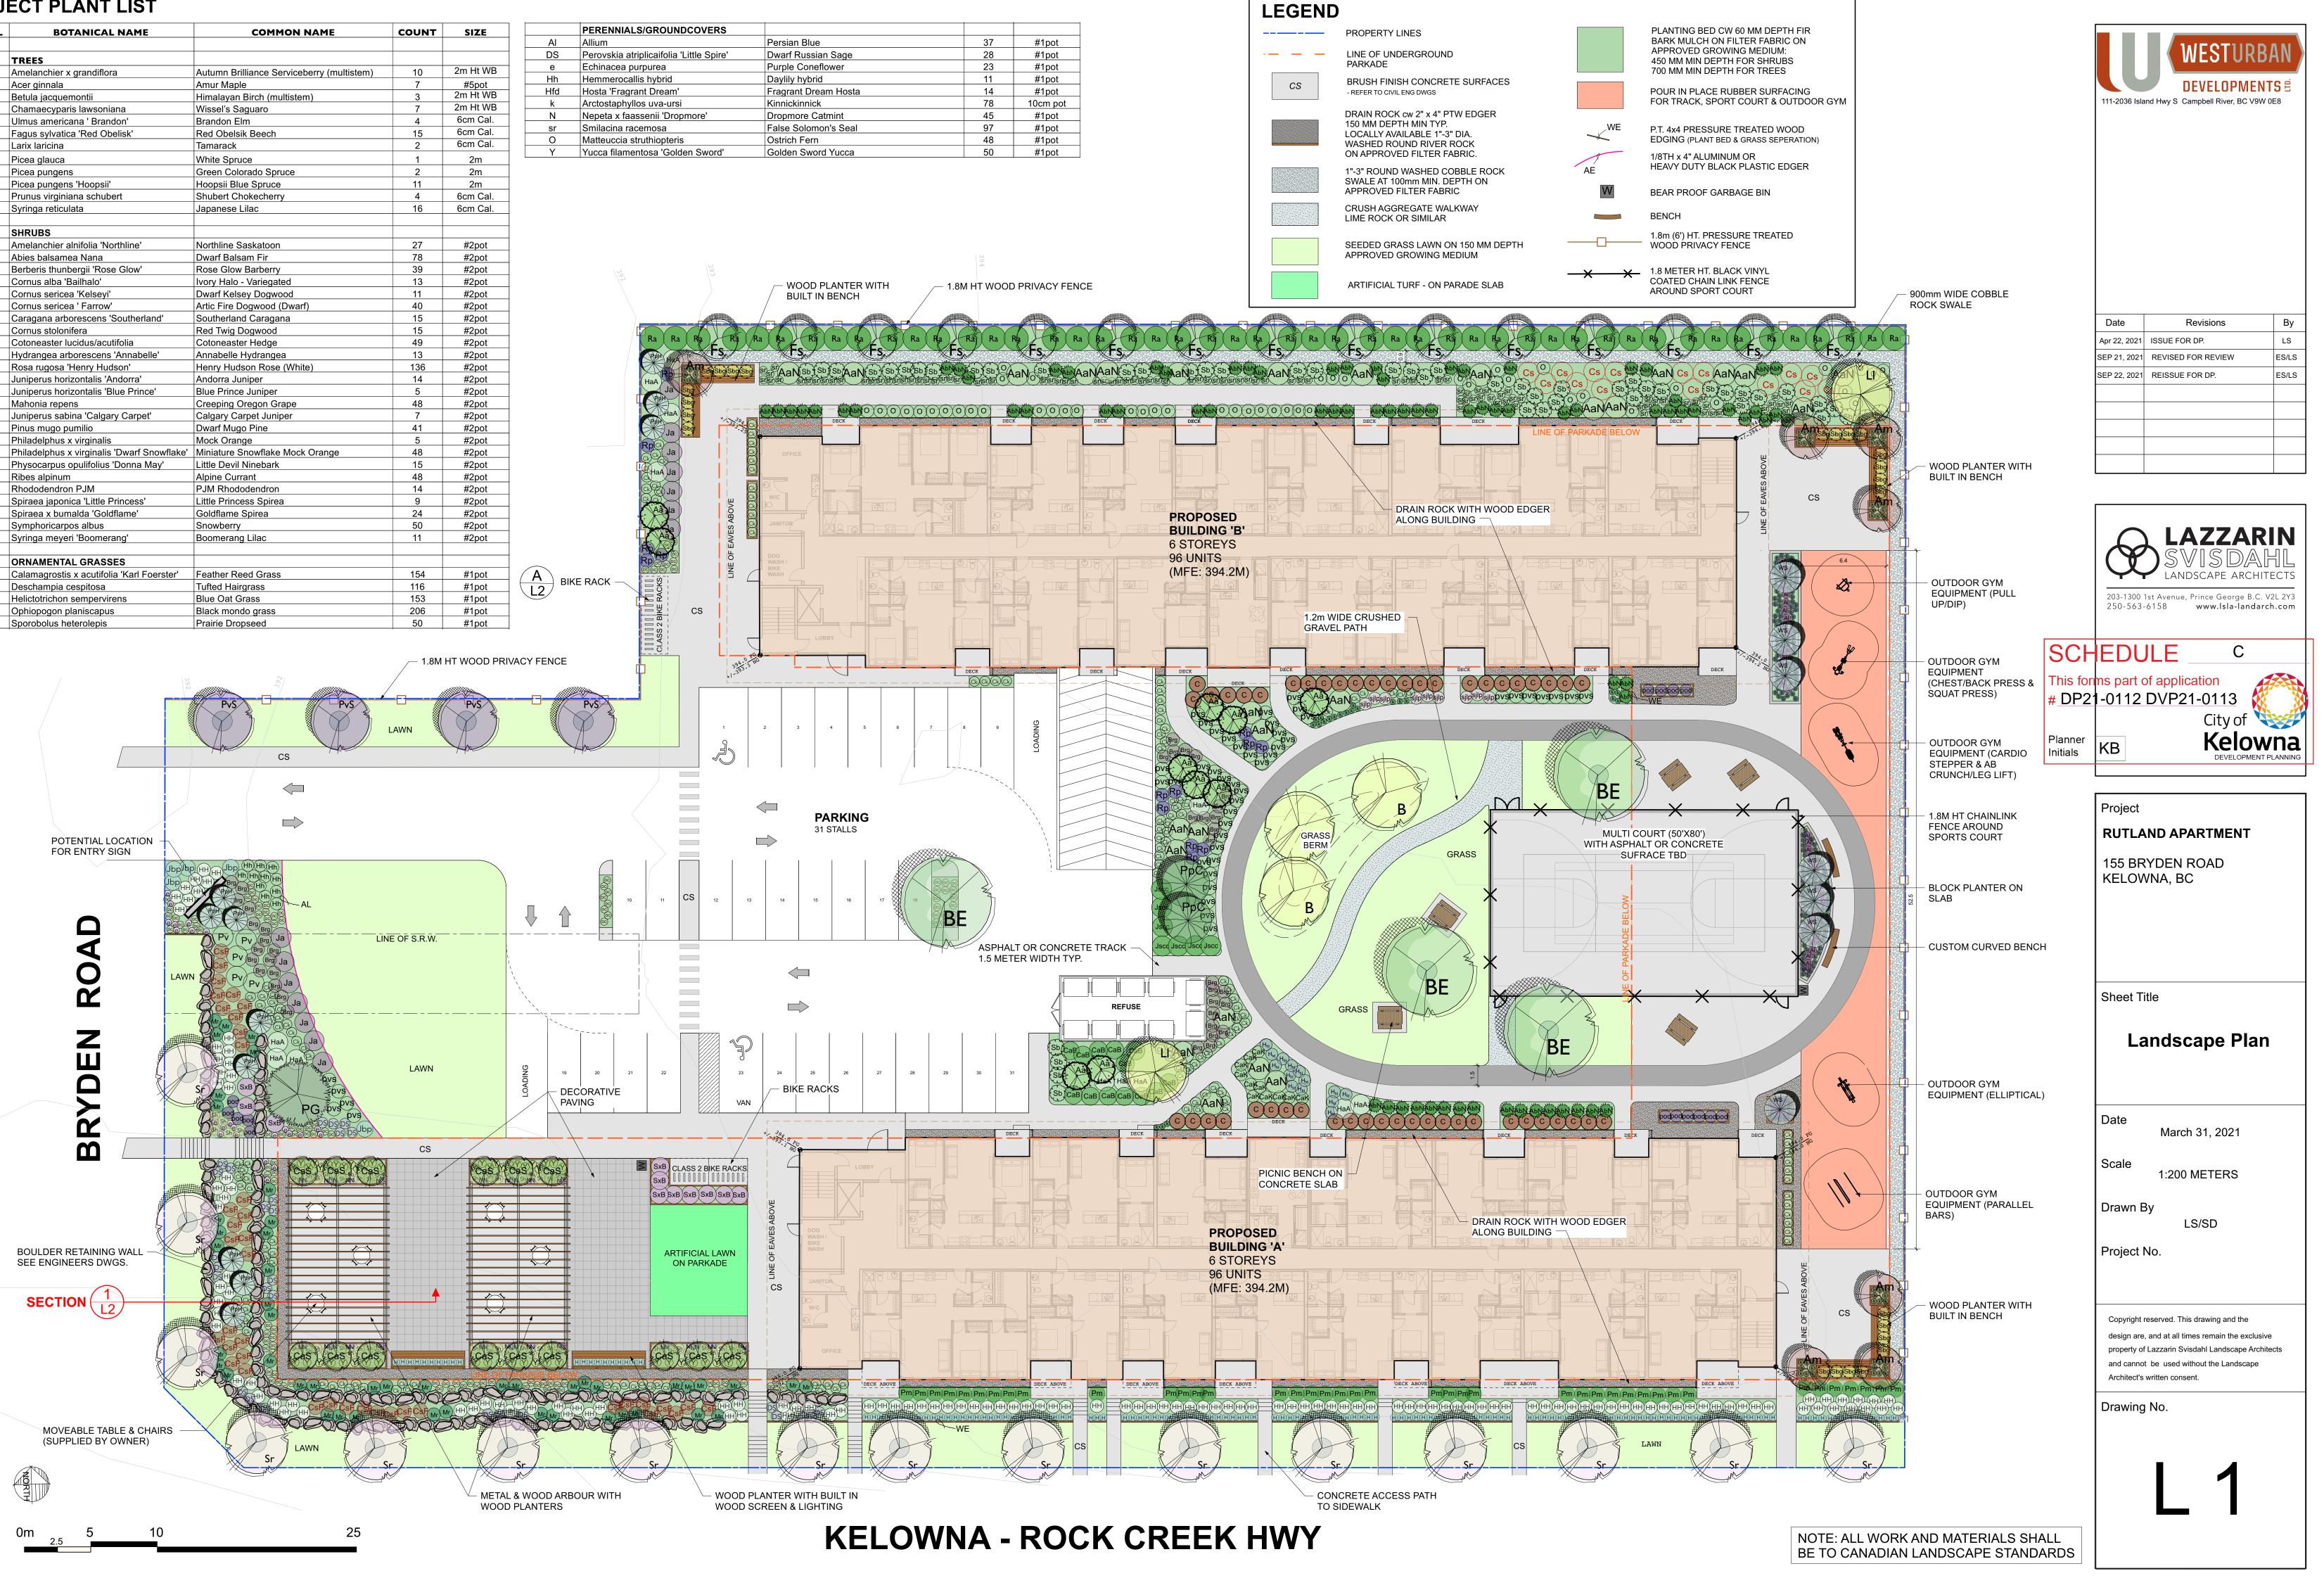


'DERO HOOP' BIKE RACK (CAPACITY 2 BIKES EACH). REFER TO L100 & L102 FOR LOCATION.

**BIKE RACK** 


COLOUR: STANDARD BLACK POWDER COATED


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## PRECEDENT EXAMPLE OF WOOD PLANTER & BUILT-IN BENCH

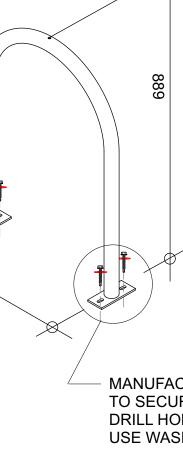




### **SECTION VIEW**

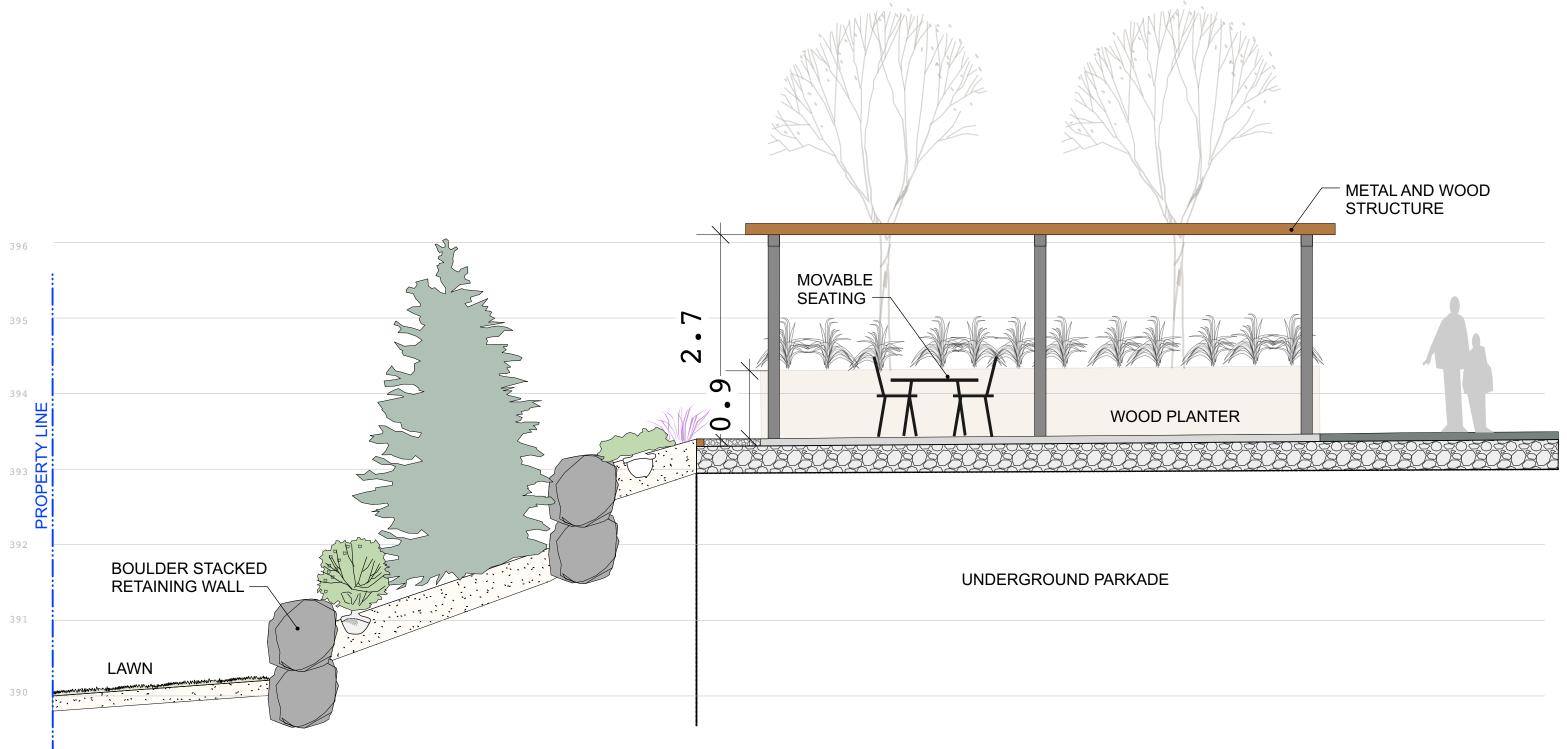MANUFACTURER SUPPLIED 3/8" DIA. KWIK ANCHOR BOLTS TO SECURE BIKE RACK TO CONCRETE BASE. DRILL HOLES IN CONCRETE TO 3" DEPTH. USE WASHER(S) IF NECESSARY TO LEVEL RACK.

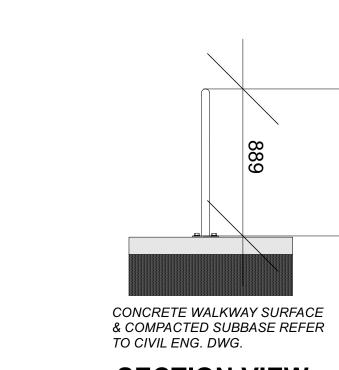NOT TO SCALE

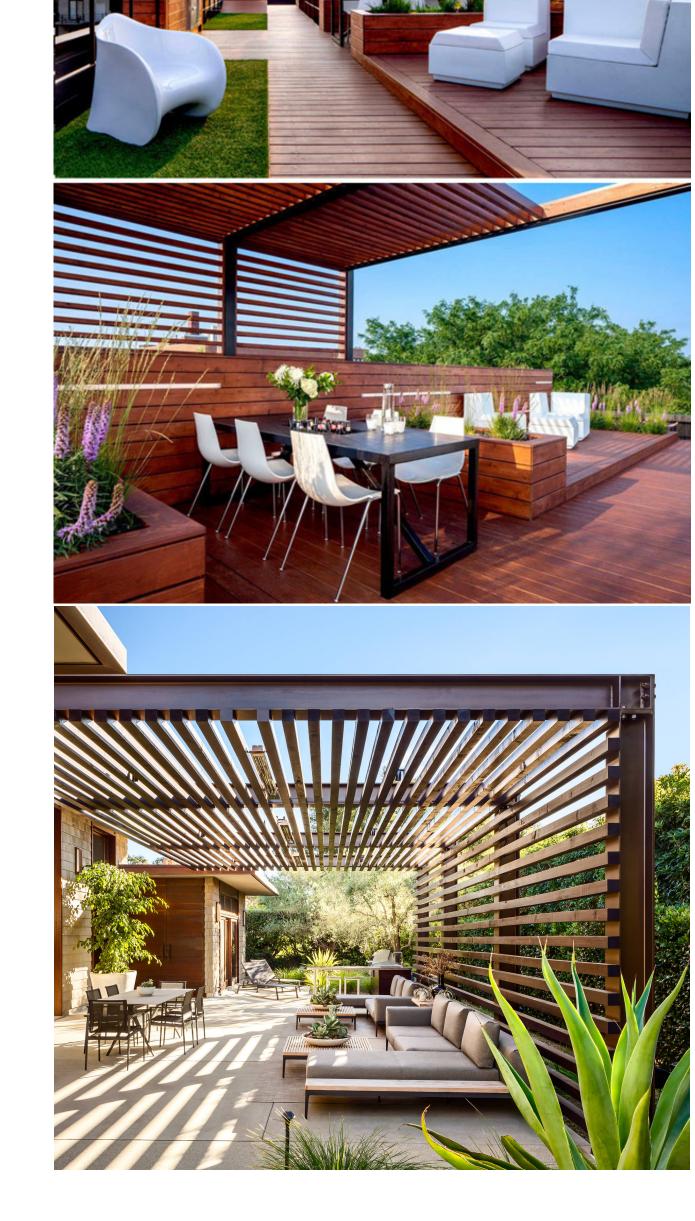



Ab Crunch/ Leg Lift




Parallel Bars



Cardio Stepper




Pull Up/ Dip

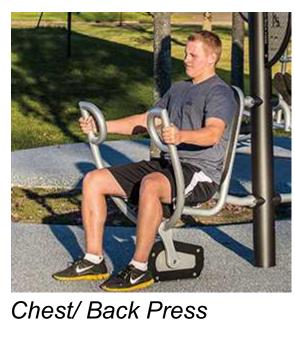



Squat Press

HEALTH BEAT FITNESS EQUIPMENT BY HABITAT SYSTEMS

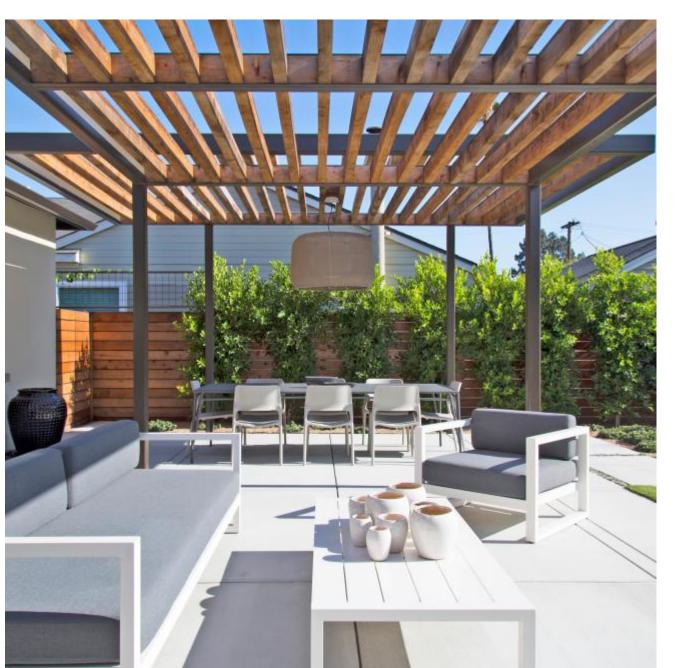

### PRECEDENT IMAGES OF WOOD **& METAL ARBOUR STRUCTURE**



### LAWN BERM BY ATHLETIC COURT



Elliptical



Date	Revisions	Ву
Date	Tevisions	Dy
Apr 22, 2021	ISSUE FOR DP.	LS
Sep 22, 2021	REISSUE FOR DP.	LS



Planner nitials KB

Kelowna DEVELOPMENT PLANNING

Project	
RUTLAND APAR	RTMENT
155 BRYDEN RC KELOWNA, BC	DAD
Sheet Title	
Landscape Sect	
Date March 3	1, 2021
Scale as sh	own
Drawn By LS/	SD
Project No.	
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Drawing No.	
	2



### HYDROZONE NOTES

### **DESIGN INTENT:**

THIS DRAWING ILLUSTRATES THE APPROXIMATE DESIGNED DIVISION OF THE LANDSCAPE INTO AREAS OF DIFFERENT WATERING REQUIREMENTS. IT IS NOT INTENDED TO BE USED FOR CONSTRUCTION.

### **GROWING MEDIUM:**

0m

2.5


SCALE: 1:200

ENSURE THAT ADEQUATE GROWING MEDIUM TYPE AND DEPTHS ARE INSTALLED. IT IS IMPORTANT IN ORDER TO STORE AND RETAIN WATER AND NUTRIENTS FOR PLANT SURVIVAL AND GROWTH. SEE ATTACHED WATER SEE ATTACHED WATER CONSERVATION CALCULATION SPREADSHEET.

### ESTABLISHMENT WATER USE:

ALL IRRIGATION ESTABLISHMENT AREA(S) SHALL BE TEMPORARY AND FOR ESTABLISHMENT AND DROUGHT CONDITIONS ONLY.

LANDSCAPE WATER BUDGET (WB) = 2,433 cu.m./yr. ESTIMATED LANDSCAPE WATER USE (WU) = 2,314 cu.m./yr. WATER BUDGET IS UNDER BY 119 cu.m./yr.

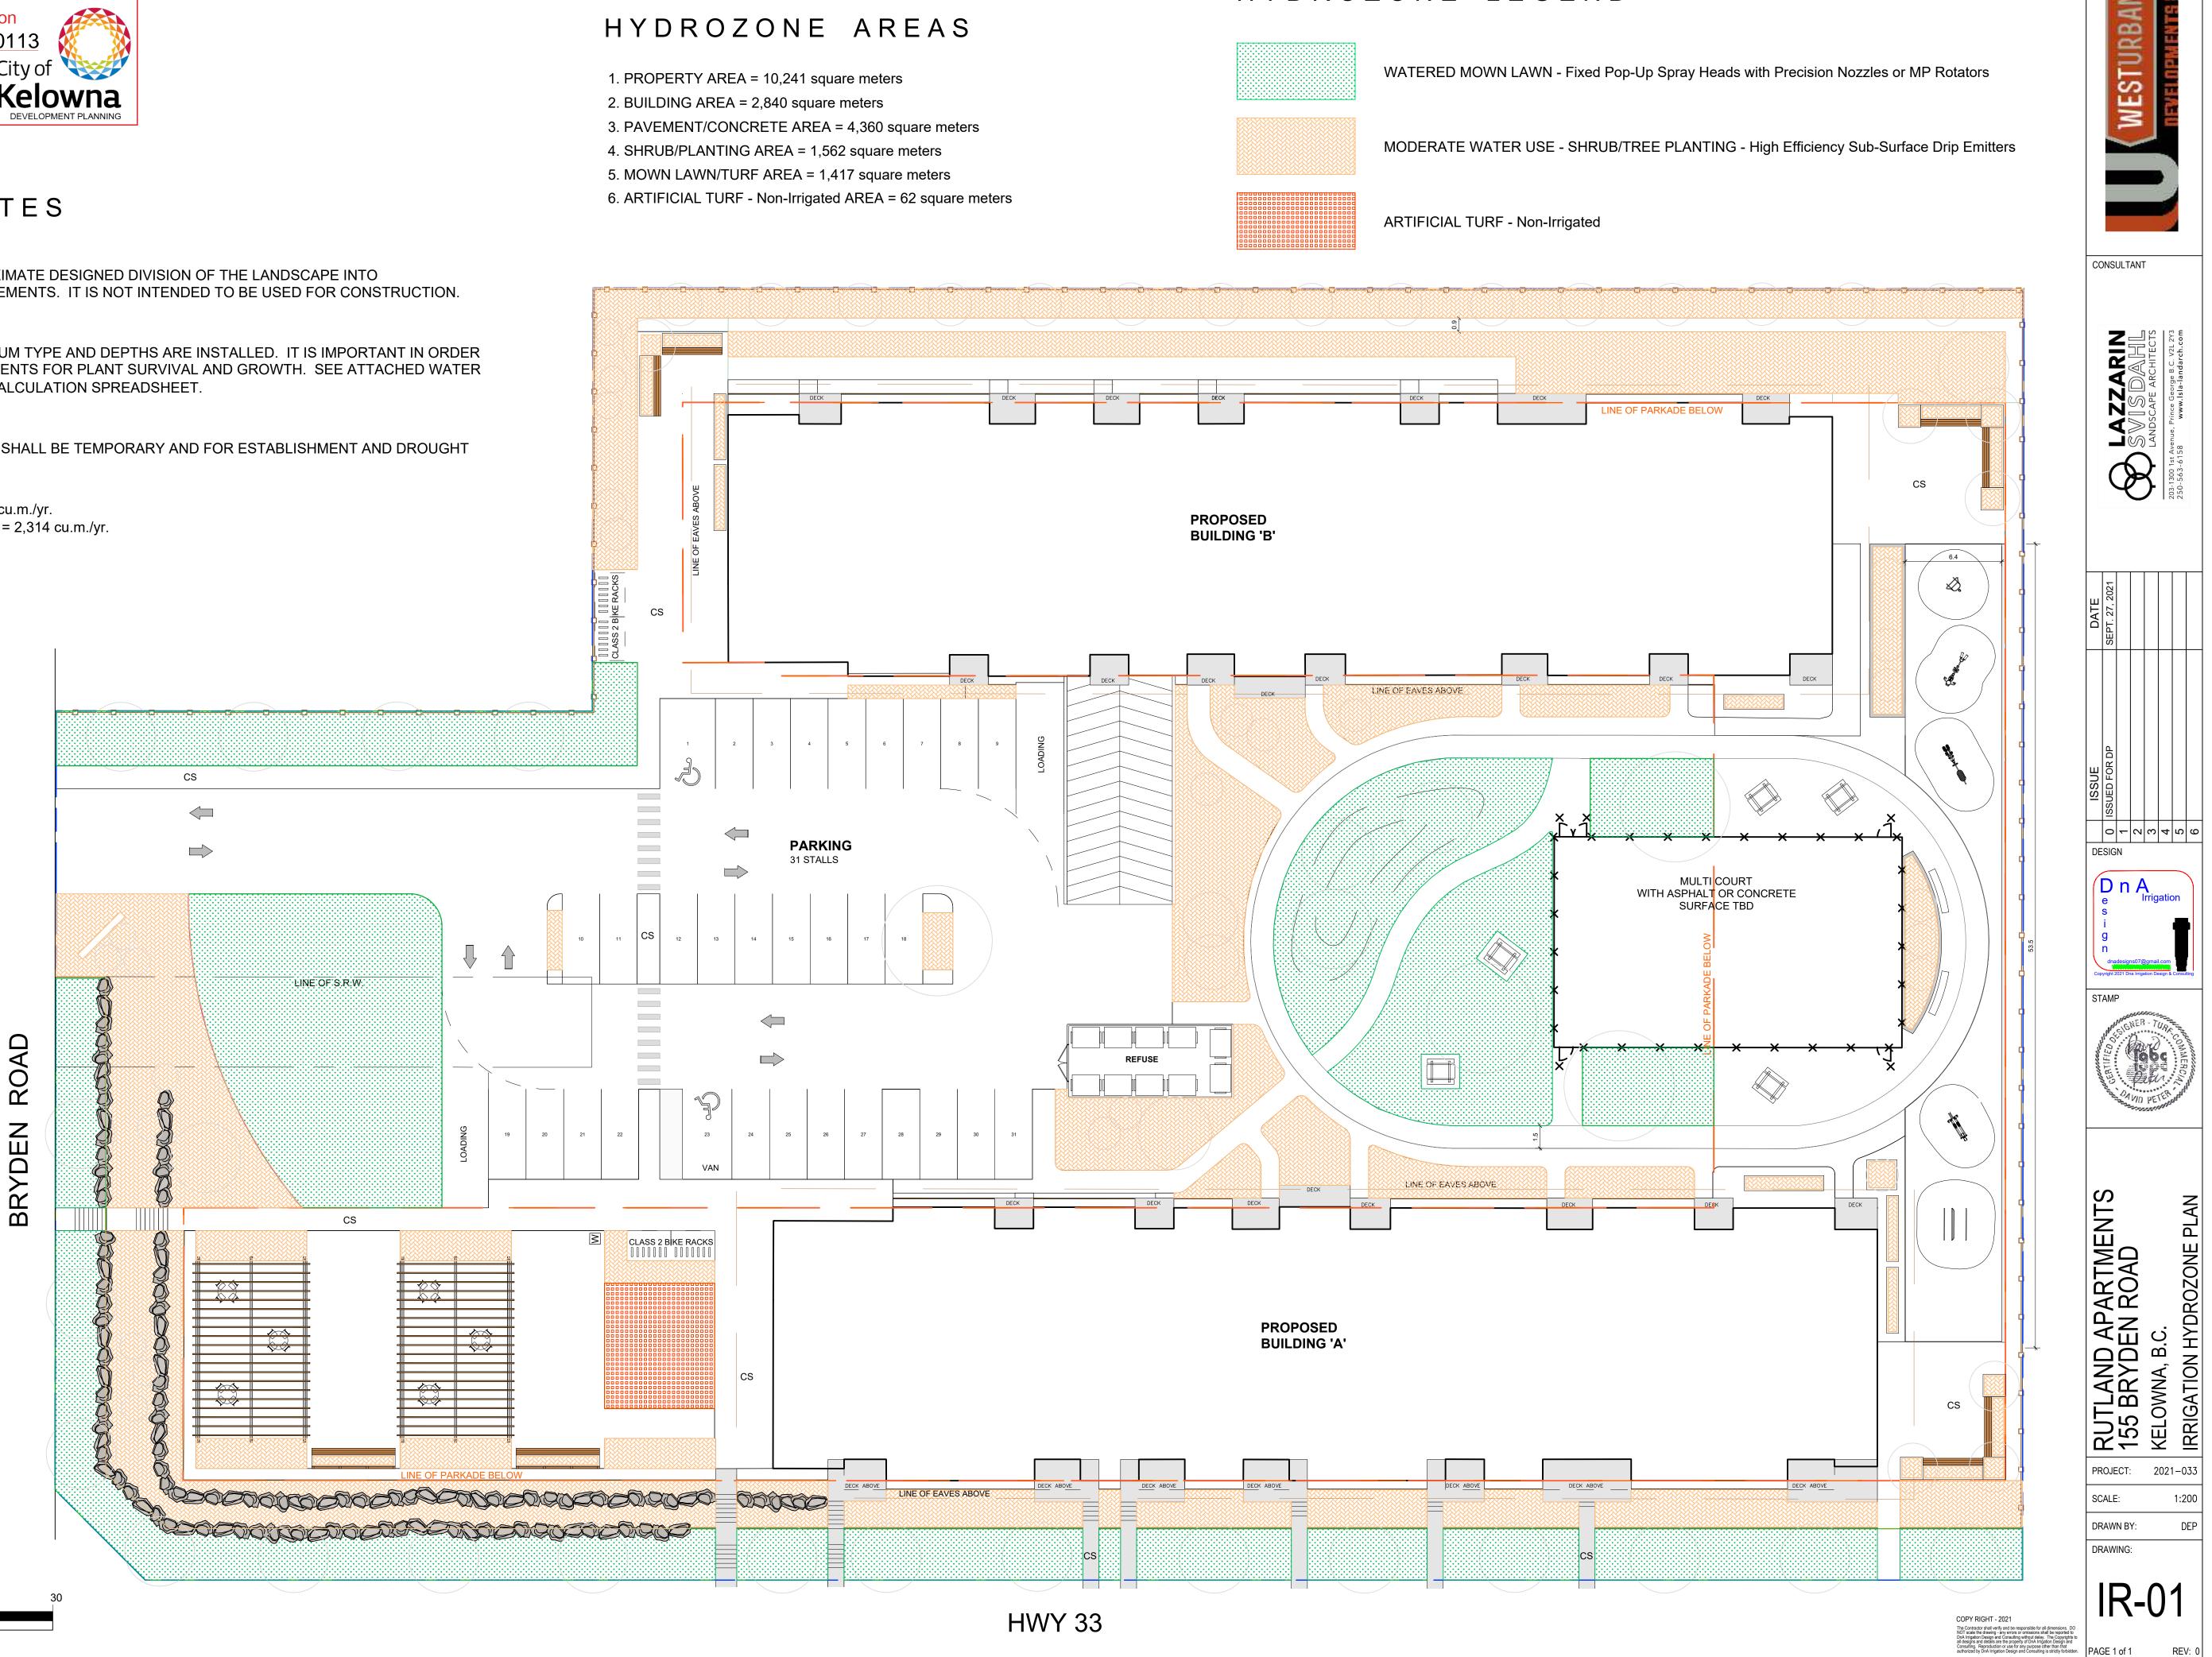

### HYDROZONE LEGEND

OWNER

1:200

DEP

REV: 0