## PROJECT DATA


CIVIC ADDRESS: 5008 SOUTHRIDGE DRIVE

LEGAL DESCRIPTION: LOT 2, PLAN 68647, DL , O.D.Y.D.

CURRENT ZONING: C1 LOCAL COMMERCIAL

#### ZONING BYLAW REQUIREMENTS

SITE AREA: BUILDING AREA:	12,995 SQ.FT. (1,207.3 SQ.M	.)
,	2,520 SQ.FT. (234.1 SQ.M.) 2,120 SQ.FT. (197.0 SQ.M.) 4,640 SQ.FT. (431.1 SQ.M.)	
	<u>REQUIREMENTS</u>	<u>EXISTING</u>
LOT WIDTH	40.0m	30,0m
LOT DEPTH	30.0m	39.99m
LOT AREA	830 sq.m.	1,207.3 sq.m.
	<u>PERMITTED</u>	PROPOSED
FAR COMMERCIAL	0.3 (362.2 sq.m.)	0.19 (234.1 sq.m.)
FAR RESIDENTIAL	0.2 (241.5 sq.m.)	0.16 (197.0 sq.m.)
SITE COVERAGE	035 (422.6 sq.m.)	, , ,
HEIGHT (m)	10.5m/ 2.5 STOREYS	9.0m/ 2 STOREYS
SETBACKS (m)		
FRONT (SOUTHRIDGE DRIVE)	4.5m	9.84m
SIDE (FROST ROAD)	4.5m	4.94m
SIDE (SOUTH) REAR (WEST)	3.0m 3.0m	16.03m 3.0m
NEAN (WEST)	5.0111	5.011
PARKING		
RETAIL @ 2.0/100 sq.m. GFA x	: 234,1 sq.m. = 5 STALLS	7 STALLS
RESIDENTIAL 2/UNIT =	4 STALLS	4 STALLS
LOADING @ 1/1900 sq.m. GFA	= 1 STALL	1 STALL
BICYCLE PARKING		
CLASS I @ 0.2/100 sq.m. G	·	
	1 SPACE	
CLASS II @ 0.6/100 sq.m. (	GLA = 2 SPACES	2 SPACES
LANDSCAPE BUFFERS (m)		
FRONT (SOUTHRIDGE DRIVE) SIDE (FROST ROAD)	3.0m	4.5m 4.94m
SIDE (FROST ROAD) SIDE (SOUTH)	3.0m* 3.0m*	OPAQUE BARRIER
REAR (WEST)	3.0m*	3.0m
LANDSCAPE TREATMENT LEVELS	* OR OPAQUE E <u>S</u>	DAINNEN
FRONT (SOUTHRIDGE DRIVE)		2
SIDE (FROST ROAD) SIDE (SOUTH)	2 3 3 3	2 3 3 3
REAR (WEST)	3	3

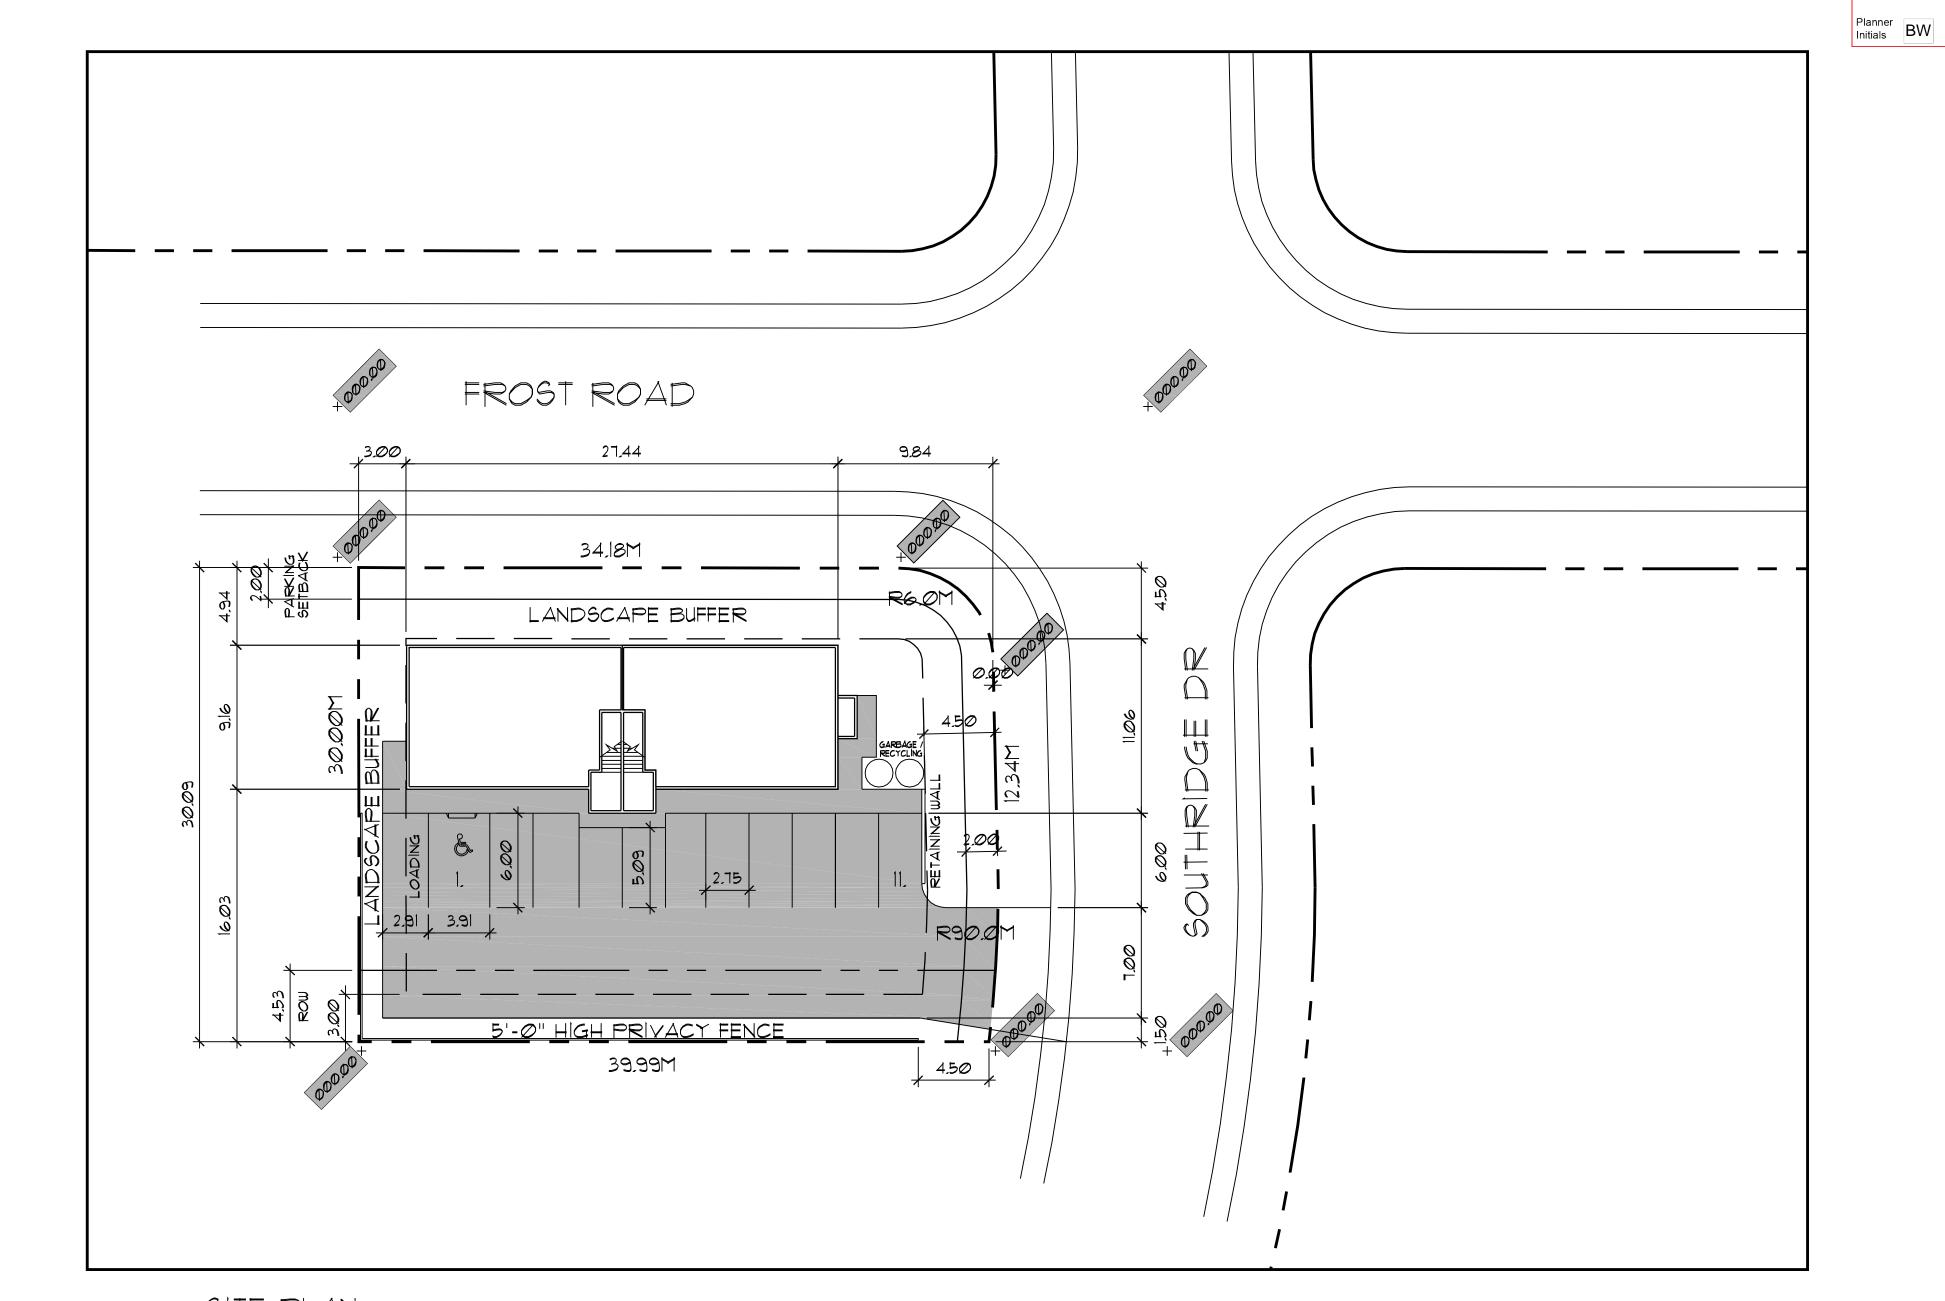

SITE PLAN SCALE: 1" = 20'-0"

> 5008 SOUTHRIDGE DR, KELOWNA LOT 2, PLAN 68647

SCALE: 1" = 20'-0"

DATE: FEB 2,2020

SITE PLAN


ATTACHMENT A

City of Kelowna

NORTH

This forms part of application # Z21-0049

DRAWING No.

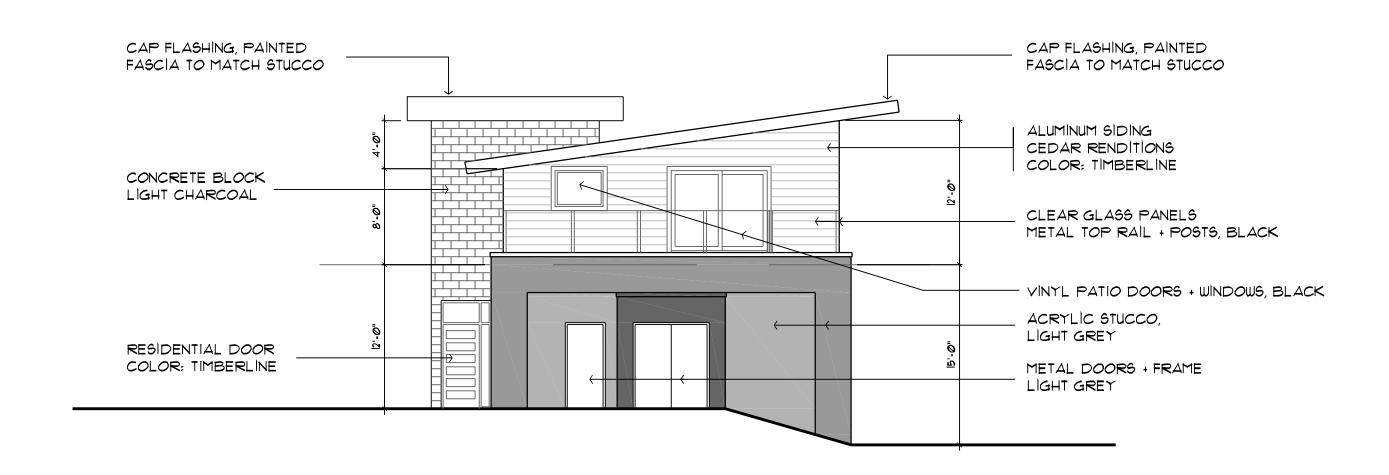


SOUTHRIDGE ELEVATION SCALE: 1/8" = 1'-0"




WEST ELEVATION

SCALE: 1/8" = 1'-0"

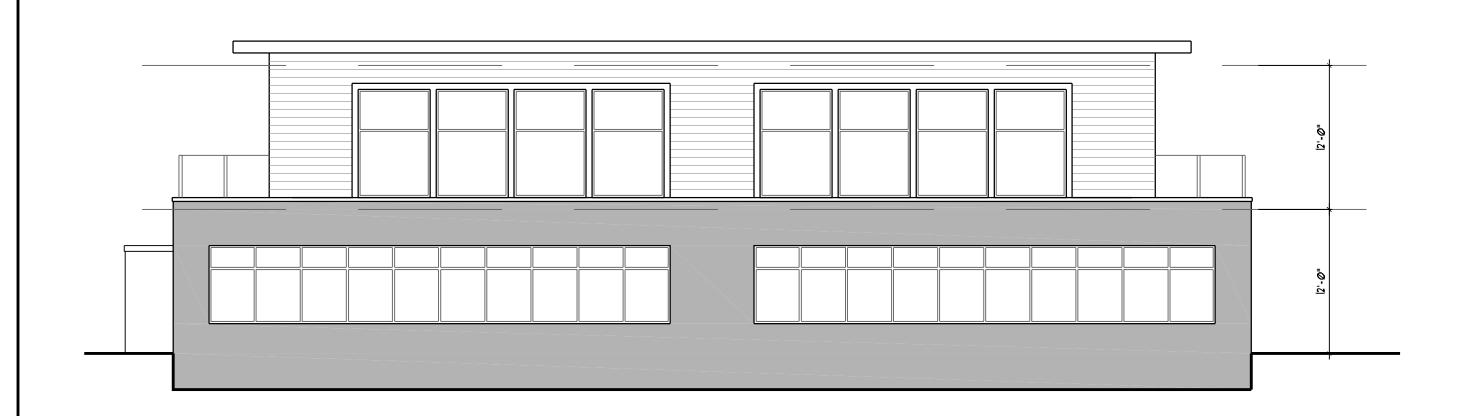

FROST ROAD ELEVATION

SCALE: 1/8" = 1'-0"

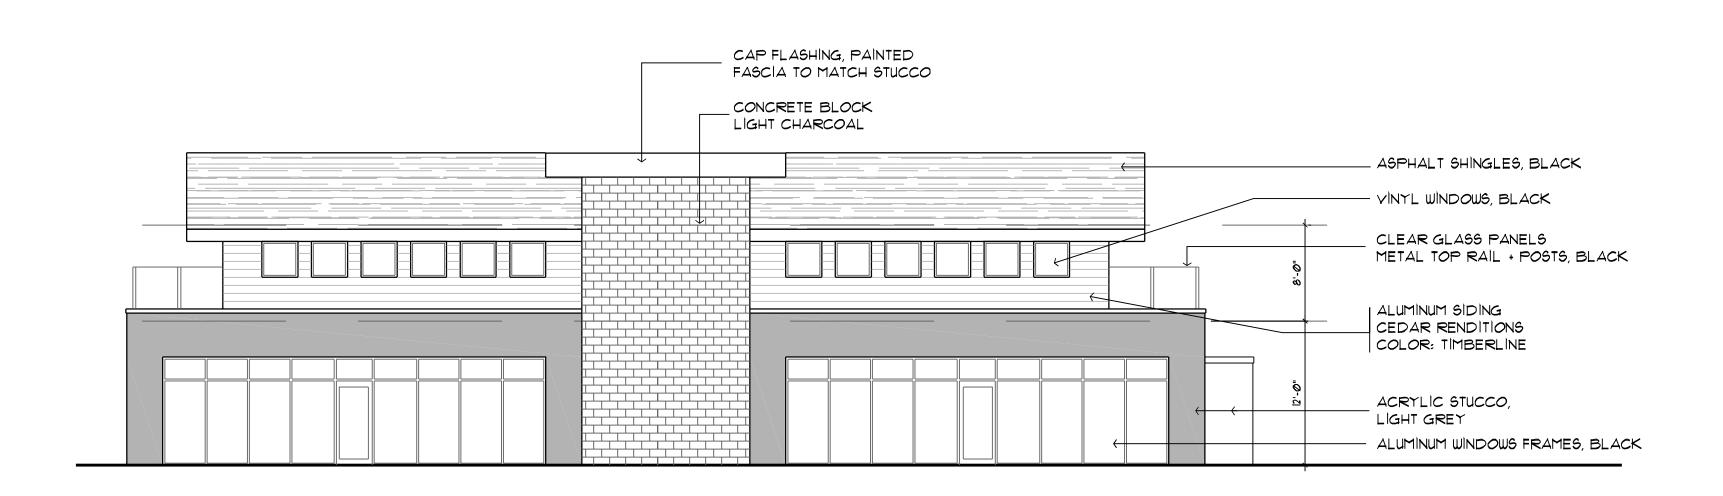


PARKING (SOUTH) ELEVATION SCALE: 1/8" = 1'-0"

5008 SOUTHRIDGE DR, KELOWNA
LOT 2, PLAN 68647

SCALE: 1/8" = 1'-0"

DATE: FEB 22020

DRAWING No.
A3

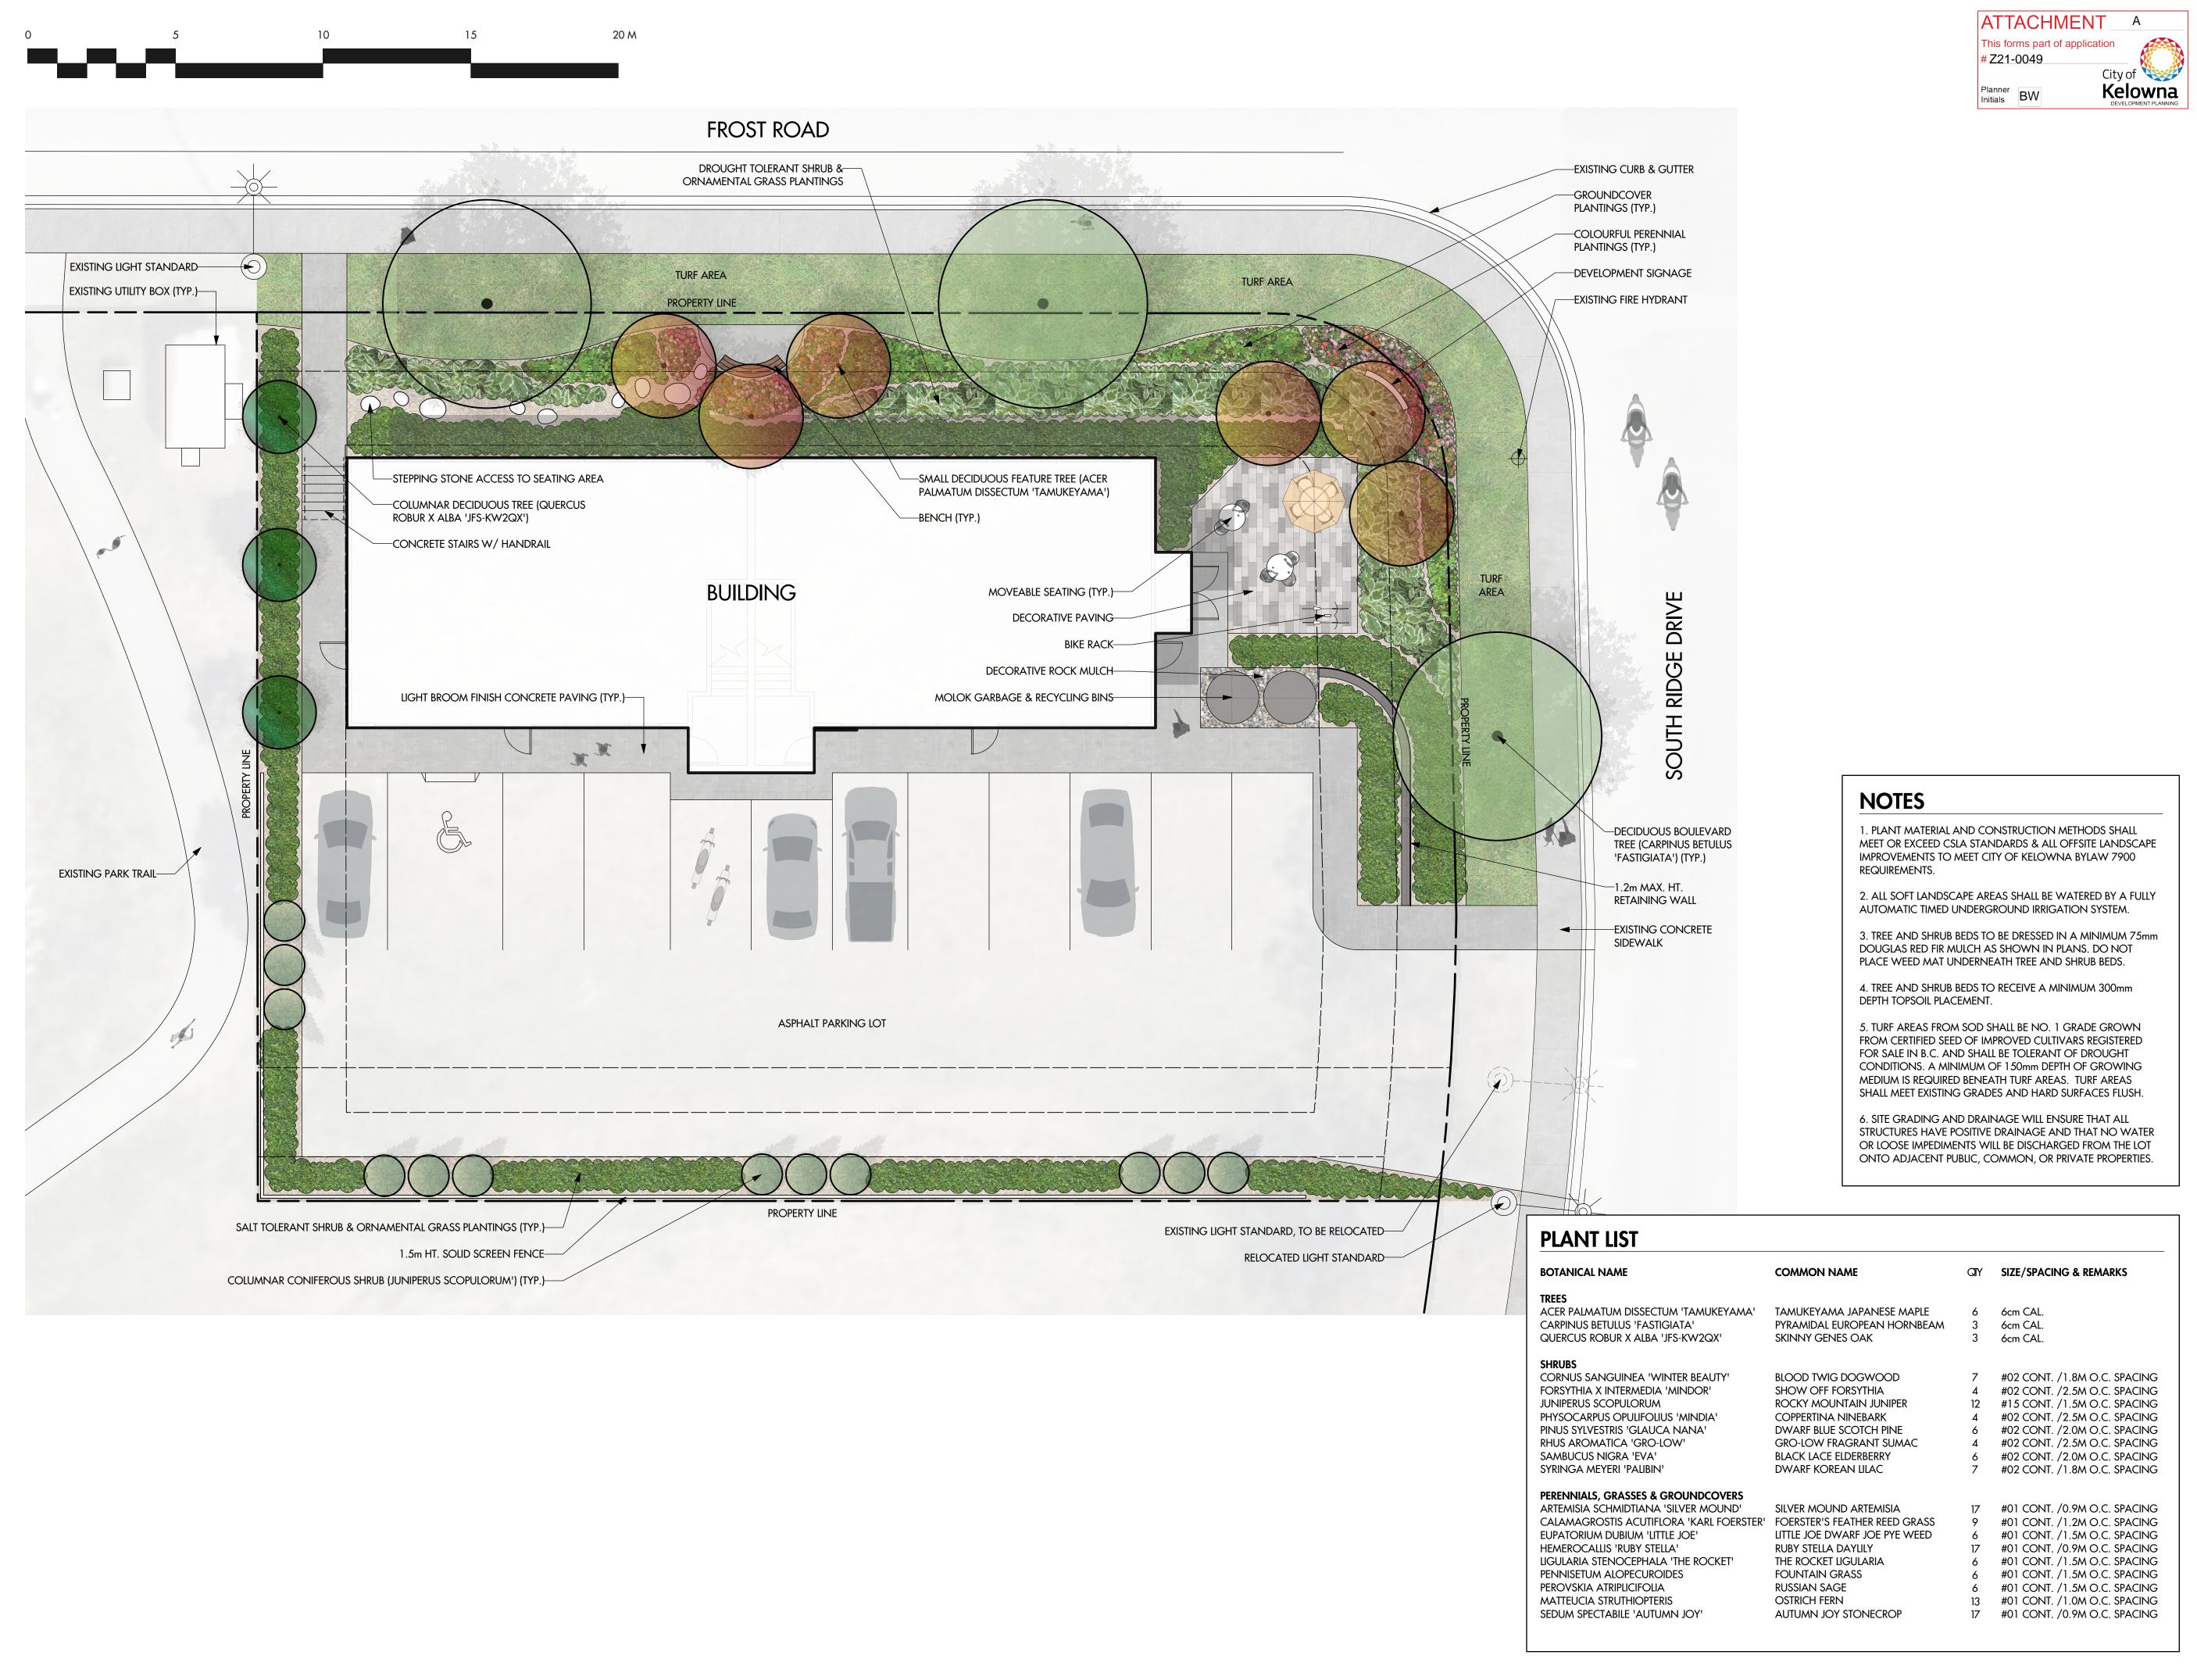



303 - 590 KLO Road Kelowna, BC V1Y 7S2 T (250) 868-9270 www.outlanddesign.ca



PROJECT TITLE

## **5008 SOUTH RIDGE DRIVE**

Kelowna, BC

DRAWING TITLE

ISSUED FOR / REVISION

1 20.01.07 Review

# CONCEPTUAL LANDSCAPE PLAN

2		
3		
4		
5		
3		
	JECT NO	20.013

PROJECT NO	20-013
DESIGN BY	KM
DRAVVN BY	KM
CHECKED BY	FB
DATE	FEB. 7, 2020
SCALE	1:100
PAGE SIZE	24"x36"

SEAL




DRAWING NUMBER

1/2

ISSUED FOR REVIEW ONLY

Copyright Reserved. This drawing is the property of Outland Design Landscape Architecture Limited and shall not be reproduced, resold, or tendered without permission.

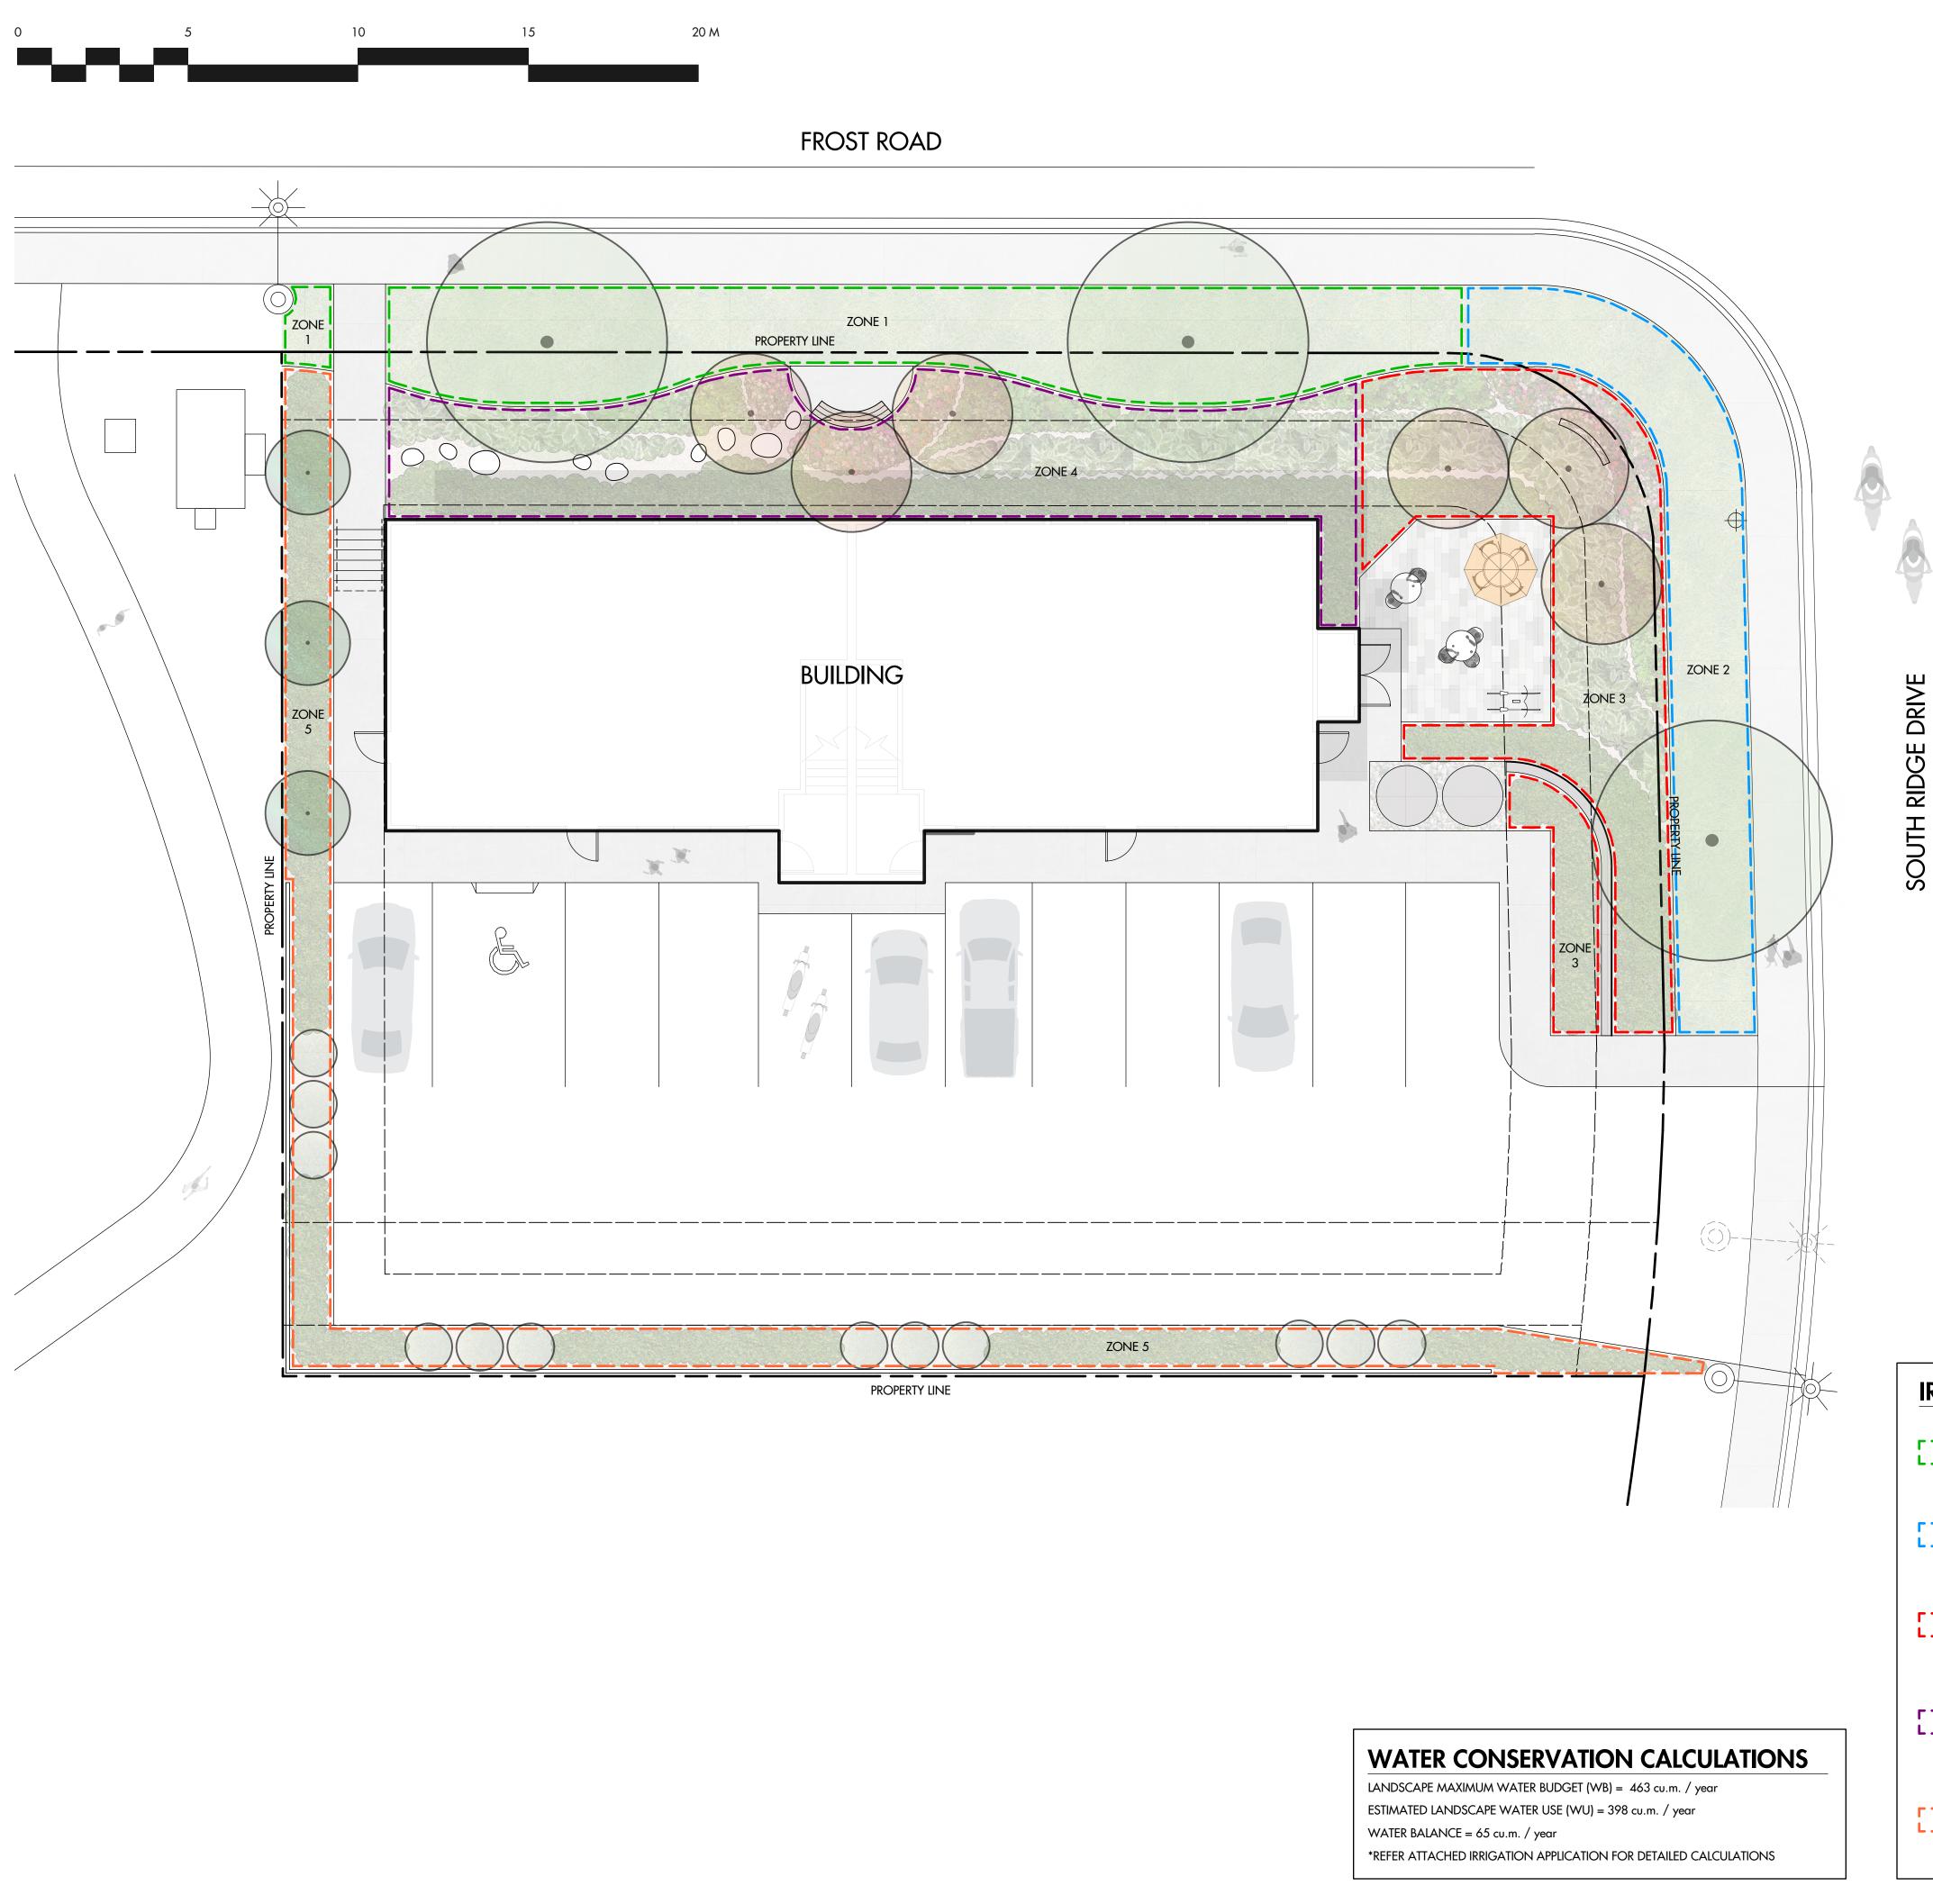



303 - 590 KLO Road Kelowna, BC V1Y 7S2 T (250) 868-9270 www.outlanddesign.ca

#### **IRRIGATION NOTES**

1. IRRIGATION PRODUCTS AND INSTALLATION METHODS SHALL MEET OR EXCEED THE REQUIREMENTS OF THE WATER USE REGULATION BYLAW NO. 10480 AND THE SUPPLEMENTARY SPECIFICATIONS IN THE CITY OF KELOWNA BYLAW 7900 (PART 6, SCHEDULE 5).

2. THE IRRIGATION SYSTEM SHALL MEET THE REQUIREMENTS, REGULATIONS, AND BYLAWS OF THE WATER PURVEYOR.

3. THE IRRIGATION SYSTEM SHALL BE EQUIPPED WITH AN APPROVED BACKFLOW PREVENTION DEVICE, WATER METER, AND SHUT OFF VALVE LOCATED OUTSIDE THE BUILDING ACCESSIBLE TO THE CITY.

4. AN APPROVED SMART CONTROLLER SHALL BE INSTALLED. THE IRRIGATION SCHEDULING TIMES SHALL UTILIZE A MAXIMUM ET VALUE OF 7" / MONTH (KELOWNA JULY ET), TAKING INTO CONSIDERATION SOIL TYPE, SLOPE, AND MICROCLIMATE.

5. DRIP LINE AND EMITTERS SHALL INCORPORATE TECHNOLOGY TO LIMIT ROOT INTRUSION.

6. IRRIGATION SLEEVES SHALL BE INSTALLED TO ROUTE IRRIGATION LINES UNDER HARD SURFACES AND FEATURES.

7. IRRIGATION PIPE SHALL BE SIZED TO ALLOW FOR A MAXIMUM FLOW OF

1.5m /SEC.

8. A FLOW SENSOR AND MASTER VALVE SHALL BE CONNECTED TO THE CONTROLLER AND PROGRAMMED TO STOP FLOW TO THE SYSTEM IN CASE OF AN IRRIGATION WATER LEAK.

#### IRRIGATION LEGEND

TOTAL AREA: 100 sq.m.

ZONE #1: LOW VOLUME POP-UP SPRAYHEADS FOR TURF AREAS

L \_\_\_ \_ J MICROCLIMATE: NORTHWEST EXPOSURE, PARTIALLY SHADED BY TREES ESTIMATED ANNUAL WATER USE: 143 cu.m.

ZONE #2: LOW VOLUME POP-UP SPRAYHEADS FOR TURF AREAS TOTAL AREA: 61 sq.m. L \_\_\_ \_ J MICROCLIMATE: EAST EXPOSURE, PARTIALLY SHADED BY TREES

ESTIMATED ANNUAL WATER USE: 87 cu.m. ZONE #3: HIGH EFFICIENCY SUBSURFACE DRIP IRRIGATION FOR MODERATE

WATER USE PLANTING AREAS TOTAL AREA: 98 sq.m. MICROCLIMATE: EAST EXPOSURE, PARTIALLY SHADED BY TREES & BUILDING ESTIMATED ANNUAL WATER USE: 54 cu.m.

ZONE #4: HIGH EFFICIENCY SUBSURFACE DRIP IRRIGATION FOR MODERATE WATER USE PLANTING AREAS TOTAL AREA: 108 sq.m.

MICROCLIMATE: NORTHWEST EXPOSURE, PARTIALLY SHADED BY TREES & BUILDING ESTIMATED ANNUAL WATER USE: 60 cu.m.

ZONE #5: HIGH EFFICIENCY SUBSURFACE DRIP IRRIGATION FOR MODERATE WATER USE PLANTING AREAS TOTAL AREA: 96 sq.m.

MICROCLIMATE: SOUTHWEST EXPOSURE, PARTIALLY SHADED BY TREES ESTIMATED ANNUAL WATER USE: 51 cu.m.



#### **5008 SOUTH RIDGE DRIVE**

Kelowna, BC

DRAWING TITLE

ISSUED FOR / REVISION

## WATER CONSERVATION & IRRIGATION PLAN

1	20.01.07	Review
2		
3		
4		
5		

PROJECT NO	20-013
DESIGN BY	KM
DRAWN BY	KM
CHECKED BY	FB
DATE	FEB. 7, 2020
SCALE	1:100
PAGE SIZE	24">36"



DRAWING NUMBER

**ISSUED FOR REVIEW ONLY** 

Copyright Reserved. This drawing is the property of Outland Design Landscape Architecture Limited and shall not be reproduced, resold, or tendered without permission.