

This forms part of application

Z20-0099

TC

City of Kelowna

Planner Initials






1 CARRIAGE HOUSE NORTH ELEVATION
Scale: 1/4" = 1'-0"



CARRIAGE HOUSE SOUTH ELEVATION
Scale: 1/4" = 1'-0"

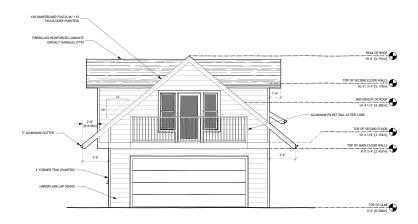

2 CARRIAGE HOUSE WEST ELEVATION Scale: 1/4" = 1'-0"



4 CARRIAGE HOUSE EAST ELEVATION
Scale: 1/4" = 1'-0"



#202 - 1470 ST. PAUL STREET KELOWNA, BC V1Y 2E6 www.ihsdesign.com 250.212.7938

THESE DRAWINGS ARE THE EXCLUSIVE PROPERTY OF IHS DESIGN AND MAY NOT BE REPRODUCED OR USED WITHOUT EXPRESSED WRITTEN PERMISSION FROM THE SAME.



REMISION DATE DISCRIPTION

PROJECT

CARRIAGE HOUSE 395 FLEMING ROAD KELOWNA, BC V1X 3Z4 LOT A PLAN KAP26972

DRAWING TITLE


ELEVATIONS

NOVEMBER 4, 2020

RAWING NUMBER

1 - of -

3

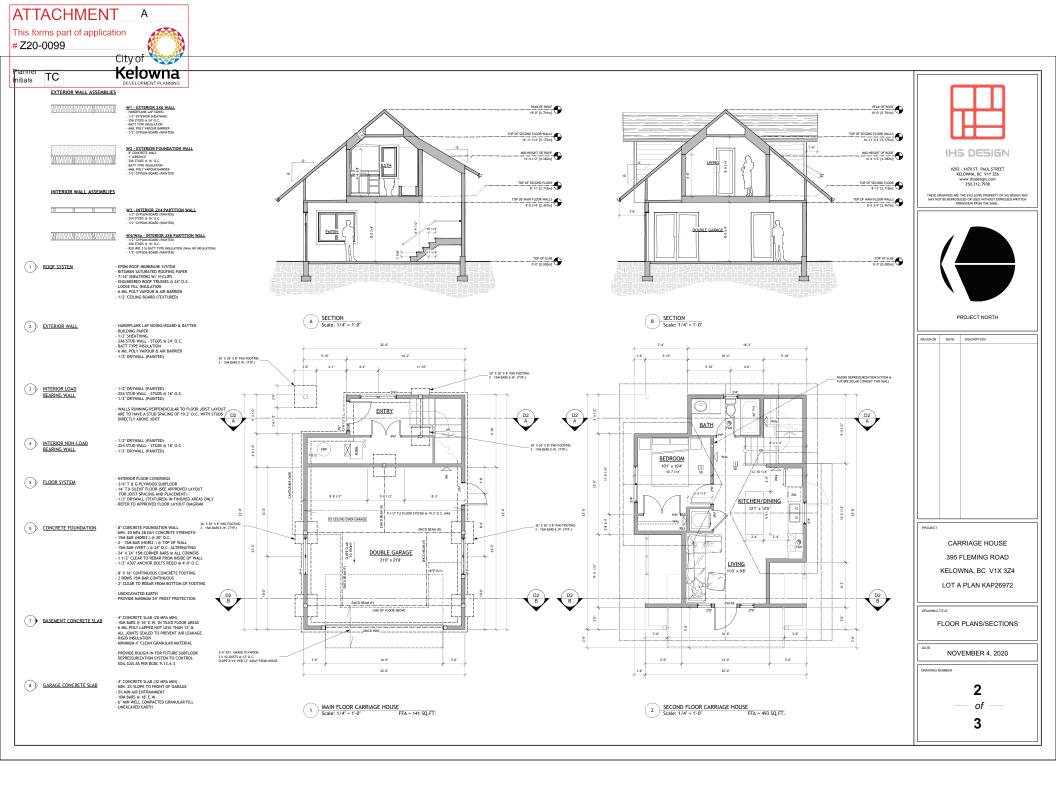



Planner Initials TC Kelowna DEVELOPMENT PLANNING


PROJECT DATA: CIVIC ADDRESS

LEGAL ADDRESS LOT
CURRENT ZONING RUPROPOSED ZONING RUFUTURE LAND USE MRL

395 FLEMING ROAD
KELOWIA, BC VIX 324
LOT A PLAN AR229572 SEC. 27 TWP. 26 ODYD
RU-1 LARGE LOT HOUSING
RU-1 LARGE LOT HOUSING WITH CARRIAGE HOUSE
MRL - MULTIPLE UNIT RESIDENTIAL (LOW DENSITY)

RU1-C ZONING ANYALYSIS	PERMITTED	PROPOSED	
PROJECT INFORMATION			
SITE AREA	550.00m2	931.85m2	
EXISTING BUILDING FOOTPRINT AT GRADE		137.20m2	
EXISTING DECK		28.66m2	
PROPOSED CARRIAGE HOUSE FOOTPRINT AT GRADE		62.54m2	
PRINICPAL DWELLING NET FLOOR AREA		236.90m2	
PROPOSED CARRIAGE HOUSE NET FLOOR AREA		58.90m2	
EXISTING DRIVEWAY		49.93m2	
PROPOSED DRIVEWAY		110.23m2	
8.3.1.1 RESIDENTIAL PARKING			
SINGLE DETACHED HOUSING	2.0	2.0	
SECONDARY SUITE	1.0	1.0	
REGULAR SIZE VEHICLE PARKING SPACE 6.0m X 2.5m	50.0%	2.0	
SMALL SIZE VEHICLE PARKING SPACE 4.8m X 2.3m	50.0%	1.0	
9.5b CARRIAGE HOUSE REGULATIONS			
MAXIMUM SITE COVERAGE	14.0%	6.7%	
MAXIMUM FOOTPRINT	90.00m2	62.54m2 58.90m2 24.9% 4.382m/1 1/2 STOREYS	
MAXIMUM FLOOR AREA	90.00m2		
CARRIAGE HOUSE NFA PERCENTAGE OF PRINCIPAL	75.0%		
MAXIMUM HEIGHT	4.8m/1 1/2 STOREYS		
PRINCIPAL ROOF PEAK TO CH ROOF PEAK	5.822m	5.791m	
MINIMUM FRONT YARD (WEST)	9.000m	31.593m	
MINIMUM REAR YARD (EAST)	1.500m	7.315m	
MINIMUM SIDE YARD (NORTH)	1.500m	2.378m	
MINIMUM SIDE YARD (SOUTH)	1.500m	11.847m	
MINIMUM DISTANCE TO PRINCIPAL DWELLING	3.000m	8.528m	
PRIVATE OPEN SPACE	30.00m2	51.52m2	
12.3.6 DEVELOPMENT REGULATIONS			
SITE COVERAGE	40.0%	21.4%	
SITE COVERAGE WITH DRIVEWAYS	50.0%	38.6%	
PRINCIPAL DWELLING BUILDING HEIGHT	9.5m/2 1/2 STOREYS	5.822m/2 STOREYS	
FRONT (WEST) YARD SETBACK (HOUSE TO P.L.)	6.000m	8.996m	
REAR (EAST) YARD SETBACK	7.500m	23.250m	
SIDE (NORTH) YARD SETBACK	2.000m	3.600m	
SIDE (SOUTH) YARD SETBACK	2.000m	2.184m	



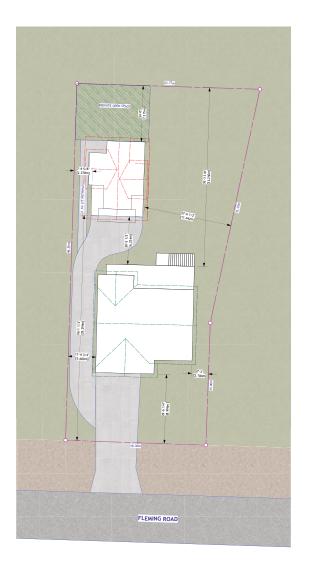







#202 - 1470 ST. PAUL STREET KELOWNA, BC V1Y 2E6 www.ihsdesign.com 250.212.7938

THESE DRAWINGS ARE THE EXCLUSIVE PROPERTY OF IHS DESIGN AN MAY NOT BE REPRODUCED OR USED WITHOUT EXPRESSED WRITTE



Н				
Ш	REVISION	DATE	DISCRIPTION	
Ш				
Ш				
П				
П				
П				
П				

PROJECT

CARRIAGE HOUSE 395 FLEMING ROAD KELOWNA, BC V1X 3Z4 LOT A PLAN KAP26972

RAWING TITLE

SITE PLAN/ZONING ANALYSIS

NOVEMBER 4, 2020

DRAWING NUMBER

3

of —

3