## **KIRSCHNER MOUNTAIN - PHASE 6**

## **REZONING & DEVELOPMENT PERMIT APPLICATION**

# **DESIGN RATIONALE**



2020.02.19

Prepared for:

Kirschner Mountain Developments 1261 Loseth Rd Kelowna, BC, V1P 1E5

To be submitted to:

City of Kelowna Development Services City of Kelowna Prepared by:

Architecture Interior Design and Planning Building Envelope Consulting



Garry Tomporowski Architect Ltd Kelowna, B.C. 250.979.1668

Garry Tomporowski
ArchitectLtd
243 - 1889 Springfield Road
Kelowna, BC Canada V1Y 5V5
Phone: 250. 979.1668

Email: gtaoffice@gtarch.ca

# **TABLE OF CONTENTS**

1.0	OVERVIEW	1
2.0	PROJECT DESCRIPTION	1
3.0	SITE AND PARKING ACCESS	2
4.0	VARIANCES	3
5.0	SUSTAINABILITY AND CRIME PREVENTION	4
6.0	LANDSCAPING	5
7.0	SUMMARY	5
8.0	ARCHITECTURAL RENDERINGS	6



### 1.0 OVERVIEW

The proposed hillside housing development thoroughly addresses the main goals pursued by the City of Kelowna for these land uses. Many strategies have been discussed among the project's stakeholders and the City Planning for minimizing the impact of the development on the natural environment, topography, open space and visual hillside character of Kelowna.

During the creation of the new Kirschner Mountain Area Structure Plan there was considerable pressure from the City at the time, to ensure a high proportion of units would be in the multifamily residential forms and density to ensure efficient use of the land. The OCP Future Land use Designation was adopted accordingly, and the aimed Zoning: RH3 – Hillside Cluster Housing accepts that the form and character may include multiple dwelling housing units.

We believe that the proposed townhouse typology – Triplex, Fourplex and Fiveplex – addresses all significant elements of the OCP, and are deemed to be quality yet affordable forms of housing in the Kelowna area market. They have become an excellent product type to satisfy the mid to upper market housing demand, much of which has not been available in the overall Kirschner/Black Mountain areas.

### 2.0 PROJECT DESCRIPTION

The topography of the developable land lends itself to this multi-family form product type. The subject site is located in a gully where there are limited views, largely inward-looking and in a transition area through to the backside of the mountain via single road, rendering the area somewhat restricted in development potential. The setting also limits the visual impact from any surrounding view perspectives.

This townhouse form project develops along Loseth Road, on both North and South sides, with 19 residential buildings and a total number of 77 units. It comprises diversified buildings types – triplex, four-plex and five-plex – and multiple configurations based on their relationship with the topographic setting and the road/grading design by CTQ Civil Engineers.

In terms of density, the Kirschner Mountain – Phase 6 achieves a slightly higher density at approximately 8.5 to 9 units/acre with this 'low density' multi-plex housing type.

Also this site, of approximately 8 acres serves as the entry to the multifamily residential area in line with the approved Master Plan (Area Structure Plan).

'Flat pad' building lots live together with half storey benched and full storey benched lots. This provides a rich variety of topographical context to the architectural design, which GTA has certainly taken advantage of.

In this regard, the architectural design has tackled a wide range of different floor plans options, in combination with diverse section developments. We propose full three storey units, split-level units and walk-out units, ensuring an attractive broad housing mix in this new neighborhood.

The Architectural exterior design has been carefully designed taking in account the adjacent neighborhoods architectural context and design guidelines, and the specific



sensibilities that were put on the table by the participants during the preliminary design stage.

Therefore, a refined craftsman style with flares of urban and mountain appeal defines the architectural design of Kirschner Mountain - Phase 6, creating an elegant, modern and vibrant looking neighborhood.

In addition, the buildings' envelope have been conceived with parameters that enable the efficiency of both energy and construction costs, emphasizing the differentiation of the buildings through the choice of colors, architectural accents and landscaping, rather than over-complicating the facades layout (form factor, opaque walls to openings ratio,...) or over-designing the buildings' elevations.

Generous patios and balconies allow for enjoyment of the Okanagan environment and personal entertainment, and a carefully created landscape views are key factors on this design.

Special attention was given to the landscaped areas and to the interface with the adjacent natural parks, enhancing the pedestrian connectivity between the development and these Kirschner Mountain Estates' preserved enclaves.

Finally, an amenity building has been proposed in a central location, certainly adding a great supporting infrastructure for the use of the community.

### 3.0 SITE AND PARKING ACCESS

The proposed roads and grading layout, as well as the architectural design tackle the challenging topographic context by giving a responsible and conscious solution from many perspectives: cost efficiencies, yield efficiencies, tax impact to municipality, neighborhood character and efficient use of the land.


In regards to parking; all the units have double garage, with a minimum driveway length of 6 m, and provisions for visitor on-site parking as per the Section 8 – Parking and Loading zoning bylaw.




### 4.0 VARIANCES

We are requesting two variances in this application. These variances have been lengthily discussed with the Planning Department at the City of Kelowna, and are being sought to reduce the mountain cut height at both sides of Loseth Road.

VARIANCE 1: 3.0 m REAR YARD VARIANCE WITH LOSETH ROAD.
Request a variance for the reduction of the rear yards setback from 4.5 m to 3.0 m at the buildings B-01, B-02, B-09 and B-10 with Loseth Road. This allows the Roads 1 & 4 to be pushed further off the mountain cut.

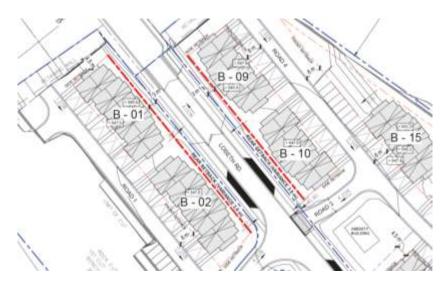

■ <u>VARIANCE 2</u>: BUILDING HEIGHT VARIANCE FROM 9.5 m TO 10.5 m. Request a variance for the increase of building height of the walk-out buildings adjoining the toe of mountain cuts; buildings B-06, B-07, B-08, B-15, B-16, B-17, B-18, B-19.

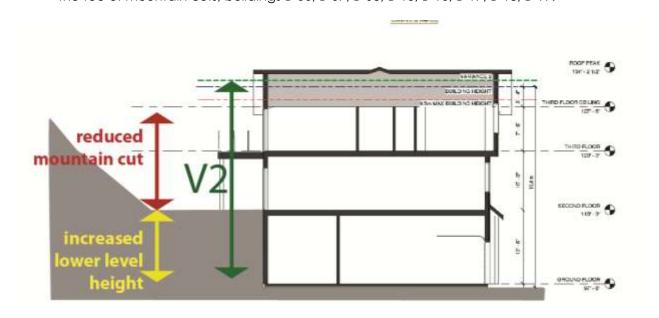



### 5.0 SUSTAINABILITY AND CRIME PREVENTION

This increased density over the traditional or even small-lot residential forms of housing is not only able to help mitigate increasing costs for first time buyers, but also enables efficiencies in achieving reductions in cost of city services per capita, energy consumption, carbon footprint, heat island effect,...

Envelope details that prevent water and moisture ingress, yet still allow the assemblies to dry, will prevent mould growth. Reducing thermal bridging combined with appropriate thermal insulation will reduce heating and cooling loads. Providing windows in all of the occupied spaces allows natural day lighting, and reducing energy consumption required for illumination. Operable windows also allow for natural ventilation, thus reducing the need for mechanical ventilation to provide fresh air, and adding "liveability".

Extensive use of materials from natural sources is used to the largest extent possible, and thereby reduces the carbon foot print accordingly. A properly designed and detailed building will also reduce heating and cooling loads, increase air quality, and reduce energy consumption.

Carefully selected landscaping material will help reduce the projects use of water. This will prove an attractive, colorful and interesting variety of grass, shrubs and large trees for shade, privacy and path definition. Special attention was placed on the connection to the adjacent parks, and should provide a style of development which is highly desirable within the Kelowna community.

The design of the buildings and landscaping promote natural surveillance and does not provide opportunistic hiding spaces. The entrances are clearly visible from the street and well lit public sidewalks surround the building.

The intentions of CPTED have been addressed in the following ways: well maintained entrances and frontages are intended to promote pride in ownership amongst the residents and allied businesses. This will discourage vandalism, encourage surveillance and will improve overall maintenance of the site. The walk-up, pedestrian friendly and ground oriented entrance has been provided to reinforce this principle.

The social lifestyle of the site will help promote further surveillance and territorial reinforcement. Separation of private, semi-private and public spaces will be achieved with overall landscaping and finish materials to separate and add comfort to the residents and visitors. Large windows and patios help to provide eyes to the street and surrounding areas. To support interaction and familiarity amongst the residents and users, an abundance of common outdoor space has been provided.

Site lighting to the streetscape and pathways will be clearly lit, designed to illuminate the faces of users, and provide illumination levels that do not create high contrast areas that could potentially conceal offenders.

This unique and attractive project will endure due to its sense of community, and the fact that it presents a prominent streetscape and connection to the surrounding neighborhood. It also provides well thought out external traffic patterns.



### 6.0 LANDSCAPING

The Developer has selected CTQ Landscaping Consultants to create an interesting and aesthetically pleasing landscape solution that responds to the challenging grading and the architectural style of the project. This will also compliment the character of the surrounding and future neighborhoods. The site design proposes a series of green pockets for the use and enjoyment of the families, with play areas for children to benefit from the outdoors.

Special attention was placed on the connection to the adjacent parks, and should provide a style of development which is highly desirable within the Kelowna community.

Carefully selected landscaping material will help reduce the projects use of water. A number of annual and perennial shrubs have been selected for along Loseth and the internal roads throughout the site, and in special groupings adjoining the buildings' ends. This will prove an attractive, colorful and interesting variety of grass, shrubs and large trees for shade, privacy and path definition. Trees will be planted along the roads. Given enough time to mature, these trees will help the project blend with the existing forest that surrounds the site.

The landscape concept for the boundary areas, the Loseth Rd. Boulevard and the small community gardens, will provide a visually exciting and high volume of green space. If viewed from above, there would appear to be significantly more "green" than buildings. Finally, Decorative Allan type blocks will be used for addressing the minimized locations where retaining soils is needed.

### 7.0 SUMMARY

Kirschner Mountain Developments and the design team feel that the combination of a quality design coupled with leading edge technology, pedestrian-friendly landscape features, and modern building materials will provide for a very functional and highly desired residential neighbourhood project.

It is also our desire that this project will be one of many to be built in an area critical to the continued sustainability and growth of our City internationally.

We look forward to your enthusiastic support and recognition for all the project brings to our community.



### 8.0 ARCHITECTURAL RENDERINGS



















END





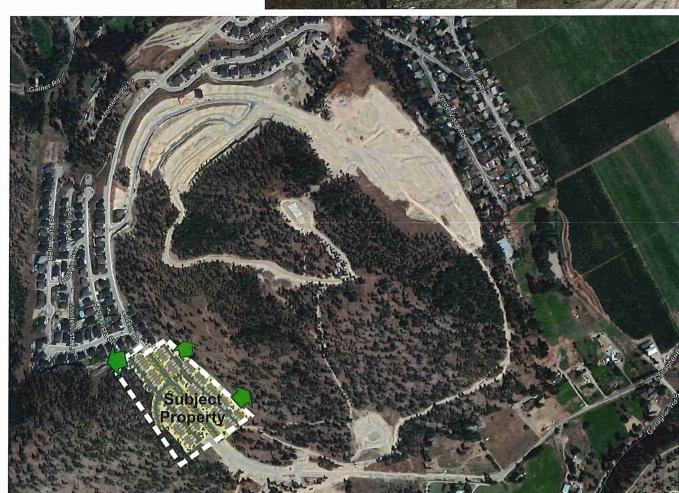


**Connections to OPEN SPACE NETWORK, TRAILS AND PARKS** 

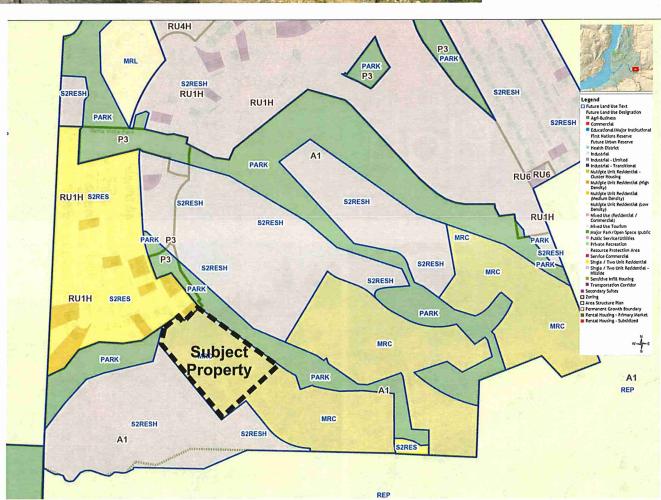


**LAND USE PLAN** 






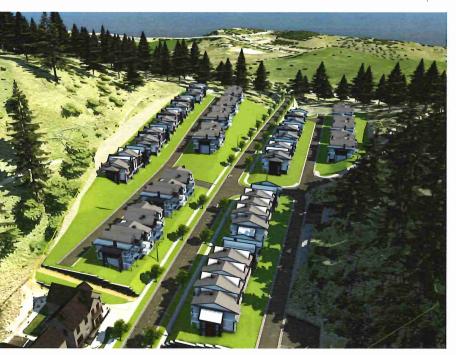





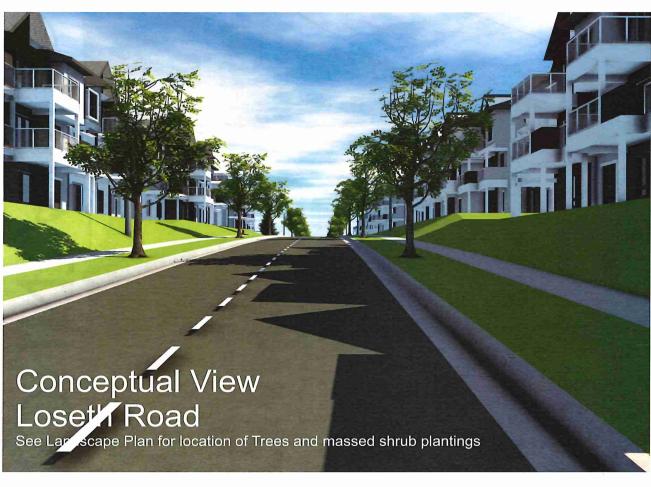


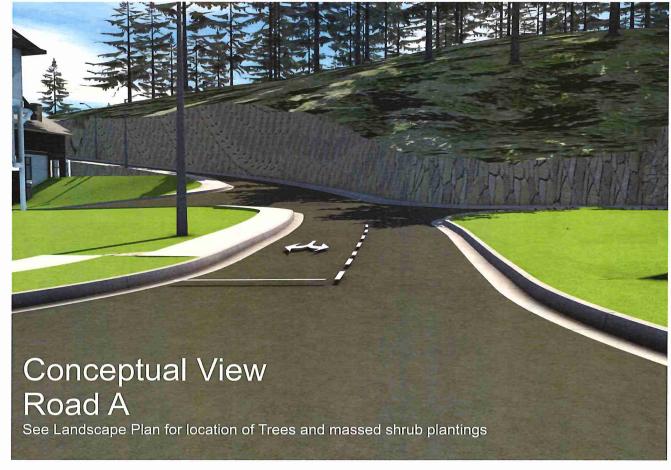



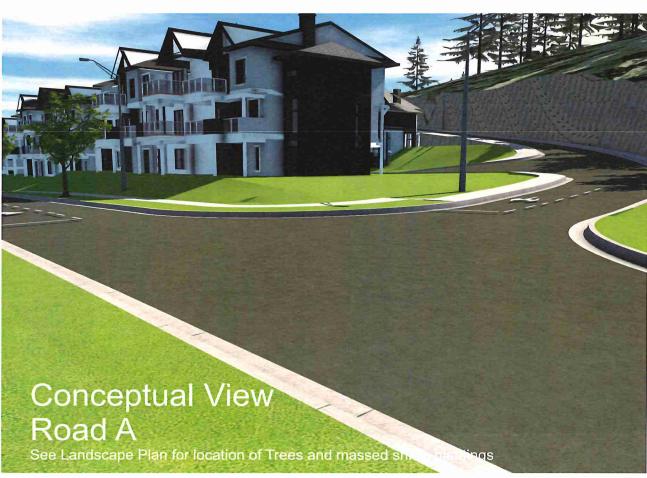

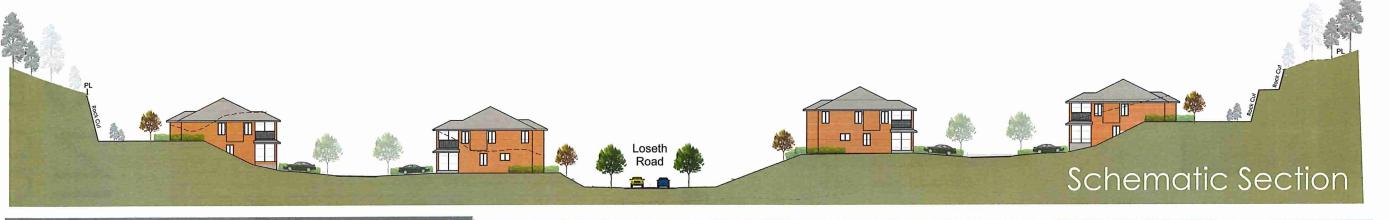

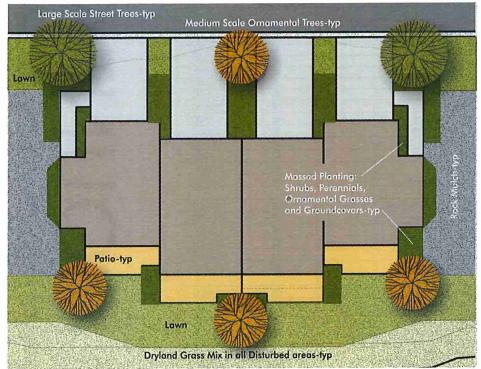





Townhomes represented as simple blocks see Architectural Drawings











Coniferous Trees 1.8m ht









Medium Scale Ornamental Trees 60MM CAL

SHRUBS, GRASSES, PERENNIALS MIN # 2 POT



	Proposed Plant List -Kirschn	er Mountain Phase 6		
Symbol.	Botanical Name	Common Name	Size	Spacin
NIN/L				
	Acer rubrum 'Red Sunset'	Red Sunset Maple	75mm cal	
	Gleditsia triacanthos inermis "Skyline"	Skyline Honeylocust	75mm cal	
	Populus tremuloides	Trembling Aspen	60mm cal	
	Cercis canadensis	Eastern Redbud	60mm cal	
A Property of the Party of the	Magnolia stellata	Star Magnolia	tree form 60 mm cal	
STATE OF	Pyrus calleryanna "Chanticlear"	Chanticlear Pear	60mm cal	
	Syringa reticulata 'Ivory Silk'	Nory Silk Tree Lilac	60 mm cal	
	Pinus ponderosa	Ponderosa Pine	1.8 m ht, B&B	
	Pseudotsuga menziesii	Douglas Fir	1.8 m ht, B&B	
	Cornus sericea	Red Twig Dogwood	#2	1.2m O
	Euonymus alata compacta	Dwarf Burning Bush	#2	1.2m O
_	Forsythia x courtasol 'Gold Tide' (yellow)	Gold Tide Forsythia	#2	1.2m O
	Hosta "El Nino"	El Nino Hosta	#2	1.0m O
	Kerria japonica Mahonia aquifolium	Japanese Kerria	#2	1.2m O
	Paxistima canbvi	Oregon Grape Cliff Green	#2	1.0m O
	Philadelphus lewisii 'Blizzzard'		#2	1.2m O
		Blizzard Mockorange	#2	2.0m O
	Pinus mugo pumilio	Dwarf Mugo Pine	#2	1.2m O
-	Potentilla fruiticosa "Red Ace"	Red Ace Potentilla	#2	1.2m O
	Rosa 'meicoublan	White Meidiland Rose	#2	1.2m O
_	Rhus aromatica 'Gro-low'	Gro Low Sumac	#2	1.5m O
	Symphoricarpus alba	Snowberry	#2	2.0m O
	Syringa vulgaris 'Belle de Nancy'	Belle de Nancy Lilac	#2	1.5m O
	Calamagrostis ' Karl Foerster'	Karl Foerster Reed grass	#2	1.0m O
	Festuca ovina Elijah Blue	Elijah Blue Fescue	#2	0.6m O
	Helictotrichon sempervirens	Blue Oat Grass	#2	1.0m O
	Mscanthus sinensis purpurascens	Orange Flame grass	#2	1.2m O
	Pennisetum alopercuroides	Fountain Grass	#2	1.0m O
	Pennisetum orientale' Tall Tails'	Oriental fountain grass	#2	1.0m O
	Artemesia ludoviciana 'Valerie Finnis'	White Sage	#2	1.2m O
THE	Aster woods purple	Woods Purple Aster	#2	1.2110
	Hermocallis ' Gentle Sheperd' (white)	Gentle Sheperd Daylily	#2	0.6m O
	Hermocallis ' Stella d'Oro' (yellow)	Stella D'Oro Dayiily	#2	0.6m O
	Lavendula ' Munstead' (purple)	Munstead lavender	#2	
	Perovskia atriplicifolia			1.0m O
		Russian sage	#2	1.2m O
	Rudbeckia hirta 'Goldsturm' (yellow)	Goldsturm Gloriosa Daisy	#2	0.6m O
	Leucanthemum x superbum 'Snow Lady' (white)	Snow Lady Shasta Daisy	#2	0.6m O
	Arctostaphylos uva ursi 'Vancouver Jade'	Vancouver Jade Kinnikinick	#2	0.6m O

### **Dryland Grass Mix Seed Blend**

- (% by weight)

  Crested Wheat Grass Crested Wheat Grass
  Perennial Rye
  Slender Wheat Grass
  10


- Tall Wheat Grass 10
   Hard Fescue 10
   Creeping Red Fescue 10
   Annual Rye 10
   Fall Rye 15

Application Rate - 150 kg/ha Seed Mix to be certifled #1 Grade

# KIRSCHNER MOUNTAIN PHASE 6

2980 GALLAGHER RD.

77 TOWNHOME UNITS REZONING + DEVELOPMENT PERMIT

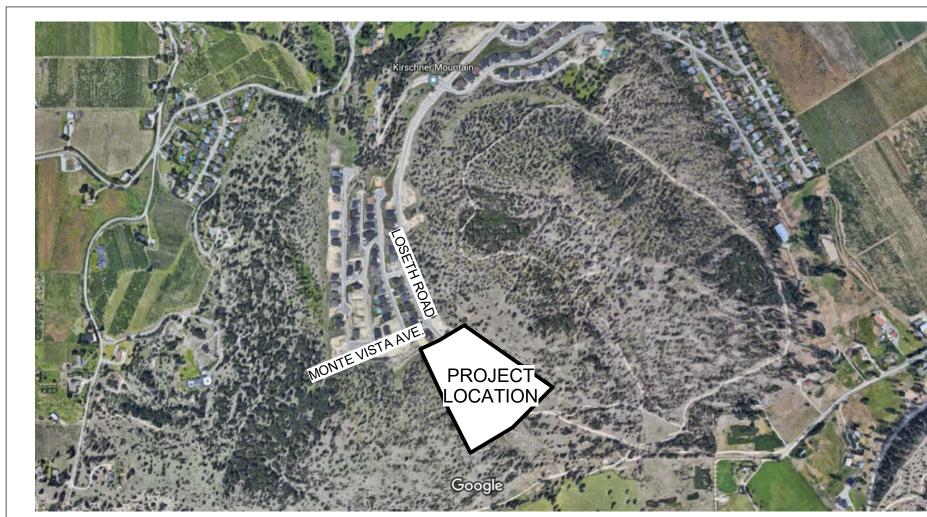

**LOCATION MAP** 



# **CONSULTANTS:** ARCHITECTURAL: LANDSCAPE: GTA ARCHITECTURE LTD. CTQ CONSULTANTS LTD. A0.0 COVER SHEET CONTACT: GARRY TOMPOROWSKI **CONTACT: FRANK POHLAND** A0.1 SITE PHOTOS 243 - 1889 SPRINGFIELD ROAD 1334 SAINT PAUL STREET. KELOWNA, B.C., V1V 1S9 A1.0 SITE PLAN KELOWNA, BC V1Y 2E1 PHONE: (250) 979-1668, FAX: (250) 979-4366 PHONE: 250.979.1221 ext. 115 EMAIL: garry@gtarch.ca EMAIL: FPohland@ctqconsultants.ca A1.2 CROSS SITE SECTIONS A1.3 CROSS SITE SECTIONS **SURVEYOR: RUNNALLS DENBY.** CONTACT: ROB MCDONALD 259A LAWRENCE AVE, KELOWNA, BC V1Y 6L2 PHONE: (250) 763-7322 EMAIL: rob@runnallsdenby.com CIVIL: CTQ CONSULTANTS LTD. **CONTACT: DAVE CULLEN** 1334 SAINT PAUL STREET KELOWNA, BC V1Y 2E1 PHONE: 250.979.1221 ext. 120 EMAIL: DCullen@ctqconsultants.ca SYMBOL LEGEND: GRID LINE: —DRAWING NUMBER **BUILDING SECTION** REFERENCE MARKER DETAIL REFERENCE —ASSEMBLY TYPE ASSEMBLY TYPE REFERENCE ─ STRUCTURAL MATERIAL

# LIST OF DRAWINGS:


(TRIPLEX)

(FIVEPLEX)

GRADING

# **VISITOR:** A0.2 BUILDING PERSPECTIVES A1.1 LONGITUDINAL SITE SECTIONS A2.1 BUILDINGS ON LEVELED GRADING FLOOR PLANS (FOURPLEX) A2.2 BUILDINGS ON FULL STOREY BENCHED GRADING FLOOR PLANS. WALK-OUT A2.3 BUILDINGS ON HALF STOREY BENCHED GRADING FLOOR PLANS. SPLIT A3.1 LEVEL GRAD. MID-LEVEL FLOOR PLAN A3.2 LEVEL GRAD. END-UNIT FLOOR PLAN A3.3 WALK OUT. MID-UNIT FLOOR PLAN A3.4 WALK OUT. END-UNIT FLOOR PLAN A3.5 SPLIT LEVEL. MID-UNIT FLOOR PLAN A3.6 SPLIT LEVEL. END-UNIT FLOOR PLAN A4.1 ELEVATIONS. BUILDINGS ON LEVELED A4.2 ELEVATIONS. BUILDINGS ON FULL STOREY BENCHED GRAD. (WALK-OUT) A4.3 ELEVATIONS. BUILDINGS ON HALF STOREY BENCHED GRADING (SPLIT) A5.1 SECTIONS TYPICAL - HEIGHT VARIANCE

FLOOR AREAS PER UNIT TYPE (G.F.A.) SQ.FT.: PROJECT INFO: **UNIT COUNT:** LEVEL GRADE MID-UNIT: 17 GROUND: 288 (+600) SECOND: 894 THIRD: 854 **TOTAL**: 2,036 LEVEL GRADE MID-UNIT: LEVEL GRADE END-UNIT: 16 LEVEL GRADE END-UNIT: **TOTAL:** 2,026 CIVIL ADDRESS: 2980 GALLAGHER RD. WALK-OUT MID-UNIT: **LEGAL DESCRIPTION**: KID: 820186; PLAN#: 71697; LOT#; 1 WALK-OUT MID-UNIT: GROUND: 288 (+600) SECOND: 894 THIRD: 854 **TOTAL:** 2,036 WALK-OUT END-UNIT: GROUND: 361 (+540) SECOND: 776 **TOTAL:** 1,857 SPLIT MID-UNIT: SPLIT MID-UNIT: GROUND: 608 (+453) SECOND: 906 **TOTAL:** 1,514 **EXISTING LEGAL USE: VACANT** SPLIT END-UNIT: GROUND: 690 (+411) SECOND: 897 SPLIT END-UNIT: **TOTAL:** 1,587 **UNIT TOTAL**: **CURRENT ZONING:** A1 - Agriculture 1 RH3 - Hillside Cluster Housing PROPOSED ZONING: TOTAL FLOOR AREA (G.F.A.) SQ.FT.:: VARIES / HIILSIDE **GRADES:** LEVEL GRADE MID-UNIT: 17 X 2,036 = 34,612 4.05 Ha = 40,500 m2 LOT AREA: LEVEL GRADE END-UNIT: 16 X 2,026 = 32,416 WALK-OUT MID-UNIT: 15 X 2,036 = 30,540NUMBER OF BUILDINGS: 19 RESIDENTIAL + 1 AMENITY WALK-OUT END-UNIT: 7 X 1,514 = 10,598 SPLIT MID-UNIT: SPLIT END-UNIT:  $6 \times 1,587 = 9,522$ TOTAL = 147, 400

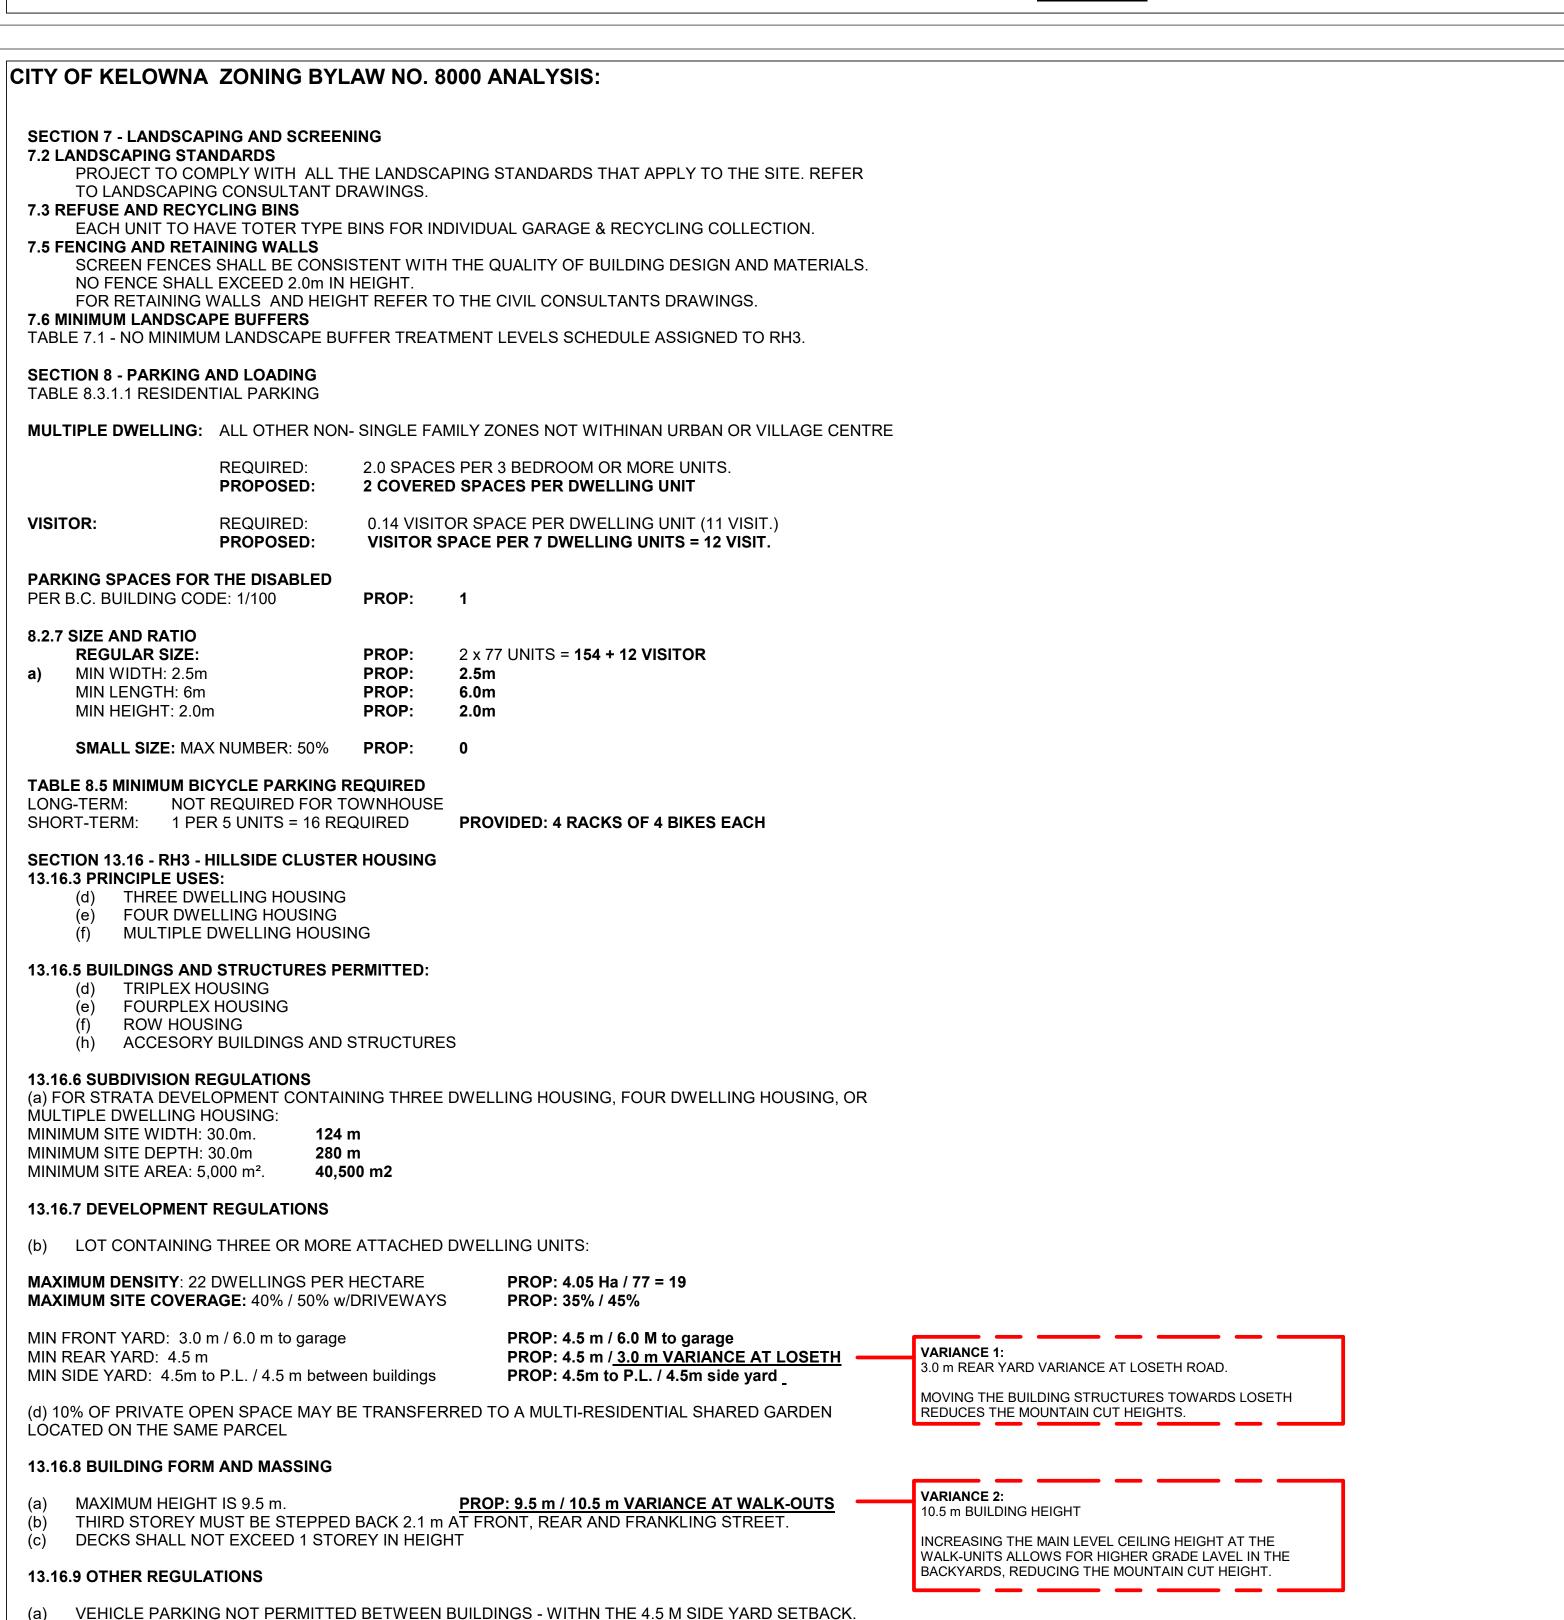

- THIS DRAWING MUST NOT BE SCALED.

- VERIFY ALL DIMENSIONS AND DATUMS PRIOR TO COMMENCEMENT OF WORK. REPORT ALL ERRORS AND OMMISIONS

VARIATIONS AND MODIFICATIONS ARE NOT

- ANY REPRODUCTION MUST BEAR THEIR

ALLOWED WITHOUT WRITTEN PERMISSION THIS DRAWING IS THE EXCLUSIVE PROPERTY OF THE ARCHITECT.

NAME AS ARCHITECT.

FOR REZONING AND DEV. **PERMIT** 

20.02.2020 CP FOR RZ + DP 08.11.2018 CP FOR CLIENT REVIEW 29.03.2018 CP CONCEPT DESIGN

NO. DATE BY DESCRIPTION

ESIGN CONSULTANT

GTA ARCHITECTURE LTD.

243 1889 SPRINGFIELD ROAD Kelowna, British Columbia. TELEPHONE: (250)979-1668

DEVELOPED BY:

KIRSCHNER MOUNTAIN

KIRSCHNER MOUNTAIN PH. 6 Enter address here

**COVER SHEET** 

DRAWN BY: Author Drawing No.

Designed BY: Designer

12" = 1'-0"

19/12/2018 FILE: 0001



VIEW FROM THE END OF LOSETH ROAD TOWARDS THE SITE (SOUTH-WEST)



VIEW FROM THE SOUTH SIDE OF THE FUTURE LOSETH RD TOWARDS THE NORTH



VIEW FROM THE NORTH SIDE OF THE FUTURE LOSETH RD TOWARDS THE SOUTH



VIEW FROM THE FUTURE LOSETH ROAD AT THE MIDDLE POINT OF THE SITE TOWARDS NORTH-EAST



VIEW FROM THE FUTURE LOSETH ROAD AT THE MIDDLE POINT OF THE SITE TOWARDS SOUTH-WEST

Notes:

- THIS DRAWING MUST NOT BE SCALED.

- VERIFY ALL DIMENSIONS AND DATUMS PRIOR TO COMMENCEMENT OF WORK. REPORT ALL ERRORS AND OMMISIONS TO THE ARCHITECT.

- VARIATIONS AND MODIFICATIONS ARE NOT ALLOWED WITHOUT WRITTEN PERMISSION FROM THE ARCHITECT.

- THIS DRAWING IS THE EXCLUSIVE PROPERTY OF THE ARCHITECT.

- ANY REPRODUCTION MUST BEAR THEIR NAME AS ARCHITECT.

OR REZONING AND DEV. PERMIT

2 08.11.2018 CP FOR CLIENT REVIEW 1 29.03.2018 CP CONCEPT DESIGN

NO. DATE BY DESCRIPTION

DESIGN CONSULTANT

SEA

gta

GTA ARCHITECTURE LTD.

243 1889 SPRINGFIELD ROAD Kelowna, British Columbia. V1Y 5V5

TELEPHONE: (250)979-1668 www.gtarch.ca

DEVELOPED BY:

M

KIRSCHNER MOUNTAIN

PROJECT

KIRSCHNER MOUNTAIN PH.

SHEET TITLE SITE PHOTOS

n by: Author drawing

NED BY: Designer

CALE: 3" = 1'-0"

03/29/18 FILE: 0001

Project File Name and Location: P:\2018 Architecture\A18-08 Kirschner Mountain Phase 6\3.0 Drawings\A18-08 Kirschner Mountain COVER REND ELEV (2020.01.16).rvt



RENDERING VIEW OF BUILDING 19 - FROM ROAD 4 (WALK-OUT FOURPLEX)



RENDERING VIEW OF END OF ROAD 1 LOOKING TOWARDS THE SOUTH-WEST

RENDERING VIEW OF LOSETH ROAD AT NORTHERN SIDE



RENDERING VIEW OF ROAD 4 FROM THE VISITORS PARKING TOWARDS THE WEST



RENDERING VIEW OF BUILDING 10 FROM THE BACKYARD OF BUILDING 1, AT THE OTHER SIDE OF LOSETH RAOD



RENDERING VIEW OF BUILDING 6 (WALK-OUT) AND BUILDING 3 (LEVELED GRADING) LOOKING TOWARDS THE NORTH-WEST

Notes:

- THIS DRAWING MUST NOT BE SCALED.

- VERIFY ALL DIMENSIONS AND DATUMS PRIOR TO COMMENCEMENT OF WORK. REPORT ALL ERRORS AND OMMISIONS TO THE ARCHITECT.

- VARIATIONS AND MODIFICATIONS ARE NOT ALLOWED WITHOUT WRITTEN PERMISSION FROM THE ARCHITECT.

- THIS DRAWING IS THE EXCLUSIVE PROPERTY OF THE ARCHITECT.

- ANY REPRODUCTION MUST BEAR THEIR NAME AS ARCHITECT.

> FOR CLIENT REVIEW

2 08.11.2018 CP FOR CLIENT REVIEW 1 29.03.2018 CP CONCEPT DESIGN

NO. DATE BY DESCRIPTION

DESIGN CONSULTANT

gta

GTA ARCHITECTURE LTD.

243 1889 SPRINGFIELD ROAD Kelowna, British Columbia. V1Y 5V5 TELEPHONE: (250)979-1668

DEVELOPED BY:

KIRSCHNER MOUNTAIN

PROJECT

KIRSCHNER MOUNTAIN PH. 6 Enter address here

BUILDINGS
PERSPECTIVES

(RENDERINGS)

DESIGNED BY: De

 $\frac{\text{Pesigner}}{12" = 1'-0"} \quad \mathbf{A0}$ 

19/12/2018 FILE: 0001

Project File Name and Location: P:\2018 Architecture\A18-08 Kirschner Mountain Phase 6\3.0 Drawings\A18-08 Kirschner Mountain COVER REND ELEV.rvt



RENDERING VIEW OF SITE FROM ABOVE ROAD 4



RENDERING VIEW LOOKING WEST FROM INTERSECTION OF ROAD 3 AND 4



RENDERING VIEW LOOKING SOUTH ON ROAD 1



RENDERING VIEW LOOKING NORTH-WEST AT END OF ROAD 2



RENDERING VIEW LOOKING SOUTH ON LOSETH ROAD



RENDERING VIEW LOOKING EAST ON LOSETH ROAD

2 08.11.2018 CP FOR CLIENT REVIEW 1 29.03.2018 CP CONCEPT DESIGN

NO. DATE BY DESCRIPTION

DESIGN CONSULTANT

GTA ARCHITECTURE LTD.

243 1889 SPRINGFIELD ROAD Kelowna, British Columbia.

TELEPHONE: (250)979-1668

DEVELOPED BY:

KIRSCHNER MOUNTAIN

PROJECT

KIRSCHNER MOUNTAIN PH. 6

SHEET TITLE BUILDINGS PERSPECTIVES (RENDERINGS)

DATE: 19/12/2018 FILE: 0001

Project File Name and Location: P:\2018 Architecture\A18-08 Kirschner Mountain Phase 6\3.0 Drawings\A18-08 Kirschner Mountain COVER REND ELEV (2020.01.16).rvt

- THIS DRAWING MUST NOT BE SCALED.


- VERIFY ALL DIMENSIONS AND DATUMS PRIOR TO COMMENCEMENT OF WORK. REPORT ALL ERRORS AND OMMISIONS TO THE ARCHITECT.


- VARIATIONS AND MODIFICATIONS ARE NOT ALLOWED WITHOUT WRITTEN PERMISSION FROM THE ARCHITECT.


- ANY REPRODUCTION MUST BEAR THEIR NAME AS ARCHITECT.


- THIS DRAWING IS THE EXCLUSIVE PROPERTY OF THE ARCHITECT.

ISSUED FOR BUILDING PERMIT

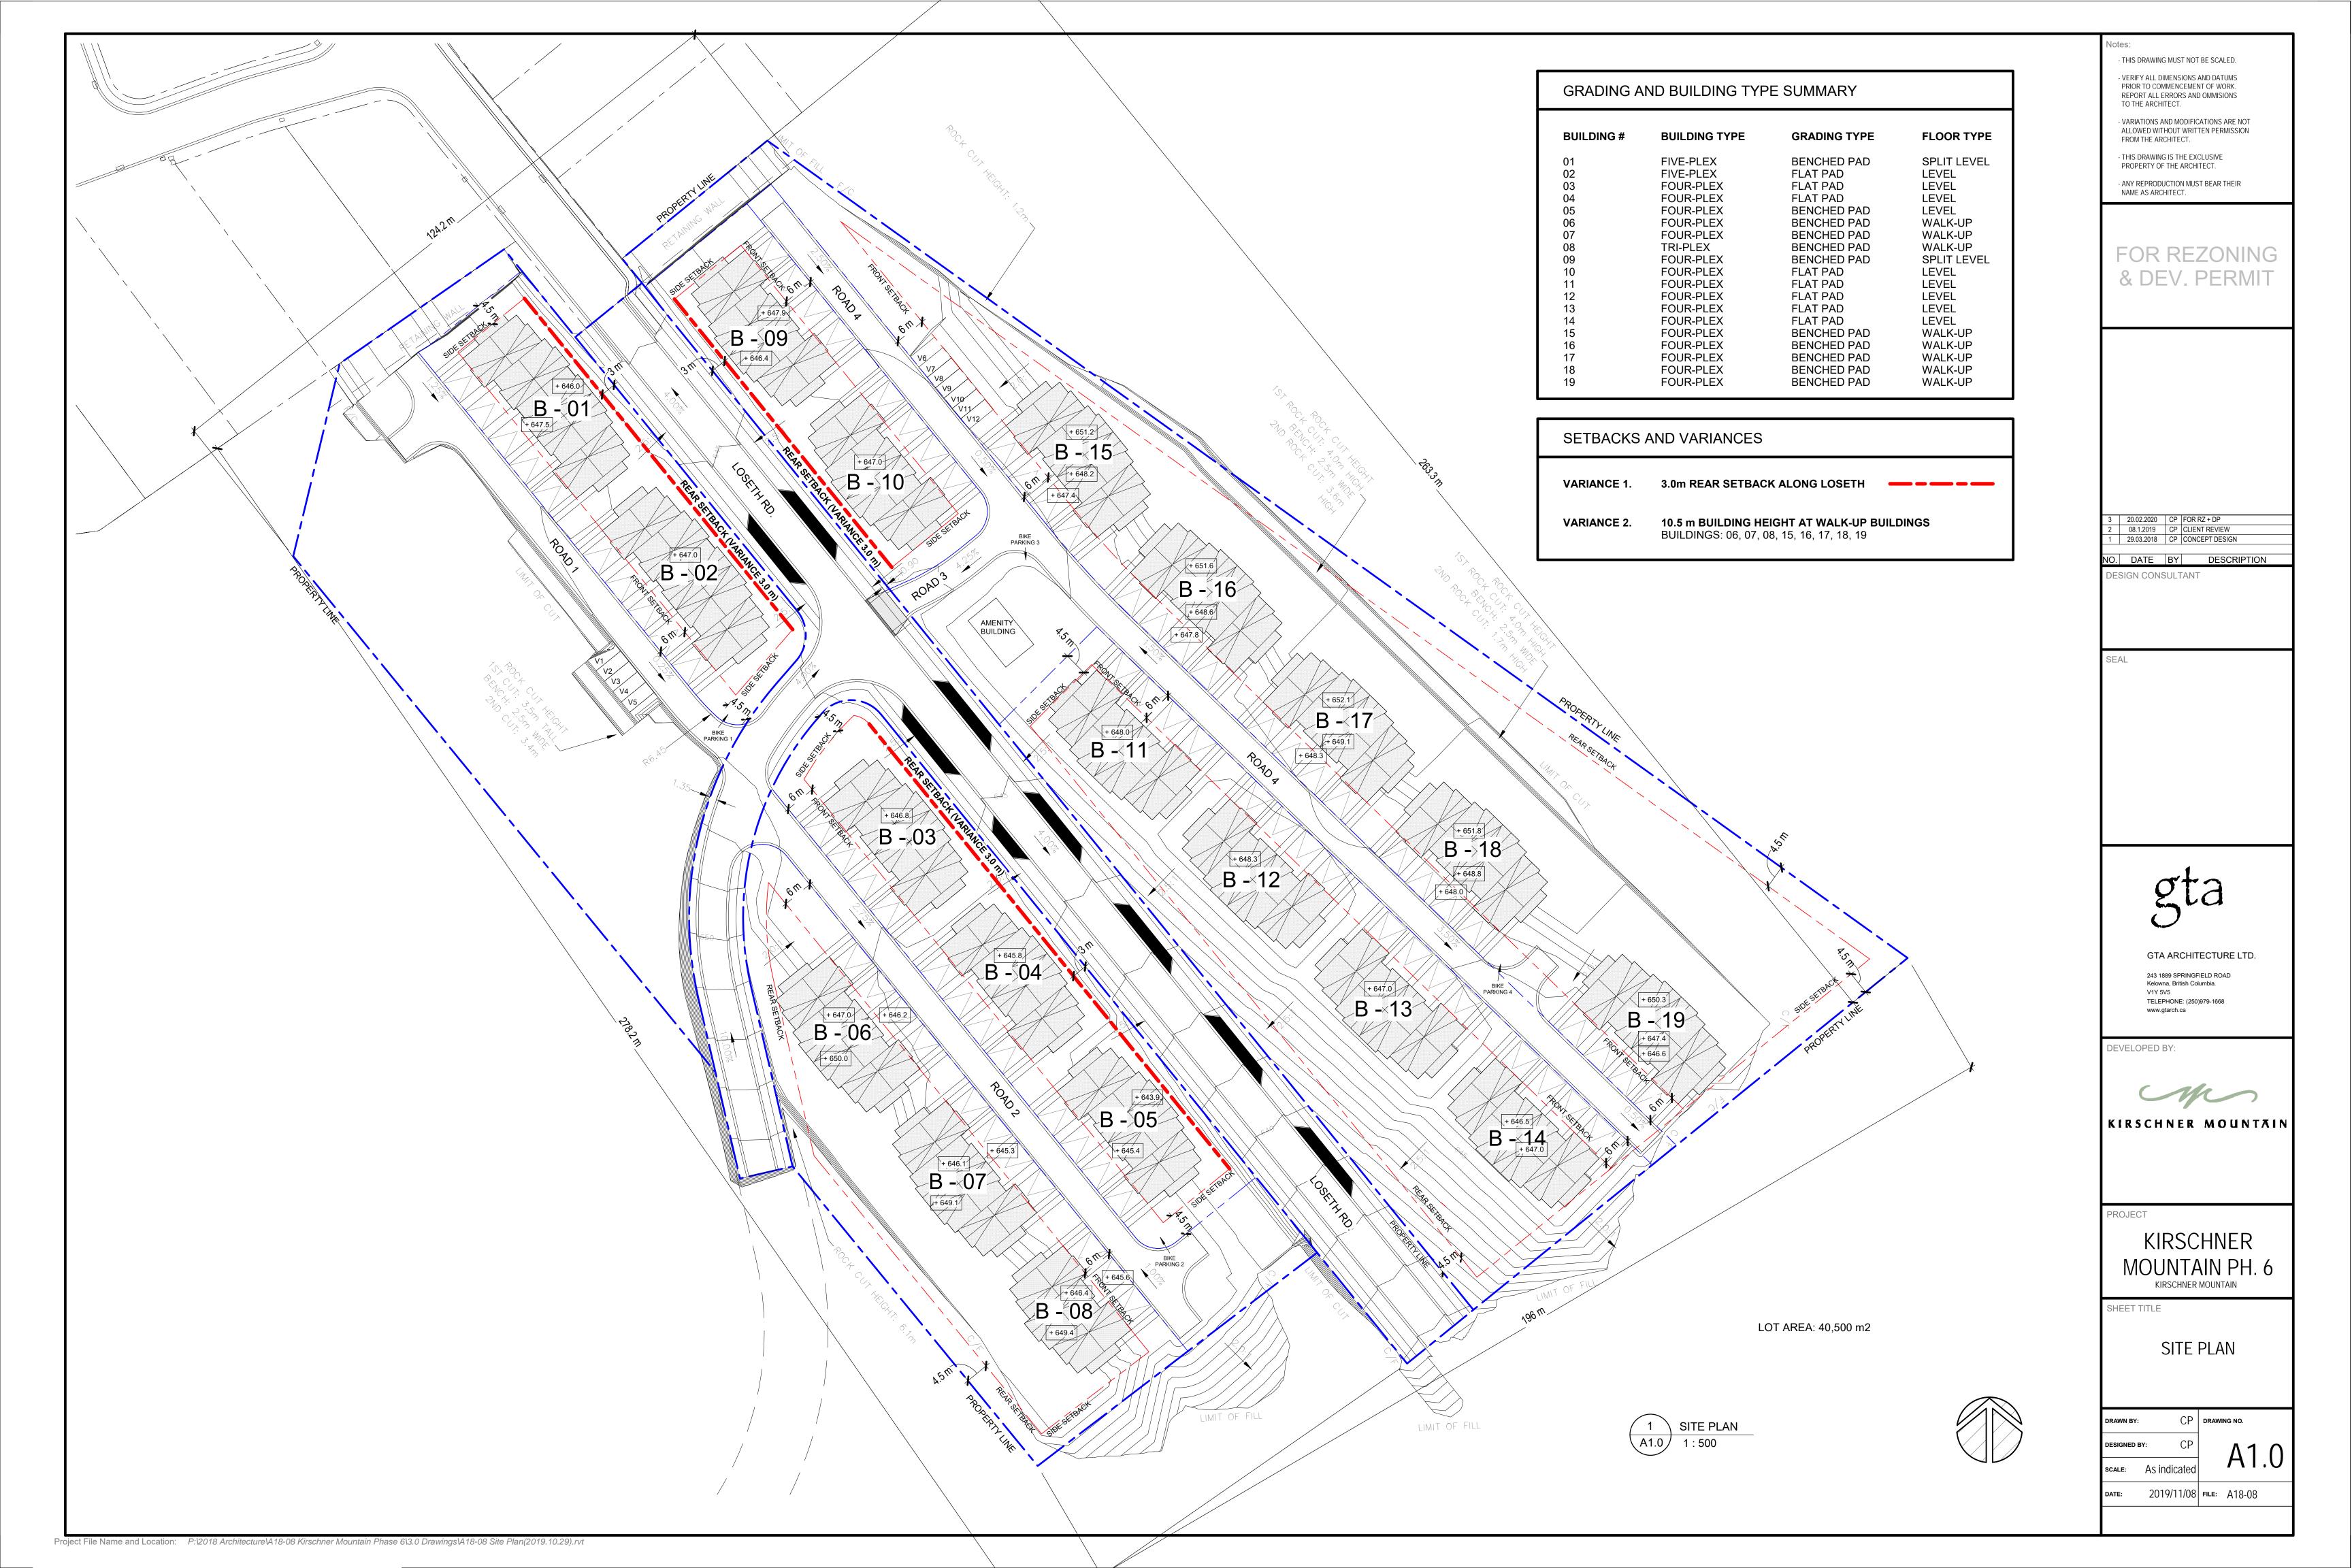


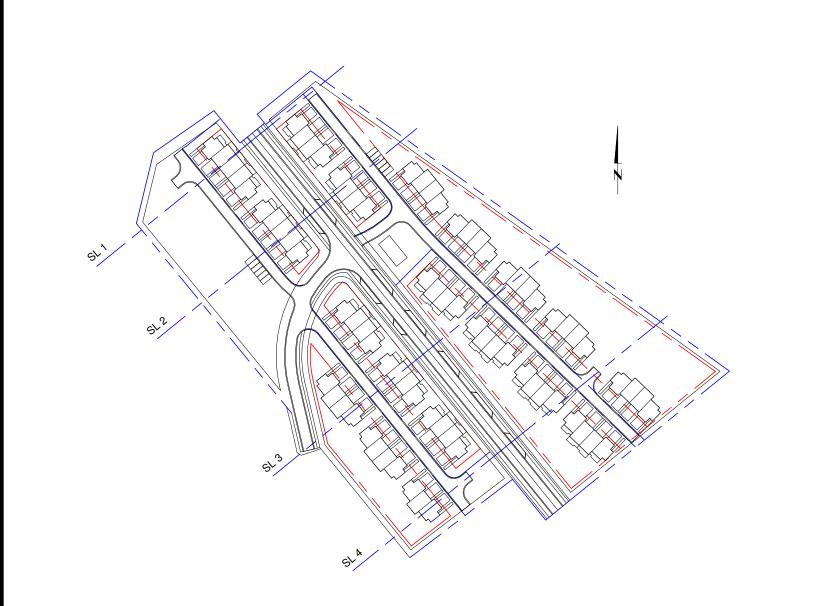


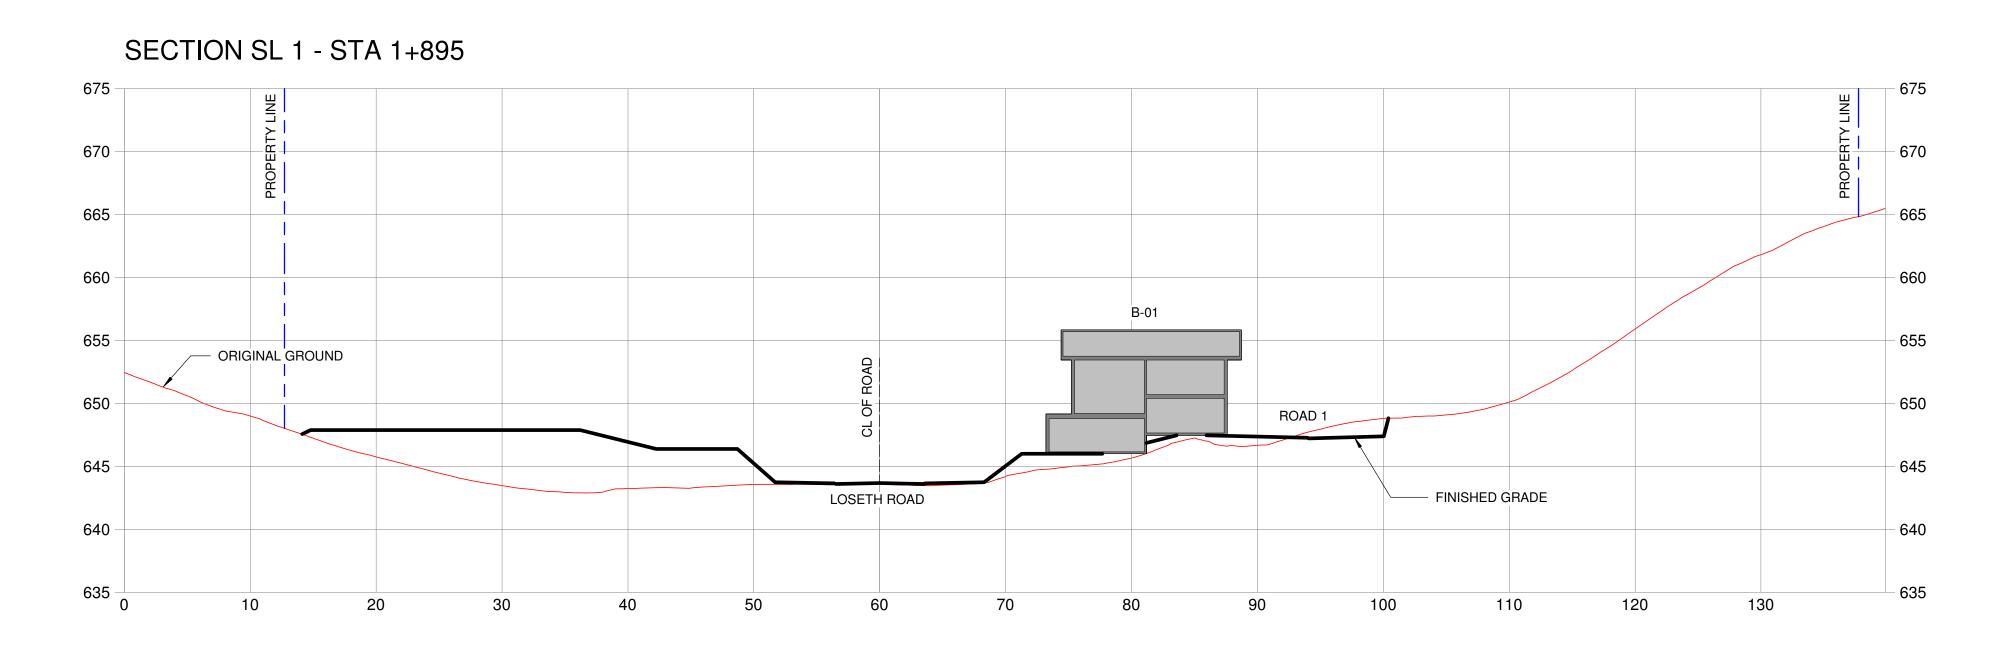


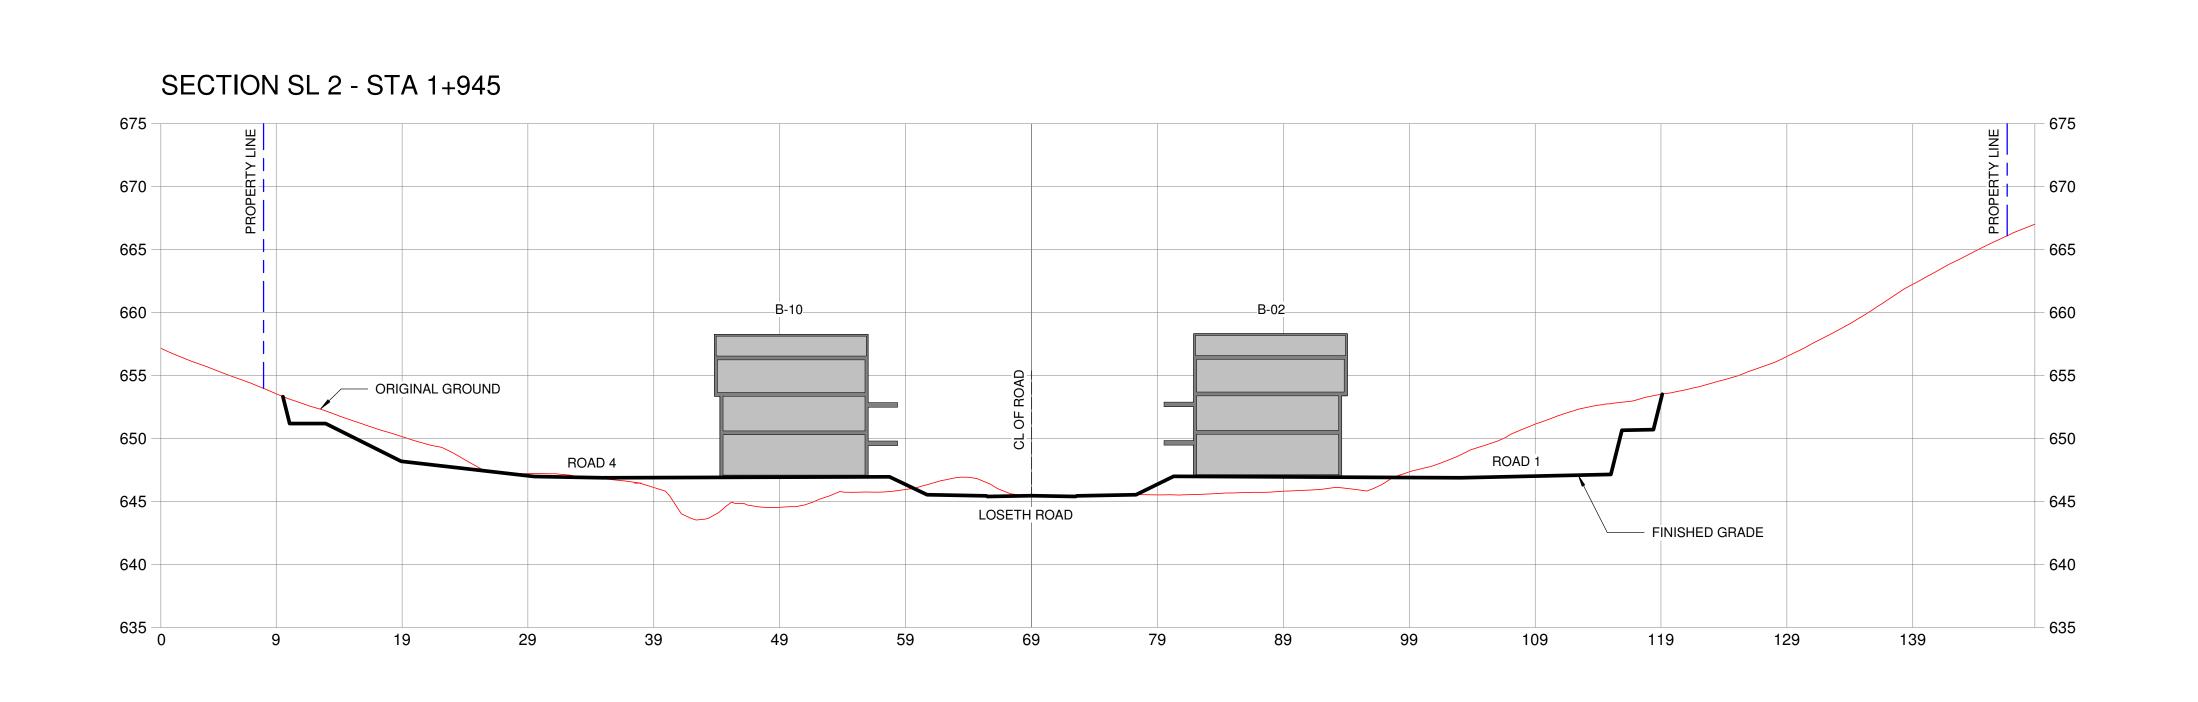

- THIS DRAWING MUST NOT BE SCALED. - VERIFY ALL DIMENSIONS AND DATUMS PRIOR TO COMMENCEMENT OF WORK. REPORT ALL ERRORS AND OMMISIONS TO THE ARCHITECT. - VARIATIONS AND MODIFICATIONS ARE NOT ALLOWED WITHOUT WRITTEN PERMISSION FROM THE ARCHITECT. - THIS DRAWING IS THE EXCLUSIVE PROPERTY OF THE ARCHITECT. - ANY REPRODUCTION MUST BEAR THEIR NAME AS ARCHITECT. NO. DATE BY DESCRIPTION DESIGN CONSULTANT GTA ARCHITECTURE LTD. 243 1889 SPRINGFIELD ROAD Kelowna, British Columbia. TELEPHONE: (250)979-1668 DEVELOPED BY: KIRSCHNER MOUNTAIN KIRSCHNER MOUNTAIN SHEET TITLE CROSS SITE SECTIONS 08/11/2019 FILE: A18-08

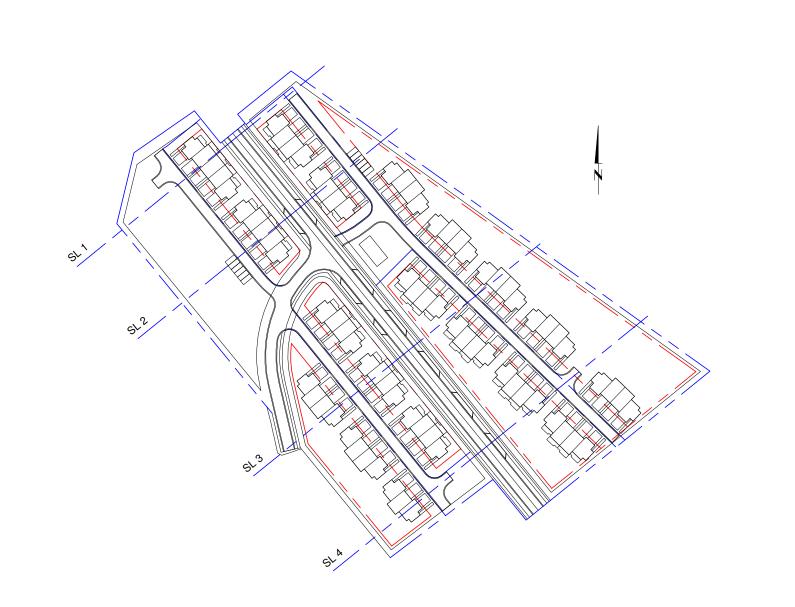

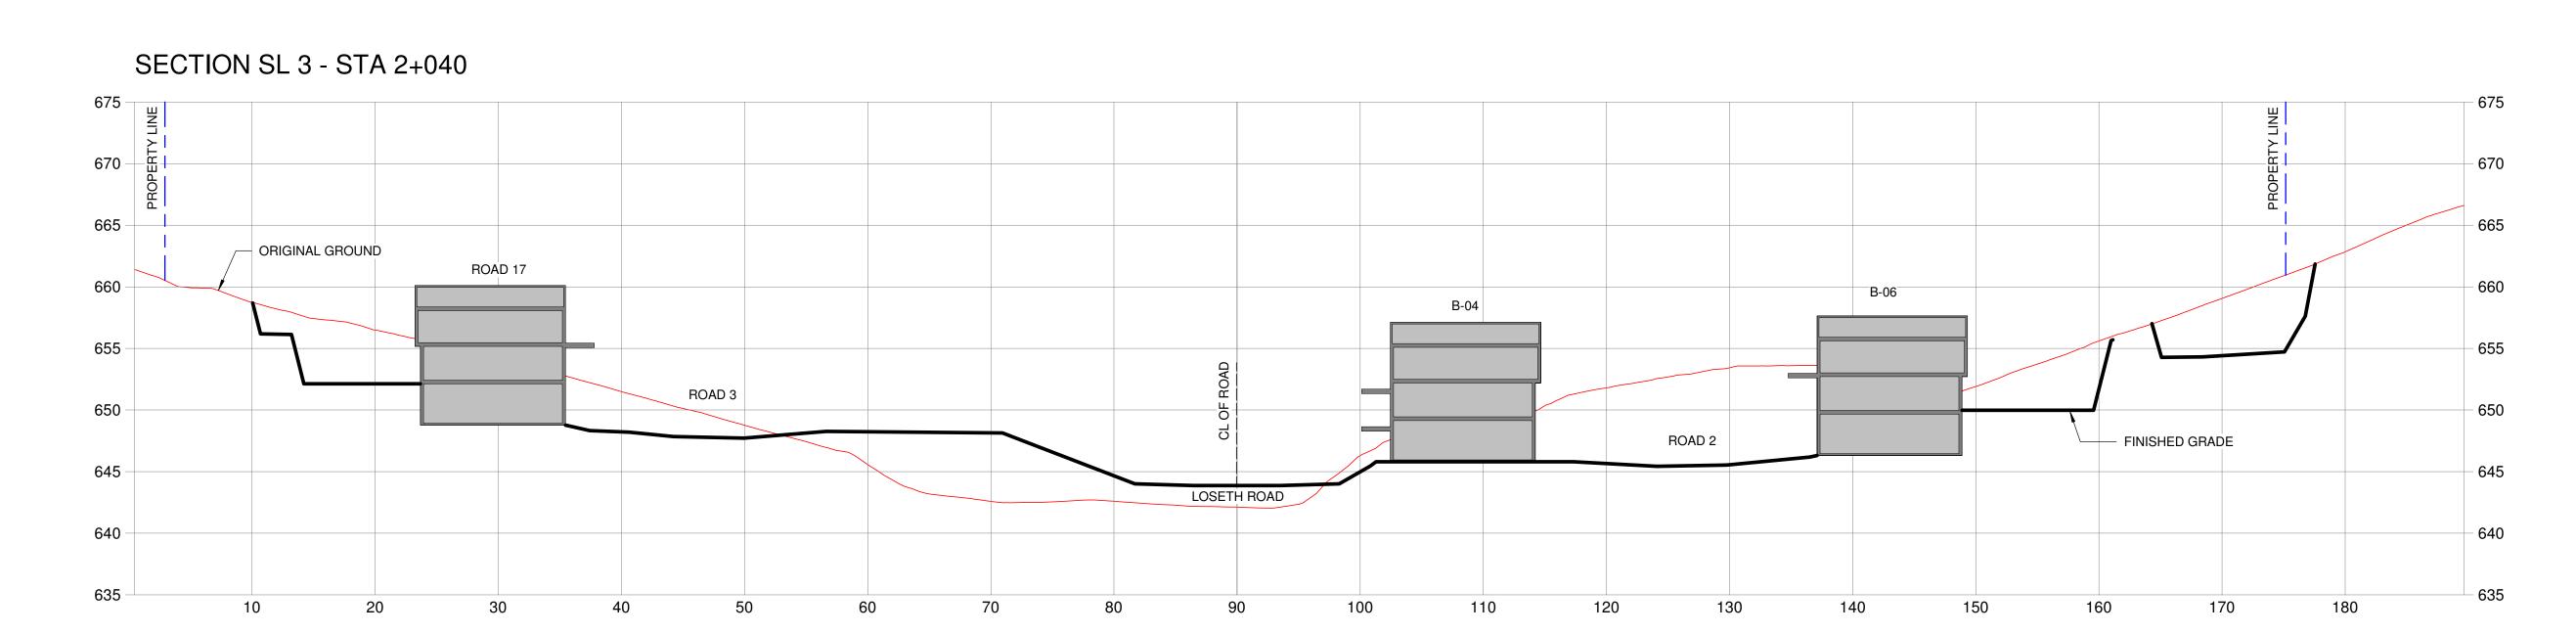

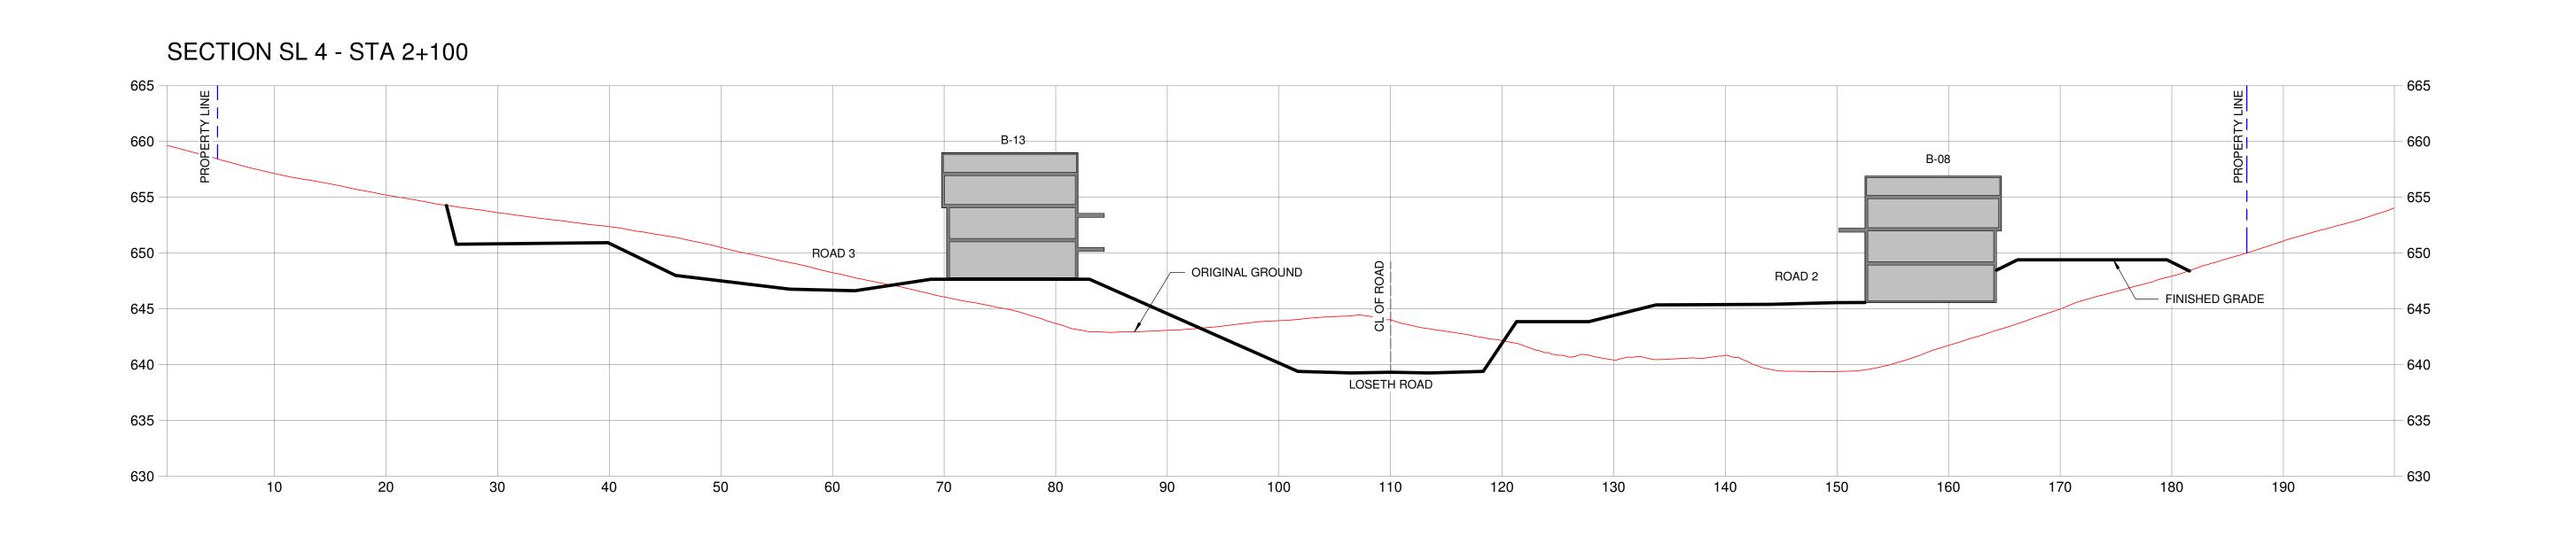

- THIS DRAWING MUST NOT BE SCALED. - VERIFY ALL DIMENSIONS AND DATUMS PRIOR TO COMMENCEMENT OF WORK. REPORT ALL ERRORS AND OMMISIONS TO THE ARCHITECT. - VARIATIONS AND MODIFICATIONS ARE NOT ALLOWED WITHOUT WRITTEN PERMISSION FROM THE ARCHITECT. - THIS DRAWING IS THE EXCLUSIVE PROPERTY OF THE ARCHITECT. - ANY REPRODUCTION MUST BEAR THEIR NAME AS ARCHITECT. NO. DATE BY DESCRIPTION DESIGN CONSULTANT GTA ARCHITECTURE LTD. 243 1889 SPRINGFIELD ROAD Kelowna, British Columbia. TELEPHONE: (250)979-1668 DEVELOPED BY:

KIRSCHNER MOUNTAIN

KIRSCHNER MOUNTAIN


SHEET TITLE


CROSS SITE SECTIONS


scale: As indicated

DATE: 08/11/2019 FILE: A18-08

Project File Name and Location: P:\2018 Architecture\A18-08 Kirschner Mountain Phase 6\3.0 Drawings\November 2019 Submission\A18-08 Site Plan (2020) 2019.11.06.rvt

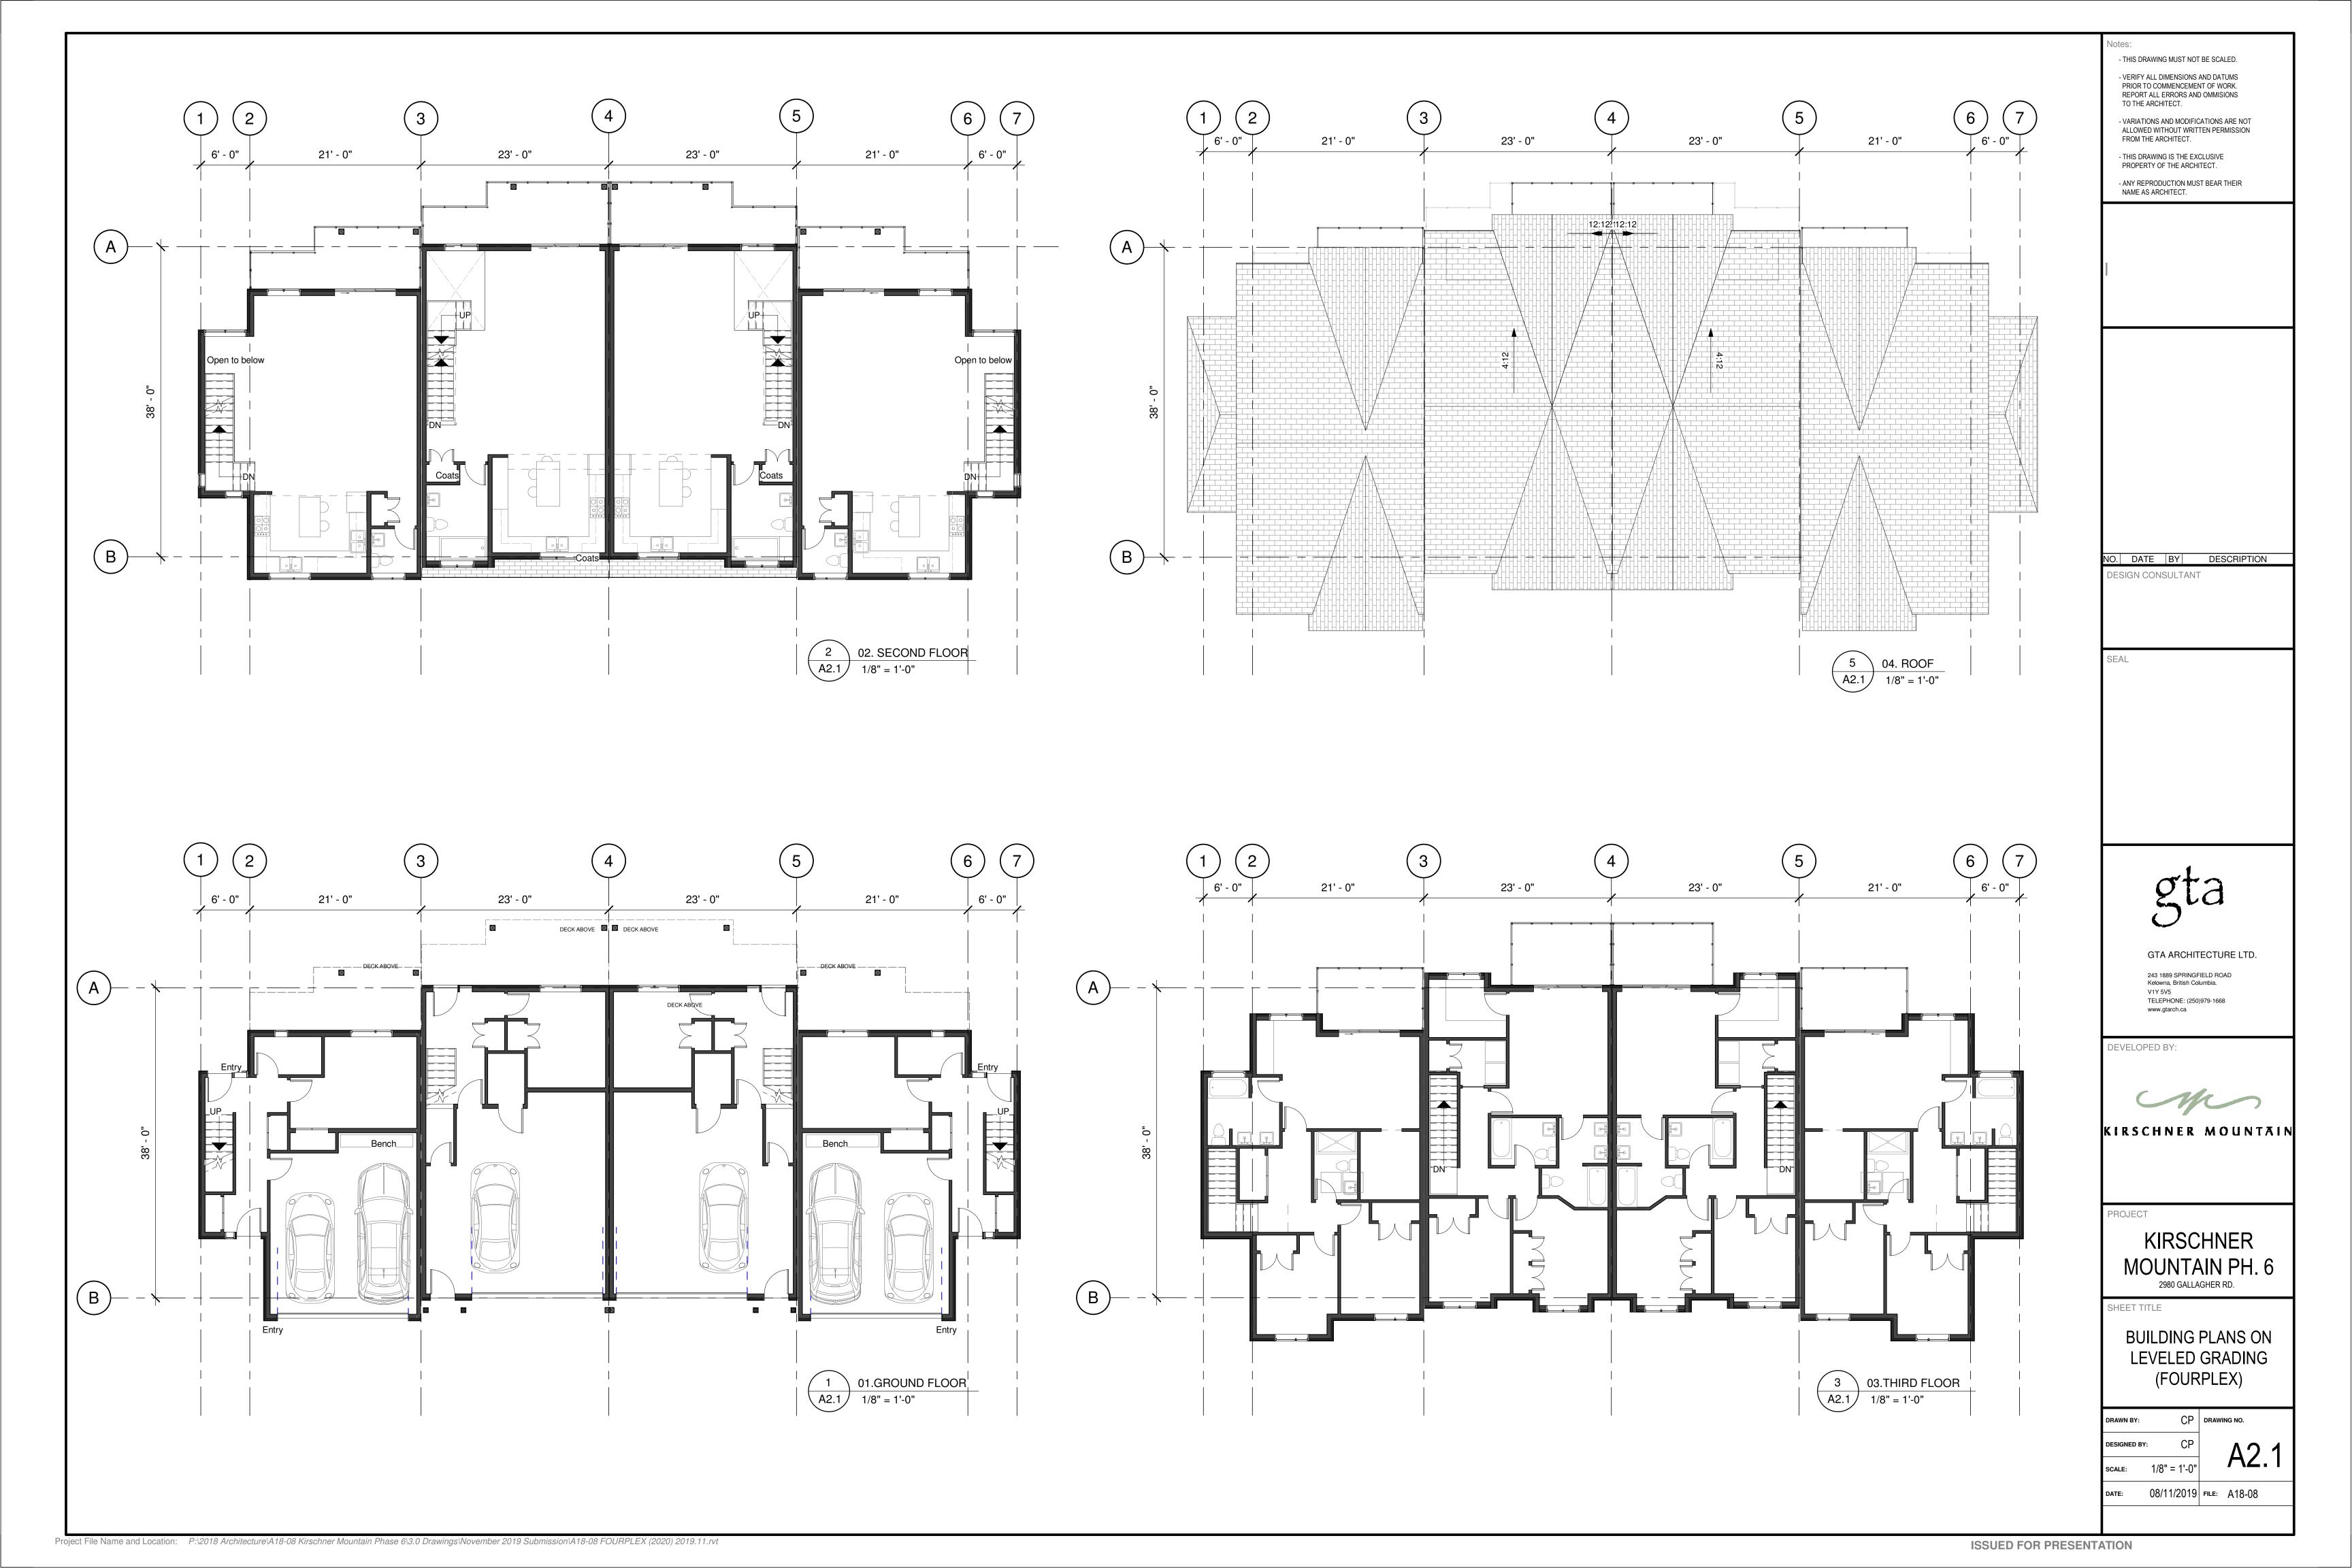

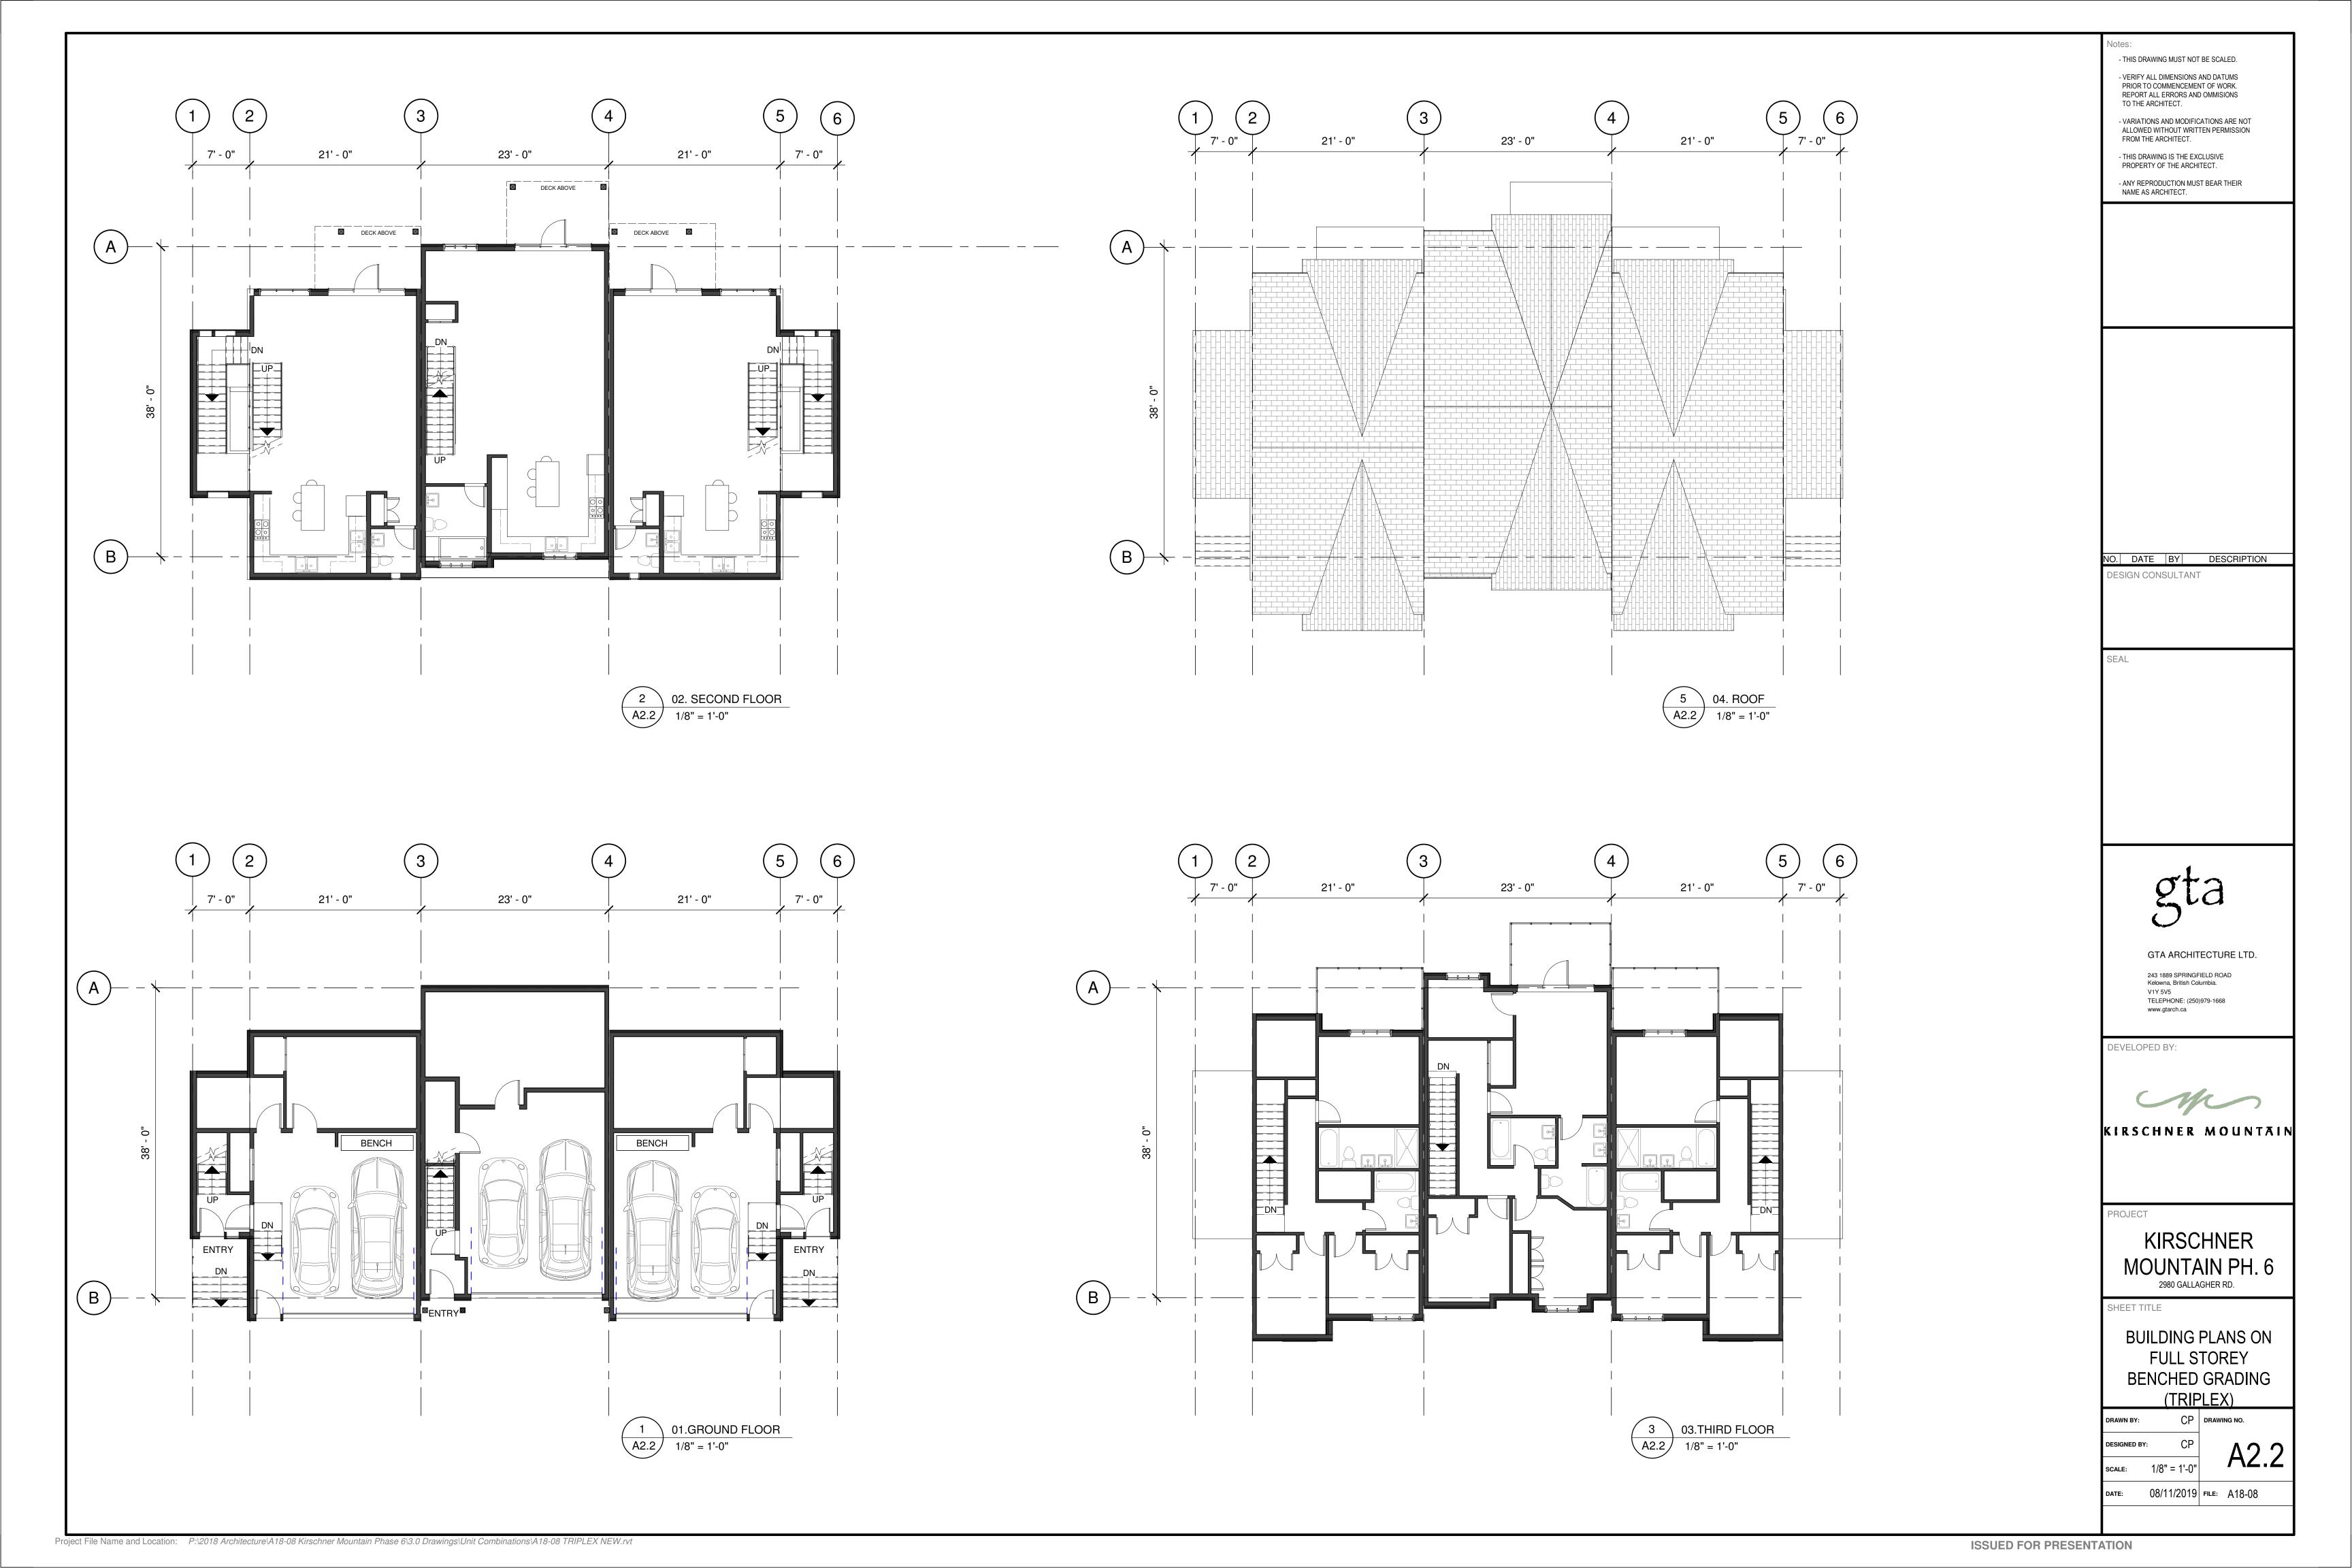

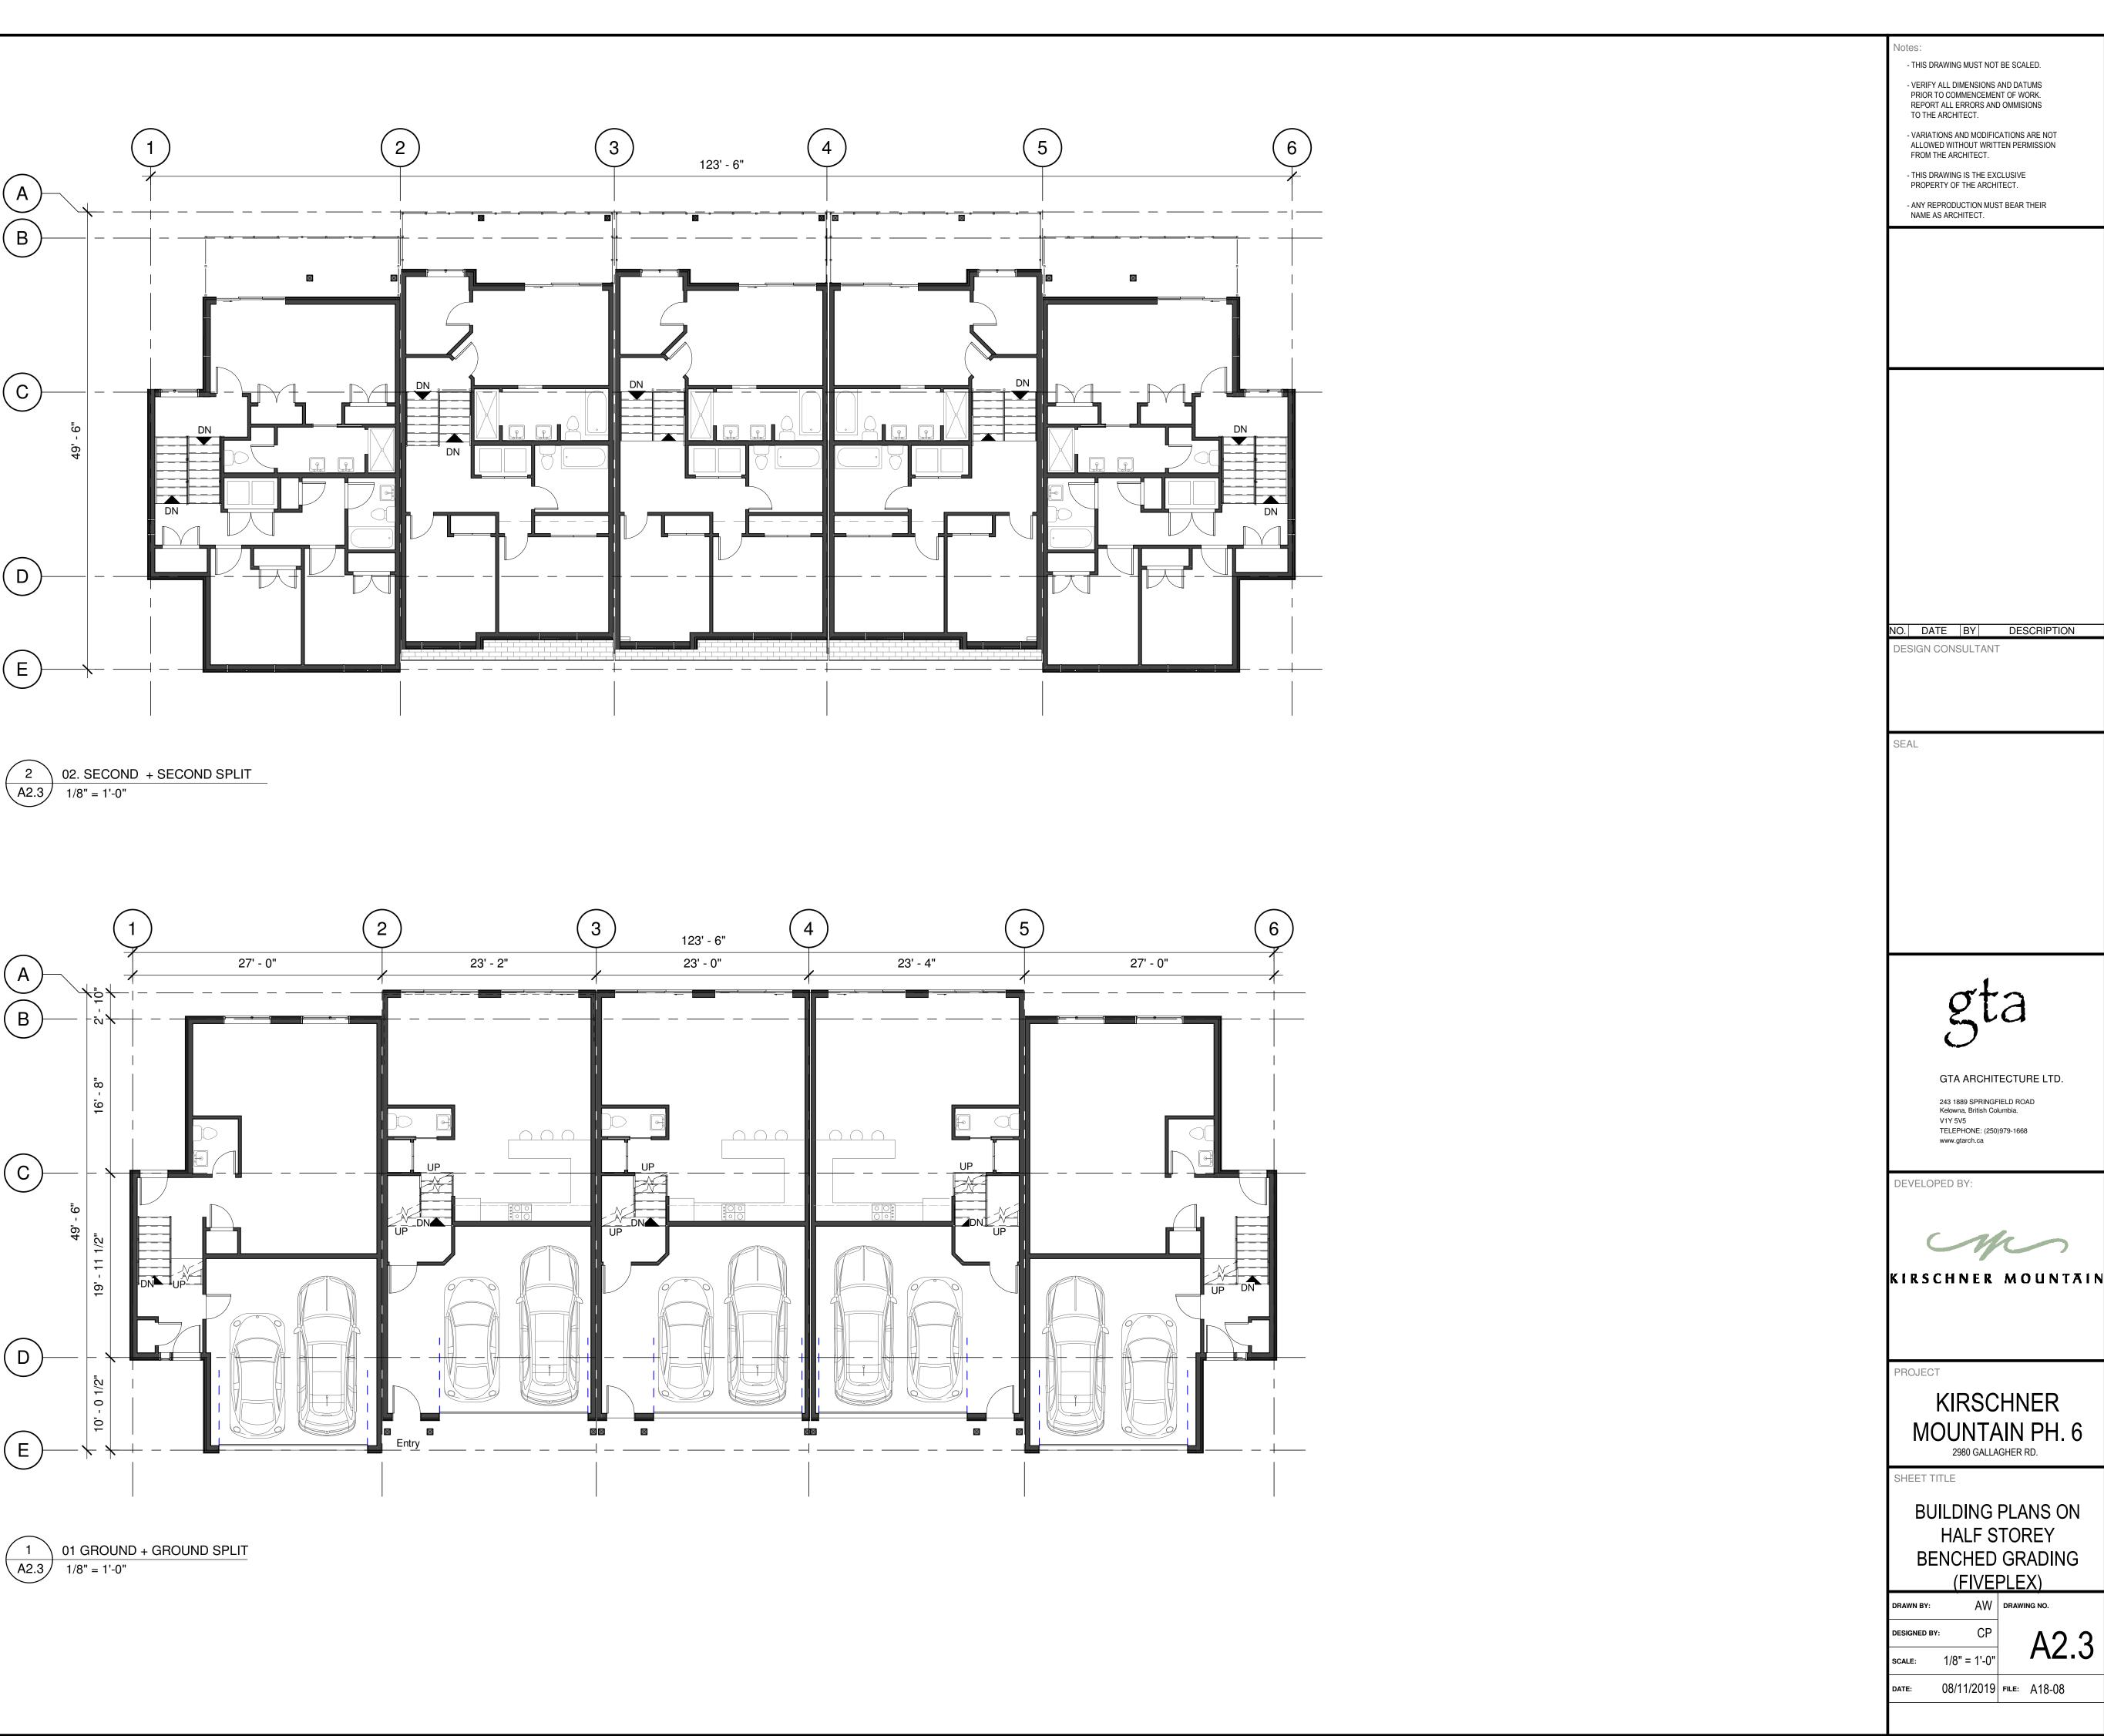



Project File Name and Location: P:\2018 Architecture\A18-08 Kirschner Mountain Phase 6\3.0 Drawings\Unit Combinations\A18-08 FIVEPLEX SPLIT NEW.rvt


**ISSUED FOR PRESENTATION** 


(FIVEPLEX)


AW DRAWING NO.

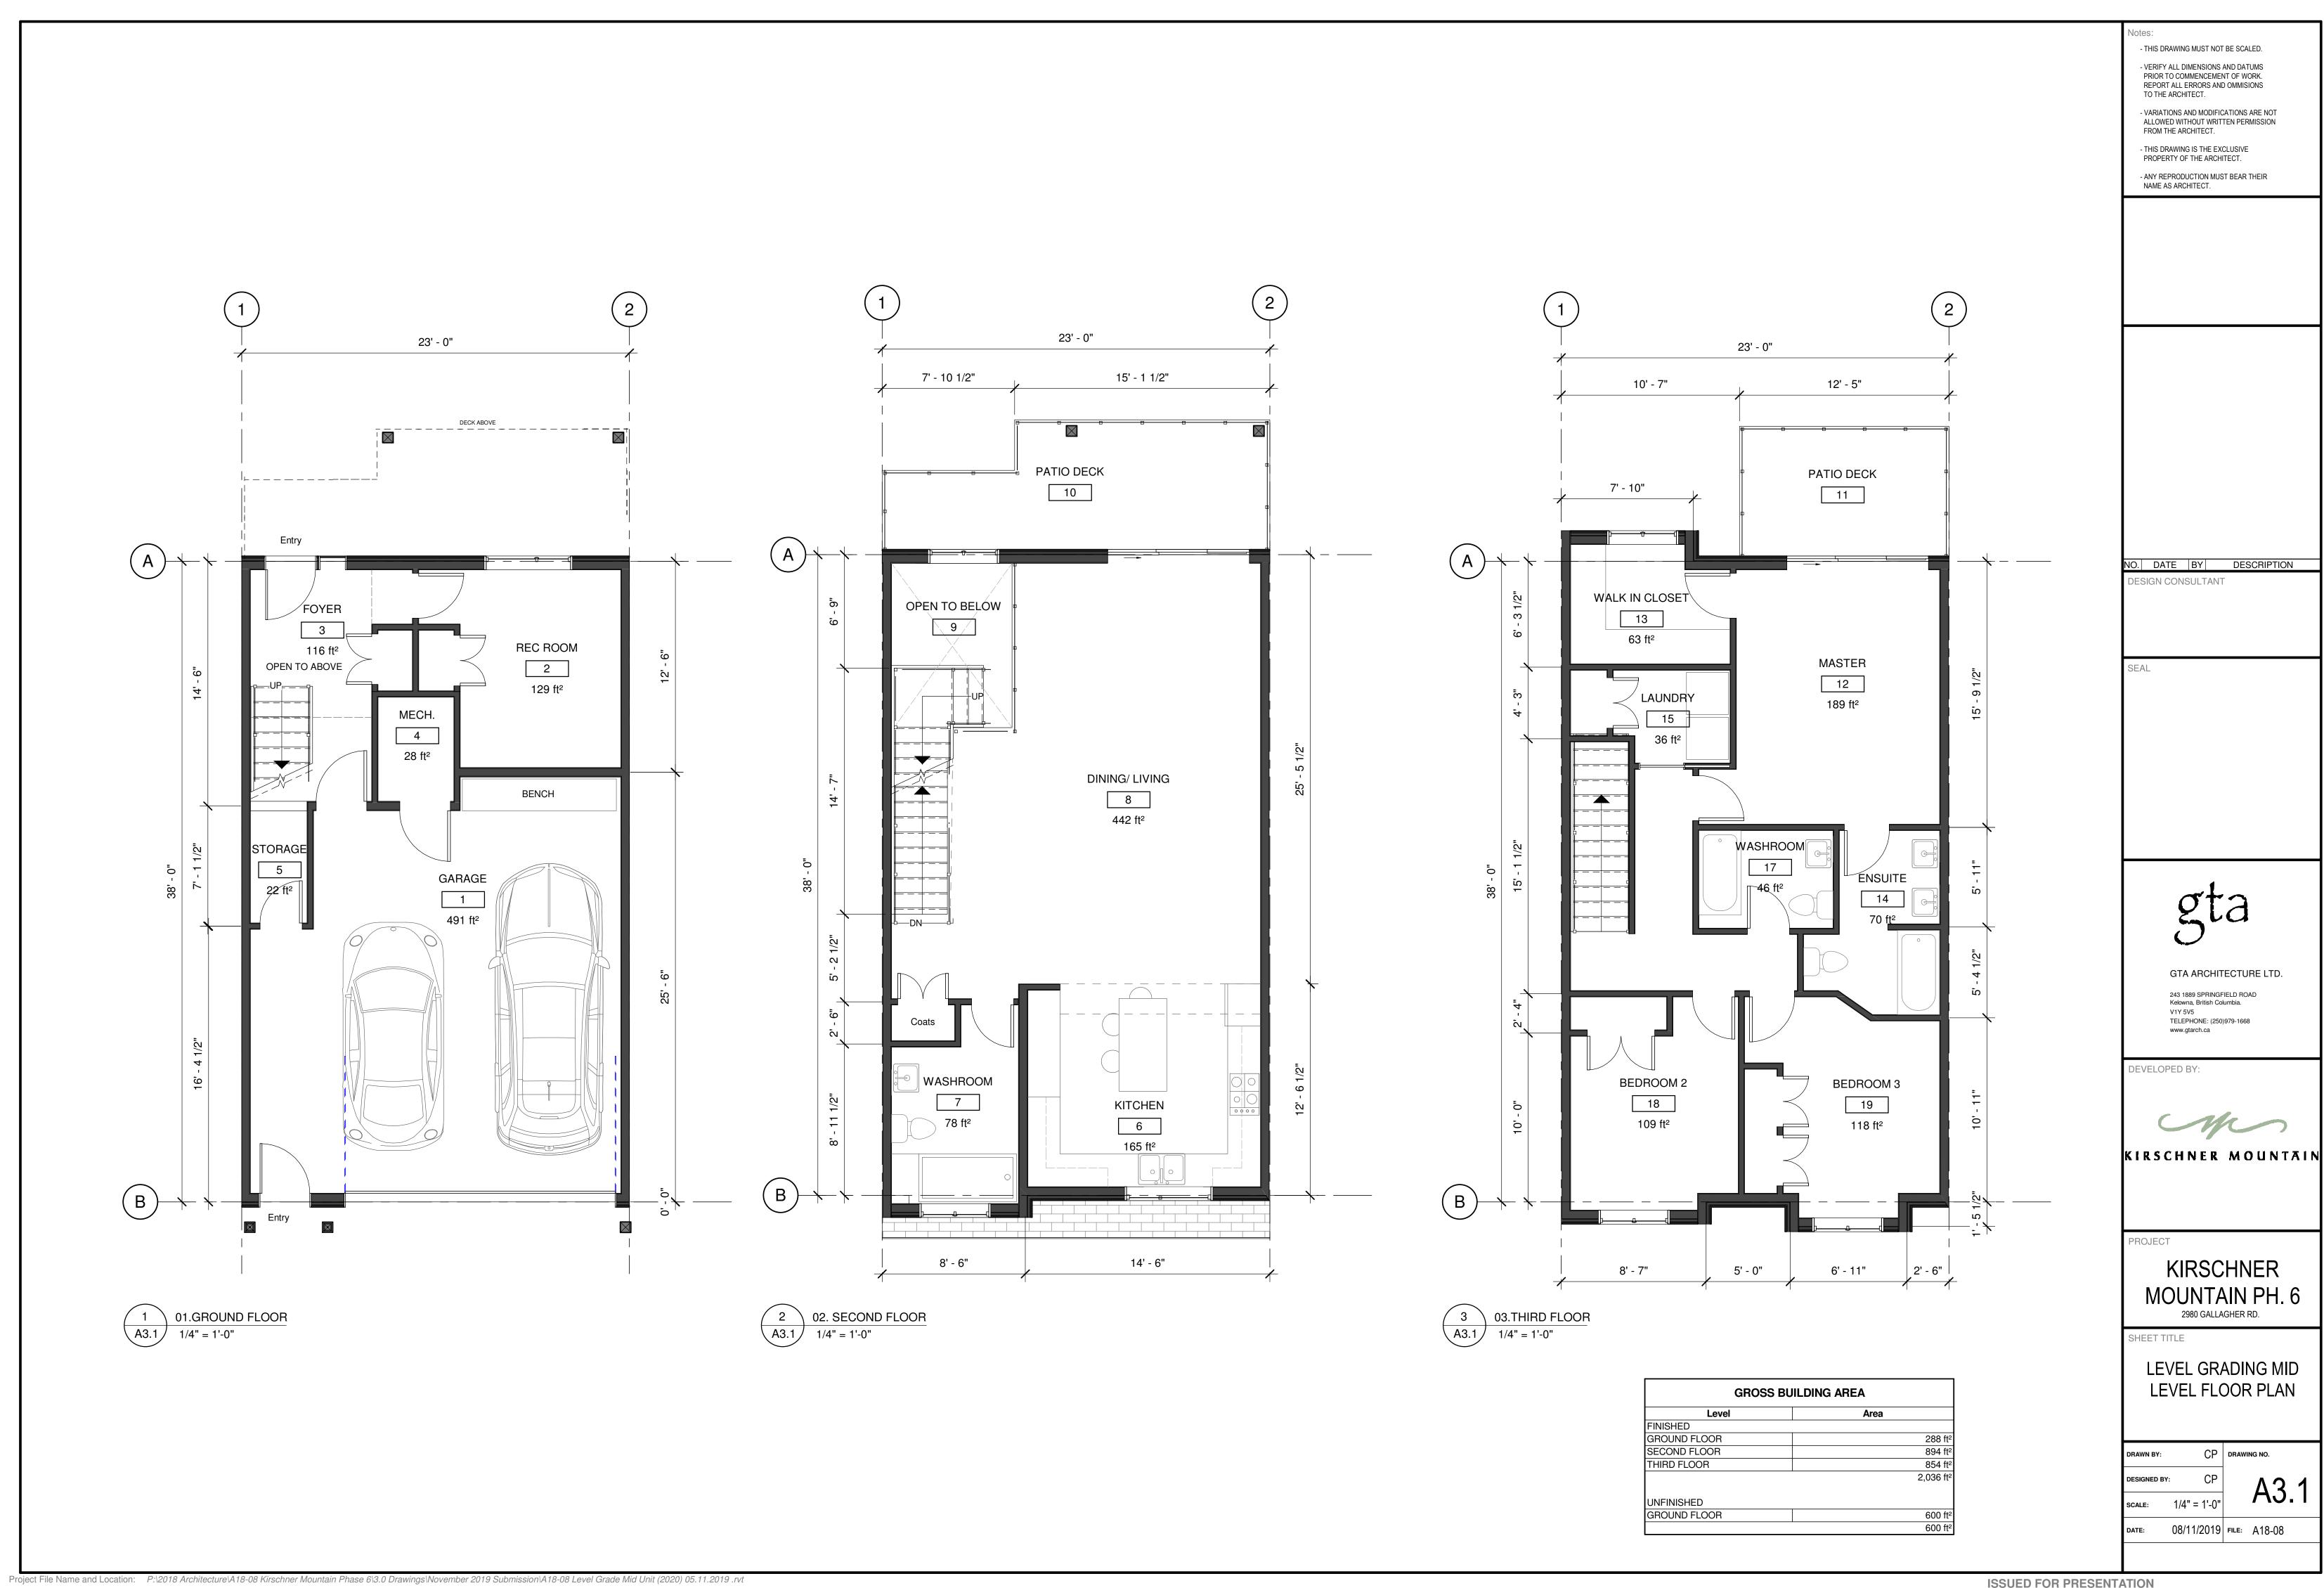

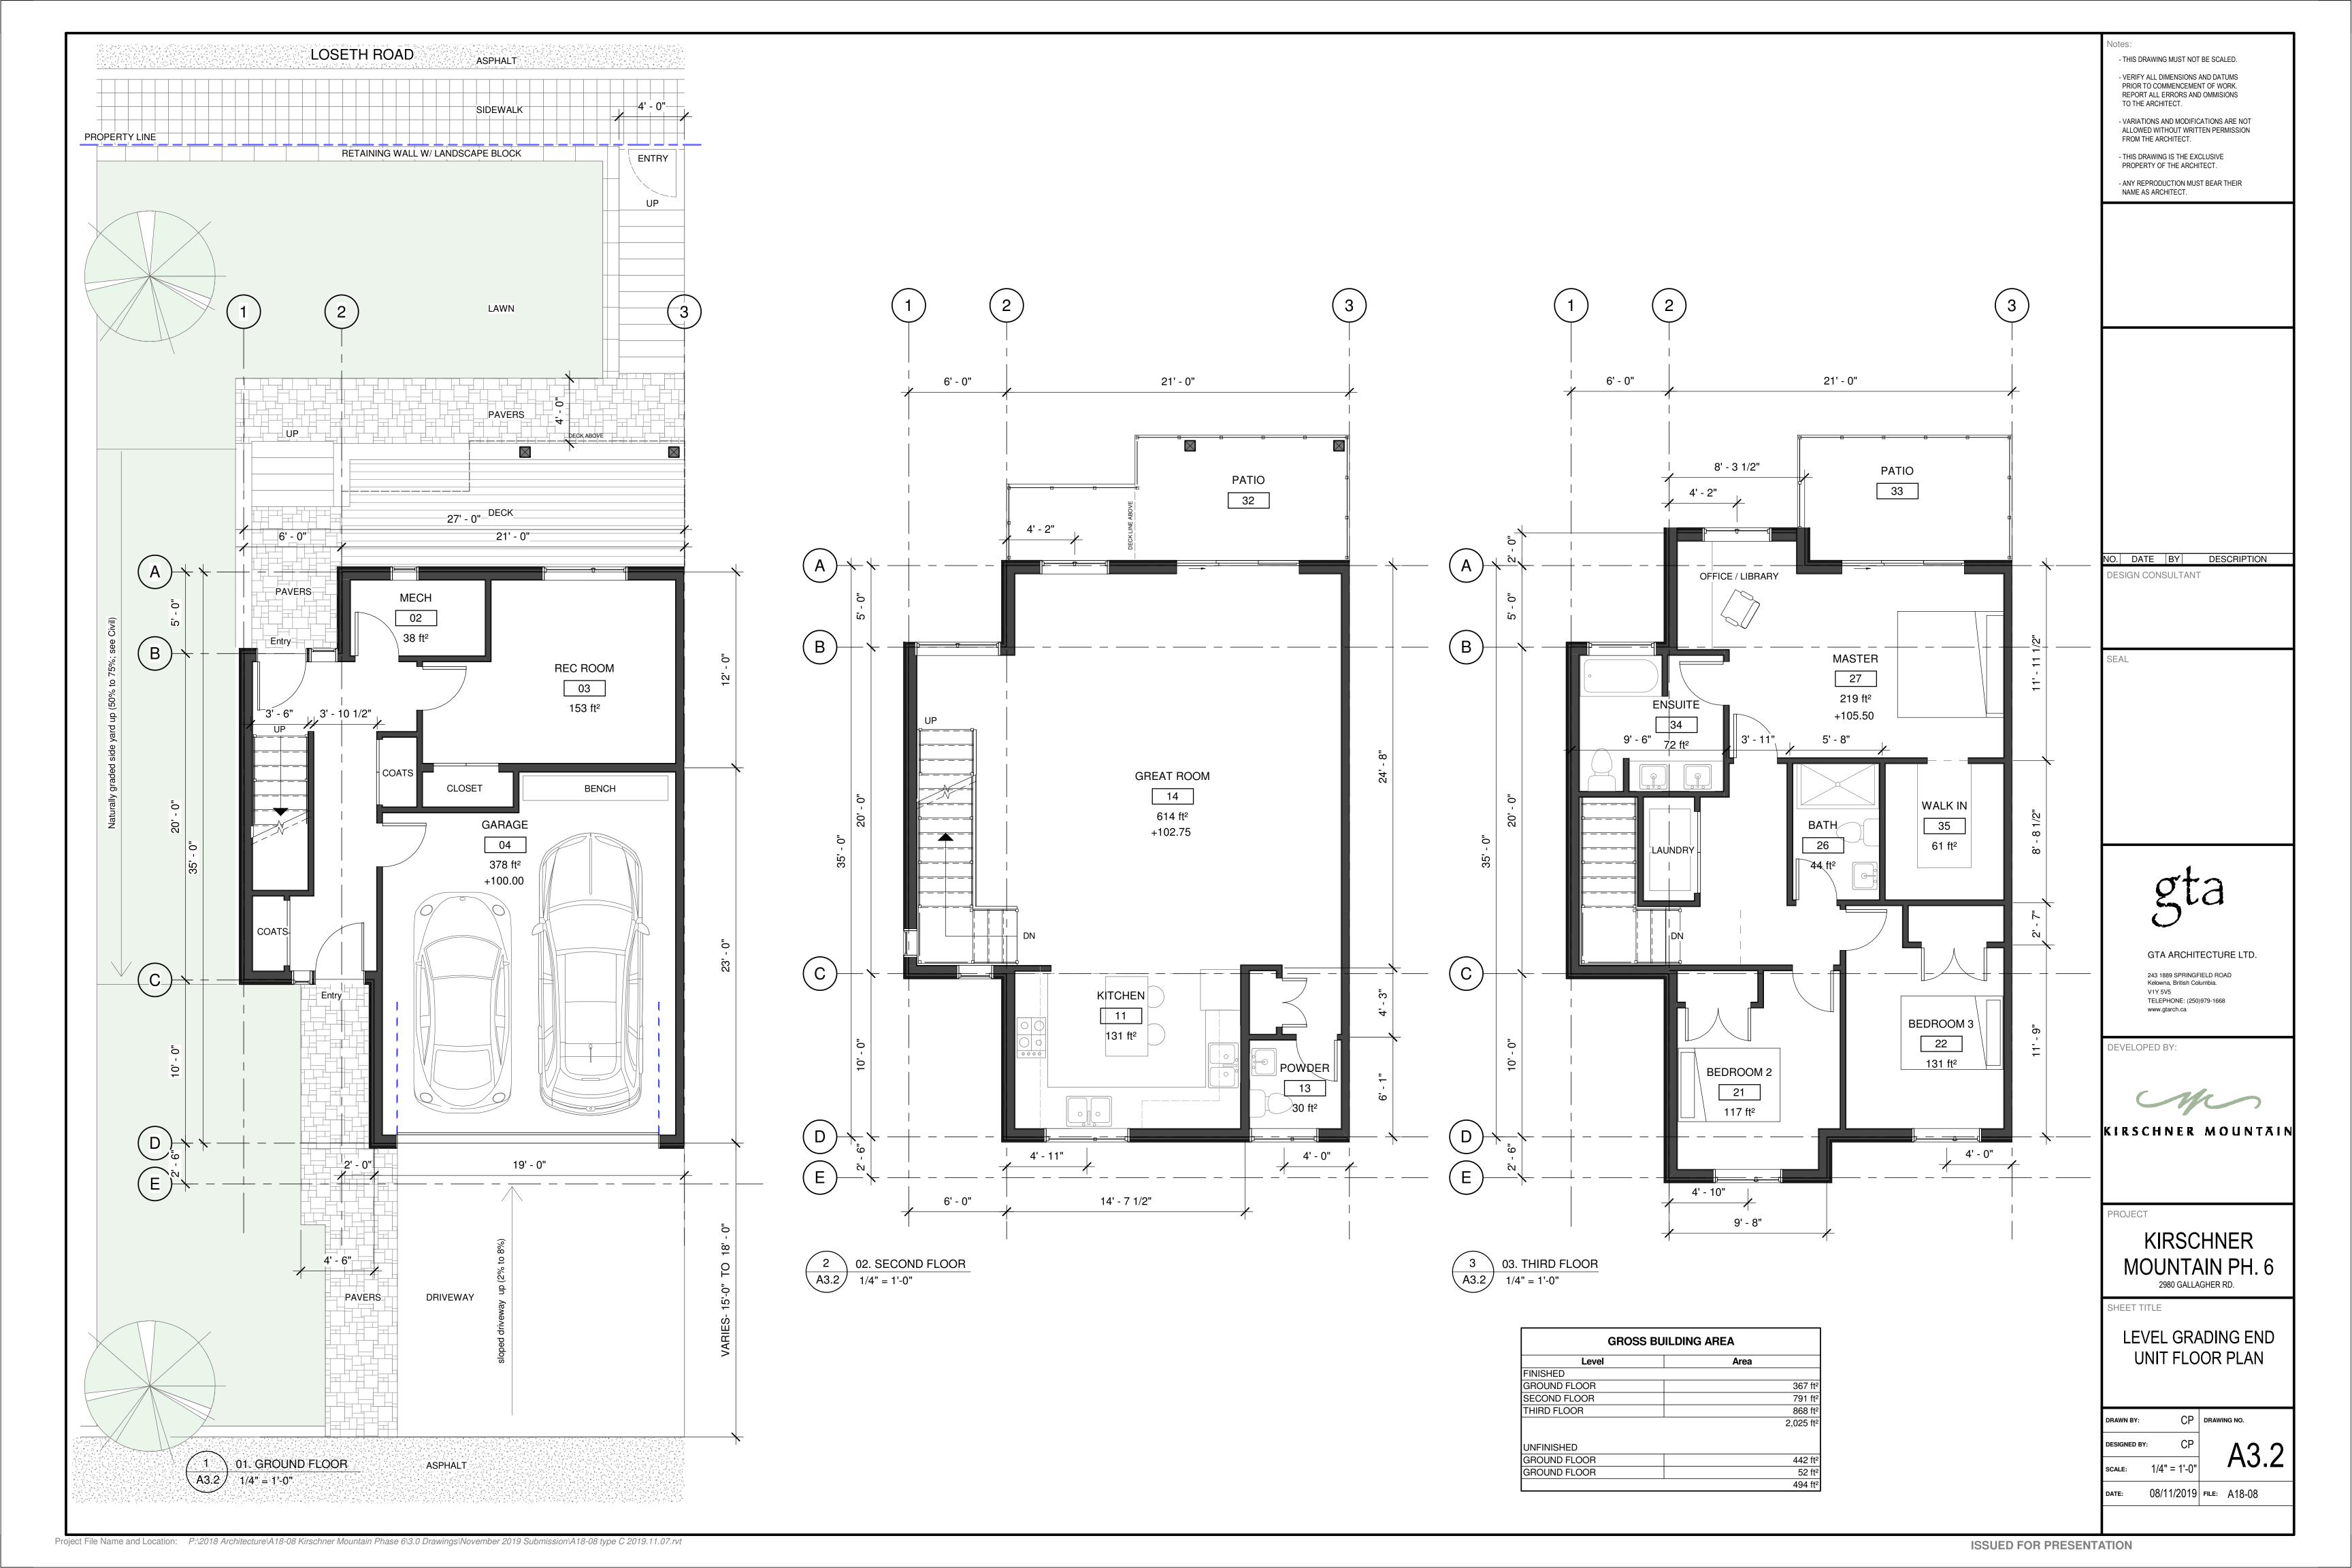

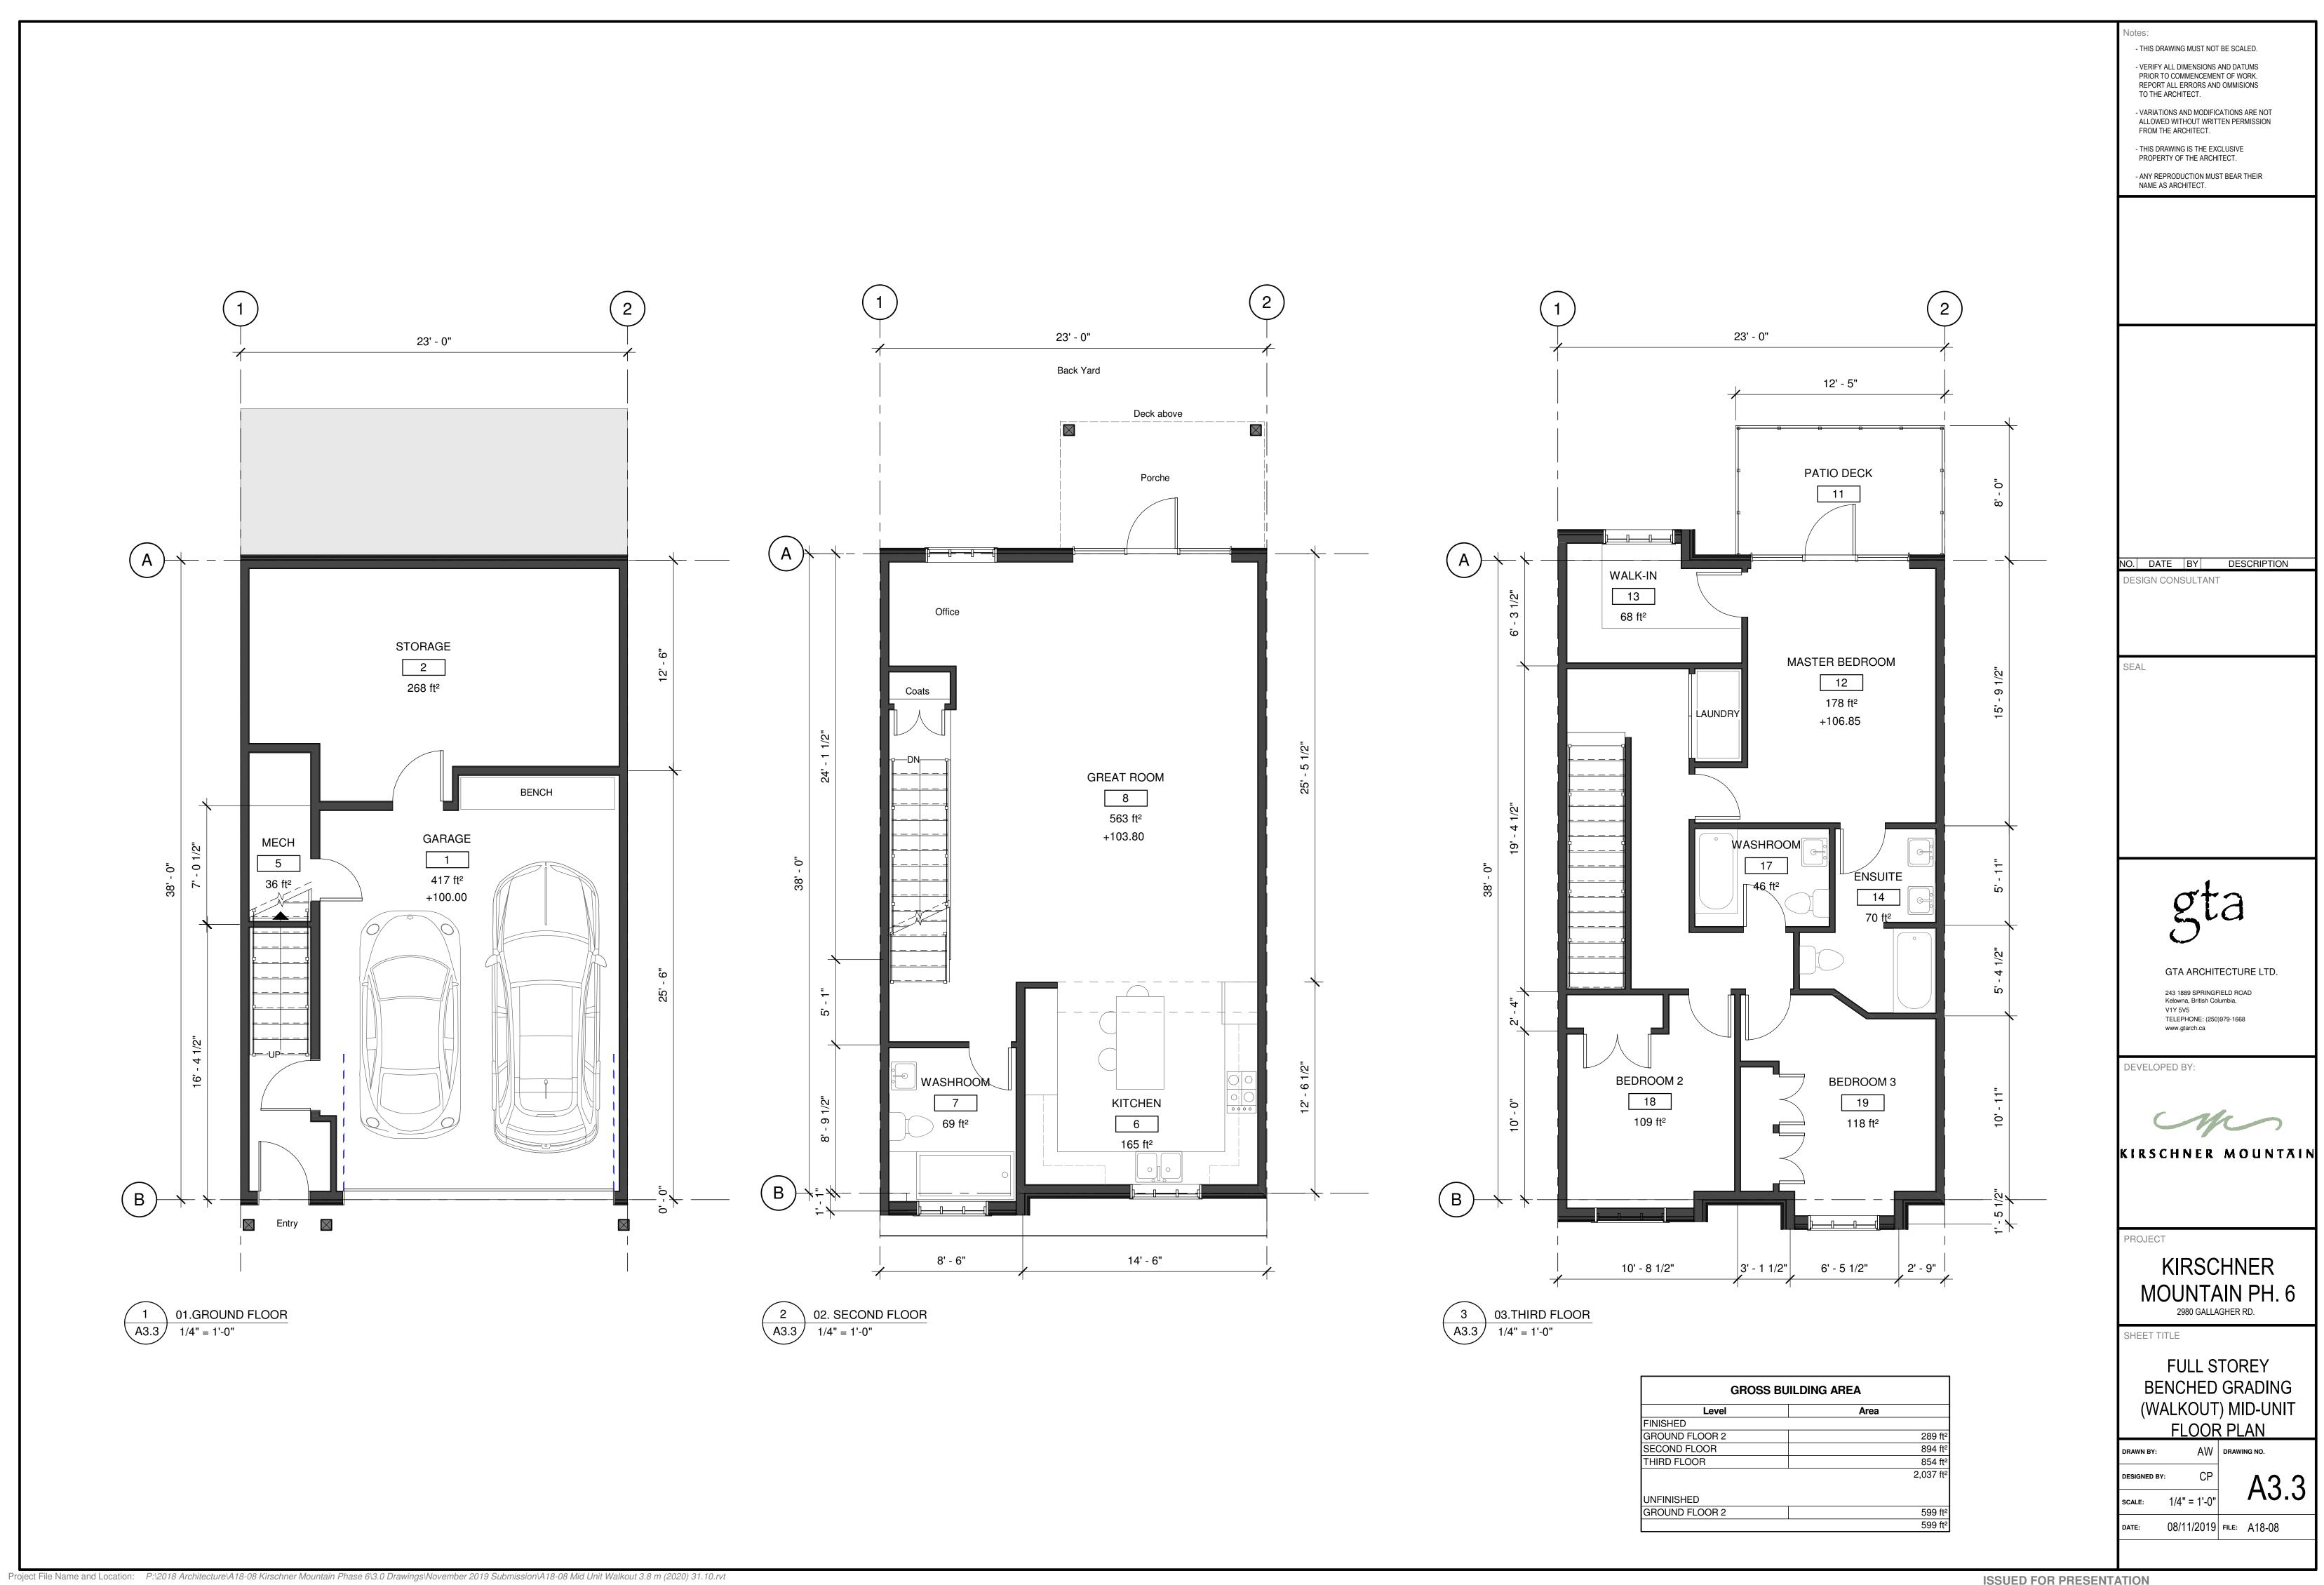

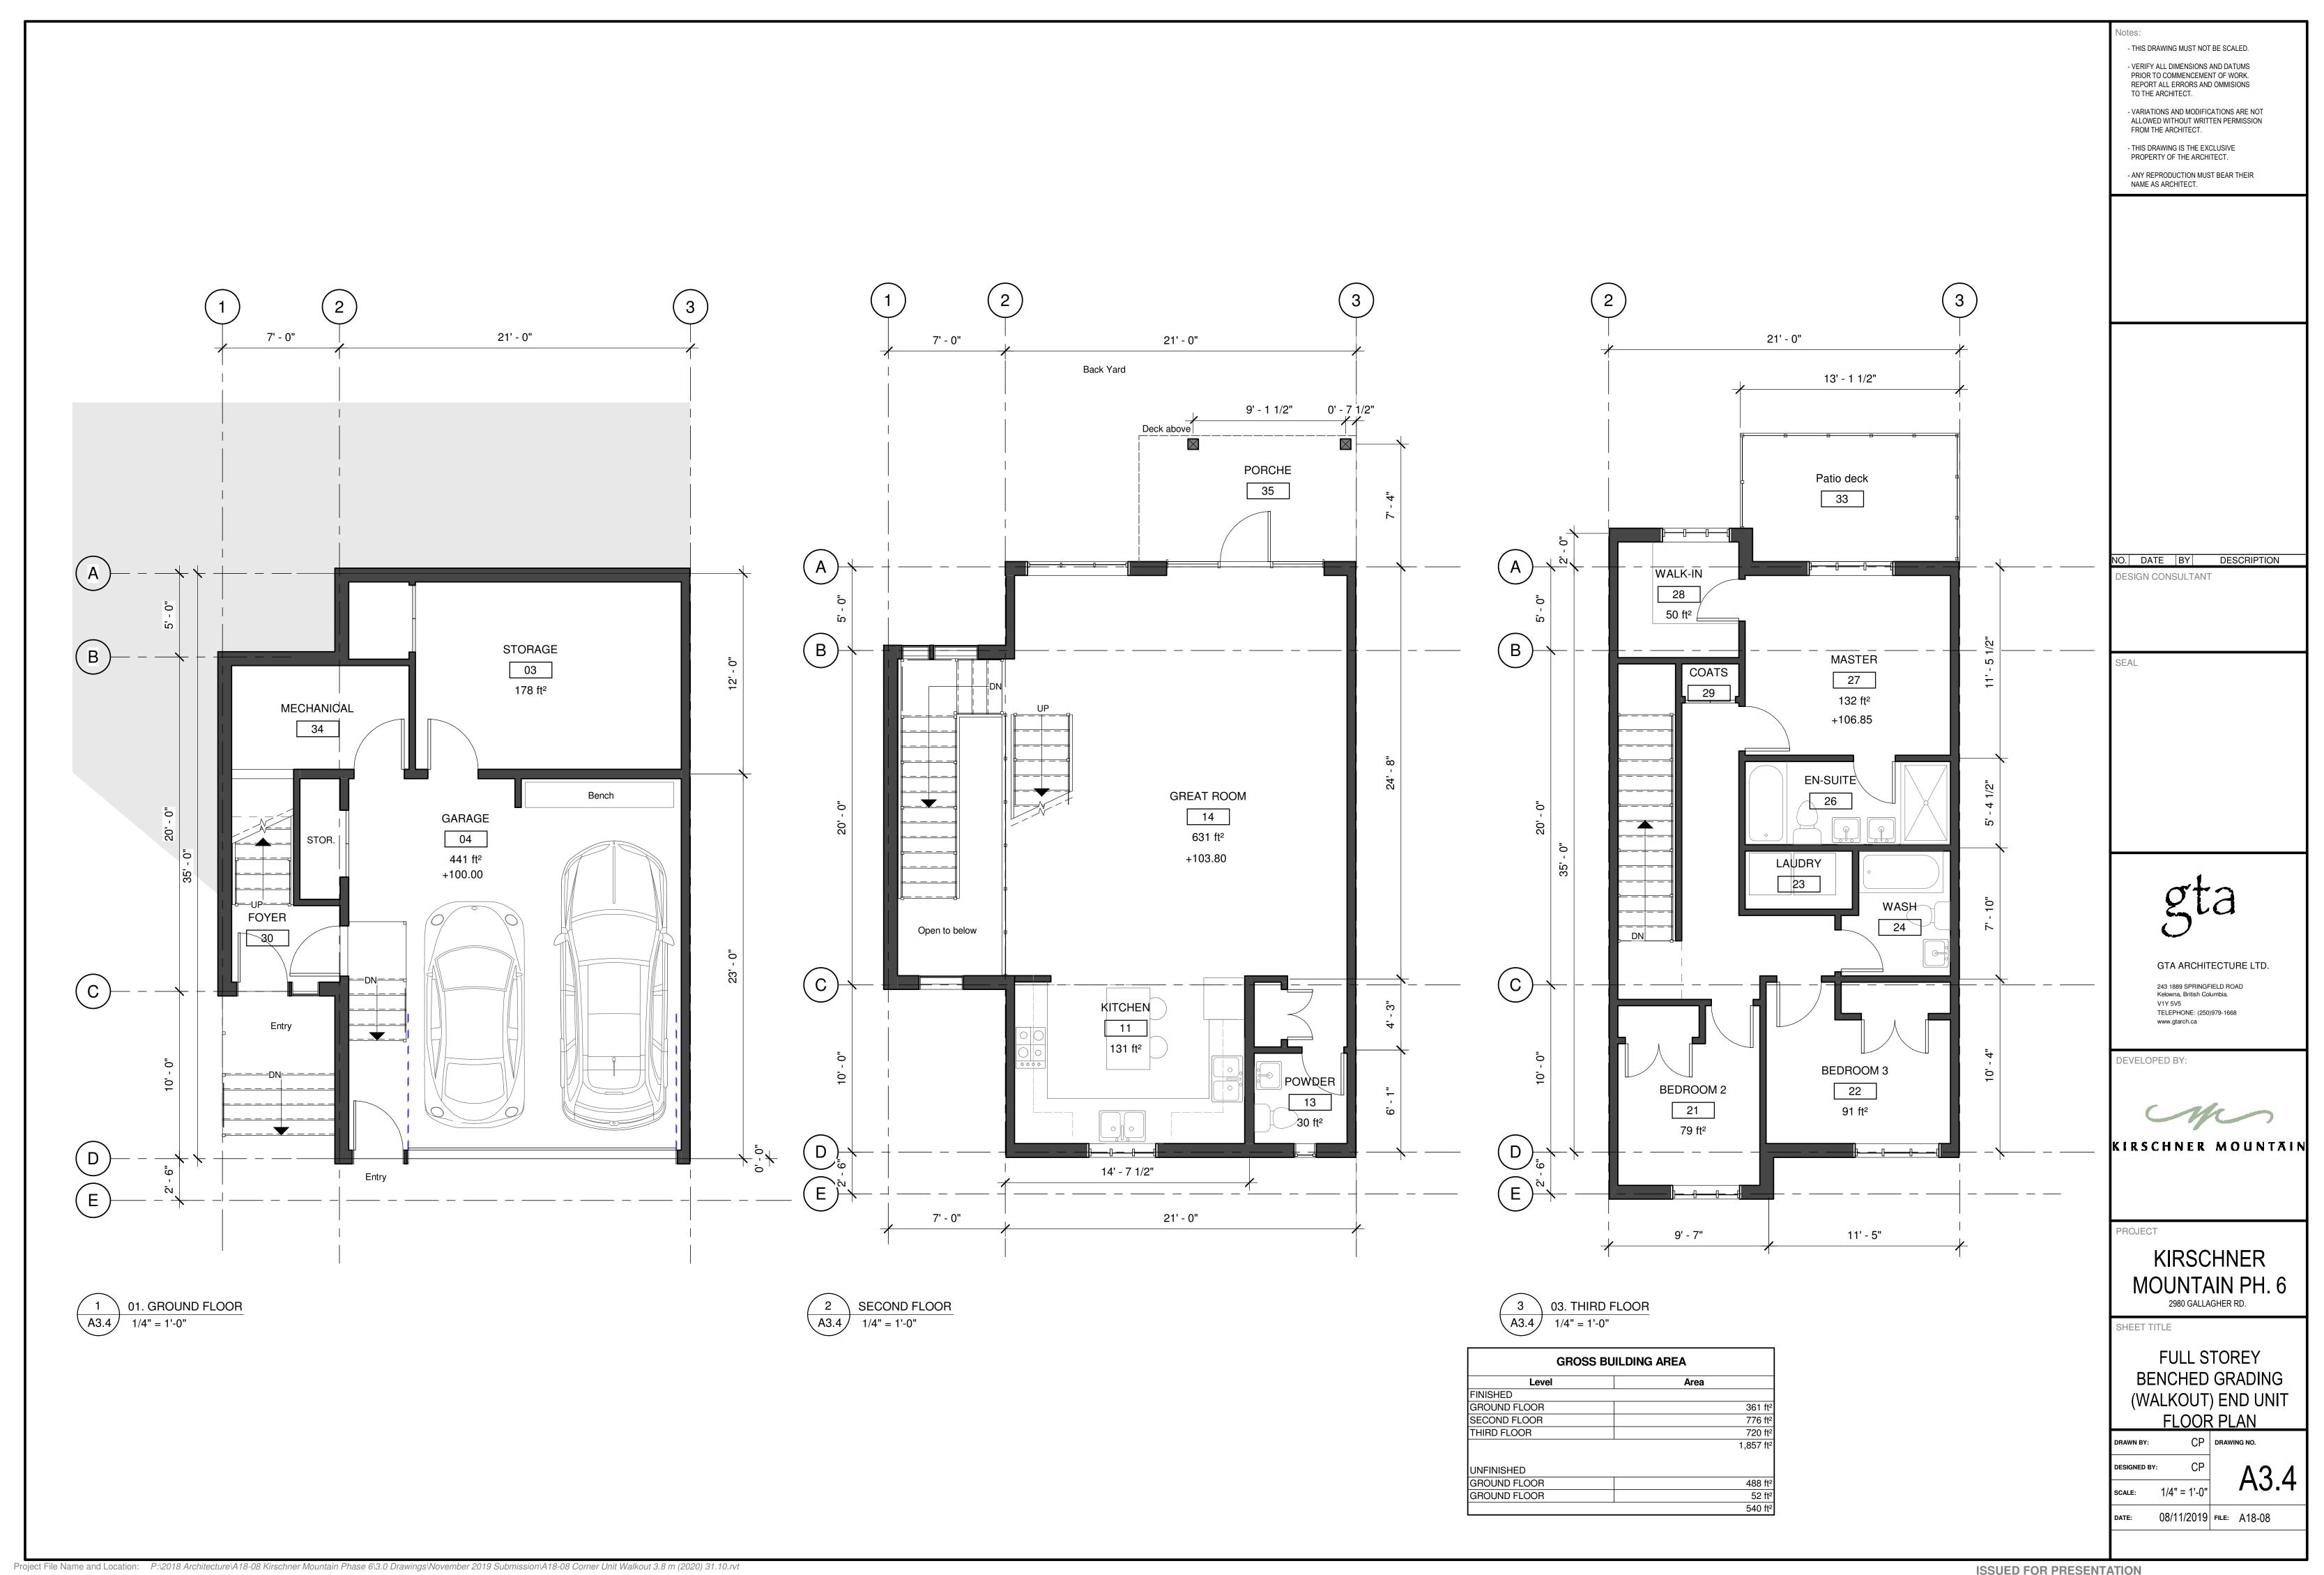

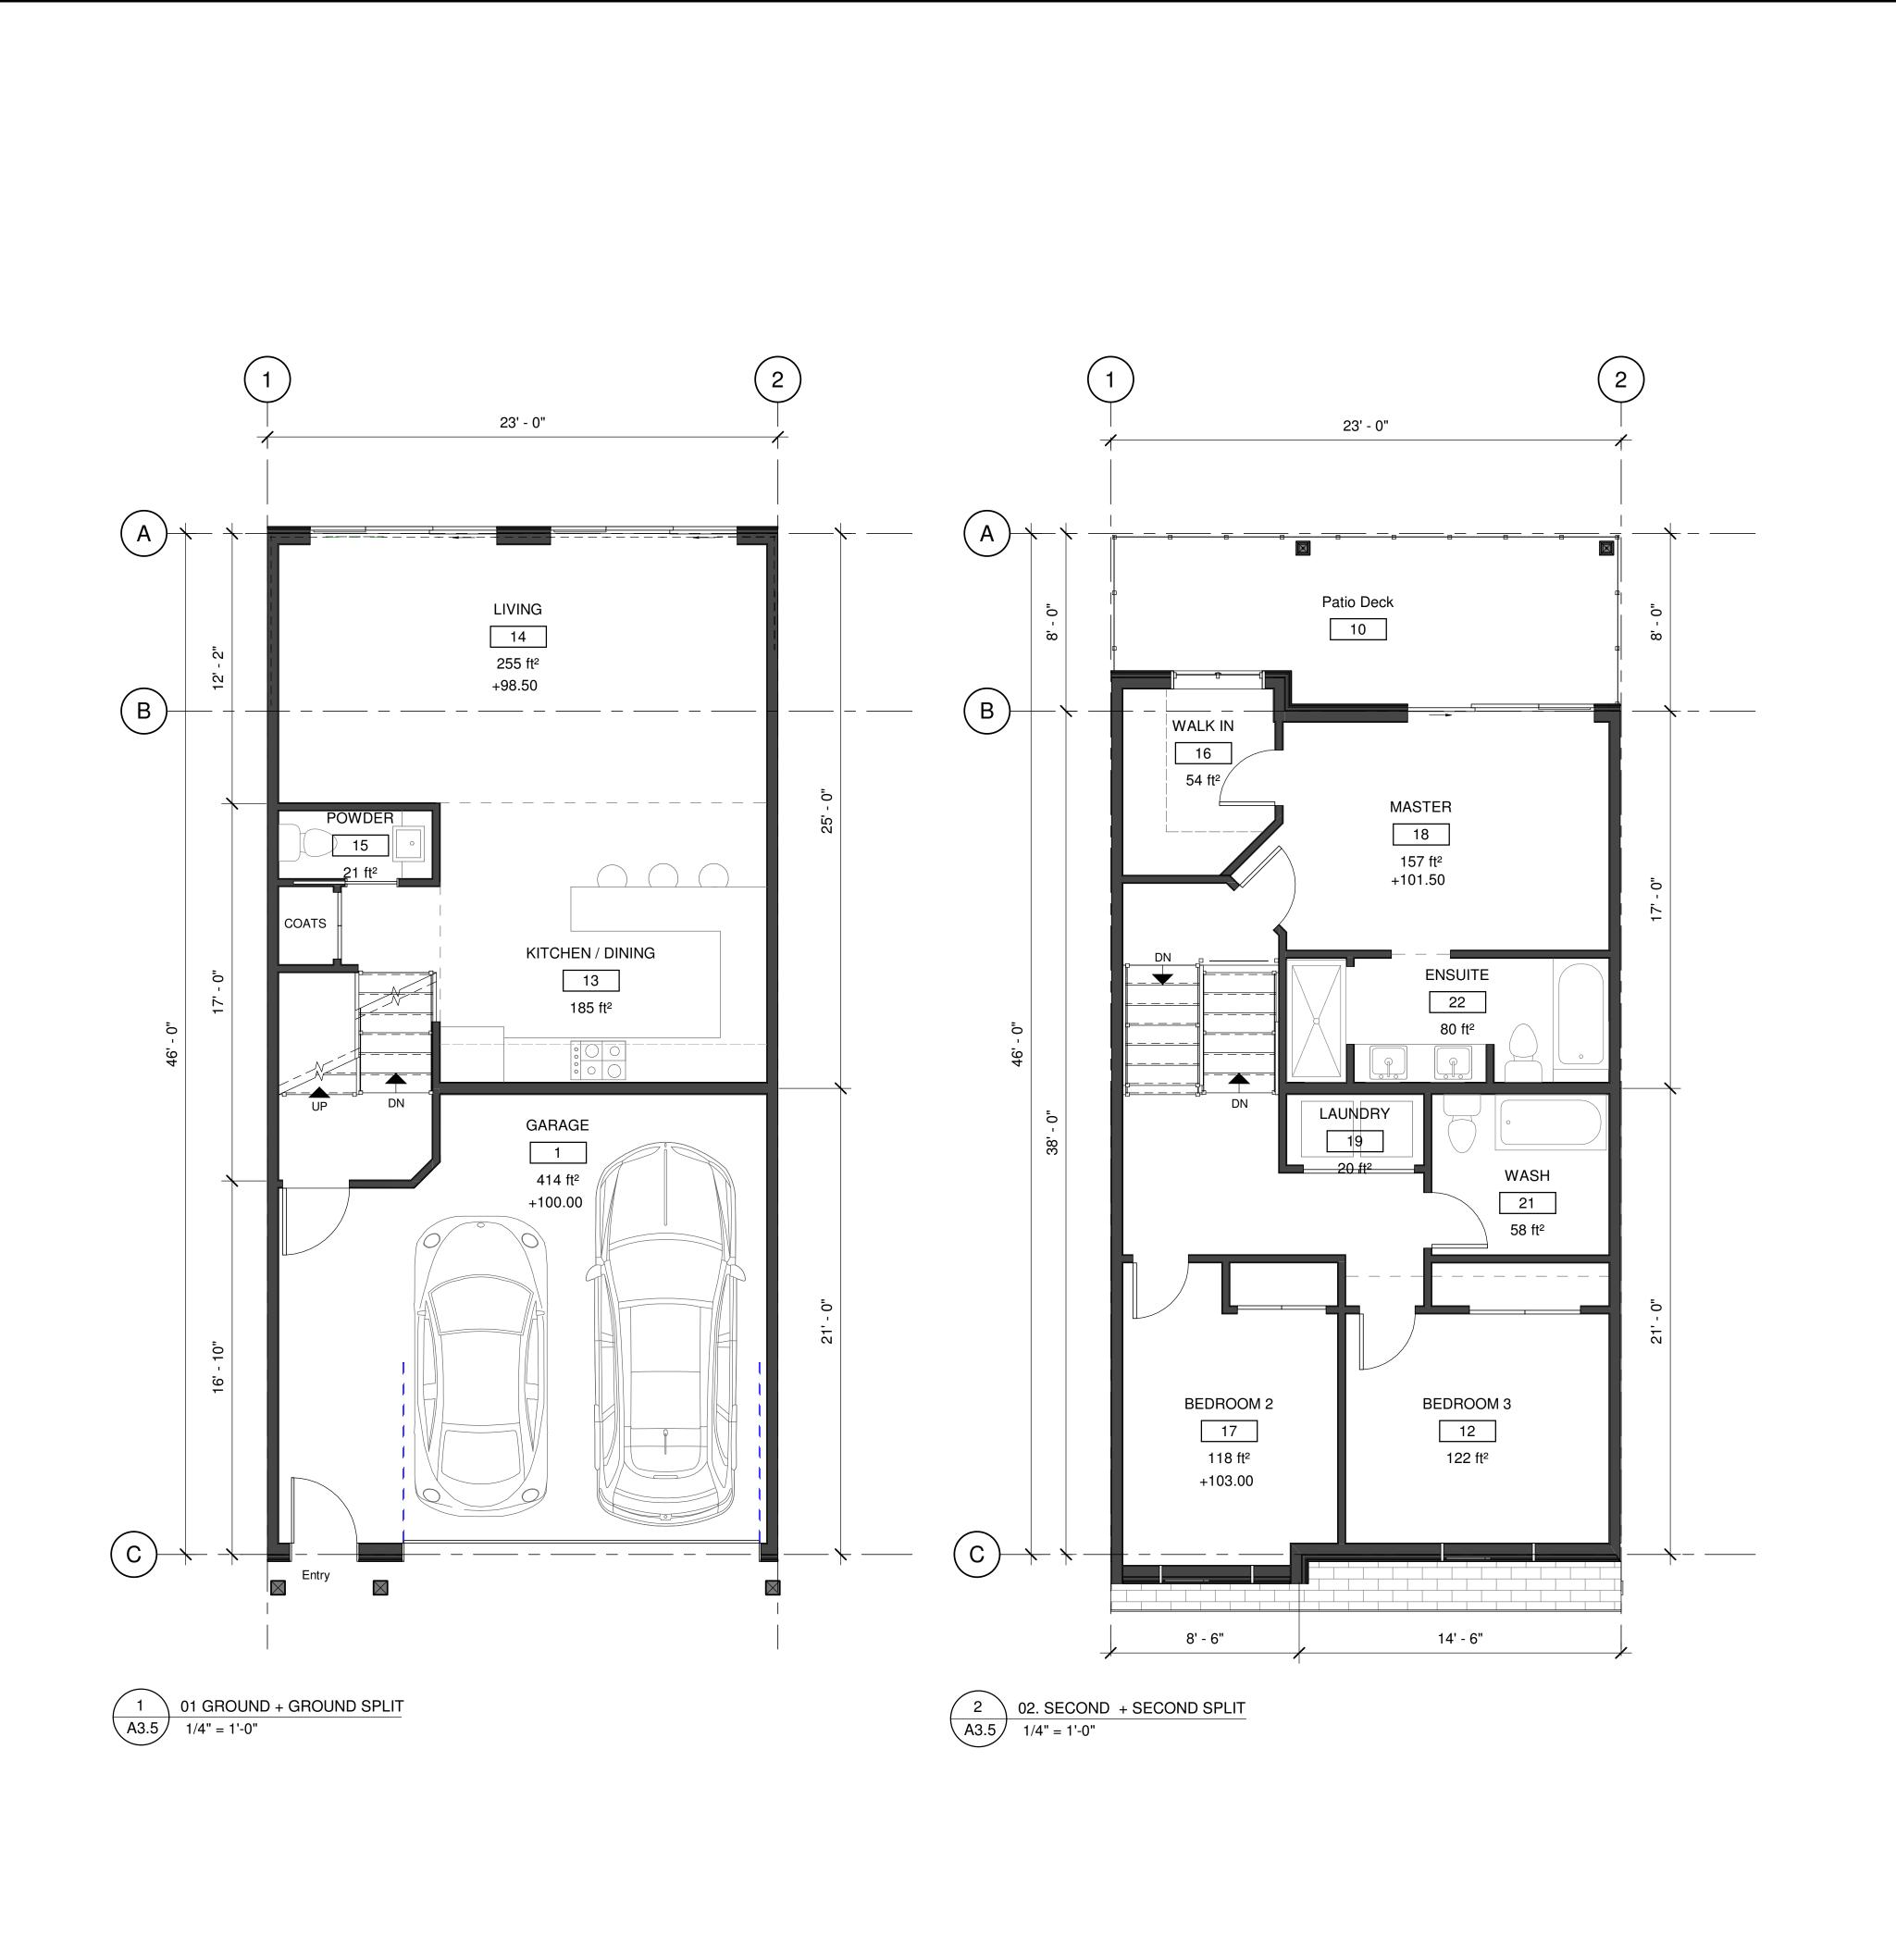

Project File Name and Location: P:\2018 Architecture\A18-08 Kirschner Mountain Phase 6\3.0 Drawings\November 2019 Submission\A18-08 type A Split.rvt

 GROSS BUILDING AREA

 Level
 Area

 FINISHED
 608 ft²

 GROUND FLOOR
 906 ft²

 SECOND FLOOR
 906 ft²


 UNFINISHED
 453 ft²

 GROUND FLOOR
 453 ft²

 453 ft²
 453 ft²

- THIS DRAWING MUST NOT BE SCALED. - VERIFY ALL DIMENSIONS AND DATUMS PRIOR TO COMMENCEMENT OF WORK.
REPORT ALL ERRORS AND OMMISIONS TO THE ARCHITECT. - VARIATIONS AND MODIFICATIONS ARE NOT ALLOWED WITHOUT WRITTEN PERMISSION FROM THE ARCHITECT. - THIS DRAWING IS THE EXCLUSIVE PROPERTY OF THE ARCHITECT. - ANY REPRODUCTION MUST BEAR THEIR NAME AS ARCHITECT. NO. DATE BY DESCRIPTION DESIGN CONSULTANT GTA ARCHITECTURE LTD. 243 1889 SPRINGFIELD ROAD Kelowna, British Columbia. TELEPHONE: (250)979-1668 DEVELOPED BY: KIRSCHNER MOUNTAIN PROJECT KIRSCHNER MOUNTAIN PH. 6 2980 GALLAGHER RD. SHEET TITLE HALF STOREY BENCHED GRADING (SPLIT) MID UNIT FLOOR AW DRAWING NO. 1/4" = 1'-0"

DATE: 08/11/2019 FILE: A18-08

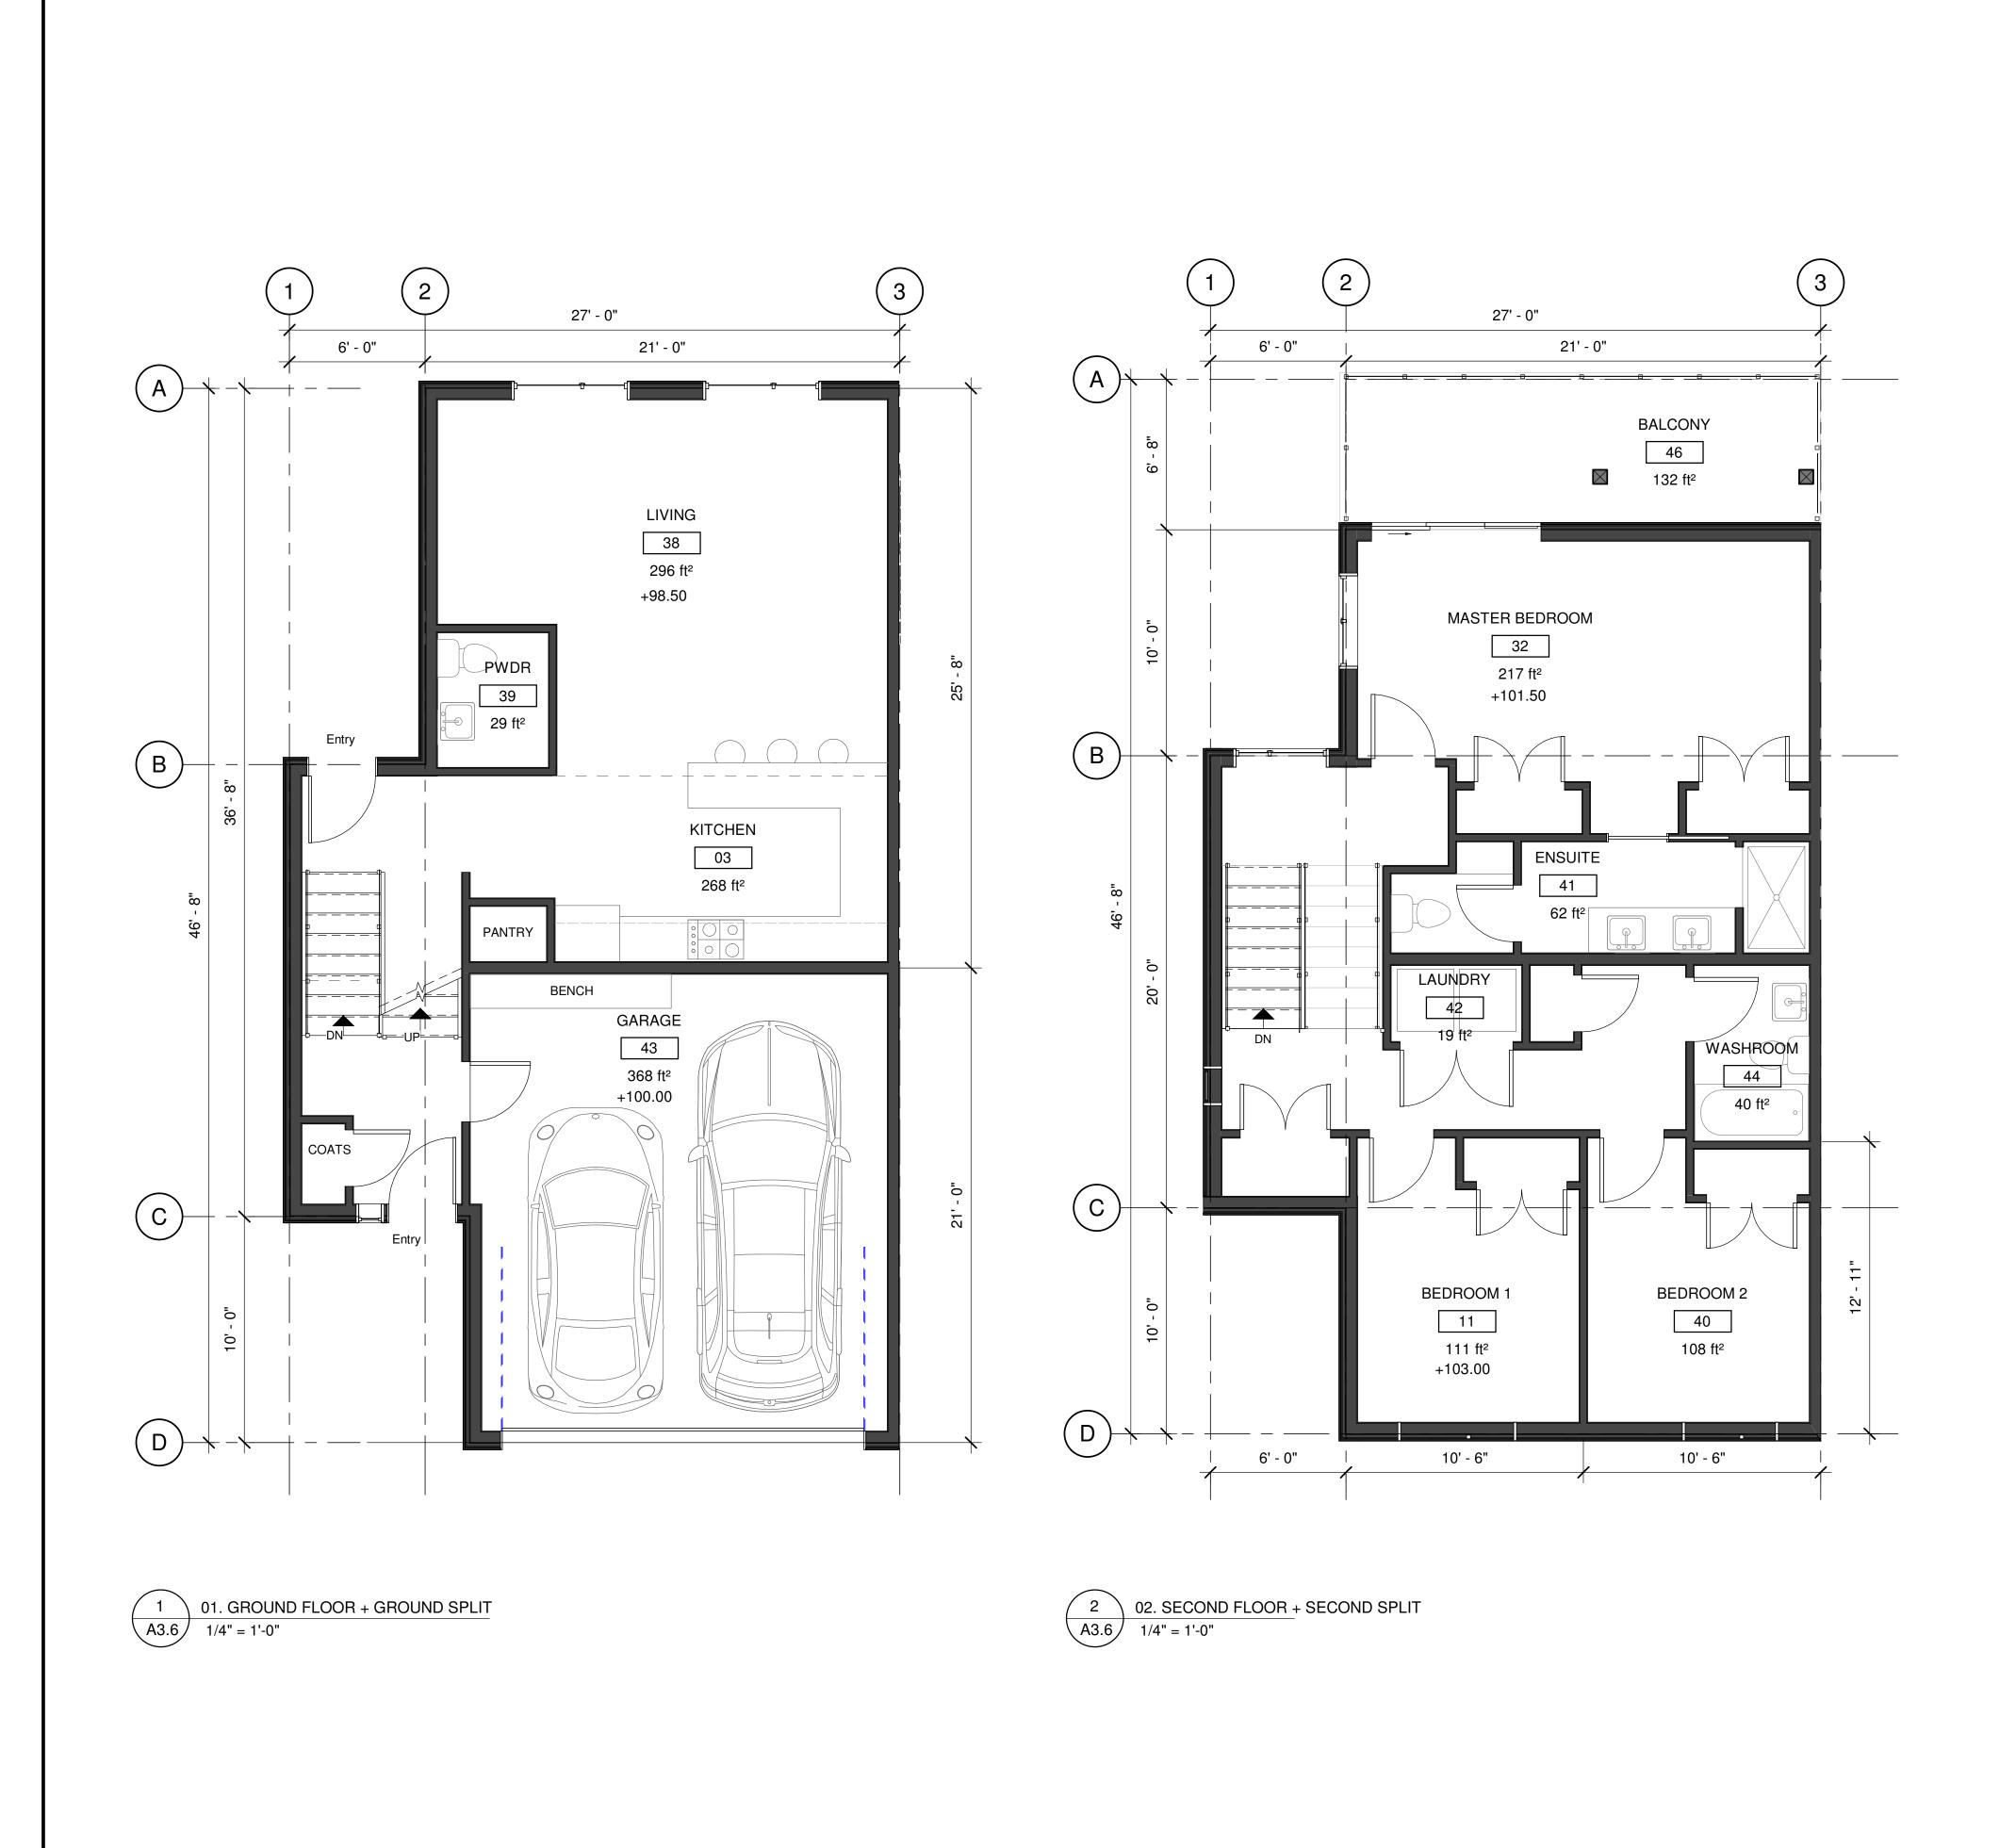

Project File Name and Location: P:\2018 Architecture\A18-08 Kirschner Mountain Phase 6\3.0 Drawings\November 2019 Submission\A18-08 type C Split.rvt

GROSS BUILDING AREA					
Level	Area				
FINISHED					
GROUND FLOOR	690 ft <sup>2</sup>				
SECOND FLOOR	897 ft <sup>2</sup>				
·	1,588 ft²				
UNFINISHED					
GROUND FLOOR	411 ft²				
<u>,                                      </u>	411 ft²				

- VERIFY ALL DIMENSIONS AND DATUMS PRIOR TO COMMENCEMENT OF WORK. REPORT ALL ERRORS AND OMMISIONS TO THE ARCHITECT. - VARIATIONS AND MODIFICATIONS ARE NOT ALLOWED WITHOUT WRITTEN PERMISSION FROM THE ARCHITECT. - THIS DRAWING IS THE EXCLUSIVE PROPERTY OF THE ARCHITECT. - ANY REPRODUCTION MUST BEAR THEIR NAME AS ARCHITECT. NO. DATE BY DESCRIPTION DESIGN CONSULTANT GTA ARCHITECTURE LTD. 243 1889 SPRINGFIELD ROAD Kelowna, British Columbia. TELEPHONE: (250)979-1668 DEVELOPED BY: KIRSCHNER MOUNTAIN PROJECT KIRSCHNER MOUNTAIN PH. 6 2980 GALLAGHER RD. SHEET TITLE HALF STOREY

- THIS DRAWING MUST NOT BE SCALED.

BENCHED GRADING

(SPLIT) END UNIT

**FLOOR PLAN** 

1/4" = 1'-0"

DATE: 08/11/2019 FILE: A18-08

CP DRAWING NO.


LEVELED GRADING / FIVEPLEX - REAR FACADE

B-02

LEVELED GRADING / FIVEPLEX - FRONT FACADE



B-02

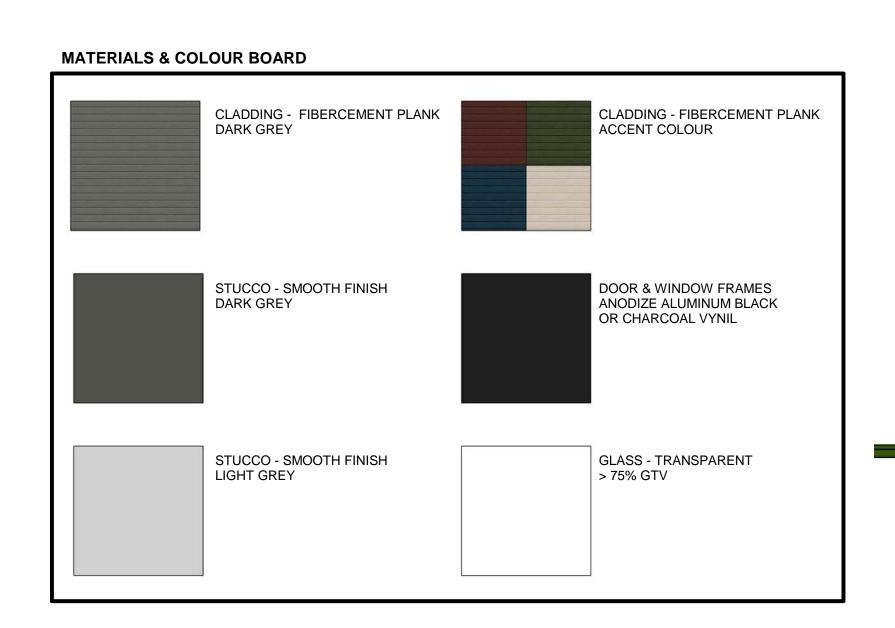



B-03, B-04, B-10, B-11, B12, B13, B14 NOTE: CLADDING ACCENT COLOUR VARIES FROM BUILDING TO BUILDING

LEVELED GRADING / FOURPLEX - FRONT FACADE



B-03, B-04, B-10, B-11, B12, B13, B14 NOTE: CLADDING ACCENT COLOUR VARIES FROM BUILDING TO BUILDING

LEVELED GRADING / FOURPLEX - REAR FACADE

2 08.11.2018 CP FOR CLIENT REVIEW 1 29.03.2018 CP CONCEPT DESIGN NO. DATE BY DESCRIPTION

DESIGN CONSULTANT

GTA ARCHITECTURE LTD.

243 1889 SPRINGFIELD ROAD Kelowna, British Columbia. TELEPHONE: (250)979-1668

DEVELOPED BY:

KIRSCHNER MOUNTAIN

PROJECT

KIRSCHNER MOUNTAIN PH. 6 Enter address here

ELEVATIONS. BUILDINGS ON LEVELED GRADING

DRAWN BY: CP/AW DRAWING NO. 12" = 1'-0" 09/11/19 FILE: 0001

Project File Name and Location: P:\2018 Architecture\A18-08 Kirschner Mountain Phase 6\3.0 Drawings\A18-08 Kirschner Mountain COVER REND ELEV.rvt

- THIS DRAWING MUST NOT BE SCALED. - VERIFY ALL DIMENSIONS AND DATUMS

PRIOR TO COMMENCEMENT OF WORK. REPORT ALL ERRORS AND OMMISIONS TO THE ARCHITECT.

- VARIATIONS AND MODIFICATIONS ARE NOT ALLOWED WITHOUT WRITTEN PERMISSION FROM THE ARCHITECT.

- ANY REPRODUCTION MUST BEAR THEIR

- THIS DRAWING IS THE EXCLUSIVE PROPERTY OF THE ARCHITECT.


NAME AS ARCHITECT.



+103.8 m B-08

FULL STOREY BENCHED GRADING (WALK-OUT) / TRIPLEX SIDE FACADE

B-08

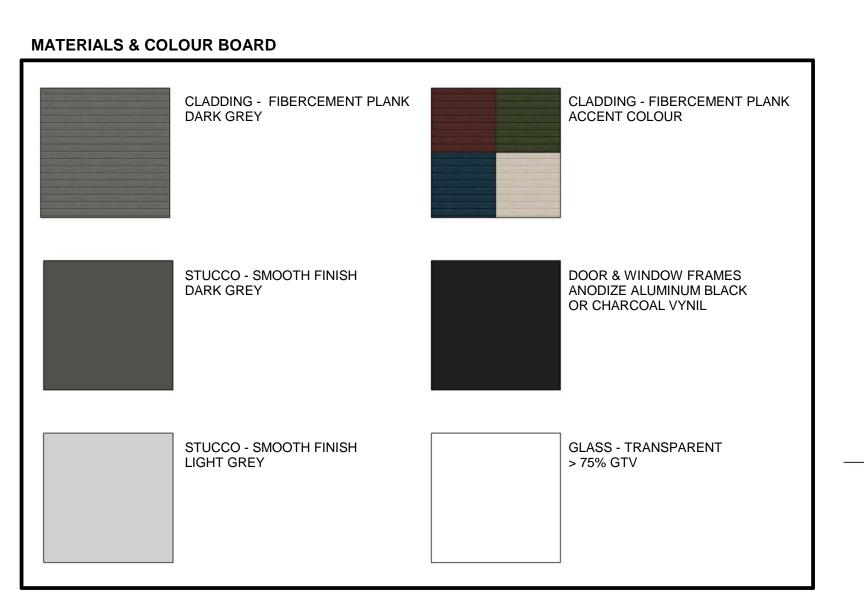



B-06, B-07, B-15, B-16, B-17, B-18, B-19 NOTE: CLADDING ACCENT COLOUR VARIES FROM BUILDING TO BUILDING

FULL STOREY BENCHED GRADING (WALK-OUT) / TRIPLEX - FRONT FACADE



B-06, B-07, B-15, B-16, B-17, B-18, B-19 NOTE: CLADDING ACCENT COLOUR VARIES FROM BUILDING TO BUILDING FULL STOREY BENCHED GRADING (WALK-OUT) / FOURPLEX - REAR FACADE



B-06, B-07, B-15, B-16, B-17, B-18, B-19 NOTE: CLADDING ACCENT COLOUR VARIES FROM BUILDING TO BUILDING

FULL STOREY BENCHED GRADING (WALK-OUT) / FOURPLEX - FRONT FACADE

- THIS DRAWING MUST NOT BE SCALED. - VERIFY ALL DIMENSIONS AND DATUMS PRIOR TO COMMENCEMENT OF WORK.

- VARIATIONS AND MODIFICATIONS ARE NOT ALLOWED WITHOUT WRITTEN PERMISSION FROM THE ARCHITECT.

- ANY REPRODUCTION MUST BEAR THEIR

REPORT ALL ERRORS AND OMMISIONS

- THIS DRAWING IS THE EXCLUSIVE PROPERTY OF THE ARCHITECT.

NAME AS ARCHITECT.

2 08.11.2018 CP FOR CLIENT REVIEW 1 29.03.2018 CP CONCEPT DESIGN

NO. DATE BY DESCRIPTION DESIGN CONSULTANT

GTA ARCHITECTURE LTD.

243 1889 SPRINGFIELD ROAD Kelowna, British Columbia.

TELEPHONE: (250)979-1668

DEVELOPED BY:

KIRSCHNER MOUNTAIN

PROJECT

KIRSCHNER MOUNTAIN PH. 6 Enter address here

ELEVATIONS. **BUILDINGS ON FULL** STOREY BENCHED GRADING (WALK-OUT)

DRAWN BY: Author Drawing No. Designer Designer 12" = 1'-0" 10/11/18 FILE: 0001













- THIS DRAWING MUST NOT BE SCALED.

- VERIFY ALL DIMENSIONS AND DATUMS PRIOR TO COMMENCEMENT OF WORK. REPORT ALL ERRORS AND OMMISIONS

- VARIATIONS AND MODIFICATIONS ARE NOT ALLOWED WITHOUT WRITTEN PERMISSION FROM THE ARCHITECT.

- THIS DRAWING IS THE EXCLUSIVE PROPERTY OF THE ARCHITECT.

- ANY REPRODUCTION MUST BEAR THEIR

2 08.11.2018 CP FOR CLIENT REVIEW 1 29.03.2018 CP CONCEPT DESIGN

NO. DATE BY DESCRIPTION

DESIGN CONSULTANT

TO THE ARCHITECT.

NAME AS ARCHITECT.

GTA ARCHITECTURE LTD.

243 1889 SPRINGFIELD ROAD

Kelowna, British Columbia. TELEPHONE: (250)979-1668

DEVELOPED BY:

KIRSCHNER MOUNTAIN

PROJECT

KIRSCHNER MOUNTAIN PH. 6 Enter address here

SHEET TITLE ELEVATIONS. **BUILDINGS ON HALF** STOREY BENCHED **GRADING (SPLIT)** 

DRAWN BY: Author Drawing No. Designed by: Designer

12" = 1'-0" 10/10/18 FILE: 0001

B-05, B-09 NOTE: CLADDING ACCENT COLOUR VARIES FROM BUILDING TO BUILDING HALF STOREY BENCHED GRADING (SPLIT) / FOURPLEX - REAR FACADE



B-05, B-09 NOTE: CLADDING ACCENT COLOUR VARIES FROM BUILDING TO BUILDING

