CITY OF KELOWNA

MEMORANDUM

Date: November 13, 2019

File No.: Z19-0119

To: Urban Planning Management (AC)

From: Development Engineering Manager (JK)

Subject: 969 Harvey Ave RM5 to RM6

SCHEDULE A

This forms part of application
Z19-0119

City of

Planner Initials

AC

Kelowna

DEVELOPMENT PLANNING

The Development Engineering Department has the following comments and requirements associated with this rezoning application. The road and utility upgrading requirements outlined in this report will be a requirement of this development. The Development Engineering Technologist for this project is Aaron Sangster.

1. General

- a) Where there is a possibility of a high water table or surcharging of storm drains during major storm events, non-basement buildings may be required. This must be determined by the engineer and detailed on the Lot Grading Plan required in the drainage section.
- b) Provide easements as may be required.
- c) This These Development Engineering comments and requirements and are subject to review and or revision for approval by the Ministry of Transportation (MOTI) Infrastructure.

2. <u>Domestic Water and Fire Protection</u>

- a) Property 969 Harvey Ave is currently serviced with a 100mm-diameter water service. The developer's consulting mechanical engineer will determine the domestic, fire protection requirements of this proposed development and establish hydrant requirements and service needs. The applicant will arrange for the removal and disconnection of the existing services and the installation of one new larger service at the applicants cost.
- b) A water meter is mandatory for this development and must be installed inside the building on the water service inlet as required by the City Plumbing Regulation and Water Regulation bylaws. The developer or building contractor must purchase the meter from the City at the time of application for a building permit from the Inspection Services Department, and prepare the meter setter at his cost. Boulevard landscaping, complete with underground irrigation system, must be integrated with the on-site irrigation system
- c) The developer must obtain the necessary permits and have all existing utility services disconnected prior to removing or demolishing the existing structures. The City of Kelowna water meter contractor must salvage existing water meters, prior to building demolition. If water meters are not salvaged, the developer will be invoiced for the meters.



2. <u>Sanitary Sewer</u>

Our records indicate that these properties are currently serviced with a 200mm-diameter sanitary sewer service. The applicant's consulting mechanical engineer will determine the requirements of the proposed development and establish the service needs. Only one service will be permitted for this development. If required, the applicant will arrange for the removal and disconnection of the existing service and the installation of one new larger service at the applicants cost.

3. Storm Drainage

The developer must engage a consulting civil engineer to provide a storm water management plan for this site which meets the requirements of the City Subdivision Development and Servicing Bylaw 7900. The storm water management plan must also include provision of lot grading plans, minimum basement elevations (MBE), if applicable, and provision of a storm drainage service and recommendations for onsite drainage containment and disposal systems

4. Road Improvements

- a) Harvey Ave has been upgraded to an urban standard along the full frontage of this proposed development. No further upgrades are needed at this time.
- b) The laneway standard along the full frontage of this proposed development must be upgraded including a drainage system including catch basins, manholes and pavement removal and replacement, and re-location or adjustment of utility appurtenances if required to accommodate the upgrading construction.
- c) The laneway access on Gagnon PI. requires an improved letdown from the road to the lane. SS-C7 detail shall be used the design.

4. Road Dedication and Subdivision Requirements

- a) Grant Statutory Rights of Way if required for utility services.
- b) If any road dedication or closure affects lands encumbered by a Utility right-of-way (such as Hydro, TELUS, Gas, etc.) please obtain the approval of the utility. Any works required by the utility as a consequence of the road dedication or closure must be incorporated in the construction drawings submitted to the City's Development Manager.

5. Development Permit and Site Related Issues

a) Direct the roof drains into on-site rock pits or splash pads.

6. <u>Electric Power and Telecommunication Services</u>

The electrical and telecommunication services to this building must be installed in an underground duct system, and the building must be connected by an underground service. It is the developer's responsibility to make a servicing application with the respective electric power, telephone and cable transmission companies to arrange for these services, which would be at the applicant's cost.

7. Design and Construction

a) Design, construction supervision and inspection of all off-site civil works and site servicing must be performed by a Consulting Civil Engineer and all such work is



subject to the approval of the City Engineer. Drawings must conform to City standards and requirements.

- b) Engineering drawing submissions are to be in accordance with the City's "Engineering Drawing Submission Requirements" Policy. Please note the number of sets and drawings required for submissions.
- c) Quality Control and Assurance Plans must be provided in accordance with the Subdivision, Development & Servicing Bylaw No. 7900 (refer to Part 5 and Schedule 3).
- d) A "Consulting Engineering Confirmation Letter" (City document 'C') must be completed prior to submission of any designs.
- e) Before any construction related to the requirements of this subdivision application commences, design drawings prepared by a professional engineer must be submitted to the City's Works & Utilities Department. The design drawings must first be "Issued for Construction" by the City Engineer. On examination of design drawings, it may be determined that rights-of-way are required for current or future needs.

8. <u>Servicing Agreement for Works and Services</u>

- a) A Servicing Agreement is required for all works and services on City lands in accordance with the Subdivision, Development & Servicing Bylaw No. 7900. The applicant's Engineer, prior to preparation of Servicing Agreements, must provide adequate drawings and estimates for the required works. The Servicing Agreement must be in the form as described in Schedule 2 of the bylaw.
- b) Part 3, "Security for Works and Services", of the Bylaw, describes the Bonding and Insurance requirements of the Owner. The liability limit is not to be less than \$5,000,000 and the City is to be named on the insurance policy as an additional insured.

9. Survey, Monument and Iron Pins

If any legal survey monuments or property iron pins are removed or disturbed during construction, the developer will be invoiced a flat sum of \$1,200.00 per incident to cover the cost of replacement and legal registration. Security bonding will not be released until restitution is made.

10. **Geotechnical Report**

As a requirement of this application the owner must provide a geotechnical report prepared by a Professional Engineer qualified in the field of hydro-geotechnical survey to address the following:

- a) Area ground water characteristics.
- b) Site suitability for development, unstable soils, etc.
- c) Drill and / or excavate test holes on the site and install pisometers if necessary. Log test hole data to identify soil characteristics, identify areas of fill if any. Identify unacceptable fill material, analyse soil sulphate content, identify unsuitable underlying soils such as peat, etc. and make recommendations for remediation if necessary.
- d) List extraordinary requirements that may be required to accommodate construction of roads and underground utilities as well as building foundation designs.

e) Additional geotechnical survey may be necessary for building foundations, etc.

11. Charges and Fees

- a) Development Cost Charges (DCC's) are payable.
- b) Fees per the "Development Application Fees Bylaw" include:
 - i. Street/Traffic Sign Fees: at cost if required (to be determined after design).
 - ii. Survey Monument, Replacement Fee: \$1,200.00 (GST exempt) only if disturbed.
- c) Engineering and Inspection Fee: 3.5% of construction value (plus GST).

James Kay, P. Eng.

Development Engineering Manager

AS



CITY OF KELOWNA

MEMORANDUM

Date: November 13, 2019

File No.: OCP19-0009

To: Urban Planning Management (AC)

From: Development Engineer Manager (JK)

Subject: 969 Harvey Ave.

The Development Engineering comments and requirements regarding An Official Community Plan (OCP) Amendment to change the Future Land Use from MRM designation to MRH designation to facilitate a proposed six story multi-family bulding.

1. General.

- a) This application does not compromise any Municipal services.
- b) For Development Engineering servicing requirements refer to file Z19-0119

James Kay James Kay, P.Eng. Development Engineering Manager

AS



CONSULTANTS:

<u>ARCHITECTURAL</u> NOVATIONARCHITECTURE 302-2237 LECKIE ROAD KELOWNA. BC V1Y 9T1 TEL. (236) 420-4144 FAX. (250) 000-0000

LANDSCAPE OUTLAND DESIGN 303-590 KLO ROAD KELOWNA. BC V1Y 7S2

TEL. (250) 868-9270

FAX. (250) 763-0321

SURVEY FERGUSON LAND SURVEYOR 404-1630 PANDOSY STREET KELOWNA. BC V1Y 1P7 TEL. (250) 763-3115

DRAWING INDEX:

ARCHITECTURAL DRAWING LIST

	ARCHITECTURAL DRAWIN
NO.	NAME
A0.00	COVER SHEET
A0.01	VISUALIZATIONS
A0.02	VISUALIZATIONS
A1.01	SITE PLAN - PARKADE
A1.02	SITE PLAN - ROOF
A2.00	PARKADE FLOOR PLAN
A2.01	LEVEL 1 FLOOR PLAN
A2.02	LEVEL 2 FLOOR PLAN
A2.03	LEVEL 3 FLOOR PLAN
A2.04	LEVEL 4 FLOOR PLAN
A2.05	LEVEL 5 F LOOR PLAN
A2.06	LEVEL 6 FLOOR PLAN
A2.07	ROOF PLAN
A3.01	ELEVATIONS
A3.02	ELEVATIONS
A3.03	ELEVATIONS
A4.01	BUILDING SECTIONS

ZONING ANALYSIS:

Legal:

969 Harvey Ave, Kelowna, B.C. Address: PID: 003-567-257 Lot A KAP 31933 Parcel Coverage Maximum 50% (Proposed 70%) (Building, Parking and Driveways) Zoning (Current): RM5 Maximum # of dwelling units

Permitted Use: Refer to Zoning bylaw #8000 Zoning: (Proposed) RM6 Refer to Zoning bylaw #8000 section 13.12 Permitted Use:

7,218.0 sq.m. 77,696 sq.ft. Site Area: 0.7218 Ha

Min Lot Width Min Lot Depth Min Parcel Size

Setbacks ront yard parking Side yard/Flanking 6.0 m 4.5 m 3.6 m 9.0 m 9.1 m Side yard

LANDSCAPE BUFFER Front Side Or Continuous Opaque Barrier 3.0 m 9.84 ft

Lesser of 55m or 16 storeys Height New Private 12 sq.m. per 1 bedroom unit Open Space

Building Foot Print

(6 Units) 18 sq.m. per 2 or more bedroom unit (34 Units) Common open space or Multi-residential shared garden Total

Floor Area Ratio 1.5 + .19 (F.A.R. Bonus) = 1.69 max (12,198 m²)

Resident: 1.25 per 1 bedroom dwelling (6 units) Resident: 1.5 per 2 bedroom dwelling (1 units) Resident: 2.0 per 3 bedroom dwelling (33 units) Existing: 1.25 per 1 bedroom dwelling (5 units) Existing: 1.5 per 2 bedroom dwelling (55 units) Existing: 2.0 per 3 bedroom dwelling (4 units) Visitor: 0.14 per dwelling unit (104 units)

New Regular Size Existing Regular Size Regular Size (6m x 2.5m) 50% = 86 stalls min. Medium (4.8m x 2.3m) 50% = 86 stalls max.

F.A.R. Bonus New: 36 covered parking

Total:

Short-term - 6 per entry + 1 per 5 units over 70 Bonus Long-term - 1.0 per 1 bedroom unit (6) Bonus Long-term - 1.5 per 2 bedroom unit (1) Bonus Long-term - 2.0 per 3 bedroom unit (33) *50% of required stalls are horizontal

Existing: 92 covered parking

Existing Building = 6,754 m² approx. Proposed Building = 4,434 m² Parking (Level 1 Typical Floo 8,073 sq.ft. 5,651 sq.ft. Residential Typical Floo Residential Main Floo 2,422 sq.ft. 7,772 sq.ft. 7,664 sq.ft. CRU Main Floor

Residential Fifth Floo

Residential Sixth Floor

 sq.m.
 44.4
 sq.m.

 sq.ft.
 477.9
 sq.ft.

 sq.m.
 464.4
 sq.m.

 sq.ft.
 4998.9
 sq.ft.
 720.0 7750.3 774.3 sq.m. 8334.8 sq.ft.

1.5 spaces 66.0 spaces 6.0 spaces 82.5 spaces 8.0 spaces 14.5 spaces 10% for rental housing -19.0 spaces 5 stalls from bike parking -5.0 spaces (104 units) Total Required 162 spaces

20 spaces 97 spaces 117 spaces 26 spaces 143 spaces 133 / 143 stalls provided to get 93% factor, then

66 spaces

87 spaces

multiply 93% to .2 = 0.19 for F.A.R. bonus 13 spaces 6 spaces 1.5 spaces

CONTEXT SITE PLAN:





ILLUSTRATIONS:





ISSUED FOR DP

© Copyright Reserved. This drawing and designis, and at all times remains, the property of NOvation Architecture, and can be

All drawings shall be read in conjunction with specifications and

All work shall be carried outinaccordancewith Canadian

Tabulated scales refer to Arch D size drawings sheet.

standards, spedifications, BC Building Code (2018 edition) and

Contractors shall verify all dimensions prior to commencement of

Any omissions or discrepancies shall be reported to the architect.

2020-01-21

NOT controlled. Revisions may be made without notice.

The first issue of the document.

A CONTROLLED document. Revisions

A complete revision. Remove previous issues from use.

A partial revision. Remove previous

NOT FOR CONSTRUCTION

issues of corresponding sheets / pages

reproduced only with written consent.

lo cal authority by-laws and regulations.

This drawing must not be scaled.

this document is:

will be advised.

Not for Construction.

consultant details.



302 - 2237 LECKIE ROAD KELOWNA BC V1X 6Y5

969 HARVEY AVENUE LOT A DISTRICT LOT 138 ODYD PLAN 31933 EXCEPT PLAN 36604

KELOWNA, BRITISH COLUMBIA

drawing title

oject no. 1821

COVER SHEET

21/01/2020 10:38:27 AM

Project File Name and Location: \\SERVER1\shared\Novation Design Studio\Projects\1821_969 Harvey Ave\Working Drawings\Revit\dwg\Harvey Ave.rvt





ATTACHMENT B This forms part of application # OCP19-0009 / Z19-0119


© Copyright Reserved. This drawing and design is, and at all times remains, the property of NOvation Architecture, and can be reproduced only with written consent.

All drawings shall be read in conjunction with specifications and consultant details. All work shall be carried out in a ccordance with Canadian standards, specifications, BC Building Code (2018 edition) and local authority by-laws and regulations.

Tabulated scales refer to Arch D size drawings sheet.

This drawing must not be scaled. Contractors shall verify all dimensions prior to commencement of

Any omissions or discrepancies shall be reported to the architect.

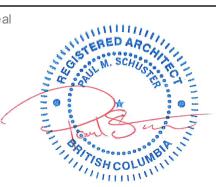

2020-01-21

this document is:

NOT controlled. Revisions may be made without notice.

A CONTROLLED document. Revisions will be advised.

The first issue of the document.

A complete revision. Remove previous issues from use.

A partial revision. Remove previous issues of corresponding sheets / pages from use.

Not for Construction.

NOT FOR CONSTRUCTION

20190930 ISSUED FOR DP

Revisions

302 - 2237 LECKIE ROAD KELOWNA BC V1X 6Y5

969 HARVEY AVENUE LOT A DISTRICT LOT 138 ODY D PLAN 31933 EXCEPT PLAN 36604


KELOWNA, BRITISH COLUMBIA

project no. 1821

drawing title VISUALIZATIONS

21/01/2020 10:38:28 AM



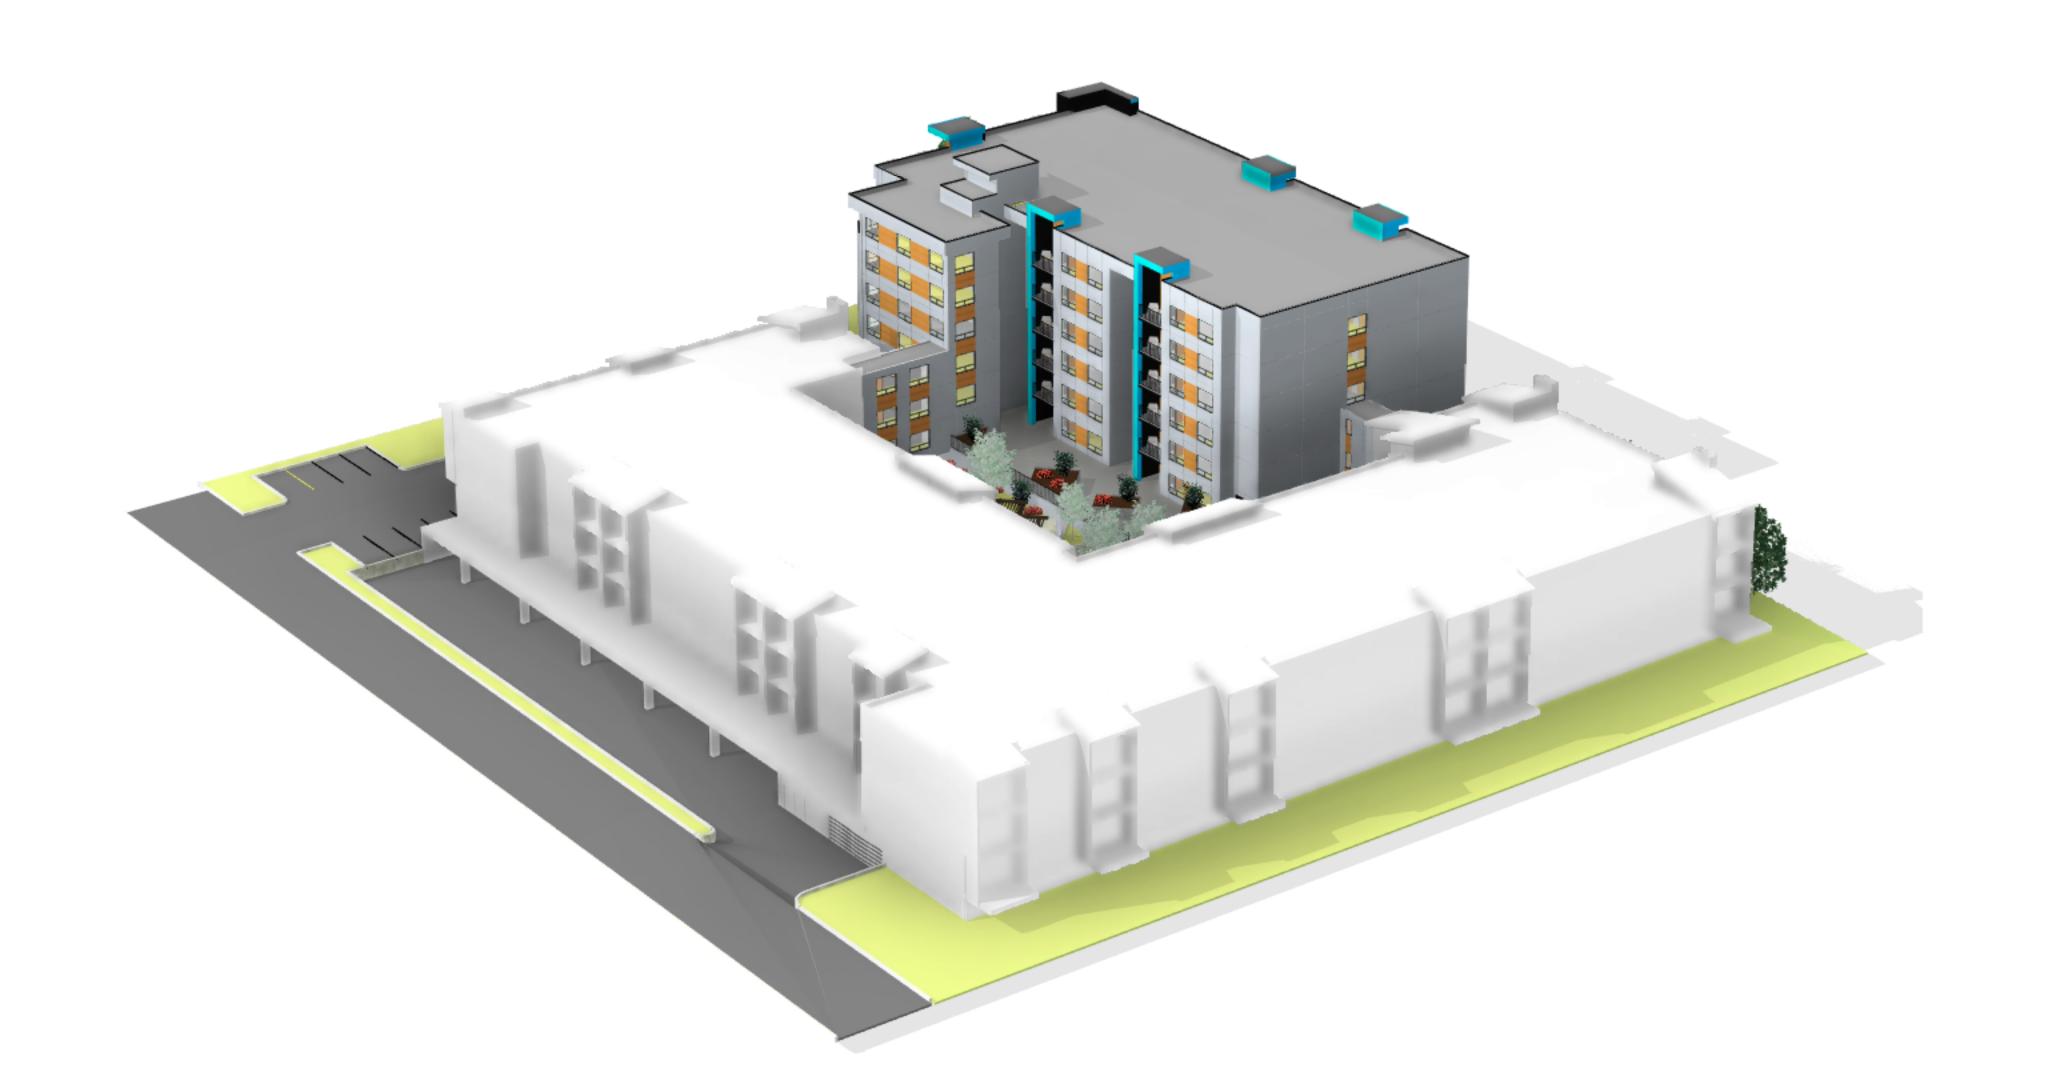

ATTACHMENT B

This forms part of application
OCP19-0009 / Z19-0119
City of

Planner Initials

AC

Relowna

Notes:
© Copyright Reserved. This drawing and design is, and at all times remains, the property of NOvation Architecture, and can be reproduced only with written consent.

All drawings shall be read in conjunction with specifications and consultant details.

All work shall be carried out in a ccordance with Canadian standards, specifications, BC Building Code (2018 edition) and local authority by-laws and regulations.


lo cal authority by-laws and regulations.

Tabulated scales refer to Arch D size drawings sheet.

This drawing must not be scaled.

Contractors shall verify all dimensions prior to commencement of

Any omissions or discrepancies shall be reported to the architect.

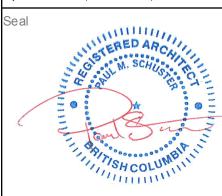

2020-01-21

this document is:

NOT controlled. Revisions may be made without notice.

A CONTROLLED document. Revisions will be advised.

The first issue of the document.

A complete revision. Remove previous issues from use.

A partial revision. Remove previous issues of corresponding sheets / pages from use.

Not for Construction.

NOT FOR CONSTRUCTION

1 20190930 ISSUED FOR DP

Date Descrip

OVATION ARCHITECTURE

302-2237 LECKIE ROAD KELOWNA BC VIX 6Y5

project ti

969 HARVEY AVENUE

LOT A DISTRICT LOT 138 ODYD PLAN 31933

EXCEPT PLAN 36604

KELOWNA, BRITISH COLUMBIA

project no. 1821

drawing title
VISUALIZATIONS

designed PS scale

drawn BD

checked DS


drawing no

A0.02

21/01/2020 10:39:17 AM





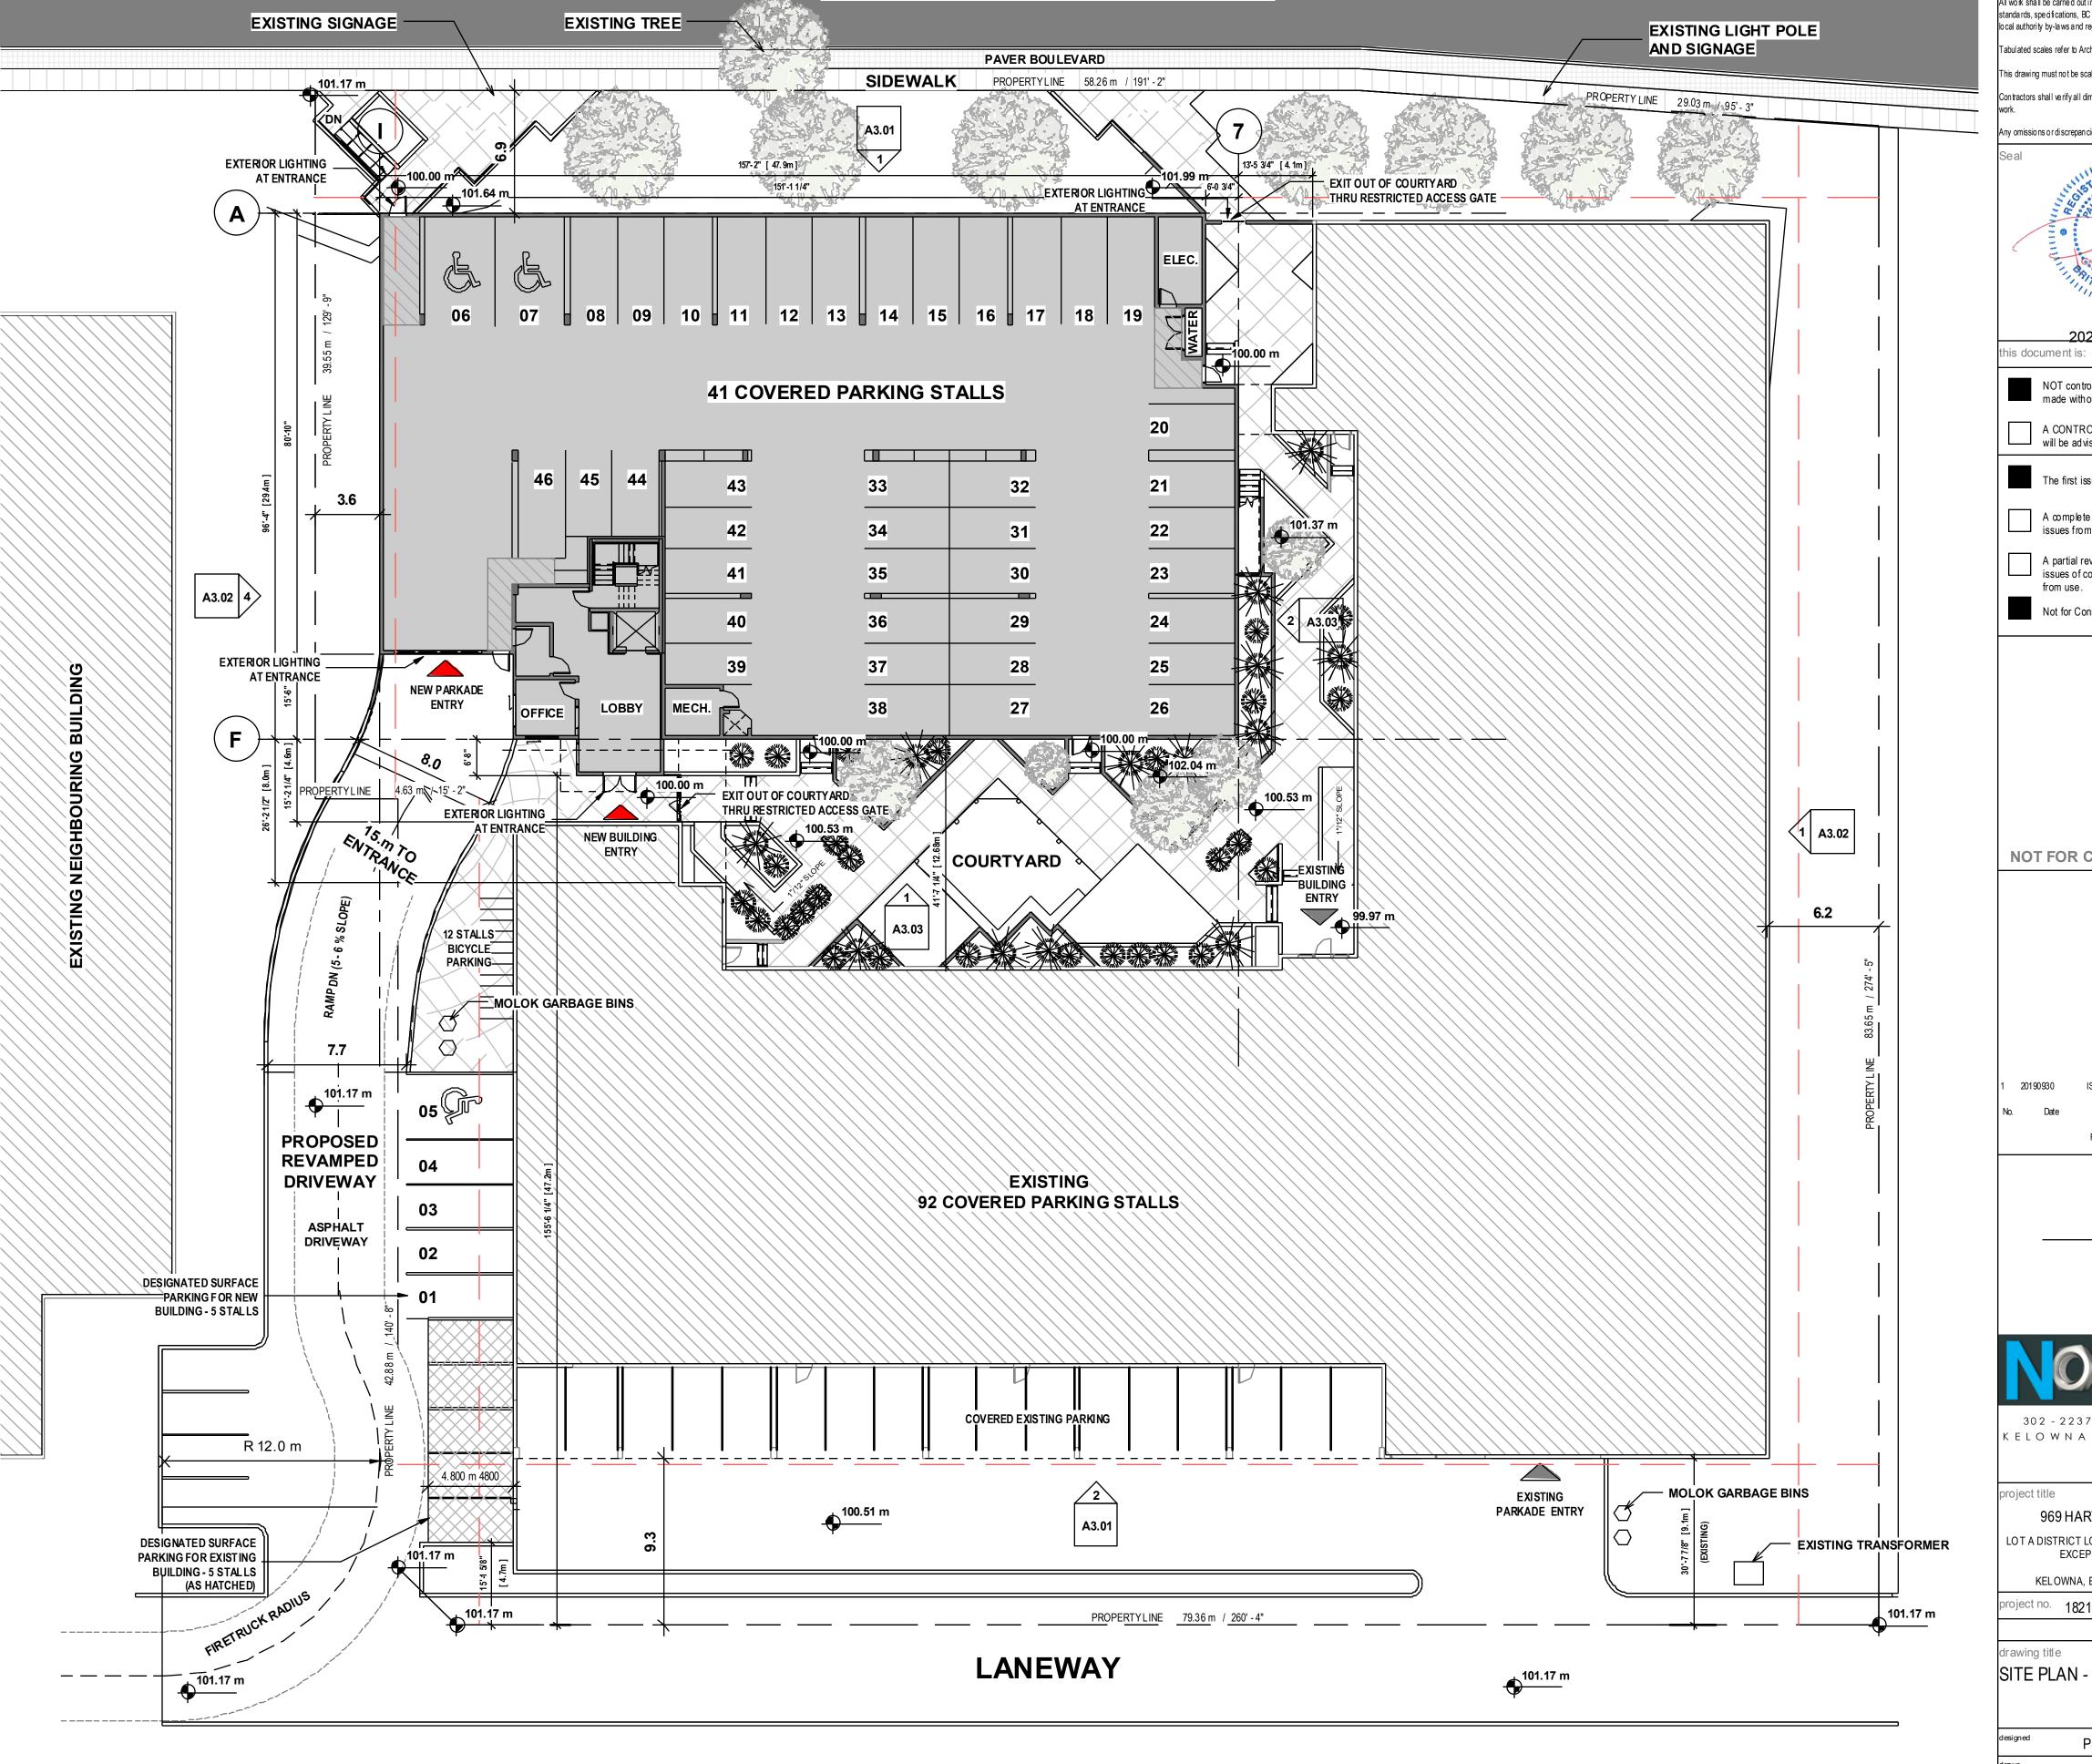

HARVEY AVENUE / HIGHWAY 97

ATTACHMENT B This forms part of application
OCP19-0009 / Z19-0119

Site Plan - ParkadeSITE AREA = 7,225m²

Project File Name and Location: \\SERVER1\shared\Novation Design Studio\Projects\1821_969 Harvey Ave\Working Drawings\Revit\dwg\Harvey Ave.rvt

All drawings shall be read in conjunction with specifications and

© Copyright Reserved. This drawing and design is, and at all times remains, the property of NOvation Architecture, and can be

All work shall be carried outinaccordancewith Canadian standards, specifications, BC Building Code (2018 edition) and lo cal authority by-laws and regulations.

reproduced only with written consent.

Tabulated scales refer to Arch D size drawings sheet. This drawing must not be scaled.

on tractors shall verify all dimensions prior to commencement of



NOT controlled. Revisions may be made without notice.

A CONTROLLED document. Revisions will be advised.

The first issue of the document. A complete revision. Remove previous issues from use.

A partial revision. Remove previous issues of corresponding sheets / pages

Not for Construction.

NOT FOR CONSTRUCTION

ISSUED FOR DP 20190930

KELOWNA BC V1X 6Y5

969 HARVEY AVENUE LOT A DISTRICT LOT 138 ODYD PLAN 31933 EXCEPT PLAN 36604


KELOWNA, BRITISH COLUMBIA roject no. 1821

SITE PLAN - PARKADE

PS scale As indicated

A1.01

21/01/2020 10:39:31 AM

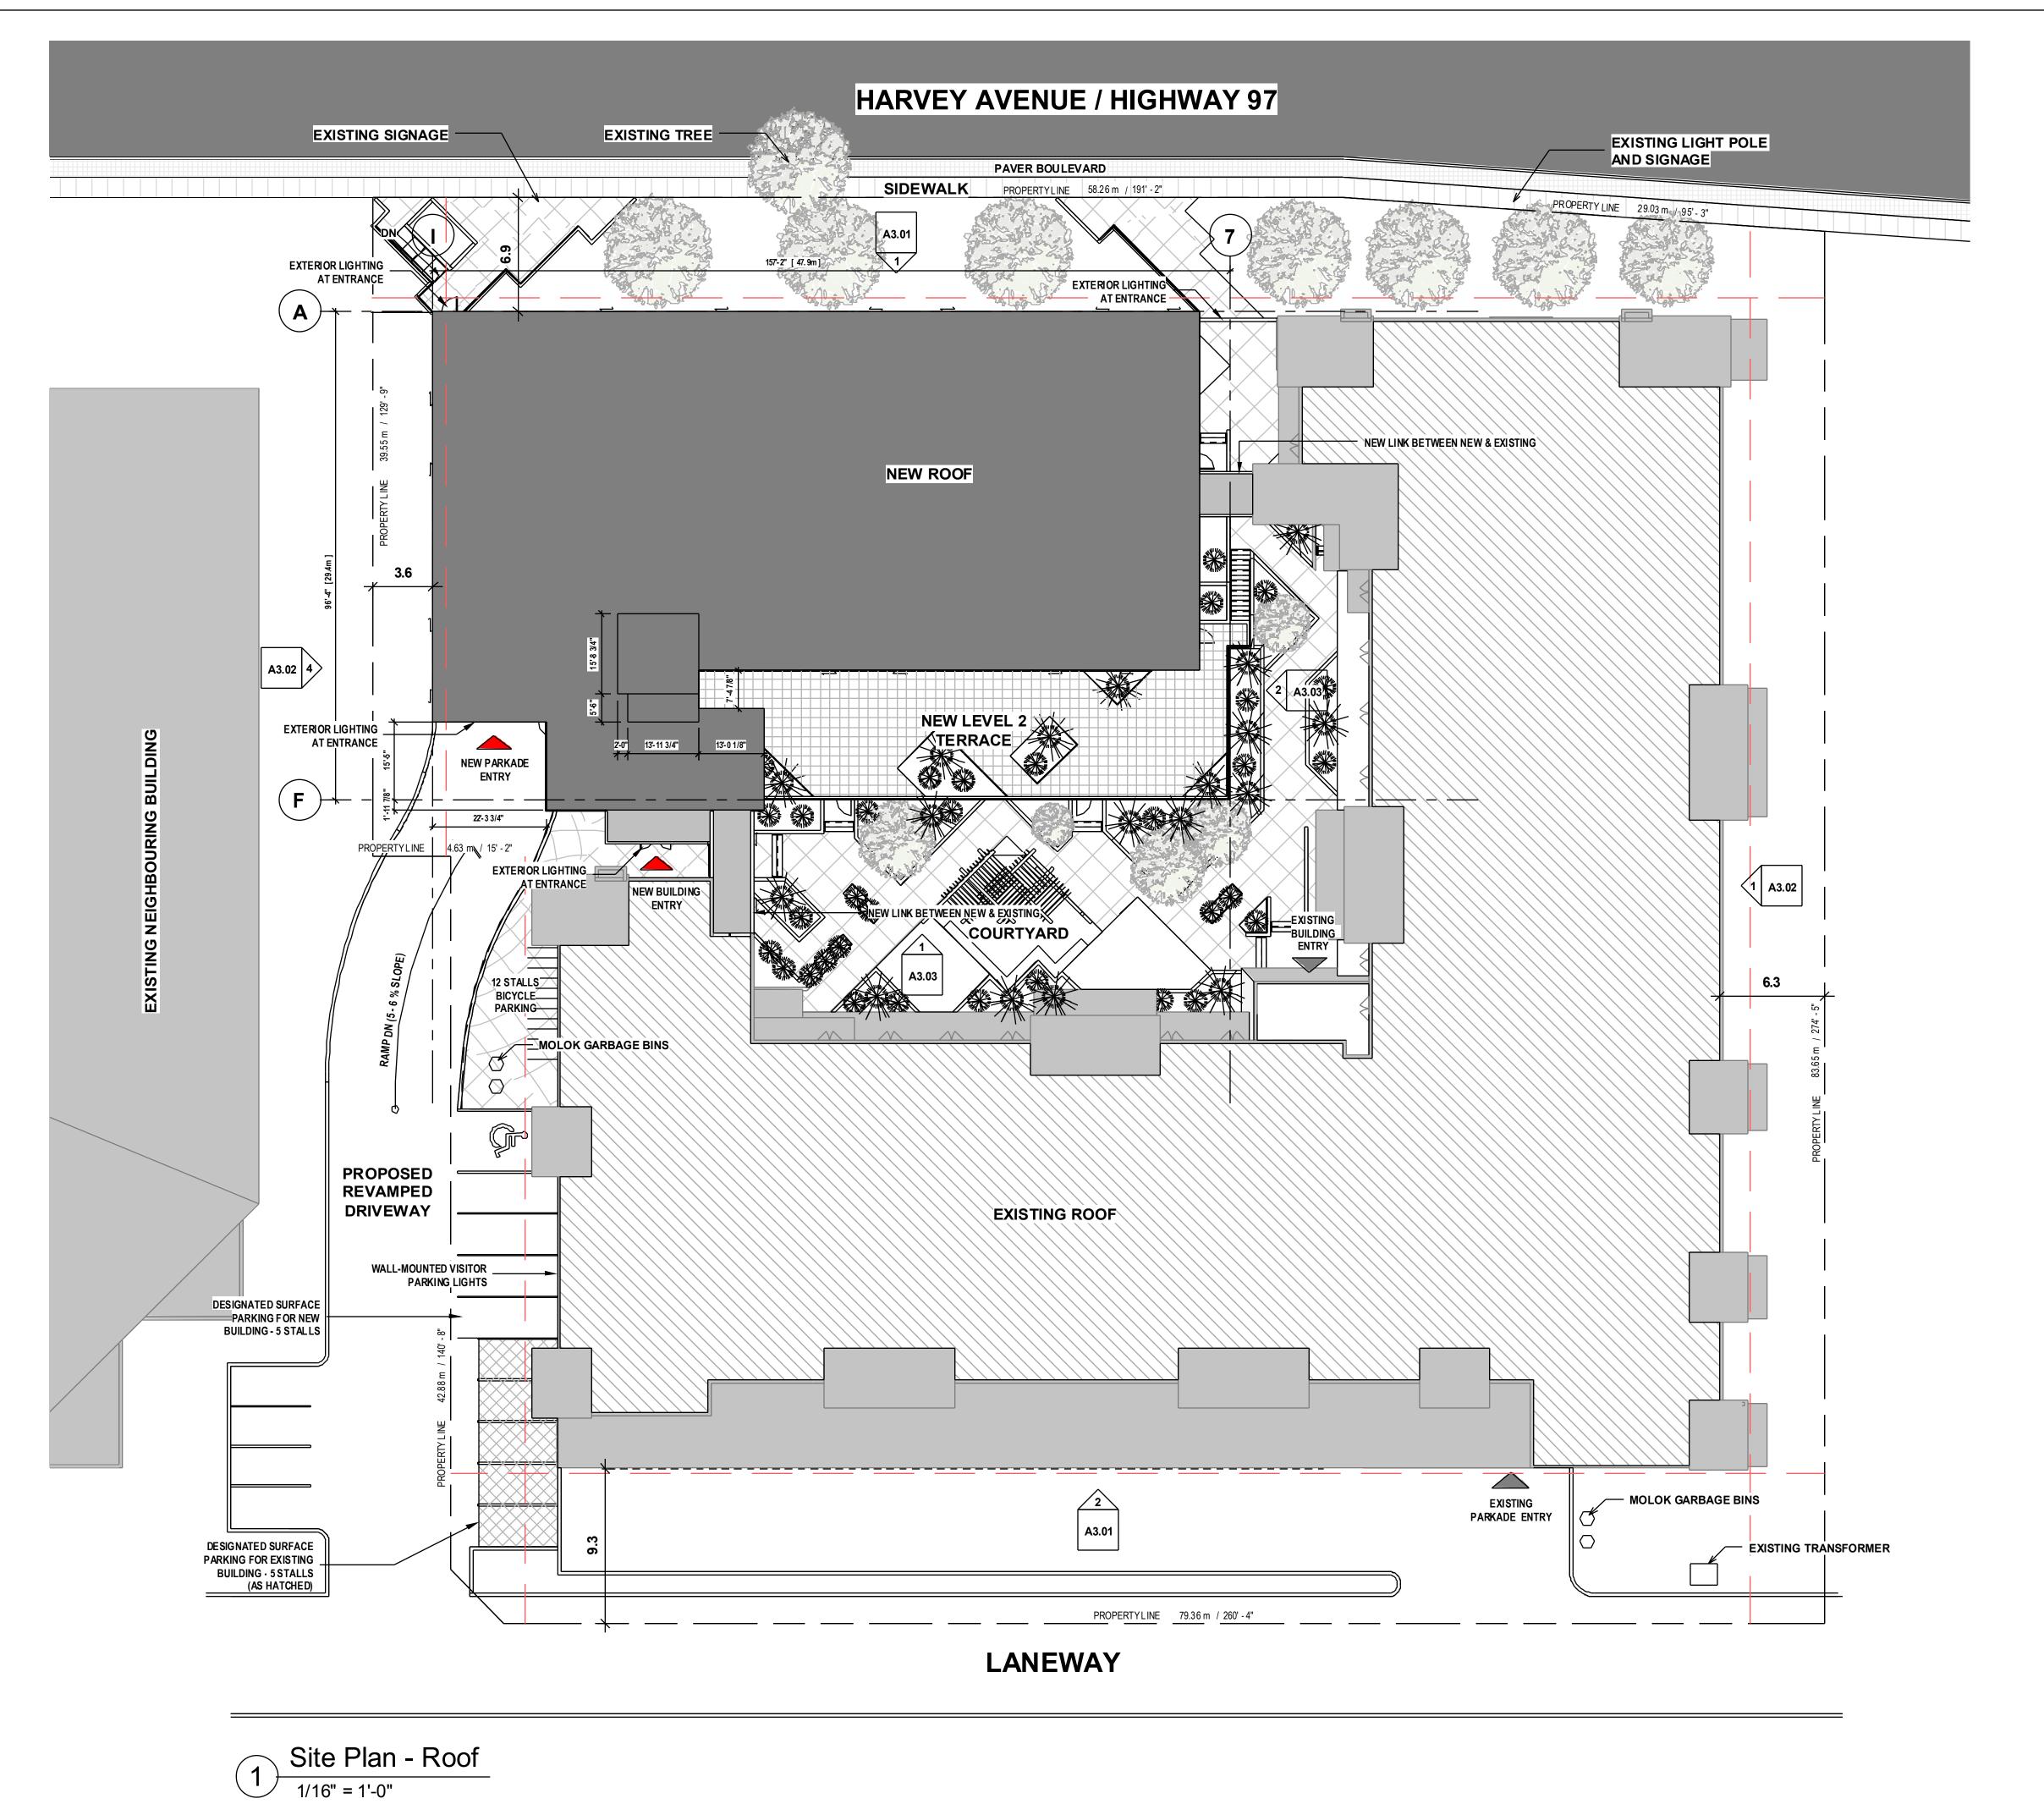

ATTACHMENT B

This forms part of application
OCP19-0009 / Z19-0119
City of

Planner Initials

AC

Kelowna

Notes:

© Copyright Reserved. This drawing and designis, and at all times remains, the property of Novation Architecture, and can be reproduced only with written consent.

All drawings shall be read in conjunction with specifications and consultant details.

All work shall be carried out in a ccordance with Canadian standards, spedifications, BC Building Code (2018 edition) and


lo cal authority by-laws and regulations.

Tabulated scales refer to Arch D size drawings sheet.

This drawing must not be scaled.

Contractors shall verify all dimensions prior to commencement of

Any omissions or discrepancies shall be reported to the architect.

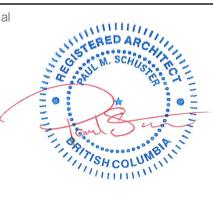

2020-01-21

this document is:

NOT controlled. Revisions may be made without notice.

A CONTROLLED document. Revisions will be advised.

The first issue of the document.

A complete revision. Remove previous issues from use.

A partial revision. Remove previous issues of corresponding sheets / pages from use.

Not for Construction.

NOT FOR CONSTRUCTION

20190930 ISSUED FOR DP

Date Description

Revisions



302 - 2237 LECKIE ROAD KELOWNA BC V1X 6Y5

projec

969 HARVEY AVENUE

LOT A DISTRICT LOT 138 ODYD PLAN 31933

EXCEPT PLAN 36604

KELOWNA, BRITISH COLUMBIA

project no. 1821

drawing title
SITE PLAN - ROOF

 designed
 PS
 scale
 1/16" = 1'-0"

 drawn
 BD

 checked
 PS

Δ1 Λ

otted 21/01/2020 10:39:38 AM