Development Permit DP19-0182



This permit relates to land in the City of Kelowna municipally known as

595 Houghton Road

and legally known as

Lot 5 Section 26 Township 26 ODYD Plan 29795

and permits the land to be used for the following development:

ATTACHMENT A This forms part of application # DP19-0182 City of Planner Initials AJ City of Kelowna DEVELOPMENT PLANNING

Animal Clinics, Minor

The present owner and any subsequent owner of the above described land must comply with any attached terms and conditions.

Date of Council Decision:

<u>Decision By:</u> Council

<u>Development Permit Area:</u> Revitalization Development Permit Area

Existing Zone: C4 – Urban Centre Commercial

Future Land Use Designation: MXR – Mixed Use (Residential / Commercial)

This is NOT a Building Permit.

In addition to your Development Permit, a Building Permit may be required prior to any work commencing. For further information, contact the City of Kelowna, Development Services Branch.

NOTICE

This permit does not relieve the owner or the owner's authorized agent from full compliance with the requirements of any federal, provincial or other municipal legislation, or the terms and conditions of any easement, covenant, building scheme or agreement affecting the building or land.

Terry Barton
Community Planning Department Manager
Planning & Development Services

Date

1. SCOPE OF APPROVAL

This Development Permit applies to and only to those lands within the Municipality as described above, and any and all buildings, structures and other development thereon.

This Development Permit is issued subject to compliance with all of the Bylaws of the Municipality applicable thereto, except as specifically varied or supplemented by this permit, noted in the Terms and Conditions below.

The issuance of a permit limits the permit holder to be in strict compliance with regulations of the Zoning Bylaw and all other Bylaws unless specific variances have been authorized by the Development Permit. No implied variances from bylaw provisions shall be granted by virtue of drawing notations that are inconsistent with bylaw provisions and that may not have been identified as required Variances by the applicant or Municipal staff.

2. CONDITIONS OF APPROVAL

- a) The dimensions and siting of the building to be constructed on the land be in accordance with Schedule "A";
- b) The exterior design and finish of the building to be constructed on the land be in accordance with Schedule "B";
- c) Landscaping to be provided on the land be in accordance with Schedule "C"; and
- d) The applicant be required to post with the City a Landscape Performance Security deposit in the form of a "Letter of Credit" in the amount of 125% of the estimated value of the landscaping, as determined by a Registered Landscape Architect.

This Development Permit is valid for two (2) years from the date of approval, with no opportunity to extend.

3. PERFORMANCE SECURITY

As a condition of the issuance of this Permit, Council is holding the security set out below to ensure that development is carried out in accordance with the terms and conditions of this Permit. Should any interest be earned upon the security, it shall accrue to the Developer and be paid to the Developer or his or her designate if the security is returned. The condition of the posting of the security is that should the Developer fail to carry out the development hereby authorized, according to the terms and conditions of this Permit within the time provided, the Municipality may use enter into an agreement with the property owner of the day to have the work carried out, and any surplus shall be paid over to the property own of the day. Should the Developer carry out the development permitted by this Permit within the time set out above, the security shall be returned to the Developer or his or her designate. There is filed accordingly:

a) An Irrevocable Letter of Credit OR certified cheque in the amount of \$14,989.06

Before any bond or security required under this Permit is reduced or released, the Developer will provide the City with a statutory declaration certifying that all labour, material, workers' compensation and other taxes and costs have been paid.


4. INDEMNIFICATION


Upon commencement of the works authorized by this Permit the Developer covenants and agrees to save harmless and effectually indemnify the Municipality against:

a) All actions and proceedings, costs, damages, expenses, claims, and demands whatsoever and by whomsoever brought, by reason of the Municipality said Permit.

All costs, expenses, claims that may be incurred by the Municipality where the construction, engineering or other types of works as called for by the Permit results in damages to any property owned in whole or in part by the Municipality or which the Municipality by duty or custom is obliged, directly or indirectly in any way or to any degree, to construct, repair, or maintain.

The PERMIT HOLDER is the <u>CURRENT LAND OWNER</u>. Security shall <u>ONLY</u> be returned to the signatory of the Landscape Agreement or their designates.

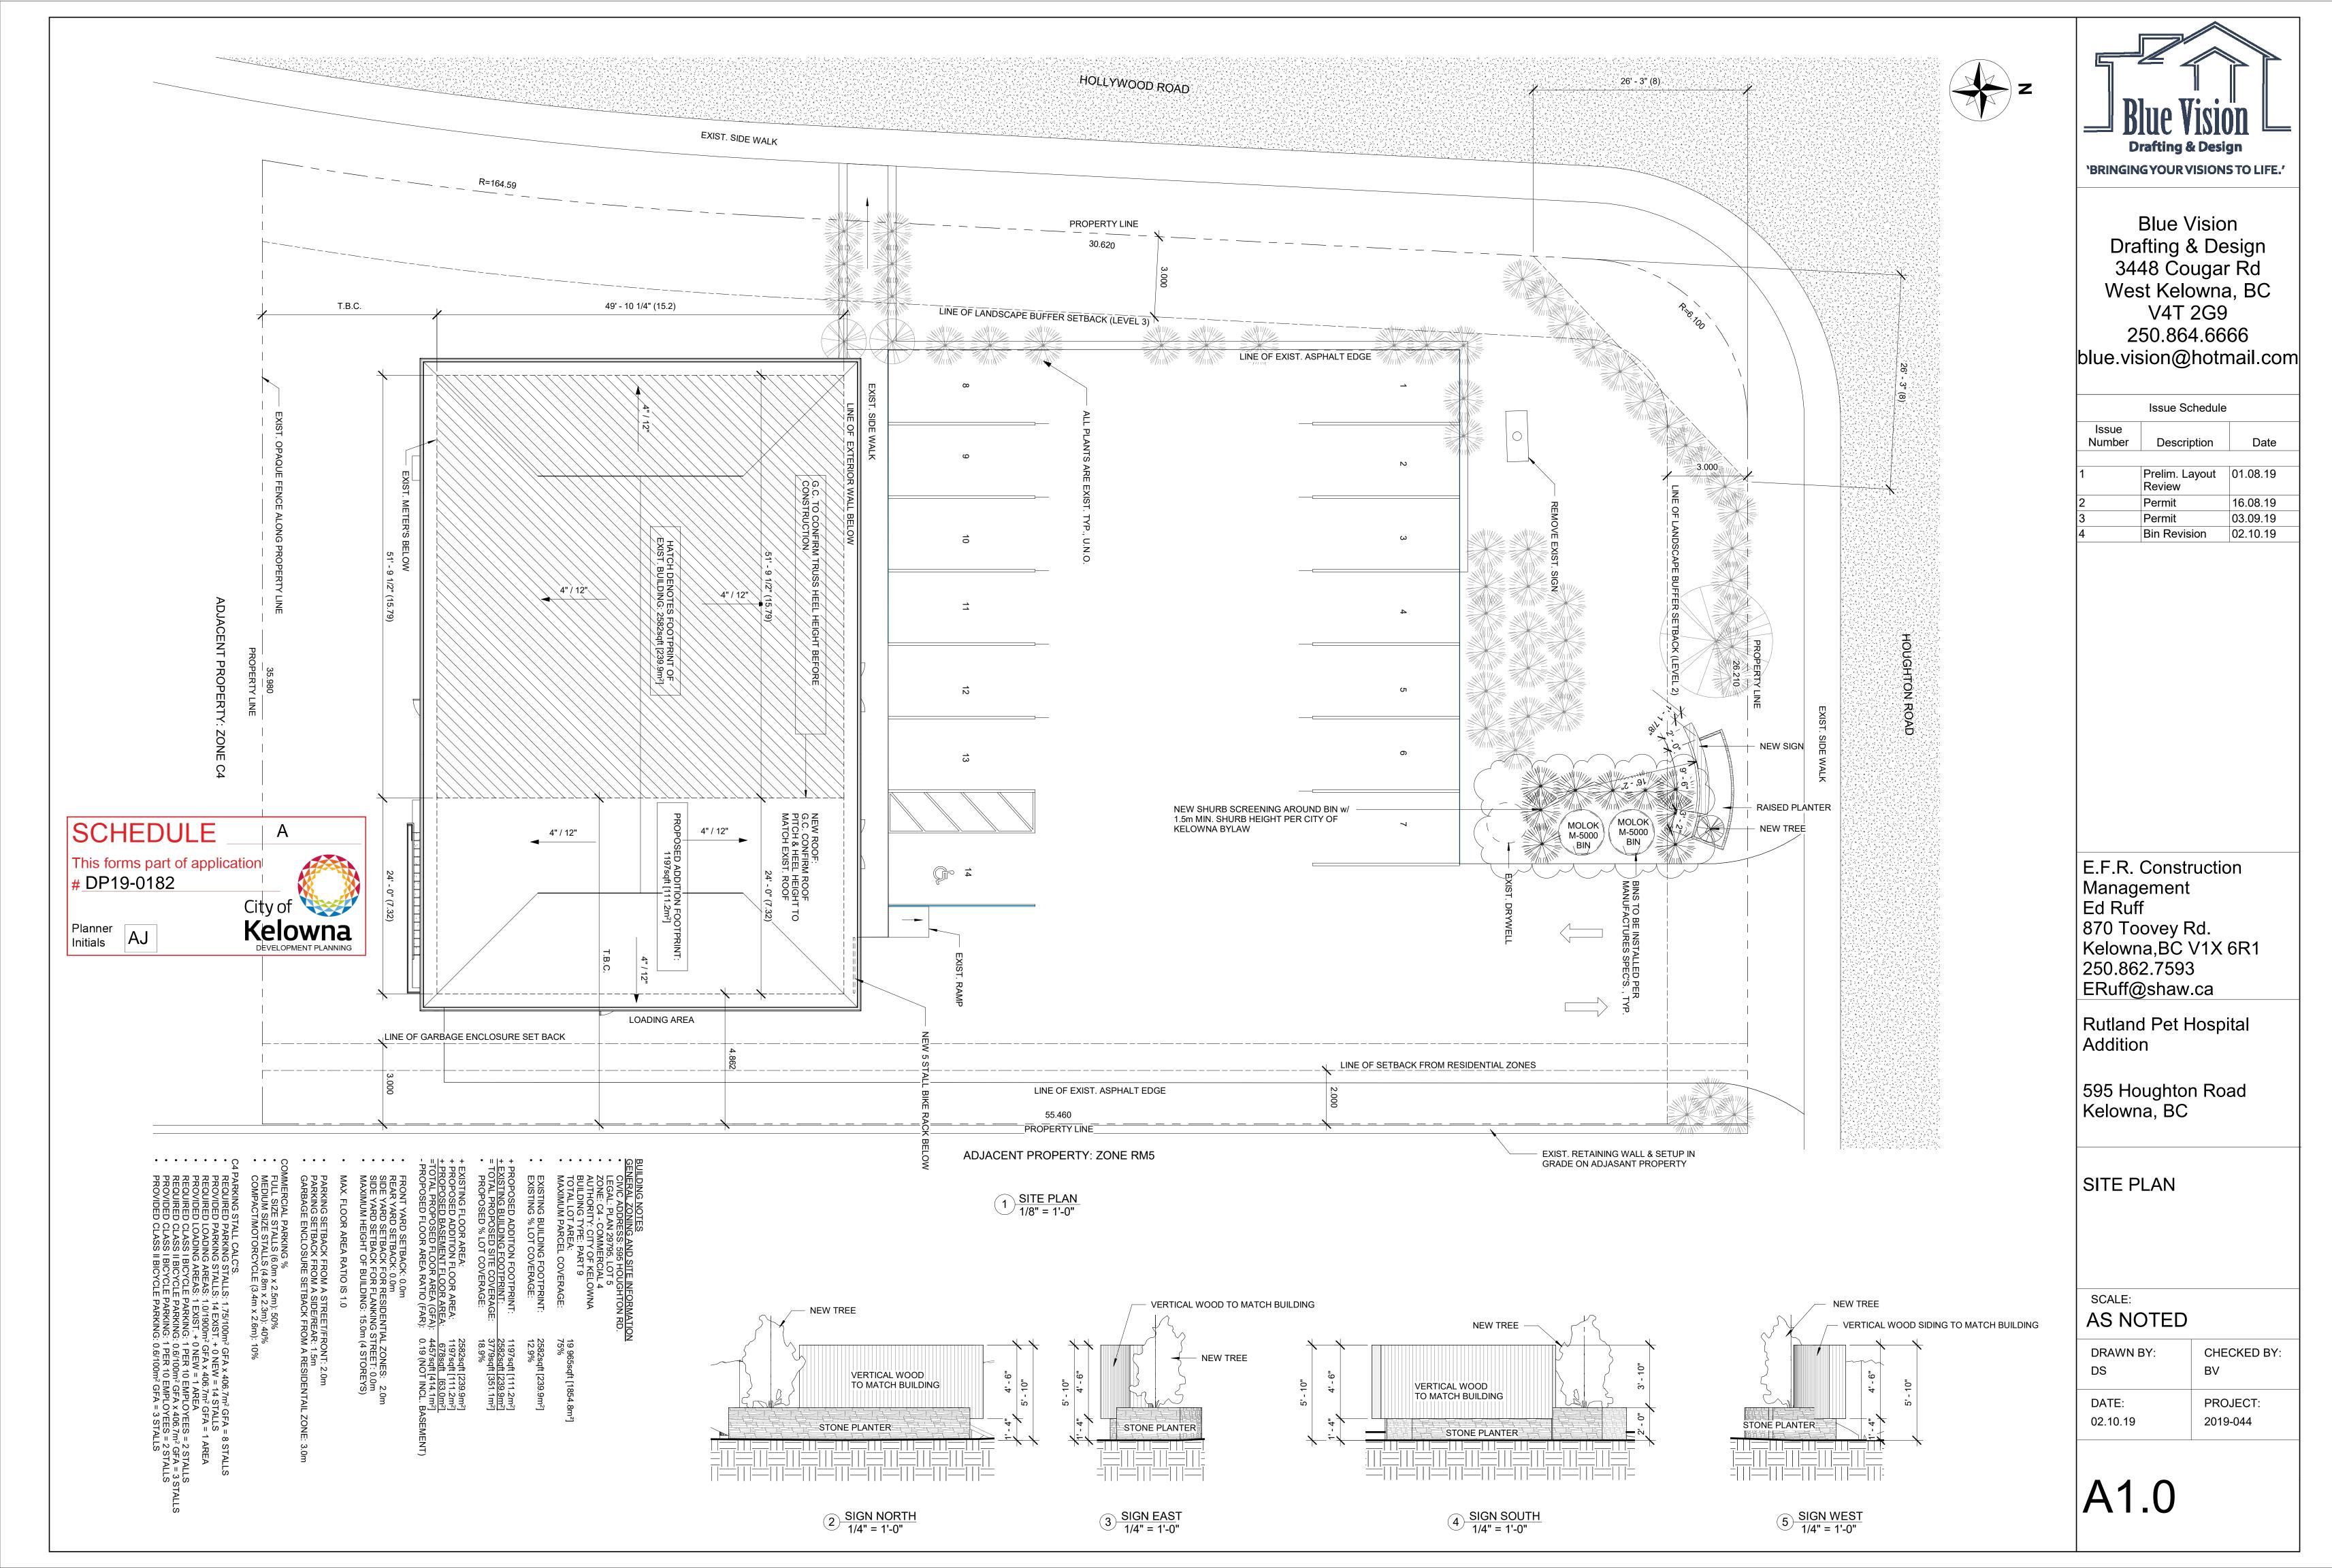

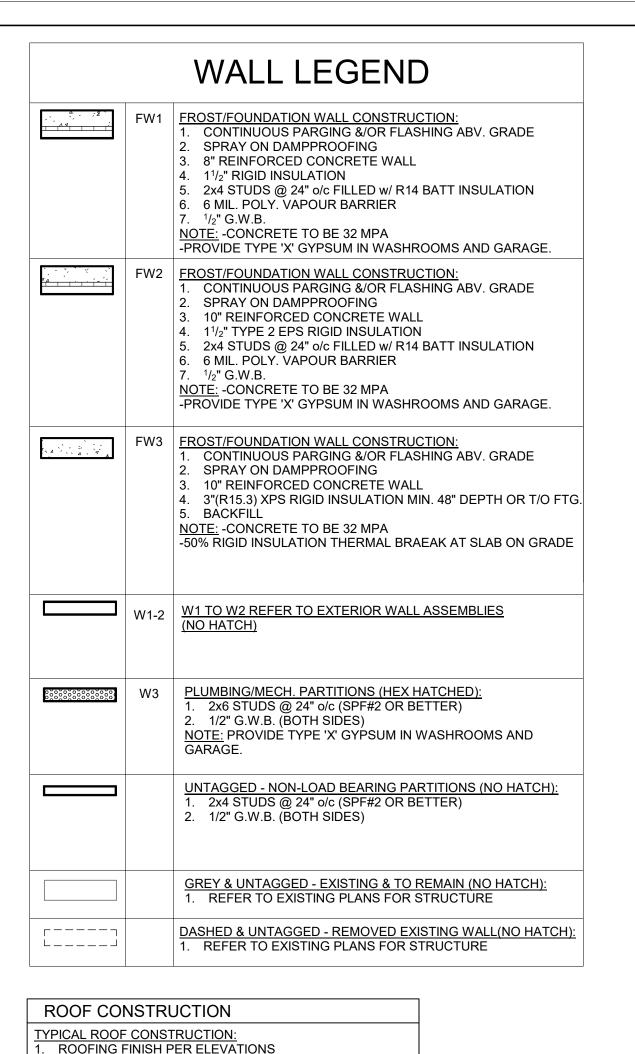

R50 BLOWN CELLULÒSE 6 MIL. POLY. AS VAPOR BARRIER G.W.B. HANGERS TO MATCH EXIST. SERVICE CAVITY 1/2" G.W.B. CEILING NOTE: PROVIDE TYPE 'X' GYPSUM IN WASHROOMS AND GARAGE. EAVE CONSTRUCTION: ALUMINUM VENTED SOFFITS 5" ALUMINUM EAVESTROUGH RECESSED INTO ENGINEERED TRUSSES (DRAIN TO SLOPE TO WATER LEADER THROUGH SOFFIT) EAVESTROUGH SCREEN - PROVIDE ICE DAMN EAVE PROTECTION MEMBRANE - ATTIC VENTILATION TO BE 1/300 OF INSULATED AREA

7/16" OSB ROOF SHEATHING (c/w H-CLIPS)

INSULATION STOPS (AS REQ'D)

ENGINEERED ROOF TRUSSES OR RAFTERS PER

WALL CONSTRUCTION REFER TO EXTERIOR WALL ASSEMBLIES OR WALL LEGEND

MANUF'RS SPEC.

FLOOR CONSTRUCTION

F1 - TYPICAL FLOOR CONSTRUCTION:

1. FLOOR FINISH AS PER OWNER/CONTRACTOR

MAX. 2" CONCRETE TOPPING 3/4" T&G OSB SUBFLOOR (GLUED & SCREWED)

FLOOR JOISTS AS PER FLOOR PLAN

5. 1/2" G.W.B. (INTERIOR EXPOSURE ONLY) NOTE: INSULATE ALL JOISTS SPACES @ EXTERIOR

PERIMETER WALLS BEAMS & STRUCTURAL FRAMING: AS PER PLAN OR AS REQUIRED BY FLOOR/TRUSS SUPPLIER

FOUNDATION CONSTRUCTION

REFER TO STRUCTURAL DRAWINGS AS REQ'D.

FROST WALL CONSTRUCTION:
1. CONTINUOUS PARGING &/OR FLASHING ABV. GRADE

DRAIN MAT SPRAY ON DAMPPROOFING

8" OR 10" PER PLAN CONCRETE WALL c/w 2 ROWS 10mm (10M) REBAR TOP & BOTTOM, 10mm (10M) REBAR @ 24"

o/cVERT. & HORIZ. R15 RIGID INSULATION w/ 50% @ SLAB

NOTE: CONCRETE TO BE 32 MPA

FOOTING CONSTRUCTION:

16"x8" CONCRETE STRIP FOOTING c/w 2"x4" KEYWAY OR 10M DOWELS @ 24" o/c

2 ROWS 16mm DIA. (15M) REBAR REINFORCEMENT. FOOTING TO BE PLACED ON UNDISTURBED NATIVE

SOIL OR ENGINEERED SOIL. U/S OF FOOTING TO BE A MINIMUM OF 2'-0" BELOW

GRADE (FROST DEPTH). NOTE: CONCRETE TO BE 32 MPA

<u>DAMPPROOFING:</u>

1. ASPHALT EMULION APPLIED TO OUTSIDE OF

CONCRETE WALL TO GRADE LEVEL CONTINUOUS 4"Ø PERFORATED DRAIN PIPE AROUND

Door Type | Count

Grand total: 21

FOOTING 6" CRUSHED ROCK (DRAIN ROCK)

NOTE: ALL SNAP TIES TO BE TARRED

SLAB CONSTRUCTION

S1 - FLOOR SLAB: 1. 4" CONCRETE SLAB

6X6-10/10 W.W.M. OR 10mm (10M) REBAR @ 24" o/c e/w

6 MIL. POLY VAPOUR BARRIER 4. 5" MIN. COMPACTED GRANULAR BASE

NOTE: CONCRETE TO BE 32MPA TIE TO FOUNDATION/ GRADE BEAM w/ 10mm DOWELS

DRIVEWAY/SIDEWALKS: 4" CONCRETE SLAB

10mm REBAR @ 24" o/c e/w NOTE: CONCRETE TO BE 25MPA

- TIE TO FOUNDATION/ GRADE BEAM w/ 10mm DOWELS - PILES AS NOTED ABOVE

WINDOW SCHEDULE Window Type | Count Height Comments 48"x48" - Double Casement Window 4' - 0" 4' - 0" Grand total: 1

72"x82"- Exterior- NEW Double Swing Curtain Wall Door

36" x 80" - Exterior - New Single Swing Door

36" x 80" - Interior - New Single Swing Door

36" x 80" - Interior - New Single Pocket Door

30" x 80" - Exterior - New Single Swing Door

30" x 80" - Interior - New Dog Kennel Door

DOOR SCHEDULE

Width


3' - 0" 6' - 8"

3' - 0" | 6' - 8"

3' - 0" 6' - 8"

2' - 6" | 6' - 8"

2' - 6" 6' - 8"

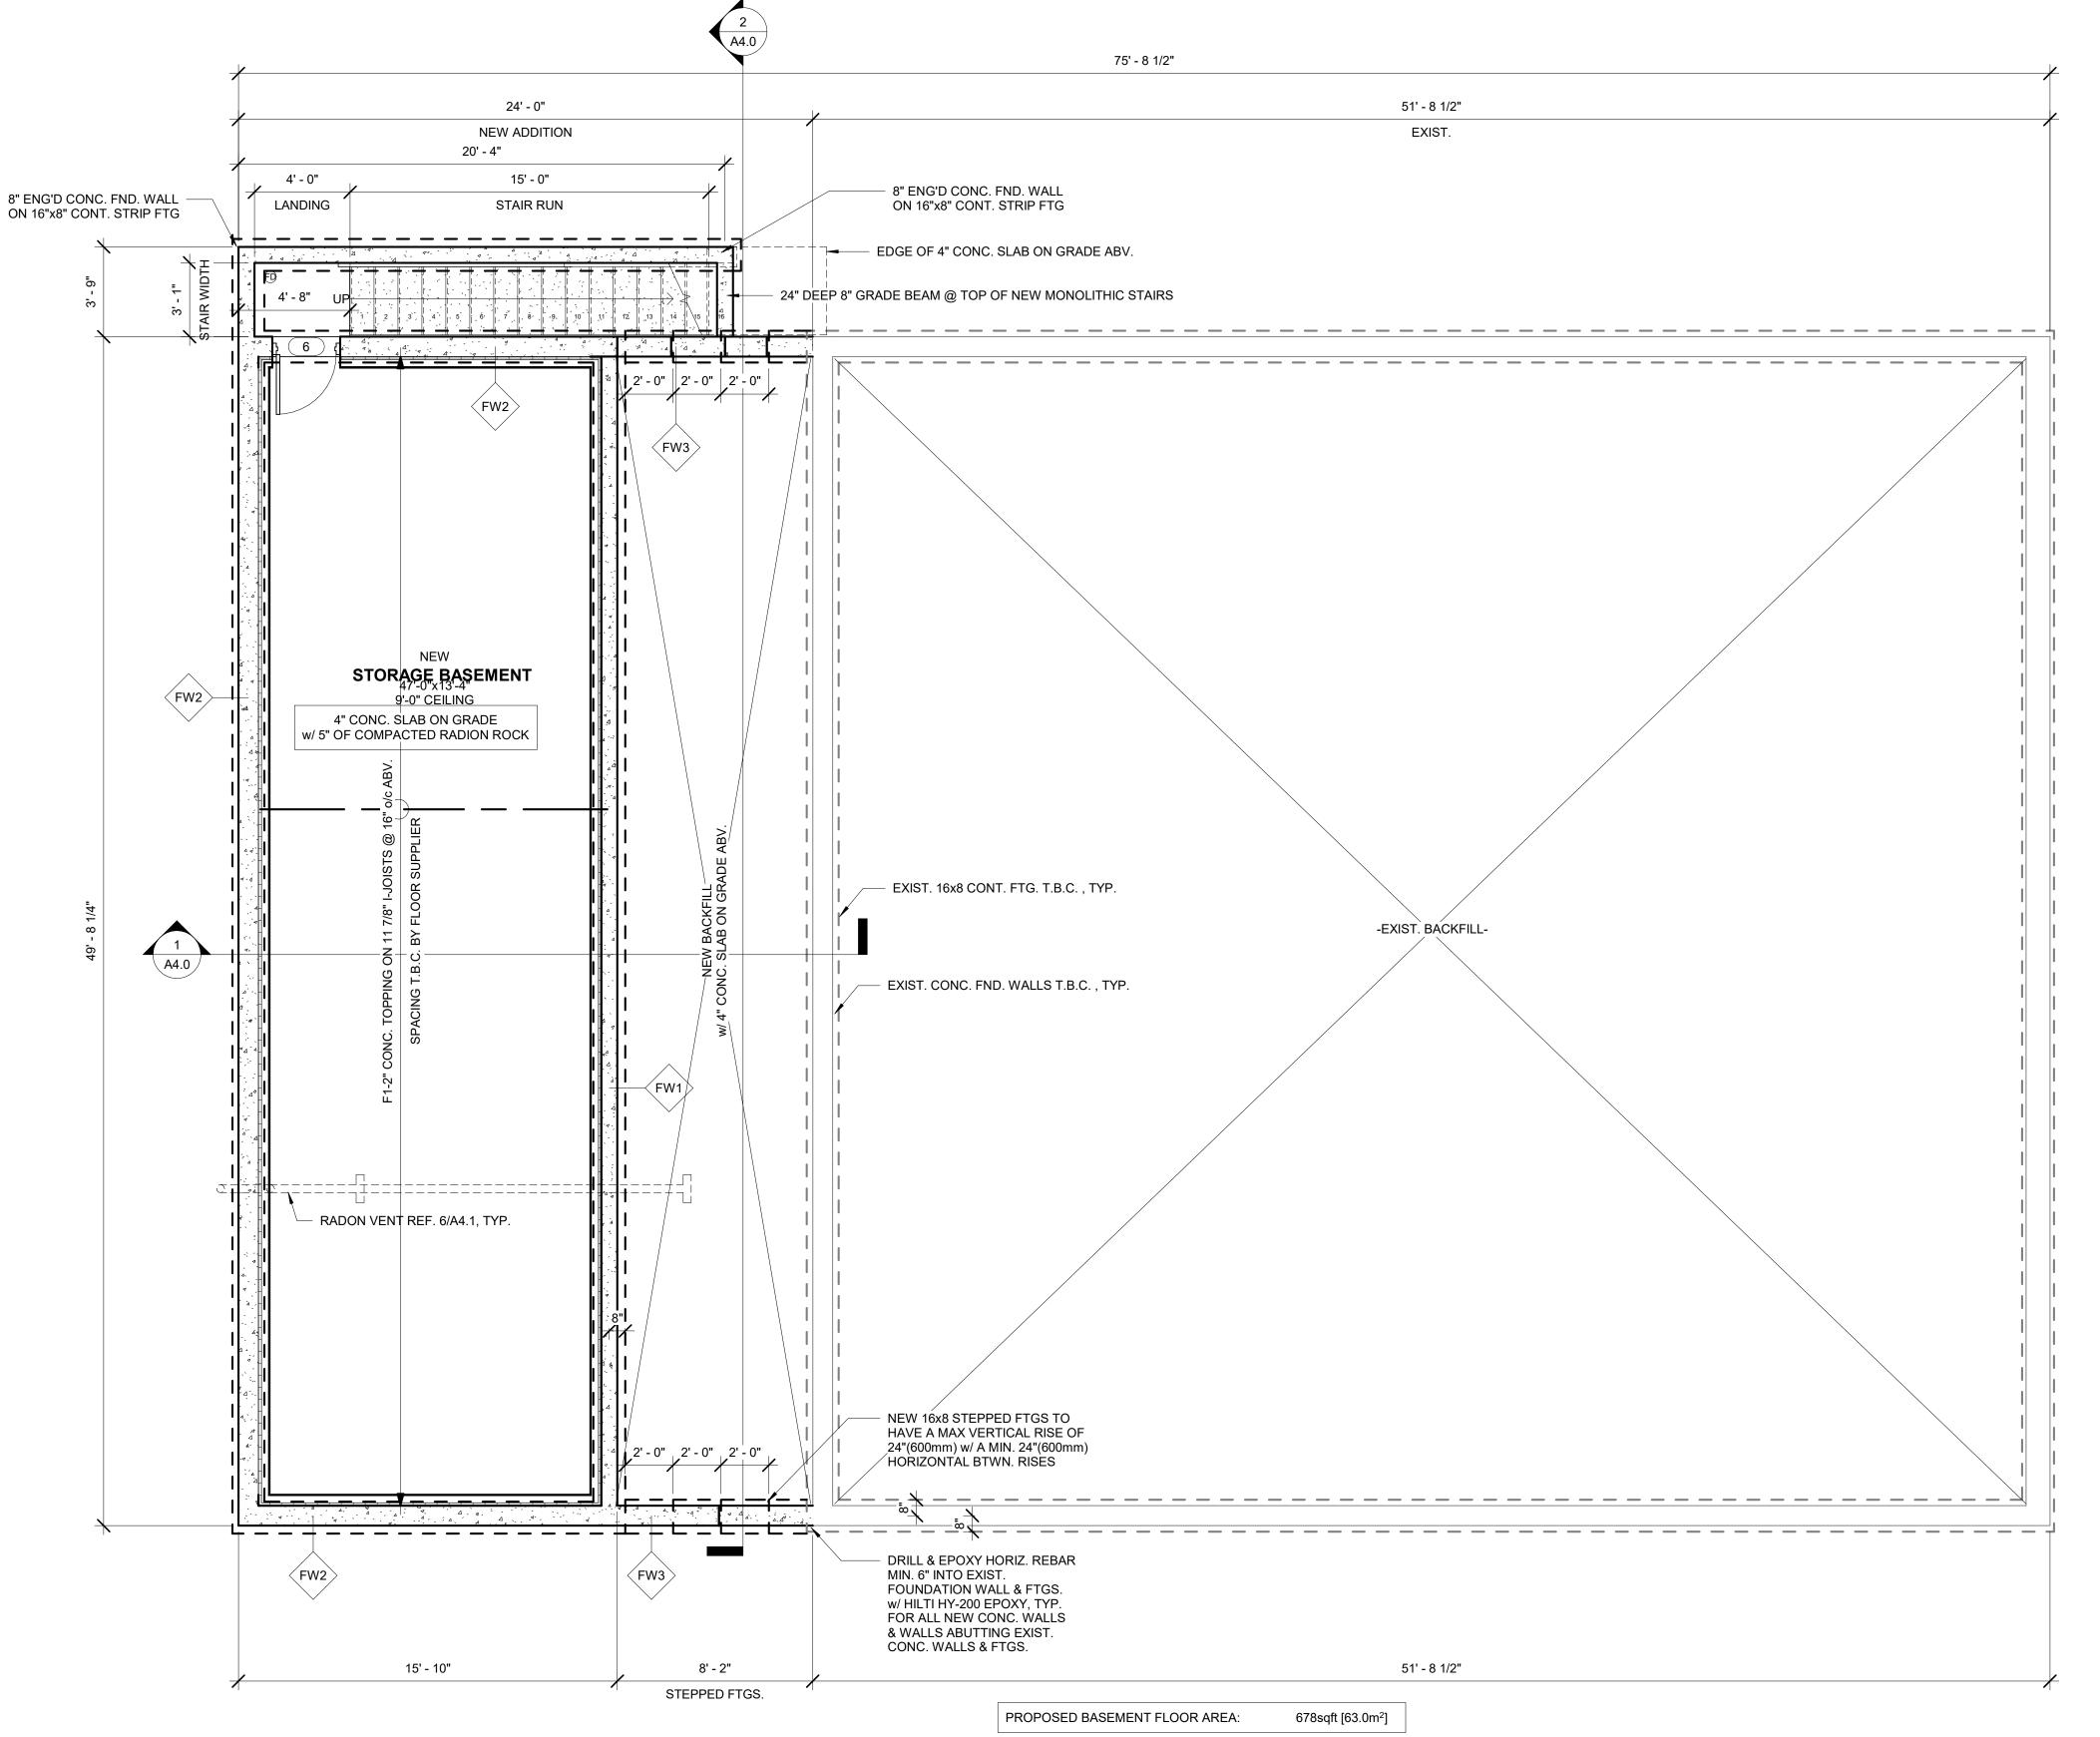

1 BASEMENT & FOUNDATION PLAN 1/4" = 1'-0"

Comments

6' - 0" 6' - 10" To Match Existing Curtain Wall Double Door (Size to be confirmed by G.C. before ordering/construction)

SCHEDULE This forms part of application # DP19-0182 City of Planner

Initials

GENERAL CONSTRUCTION NOTES:

1. 1/2 WALL STAIR GUARDS TO BE 42" HIGH OR AS PER

2. PROVIDE MIN 2" FRONT ENTRY STEP. 3. ALL BATHROOMS TO BE MECHANICALLY VENTILATED TO PROVIDE AT LEAST 1 AIR CHANGE PER HOUR. 4. 20"x28" INSULATED/WEATHER STRIPPED ATTIC ACCESS HATCH W/ INSULATION SHAFT 5. PROVIDE 2" (MIN.) CLEARANCE AROUND

MECHANICAL FLUES TO ALL COMBUSTIBLE CONSTRUCTION. 6. PROVIDE FLASHING ABOVE EXTERIOR DOORS AND WINDOW OPENINGS WHERE REQUIRED 7. NON-HARDENING EXTERIOR CAULKING COMPOUND TO BE USED OVER & AROUND ALL EXTERIOR

OPENINGS / IE. SERVICE ELECT., ETC. 8. ALL EXTERIOR/ INTERIOR LOAD BEARING LINTELS TO BE 2-PLY 2x10 U.N.O. 9. ALL EXTERIOR SIDING/ STUCCO FINISHES TO BE 8" MIN. ABOVE FINISHED GRADE 10. ALL WORKMANSHIP AND MILLWORK TO CONFORM TO THE STANDARDS OF GOOD BUILDING PRACTICES, &

CURRENT LOCAL BUILDING CODES WITH ALL 11. WHERE THERE IS A DISCREPANCY BETWEEN THE PLANS AND THE BUILDING CODE, THE BUILDING CODE SHALL TAKE PRECEDENCE

Blue Vision Drafting & Design 3448 Cougar Rd West Kelowna, BC V4T 2G9

'BRINGING YOUR VISIONS TO LIFE.'

250.864.6666 blue.vision@hotmail.com

	Issue Schedule)
Issue Number	Description	Date
1	Prelim. Layout Review	01.08.19
2	Permit	16.08.19
_		

E.F.R. Construction Management Ed Ruff 870 Toovey Rd. Kelowna, BC V1X 6R1 250.862.7593 ERuff@shaw.ca

Rutland Pet Hospital Addition


595 Houghton Road Kelowna, BC

BASEMENT CONSTRUCTION / **FOUNDATION PLAN**

SCALE:

AS NOTED

DRAWN BY: DS	CHECKED BY: BV
DATE:	PROJECT:
03.09.19	2019-044

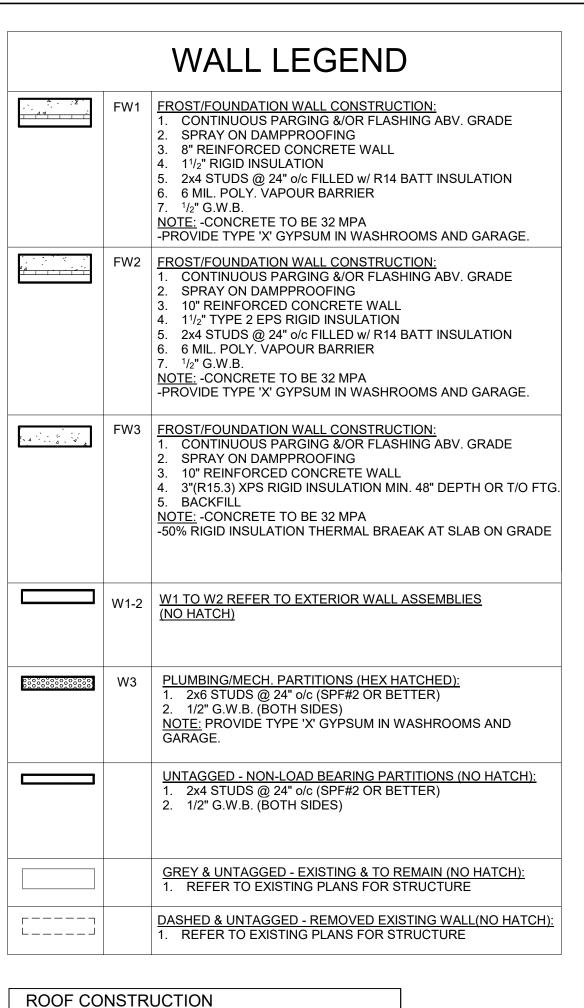

TYPICAL ROOF CONSTRUCTION ROOFING FINISH PER ELEVATIONS 7/16" OSB ROOF SHEATHING (c/w H-CLIPS)

ENGINEERED ROOF TRUSSES OR RAFTERS PER MANUF'RS SPEC. INSULATION STOPS (AS REQ'D) . R50 BLOWN CELLULOSE . 6 MIL. POLY. AS VAPOR BARRIER

G.W.B. HANGERS TO MATCH EXIST. SERVICE CAVITY

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WALL CONSTRUCTION

REFER TO EXTERIOR WALL ASSEMBLIES OR WALL LEGEND

FLOOR CONSTRUCTION

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2. MAX. 2" CONCRETE TOPPING 3. 3/4" T&G OSB SUBFLOOR (GLUED & SCREWED) 4. FLOOR JOISTS AS PER FLOOR PLAN 5. 1/2" G.W.B. (INTERIOR EXPOSURE ONLY)

NOTE: INSULATE ALL JOISTS SPACES @ EXTERIOR

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. R15 RIGID INSULATION w/ 50% @ SLAB NOTE: CONCRETE TO BE 32 MPA

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. ASPHALT EMULION APPLIED TO OUTSIDE OF CONCRETE WALL TO GRADE LEVEL CONTINUOUS 4"Ø PERFORATED DRAIN PIPE AROUND

FOOTING 3. 6" CRUSHED ROCK (DRAIN ROCK) NOTE: ALL SNAP TIES TO BE TARRED

SLAB CONSTRUCTION

- PILES AS NOTED ABOVE


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4. 5" MIN. COMPACTED GRANULAR BASE NOTE: CONCRETE TO BE 32MPA - TIE TO FOUNDATION/ GRADE BEAM w/ 10mm DOWELS

DRIVEWAY/SIDEWALKS: 4" CONCRETE SLAB 10mm REBAR @ 24" o/c e/w NOTE: CONCRETE TO BE 25MPA TIE TO FOUNDATION/ GRADE BEAM w/ 10mm DOWELS

Window Type | Count | 48"x48" - Double Casement Window | 4' - 0" | 4' - 0" Grand total: 1



DOOR SCHEDULE Door Type | Count Type Width Height Comments 72"x82"- Exterior- NEW Double Swing Curtain Wall Door 6' - 10" To Match Existing Curtain Wall Double Door (Size to be confirmed by G.C. before ordering/construction) 3' - 0" 6' - 8" 36" x 80" - Exterior - New Single Swing Door 36" x 80" - Interior - New Single Swing Door 3' - 0" 6' - 8" 36" x 80" - Interior - New Single Pocket Door 3' - 0" 6' - 8" 30" x 80" - Interior - New Dog Kennel Door 2' - 6" 6' - 8" 2' - 6" 6' - 8" 30" x 80" - Exterior - New Single Swing Door Grand total: 21 WINDOW SCHEDULE

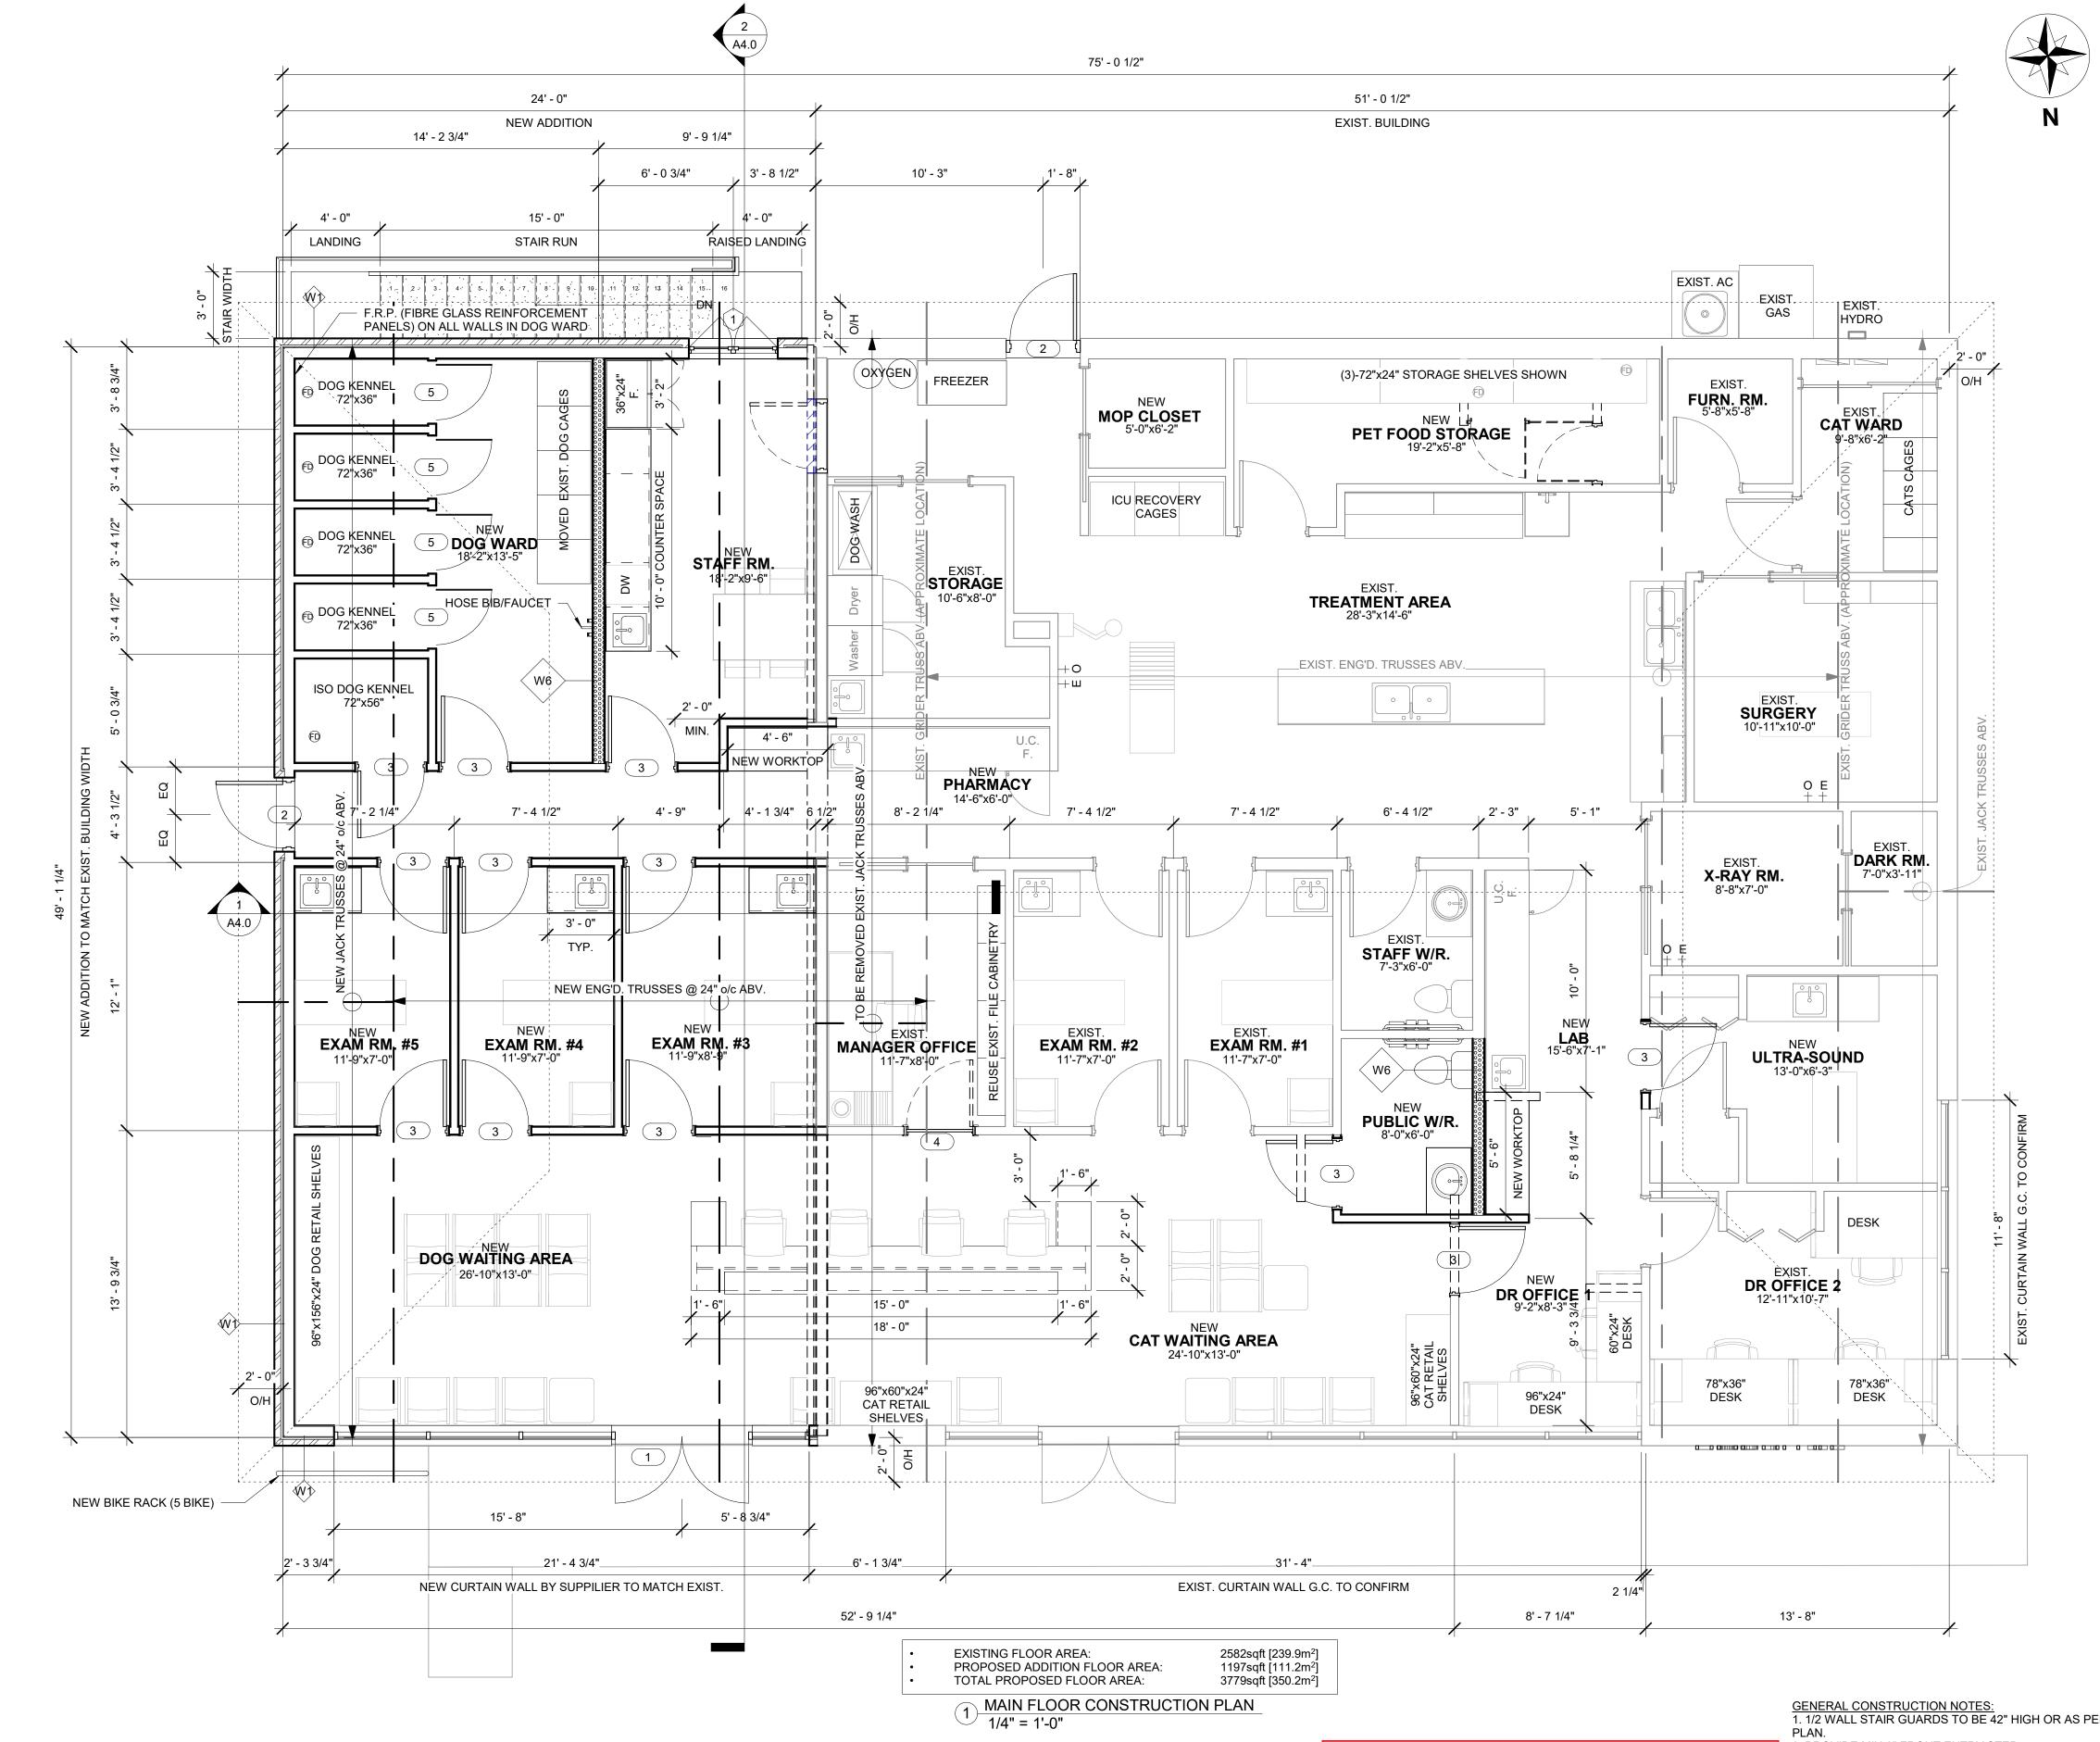Height Comments

SCHEDULE This forms part of application # DP19-0182 City of

Planner

Initials

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RESPECTS 11. WHERE THERE IS A DISCREPANCY BETWEEN THE PLANS AND THE BUILDING CODE, THE BUILDING CODE SHALL TAKE PRECEDENCE

SCALE:

5. PROVIDE 2" (MIN.) CLEARANCE AROUND MECHANICAL FLUES TO ALL COMBUSTIBLE

OPENINGS / IE. SERVICE ELECT., ETC.

TO THE STANDARDS OF GOOD BUILDING PRACTICES. & CURRENT LOCAL BUILDING CODES WITH ALL

AS NOTED DRAWN BY: CHECKED BY: DS BV

PROJECT:

2019-044

Drafting & Design

'BRINGING YOUR VISIONS TO LIFE.'

Blue Vision

Drafting & Design 3448 Cougar Rd

West Kelowna, BC

V4T 2G9

250.864.6666

blue.vision@hotmail.com

Issue Schedule

Description

Review

Permit

Permit

E.F.R. Construction

Kelowna, BC V1X 6R1

Rutland Pet Hospital

595 Houghton Road

CONSTRUCTION PLAN

Management

870 Toovey Rd.

250.862.7593

Kelowna, BC

MAIN FLOOR

ERuff@shaw.ca

Ed Ruff

Addition

Prelim. Layout 01.08.19

Date


16.08.19

03.09.19

Number

DATE:

03.09.19

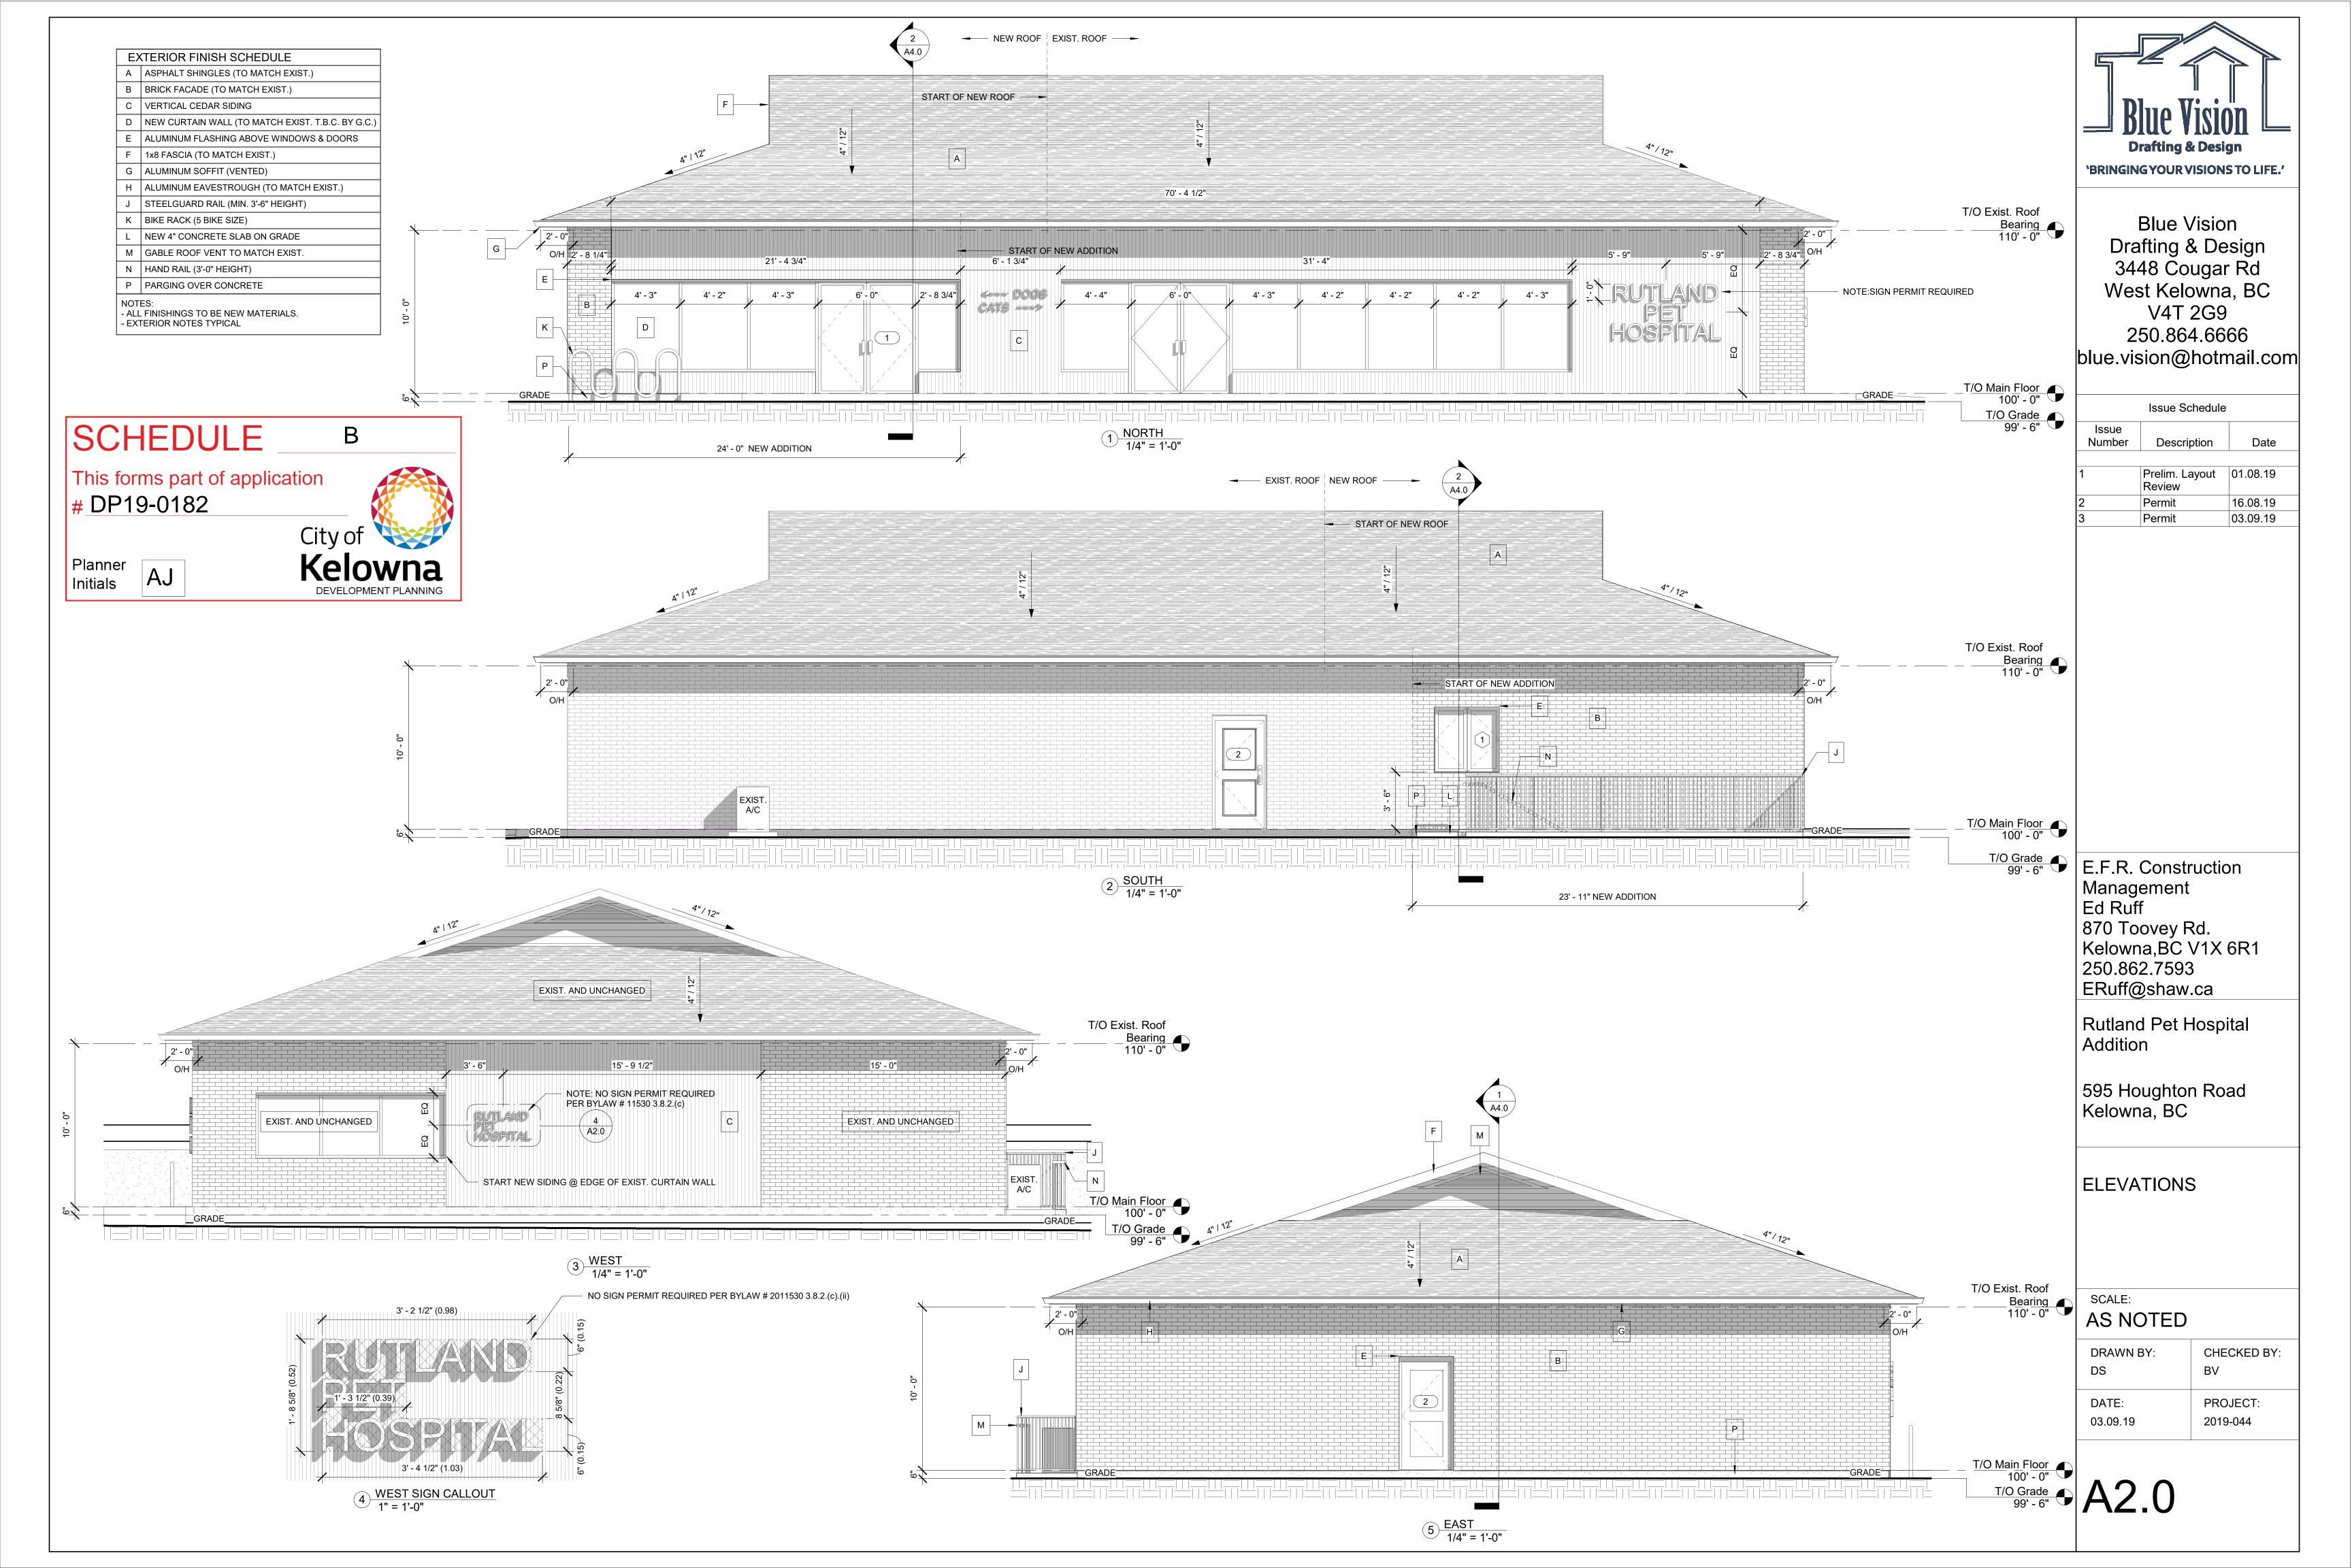

Iko Cambridge Driftwood Shingle
Matches existing shingles



Existing Door and Windows New ones to match

Proposed Material and Colours For 595 Houghton Road



Existing Coloured Bricks



Spraynet Brick Stain Colour Kahki



Cedar Siding For Accents




Behr
Transparent Wood Stain
Colour Padre Brown



DEVELOPMENT PERMIT NOTES:

- A PLANT MATERIALS AND CONSTRUCTION METHODS SHALL CONFORM TO MINIMUM STANDARDS ESTABLISHED IN THE LATEST EDITION OF THE CANADIAN LANDSCAPE STANDARDS, PUBLISHED BY C.L.N.A. AND C.S.L.A. AS WELL AS THE CITY OF KELOWNA LANDSCAPE STANDARDS IN BYLAW 7900.
- B THE LANDSCAPE DESIGN DESIGNATED HEREIN IS CONCEPTUAL BUT REFLECTS THE MINIMUM CITY OF KELOWNA FORM AND CHARACTER REQUIREMENTS
- C PLANT MATERIAL SELECTIONS ARE CONCEPTUAL ONLY. FINAL PLANTING SELECTIONS MAY VARY DEPENDING UPON AVAILABILITY AT THE TIME OF CONSTRUCTION.
- D TREES SHALL BE INSTALLED IN DEFINED SOIL PITS OR PLANTING BED AREAS. ADEQUATE SOIL VOLUME SHALL BE PROVIDED BASED ON THE SPECIFIED TREE SPECIES AND LOCATION.
- E ORNAMENTAL SHRUB, GRASS AND PERENNIAL CLUSTERS ARE TO BE PLACED WITHIN DEFINED PLANTING BEDS. ALL PLANTING BEDS SHALL HAVE A MIN. OF 450mm (18") IMPORTED GROWING MEDIUM AND 75mm (3") OF COMPOSTED MULCH OR APPROVED EQUAL.
- F TURF AREAS SHALL BE LOW WATER USE 'NO. 1 PREMIUM' SOD WITH A MIN, OF 150mm (6") IMPORTED GROWING MEDIUM
- G A HIGH EFFICIENCY IRRIGATION SYSTEM SHALL BE INSTALLED FOR ALL ORNAMENTAL LANDSCAPE AREAS AND SHALL CONFORM TO THE CITY OF KELOWNA'S IRRIGATION STANDARDS IN BYLAW 7900.

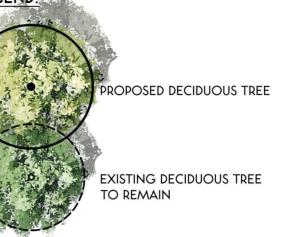



CONCRETE PAD

EXISTING CONCRETE SIDEWALK TO REMAIN

PROPOSED SODDED LAWN

EXISTING SODDED LAWN TO REMAIN

EXISTING CHAINLINK FENCE TO

SECONDARY BUILDING ENTRY / EXIT

MAIN BUILDING ENTRY / EXIT

VEHICULAR ENTRY / EXIT

PLANT LIST:

TREES

Botanical Name

Acer x freemanii 'Jeffersred'	Autumn Blaze maple	6cm Cal.	B&B
SHRUBS			
Botanical Name	Common Name	Size/Spacing	Root
Berberis thunbergii 'Bailone'	Ruby Carousel barberry	#01 Cont./1.0m O.C.	Potted
Cornus sericea 'Kelseyi'	Kelsey dogwood	#03 Cont./0.75m O.C.	Potted
Paxistima canbyi	Cliff green	#01 Cont./1.2m O.C.	Potted
Philadelphus lewisii 'Snowbelle'	Snowbelle mockorange	#05 Cont./1.0m O.C.	Potted
Pinus mugo 'Slowmound'	Dwarf mugo pine	#03 Cont./0.75m O.C.	Potted
Spiraea betulifolia 'Tor'	Tor birchleaf spirea	#02 Cont./1.0m O.C.	Potted
Taxus media 'Hicksii'	Hick's yew	#05 Cont./1.0m O.C.	Potted
PERENNIALS			
Botanical Name	Common Name	Size/Spacing	Root
Eutrochium dubium 'Little Joe'	Little Joe pye weed	#01 Cont./0.9m O.C.	Potted

Common Name

GRASSES

Rudbeckia fulgida 'Goldsturm'

Sedum spectabile 'Autumn Fire'

Botanical Name	Common Name	Size/Spacing	Root
Miscanthus sinensis 'Gracillimus'	Maiden hair grass	#01 Cont./1.2m O.C.	Potted
Calamagrostis brachytricha	Korean feather reed grass	#01 Cont./0.75m O.C.	Potted

Goldsturm coneflower

Autumn Fire stonecrop

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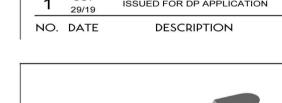
REVISIONS / ISSUED:

NORTH ____

S

TON N

1	OCT 29/19	ISSUED FOR DP APPLICATION





RUTLAND PET HOSPITAL


PROJECT:

RUTLAND PET HOSPITAL SCREENING PLAN KELOWNA, B.C.

LANDSCAPE PLAN

DESIGN BY	LS
DRAWN BY	YY
CHECKED BY	XS
PROJECT NO.	19-021
SCALE	1:150

L-1

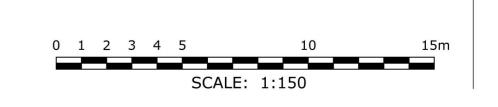

#01 Cont./0.6m O.C.

#01 Cont./0.5m O.C.

Size/Spacing

Root

Potted

Potted

Revitalization Development Permit Area

Consideration has been given to the following guidelines as identified in Section 14.B. of the City of Kelowna Official Community Plan relating to Revitalization Development Permit Areas:

REVITALIZATION DEVELOPMENT PERMIT AREA	YES	NO	N/A
Relationship to the Neighbourhood and Street			
Does the proposal maintain the established or envisioned architectural character of the neighbourhood?	✓		
Do developments adjacent to non-revitalization areas create an appropriate transition?			✓
Are spaces for pedestrian friendly amenities, such as street furniture, included on site?		✓	
Is the ratio of streetwall height to street width less than 0.75:1?	✓		
Does the building frontage occupy the entire length of the street, without drive aisles or other dead zones?		✓	
Building Design			
Are architectural elements aligned from one building to the next?			✓
Are the effects of shadowing on public areas mitigated?			✓
Are doors or windows incorporated into at least 75% of street frontage?		✓	
Do proposed buildings have an identifiable base, middle and top?			✓
Are windows, entrances, balconies and other building elements oriented towards	✓		
surrounding points of interest and activity? Are architectural elements such as atriums, grand entries and large ground-level			
windows used to reveal active interior spaces?	V		
Are buildings designed with individual entrances leading to streets and pathways			√
rather than with mall style entrances and internal connections? For multiple unit residential projects, is ground level access for first storey units			✓
provided? Are buildings finished with materials that are natural, local, durable and			
appropriate to the character of the development?	✓		
Are prohibited materials such as vinyl siding, reflective or non-vision glass, plastic, unpainted or unstained wood, and concrete block not used in the design?	✓		
Are stucco and stucco-like finishes omitted as a principal exterior wall material?	✓		
Are vents, mechanical rooms/equipment and elevator penthouses integrated with the roof or screened with finishes compatible with the building's design? View Corridors			✓
Are existing views preserved and enhanced?			✓
Vehicular Access and Parking			
Are at-grade and above-grade parking levels concealed with façade treatments?			✓
Are garage doors integrated into the overall building design?			√

REVITALIZATION DEVELOPMENT PERMIT AREA	YES	NO	N/A
Are pedestrian entrances more prominent features than garage doors and vehicle entrances?	✓		
Is surface parking located to the rear of the building or interior of the block?		\checkmark	
Are truck loading zones and waste storage areas screened from public view?	✓		
Do parking lots have one shade tree per four parking stalls?		✓	
Are pedestrian connections provided within and between parking lots?			√
Are driving, parking, pedestrian and cycling areas distinguished through changes in colour or pattern of paving materials?			√
Signage			
Is signage design consistent with the appearance and scale of the building?	✓		
Are corporate logos on signs complimentary to the overall building character?	✓		
Is signage lighting minimized?	√		