CITY OF KELOWNA

MEMORANDUM

Date: December 10, 2018

File No.: DP18-0237

To: Urban Planning Management (LK)

From: Development Engineer Manager (JK)

Subject: 280 Nickel Rd



The Development Engineering comments and requirements regarding this Development Permit application are as follows:

1) General

a. All the offsite infrastructure and services upgrades are addressed in the Rezoning Engineering Report under file Z16-0064.

2) Road Improvements

- a. Nickel Rd must be upgraded to a 2-lane major collector along the full frontage of this proposed development including curb and gutter, LED street lights, irrigated landscaped boulevard, sidewalk, drainage system including catch basins, and pavement removal and replacement and re-location or adjustment of utility appurtenances if required to accommodate the upgrading construction. Road cross section to be used is SS-R5.
- b. Cash-in-lieu payment noted in permit Z16-0064 section 5-Road Improvements will not be required as the developer is required to build above upgrades.

3) Servicing Agreements for Works and Services

- a) A Servicing Agreement is required for all offsite works and services on City lands in accordance with the Subdivision, Development & Servicing Bylaw No. 7900. The applicant's Engineer, prior to preparation of Servicing Agreements, must provide adequate drawings and estimates for the required works. The Servicing Agreement must be in the form as described in Schedule 2 of the bylaw.
- b) Part 3, "Security for Works and Services", of the Bylaw, describes the Bonding and Insurance requirements of the Owner. The liability limit is not to be less than \$5,000,000 and the City is to be named on the insurance policy as an additional insured.

Jámes Kay, P.Eng.

Development Engineering Manager

AS

CITY OF KELOWNA

MEMORANDUM

ATTACHMENT _
This forms part of application

Planner

Initials

ΑJ

Α

City of

Kelov

March 21, 2019 Revised II # DP18-0237 & DVP18-0238

File No.: Z16-0064

To: Urban Planning Management (LK)

From: Development Engineering Manager (SM)

Subject: 280 Nickel Rd RU1 to RM1

The Development Engineering Division has the following comments and requirements associated with this rezoning application. The Development Engineering Technologist for this project is *Aaron Sangster*.

1. Domestic Water and Fire Protection

The property is located within the Black Mountain Irrigation District (BMID) service area. The water system must be capable of supplying domestic and fire flow demands of the project in accordance with the Subdivision, Development & Servicing Bylaw. The developer is responsible, if necessary, to arrange with BMID staff for any service improvements and, if necessary, the decommissioning of existing services.

2. Sanitary Sewer

Date:

Our records indicate that this property is currently serviced with a 100mm-diameter sanitary sewer service. The developer's consulting mechanical engineer will determine the development requirements of this proposed development and establish the service needs. Only one service will be permitted for this development. Service upgrades can be provided by the City at the applicant's cost, if required. The applicant will be required to sign a Third Party Work Order for the cost of the service upgrade. For estimate inquiry's please contact Andy Marshall, by email amarshall@kelowna.ca or phone, 250-469-8591.

3. Storm Drainage

- a) Provide an adequately sized drainage system complete with individual lot connections. The Subdivision, Development and Servicing Bylaw requires that each lot be provided with an individual connection; however, the City Engineer may permit use of individual ground water disposal systems, where soils are suitable. For on-site disposal of drainage water, a hydrogeotechnical report will be required complete with a design for the disposal method (i.e. trench drain / rock pit). The Lot Grading Plan must show the design and location of these systems for each lot.
- b) Provide the following drawings:
 - i) A detailed Lot Grading Plan (indicate on the Lot Grading Plan any slopes that are steeper than 30% and areas that have greater than 1.0 m of fill);

- ii) A detailed Stormwater Management Plan for this subdivision; and,
- iii) An Erosion and Sediment Control Plan.

4. <u>Geotechnical Report</u>

As a requirement of this application the owner must provide a geotechnical report prepared by a Professional Engineer qualified in the field of hydro-geotechnical survey to address the following:

- (a) Area ground water characteristics.
- (b) Site suitability for development, unstable soils, etc.
- (c) Drill and / or excavate test holes on the site and install pisometers if necessary. Log test hole data to identify soil characteristics, identify areas of fill if any. Identify unacceptable fill material, analyse soil sulphate content, identify unsuitable underlying soils such as peat, etc. and make recommendations for remediation if necessary.
- (d) List extraordinary requirements that may be required to accommodate construction of roads and underground utilities as well as building foundation designs.
- (e) Additional geotechnical survey may be necessary for building foundations, etc.

5. Road Improvements

Nickel Rd must be upgraded to a 2-lane major collector along the full frontage of this proposed development including curb and gutter, LED street lights, irrigated landscaped boulevard, sidewalk, drainage system including catch basins, and pavement removal and replacement and re-location or adjustment of utility appurtenances if required to accommodate the upgrading construction. The road cross section to be used is SS-R5.

6. Subdivision

- (a) Grant Statutory Rights of Way if required for utility services.
- (b) Provide a 2.5m road dedication along the full frontage of Nickel Road.
- (c) If any road dedication or closure affects lands encumbered by a Utility right-of-way (such as Hydro, Telus, Gas, etc.) please obtain the approval of the utility. Any works required by the utility as a consequence of the road dedication or closure must be incorporated in the construction drawings submitted to the City's Development Manager.

7. Development Permit and Site Related Issues

- (a) Direct the roof drains into on-site rock pits or splash pads.
- (b) Provide for parking onsite.

8. Electric Power and Telecommunication Services

The electrical and telecommunication services to this building must be installed in an underground duct system, and the building must be connected by an underground service. It is the developer's responsibility to make a servicing application with the respective electric power, telephone and cable transmission companies to arrange for these services, which would be at the applicant's cost.

Z16-0064 3 -

9. Design and Construction

- a) Design, construction supervision and inspection of all off-site civil works and site servicing must be performed by a Consulting Civil Engineer and all such work is subject to the approval of the City Engineer. Drawings must conform to City standards and requirements.
- b) Engineering drawing submissions are to be in accordance with the City's "Engineering Drawing Submission Requirements" Policy. Please note the number of sets and drawings required for submissions.
- c) Quality Control and Assurance Plans must be provided in accordance with the Subdivision, Development & Servicing Bylaw No. 7900 (refer to Part 5 and Schedule 3).
- d) A "Consulting Engineering Confirmation Letter" (City document 'C') must be completed prior to submission of any designs.
- e) Before any construction related to the requirements of this subdivision application commences, design drawings prepared by a professional engineer must be submitted to the City's Development Engineering Department. The design drawings must first be "Issued for Construction" by the City Engineer. On examination of design drawings, it may be determined that rights-of-way are required for current or future needs.

10. Servicing Agreements for Works and Services

- a) A Servicing Agreement is required for all works and services on City lands in accordance with the Subdivision, Development & Servicing Bylaw No. 7900. The applicant's Engineer, prior to preparation of Servicing Agreements, must provide adequate drawings and estimates for the required works. The Servicing Agreement must be in the form as described in Schedule 2 of the bylaw.
- b) Part 3, "Security for Works and Services", of the Bylaw, describes the Bonding and Insurance requirements of the Owner. The liability limit is not to be less than \$5,000,000 and the City is to be named on the insurance policy as an additional insured.

11. Charges and Fees

- a) Development Cost Charges (DCC's) are payable
- b) Fees per the "Development Application Fees Bylaw" include:
 - i) Street/Traffic Sign Fees: at cost if required (to be determined after design).
 - ii) Survey Monument, Replacement Fee: \$1,200.00 (GST exempt) only if disturbed.
 - iii) Engineering and Inspection Fee: 3.5% of construction value (plus GST).



November 11, 2018

280 Nickel Road, Kelowna Design Rationale Statement



Z16-0064 Rezoning - RU to RM1
Development Permit
Development Variance Permit - section 13.7.6.(a)

The attached application for Rezoning, Development Permit and Development Variance Permit is submitted by Radec Group Inc. on behalf of 1126112 Alberta Ltd, owner and developer of 280 Nickel Road, Kelowna. The owners wishes to:

- Rezone the subject property from RU1 (Large Lot Housing) to RM1 (Four Dwelling Housing);
- Development Permit: construction of two 2-story duplexes for a total of four dwelling units
- Development Variance Permit: A variance to Section 13.7.6.(a)

Radec Group has discussed the proposed duplexes with the City of Kelowna's Planning Department and the preliminary concept was supported. The duplexes are targeted to meet the growing demand for entry-level ground oriented family housing and to revitalize the Rutland neighbourhood.

The street is characterized by single family homes and duplexes of older construction. A townhouse development is located two lots to the north. Immediately to the south, an application has been submitted for 16 townhomes. The subject property's Future Land use is designated as Multiple Unit Residential - Low Density (MRL) by the Official Community Plan, consistent with the proposed zoning of RM1. RM1 permits duplex housing and fourplex housing. Two side-by side duplexes are proposed for this property.

In keeping with the neighbourhood context, the overall height of the proposed building is limited to two storeys. Each dwelling unit is served by a shared driveway and has a one-car garage and one surface parking stall. A turnaround has been provided which permits forward motion access in and off the property.

Each 1,200 sf dwelling will consist of three bedrooms plus flex space, and an open-concept living, kitchen, and dining area. The end unit is has its front door oriented to the street, is served by a private walkway, and is framed by two lilac trees. The two-story homes have a gable roof and contemporary farmhouse appearance. The exterior finish is a mix of durable Hardie lap siding and board & batten siding



in soft greys. Entry doors are defined by a sage green colour, consistent with hues found in the local landscape.

Each home has a private amenity space well above the minimum requirement. The landscaping architecture prepared by Bench Site Design includes trees to provide screening along the rear and north side of the property, and include flowering lilacs in the spring and brightly hued maples in the falls. Coniferous trees provide year round greenery. The irrigated landscaping includes drought-resistant species in a variety of colours.

A variance to Section 13.7.6.(a) is requested in order to satisfy the parking requirements and provide forward-motion access to and from Nickel Road. Per 13.7.6.(a), site coverage including buildings, driveways and parking is 50%, we propose 59%. As a solution, we propose permeable pavers for the surface parking and a portion of the driveway, which reduces impermeable site coverage to 49%. Pavers also reduce quantity of asphalt paving and provide visual interest to the driveway. The site coverage for buildings is well under the permitted 40% at 28%. The remainder of the lot is fully landscaped with flowers, shrubs, grasses and a variety of trees.

Radec Group thanks the City of Kelowna for the opportunity to add thoughtfully designed and well-constructed ground orientated family living in the Rutland area. We respectfully request Rezoning, Development Permit, and Development Variance Permit.

Development Permit & Development Variance Permit DP18-0237/DVP18-0238



C

ATTACHMENT

This forms part of application

DP18-0237 & DVP18-0238

ΑJ

Planner

Initials

This permit relates to land in the City of Kelowna municipally known as

280 Nickel Road

and legally known as

Lot A Section 27 Township 26 ODYD Plan EPP87929

and permits the land to be used for the following development:

Four Dwelling Housing

with a variance to the following section of Zoning Bylaw No. 8000 in general accordance with Schedule "A":

Section 13.7.6(a)]: [RM1 - Four Dwelling Housing Development Regulations

To vary the required maximum site coverage of buildings, driveways and parking areas from 50% to 59% proposed.

The present owner and any subsequent owner of the above described land must comply with any attached terms and conditions.

Date of Council Decision:

Owner:

Decision By: Council

<u>Development Permit Area:</u> Comprehenisive Development Permit Area

This permit will not be valid if development has not commenced within two years of the issuance date.

Existing Zone: RM1 Future Land Use Designation: MRL

1126112 Alberta Ltd. Inc. No. A0084599

This is NOT a Building Permit.

In addition to your Development Permit, a Building Permit may be required prior to any work commencing. For further information, contact the City of Kelowna, Development Services Branch.

NOTICE

This permit does not relieve the owner or the owner's authorized agent from full compliance with the requirements of any federal, provincial or other municipal legislation, or the terms and conditions of any easement, covenant, building scheme or agreement affecting the building or land.

Applicant:	Radec Group		
Terry Barton Urban Plannir	ng Manager	Date	

1. SCOPE OF APPROVAL

This Development Permit applies to and only to those lands within the Municipality as described above, and any and all buildings, structures and other development thereon.

This Development Permit is issued subject to compliance with all of the Bylaws of the Municipality applicable thereto, except as specifically varied or supplemented by this permit, noted in the Terms and Conditions below.

The issuance of a permit limits the permit holder to be in strict compliance with regulations of the Zoning Bylaw and all other Bylaws unless specific variances have been authorized by the Development Permit. No implied variances from bylaw provisions shall be granted by virtue of drawing notations that are inconsistent with bylaw provisions and that may not have been identified as required Variances by the applicant or Municipal staff.

2. CONDITIONS OF APPROVAL

- a) The dimensions and siting of the building to be constructed on the land be in accordance with Schedule "A";
- b) The exterior design and finish of the building to be constructed on the land be in accordance with Schedule "B";
- c) Landscaping to be provided on the land be in accordance with Schedule "C"; and
- d) The applicant be required to post with the City a Landscape Performance Security deposit in the form of a "Letter of Credit" in the amount of 125% of the estimated value of the landscaping, as determined by a Registered Landscape Architect.

This Development Permit is valid for two (2) years from the date of Council approval, with no opportunity to extend.

3. PERFORMANCE SECURITY

As a condition of the issuance of this Permit, Council is holding the security set out below to ensure that development is carried out in accordance with the terms and conditions of this Permit. Should any interest be earned upon the security, it shall accrue to the Developer and be paid to the Developer or his or her designate if the security is returned. The condition of the posting of the security is that should the Developer fail to carry out the development hereby authorized, according to the terms and conditions of this Permit within the time provided, the Municipality may use enter into an agreement with the property owner of the day to have the work carried out, and any surplus shall be paid over to the property own of the day. Should the Developer carry out the development permitted by this Permit within the time set out above, the security shall be returned to the Developer or his or her designate. There is filed accordingly:

a) An Irrevocable Letter of Credit or certified cheque in the amount of \$26,793.75

Before any bond or security required under this Permit is reduced or released, the Developer will provide the City with a statutory declaration certifying that all labour, material, workers' compensation and other taxes and costs have been paid.

4. INDEMNIFICATION

Upon commencement of the works authorized by this Permit the Developer covenants and agrees to save harmless and effectually indemnify the Municipality against:

a) All actions and proceedings, costs, damages, expenses, claims, and demands whatsoever and by whomsoever brought, by reason of the Municipality said Permit.


All costs, expenses, claims that may be incurred by the Municipality where the construction, engineering or other types of works as called for by the Permit results in damages to any property owned in whole or in part by the Municipality or which the Municipality by duty or custom is obliged, directly or indirectly in any way or to any degree, to construct, repair, or maintain.

The PERMIT HOLDER is the <u>CURRENT LAND OWNER</u>.

Security shall <u>ONLY</u> be returned to the signatory of the Landscape Agreement or their designates.



NOTE: SITE PLAN T BE READ IN CONJUCTION WITH CIVIL AND LANDSCAPE DRAWINGS

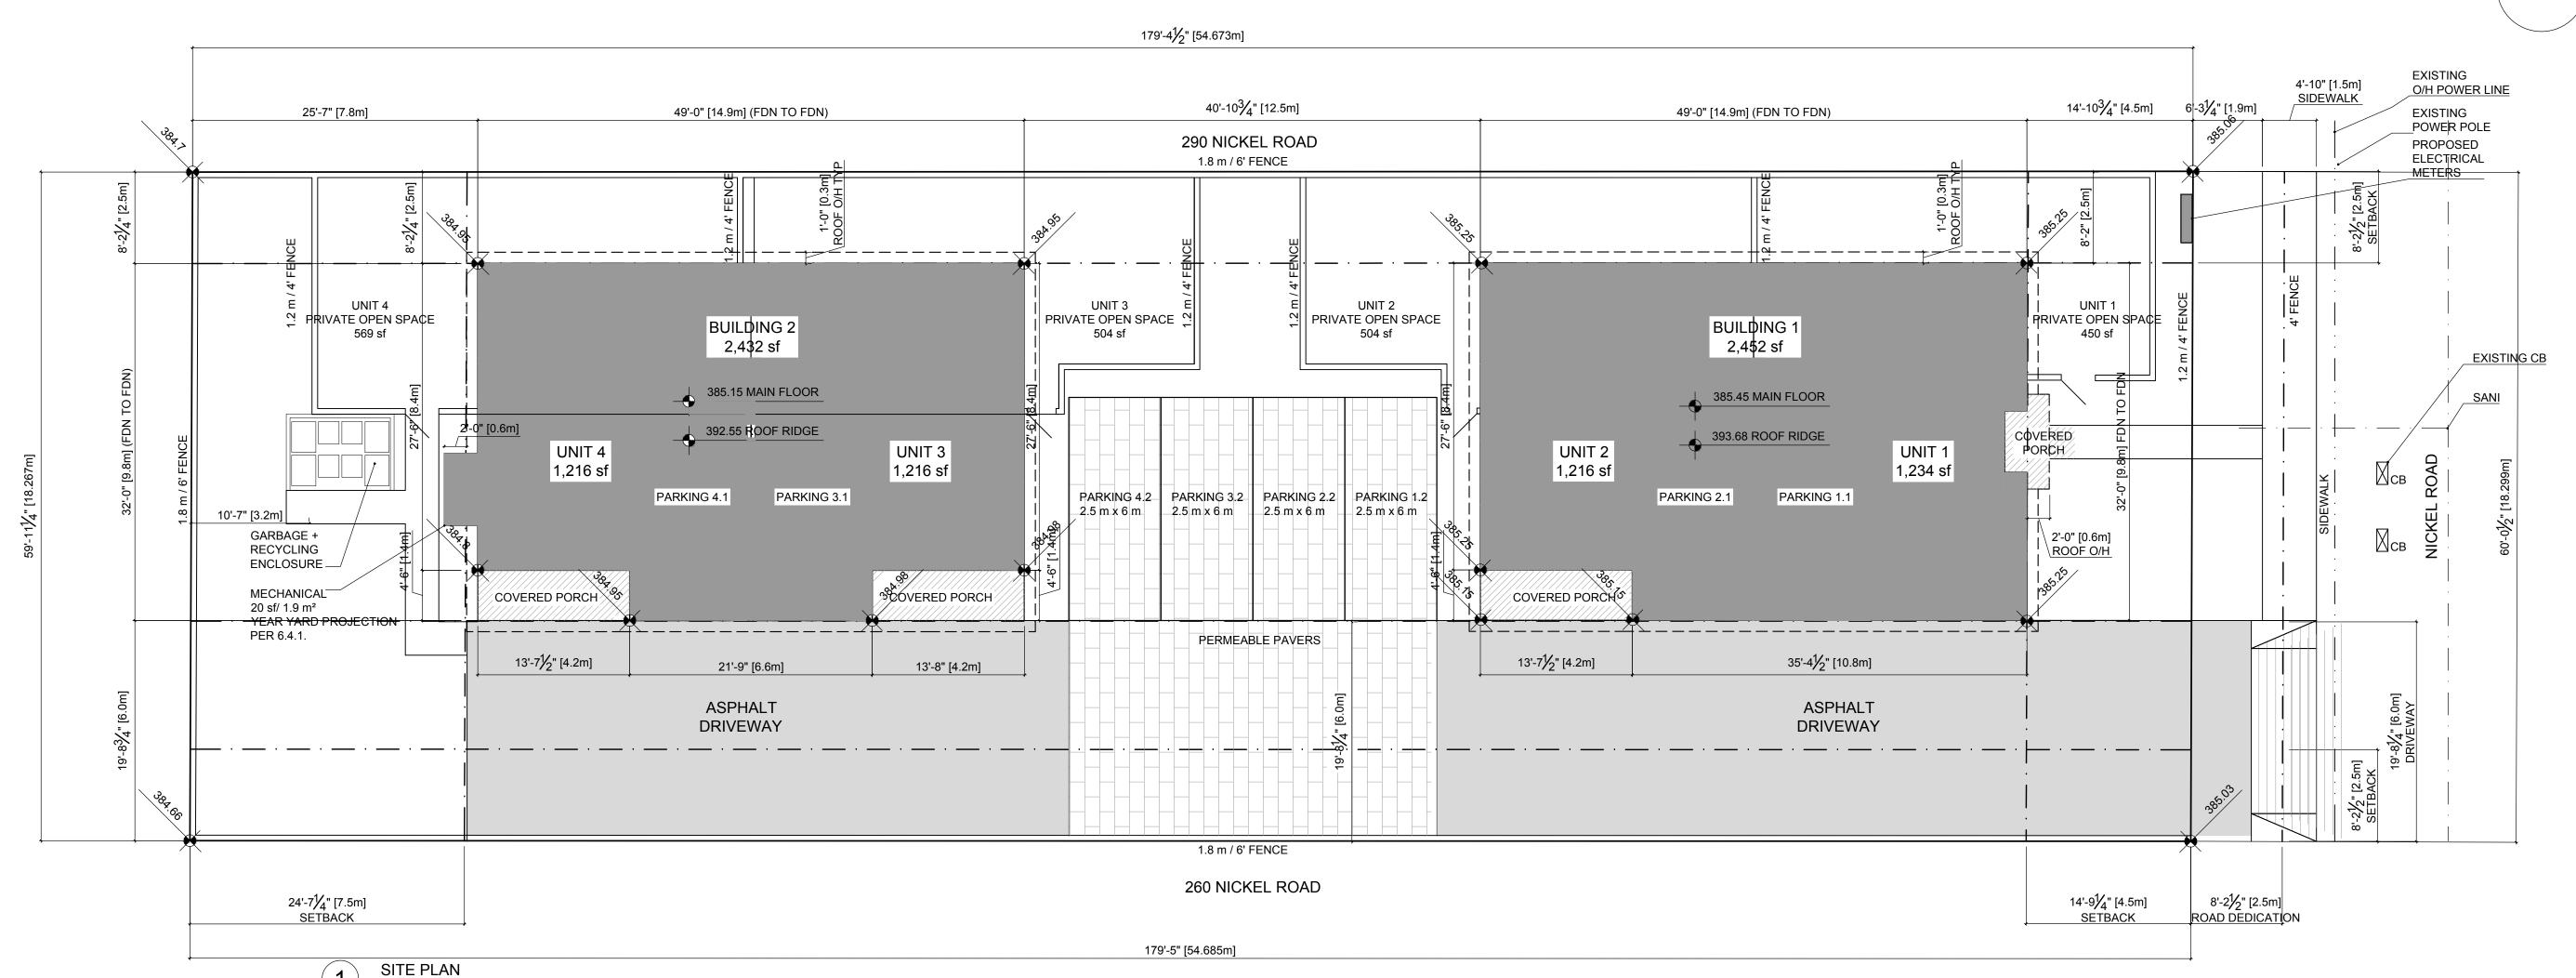

1/8" = 1'-0" LOT AREA: 1,045.14 m² / 11,250 sf SITE COVERAGE (BLDGS): 291 m² / 3,136 sf / 28% SITE COVERAGE (BLDGS, DRIVEWAY, PARKING): 617 m² / 6,637 sf / 59% SITE COVERAGE (IMPERMEABLE DRIVEWAY + PARKING, BLDGS): 512 m² / 5,513 sf / 49% GARNET

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ALL CONSTRUCTION TO BE COMPLIANCE WITH LOCAL BUILDING CODE, CURRENT EDITION AND ALL APPLICABLE CODES AND BY-LAWS

GENERAL CONTRACTOR AND/OR SUBTRADES AS SHOWN ON DRAWINGS WITH ACTUAL EXISTING CONDITIONS. ANY DISCREPANCIES TO BE REPORTED PRIOR TO COMMENCEMENT OF CONSTRUCTION AND/OR INSTALLATION.

IF IN DOUBT, ASK.

GARNET DESIGN STUDIO PHONE: 604.789.4418

NOTES:

REV	DATE	DESCRIPTION
0	Jul 26, 2018	ISSUED FOR COORDINATION
1	Nov 17, 2018	
2	Jan 29, 2019	RE-ISSUED FOR RZ/DP
3	May 8, 2019	RE-ISSUED FOR RZ/DP
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PROJECT

NICKEL ROAD DUPLEXES

ADDRESS


280 Nickel Road Kelowna, BC V1X 4E6

SHEET TITLE

SITE PLAN

SCALE SHEET No.

 $\frac{1}{8}$ " = 1'-0"

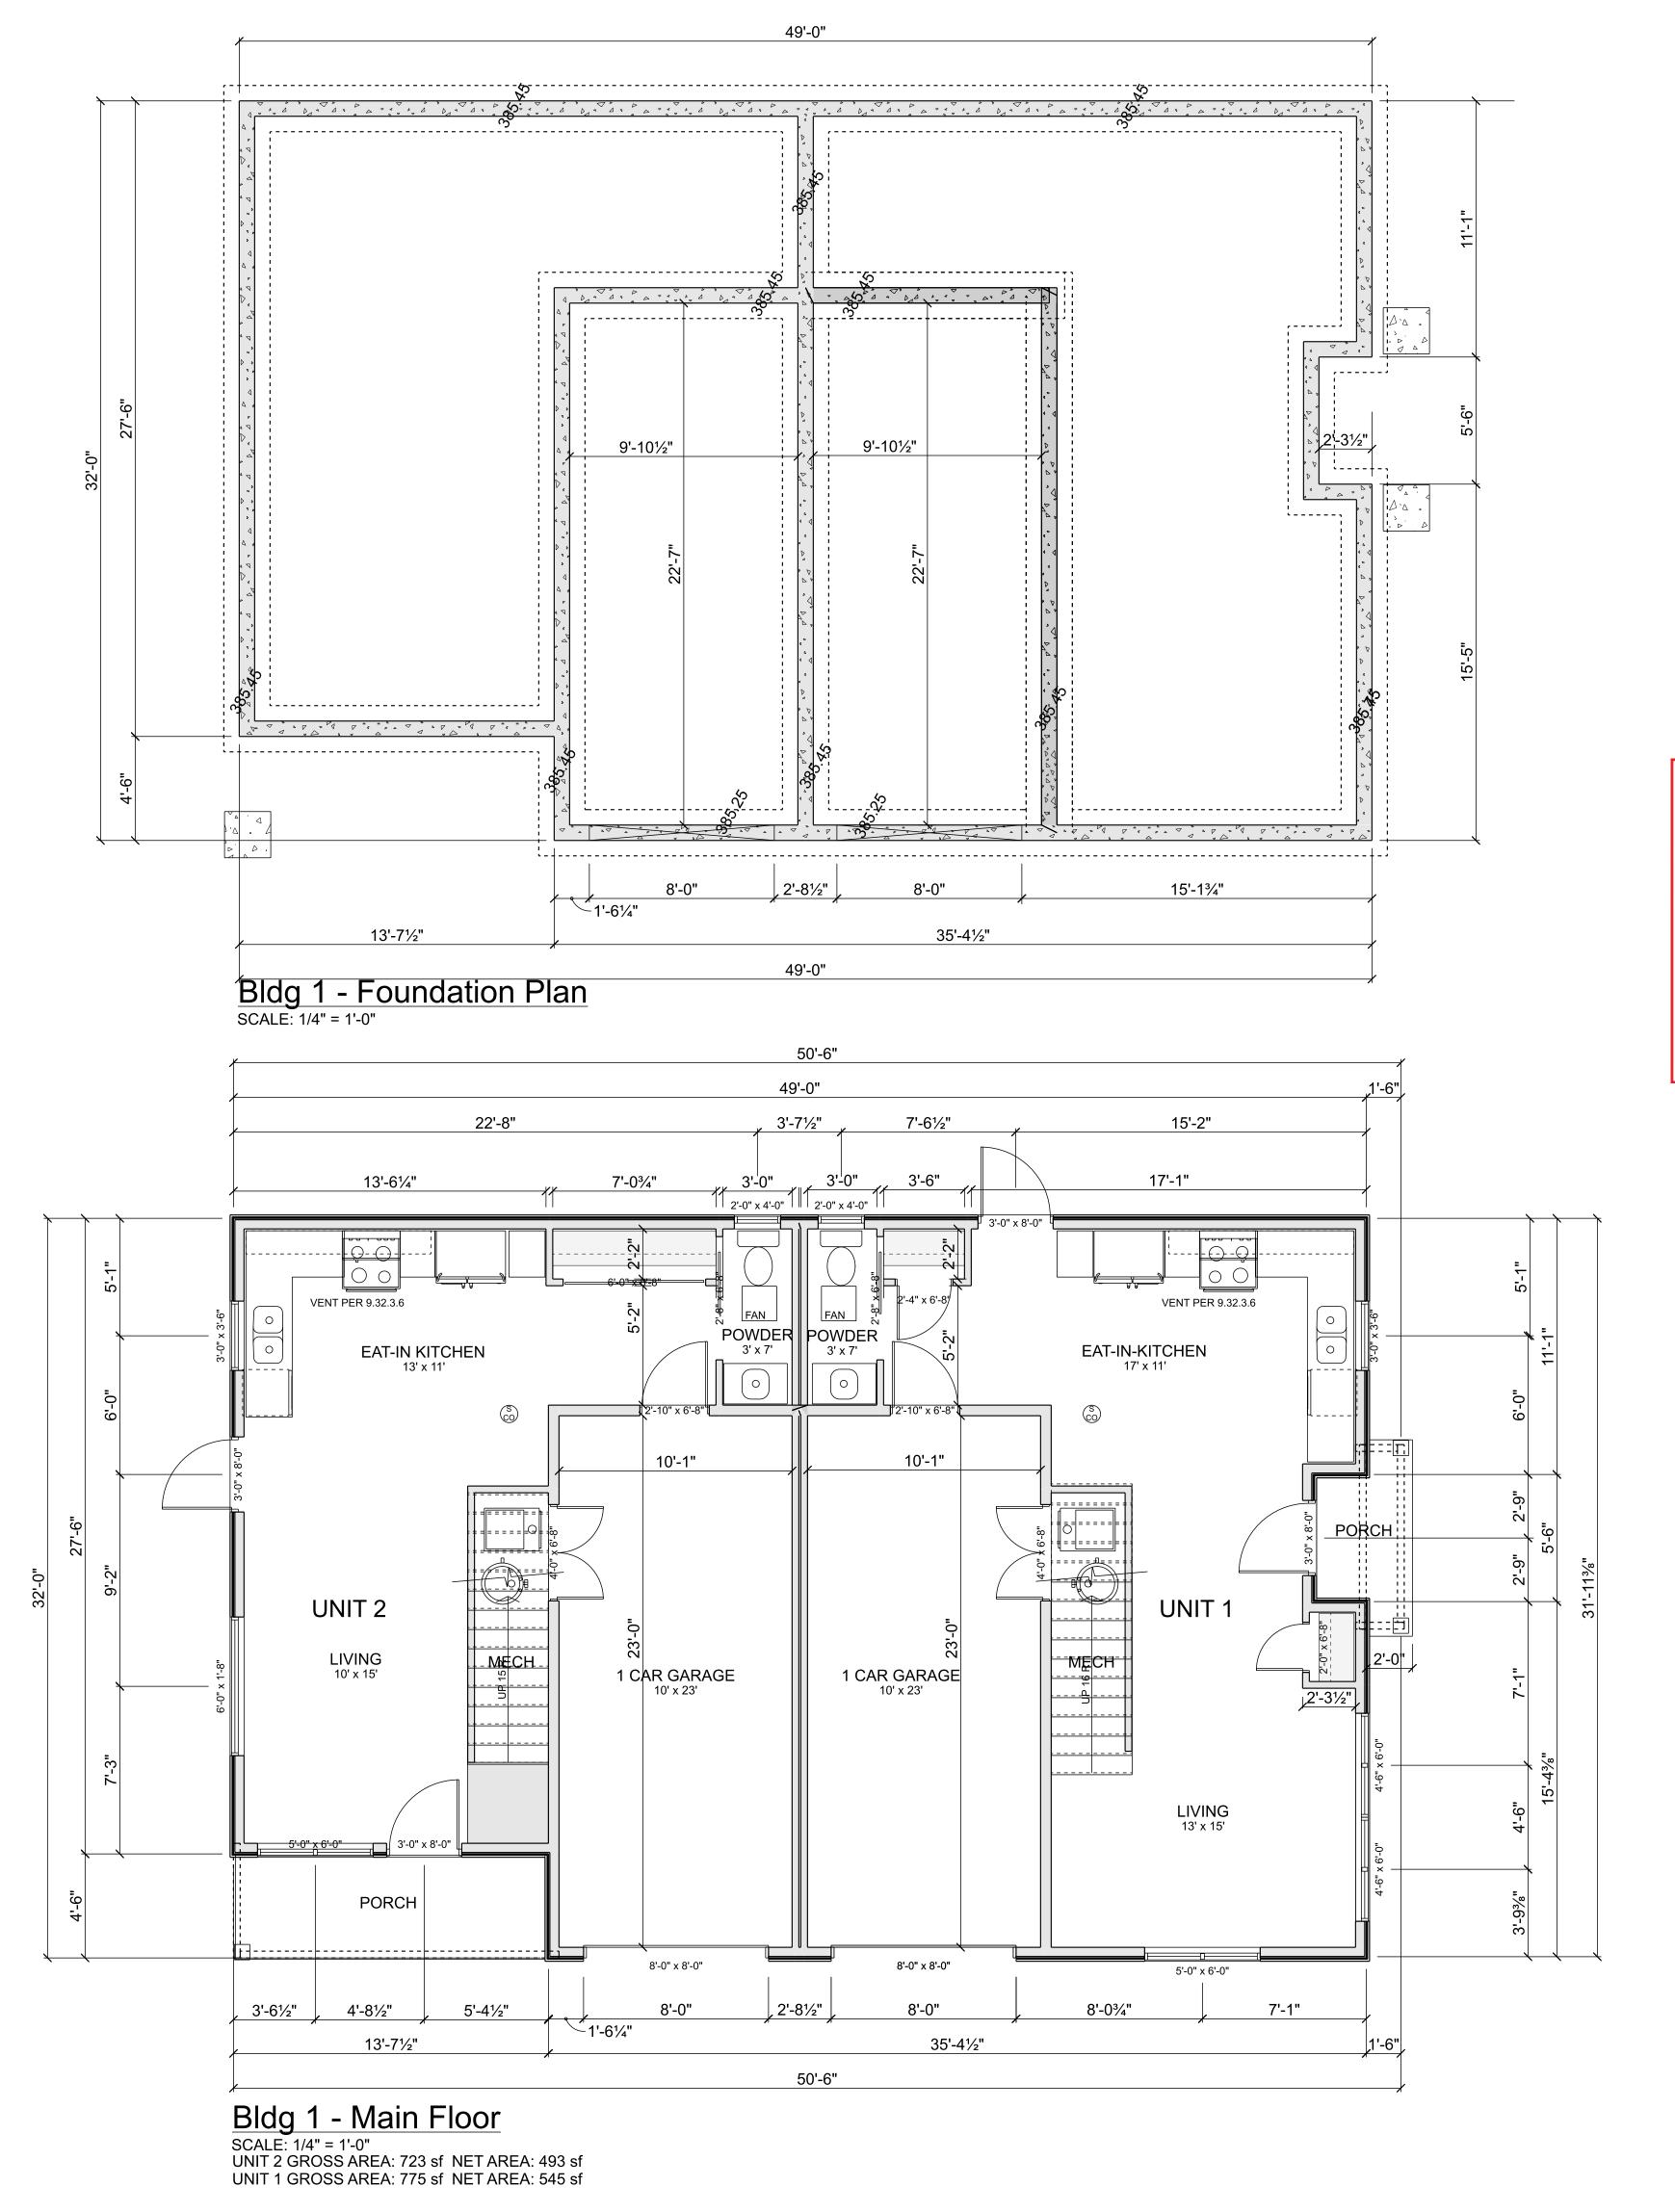

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TO VERIFY ALL DIMENSIONS AND CONDITIONS AS SHOWN ON DRAWINGS WITH ACTUAL EXISTING CONDITIONS. ANY DISCREPANCIES TO BE REPORTED PRIOR TO COMMENCEMENT OF CONSTRUCTION AND/OR INSTALLATION.

IF IN DOUBT, ASK.

GARNET DESIGN STUDIO PHONE: 604.789.4418

NOTES:

SCHEDULE

This forms part of application # DP18-0237 & DVP18-0238

Planner Initials

AJ

REV	DATE	DESCRIPTION
0	Jul 26, 2018	ISSUED FOR COORDINATION
1	Nov 17, 2018	ISSUED FOR RZ/DP
2	Jan 29, 2018	RE-ISSUED FOR RZ/DP

PROJECT


NICKEL ROAD **DUPLEXES**

ADDRESS

280 Nickel Road Kelowna, BC V1X 4E6

SHEET TITLE BUILDING 1 FOUNDATION + MAIN FLOOR PLAN

SHEET No.

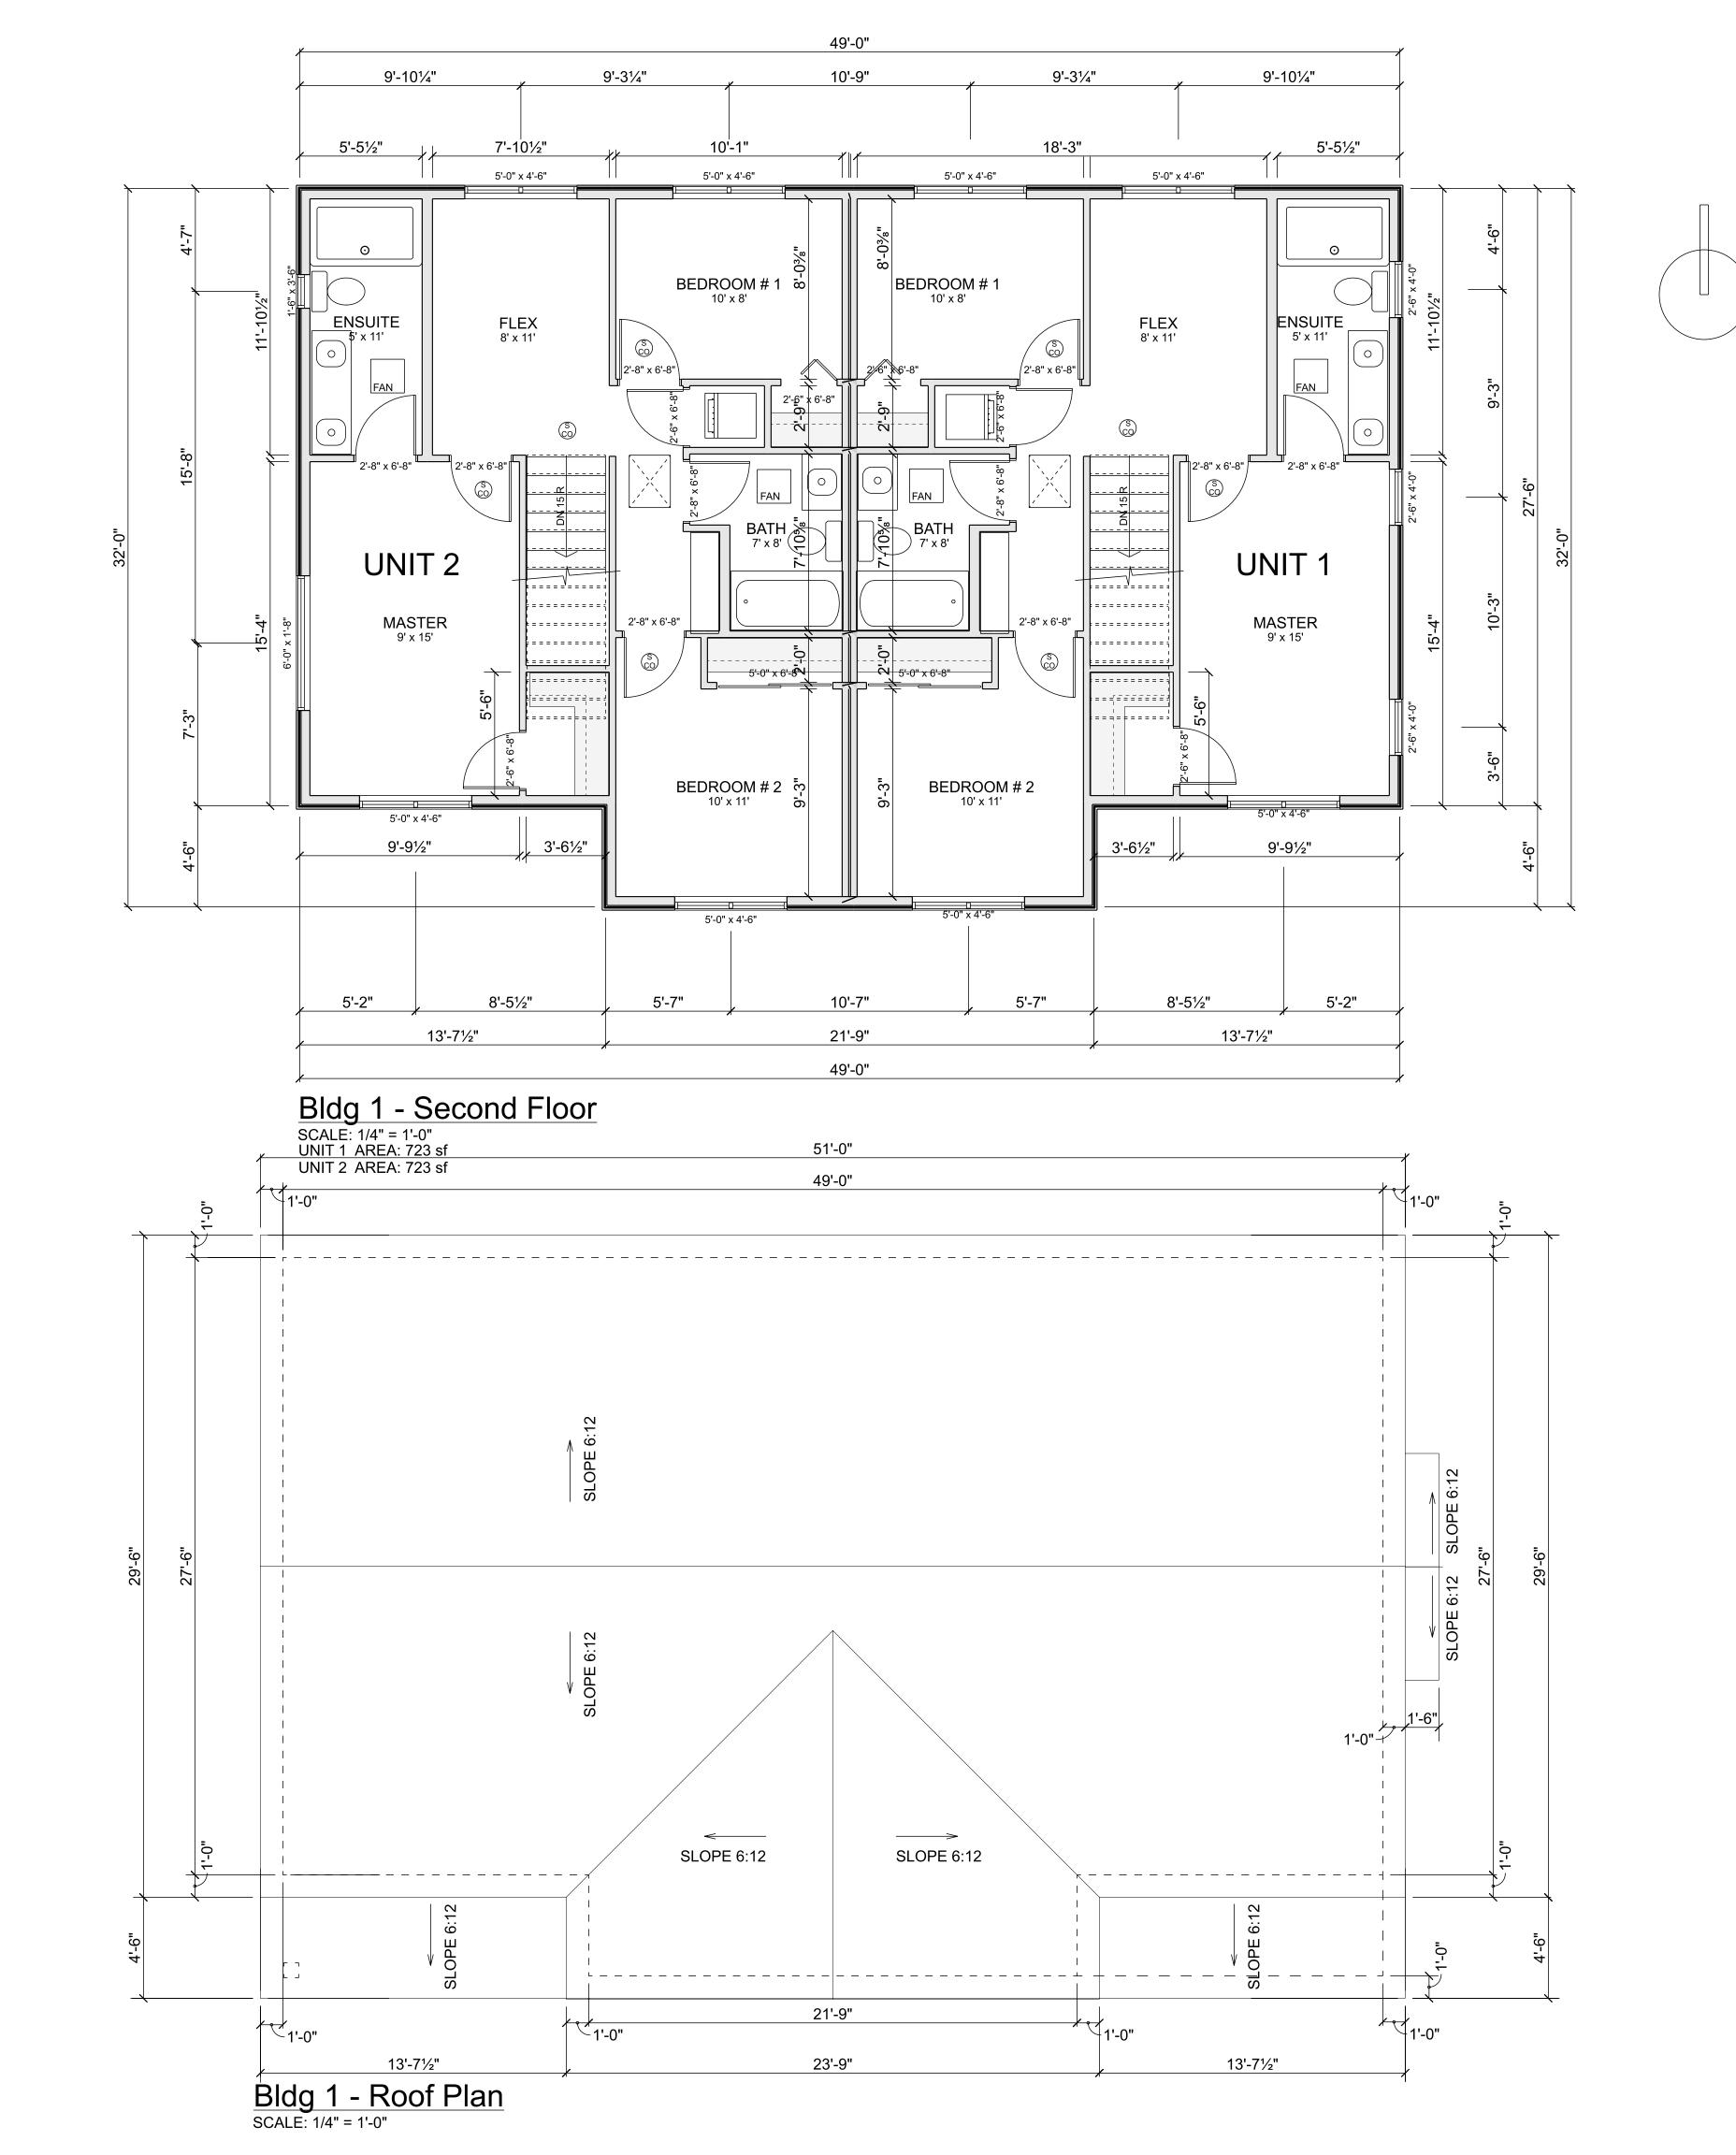



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GARNET DESIGN STUDIO PHONE: 604.789.4418

NOTES:

SCHEDULE



City of Valous

This forms part of application # DP18-0237 & DVP18-0238

Planner Initials

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PROJECT

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280 Nickel Road Kelowna, BC V1X 4E6


SHEET TITLE

BLDG 1 SECOND FLOOR + ROOF PLAN

SCALE 1/4" = 1'-0"

SCALE SHEET No.



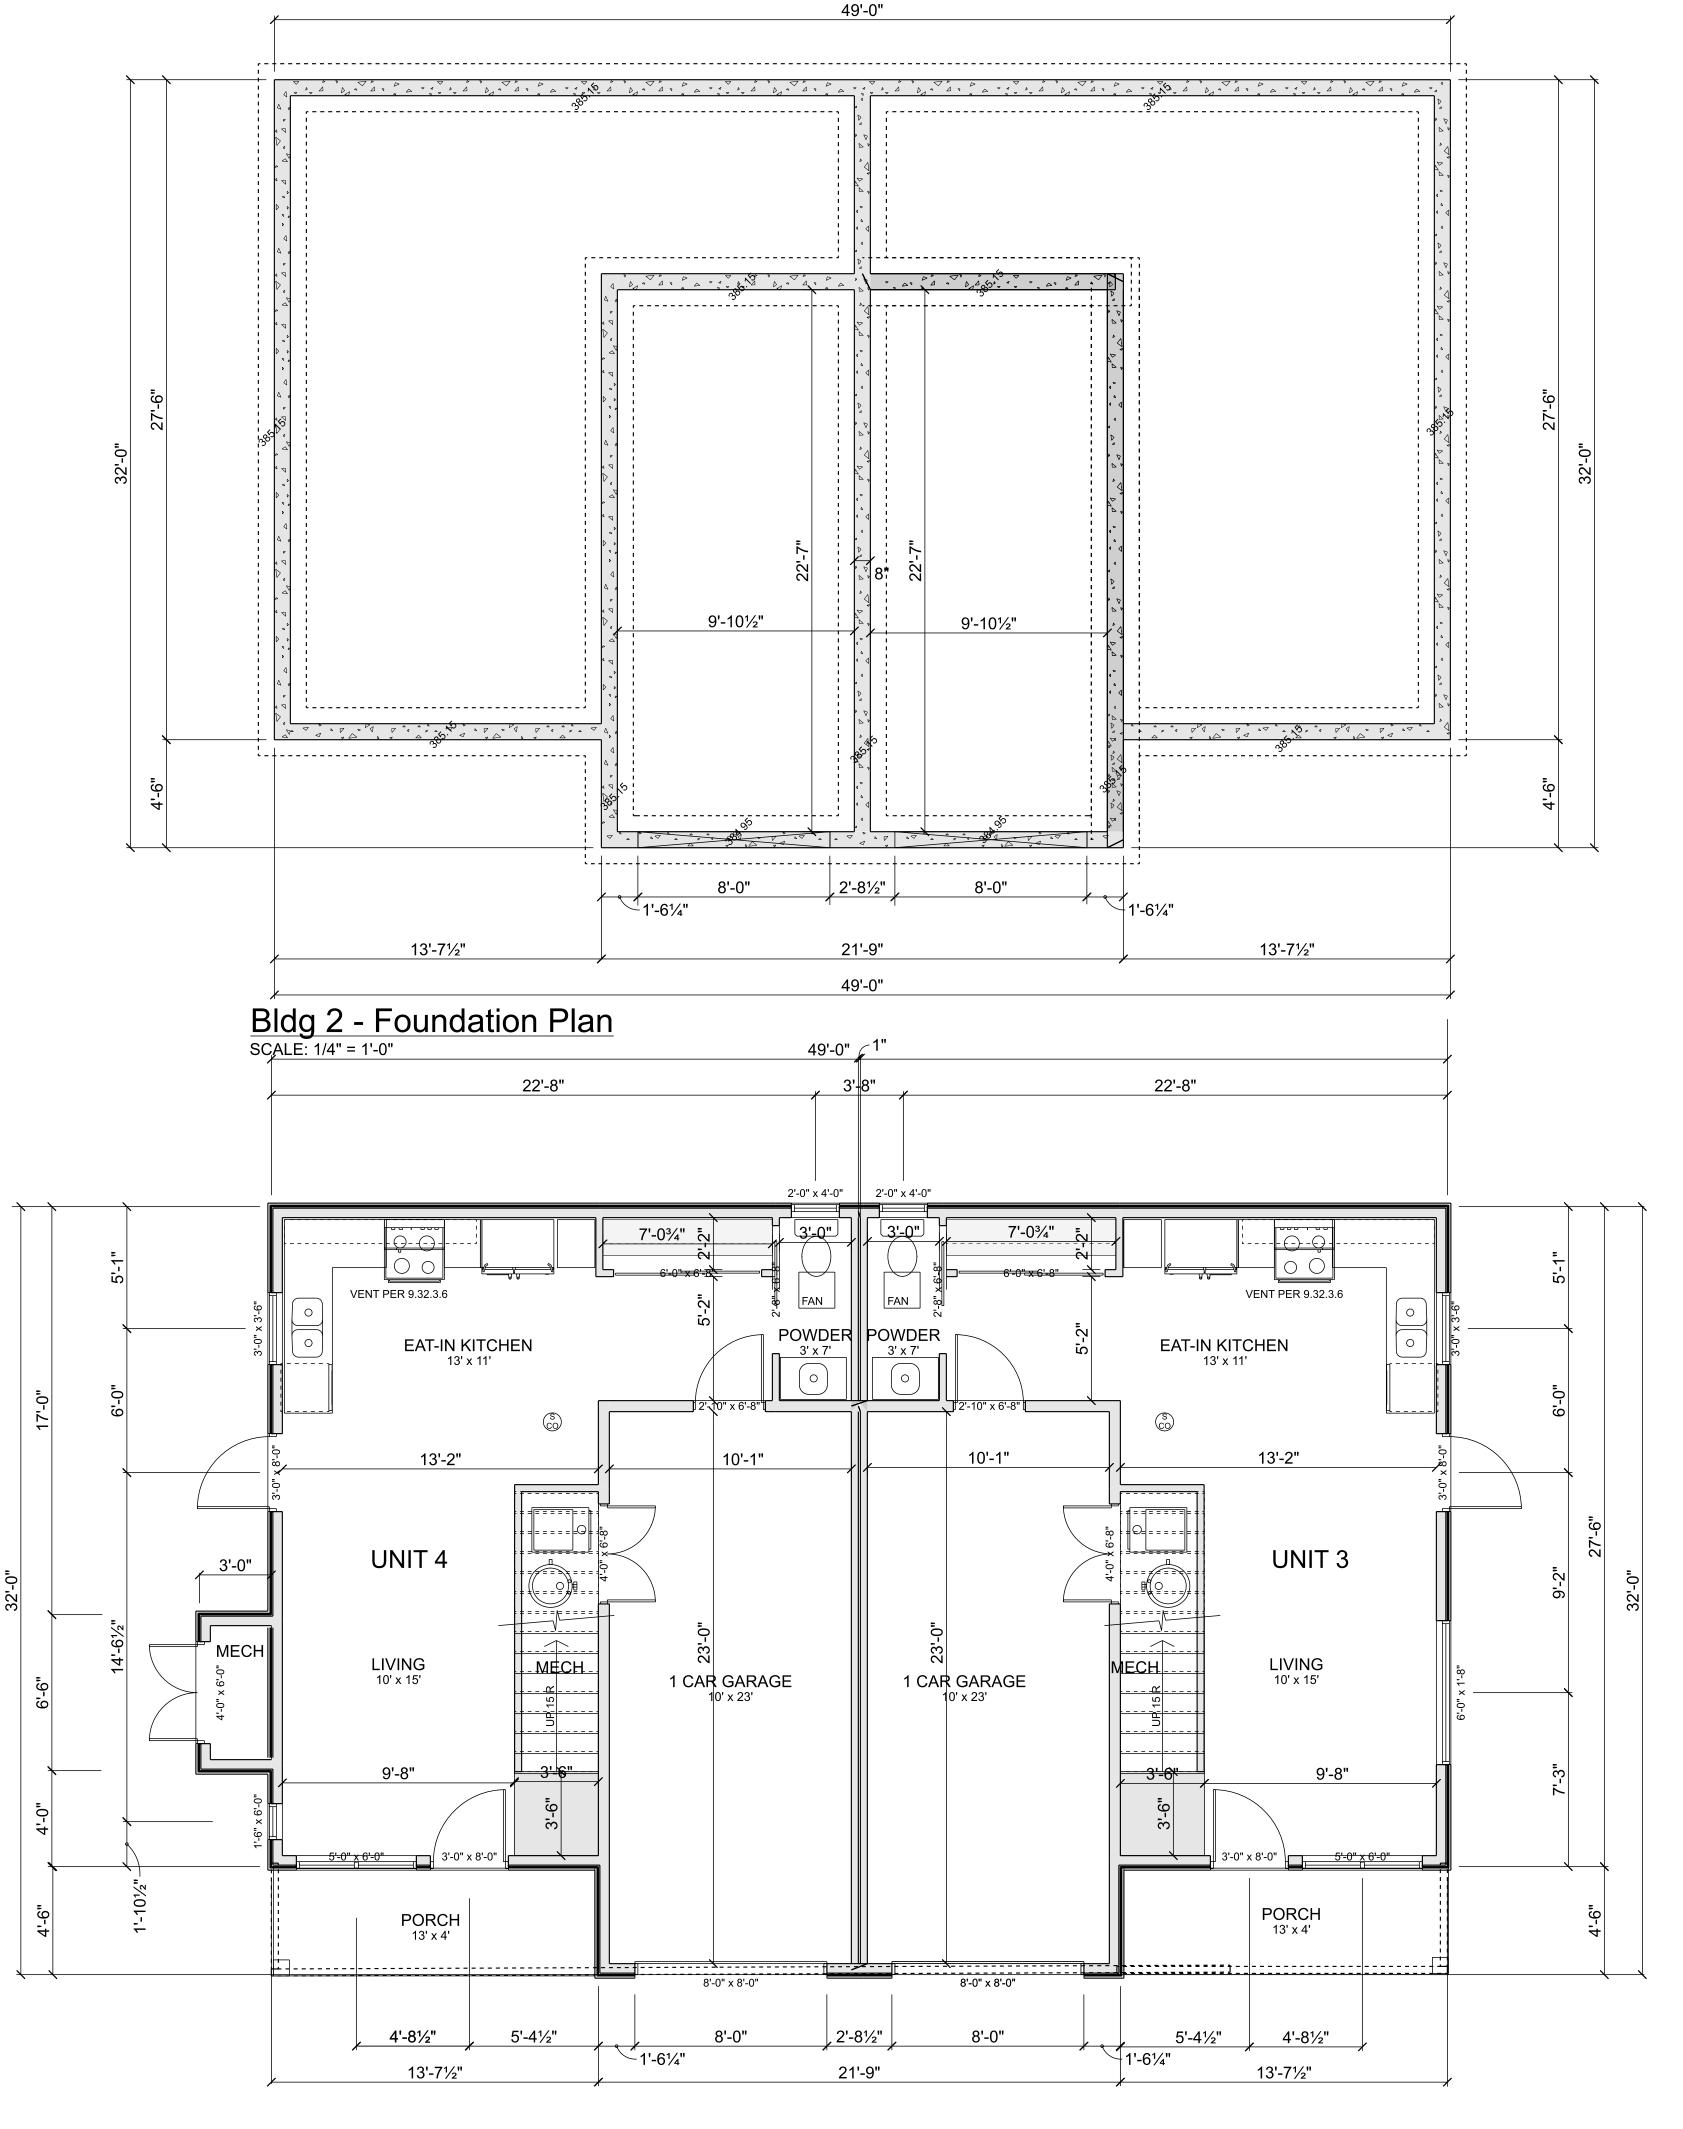

Bldg 2 - Main Floor SCALE: 1/4" = 1'-0"

UNIT 4 GROSS AREA: 775 sf NET AREA: 545 sf UNIT 3 GROSS AREA: 775 sf NET AREA: 545 sf

GARNET

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IF IN DOUBT, ASK.

GARNET DESIGN STUDIO PHONE: 604.789.4418

NOTES:

SCHEDULE A

This forms part of application # DP18-0237 & DVP18-0238

Initials

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0	Jul 26, 2018	ISSUED FOR COORDINATION
1	Nov 17, 2018	ISSUED FOR RZ/DP
2	Jan 29, 2019	RE-ISSUED FOR RZ/DP

PROJECT


NICKEL ROAD **DUPLEXES**

280 Nickel Road Kelowna, BC V1X 4E6

BUILDING 2 FOUNDATION + MAIN FLOOR PLAN 1/4" = 1'-0"

SHEET No.



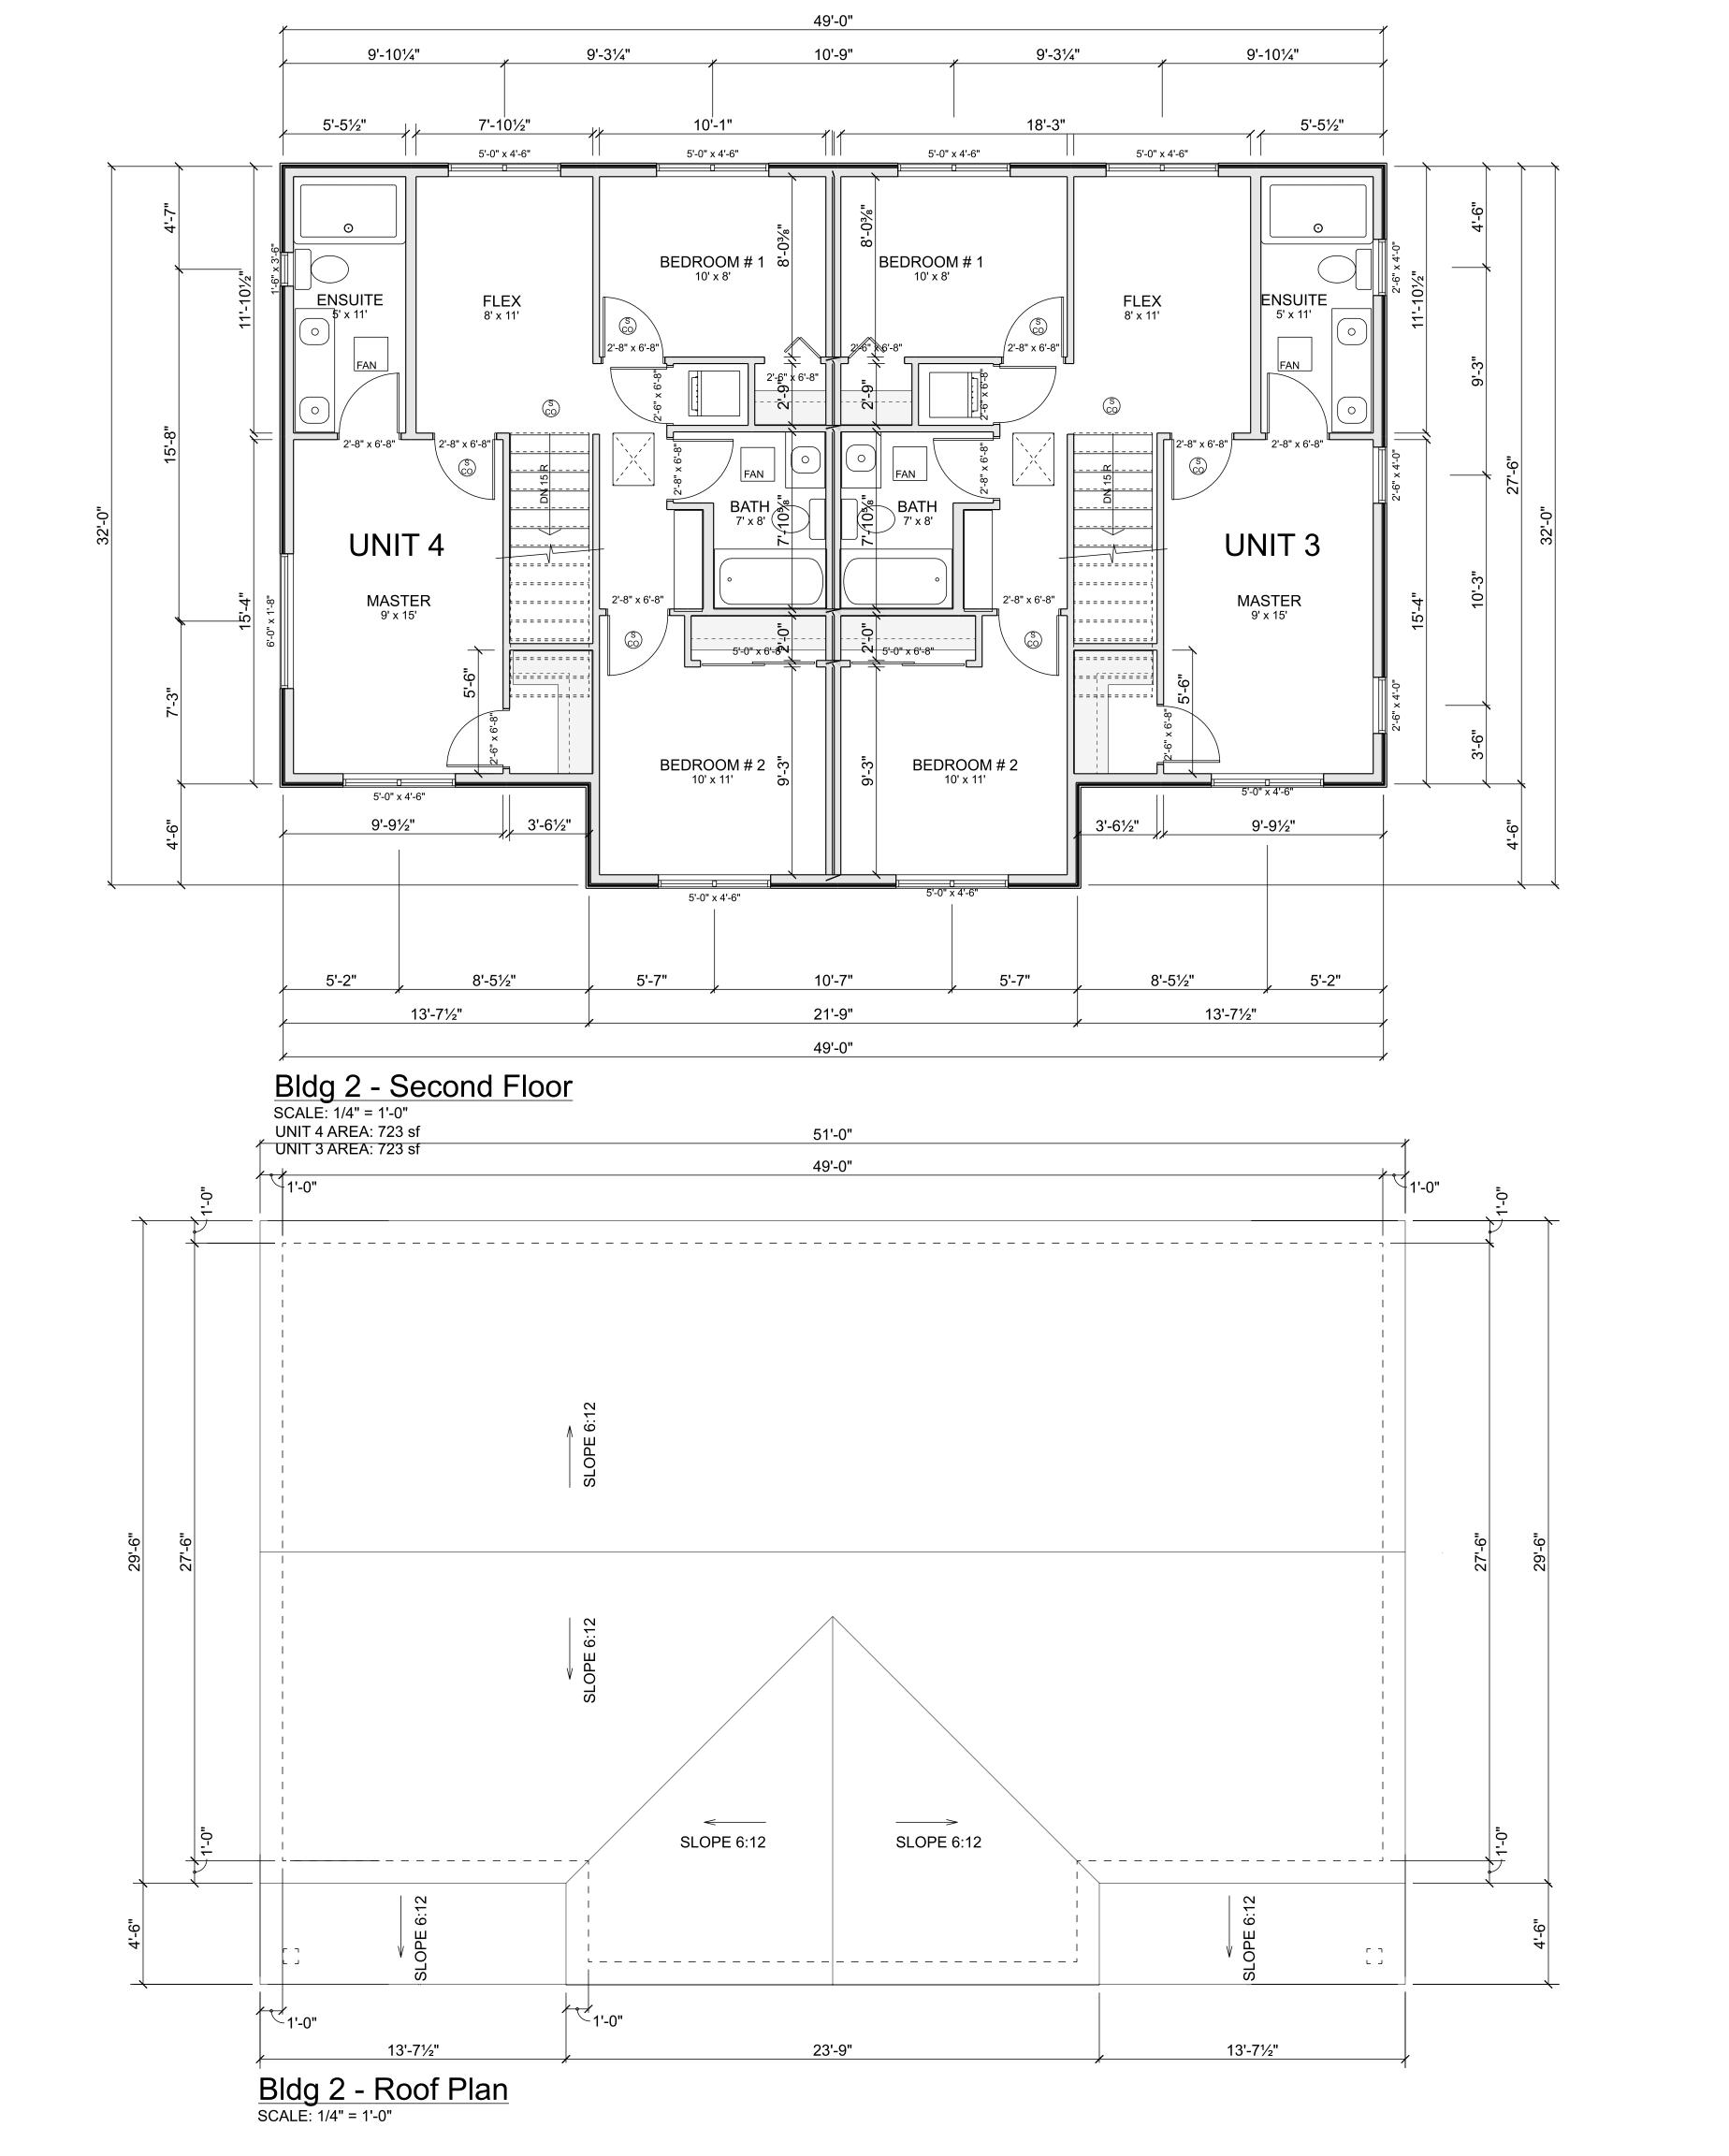

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OF CONSTRUCTION AND/OR INSTALLATION.

IF IN DOUBT, ASK.

GARNET DESIGN STUDIO PHONE: 604.789.4418

NOTES:

SCHEDULE

A

This forms part of application # DP18-0237 & DVP18-0238

Planner Initials AJ Kelowna

REV DATE DESCRIPTION

0 Jul 26, 2018 ISSUED FOR COORDINATION

1 Nov 17, 2018 ISSUED FOR RZ/DP

2 Jan 29, 2018 RE-ISSUED FOR RZ/DP

PROJECT

NICKEL ROAD DUPLEXES

ADDRESS

280 Nickel Road Kelowna, BC V1X 4E6

SHEET TITLE

BLDG 2 - SECOND FLOOR + ROOF PLAN

SCALE 1/4" = 1'-0"

SHEET No.

PROJECT STATISTICS:

MUNICIPAL ADDRESS 280 NICKEL ROAD, KELOWNA, BC V1X 4E6 009-781-366

OCP

LEGAL DESCRIPTION LOT 4 SECTION 27 TOWNSHIP 26 OSOYOOS

DIVISION YALE DISTRICT PLAN 8839

CURRENT ZONING

RU1 - LARGE LOT HOUSING

RM1 - FOUR DWELLING HOUSING PROPOSED ZONING

PROPOSED TWO DUPLEXES (FOUR DWELLING UNITS TOTAL)

EACH DWELLING: 2-STOREYS, 3 BEDROOM w/ ATTACHED 1-CAR GARAGE + 1 SURFACE PARKING

LOT AREA 1,045.14 m² / 11,250 sf

> PERMITTED PROPOSED

MRL (MULTIPLE UNIT RESIDENTIAL, LOW DENSITY)

49% (512 m² /5,513 sf)

MAXIMUM SITE COVERAGE 40% (418 m² /4,500 sf) 28% (291 m²/3,136 sf)

VARIANCE

MAXIMUM SITE COVERAGE 50% (522.6 m² /5,625 sf) 59% (617 m² /6,637 sf) BUILDINGS, DRIVEWAYS, PARKING

MAXIMUM SITE COVERAGE IMPERMEABLE DRIVEWAYS, PARKING, BUILDINGS

MAXIMUM F.A.R.

0.44

TOTAL NET FLOOR AREA 627 m² /6,750 sf 456.7 m² /4,916 sf TOTAL NET FLOOR AREA - BLDG 1 227.7 m² / 2,484 sf

TOTAL NET FLOOR AREA - BLDG 2 225.8 m² / 2,432 sf MINIMUM FRONT YARD 4.5 m 4.5 m (14'-9") MINIMUM SIDE YARD NORTH 2.5 m 2.5 m (8'-3") MINIMUM SIDE YARD SOUTH 2.5 m

6.0 m (19'-10") 7.5 m (24'-7") MINIMUM REAR YARD 8.2 m / 27'-0" (2 storeys) MAXIMUM HEIGHT 9.5 m / 2.5 storeys

PRIVATE OPEN SPACE 25 m² / 269 sf

42 m² / 450 sf UNIT 1 UNIT 2 47 m² / 504 sf UNIT 3 47 m² / 504 sf UNIT 4 53 m² / 569 sf

PARKING 8 (2 per 3-bed dwelling) 8 (2 per 3-bed dwelling) **BUILDING 1** FLOOR AREA

UNIT 01 -MAIN LVL SECOND LVL 723 sf 1,498 sf 723 sf 1,268 sf MAIN LVL SECOND LVL 723 sf 1,446 sf 1,216 sf 723 sf UNIT 03 -723 sf MAIN LVL 1,216 sf SECOND LVL 723 sf 1,446 sf 723 sf 1,216 sf

CONTACT:

DESIGN: Paula Guerra

GARNET DESIGN STUDIO INC. 604.789.4418

paula@garnetdesignstudio.com paula@radecgroup.com

CONSTRUCTION: RADEC GROUP

955 Timmins Penticton, BC V2A 5V3 250.492.0069

alan@radecgroup.com

CIVIL + STRUCTURAL: Dan Salhstrom, P. Eng WSA ENGINEERING (2012) LTD 2248 Columbia Ave

Castlegar, BC V1N 2X1 1.888.617.6927 x 1 dans@wsaeng.ca

GEOTECHNICAL: Jennifer Anderson, P. Eng NTERIOR TESTING SERVICES LTD.

#1-1925 Kirschner Road Kelowna, BC V1Y 1N7 250.860.6540 jennifer@interiortesting.com

SURVEYOR: Gary Borne, BCLS

VECTOR GEOMATICSSURVEYING & LTD

170-1855 Kirschner Road Kelowna, BC V1Y 4N7 250.801.3594 gary.borne@vectorgeomatics.com

keith@benchsitedesign.com

LANDSCAPE: Keith Nyhof, BCLSA BENCH SITE DESIGN INC. 4-1652 Water St Kelowna, BC V1Y 1J7 250.470.2342

LIST OF DRAWINGS:

SITE PLAN

BLDG 1 - FOUNDATION + MAIN FLOOR PLAN

BLDG 1 -SECOND FLOOR + ROOF PLAN BLDG 2 - FOUNDATION + MAIN FLOOR PLAN

BLDG 2 -SECOND FLOOR + ROOF PLAN


BLDG 1 - ELEVATIONS BLDG 1 - ELEVATIONS

BLDG 2 - ELEVATIONS BLDG 2 - ELEVATIONS

BLDG 1 - COLOURED ELEVATIONS BLDG 1 - COLOURED ELEVATIONS A12

BLDG 2 - COLOURED ELEVATIONS A13

BLDG 2 - COLOURED ELEVATIONS STREET ELEVATION

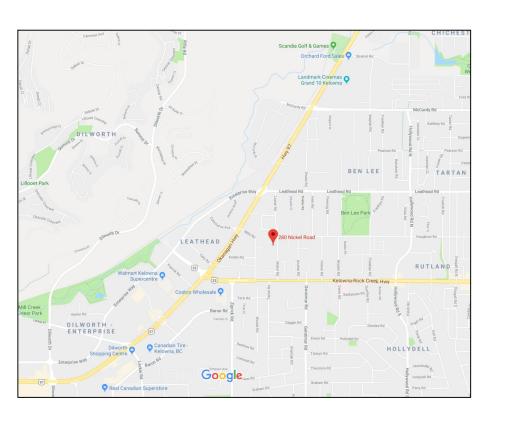



EXISTING VIEW FROM NICKEL ROAD



STREET VIEW OPPOSITE





STREETVIEW OPPOSITE TO SOUTH

SCHEDULE

B

GARNET

COPYRIGHT: GARNET DESIGN STUDIO INC.

COMPLIANCE WITH LOCAL BUILDING CODE, CURRENT EDITION AND ALL APPLICABLE CODES

GENERAL CONTRACTOR AND/OR SUBTRADES TO VERIFY ALL DIMENSIONS AND CONDITIONS

TO BE REPORTED PRIOR TO COMMENCEMENT

OF CONSTRUCTION AND/OR INSTALLATION.

AS SHOWN ON DRAWINGS WITH ACTUAL EXISTING CONDITIONS. ANY DISCREPANCIES

OTHERWISE NOTED. DO NOT SCALE.

AND BY-LAWS

IF IN DOUBT, ASK.

GARNET DESIGN STUDIO

PHONE: 604.789.4418

ALL CONSTRUCTION TO BE

ALL DIMENSIONS IN FEET AND INCHES UNLESS

This forms part of application # DP18-0237 & DVP18-0238

Planner







RENDERING - SOUTH ELEVATION

REV DATE DESCRIPTION Jul 26, 2018 ISSUED FOR COORDINATION 1 Nov 17, 2018 ISSUED FOR RZ/DP 2 Jan 29, 2019 RE-ISSUED FOR RZ/DP 3 May 8 2019 RE-ISSUED FOR RZ/DP

PROJECT NICKEL ROAD

DUPLEXES ADDRESS

Kelowna, BC V1X 4E6

SHEET No.

SHEET TITLE **COVER SHEET**

280 Nickel Road

SCALE as noted

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- ALL CONSTRUCTION TO BE COMPLIANCE WITH LOCAL BUILDING CODE, CURRENT EDITION AND ALL APPLICABLE CODES AND BY-LAWS
- GENERAL CONTRACTOR AND/OR SUBTRADES TO VERIFY ALL DIMENSIONS AND CONDITIONS AS SHOWN ON DRAWINGS WITH ACTUAL EXISTING CONDITIONS. ANY DISCREPANCIES TO BE REPORTED PRIOR TO COMMENCEMENT OF CONSTRUCTION AND/OR INSTALLATION.
- IF IN DOUBT, ASK.
- GARNET DESIGN STUDIO PHONE: 604.789.4418

NOTES:

SCHEDULE

B

This forms part of application # DP18-0237 & DVP18-0238

Planner Initials






Top of Ridge 393.68 Midpoint of Roof Top of Plate Second Floor 388.5 3'-0" x 3'-6" Main Floor 385.45 Grade 385.25

Bldg 1 - East Elevation Coloured (View from street)
SCALE: 1/4" = 1'-0"

1 Asphalt Single Roof, IKE Cambridge "WeatherWood"
2 Hardie 6" Lap Siding, "Pearl Grey"
3 Hardie Board & Batten Siding @ 16" OC, "Pearl Grey"
4 Hardie Board & Batten Siding @ 16" OC, "Aged Pewter"
5 Trim and Fascia, painted Sherwin Williams "Snowbound" SW 7004
6 Soffits, Gutters and Downspouts, Alumipro "801 White"
7 Doors, painted Sherwin Williams "Oyster Bay" SW 6206
8 White Vinyl Windows
9 Satin Etch Glazing

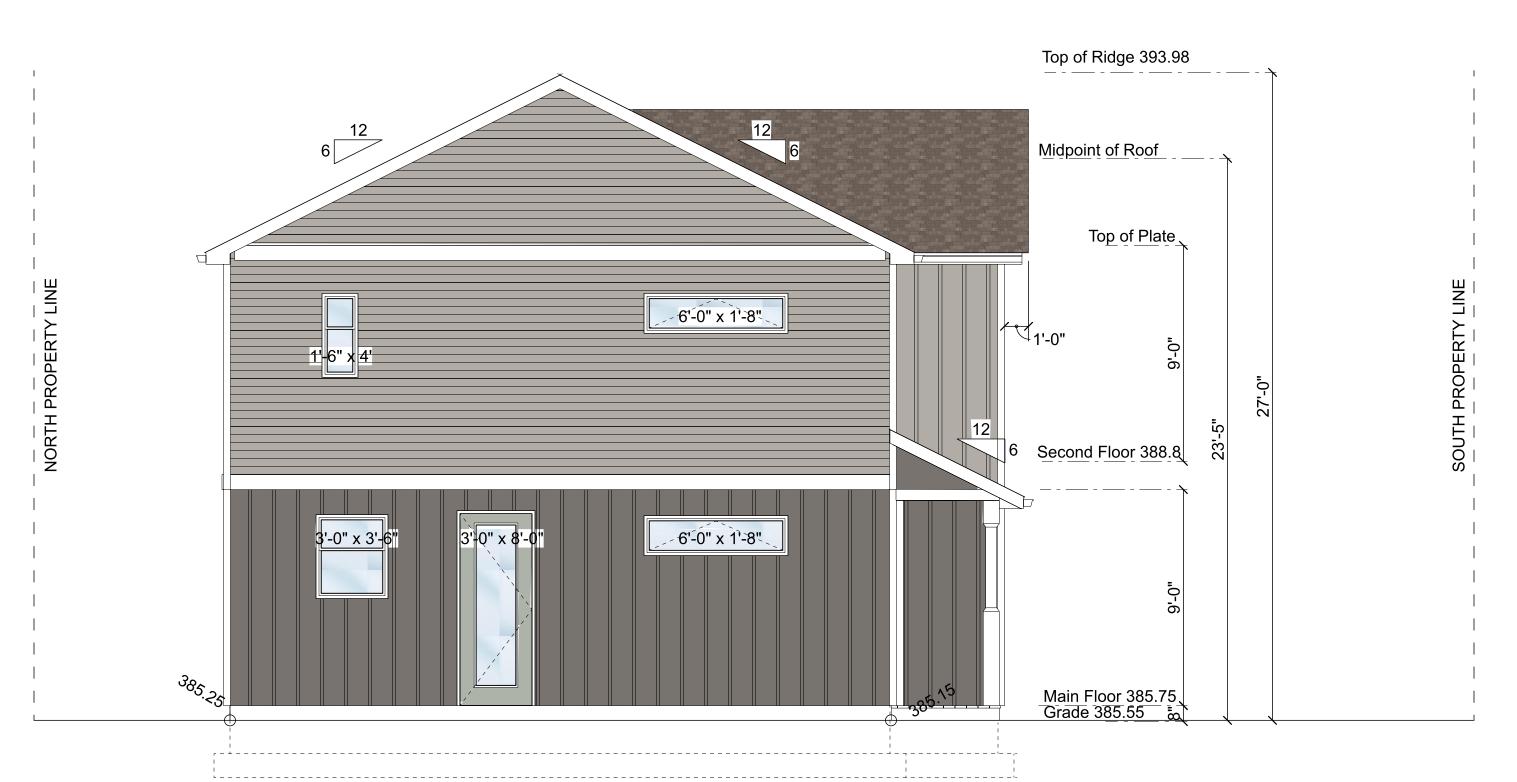

Bldg 1 - West Elevation Coloured
SCALE: 1/4" = 1'-0"

REV	DATE	DESCRIPTION
0	Jul 26, 2018	ISSUED FOR COORDINATION
1	Nov 17, 2018	ISSUED FOR RZ/DP
2	Jan 29, 2018	RE-ISSUED FOR RZ/DP

PROJECT

NICKEL ROAD **DUPLEXES**

280 Nickel Road Kelowna, BC V1X 4E6

SHEET TITLE BLDG 1 - COLOURED EAST + WEST ELEVATIONS

SHEET No.

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OF CONSTRUCTION AND/OR INSTALLATION.

- IF IN DOUBT, ASK.
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NOTES:

SCHEDULE

B

This forms part of application # DP18-0237 & DVP18-0238

Planner



Top of Ridge 393.98 Midpoint of Roof Top of Plate 5'-0" × 4'-6" 5'-0" x 4'-6" 5'-0" × 4'-6" 5'-0" 🛪 4'-6" Second Floor 388.8 2'-0" 5'-0" x 6'-0" 8/-0" x 8'-0" 8/-0"|x|8'-0" Main Floor 385.75 Grade 385.55

Bldg 1 - South Elevation Coloured
SCALE: 1/4" = 1'-0"

1 Asphalt Single Roof, IKE Cambridge "WeatherWood"
2 Hardie 6" Lap Siding, "Pearl Grey"
3 Hardie Board & Batten Siding @ 16" OC, "Pearl Grey"
4 Hardie Board & Batten Siding @ 16" OC, "Aged Pewter"
5 Trim and Fascia, painted Sherwin Williams "Snowbound" SW 7004
6 Soffits, Gutters and Downspouts, Alumipro "801 White"
7 Doors, painted Sherwin Williams "Oyster Bay" SW 6206
8 White Vined Windows

8 White Vinyl Windows

9 Satin Etch Glazing



Bldg 1 - North Elevation Coloured
SCALE: 1/4" = 1'-0"

REV DATE DESCRIPTION 0 Jul 26, 2018 ISSUED FOR COORDINATION 1 Nov 17, 2018 ISSUED FOR RZ/DP 2 Jan 29, 2018 RE-ISSUED FOR RZ/DP

PROJECT

NICKEL ROAD **DUPLEXES**

ADDRESS

280 Nickel Road Kelowna, BC V1X 4E6

SHEET TITLE BLDG 1 - COLOURED NORTH + SOUTH ELEVATIONS 1/4" = 1'-0"

SCALE SHEET No.

A12

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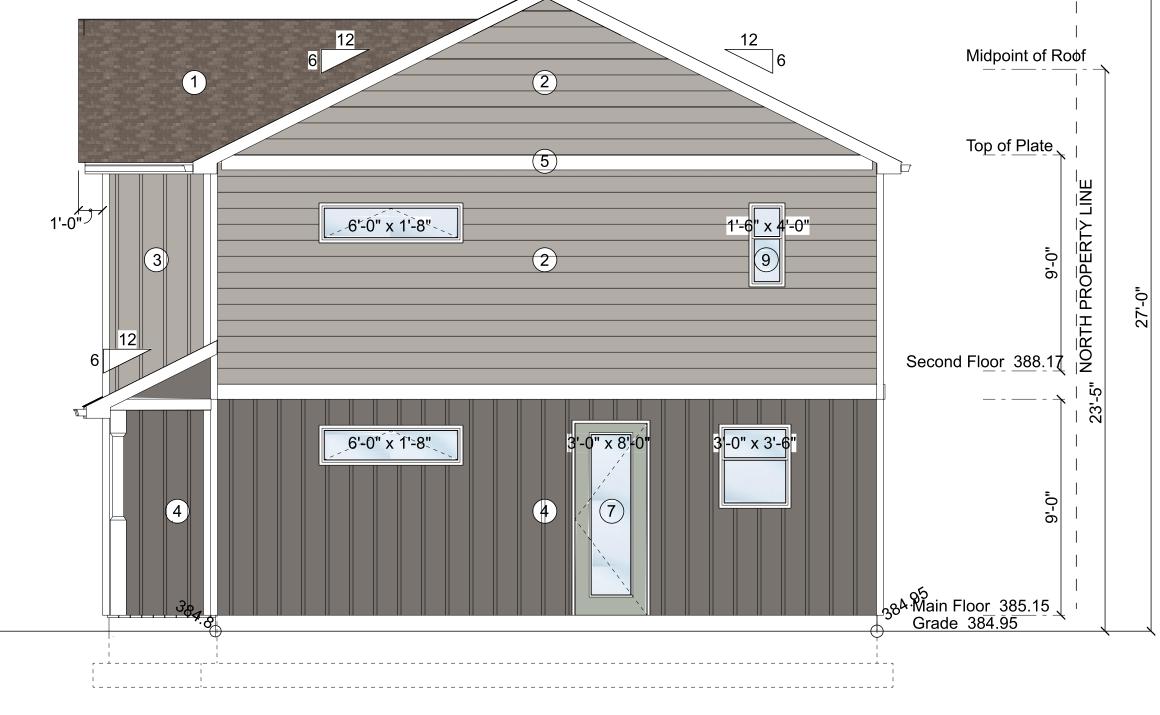
ALL CONSTRUCTION TO BE COMPLIANCE WITH LOCAL BUILDING CODE, CURRENT EDITION AND ALL APPLICABLE CODES AND BY-LAWS

GENERAL CONTRACTOR AND/OR SUBTRADES TO VERIFY ALL DIMENSIONS AND CONDITIONS AS SHOWN ON DRAWINGS WITH ACTUAL EXISTING CONDITIONS. ANY DISCREPANCIES TO BE REPORTED PRIOR TO COMMENCEMENT OF CONSTRUCTION AND/OR INSTALLATION.

IF IN DOUBT, ASK.

GARNET DESIGN STUDIO PHONE: 604.789.4418

NOTES:





Top of Ridge 392.55

Bldg 2 East Elevation Coloured SCALE: 1/4" = 1'-0"

- 1 Asphalt Single Roof, IKE Cambridge "WeatherWood"
 2 Hardie 6" Lap Siding, "Pearl Grey"
 3 Hardie Board & Batten Siding @ 16" OC, "Pearl Grey"
 4 Hardie Board & Batten Siding @ 16" OC, "Aged Pewter"
 5 Trim and Fascia, painted Sherwin Williams "Snowbound" SW 7004
 6 Soffita Cuttors and Downspay to Alumines "801 White"
- 6 Soffits, Gutters and Downspouts, Alumipro "801 White" 7 Doors, painted Sherwin Williams "Oyster Bay" SW 6206
- 8 White Vinyl Windows
 9 Satin Etch Glazing



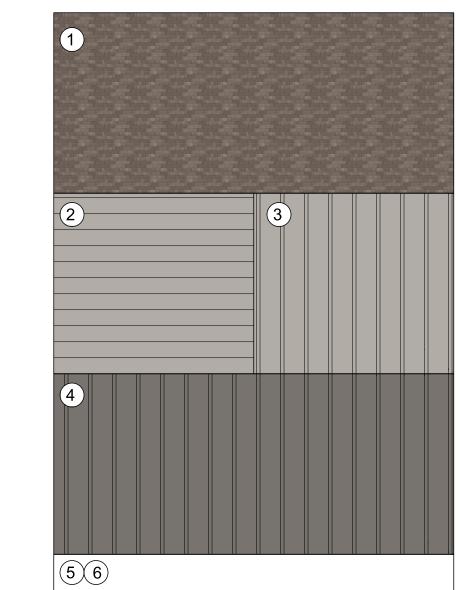

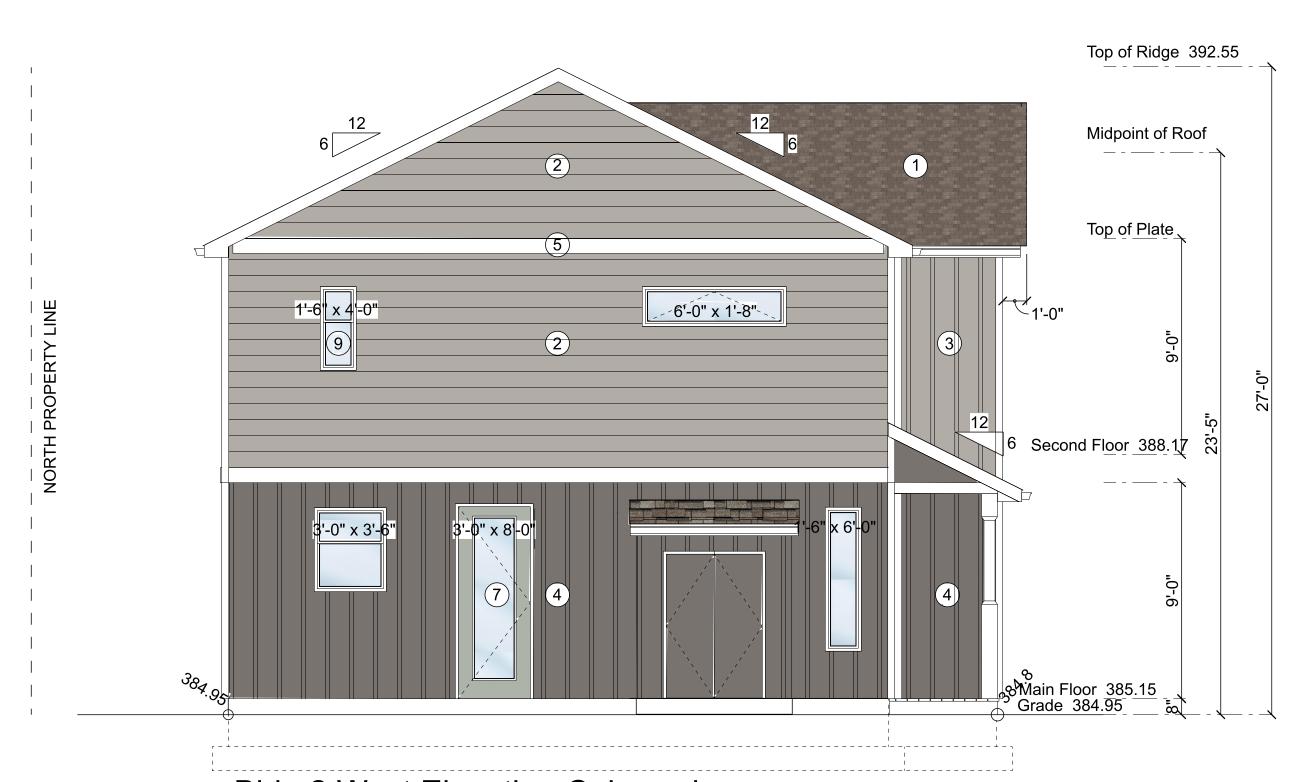

Bldg 2 West Elevation Coloured
SCALE: 1/4" = 1'-0"

REV	DATE	DESCRIPTION
0	Jul 26, 2018	ISSUED FOR COORDINATION
1	Nov 17, 2018	ISSUED FOR RZ/DP
2	Jan 29, 2019	RE-ISSUED FOR RZ/DP
·		

PROJECT

NICKEL ROAD **DUPLEXES**

ADDRESS

280 Nickel Road Kelowna, BC V1X 4E6

SHEET TITLE BLDG 2 - COLOURED EAST AND WEST ELEVATIONS

SCALE SHEET No.

A13

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ALL CONSTRUCTION TO BE COMPLIANCE WITH LOCAL BUILDING CODE, CURRENT EDITION AND ALL APPLICABLE CODES AND BY-LAWS

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IF IN DOUBT, ASK.

GARNET DESIGN STUDIO PHONE: 604.789.4418

NOTES:

B

This forms part of application # DP18-0237 & DVP18-0238

Top of Ridge 392.55

Midpoint of Roof

Top of Plate

Second Floor 388.17

Main Floor 385.15 Grade 384.95

5'-0" x 4'-6"

5'-0" x 6'-0"

3'-<u>0" x 8'</u>-0"


AJ

SCHEDULE

Initials



56

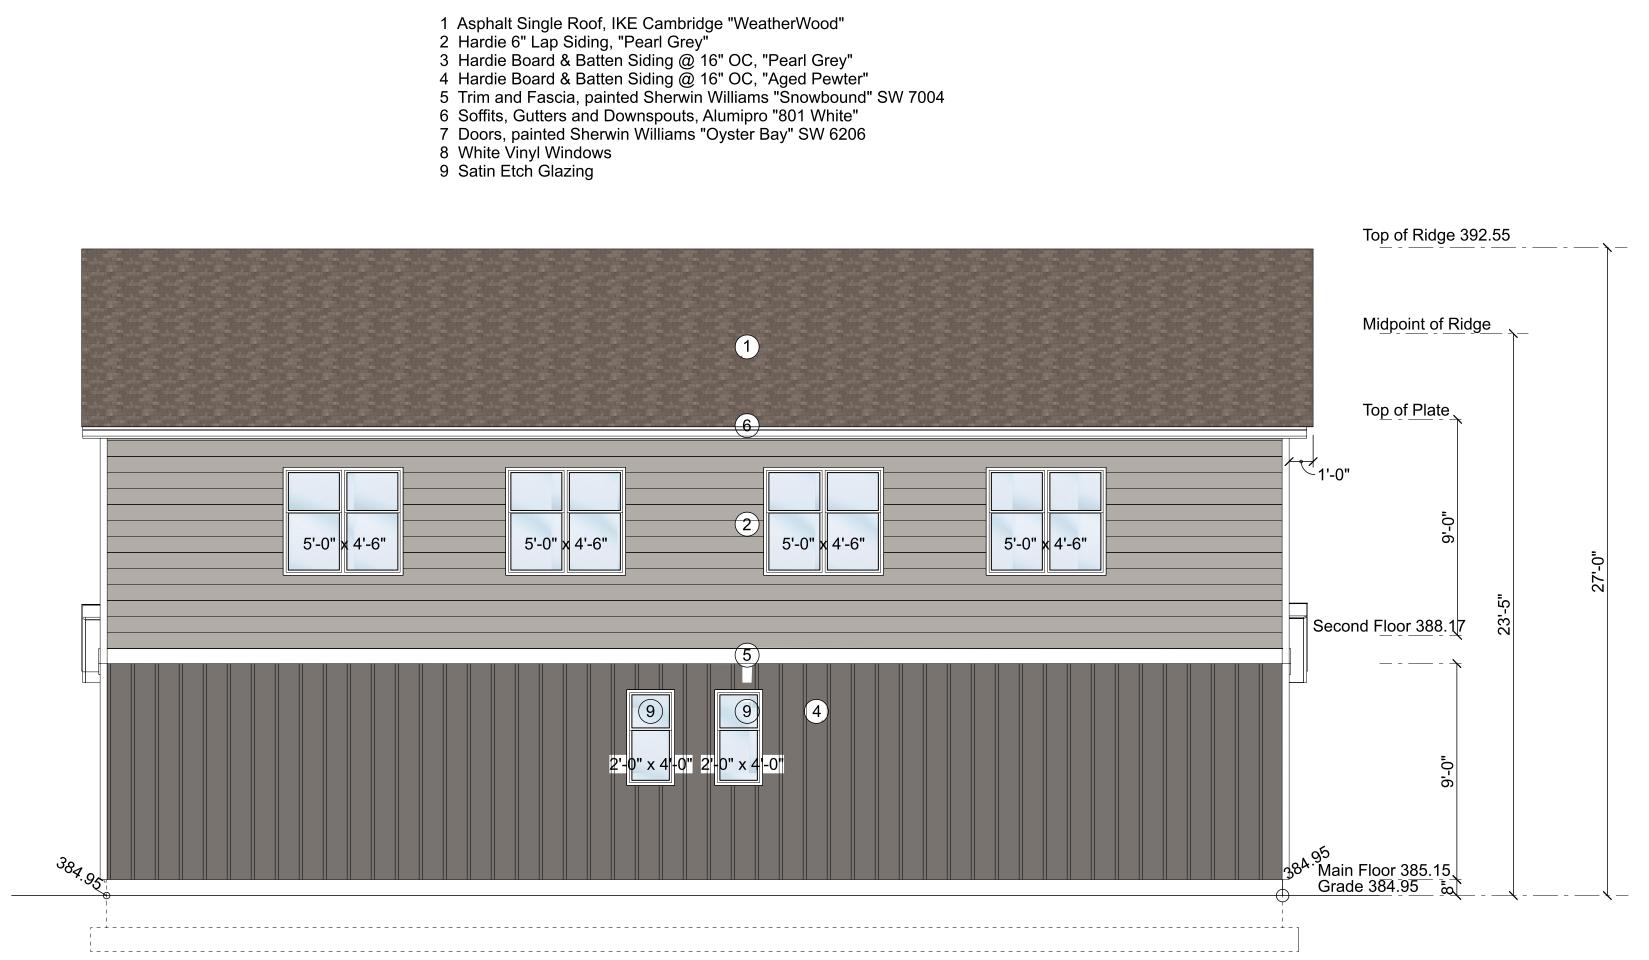

5'-0" x 4'-6"

8'-Ø" x 8\0"

5'-0" × 4'-6"

8'-Ø" x 8\-0"

Bldg 2 North Elevation Coloured
SCALE: 1/4" = 1'-0"

5'-0" x 4'-6"

Bldg 2 South Elevation Coloured
SCALE: 1/4" = 1'-0"

REV DATE DESCRIPTION 0 Jul 26, 2018 ISSUED FOR COORDINATION 1 Nov 17, 2018 ISSUED FOR RZ/DP 2 Jan 29, 2019 RE-ISSUED FOR RZ/DP

PROJECT

NICKEL ROAD **DUPLEXES**

ADDRESS

280 Nickel Road Kelowna, BC V1X 4E6


SHEET TITLE BLDG 2 - COLOURED SOUTH + NORTH ELEVATIONS

SCALE SHEET No.

A14

B THE LANDSCAPE DESIGN DESIGNATED HEREIN IS CONCEPTUAL BUT REFLECTS THE MINIMUM CITY OF KELOWNA FORM AND CHARACTER REQUIREMENTS

- C PLANT MATERIAL SELECTIONS ARE CONCEPTUAL ONLY. FINAL PLANTING SELECTIONS MAY VARY DEPENDING UPON AVAILABILITY AT THE TIME OF CONSTRUCTION.
- D TREES SHALL BE INSTALLED IN DEFINED SOIL PITS OR PLANTING BED AREAS. ADEQUATE SOIL VOLUME SHALL BE PROVIDED BASED ON THE SPECIFIED TREE SPECIES AND LOCATION.
- E ORNAMENTAL SHRUB, GRASS AND PERENNIAL CLUSTERS ARE TO BE PLACED WITHIN DEFINED PLANTING BEDS. ALL PLANTING BEDS SHALL HAVE A MIN. OF 450mm (18") IMPORTED GROWING MEDIUM AND 75mm (3") OF COMPOSTED MULCH OR APPROVED EQUAL.
- F DECORATIVE ROCK AREAS SHALL HAVE A MIN. OF 75mm (3") OF DECORATIVE COBBLE ROCK. COMMERCIAL GRADE LANDSCAPE FABRIC SHALL BE INSTALLED BELOW ALL DECORATIVE ROCK AREAS.
- G A HIGH EFFICIENCY IRRIGATION SYSTEM SHALL BE INSTALLED FOR ALL ORNAMENTAL LANDSCAPE AREAS AND SHALL CONFORM TO THE CITY OF KELOWNA'S IRRIGATION STANDARDS IN BYLAW 7900.

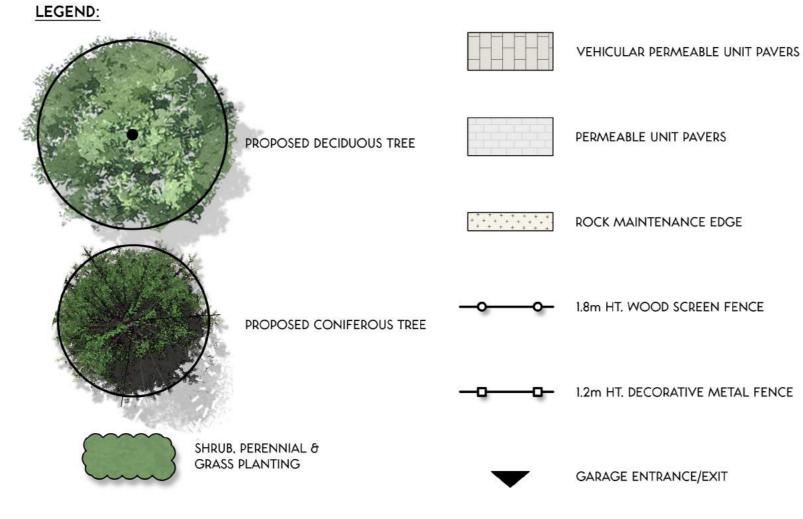

C.I.P. CONCRETE PAVING

PLANT LIST: **Botanical Name** Common Name B&B 6cm Cal. Acer fremanii 'Jeffersred' Autumn Blaze maple B&B Pinus strobus 'Fastigiata' 1.8m Ht. Eastern white pine B&B Syringa reticulata 'Ivory Silk' Japanese tree lilac 6cm Cal. **SHRUBS Botanical Name** Size/Spacing Common Name Hydrangea paniculata 'Little Lime' Little Lime hydrangea #02 Cont./1.2m O.C. Potted Syringa 'Bloomegrang Pink Perfume' Bloomerang Pink Perfume lilac #02 Cont./1.5m O.C. Potted Taxus media 'Hicksii' #02 Cont./1.0m O.C. Potted Hick's yew **GRASSES Botanical Name** Common Name Size/Spacing Astilbe arendsii 'Deutschland' Early white astilbe #01 Cont./0.6m O.C. Potted #01 Cont./0.6m O.C. Potted Bergenia cordifolia Heartleaf bergenia #01 Cont./0.6m O.C. Potted Echinacea purpurea 'Magnus' Magnus coneflower #01 Cont./0.5m O.C. Potted Hemerocallis 'Stella d'Oro' Stella d'Oro daylily Pachysandra terminalis Japanese pachysandra #01 Cont./0.3m O.C. Potted Rudbeckia fulgida 'Goldstrum' Goldstrom coneflower #01 Cont./0.6m O.C. Potted Salvia nemorosa 'Sensation Rose' Sensation Rose salvia #01 Cont./0.3m O.C. Potted GRASSES **Botanical Name** Size/Spacing Common Name Deschampsia cespitosa 'Goldtau' Gold dew tufted hair grass #01 Cont./0.6m O.C. Potted

Blue oat grass

Helictotrichon sempervirens

#01 Cont./0.75m O.C. Potted





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REVISIONS / ISSUED:

1	MAY	REISSUED FOR DP APPLICATION
4	02/19	
2	ост	ISSUED FOR DRAPRUCATION
3	10/18	ISSUED FOR DP APPLICATION
~	SEPT	DELOCATED FOR DELATION
2	28/18	REISSUED FOR REVIEW
1	SEPT	ISSUED FOR REVIEW
	26/18	
1		



RADEC GROUP

PENTICTON, B.C.

CLIENT:

PROJECT:


280 NICKEL ROAD TOWNHOMES KELOWNA, B.C.

SHEET TITLE LANDSCAPE PLAN

DESIGN BY	LS
DRAWN BY	LS
CHECKED BY	KN
PROJECT NO.	18-033
SCALE	1:100

SHEET NO.

L-1

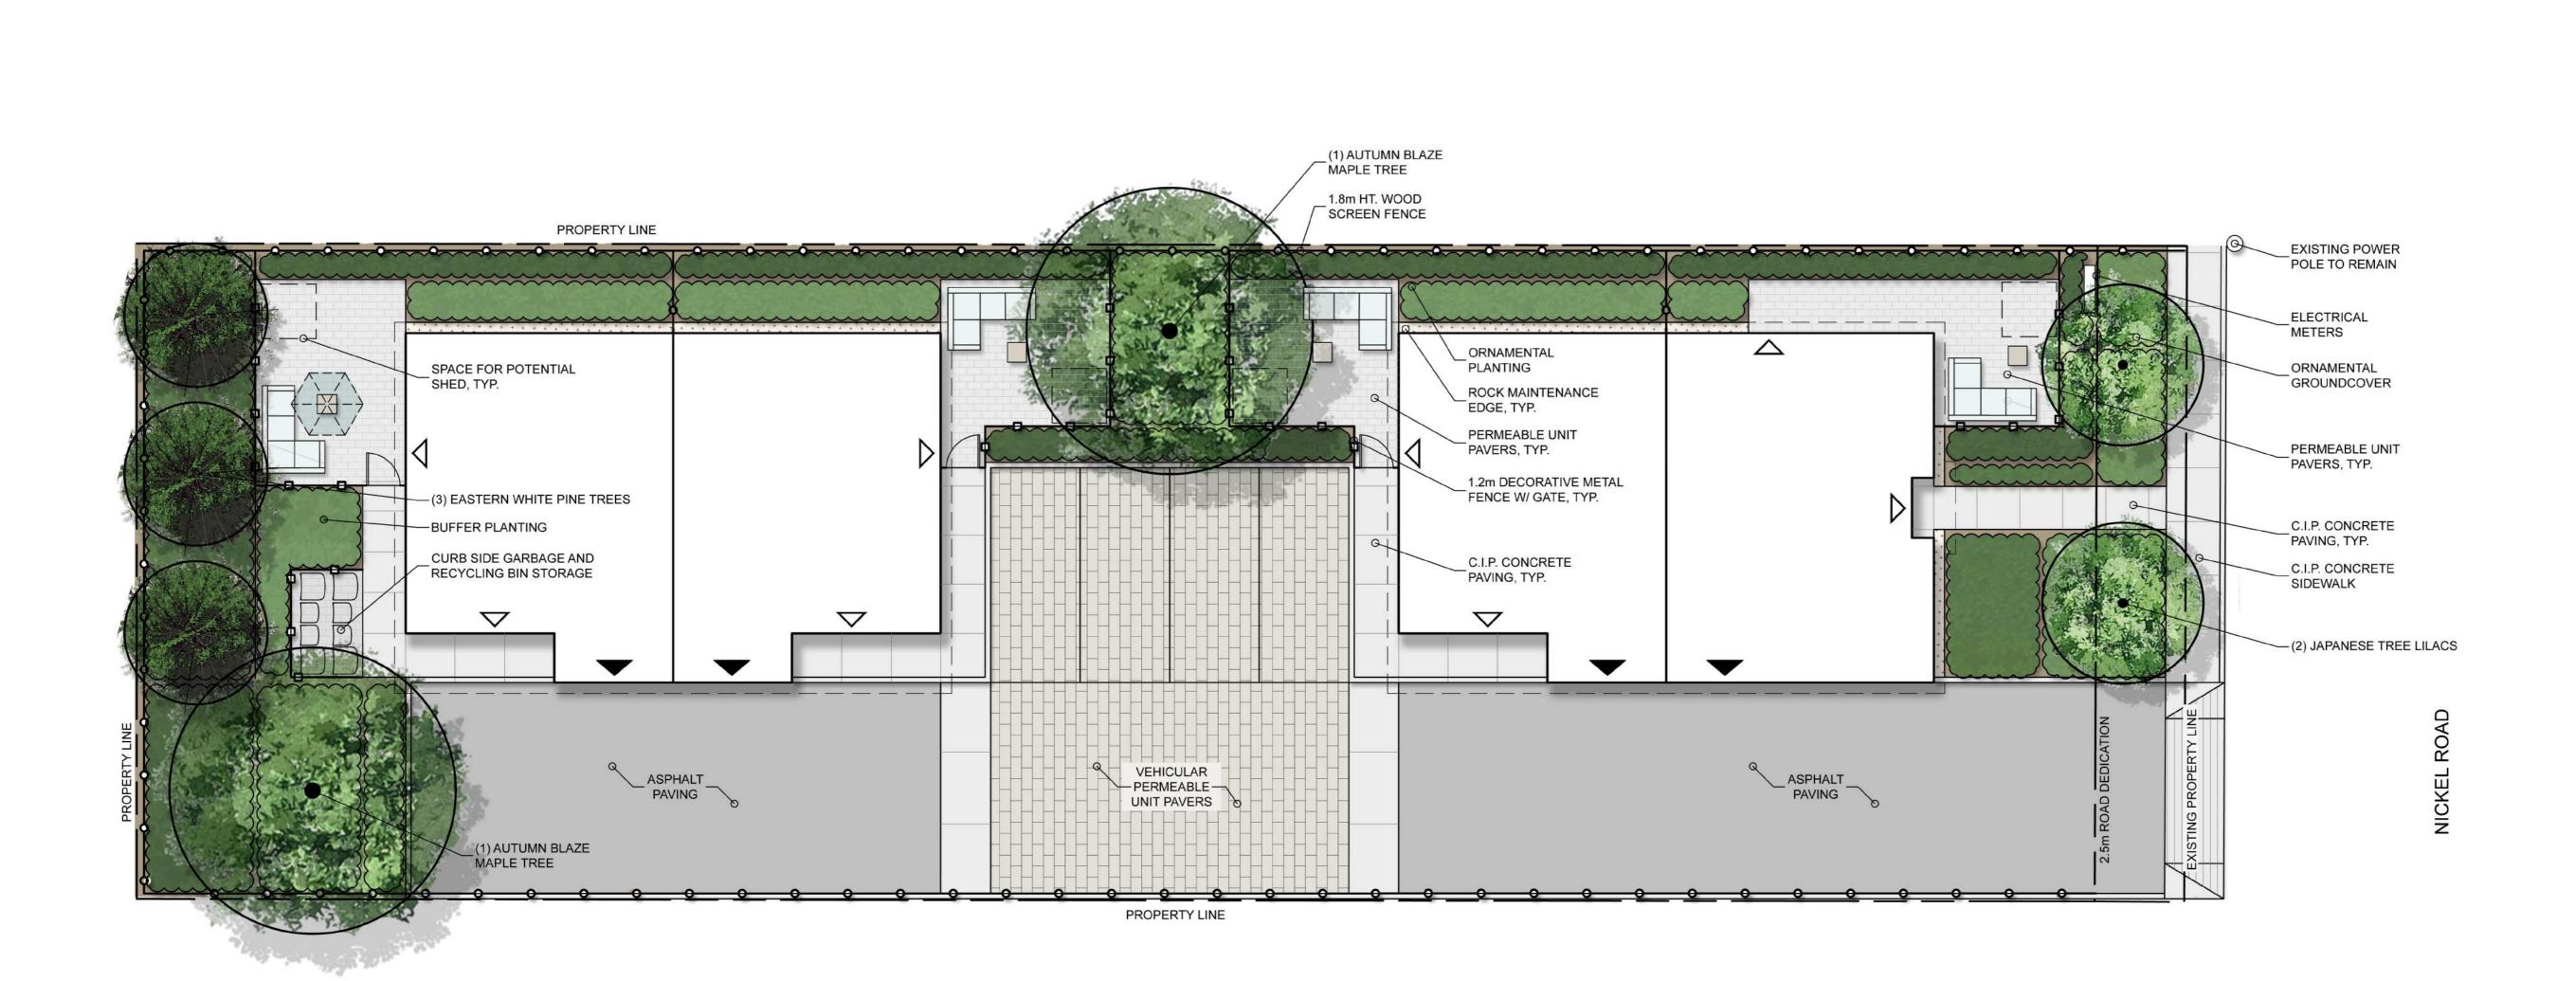

LEVEL ONE ENTRANCE/EXIT