## Development Permit & Development Variance Permit DP18-0103/DVP19-0088



This permit relates to land in the City of Kelowna municipally known as

## 1150 Black Mountain Drive

and legally known as

## Lot 1 Section 19 Township 27 Osoyoos Division Yale District Plan KAP81890

and permits the land to be used for the following development:

Multi-family Residential Development

The present owner and any subsequent owner of the above described land must comply with any attached terms and conditions.

Date of Council Decision

Decision By: COUNCIL

Issued Date:

Development Permit Area: Comprehensive Development Permit Area

This permit will not be valid if development has not commenced by June, 2021.

Existing Zone: RM3 – Low Density Multiple Housing Future Land Use Designation: MRL – Multiple Unit Residential (Low Density)

## This is NOT a Building Permit.

In addition to your Development Permit, a Building Permit may be required prior to any work commencing. For further information, contact the City of Kelowna, Development Services Branch.

## NOTICE

This permit does not relieve the owner or the owner's authorized agent from full compliance with the requirements of any federal, provincial or other municipal legislation, or the terms and conditions of any easement, covenant, building scheme or agreement affecting the building or land.

Owner: 1152712 BC Ltd.

Applicant: Patrick McCusker Architecture Inc.

Terry Barton Urban Planning Manager Community Planning & Strategic Investments Date

## 1. SCOPE OF APPROVAL

This Development Permit applies to and only to those lands within the Municipality as described above, and any and all buildings, structures and other development thereon.

This Development Permit is issued subject to compliance with all of the Bylaws of the Municipality applicable thereto, except as specifically varied or supplemented by this permit, noted in the Terms and Conditions below.

The issuance of a permit limits the permit holder to be in strict compliance with regulations of the Zoning Bylaw and all other Bylaws unless specific variances have been authorized by the Development Permit. No implied variances from bylaw provisions shall be granted by virtue of drawing notations that are inconsistent with bylaw provisions and that may not have been identified as required Variances by the applicant or Municipal staff.

### 2. CONDITIONS OF APPROVAL

- a) The dimensions and siting of the building to be constructed on the land be in accordance with Schedule "A";
- b) The exterior design and finish of the building to be constructed on the land be in accordance with Schedule "B";
- c) Landscaping to be provided on the land be in accordance with Schedule "C"; and
- d) The applicant be required to post with the City a Landscape Performance Security deposit in the form of a "Letter of Credit" in the amount of 125% of the estimated value of the landscaping, as determined by a Registered Landscape Architect.

This Development Permit is valid for two (2) years from the date of Council approval, with no opportunity to extend.

## 3. PERFORMANCE SECURITY

As a condition of the issuance of this Permit, Council is holding the security set out below to ensure that development is carried out in accordance with the terms and conditions of this Permit. Should any interest be earned upon the security, it shall accrue to the Developer and be paid to the Developer or his or her designate if the security is returned. The condition of the posting of the security is that should the Developer fail to carry out the development hereby authorized, according to the terms and conditions of this Permit within the time provided, the Municipality may use enter into an agreement with the property owner of the day to have the work carried out, and any surplus shall be paid over to the property own of the day. Should the Developer carry out the development permitted by this Permit within the time set out above, the security shall be returned to the Developer or his or her designate. There is filed accordingly:

a) An Irrevocable Letter of Credit in the amount of \$354,150

Before any bond or security required under this Permit is reduced or released, the Developer will provide the City with a statutory declaration certifying that all labour, material, workers' compensation and other taxes and costs have been paid.

### 5. INDEMNIFICATION

Upon commencement of the works authorized by this Permit the Developer covenants and agrees to save harmless and effectually indemnify the Municipality against:

a) All actions and proceedings, costs, damages, expenses, claims, and demands whatsoever and by whomsoever brought, by reason of the Municipality said Permit.

All costs, expenses, claims that may be incurred by the Municipality where the construction, engineering or other types of works as called for by the Permit results in damages to any property owned in whole or in part by the Municipality or which the Municipality by duty or custom is obliged, directly or indirectly in any way or to any degree, to construct, repair, or maintain.

The PERMIT HOLDER is the <u>CURRENT LAND OWNER</u>. Security shall <u>ONLY</u> be returned to the signatory of the Landscape Agreement or their designates.



## AERIAL CONTEXT PHOTO:



# CONSULTANTS:

ARCHITECTURAL: PATRICK MCCUSKER ARCHITECTURE INC 3430 BENVOULIN ROAD KELOWNA, B.C. VIW 4M5 TEL 778 484 0223 LANDSCAPE : OUTLAND DESIGN LANDSCAPE ARCHITECTURE 206-1889 SPALL ROAD KELOWNA, B.C. VIY 4R2 CONTACT: FIONA BARTON TEL: 250.868.9270 e-mail: fiona@outlanddesign.ca <u>CIVIL:</u> ECORA ENGINEERING AND RESOURCE GROUP LTD 579 LAWRENCE AVENUE KELOWNA, B.C. V1Y 6L8 TEL: 250.469.9757

# DRAWING INDEX:

ARCHITECTURAL:		
DRAWING NO.	DRAWING NAME	
DP0.01	COVER SHEET	DP3.01
		DP3.02
DP1.00	PLAN: SITE TOPOGRAPHIC SURVEY	DP3.03
DP1.01	PLAN: SITE @ LEVEL 01	DP3.03
DP2.01	PLAN: OVERALL BUILDING - BLDG 01 @ LEVEL 01 AND LEVEL 02	DP3.11
DP2.02	PLAN: OVERALL BUILDING - BLDG 01 @ LEVEL 03 AND ROOF	DP3.12
		DP3.13
DP2.03	PLAN: OVERALL BUILDING - BLDG 02 @ LEVEL 01 AND LEVEL 02	DP3.14
DP2.04	PLAN: OVERALL BUILDING - BLDG 02 @ LEVEL 03 AND ROOF	
		DP3.20
DP2.05	PLAN: OVERALL BUILDING - BLDG 03 @ LEVEL 01 AND LEVEL 02	
DP2.06	PLAN: OVERALL BUILDING - BLDG 03 @ LEVEL 03 AND ROOF	DP4.01
DP2.07	PLAN: OVERALL BUILDING - BLDG 04 @ LEVEL 01 AND LEVEL 02	
DP2.08	PLAN: OVERALL BUILDING - BLDG 04 @ LEVEL 03 AND ROOF	
DP2.11	PLANS: UNIT A	
DP2.12	PLANS: UNIT B1	
DP2.13	PLANS: UNIT B2	
DP2.14	PLANS: UNIT B3	
DP2.15	PLANS: UNIT B4	

ELEVATIONS: BLDG 01 ELEVATIONS: BLDG 02 ELEVATIONS: BLDG 03 ELEVATIONS: BLDG 04

ELEVATIONS: BLDG 01 (COLOURED) ELEVATIONS: BLDG 02 (COLOURED) ELEVATIONS: BLDG 03 (COLOURED) ELEVATIONS: BLDG 04 (COLOURED)

ELEVATIONS: STREETSCAPE

4.01 SECTION - SITE

# STATISTICS SHEET:

Zoning:	KID 6631443 PLAN 81 RM3 Multi Ecmilu Housing	890 LOT 1				
Permitted Use:	Multi Family Housing				12	
Site Area:		.8 sq.m.	]			
		51 sq.ft.				Site Coverage
	1.638	30 acres	(C.O.K Prop	erty Report	) {	Total Coverage
	ALLOWE	D	PROP	OSED	1	Total Goverage
Min Lot Width	30.0	m	>30	m	1	Floor Area Ratio
Min Lot Depth	30.0	m	>30	m	1	
					1	Height
Setbacks	ALLOWE		PROP			
	Front yard Side yard	4.5 m 4.0 m	4.5			Private Open
	Rear yard	7.5 m	7.5	0404040		Space Area
		•			•.2	Parking
Front	LANDSCAPE BUFFER	3.0	m			
TOIL	2	3.0 10	m ft			Parking Size Brea
Side	Level	1.5	m			
	3	5	ft			
Rear	Level	1.5	m			<b>Visitor Parking</b>
	3	5	ft			·
						Bicycle Parking
	UNIT TYPE	count	per unit	total		deck (sf)
Building Area Analysis	UNIT TYPE UNIT A	<u>count</u> 2	per unit 1873	<u>total</u> 3746	sf	<u>deck (sf)</u> 228
Area Analysis (BUILDING 01)	UNIT A UNIT B1	2		3746 11440	sf	
Area Analysis (BUILDING 01) SITE COVERAGE	UNIT A	2	1873	3746	sf	228
Area Analysis (BUILDING 01)	UNIT A UNIT B1	2	1873	3746 11440	sf	228
Area Analysis (BUILDING 01) SITE COVERAGE FOOTPRINT (SF) = 7396	UNIT A UNIT B1 TOTAL	2 8 10	1873 1430	3746 11440 15,186	sf	228 432
Area Analysis (BUILDING 01) SITE COVERAGE FOOTPRINT (SF) = 7396 Building Area	UNIT A UNIT B1 TOTAL UNIT TYPE	2 8 10	1873 1430 per unit	3746 11440 15,186 <u>total</u>	sf sf	228 432 
Area Analysis (BUILDING 01) SITE COVERAGE FOOTPRINT (SF) = 7396 Building Area Analysis	UNIT A UNIT B1 TOTAL UNIT TYPE UNIT B2	2 8 10 <u>count</u> 4	1873 1430 per unit 1690	3746 11440 15,186 <u>total</u> 6760	sf sf sf	228 432 deck (sf) 224
Area Analysis (BUILDING 01) SITE COVERAGE FOOTPRINT (SF) = 7396 Building Area Analysis (BUILDING 02)	UNIT A UNIT B1 TOTAL UNIT TYPE UNIT B2 UNIT B3	2 8 10 <u>count</u> 4 1	1873 1430 per unit	3746 11440 15,186 <u>total</u> 6760 1807	sf sf sf sf	228 432 
Area Analysis (BUILDING 01) SITE COVERAGE FOOTPRINT (SF) = 7396 Building Area Analysis	UNIT A UNIT B1 TOTAL UNIT TYPE UNIT B2	2 8 10 <u>count</u> 4	1873 1430 per unit 1690	3746 11440 15,186 <u>total</u> 6760	sf sf sf	228 432 deck (sf) 224
Area Analysis (BUILDING 01) SITE COVERAGE FOOTPRINT (SF) = 7396 Building Area Analysis (BUILDING 02) SITE COVERAGE FOOTPRINT (SF) =	UNIT A UNIT B1 TOTAL UNIT TYPE UNIT B2 UNIT B3 TOTAL	2 8 10 <u>count</u> 4 1	1873 1430 <u>per unit</u> 1690 1807	3746 11440 15,186 <u>total</u> 6760 1807 8,567	sf sf sf sf	228 432 
Area Analysis (BUILDING 01) SITE COVERAGE FOOTPRINT (SF) = 7396 Building Area Analysis (BUILDING 02) SITE COVERAGE FOOTPRINT (SF) = 3455 Building Area	UNIT A UNIT B1 TOTAL UNIT TYPE UNIT B2 UNIT B3 TOTAL UNIT TYPE	2 8 10 <u>count</u> 4 1 5 <u>count</u>	1873 1430 per unit 1690 1807	3746 11440 15,186 total 6760 1807 8,567	sf sf sf sf sf	228 432 deck (sf) 224 56 deck (sf)
Area Analysis (BUILDING 01) SITE COVERAGE FOOTPRINT (SF) = 7396 Building Area Analysis (BUILDING 02) SITE COVERAGE FOOTPRINT (SF) = 3455 Building Area Analysis	UNIT A UNIT B1 TOTAL UNIT TYPE UNIT B2 UNIT B3 TOTAL UNIT TYPE UNIT B2	2 8 10 4 1 5 5	1873 1430 per unit 1690 1807 1807 1807 1805	3746 11440 15,186 <u>total</u> 6760 1807 8,567 <u>total</u> 5055	sf sf sf sf sf sf	228 432 <u>deck (sf)</u> 224 56 <u>deck (sf)</u> 168
Area Analysis (BUILDING 01) SITE COVERAGE FOOTPRINT (SF) = 7396 Building Area Analysis (BUILDING 02) SITE COVERAGE FOOTPRINT (SF) = 3455 Building Area Analysis (BUILDING 03)	UNIT A UNIT B1 TOTAL UNIT TYPE UNIT B2 UNIT B3 TOTAL UNIT TYPE UNIT B2 UNIT B3	2 8 10 4 1 5 5 <u>count</u> 3 1	1873 1430 per unit 1690 1807 1807 per unit 1685 1807	3746 11440 15,186 <u>total</u> 6760 1807 8,567 <u>8,567</u> <u>total</u> 5055 1807	sf sf sf sf sf sf sf sf	228 432 <u>deck (sf)</u> 224 56 <u>deck (sf)</u> 168 56
Area Analysis (BUILDING 01) SITE COVERAGE FOOTPRINT (SF) = 7396 Building Area Analysis (BUILDING 02) SITE COVERAGE FOOTPRINT (SF) = 3455 Building Area Analysis (BUILDING 03) SITE COVERAGE	UNIT A UNIT B1 TOTAL UNIT TYPE UNIT B2 UNIT B3 TOTAL UNIT TYPE UNIT B2 UNIT B2 UNIT B2 UNIT B3 UNIT B4	2 8 10 <u>count</u> 4 1 5 5 <u>count</u> 3 1 1	1873 1430 per unit 1690 1807 1807 1807 1805	3746 11440 15,186 <u>total</u> 6760 1807 8,567 <u>8,567</u> <u>total</u> 5055 1807 1778	sf sf sf sf sf sf sf sf sf sf	228 432 <u>deck (sf)</u> 224 56 <u>deck (sf)</u> 168
Area Analysis (BUILDING 01) SITE COVERAGE FOOTPRINT (SF) = 7396 Building Area Analysis (BUILDING 02) SITE COVERAGE FOOTPRINT (SF) = 3455 Building Area Analysis (BUILDING 03)	UNIT A UNIT B1 TOTAL UNIT TYPE UNIT B2 UNIT B3 TOTAL UNIT TYPE UNIT B2 UNIT B2 UNIT B2	2 8 10 4 1 5 5 <u>count</u> 3 1	1873 1430 per unit 1690 1807 1807 per unit 1685 1807	3746 11440 15,186 <u>total</u> 6760 1807 8,567 <u>8,567</u> <u>total</u> 5055 1807	sf sf sf sf sf sf sf sf	228 432 <u>deck (sf)</u> 224 56 <u>deck (sf)</u> 168 56
Area Analysis (BUILDING 01) SITE COVERAGE FOOTPRINT (SF) = 7396 Building Area Analysis (BUILDING 02) SITE COVERAGE FOOTPRINT (SF) = 3455 Building Area Analysis (BUILDING 03) SITE COVERAGE FOOTPRINT (SF) =	UNIT A UNIT B1 TOTAL UNIT TYPE UNIT B2 UNIT B3 TOTAL UNIT TYPE UNIT B2 UNIT B2 UNIT B2 UNIT B3 UNIT B4	2 8 10 <u>count</u> 4 1 5 5 <u>count</u> 3 1 1	1873 1430 per unit 1690 1807 1807 per unit 1685 1807	3746 11440 15,186 <u>total</u> 6760 1807 8,567 <u>8,567</u> <u>total</u> 5055 1807 1778	sf sf sf sf sf sf sf sf sf sf	228 432 <u>deck (sf)</u> 224 56 <u>deck (sf)</u> 168 56
Area Analysis (BUILDING 01) SITE COVERAGE FOOTPRINT (SF) = 7396 Building Area Analysis (BUILDING 02) SITE COVERAGE FOOTPRINT (SF) = 3455 Building Area Analysis (BUILDING 03) SITE COVERAGE FOOTPRINT (SF) = 3485	UNIT A UNIT B1 TOTAL UNIT TYPE UNIT B2 UNIT B3 TOTAL UNIT B3 UNIT B4 TOTAL UNIT B4 TOTAL	2 8 10 4 1 5 5 <u>count</u> 3 1 1 5 5	1873         1430         per unit         1690         1807         1807         1807         1778         per unit	3746 11440 15,186 <u>total</u> 6760 1807 8,567 <u>total</u> 5055 1807 1778 8,640 <u>total</u>	sf sf sf sf sf sf sf sf sf sf	228 432 <u>deck (sf)</u> 224 56 <u>deck (sf)</u> 168 56 56 56
Area Analysis (BUILDING 01) SITE COVERAGE FOOTPRINT (SF) = 7396 Building Area Analysis (BUILDING 02) SITE COVERAGE FOOTPRINT (SF) = 3455 Building Area Analysis (BUILDING 03) SITE COVERAGE FOOTPRINT (SF) = 3485 Building Area Analysis	UNIT A UNIT B1 TOTAL UNIT TYPE UNIT B2 UNIT B3 TOTAL UNIT B3 UNIT B4 TOTAL UNIT B4 TOTAL UNIT B4 TOTAL	2 8 10 <u>count</u> 4 1 5 5 <u>count</u> 3 1 1 5 5	1873         1430         per unit         1690         1807         1807         1807         1807         1807         1807         1885         1807         1778         1873	3746 11440 15,186 <u>total</u> 6760 1807 8,567 8,567 1807 1778 8,640 <u>total</u> 3746	sf sf sf sf sf sf sf sf sf sf	228 432 432 <u>deck (sf)</u> 224 56 <u>6</u> 56 56 56 56
Area Analysis (BUILDING 01) SITE COVERAGE FOOTPRINT (SF) = 7396 Building Area Analysis (BUILDING 02) SITE COVERAGE FOOTPRINT (SF) = 3455 Building Area Analysis (BUILDING 03) SITE COVERAGE FOOTPRINT (SF) = 3485 Building Area Analysis (BUILDING 04)	UNIT A UNIT B1 TOTAL UNIT TYPE UNIT B2 UNIT B3 TOTAL UNIT B3 UNIT B3 UNIT B3 UNIT B4 TOTAL UNIT B4 TOTAL	2 8 10 2 8 10 4 1 5 5 5 5 5 5 5 5 5 5 5 5 5 5 5 5 5 5	1873         1430         per unit         1690         1807         1807         1807         1778         per unit	3746 11440 15,186 total 6760 1807 8,567 8,567 1778 8,640 total 3746 5720	sf sf sf sf sf sf sf sf sf sf sf	228 432 <u>deck (sf)</u> 224 56 <u>deck (sf)</u> 168 56 56 56
Area Analysis (BUILDING 01) SITE COVERAGE FOOTPRINT (SF) = 7396 Building Area Analysis (BUILDING 02) SITE COVERAGE FOOTPRINT (SF) = 3455 Building Area Analysis (BUILDING 03) SITE COVERAGE FOOTPRINT (SF) = 3485 Building Area Analysis	UNIT A UNIT B1 TOTAL UNIT TYPE UNIT B2 UNIT B3 TOTAL UNIT B3 UNIT B4 TOTAL UNIT B4 TOTAL UNIT B4 TOTAL	2 8 10 <u>count</u> 4 1 5 5 <u>count</u> 3 1 1 5 5	1873         1430         per unit         1690         1807         1807         1807         1807         1807         1807         1885         1807         1778         1873	3746 11440 15,186 <u>total</u> 6760 1807 8,567 8,567 1807 1778 8,640 <u>total</u> 3746	sf sf sf sf sf sf sf sf sf sf	228 432 432 <u>deck (sf)</u> 224 56 <u>6</u> 56 56 56 56



## Notes:

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Tabulated scales refer to Arch D size drawing sheet. This drawing must not be scaled.

Contractors shall verify all dimensions prior to commencement of work.

Any omissions or discrepancies shall be reported to the

Seal

architect.

Maximum 40% (Building Footprint) Maximum 70% (Building + Driveway + Parking) (Maximum 0.77) (Proposed FAR of 0.59) (0.75+0.02 Parking Bonus) Principal buildings 10 m max or 3.0 stories Required (minimum) 25 sq.m/two bed + unit @ 26 2.0 stalls per 3 bed x 26 = 52

54,940	sq.ft.	41,859	sq.ft.	
10.0	m	10.0	m	1
32.8	ft	32.8	ft	1
650	sq.m.	766	sq.m.	1
6,997	sq.t.	8,245	sq.ft.	
Required		52	spaces	]
Provided		10	spaces	(surface)
		42	spaces	(covered)
	[	52	spaces	(TOTAL)
10	ni.			14
Size Small		4		
Size Regular		48		
1971 201	24		-	
Required	ר ר	4	1	
Provided		5	1	
P.	_		-	
Class I - Requir	red	13.0	spaces	1
Class I - Requin Class II - Requi		13.0 3.0	spaces spaces	-

Total Proposed 30 spaces

ALLOWED/REQUIRED PROPOSED

 2,651
 sq.m.
 1,751
 sq.m.

 28,541
 sq.t.
 18,845
 sq.ft.

 4,640
 sq.m.
 3,190
 sq.m.

 49,946
 sq.ft.
 34,338
 sq.ft.

5,104 sq.m. 3,889 sq.m.

1 per 7 units (Required Minimum)

Class I - 0.5 stalls per unit (26 Units ) Class II - 0.1 stalls per unit (26 Units)


> 04 2019.01.23 Re-Issued for Development Permit 03 2018.11.21 Re-Issued for Development Permit 02 2018.09.21 Re-Issued for Development Permit 01 2018.04.30 Issued for Development Permit No. Date Description Revisions \_

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February 25, 2019 08:49 AM

**DP0.01** 

drawing no.

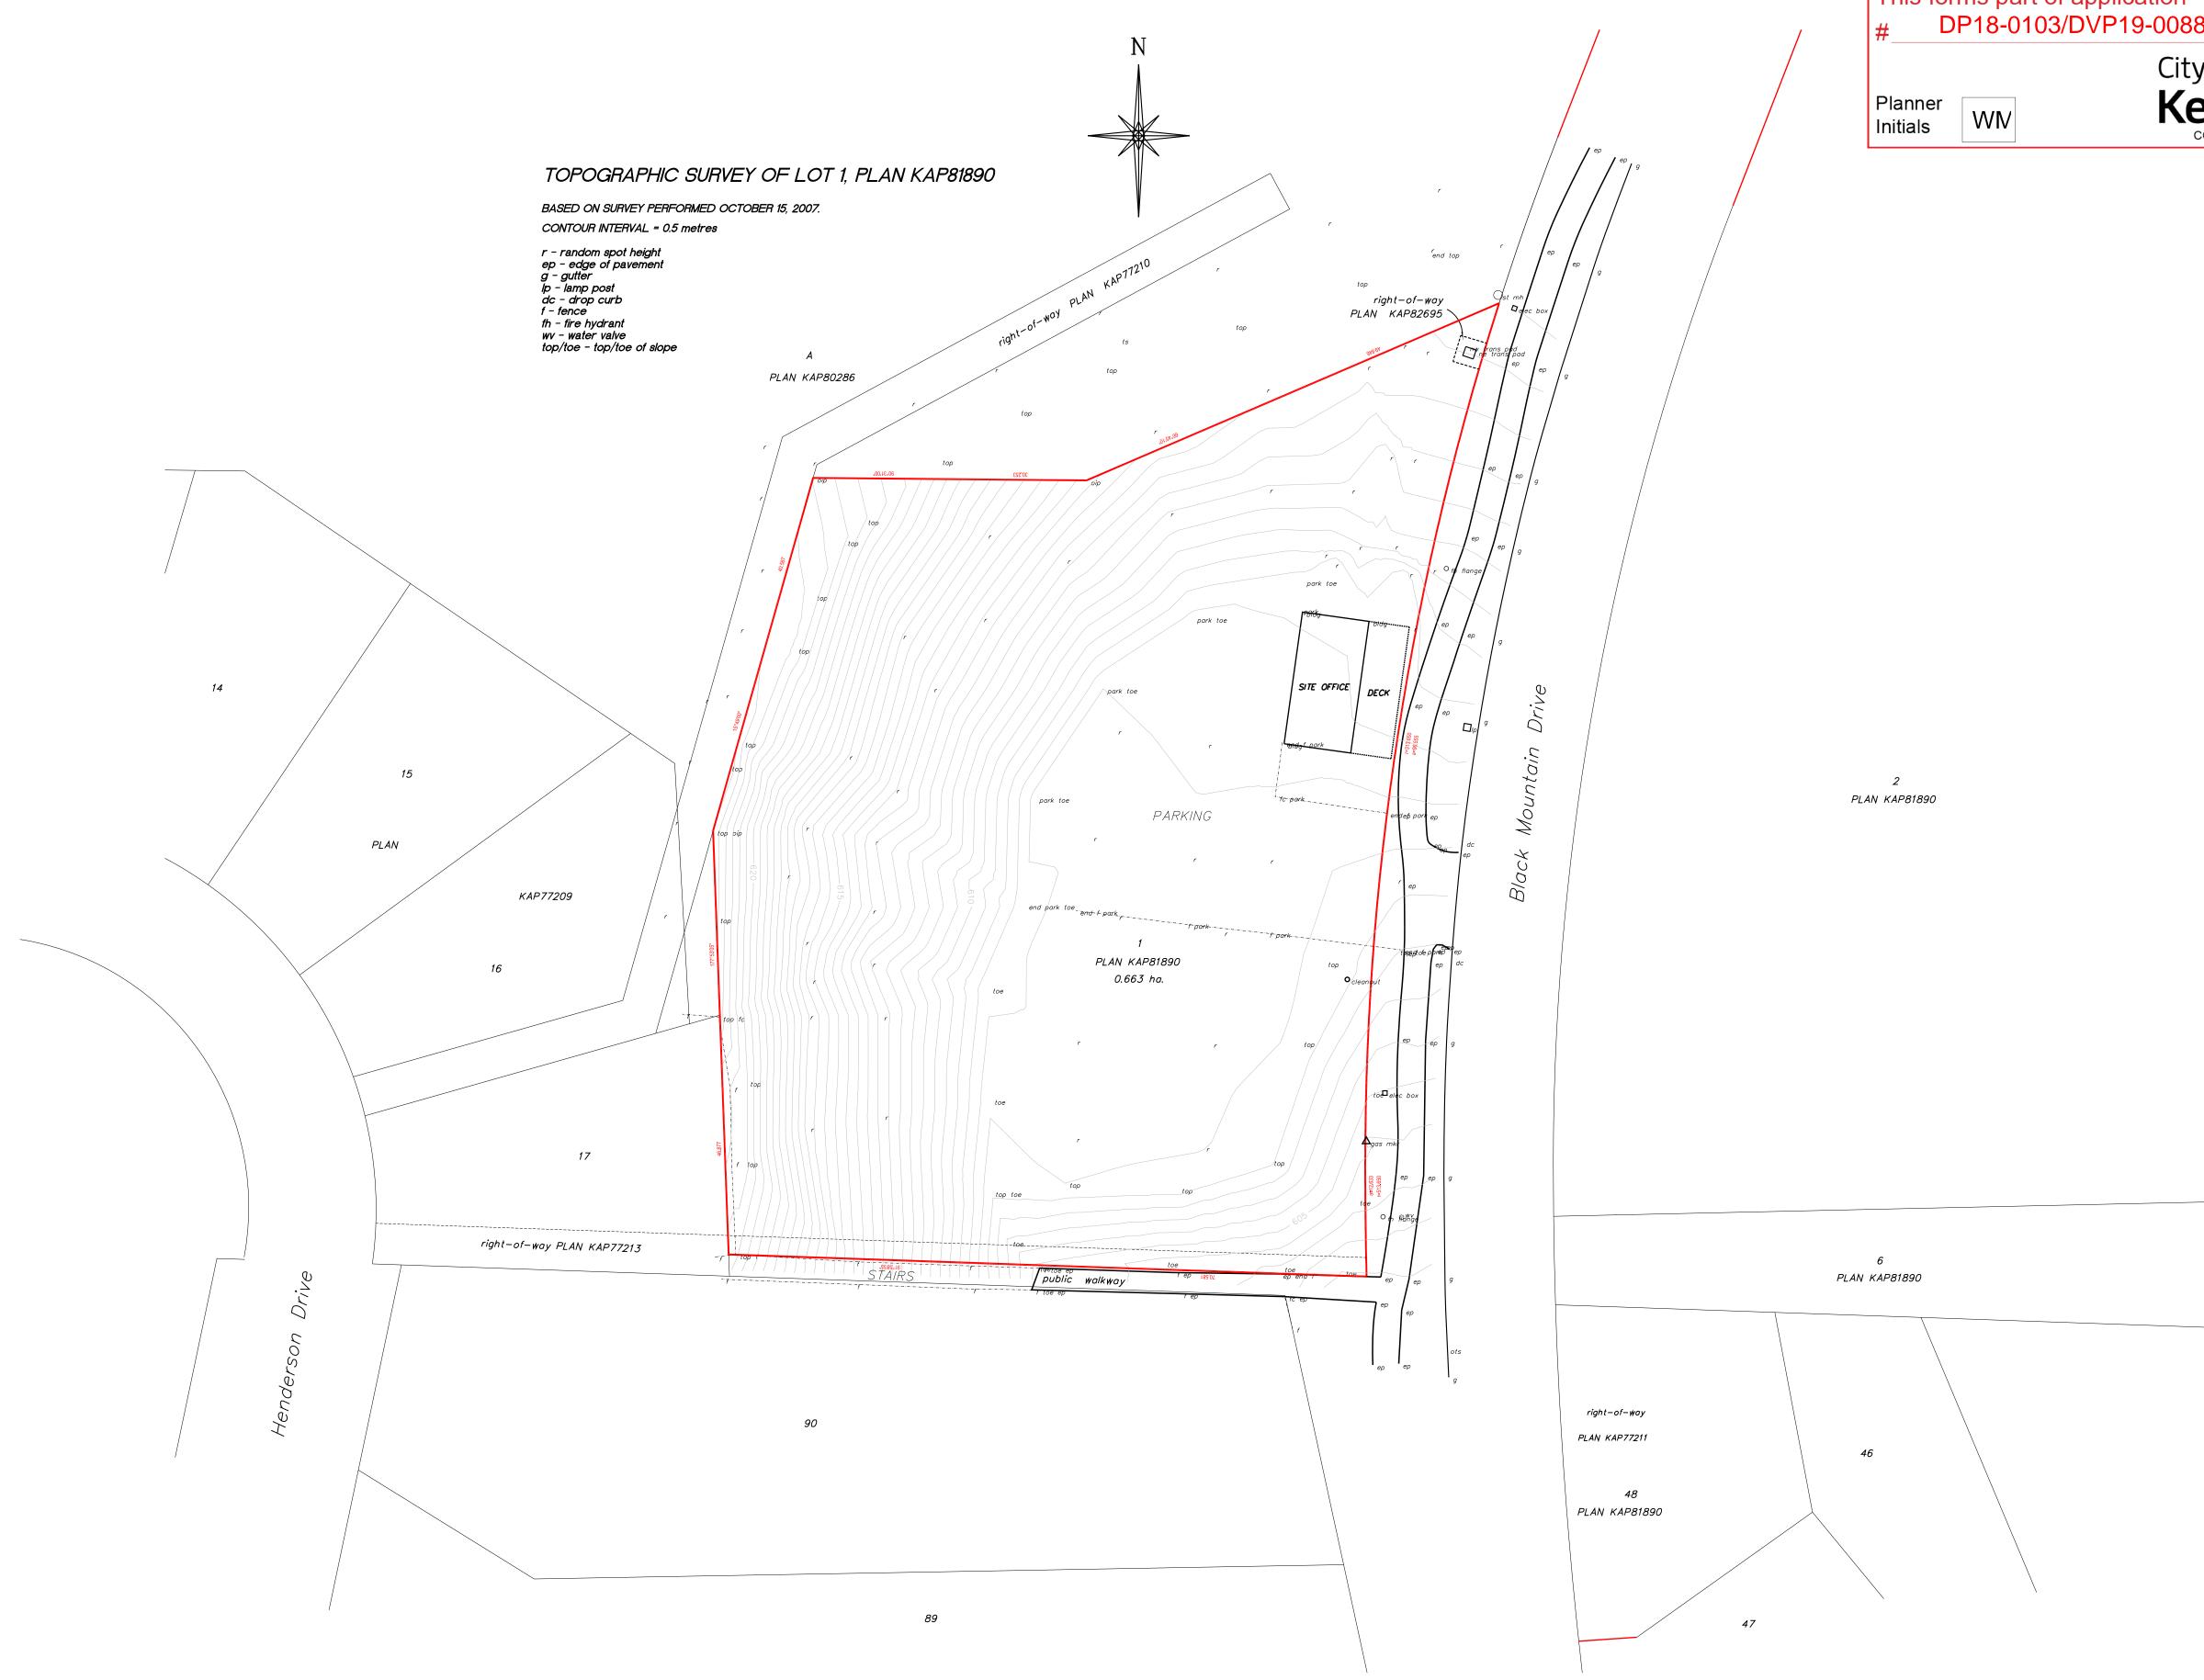

D.A. Goddard Land Surveying Inc. 103-1358 ST. PAUL STREET KELOWNA PHONE 763-3733



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Seal

042019.01.23Re-Issued for Development Permit032018.11.21Re-Issued for Development Permit022018.09.21Re-Issued for Development Permit012018.04.30Issued for Development Permit No. Date Description



DP1.00 January 24, 2019 02:46 PM


## NOTES:

SITE SURVEY BASED ON INFORMATION PROVIDED BY D.A. GODDARD LAND SURVEYING INC.

FINAL LAYOUT & GRADE ELEVATIONS TO **BE DETERMINED BY SURVEYOR & CIVIL** ENGINEER IN CONSULTATION WITH CONTRACTOR & OWNER.

ARCHITECTURAL SITE PLAN TO BE READ IN CONJUNCTION WITH CIVIL GRADING PLAN. (REFER TO CIVIL)


ARCHITECTURAL SITE PLAN TO BE READ IN CONJUNCTION WITH LANDSCAPE PLAN. (REFER TO LANDSCAPE)

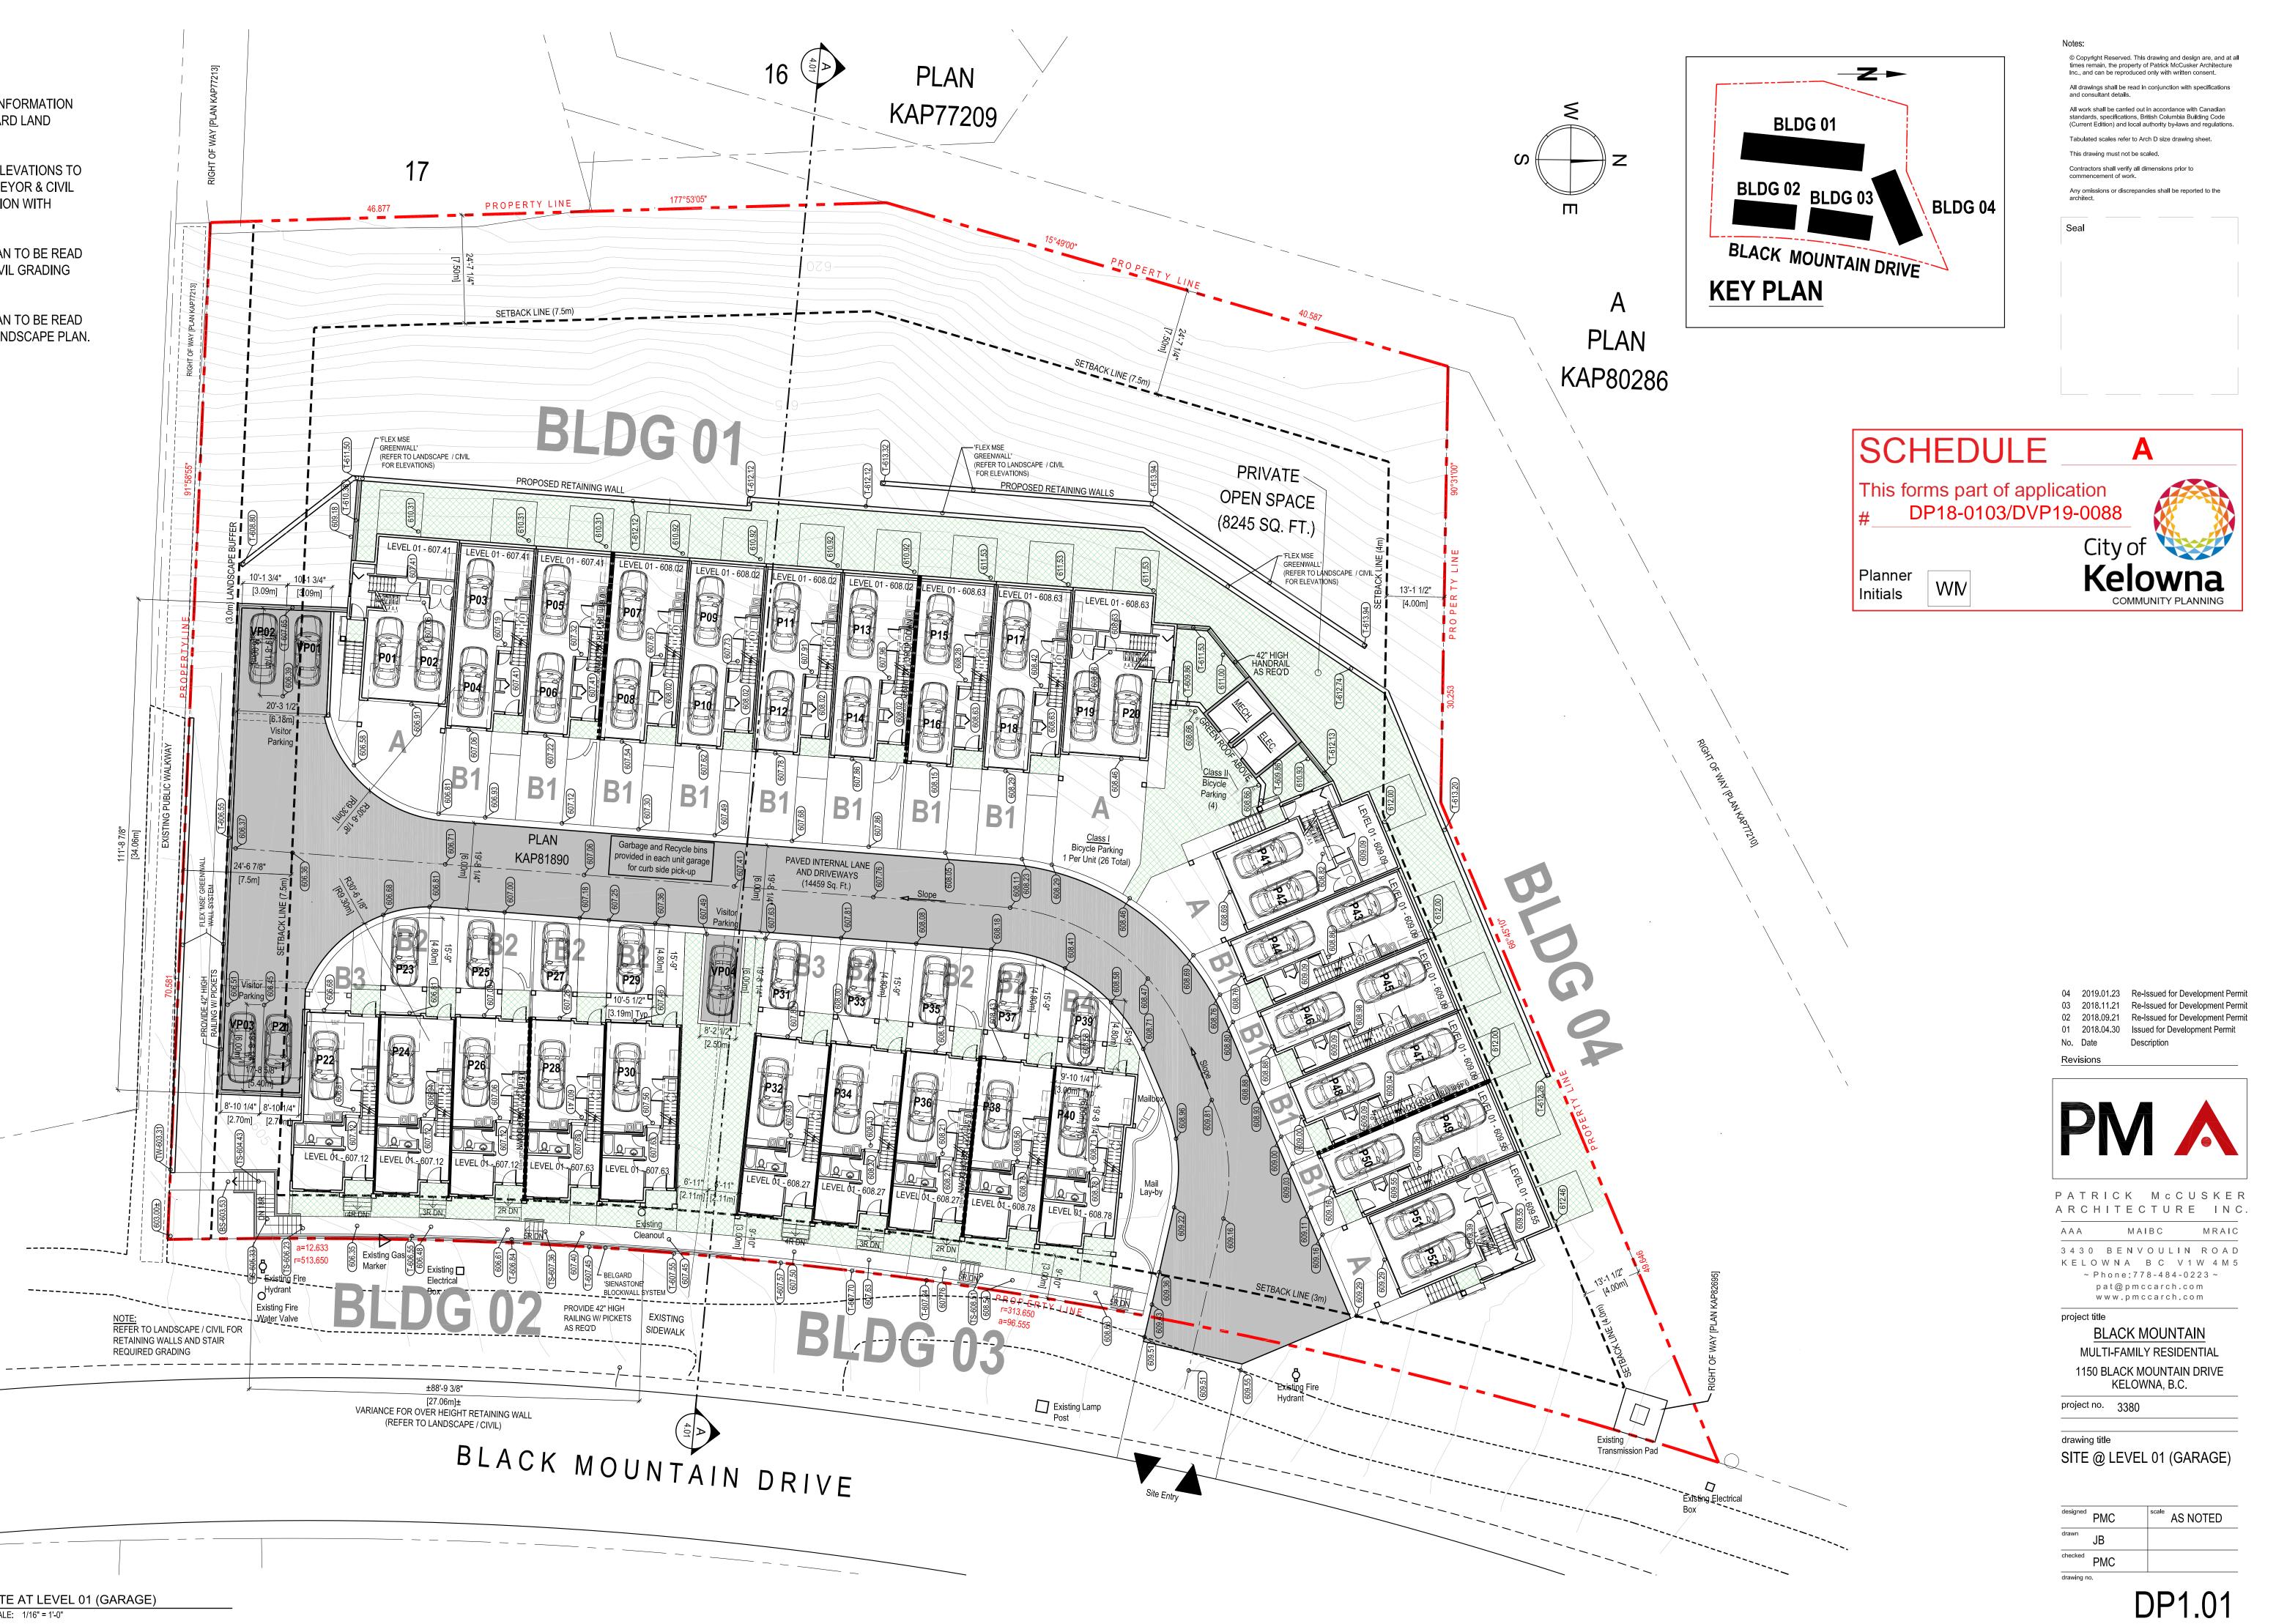


1 SITE AT LEVEL 01 (GARAGE) DP 1.01 SCALE: 1/16" = 1'-0" SITE AREA: 71351 SF (PER PROPERTY REPORT)

February 25, 2019 08:56 AM



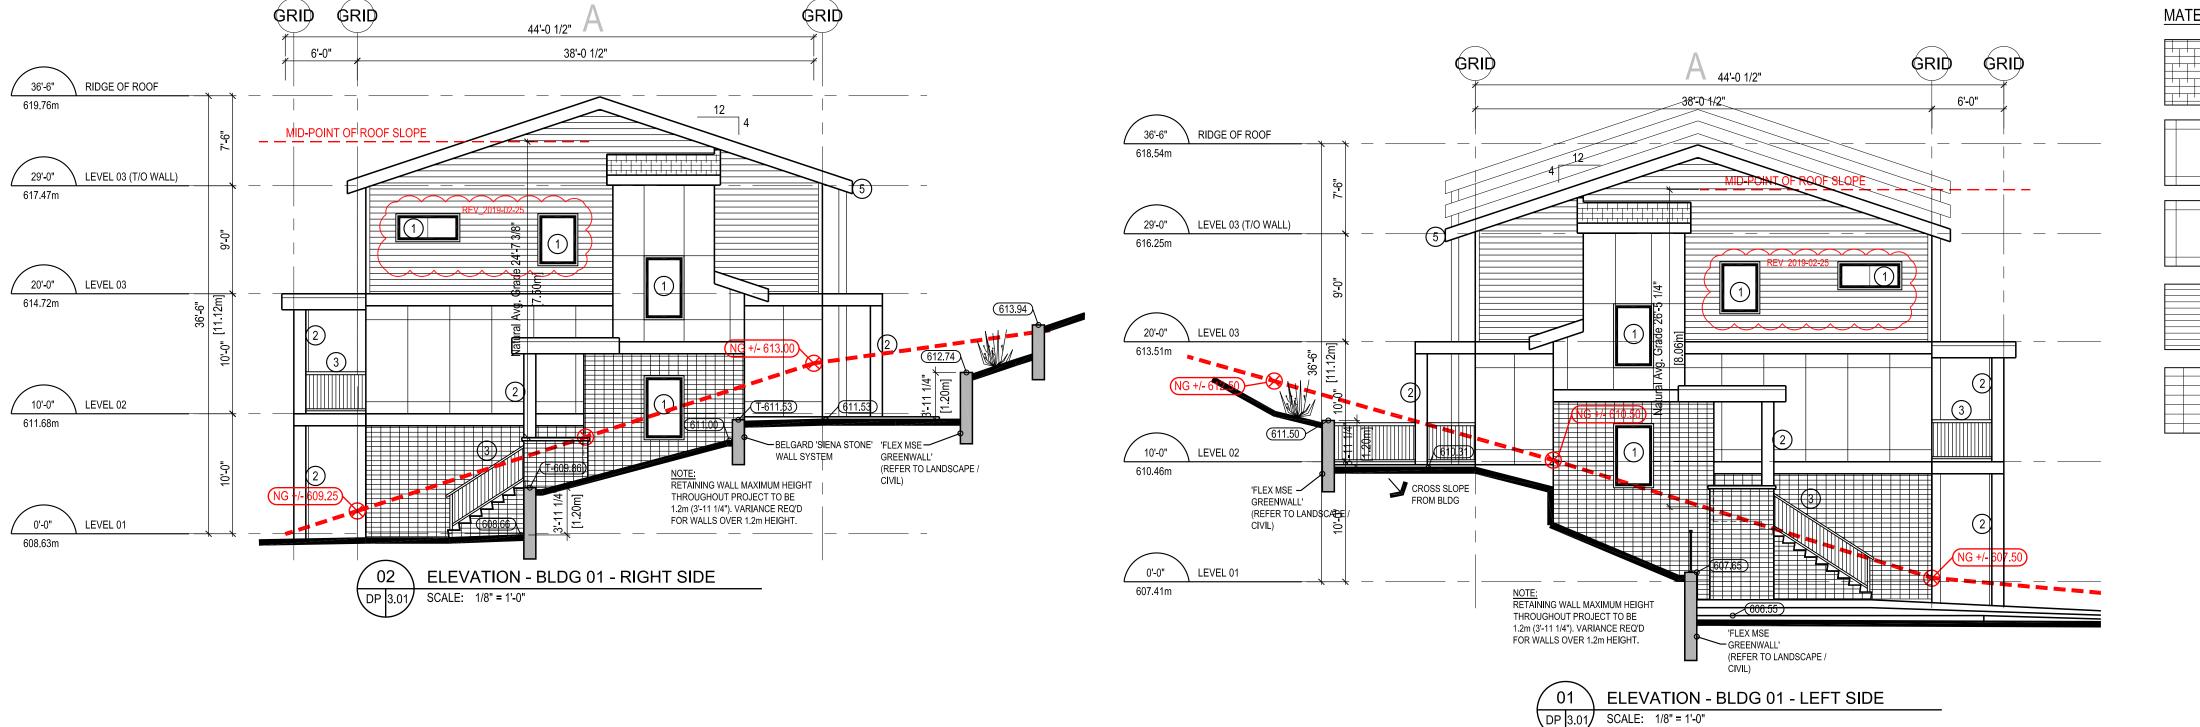


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616.47m

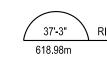613.73m

610.68m



RIALS L	EGEND:
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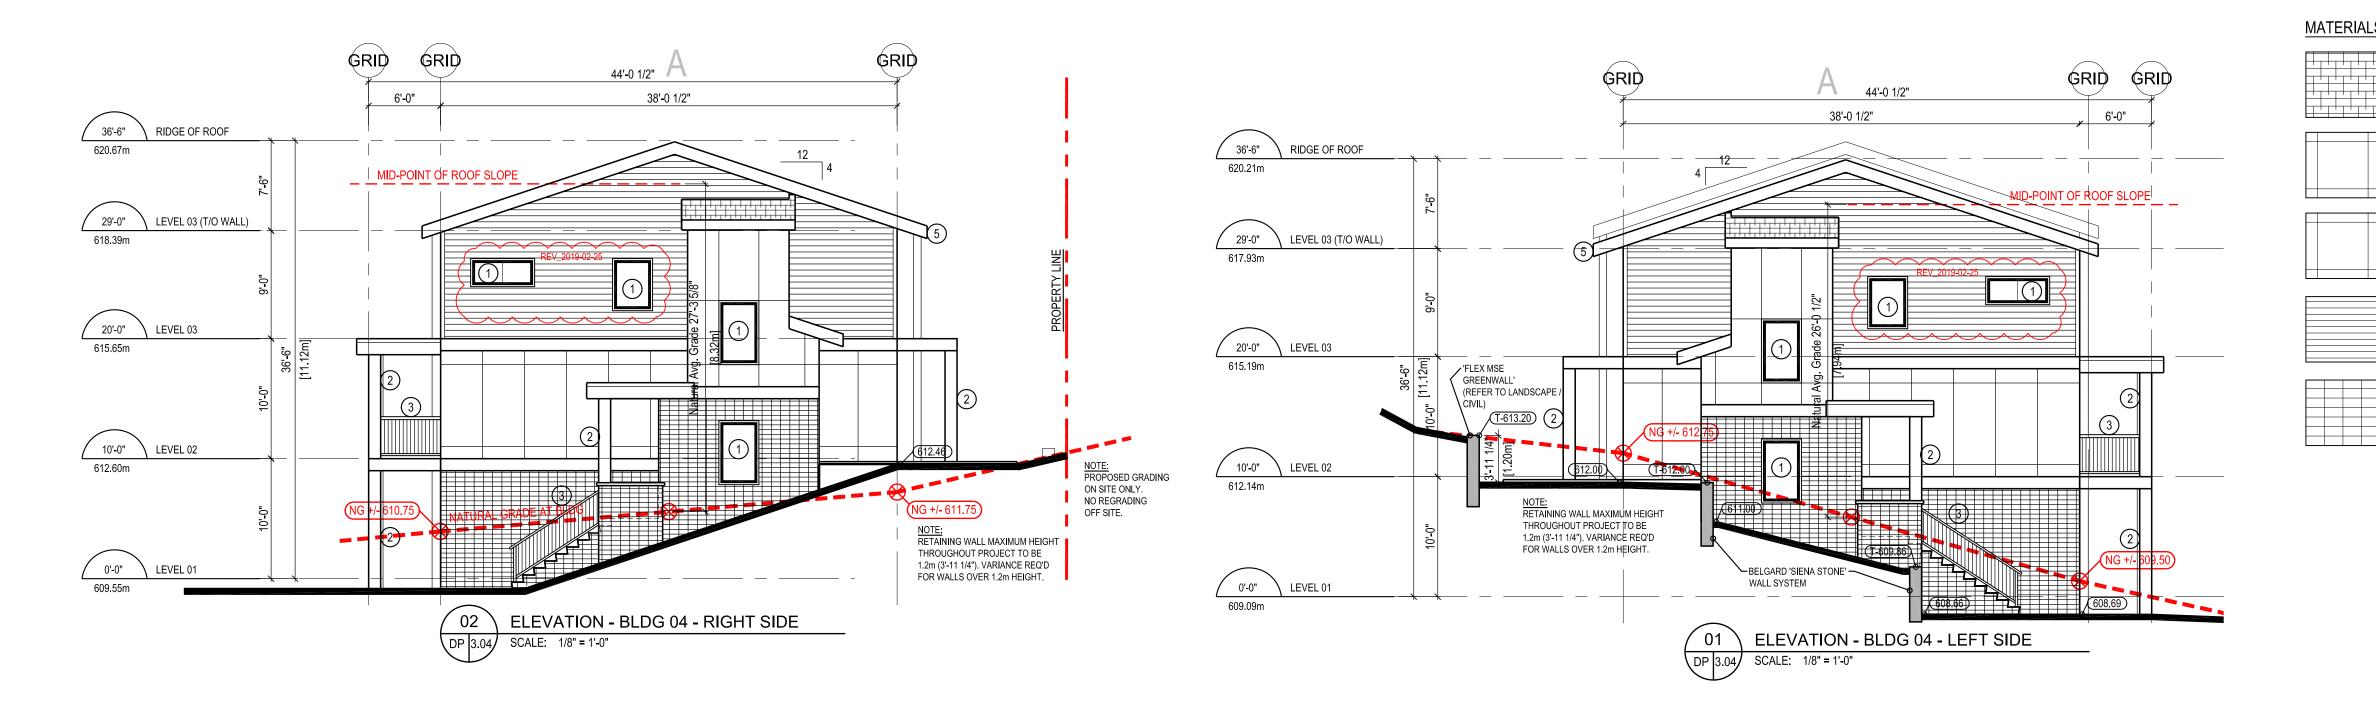
RIALS	LEGEND:
	FIBREGLASS SHINGLES
	WALL PANEL (HARDIE PRO 'GRAY SLATE'
	WALL PANEL (HARDIE PRO 'COBBLESTON

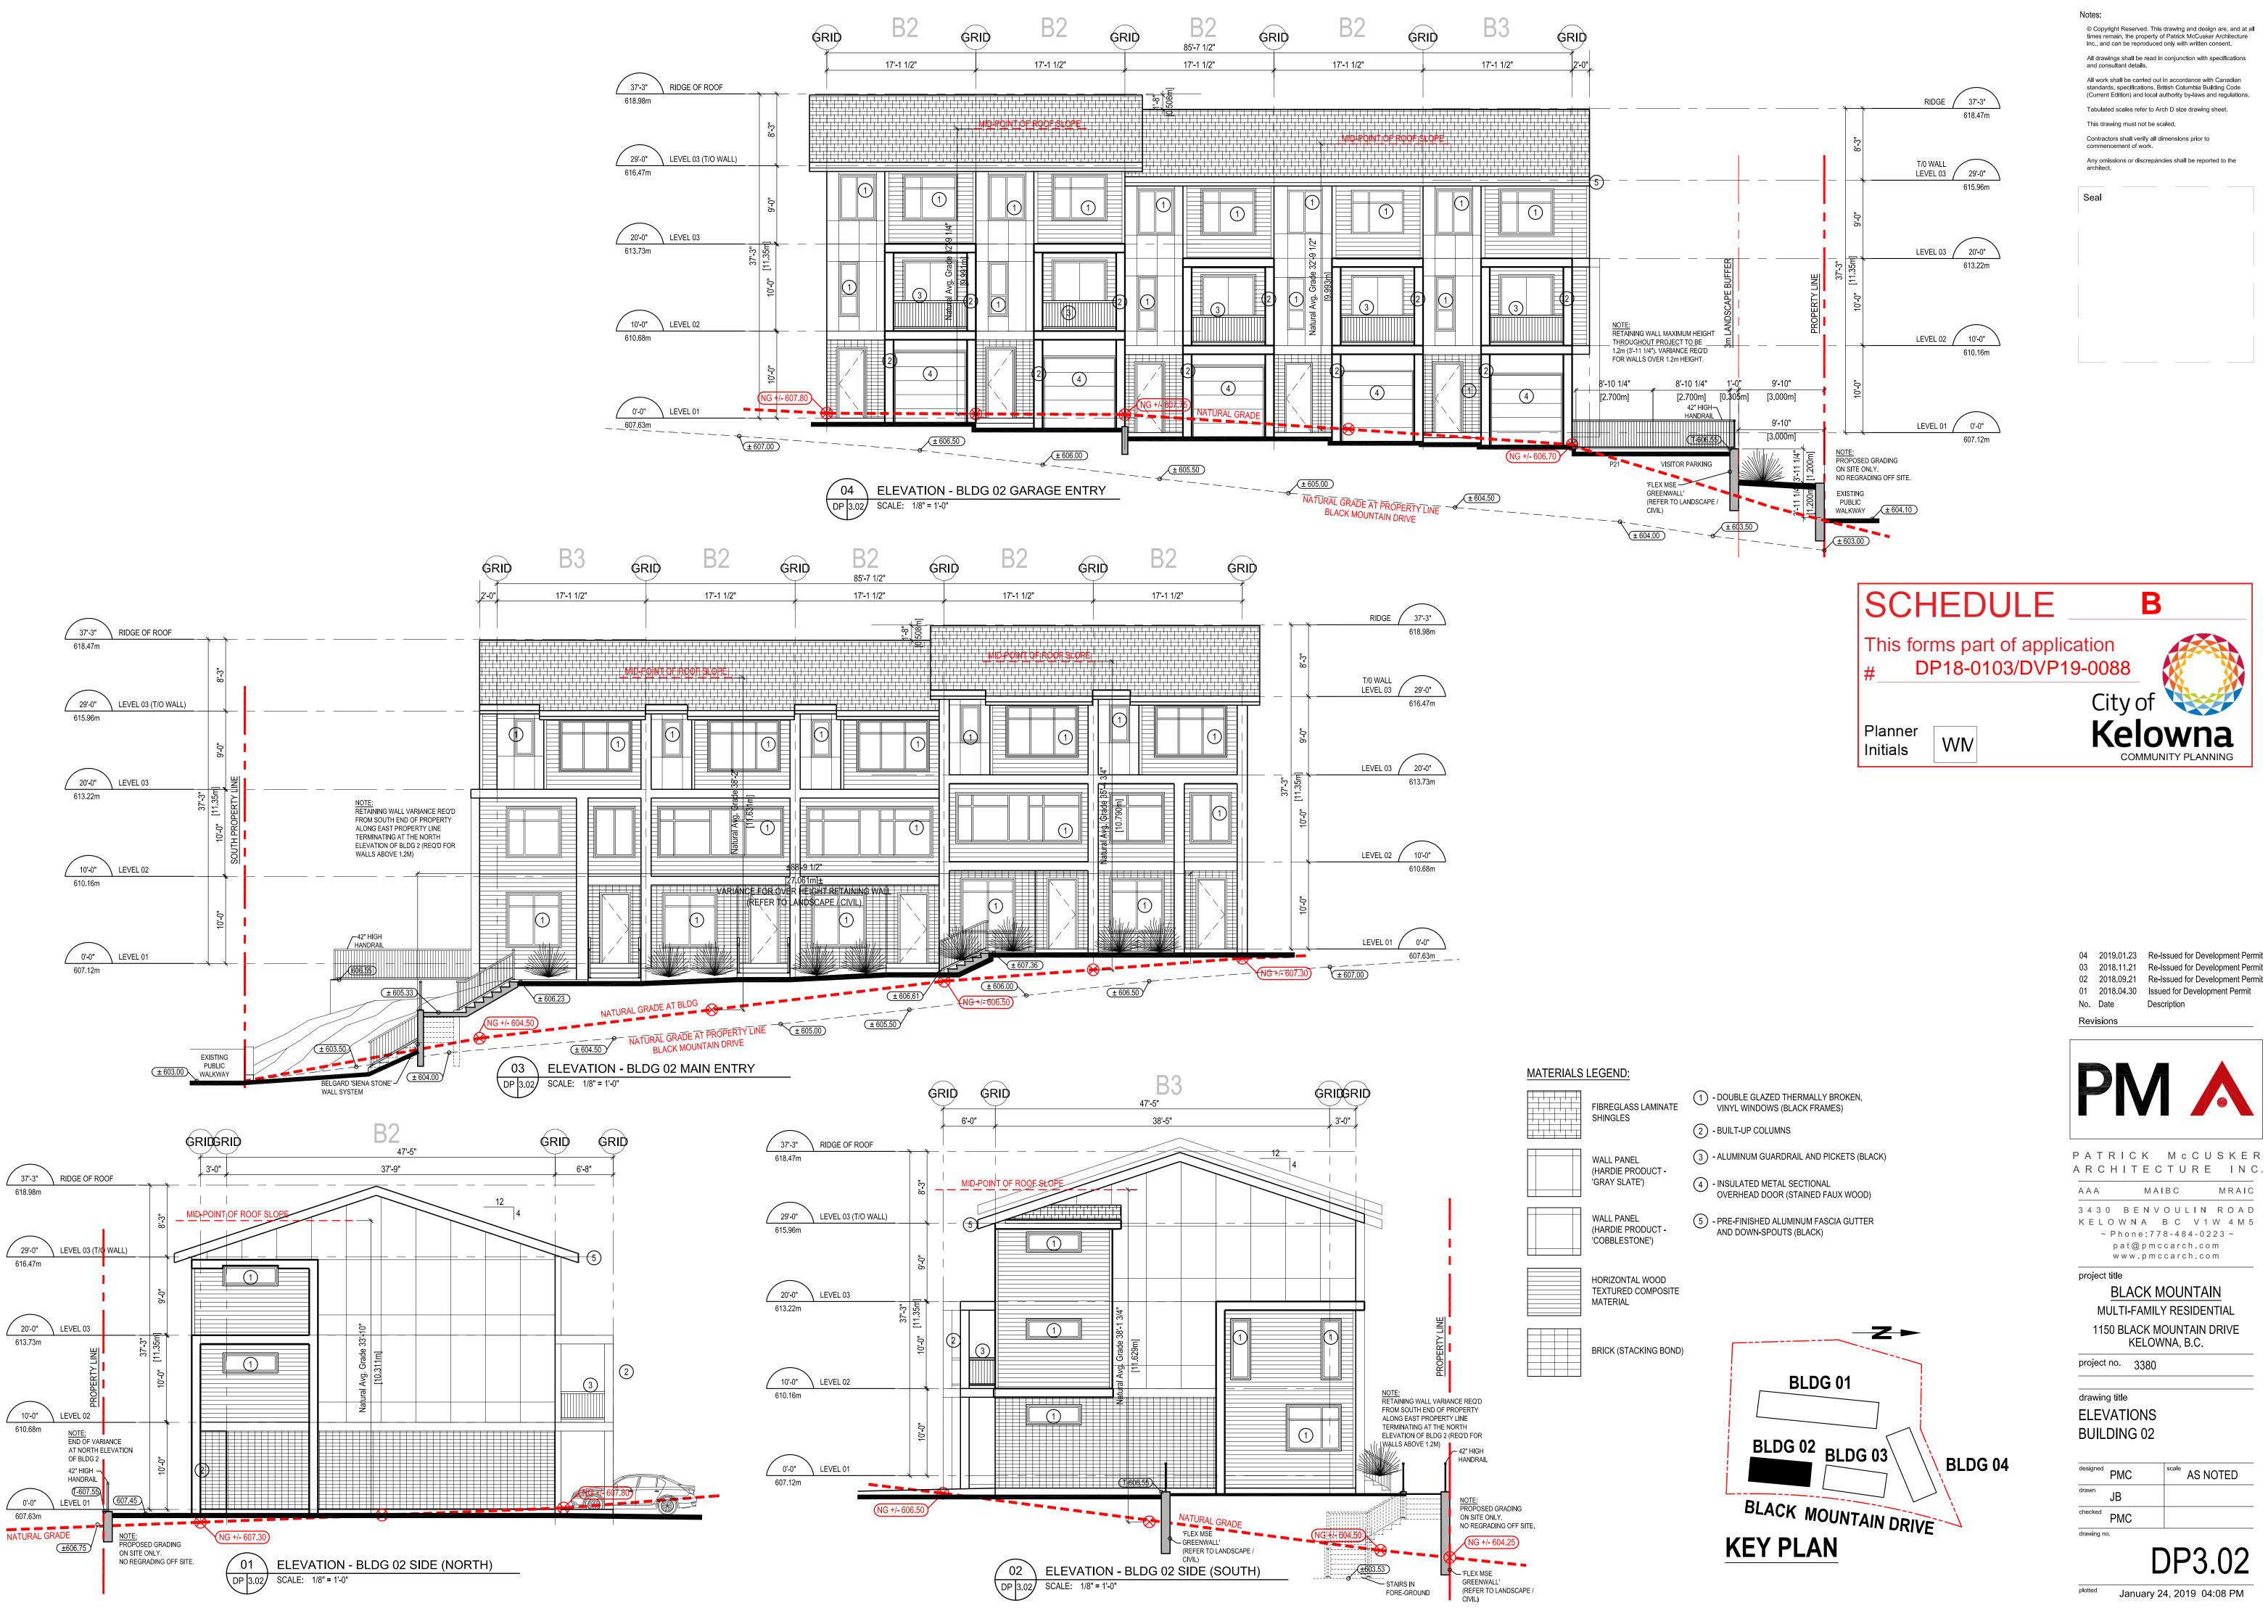
ΛTE	$\cup$	VINYL WINDOWS (BLACK FRAM
	2	- BUILT-UP COLUMNS
	3	- ALUMINUM GUARDRAIL AND P
	$\sim$	

03 02 01	2018.11.21 2018.09.21 2018.04.30	Re-Is Issue	ssued fo ssued fo ed for De	r Deve	opmer	nt Perm
No. Rev	Date isions	Desc	ription			
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drawr	JB					
check	PMC					







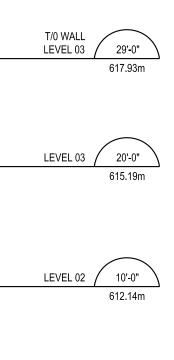

RIDGE / 36'-6"

620.21m

Planner


Initials

WN

LEVEL 01 0'-0" 609.09m

## MATERIALS LEGEND:

-	FIBREGLASS LAMINATE SHINGLES	1 - DOUBLE GLAZED THERMALLY BROKEN, VINYL WINDOWS (BLACK FRAMES)
		2 - BUILT-UP COLUMNS
	WALL PANEL (HARDIE PRODUCT -	3 - ALUMINUM GUARDRAIL AND PICKETS (BLACK)
	'GRAY SLATE')	(4) - INSULATED METAL SECTIONAL OVERHEAD DOOR (STAINED FAUX WOOD)
	WALL PANEL (HARDIE PRODUCT - 'COBBLESTONE')	5 - PRE-FINISHED ALUMINUM FASCIA GUTTER AND DOWN-SPOUTS (BLACK)
	HORIZONTAL WOOD TEXTURED COMPOSITE	

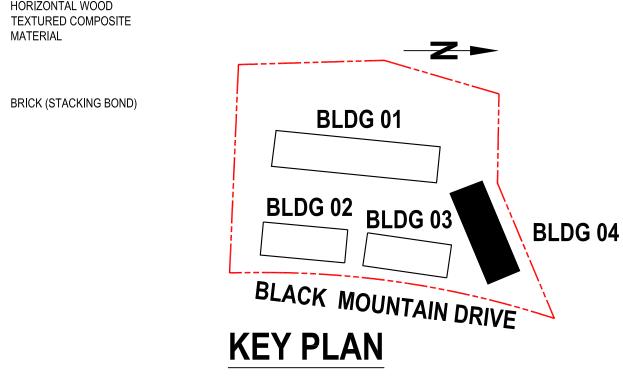



Kelowna

COMMUNITY PLANNING

February 25, 2019 09:57 AM








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m	Contractors shall verify all dimensions prior to commencement of work.
	Any omissions or discrepancies shall be reported to the architect.
	Seal
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- OUBLE GLAZED THERMALLY BROKEN, VINYL WINDOWS (BLACK FRAMES) FIBREGLASS LAMINATE 2 - BUILT-UP COLUMNS

- TEXTURED COMPOSITE
- BRICK (STACKING BOND)

NO REGRADING OFF SITE.



**KEY PLAN** 

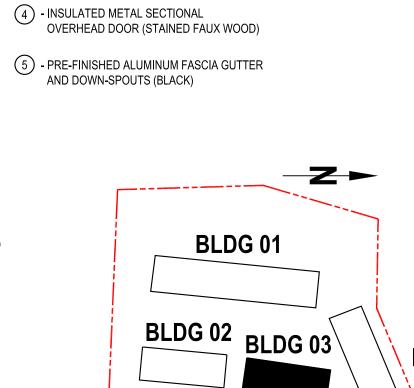(3) - ALUMINUM GUARDRAIL AND PICKETS (BLACK)

BLDG 04 BLACK MOUNTAIN DRIVE



designed	PMC	scale	AS NOTE
drawn	JB		
checked	PMC		
drawing no	).	_	


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MATERIAL

MATERIALS LEGEND:


FIBREGLASS LAMINATE SHINGLES

WALL PANEL (HARDIE PRODUCT -'GRAY SLATE')

(HARDIE PRODUCT -'COBBLESTONE')

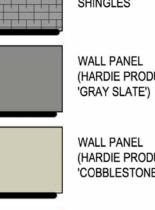HORIZONTAL WOOD TEXTURED COMPOSITE

BRICK

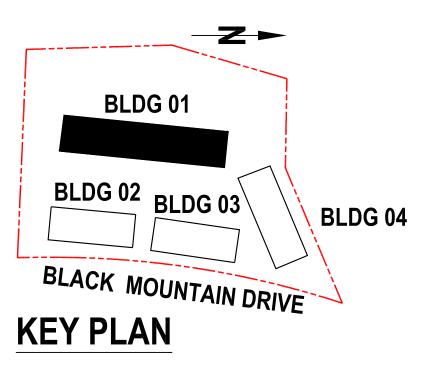


042019.01.23Re-Issued for Development Permit032018.11.21Re-Issued for Development Permit022018.09.21Re-Issued for Development Permit012018.04.30Issued for Development Permit No. Date Description Revisions **PM** PATRICK MCCUSKER ARCHITECTURE INC. AAA MAIBC MRAIC 3430 BENVOULIN ROAD KELOWNA BC V1W 4M5 ~ Phone:778-484-0223 ~ pat@pmccarch.com www.pmccarch.com project title BLACK MOUNTAIN MULTI-FAMILY RESIDENTIAL 1150 BLACK MOUNTAIN DRIVE KELOWNA, B.C. project no. 3380 \_\_\_\_\_ drawing title ELEVATIONS **BUILDING 01** (COLOURED) designed PMC AS NOTED drawn checked PMC drawing no.

Notes:

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03 ILLUSTRATION - BLDG 02 FROM DRIVE AISLE SCALE: NTS



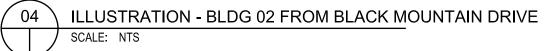





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	All drawings shall be read in conjunction with specifications and consultant details.
	All work shall be carried out in accordance with Canadian standards, specifications, British Columbia Building Code (Current Edition) and local authority by-laws and regulations.
	Tabulated scales refer to Arch D size drawing sheet.
	This drawing must not be scaled.
	Contractors shall verify all dimensions prior to commencement of work.
	Any omissions or discrepancies shall be reported to the architect.
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COMMUNITY PLANNING



MATERIALS LEGEND:

HORIZONTAL WOOD TEXTURED COMPOSITE MATERIAL

FIBREGLASS LAMINATE

SHINGLES

BLDG 01 BLDG 02 BLDG 03 BLACK MOUNTAIN DRIVE **KEY PLAN** 

**−Z ►** 

BLDG 04

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	City of					
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COMMUNITY PLANNING

MATERIALS LEGEND:


FIBREGLASS LAMINATE SHINGLES

WALL PANEL (HARDIE PRODUCT -GRAY SLATE')

WALL PANEL (HARDIE PRODUCT -'COBBLESTONE')


HORIZONTAL WOOD TEXTURED COMPOSITE MATERIAL

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All work shall be carried out in accordance with Canadian standards, specifications, British Columbia Building Code (Current Edition) and local authority by-laws and regulations. Tabulated scales refer to Arch D size drawing sheet. This drawing must not be scaled. Contractors shall verify all dimensions prior to commencement of work. Any omissions or discrepancies shall be reported to the architect. Seal LANEWAY NEAR  $(\pm 609.00)$ NATURAL GRADE AT PROPERTY LINE NG +/- 608.60 NATURAL BLACK MOUNTAIN DRIVE GRADE AT BLDG SCHEDULE Β This forms part of application DP18-0103/DVP19-0088 City of Kelowna Planner WN Initials COMMUNITY PLANNING

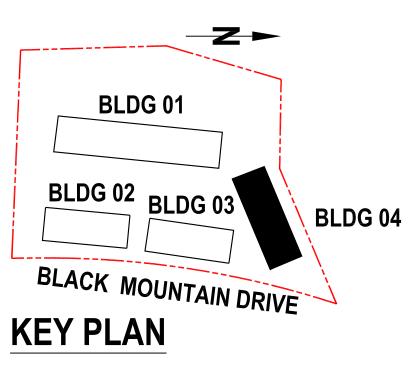
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All drawings shall be read in conjunction with specifications and consultant details.

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Revisions
PATRICK MCCUSKER ARCHITECTURE INC.
ARCHITECTURE INC.
3430 BENVOULIN ROAD
KELOWNA BC V1W 4M5 ~Phone:778-484-0223~ pat@pmccarch.com www.pmccarch.com
project title
BLACK MOUNTAIN
MULTI-FAMILY RESIDENTIAL
1150 BLACK MOUNTAIN DRIVE KELOWNA, B.C.
project no. 3380
drawing title SECTION - SITE
drawn ID
PMC
DP4.01

COMMUNITY PLANNING

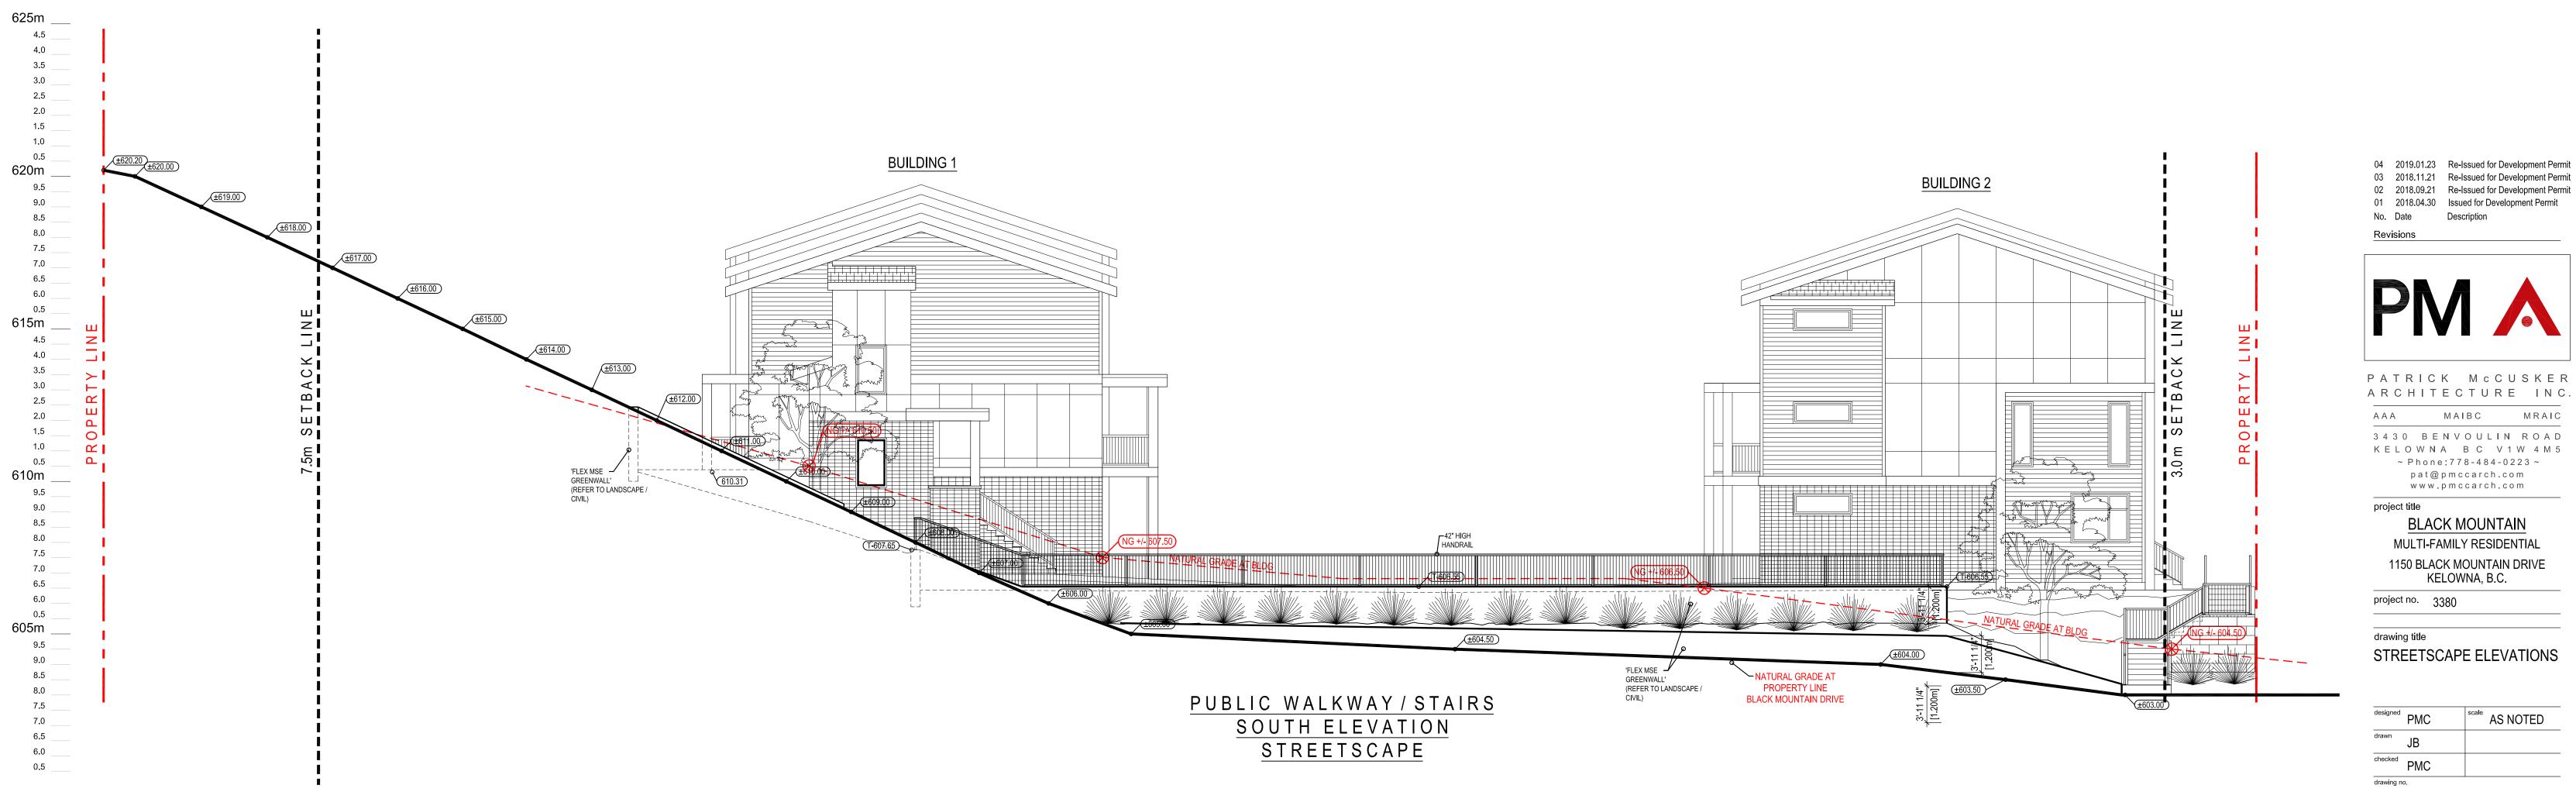January 24, 2019 04:37 PM

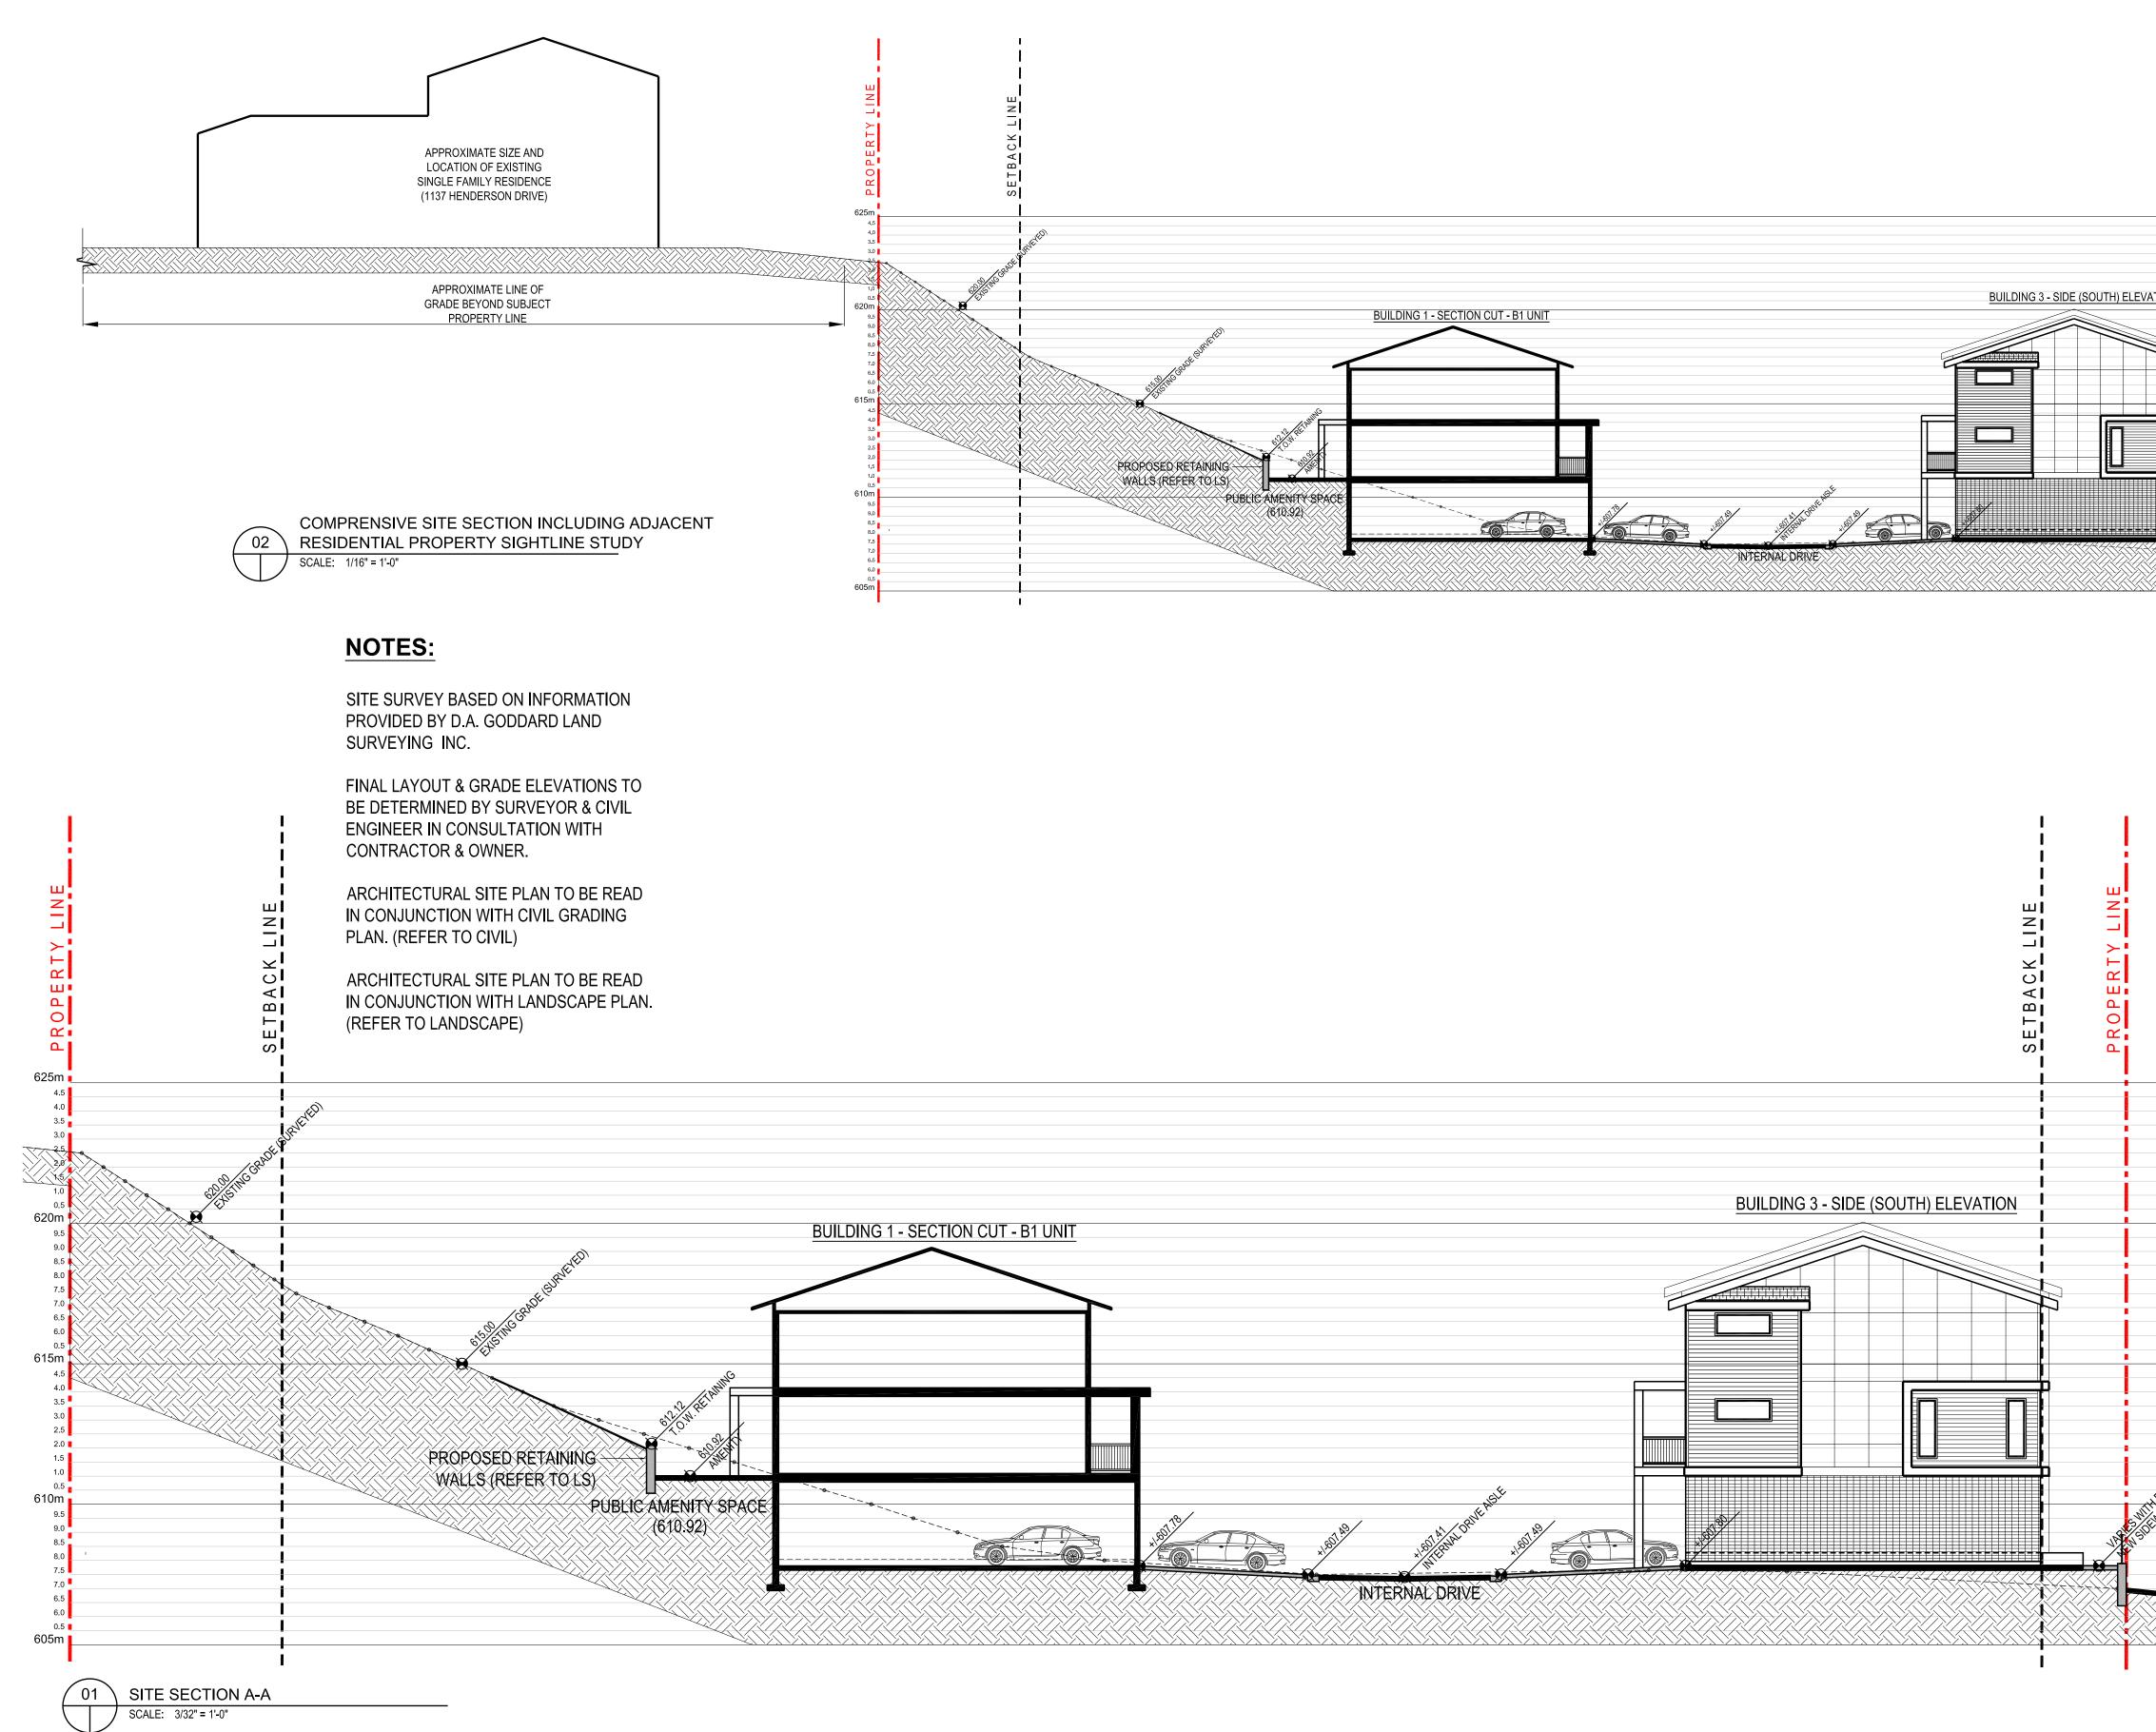

## NOTES

- IRRIGATION SYSTEM.

# PLANT LIST

## **BOTANICAL NAME** TRFFS

- PINUS CONTORTA LATIFOLIA POPULUS TREMULOIDES 'NE-ARB' QUERCUS ROBUR X BICOLOR 'LONG'
- SHRUBS, PERENNIALS & GRASSES AMELANCHIER ALNIFLORA 'REGENT' ATHYRIUM FILIX-FEMINA 'LADY IN RED' COREOPSIS GRANDIFLORA 'BABY SUN' DECENTRA SPECTABILIS 'ALBA' ECHINACEA PURPUREA 'MAGNUS' HELICTOTRICHON SEMPERVINEUS Heuchera 'Frosted Violet' HOSTA 'HALYON' JUNIPERUS SQUAMATA 'BLUE STAR' LEUCANTHEMUM SUPERBUM 'BECKY'
- LONICERA XYLOSTEOIDES 'MINIGLOBE' MUGOPINE 'MOPS' PEROVSKIA ATRIPLICIFOLIA

BECKY SHASTA DAISY

MOPS MUGO PINE

NEARLY WILD ROSE

SNOW HILL SALVIA

HICK'S YEW


russian sage

MINIGLOBE HONEYSUCKLE

GROW-LOW FRAGRANT SUMAC

GOLDSTURM CONEFLOWER

RHUS AROMATICA 'GROW-LOW' ROSA 'NEARLY WILD' RUDBECKIA FULGIDA 'GOLDSTURM' SALVIA MEMOROSA 'SNOW HILL' Taxus Media 'Hicksii'

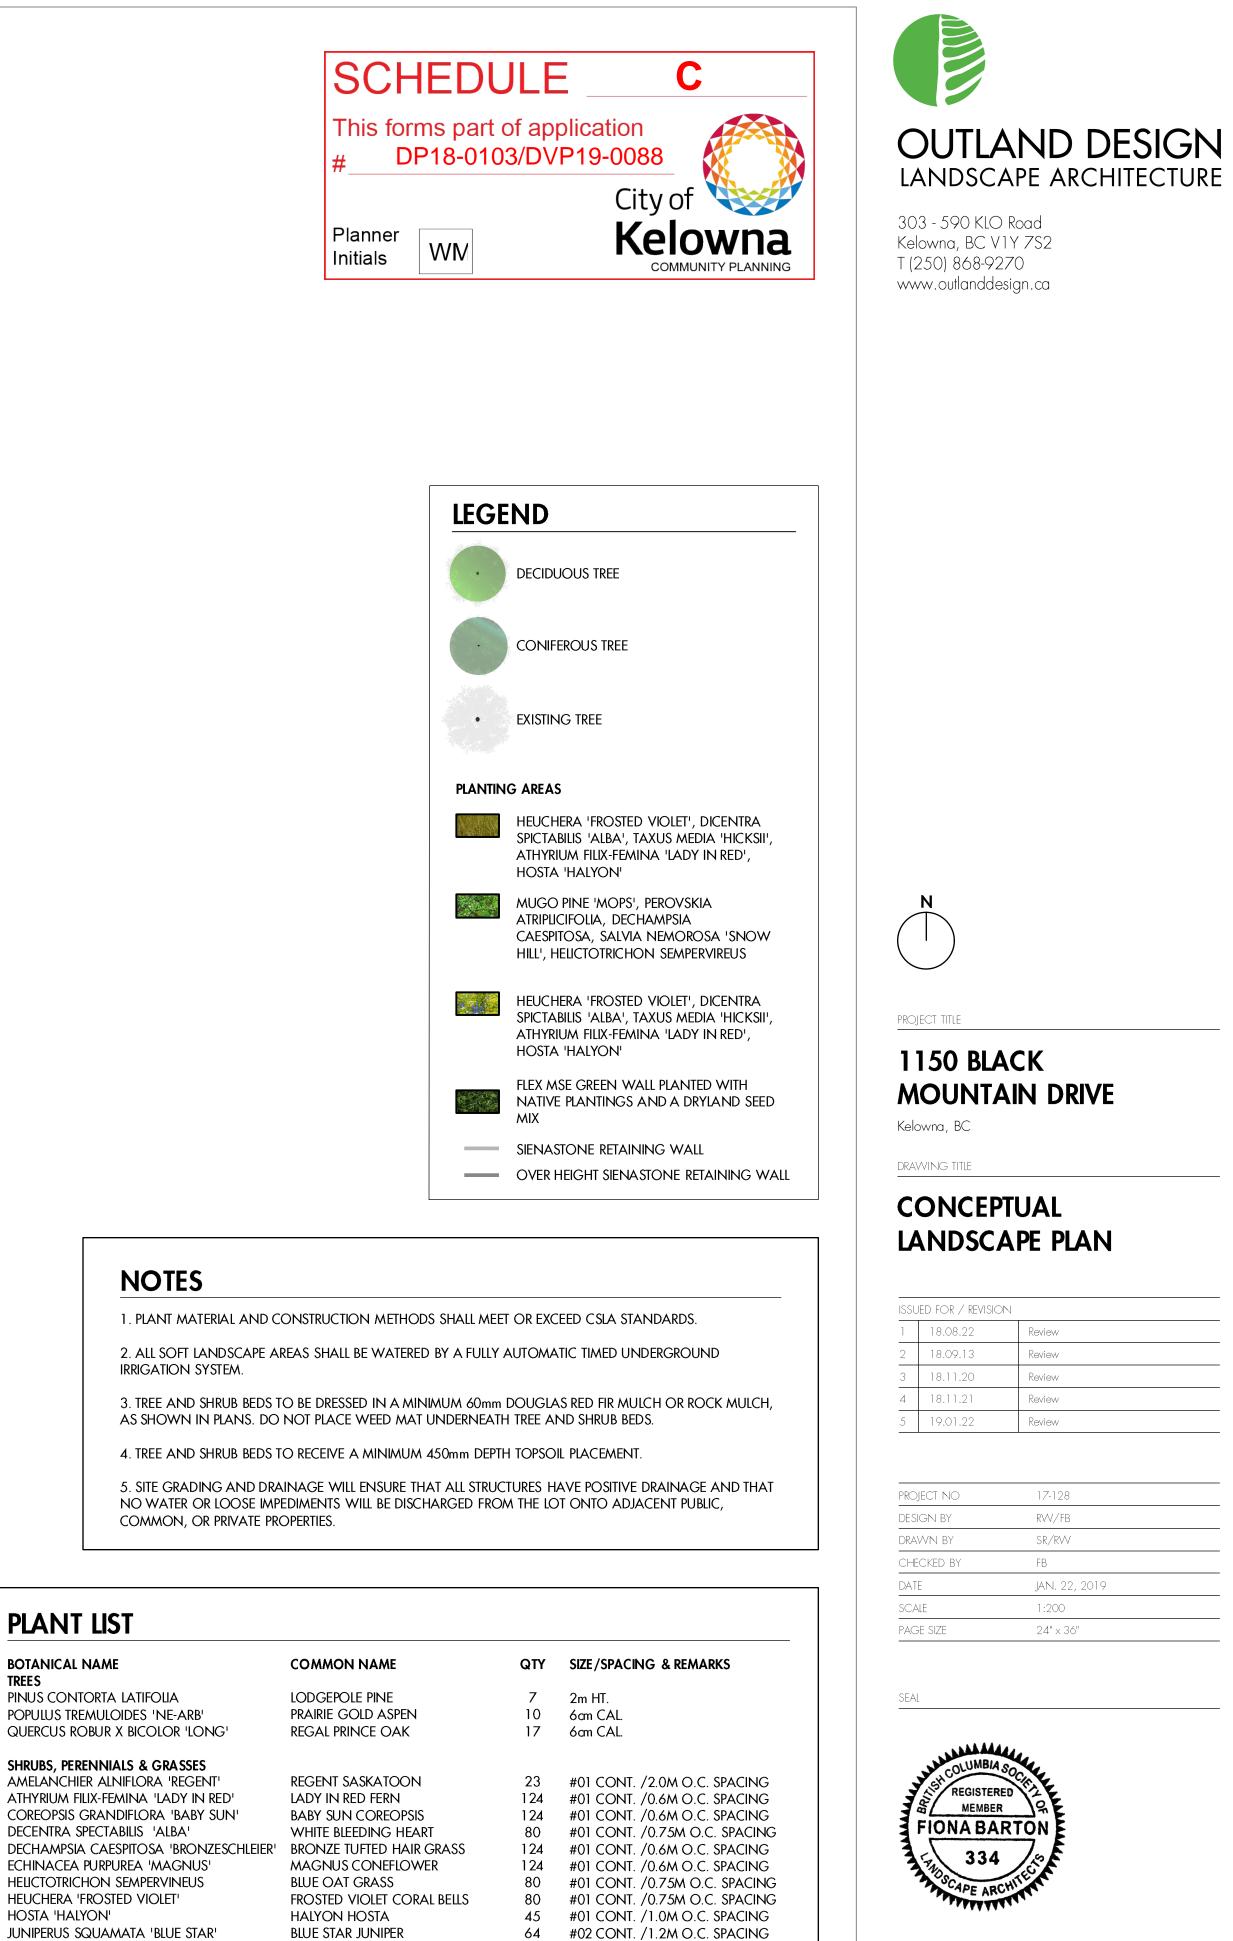

124 #01 CONT. /0.6M O.C. SPACING

64 #01 CONT. / 1.2M O.C. SPACING

45 #02 CONT. /1.0M O.C. SPACING

45 #01 CONT. /1.0M O.C. SPACING

80 #01 CONT. /0.75M O.C. SPACING

124 #01 CONT. /0.6M O.C. SPACING

124 #01 CONT. /0.6M O.C. SPACING

45 #01 CONT. /1.0M O.C. SPACING

23 #01 CONT. /2.0M O.C. SPACING

DRAWING NUMBER

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<b>RRIGA</b> 1	ION LEGEND						DESIGN HITECTURE
:==]	ZONE #1: LOW VOLUME POP-UP SPRAYHEADS FOR TURF AREAS TOTAL AREA: 104 sq.m. MICROCLIMATE: EAST EXPOSURE, FULL SUN ESTIMATED ANNUAL WATER USE: 149 cu.m. ZONE #2: LOW VOLUME POP-UP SPRAYHEADS FOR TURF AREAS			Ke T (	03 - 590 KLO elowna, BC V1 (250) 868-92; ww.outlanddes	Y 7S2 70	
J	TOTAL AREA: 92 sq.m. MICROCLIMATE: EAST EXPOSURE, FULL SUN ESTIMATED ANNUAL WATER USE: 131 cu.m.	SC	Η	ED	ULE		С
	ZONE #3: LOW VOLUME POP-UP SPRAYHEADS FOR TURF AREAS TOTAL AREA: 70 sq.m. MICROCLIMATE: EAST EXPOSURE, PARTIALLY SHADED BY BUILDING ESTIMATED ANNUAL WATER USE: 100 cu.m.	This t #			rt of appli 103/DVP		
]	ZONE #4: LOW VOLUME POP-UP SPRAYHEADS FOR TURF AREAS TOTAL AREA: 89 sq.m. MICROCLIMATE: EAST EXPOSURE, PARTIALLY SHADED BY BUILDING ESTIMATED ANNUAL WATER USE: 127 cu.m.	Planne	er [			City <b>Ke</b>	-
]	ZONE #5: LOW VOLUME POP-UP SPRAYHEADS FOR TURF AREAS TOTAL AREA: 100 sq.m. MICROCLIMATE: EAST EXPOSURE, PARTIALLY SHADED BY BUILDING ESTIMATED ANNUAL WATER USE: 143 cu.m.	Initials		WN			
==3	ZONE #6: LOW VOLUME POP-UP SPRAYHEADS FOR TURF AREAS TOTAL AREA: 92 sq.m. MICROCLIMATE: EAST EXPOSURE, PARTIALLY SHADED BY TREES ESTIMATED ANNUAL WATER USE: 131 cu.m.						
:==]	ZONE #7: HIGH EFFICIENCY SUBSURFACE DRIP IRRIGATION FOR MODERATE WATER USE PLANTING AREAS TOTAL AREA: 200 sq.m. MICROCLIMATE: SOUTH EAST EXPOSURE, PARTIALLY SHADED BY BU ESTIMATED ANNUAL WATER USE: 111 cu.m.	IILDING					
:==]	ZONE #8: HIGH EFFICIENCY SUBSURFACE DRIP IRRIGATION FOR MG WATER USE PLANTING AREAS TOTAL AREA: 198 sq.m. MICROCLIMATE: SOUTH WEST EXPOSURE, PARTIALLY SHADED BY BU ESTIMATED ANNUAL WATER USE: 110 cu.m.						
	ZONE #9: HIGH EFFICIENCY SUBSURFACE DRIP IRRIGATION FOR MODERATE WATER USE PLANTING AREAS TOTAL AREA: 34 sq.m. MICROCLIMATE: WEST EXPOSURE, PARTIALLY SHADED BY BUILDING ESTIMATED ANNUAL WATER USE: 19 cu.m.			(	N		
	ZONE #10: HIGH EFFICIENCY SUBSURFACE DRIP IRRIGATION FOR MODERATE WATER USE PLANTING AREAS TOTAL AREA: 160 sq.m. MICROCLIMATE: WEST EXPOSURE, PARTIALLY SHADED BY BUILDING ESTIMATED ANNUAL WATER USE: 81 cu.m.			PRC	Dject title		
==]	ZONE #11: HIGH EFFICIENCY SUBSURFACE DRIP IRRIGATION FOR MODERATE WATER USE PLANTING AREAS TOTAL AREA: 137 sq.m. MICROCLIMATE: WEST EXPOSURE, PARTIALLY SHADED BY WALLS ESTIMATED ANNUAL WATER USE: 76 cu.m.			1	150 BLA	CK MO	UNTAIN
:==]	ZONE #12: HIGH EFFICIENCY SUBSURFACE DRIP IRRIGATION FOR MODERATE WATER USE PLANTING AREAS TOTAL AREA: 41 sq.m. MICROCLIMATE: WEST EXPOSURE, PARTIALLY SHADED BY BUILDING ESTIMATED ANNUAL WATER USE: 23 cu.m.				Howna, BC AWING TITLE VATFR C	ONSER	VATION/
:==3	ZONE #13: HIGH EFFICIENCY SUBSURFACE DRIP IRRIGATION FOR MODERATE WATER USE PLANTING AREAS TOTAL AREA: 206 sq.m. MICROCLIMATE: WEST EXPOSURE, PARTIALLY SHADED BY BUILDING ESTIMATED ANNUAL WATER USE: 114 cu.m.	/TREES			RIGATIC	on plan	-
:==:	ZONE #14: HIGH EFFICIENCY SUBSURFACE DRIP IRRIGATION FOR MODERATE WATER USE PLANTING AREAS TOTAL AREA: 73 sq.m. MICROCLIMATE: EAST EXPOSURE, PARTIALLY SHADED BY TREES ESTIMATED ANNUAL WATER USE: 41 cu.m.			1 2 3	SUED FOR / REVISION 18.08.22 18.09.13 18.11.20 18.11.21	Review Review Review	
	ZONE #15: HIGH EFFICIENCY SUBSURFACE DRIP IRRIGATION FOR MODERATE WATER USE PLANTING AREAS TOTAL AREA: 154 sq.m. MICROCLIMATE: WEST EXPOSURE, PARTIALLY SHADED BY BUILDING ESTIMATED ANNUAL WATER USE: 86 cu.m.	2		4 5	18.11.21	Review Review	
]	ZONE #16: HIGH EFFICIENCY SUBSURFACE DRIP IRRIGATION FOR MODERATE WATER USE PLANTING AREAS TOTAL AREA: 78 sq.m.			DE DR	OJECT NO SIGN BY AWN BY HECKED BY	17-128 FB/SR RWV/MC FB	
	MICROCLIMATE: EAST EXPOSURE, PARTIALLY SHADED BY TREES ESTIMATED ANNUAL WATER USE: 43 cu.m.					JAN. 22, 201	9

## **IRRIGATION NOTES**

1. IRRIGATION PRODUCTS AND INSTALLATION METHODS SHALL MEET OR EXCEED THE REQUIREMENTS OF THE WATER USE REGULATION BYLAW NO. 10480 AND THE SUPPLEMENTARY SPECIFICATIONS IN THE CITY OF KELOWNA BYLAW 7900 (PART 6, SCHEDULE 5).

2. THE IRRIGATION SYSTEM SHALL MEET THE REQUIREMENTS, REGULATIONS, AND BYLAWS OF THE WATER PURVEYOR.

3. THE IRRIGATION SYSTEM SHALL BE EQUIPPED WITH AN APPROVED BACKFLOW PREVENTION DEVICE, WATER METER, AND SHUT OFF VALVE LOCATED OUTSIDE THE BUILDING ACCESSIBLE TO THE

4. AN APPROVED SMART CONTROLLER SHALL BE INSTALLED. THE IRRIGATION SCHEDULING TIMES SHALL UTILIZE A MAXIMUM ET VALUE OF 7" / MONTH (KELOWNA JULY ET), TAKING INTO CONSIDERATION SOIL TYPE, SLOPE, AND MICROCLIMATE.

5. DRIP LINE AND EMITTERS SHALL INCORPORATE TECHNOLOGY TO LIMIT ROOT INTRUSION.

6. IRRIGATION SLEEVES SHALL BE INSTALLED TO ROUTE IRRIGATION LINES UNDER HARD SURFACES AND FEATURES.

7. IRRIGATION PIPE SHALL BE SIZED TO ALLOW FOR A MAXIMUM FLOW OF 1.5m /Sec.

8. A FLOW SENSOR AND MASTER VALVE SHALL BE CONNECTED TO THE CONTROLLER AND PROGRAMMED TO STOP FLOW TO THE SYSTEM IN CASE OF AN IRRIGATION WATER LEAK.



DRAWING NUMBER

SEAL



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**CITY OF KELOWNA** 

Initials

## MEMORANDUM

Date: May 18, 2018

File No.: DP18-0103

To: Urban Planning Management (TH)

Development Engineering Manager (JK) From:

Subject: 1150 Black Mountain Dr.

The Development Engineering Department has the following comments and requirements associated with this Development Permit application DP18-0103. The road and utility upgrading requirements outlined in this report will be a requirement of this development.

The Development Engineering Technologist for this project is Andy Marshall

#### 1. **Domestic Water and Fire Protection**

This development is within the service area of the Black Mountain Irrigation District a) (BMID). The developer is required to make satisfactory arrangements with the BMID for these items. All charges for service connection and upgrading costs are to be paid directly to BMID.

#### 2. **Sanitary Sewer**

The developer's consulting mechanical engineer will determine the requirements (a) of this proposed development and establish the required size and preferred location of the new service. Only one service will be permitted for this development. The applicant, at his cost, will arrange for installation of a new service.

#### 3. **Storm Drainage**

The developer must engage a consulting civil engineer to provide a storm water management plan for the site, which meets the requirements of the Subdivision, Development and Servicing Bylaw No. 7900. The storm water management plan must also include provision of lot grading plan, minimum basement elevation (MBE), if applicable, and provision of a storm drainage service for the development and / or recommendations for onsite drainage containment and disposal systems. Only one service will be permitted for this development. The applicant, at his cost, will arrange for the installation of one overflow service if required.

#### **Road Improvements** 4.

a) This development application will be limited to one access to Black Mountain Dr. maximum 6m wide.

#### 5. Electric Power and Telecommunication Services

All proposed service connections are to be installed underground. It is the developer's responsibility to make a servicing application with the respective electric power, telephone and cable transmission companies to arrange for these services, which would be at the applicant's cost.

### 6. Design and Construction

- a) Design, construction supervision and inspection of all off-site civil works and site servicing must be performed by a Consulting Civil Engineer and all such work is subject to the approval of the City Engineer. Drawings must conform to City standards and requirements.
- b) Engineering drawing submissions are to be in accordance with the City's "Engineering Drawing Submission Requirements" Policy. Please note the number of sets and drawings required for submissions.
- c) Quality Control and Assurance Plans must be provided in accordance with the Subdivision, Development & Servicing Bylaw No. 7900 (Part 5 and Schedule 3).
- d) A "Consulting Engineering Confirmation Letter" (City document 'C') must be completed prior to submission of any designs.
- e) Before any construction related to the requirements of this subdivision application commences, design drawings prepared by a professional engineer must be submitted to the City's Development Engineering Department. The design drawings must first be "Issued for Construction" by the City Engineer. On examination of design drawings, it may be determined that rights-of-way are required for current or future needs.

#### 7. Servicing Agreements for Works and Services

- a) A Servicing Agreement is required for all offsite works and services on City lands in accordance with the Subdivision, Development & Servicing Bylaw No. 7900. The applicant's Engineer, prior to preparation of Servicing Agreements, must provide adequate drawings and estimates for the required works. The Servicing Agreement must be in the form as described in Schedule 2 of the bylaw.
- b) Part 3, "Security for Works and Services", of the Bylaw, describes the Bonding and Insurance requirements of the Owner. The liability limit is not to be less than \$5,000,000 and the City is to be named on the insurance policy as an additional insured.

#### 8. Other Engineering Comments

a) Provide all necessary Statutory Rights-of-Way for any utility corridors as required.

#### 9. Geotechnical Report

a) Provide a comprehensive geotechnical report prepared by a Professional Engineer competent in the field of hydro-geotechnical engineering to address the

items below: NOTE: The City is relying on the Geotechnical Engineer's report to prevent any damage to property and/or injury to persons from occurring as a result of problems with soil slippage or soil instability related to this proposed development.

- Overall site suitability for development.

- Presence of ground water and/or springs.
- Presence of fill areas.
- Presence of swelling clays.
- Presence of sulphates.
- Potential site erosion.
- Provide specific requirements for footings and foundation construction.

- Provide specific construction design sections for roads and utilities over and above the City's current construction standards

## 10. Development Permit and Site Related Issues

Access and Manoeuvrability

(i) Ensure acceptable turning movements onsite for MSU design vehicle.

### 11. Charges and Fees

- a) Development Cost Charges (DCC's) are payable.
- b) Fees per the "Development Application Fees Bylaw" include:
  - i) Engineering and Inspection Fee: 3.5% of offsite construction value (plus GST).

James Kay, P. Eng. Development Engineering Manager

agm