CITY	OF	KELOWNA

MEMORANDUM

Planner Initials LK

Date: June 07, 2018

File No.: Z18-0062

To: Community Planning (LK)

From: Development Engineering Manager (JK)

Subject: 555 Fuller Ave

RM5 to C7

ATTACHMENT

This forms part of application

DP18-0115 & DVP18-0116

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Kelowna

City of

Development Engineering Department have the following comments and requirements associated with this application. The road and utility upgrading requirements outlined in this report will be a requirement of this development. The Development Engineering Technologist for this project is Jason Angus.

.1) General

- a) Where there is a possibility of a high water table or surcharging of storm drains during major storm events, non-basement buildings may be required. This must be determined by the engineer and detailed on the Lot Grading Plan required in the drainage section.
- b) Provide easements as may be required.
- c) These are Development Engineering comments/requirements and are subject to the review and requirements from the Ministry of Transportation (MOTI) Infrastructure Branch.
- d) The address of this proposed development should be addressed off of Bertram St and not Fuller Ave.

.2) Road Dedication and Subdivision Requirements

- a) Access to the development should be via laneways.
- b) Laneway access from Bertram St should be designed to the SS-C7 standard with a continuous sidewalk at property line.

.3) Geotechnical Study.

(a) Provide a geotechnical report prepared by a Professional Engineer competent in the field of hydro-geotechnical engineering to address the items below: NOTE: The City is relying on the Geotechnical Engineer's report to prevent any damage to property and/or injury to persons from occurring as a result of problems with soil slippage or soil instability related to this proposed subdivision. The Geotechnical reports must be submitted to the Development Services Department for distribution to the Development Engineering Branch and Inspection Services Division prior to submission of Engineering drawings or application for subdivision approval:

- i. Area ground water characteristics, including any springs and overland surface drainage courses traversing the property. Identify any monitoring required.
- ii. Site suitability for development.
- iii. Site soil characteristics (i.e. fill areas, sulphate content, unsuitable soils such as organic material, etc.).
- iv. Any special requirements for construction of roads, utilities and building structures.
- v. Recommendations for items that should be included in a Restrictive Covenant.
- vi. Recommendations for roof drains, perimeter drains and septic tank effluent on the site.
- vii. Any items required in other sections of this document.

Additional geotechnical survey may be necessary for building foundations, etc

.4) Water

- a) The property is located within the City of Kelowna service area. The existing lot is serviced with a small -diameter water service. Only one service will be permitted to the site or per property. The applicant, at his cost, will arrange for the removal of the existing service and the installation of one new larger metered water service.
- b) The developer's consulting engineer will determine the domestic and fire protection requirements of this proposed development and establish hydrant requirements and service needs. The bylaw requirement for commercial zoning is 150l/s and is available at the site. If it is determined that upgrades to any other existing water distribution system must be made to achieve the required fire flows, additional bonding will be required.
- c) An approved backflow protection devise must also be installed on site as required by the City Plumbing Regulation and Water Regulation bylaws.
- d) A water meter is mandatory for this development and must be installed inside a building on the water service inlet as required by the City Plumbing Regulation and Water Regulation bylaws. The developer or building contractor must purchase the meter from the City at the time of application for a building permit from the Inspection Services Department, and prepare the meter setter at his cost

.5) Sanitary Sewer

a) The developer's consulting mechanical engineer will determine the development requirements of this proposed development and establish the service needs. Only one service will be permitted for this development. The applicant, at his cost, will arrange for the removal and

disconnection of the existing service and the installation of one new larger service.

.6) Drainage

- a) The developer must engage a consulting civil engineer to provide a storm water management plan for the site, which meets the requirements of the City Storm Water Management Policy and Design Manual. The storm water management plan must also include provision of lot grading plan, minimum basement elevation (MBE), if applicable, and provision of a storm drainage service for the development and / or recommendations for onsite drainage containment and disposal systems.
- b) It will be necessary for the developer to construct storm drainage facilities on Bertram Street and the laneway to accommodate road drainage fronting the proposed development.
- c) Provide a detailed Stormwater Management Plan for this development as per the Subdivision, Development and Servicing Bylaw #7900.
- d) There is a possibility of a high water table or surcharging of storm drains during major storm events. This should be considered in the design of the onsite system.

.7) Roads

- a) Bertram Street is designated an urban collector road. Frontage improvements required include curb and gutter, separate sidewalk, piped storm drainage system, road works, landscaped boulevard complete with underground irrigation system, street lights. A modified SS-R5 cross section will be used and provided at the time of design. The design should include up to centreline of the Bertram Street ROW.
- b) The lane way is designated to be constructed to a commercial cross section of SS-R2. Storm drainage system will be required for this laneway.

.9) Power and Telecommunication Services and Street Lights

- a) All proposed distribution and service connections are to be installed underground. Existing distribution and service connections, on that portion of a road immediately adjacent to the site, are to be relocated and installed underground as the subject properties are within the "City Center Urban Center".
- b) Streetlights must be installed on all roads.
- c) Make servicing applications to the respective Power and Telecommunication utility companies. The utility companies are required to obtain the City's approval before commencing construction.
- d) Re-locate existing poles and utilities, where necessary. Remove aerial trespass (es).

.10) Design and Construction

a) Design, construction supervision and inspection of all off-site civil works and site servicing must be performed by a Consulting Civil Engineer and all such work is subject to the approval of the City Engineer. Drawings must conform to City standards and requirements.

- b) Engineering drawing submissions are to be in accordance with the City's "Engineering Drawing Submission Requirements" Policy. Please note the number of sets and drawings required for submissions.
- c) Quality Control and Assurance Plans must be provided in accordance with the Subdivision, Development & Servicing Bylaw No. 7900 (refer to Part 5 and Schedule 3).
- d) A "Consulting Engineering Confirmation Letter" (City document 'C') must be completed prior to submission of any designs.
- e) Before any construction related to the requirements of this subdivision application commences, design drawings prepared by a professional engineer must be submitted to the City's Development Engineering Department. The design drawings must first be "Issued for Construction" by the City Engineer. On examination of design drawings, it may be determined that rights-of-way are required for current or future needs.

.11) Other Engineering Comments

- a) Provide all necessary Statutory Rights-of-Way for any utility corridors required, including those on proposed or existing City Lands, and for public access to Vaughan Ave via the proposed lane.
- b) If any road dedication affects lands encumbered by a Utility right-of-way (such as Terasen, etc.) please obtain the approval of the utility prior to application for final subdivision approval. Any works required by the utility as a consequence of the road dedication must be incorporated in the construction drawings submitted to the City's Development Manager.

.12) Servicing Agreements for Works and Services

- b) A Servicing Agreement is required for all works and services on City lands in accordance with the Subdivision, Development & Servicing Bylaw No. 7900. The applicant's Engineer, prior to preparation of Servicing Agreements, must provide adequate drawings and estimates for the required works. The Servicing Agreement must be in the form as described in Schedule 2 of the bylaw.
- c) Part 3, "Security for Works and Services", of the Bylaw, describes the Bonding and Insurance requirements of the Owner. The liability limit is not to be less than \$5,000,000 and the City is to be named on the insurance policy as an additional insured.

.13) Charges and Fees

- a) Development Cost Charges (DCC's) are payable
- b) Fees per the "Development Application Fees Bylaw" include:
 - i) Street/Traffic Sign Fees: at cost if required (to be determined after design).
 - ii) Survey Monument, Replacement Fee: \$1,200.00 (GST exempt) only if disturbed.

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Engineering and Inspection Fee: 3.5% of construction value (plus GST). iii) James Kay, P.Eng. Development Engineering Manager JĄ

CITY OF KELOWNA

MEMORANDUM

June 06, 2018 Date:

File No.: OCP18-0013

To: Community Planning (LK)

Development Engineering Manager (JK) From:

Subject: 555 Fuller Ave MRM - MXR

Planner

Initials

The Development Engineering Branch comments and requirements regarding this OCP amendment application are as follows:

1. General

JA/

All the offsite infrastructure and services upgrades are addressed in the Rezoning Engineering Report under file Z18-0062

James Kay, P. Eng. Development Engineering Manager

ATTACHMENT Α This forms part of application # DP18-0115 & DVP18-0116 City of Kelowna LΚ

	CITY OF KELOWNA	ATTACHMENT A
	MEMORANDUM	This forms part of application # DP18-0115 & DVP18-0116 City of
Date:	June 6, 2018	Planner Initials LK Kelowna
File No.:	DP18-0115	COMMUNITY PLANNING
То:	Community Planning (LK)	
From:	Development Engineer Manager (JK)	
Subject:	555 Fuller Ave	

The Development Engineering comments and requirements regarding this Development Permit application are as follows:

1. <u>General.</u>

a) All the offsite infrastructure and services upgrades are addressed in the Rezoning Engineering Report under file Z18-0062.

James Kay, P. Eng. Development Engineering Manager JA

CITY OF KELOWNA

ATTACHMENT

This forms part of application # DP18-0115 & DVP18-0116

LΚ

Planner

Initials

Α

City of 🔇

MEMORANDUM

Date: June 6, 2018

File No.: DVP18-0116

To: Community Planning (LK)

From: Development Engineering Manager (JK)

Subject: 555 Fuller Ave

Development Engineering comments and requirements regarding this development permit application are as follows:

This development variance permit application for the form and character of a multiple dwelling housing with variances to the number of parking stalls and the percentage of commercial frontage, does not compromise any municipal services.

Jarhes Kay, P. Eng. Development Engineering Manager

JA



Ministry of Transportation and Infrastructure

Your File #: Z18-0062 eDAS File #: 2018-02840 Date: Jun/18/2018



City of Kelowna 1435 Water Street Kelowna, British Columbia V1Y 1J4 Canada

Re: Proposed Bylaw – RM5-C7: 555 Fuller Avenue, Kelowna

Preliminary Approval is granted for the rezoning for one year pursuant to Section 52(3)(a) of the Transportation Act.

If you have any questions please feel free to call Kelowna Development Approvals at (250) 712-3660.

Yours truly,

Sudrie Henry

Audrie Henry **District Development Technician**

Local District Address

Kelowna Area Office

300-1358 St. Paul Street Kelowna, BC V1Y 2E1 Canada Phone: (250) 712-3660 Fax: (250) 712-3669

Development Permit & Development Variance Permit DP18-0115 & DVP18-0116



This permit relates to land in the City of Kelowna municipally known as

555 Fuller Avenue

and legally known as

Lot 1 District Lot 139 ODYD Plan EPP78052

and permits the land to be used for the following development:

68-unit purpose built rental apartment building

USE as per Zoning Bylaw

Apartment Housing

The present owner and any subsequent owner of the above described land must comply with any attached terms and conditions.

Date of Council Decision	February 26, 2019
Decision By:	Community Planning

Development Permit Area: Revitalization

This permit will not be valid if development has not commenced by February 26, 2021.

Existing Zone: C7 Future Land Use Designation: MXR

This is NOT a Building Permit.

In addition to your Development Permit, a Building Permit may be required prior to any work commencing. For further information, contact the City of Kelowna, Development Services Branch.

NOTICE

This permit does not relieve the owner or the owner's authorized agent from full compliance with the requirements of any federal, provincial or other municipal legislation, or the terms and conditions of any easement, covenant, building scheme or agreement affecting the building or land.

Owner: City of Kelowna

Applicant: M'akola Development Services

Ryan Smith Community Planning Department Manager Community Planning & Strategic Investments Date

1. SCOPE OF APPROVAL

This Development Permit applies to and only to those lands within the Municipality as described above, and any and all buildings, structures and other development thereon.

This Development Permit is issued subject to compliance with all of the Bylaws of the Municipality applicable thereto, except as specifically varied or supplemented by this permit, noted in the Terms and Conditions below.

The issuance of a permit limits the permit holder to be in strict compliance with regulations of the Zoning Bylaw and all other Bylaws unless specific variances have been authorized by the Development Permit. No implied variances from bylaw provisions shall be granted by virtue of drawing notations that are inconsistent with bylaw provisions and that may not have been identified as required Variances by the applicant or Municipal staff.

2. CONDITIONS OF APPROVAL

- a) The dimensions and siting of the building to be constructed on the land be in accordance with Schedule "A";
- b) The exterior design and finish of the building to be constructed on the land be in accordance with Schedule "B";
- c) Landscaping to be provided on the land be in accordance with Schedule "C"; and
- d) The applicant be required to post with the City a Landscape Performance Security deposit in the form of a "Letter of Credit" in the amount of 125% of the estimated value of the landscaping, as determined by a Registered Landscape Architect.

This Development Permit is valid for two (2) years from the date of Council approval, with no opportunity to extend.

3. PERFORMANCE SECURITY

As a condition of the issuance of this Permit, Council is holding the security set out below to ensure that development is carried out in accordance with the terms and conditions of this Permit. Should any interest be earned upon the security, it shall accrue to the Developer and be paid to the Developer or his or her designate if the security is returned. The condition of the posting of the security is that should the Developer fail to carry out the development hereby authorized, according to the terms and conditions of this Permit within the time provided, the Municipality may use enter into an agreement with the property owner of the day to have the work carried out, and any surplus shall be paid over to the property own of the day. Should the Developer carry out the development permitted by this Permit within the time set out above, the security shall be returned to the Developer or his or her designate. There is filed accordingly:

- a) An Irrevocable Letter of Credit in the amount of \$18,043.75 or
- b) A certified cheque in the amount of **\$18,043.75**

Before any bond or security required under this Permit is reduced or released, the Developer will provide the City with a statutory declaration certifying that all labour, material, workers' compensation and other taxes and costs have been paid.

The PERMIT HOLDER is the <u>CURRENT LAND OWNER</u>. Security shall <u>ONLY</u> be returned to the signatory of the Landscape Agreement or their designates.

Revitalization Development Permit Area

Consideration has been given to the following guidelines as identified in Section 14.B. of the City of Kelowna Official Community Plan relating to Revitalization Development Permit A

REVITALIZATION DEVELOPMENT PERMIT AREA		NO	N/A
Relationship to the Neighbourhood and Street			
Does the proposal maintain the established or envisioned architectural character of the neighbourhood?	\checkmark		
Do developments adjacent to non-revitalization areas create an appropriate transition?			\checkmark
Are spaces for pedestrian friendly amenities, such as street furniture, included on site?		\checkmark	
Is the ratio of streetwall height to street width less than 0.75:1?	\checkmark		
Does the building frontage occupy the entire length of the street, without drive aisles or other dead zones?	\checkmark		
Building Design			
Are architectural elements aligned from one building to the next?			\checkmark
Are the effects of shadowing on public areas mitigated?	\checkmark		
Are doors or windows incorporated into at least 75% of street frontage?	\checkmark		
Do proposed buildings have an identifiable base, middle and top?	\checkmark		
Are windows, entrances, balconies and other building elements oriented towards surrounding points of interest and activity?	\checkmark		
Are architectural elements such as atriums, grand entries and large ground-level	\checkmark		
windows used to reveal active interior spaces? Are buildings designed with individual entrances leading to streets and pathways		/	
rather than with mall style entrances and internal connections?		V	
For multiple unit residential projects, is ground level access for first storey units provided?	\checkmark		
Are buildings finished with materials that are natural, local, durable and appropriate to the character of the development?	\checkmark		
Are prohibited materials such as vinyl siding, reflective or non-vision glass, plastic, unpainted or unstained wood, and concrete block not used in the design?	\checkmark		
Are stucco and stucco-like finishes omitted as a principal exterior wall material?		\checkmark	
Are vents, mechanical rooms/equipment and elevator penthouses integrated with the roof or screened with finishes compatible with the building's design?	\checkmark		
View Corridors			
Are existing views preserved and enhanced?			\checkmark
Vehicular Access and Parking			·
Are at-grade and above-grade parking levels concealed with façade treatments?			\checkmark
Are garage doors integrated into the overall building design?	\checkmark		

ATTACHMENT

This forms part of application


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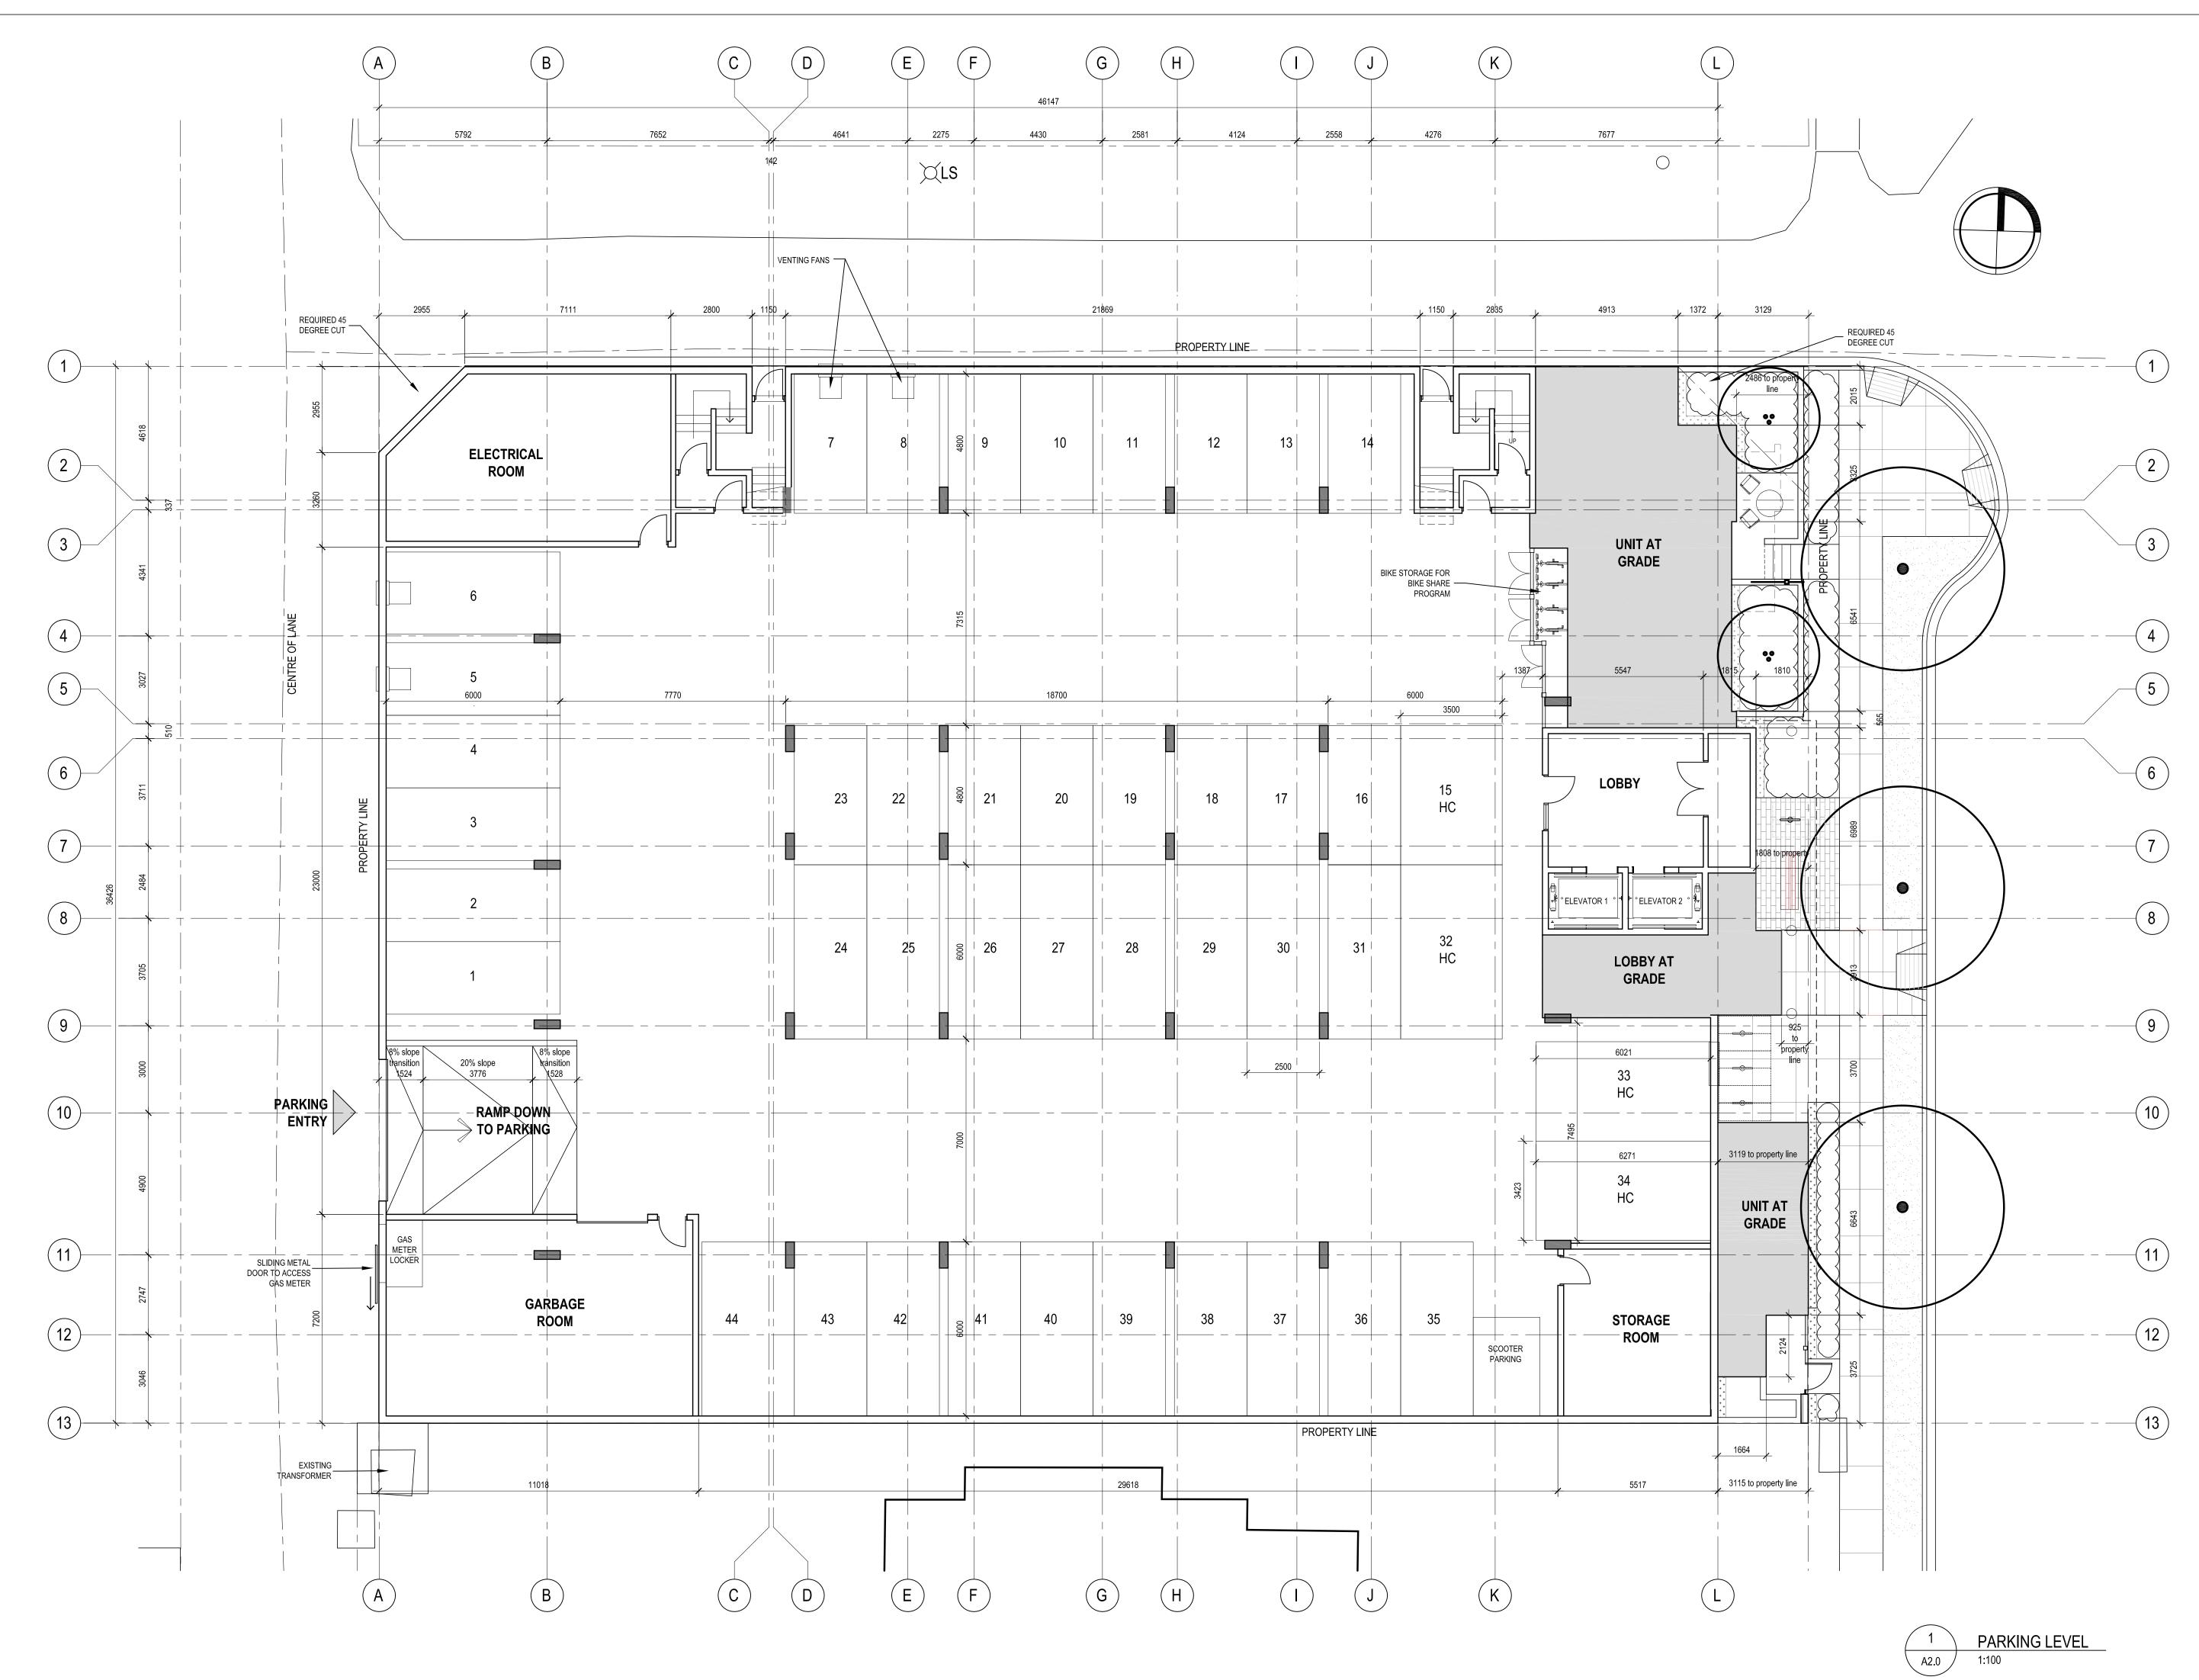
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DP18-0115 & DVP18-0116

REVITALIZATION DEVELOPMENT PERMIT AREA	YES	NO	N/A
Are pedestrian entrances more prominent features than garage doors and vehicle entrances?	\checkmark		
Is surface parking located to the rear of the building or interior of the block?			\checkmark
Are truck loading zones and waste storage areas screened from public view?	\checkmark		
Do parking lots have one shade tree per four parking stalls?			\checkmark
Are pedestrian connections provided within and between parking lots?			\checkmark
Are driving, parking, pedestrian and cycling areas distinguished through changes in colour or pattern of paving materials?			\checkmark
Signage			-
Is signage design consistent with the appearance and scale of the building?			\checkmark
Are corporate logos on signs complimentary to the overall building character?			\checkmark
Is signage lighting minimized?			\checkmark
Public Art		1	1
Is public art incorporated into the project?		\checkmark	





SUE	NO.	DATE
C Housing review	1	April 6, 2018
^o Submission	2	May 5, 2018
P Revisions	3	August 16, 2018
^o Revisions	4	September 17, 2018
^o Revisions	5	October 15, 2018

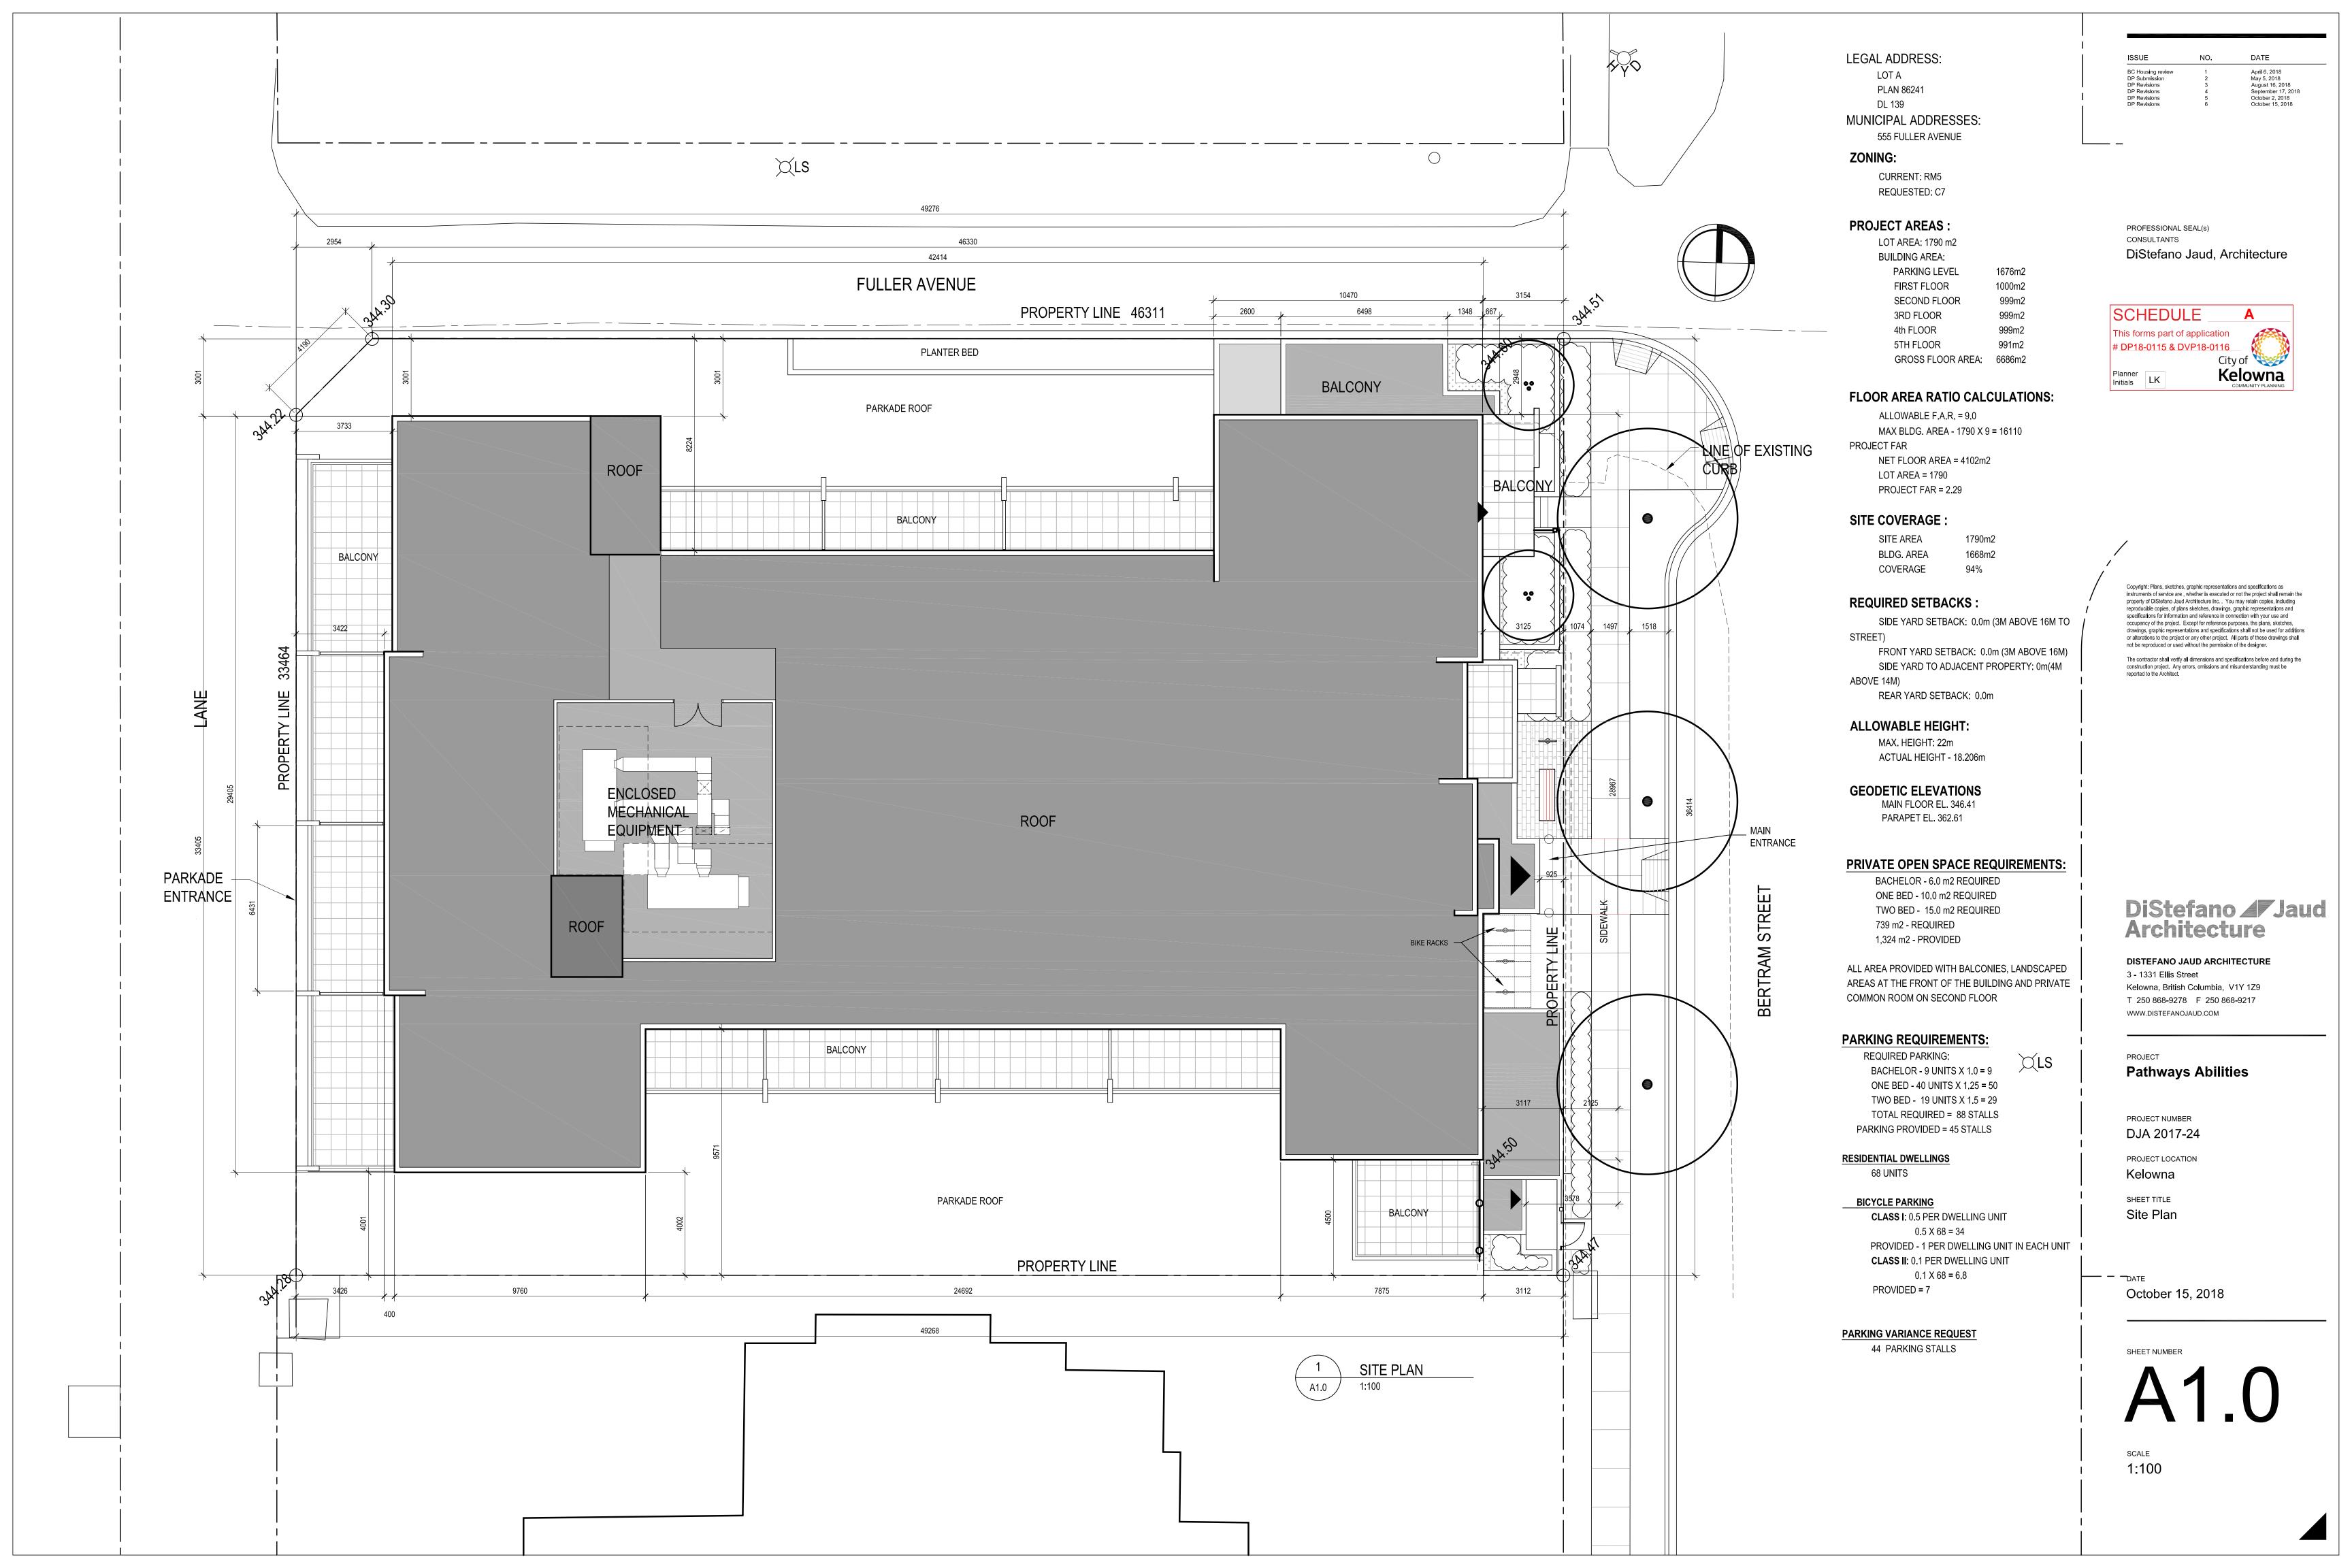PROFESSIONAL SEAL(S) CONSULTANTS DiStefano Jaud, Architecture

SCHEDULE	Α _
This forms part of ap	plication
# <u>DP18-0115 & DVP</u>	18-0116 🕺 🕅
	City of 😻
Planner Initials LK	Kelowna

Robert Turik (retired) CONSULTING ARCHITECT

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The contractor shall verify all dimensions and specifications before and during the construction project. Any errors, omissions and misunderstanding must be reported to the Architect.

DiStefano **AF** Jaud Architecture

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T 250 868-9278 F 250 868-9217 WWW.DISTEFANOJAUD.COM

PROJECT

Pathways Abilities Society

PROJECT NUMBER
DJA 2017-24


PROJECT LOCATION Fuller Ave. Kelowna

SHEET TITLE Parking Plan

DATE October 15, 2018

SHEET NUMBER



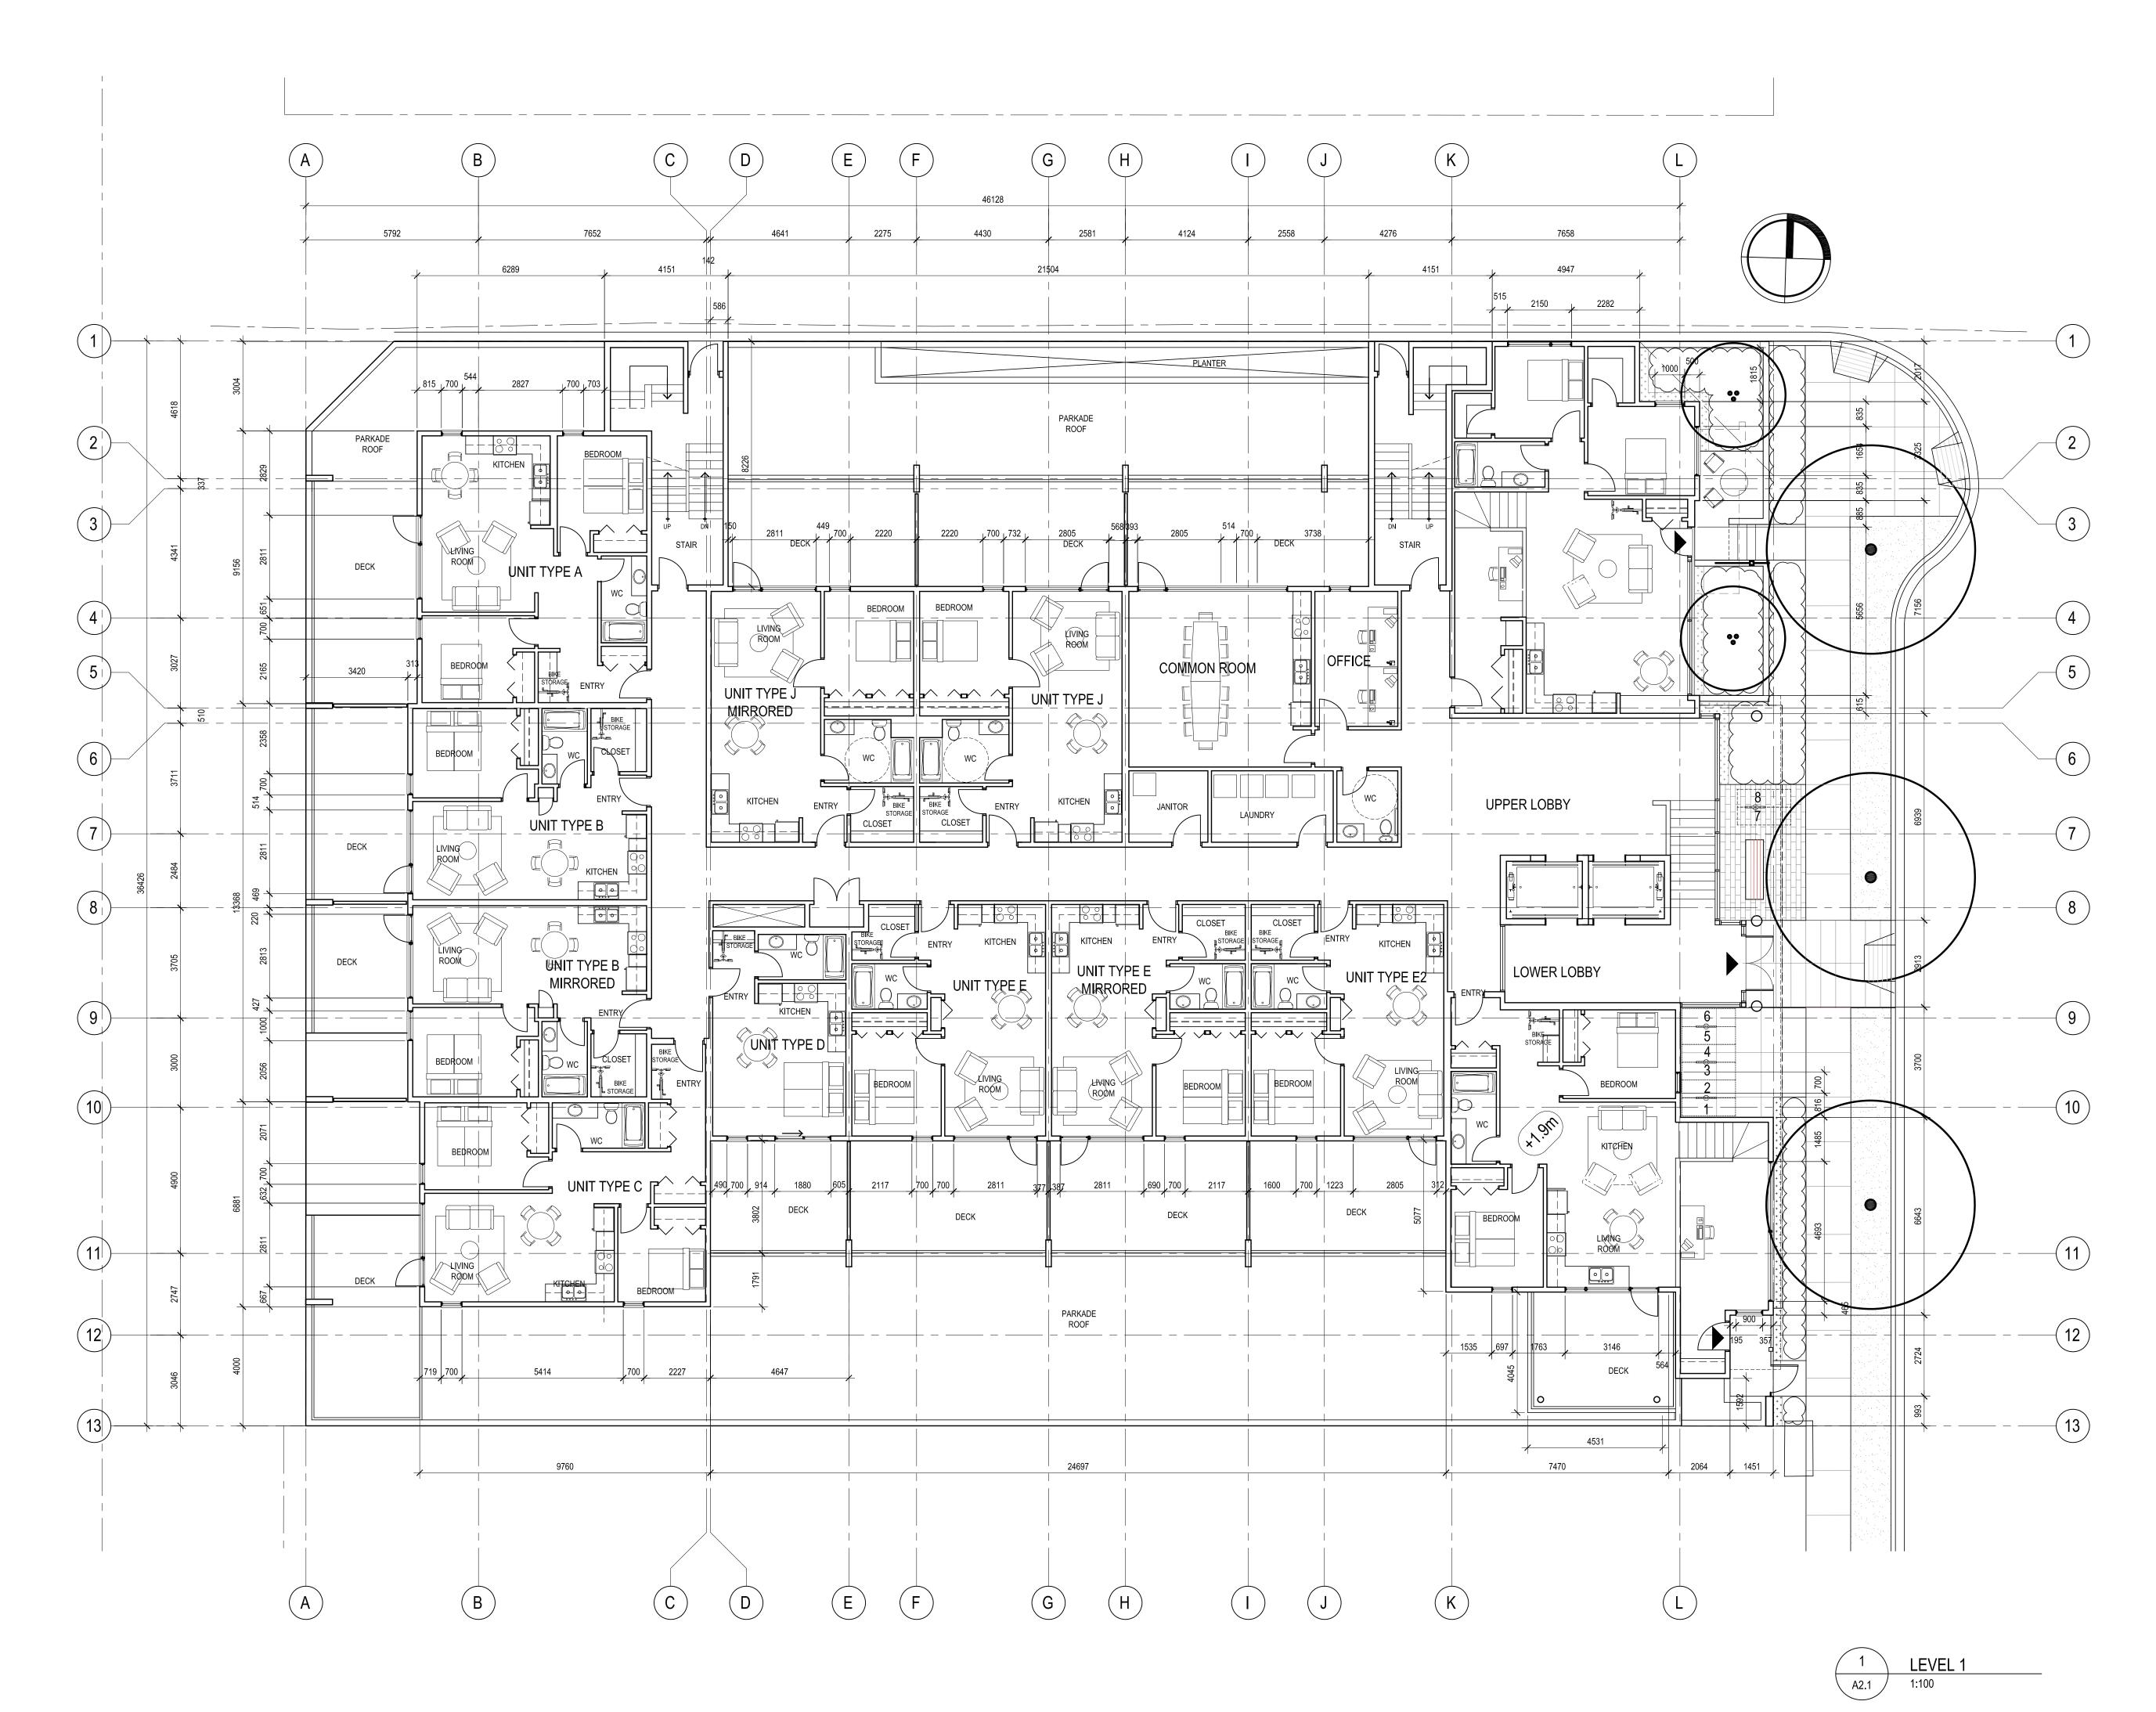

DP Submission 2 May 5, 2018 DP Revisions 3 August 16, 2018 DP Revisions 4 September 17, 2018 DP Revisions 5 October 15, 2018

DATE April 6, 2018

NO.

ISSUE

BC Housing review

PROFESSIONAL SEAL(S) CONSULTANTS DiStefano Jaud, Architecture

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This forms pa	art of application	
# DP18-0115	6 & DVP18-0116	- 🕅 🐼
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Planner Initials LK		

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PROJECT

Pathways Abilities Society

PROJECT NUMBER DJA 2017-24


PROJECT LOCATION Fuller ave. Kelowna


SHEET TITLE First Floor Plan

DATE October 15, 2018

SHEET NUMBER



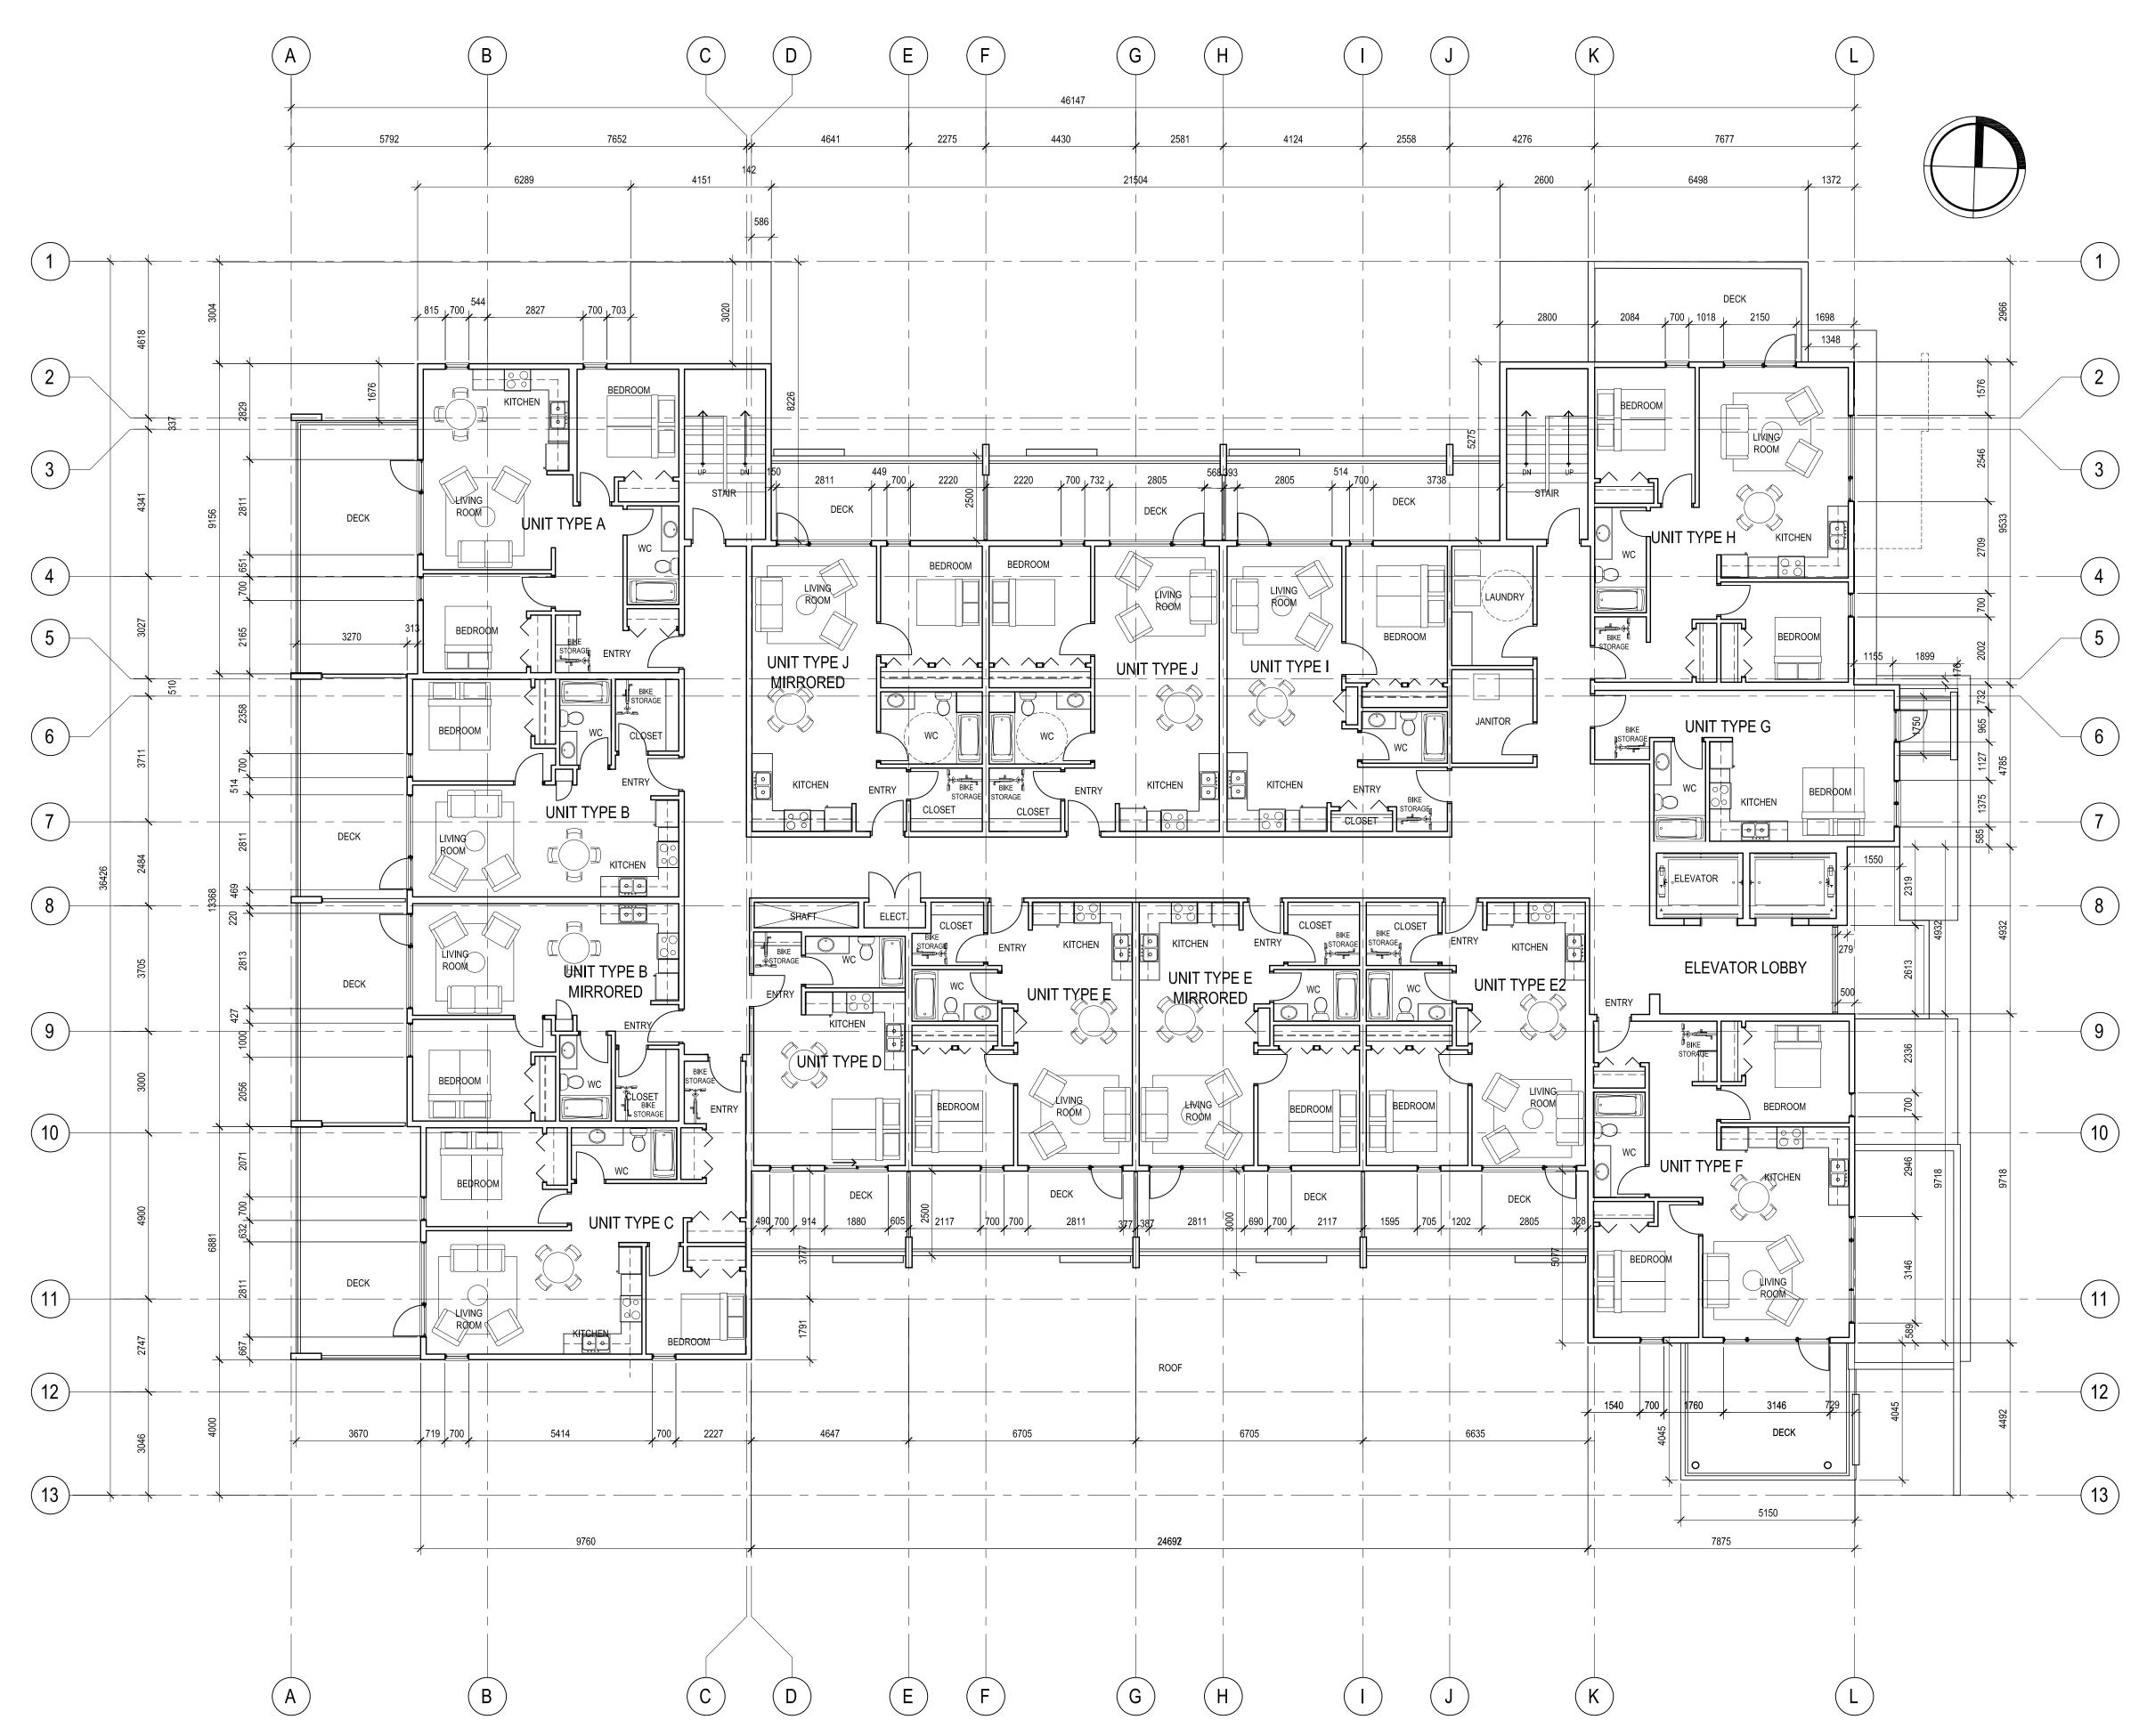

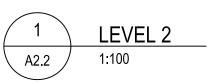

BC Housing review DP Submission DP Revisions DP Revisions DP Revisions	1 2 3 4 5	April 6, 2018 May 5, 2018 August 16, 2018 September 17, 2018 October 15, 2018
PROFESSIONAL SE/ CONSULTANTS DiStefano Ja	. ,	itecture
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Robert Turik (CONSULTINC Copyright: Plans, sketches, grap instruments of service are, whe property of DiStefano Jaud Arch reproducible copies, of plans sk specifications for information an occupancy of the project. Exce drawings, graphic representatio or alterations to the project or a not be reproduced or used with The contractor shall verify all dii construction project. Any errors reported to the Architect.	B ARCHITE phic representations and ther is executed or not to itecture inc. You may etches, drawings, graph d reference in connectic pt for reference purpose ns and specifications sh ny other project. All par but the permission of the mensions and specificat	d specifications as the project shall remain the retain copies, including ic representations and on with your use and is, the plans, sketches, all not be used for additions ts of these drawings shall a designer. ions before and during the
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DISTEFANO JAU 3 - 1331 Ellis Stree Kelowna, British C T 250 868-9278	et olumbia, V1Y	1Z9

NO. DATE

ISSUE

PROJECT

Pathways Abilities Society

PROJECT NUMBER
DJA 2017-24

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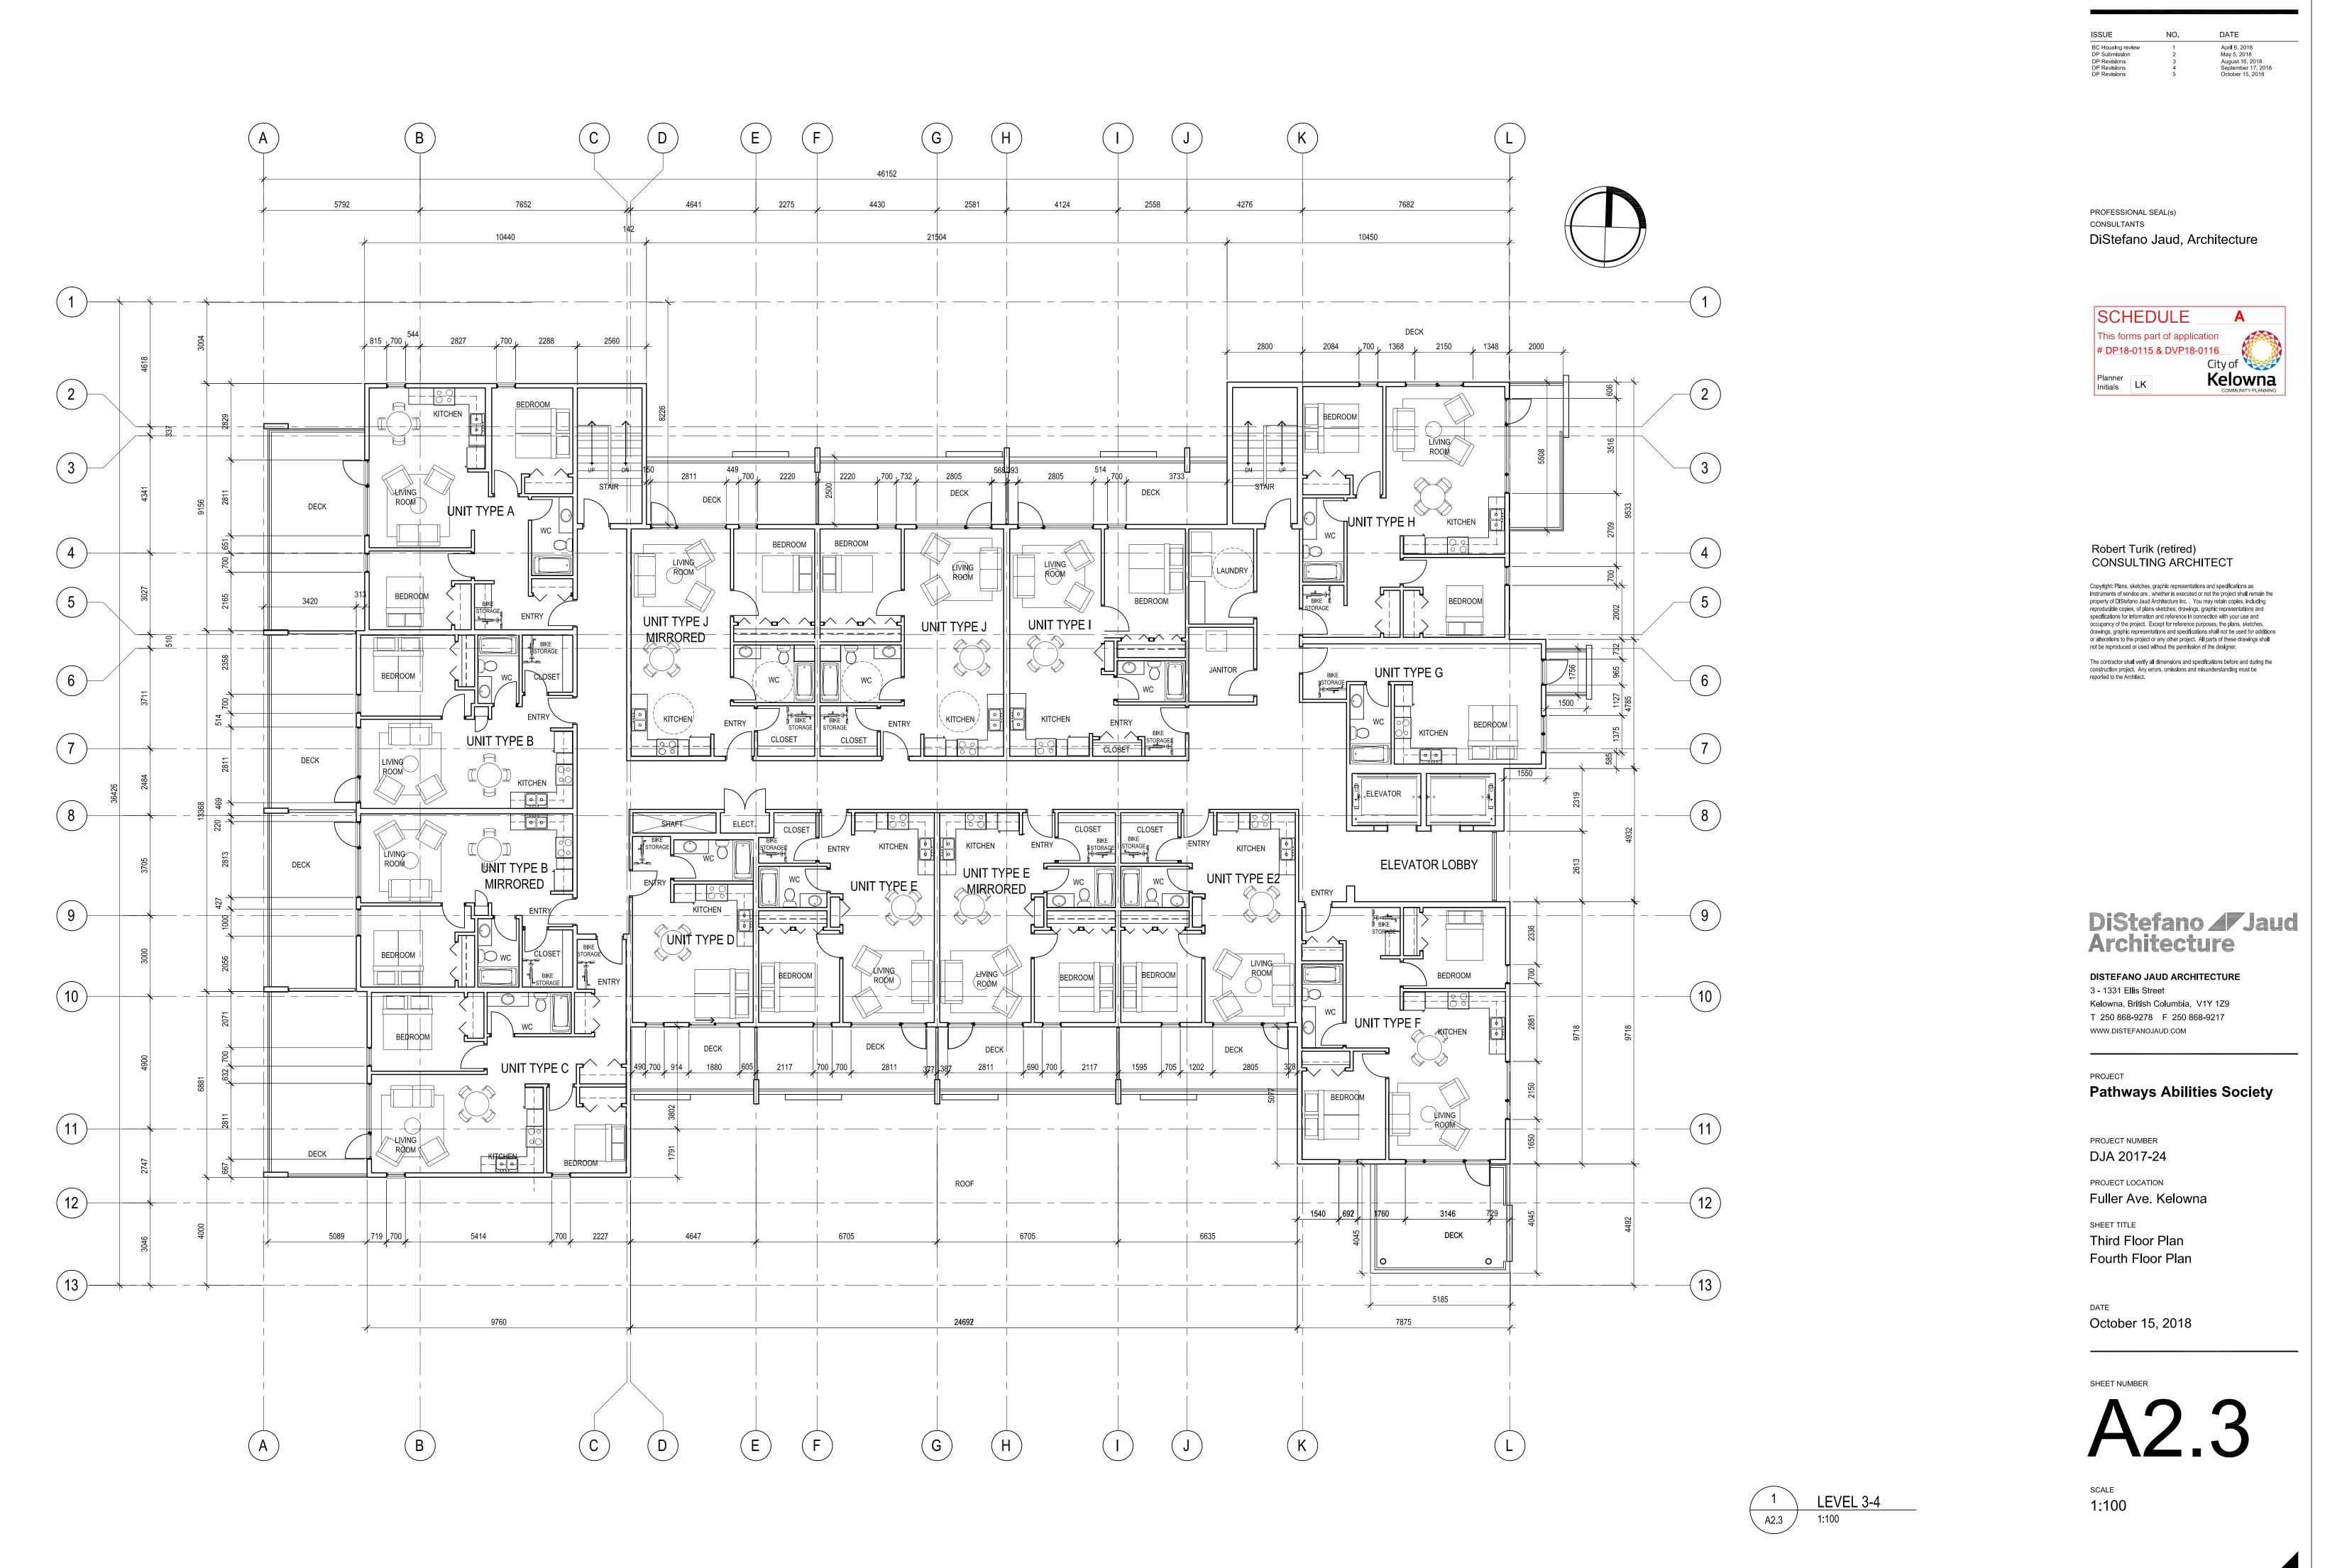
PROJECT LOCATION Fuller Ave. Kelowna


SHEET TITLE Second Floor Plan


DATE October 15, 2018

SHEET NUMBER





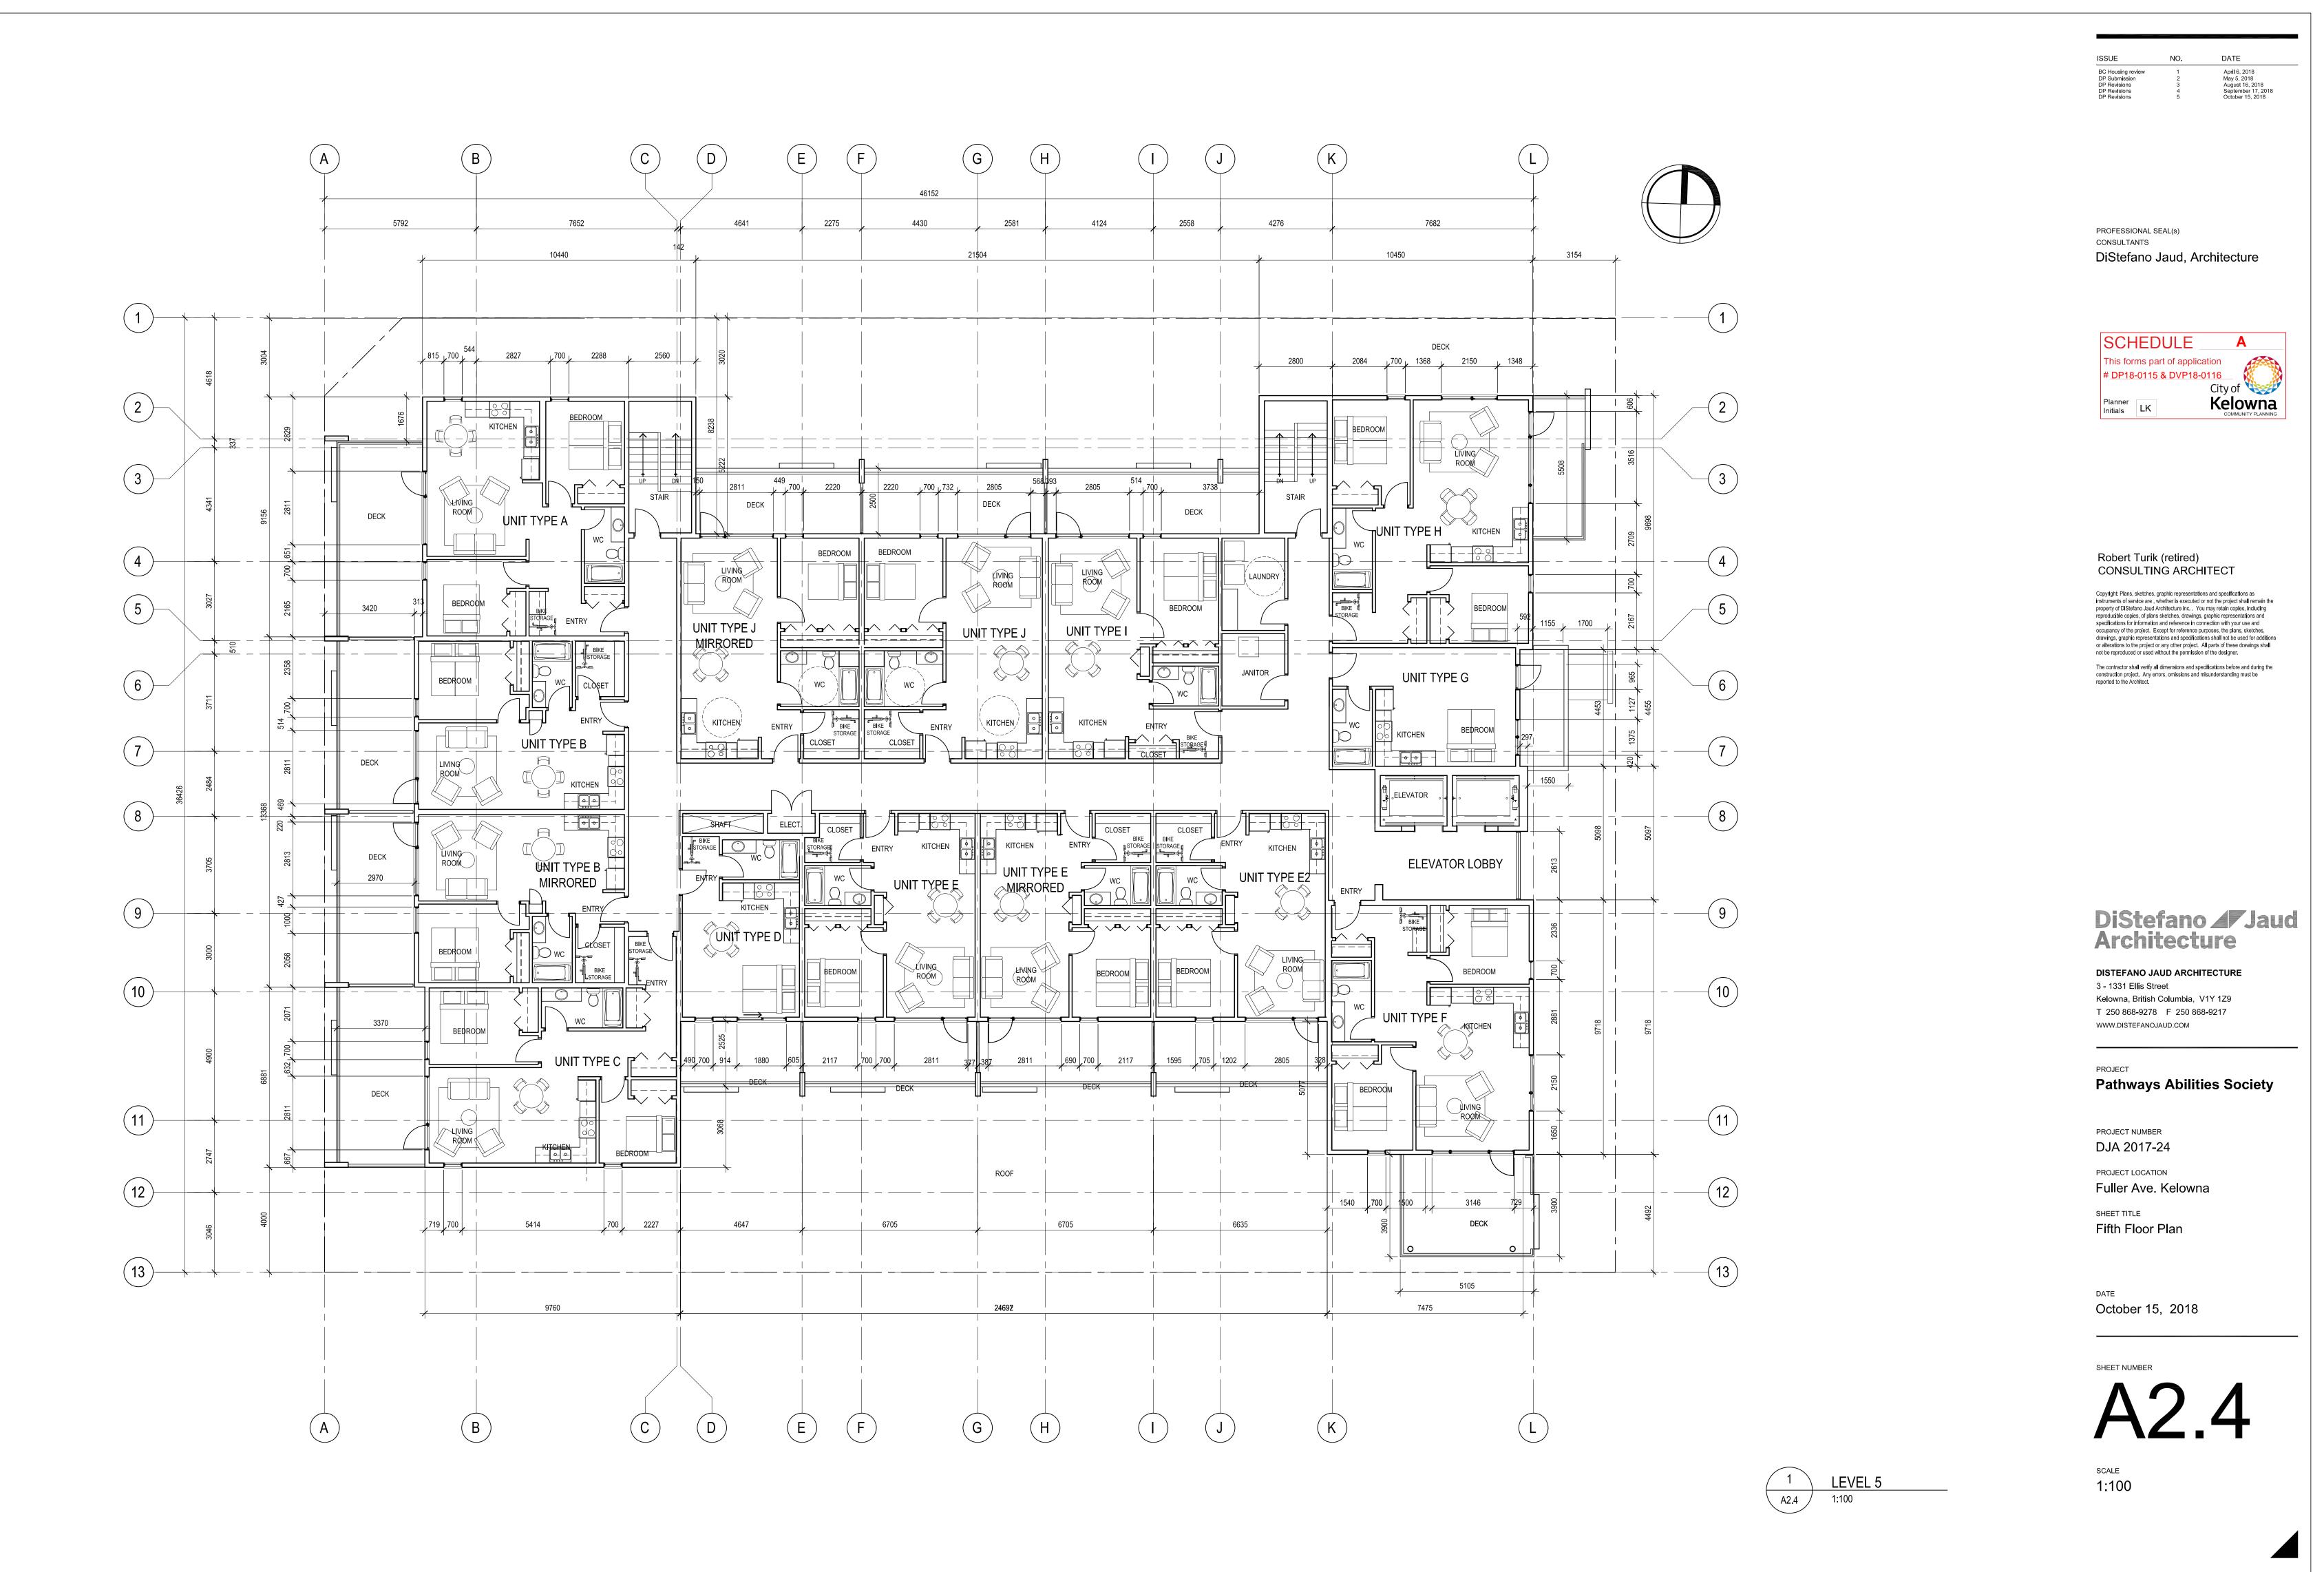

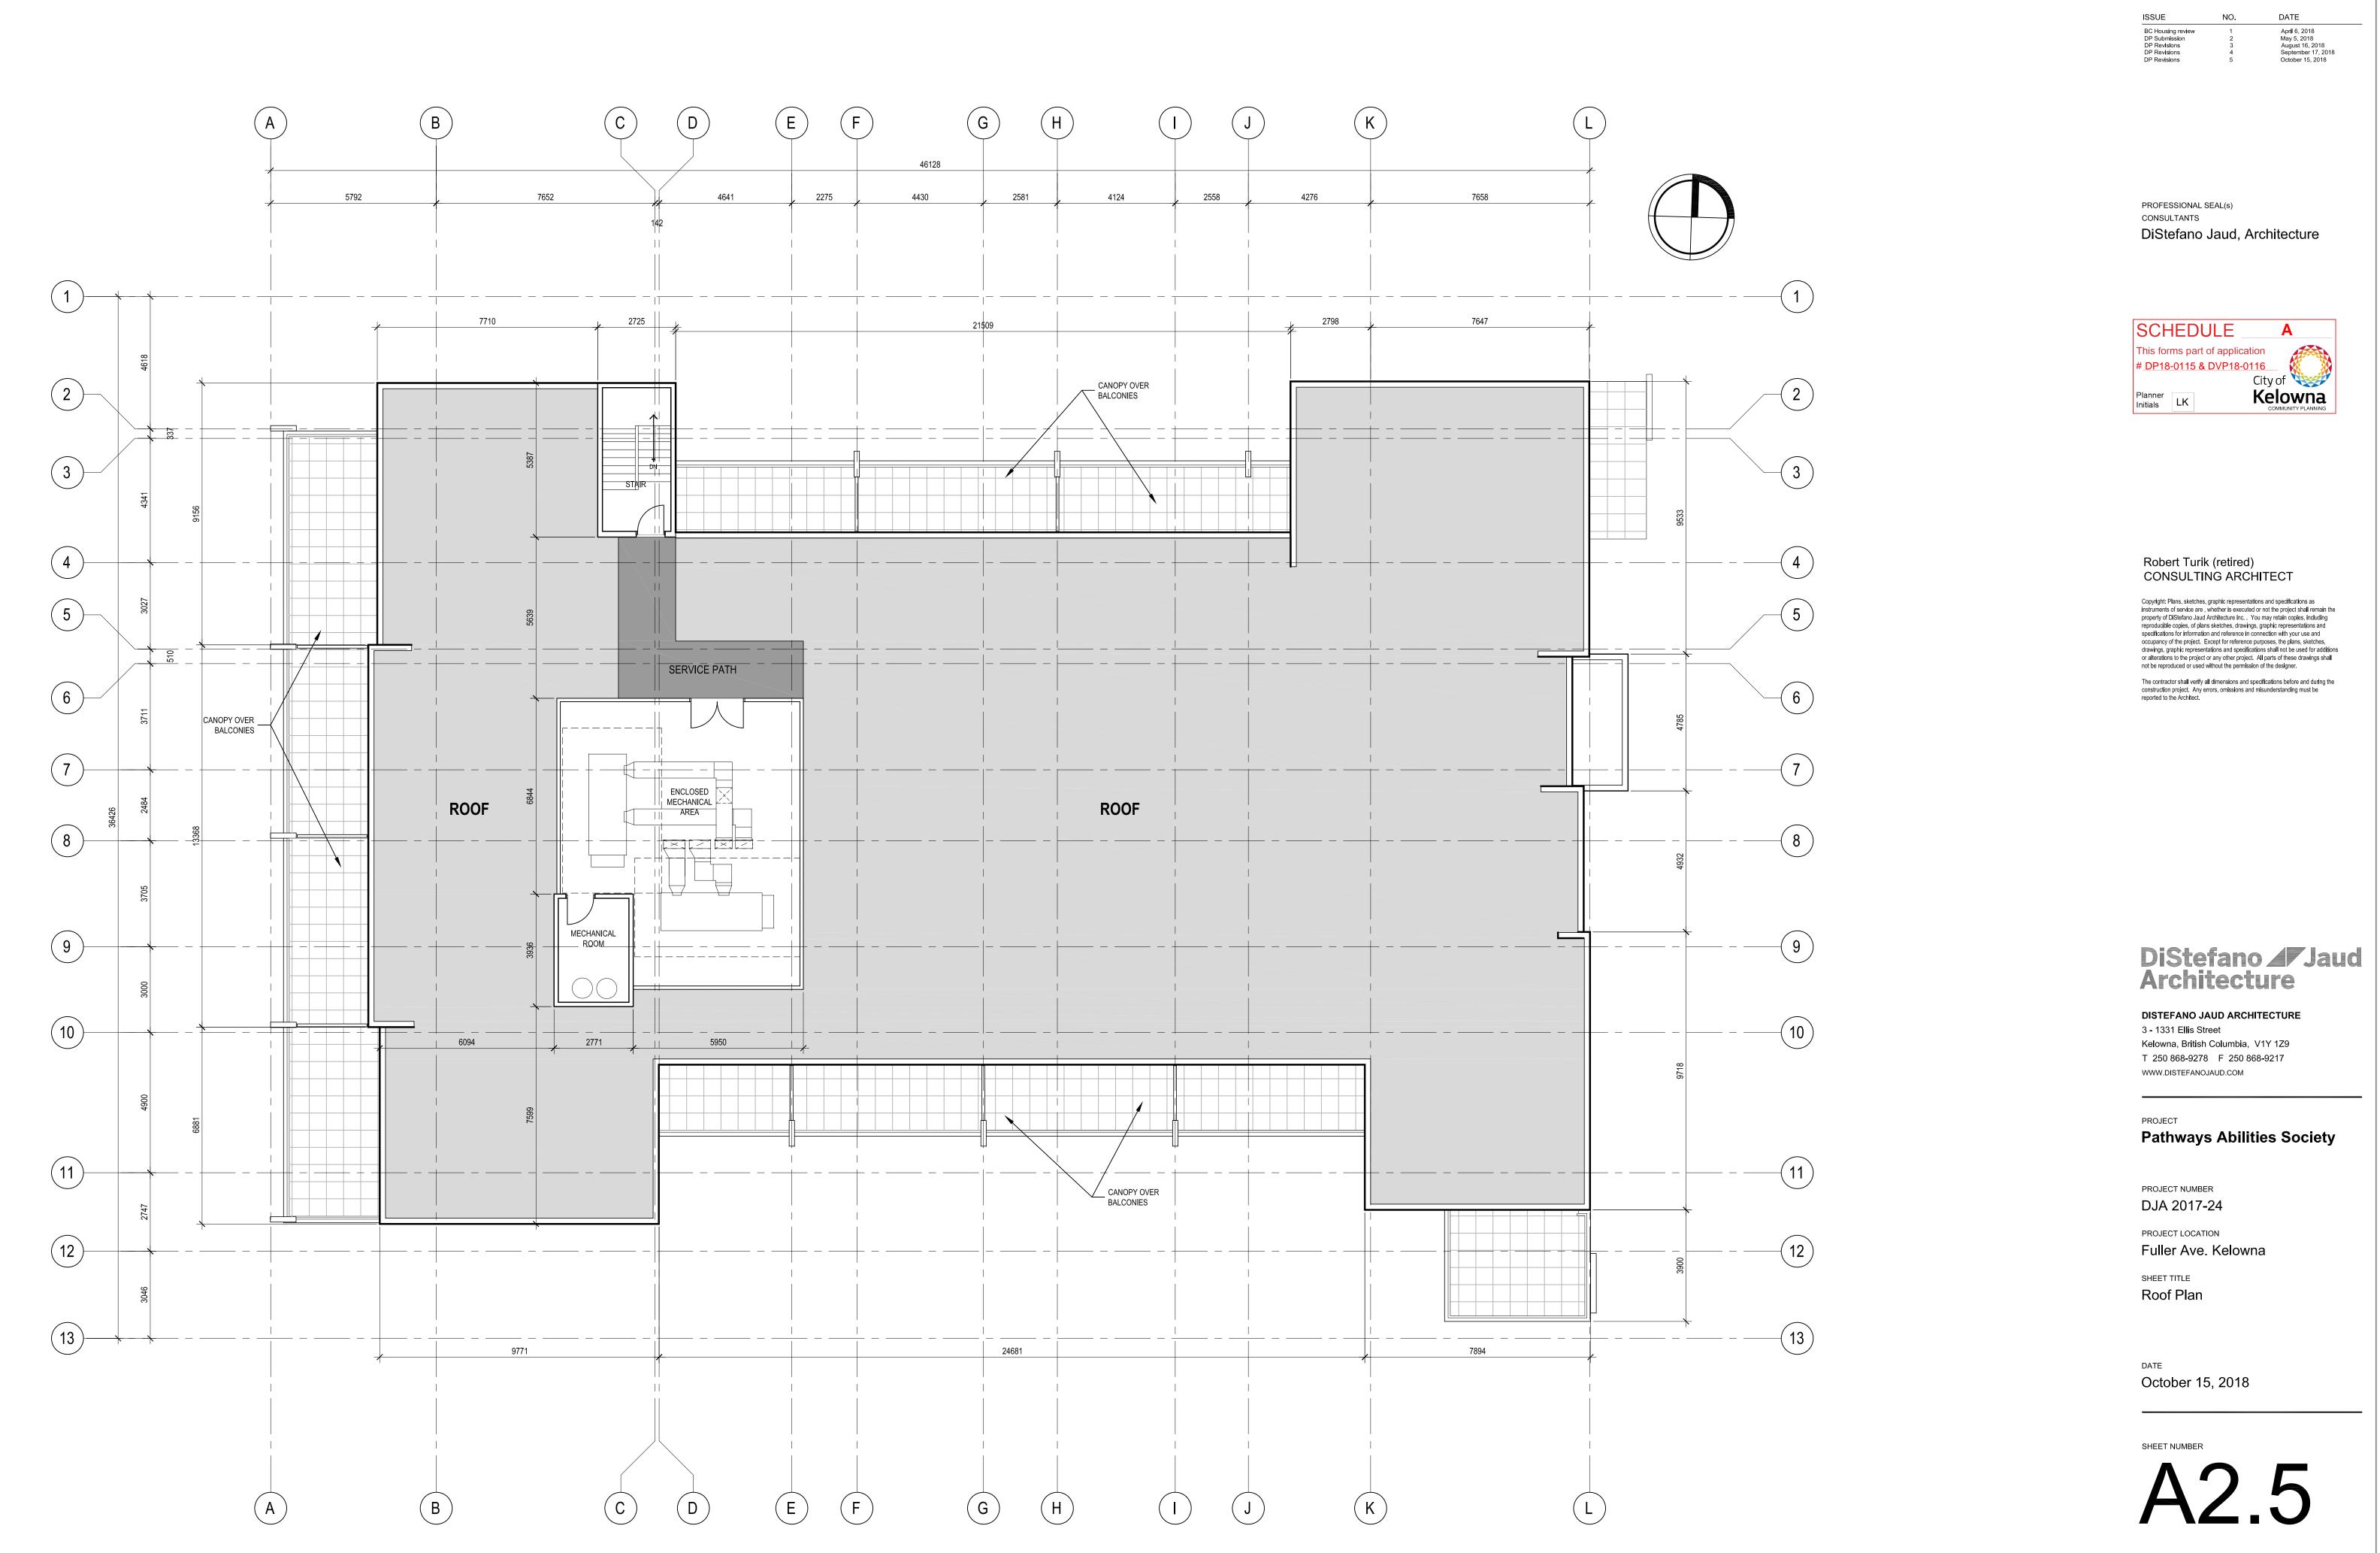

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A2.4	1:100

scale **1:50**

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NORTH ELEVATION - FULLER STREET 1:100

ISSUE BC Housing review DP Submission DP Revisions DP Revisions DP Revisions DP Revisions DATE April 6, 2018 May 5, 2018 August 16, 2018 September 17, 2018 October 2, 2018 October 15, 2018

EXTERIOR CLADDING LEGEND

TYPE	DESCRIPTION
	METAL SIDING
	METAL FLASHING EXPANSION JOINT
	METAL CLAD BALCONY EDGE
	PAINTED METAL RAILING WITH GLASS PANEL
	ALUMINUM FRAMED SPANDREL PANEL WITH COLOURED GLASS
	VINYL WINDOWS / DOORS
	ALUMINUM WINDOWS
	METAL FLASHING
	METAL CLAD CANOPY WITH STAINED WOOD SOFFIT
	STEEL COLUMN
	STUCCO
	RAISED CONCRETE PLANTER
	DECORATIVE METAL FENCE AND GATE
	COLOURED CONCRETE WALL - TEXTURED
	THROUGH WALL AC UNITS
	WINDOWS

PROFESSIONAL SEAL(s) CONSULTANTS DiStefano Jaud, Architecture

NO.



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DISTEFANO JAUD ARCHITECTURE

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PROJECT

Pathways Abilities Society Apartment Complex

PROJECT NUMBER DJA 2017-24

PROJECT LOCATION 555 Fuller Avenue, Kelowna, BC

SHEET TITLE **Building Elevations**


DATE October 15, 2018

SHEET NUMBER



SCALE 1:100



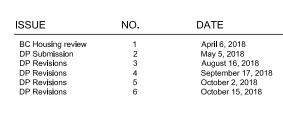

TYPE	DESCRIPTION
	METAL SIDING
	METAL FLASHING EXPANSION JOINT
	METAL CLAD BALCONY EDGE
	PAINTED METAL RAILING WITH GLASS PANEL
	ALUMINUM FRAMED SPANDREL PANEL WITH COLOURED GLASS
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	WINDOWS

PROFESSIONAL SEAL(s) CONSULTANTS DiStefano Jaud, Architecture



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PROJECT

Pathways Abilities Society Apartment Complex

PROJECT NUMBER DJA 2017-24


PROJECT LOCATION 555 Fuller Avenue, Kelowna, BC

SHEET TITLE **Building Elevations**

DATE October 15, 2018

SHEET NUMBER

A3.2

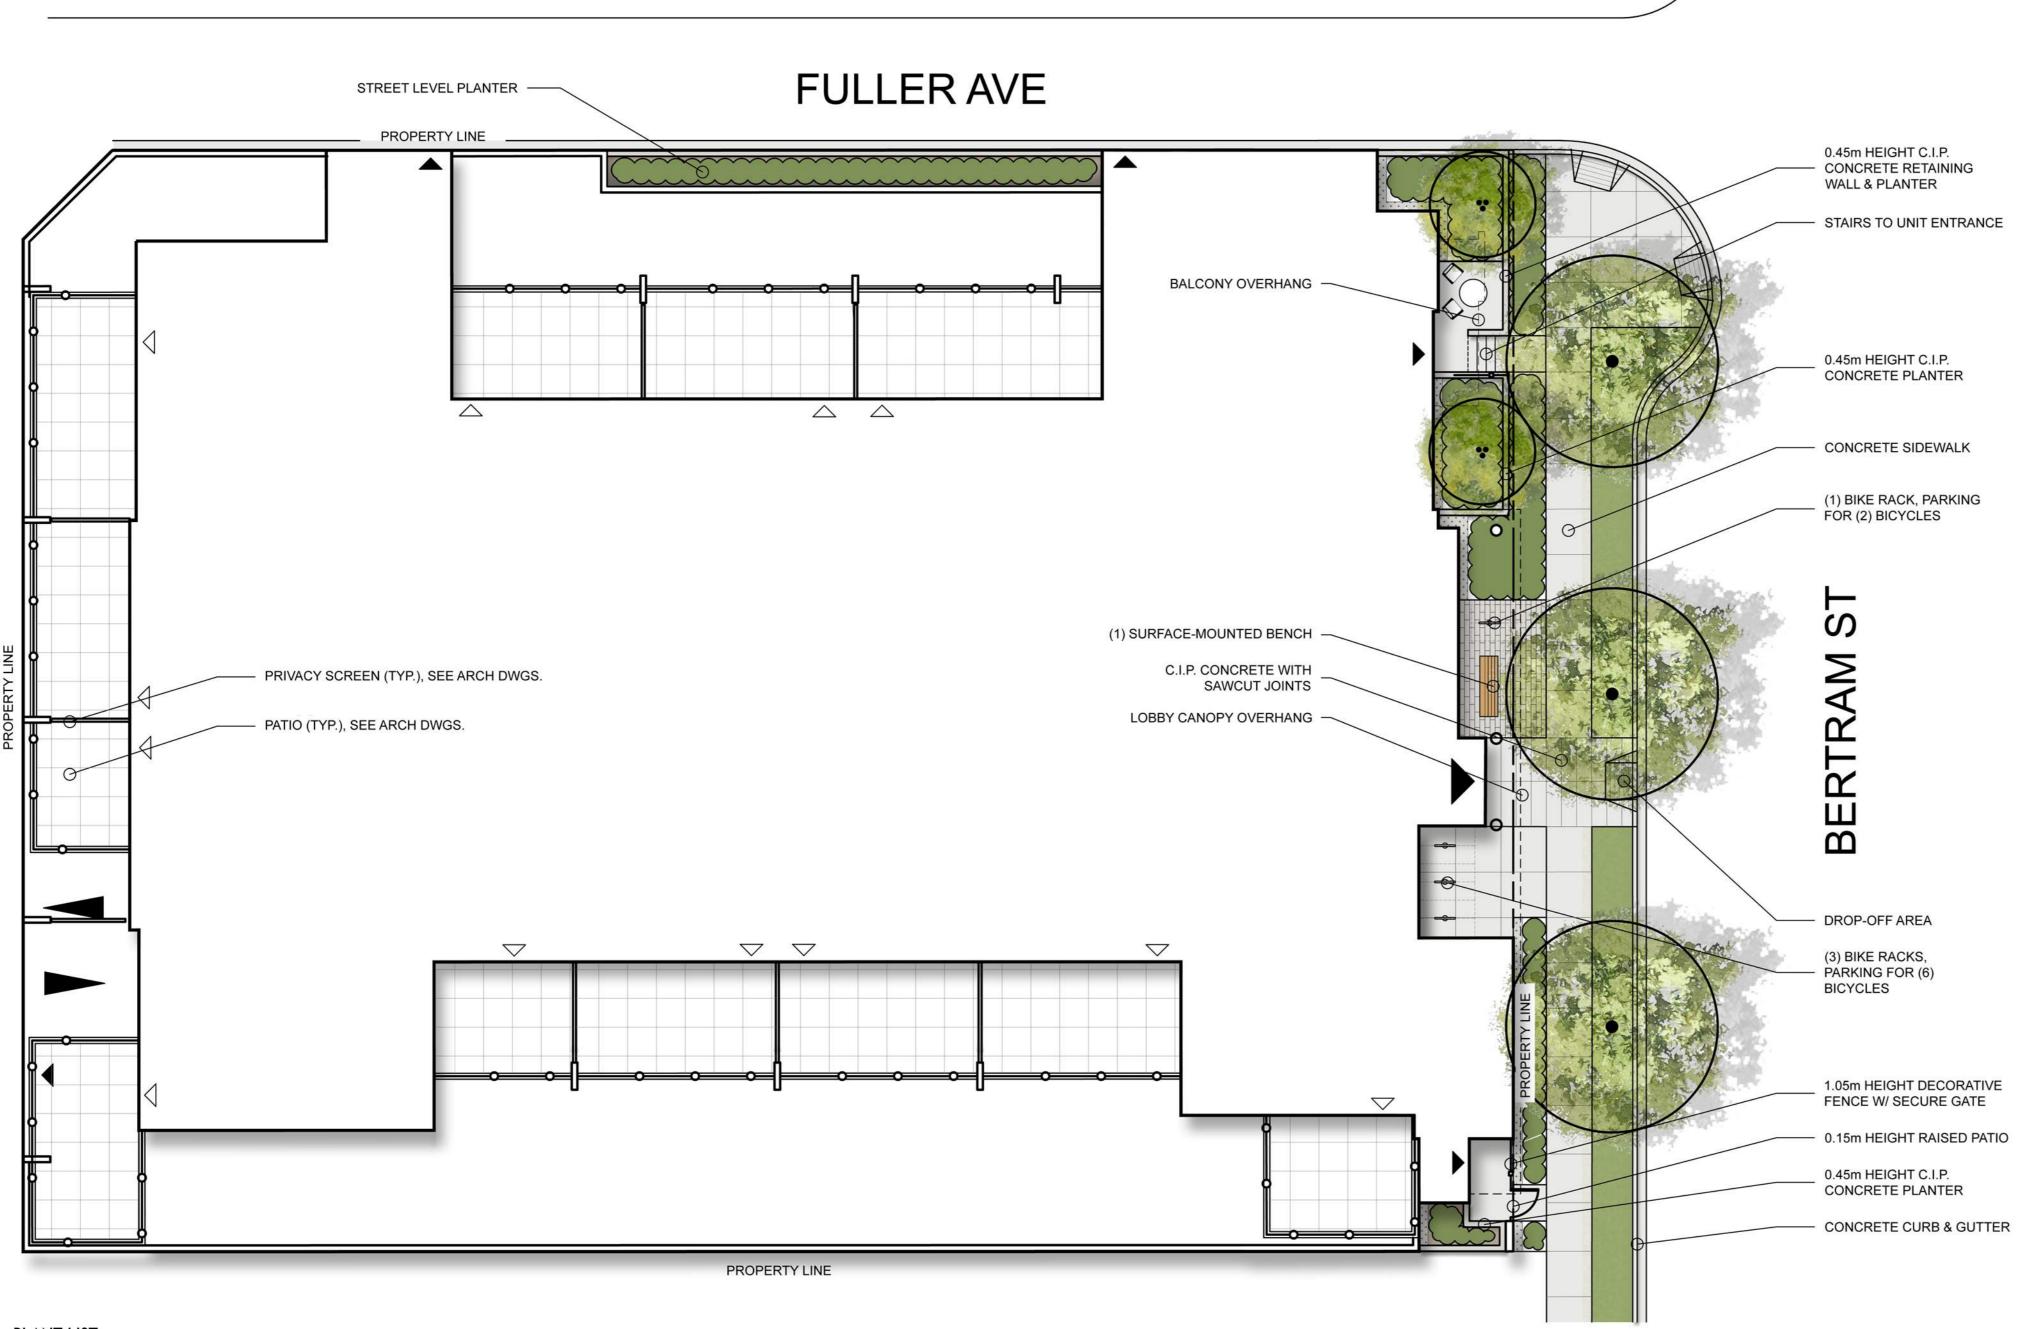


PLANT LIST:

Botanical Name	Common Name	Size/Spacing	Root
Carpinus caroliniana	American hornbeam	6cm Cal.	B&B
Hamamelis x intermedia 'Jelena'	Jelena witchhazel	1.5m Ht.	B&B
SHRUBS & VINES			
Botanical Name	Common Name	Size/Spacing	Root
Cornus sericea 'Kelseyi'	Kelsey dwarf dogwood	#02 Cont./0.75m O.C.	Potted
Hydrangea anomala ssp. petiolaris	Climbing hydrangea	#01 Cont./1m O.C.	Potted
Hydrangea paniculata 'ILVOBO'	Bobo hydrangea	#02 Cont./1.25m 0.C.	Potted
Paxistima canbyi	Cliffgreen	#02 Cont./1m O.C.	Potted
Spiraea betulifolia 'Tor Gold'	Glow Girl spirea	#02 Cont./1m O.C.	Potted
PERENNIALS			
Botanical Name	Common Name	Size/Spacing	Root
Echinacea purpurea 'White Swan'	Coneflower	#01 Cont./0.6m O.C.	Potted
Geranium sanguineum 'Album'	Bloody cranesbill	#01 Cont./0.6m O.C.	Potted
Hemerocallis 'Stella d'Oro'	Stella d'Oro daylily	#01 Cont./0.5m O.C.	Potted
GRASSES			
Botanical Name	Common Name	Size/Spacing	Root
Calamagrostis acutiflora 'Karl Foerster'	Karl Foerster feather reed grass	#01 Cont./0.75m O.C.	Potted
Panicum virgatum 'Heavy Metal'	Heavy Metal switch grass	#01 Cont./0.6m O.C.	Potted



SCALE: 1:125

NOT FOR CONSTRUCTION

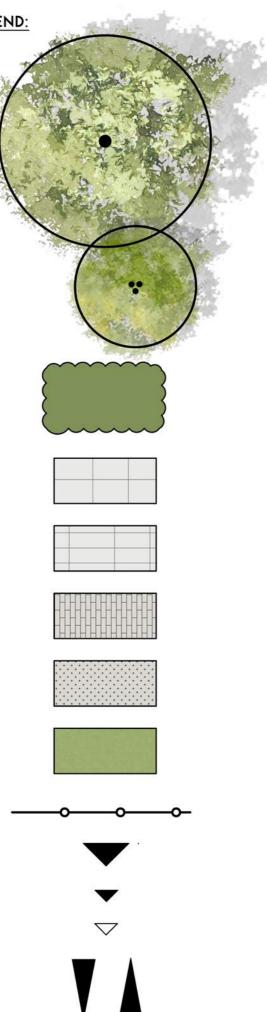

DECIDUOUS STREET TREE

ORNAMENTAL TREE

SHRUBS, PERENNIALS & GRASSES

CONCRETE SIDEWALK

C.I.P. CONCRETE PAVING WITH SAWCUT JOINTS

CONCRETE UNIT PAVERS

DECORATIVE STONE MULCH

FESCUE & MICRO CLOVER LAWN BOULEVARD

1.05m HEIGHT GUARDRAIL

MAIN BUILDING ENTRY

SECONDARY BUILDING/PRIVATE UNIT ENTRY PATIO ACCESS

PARKADE ENTRY

SCHEDULE С This forms part of application # DP18-0115 & DVP18-0116 City of Kelowna Planner Initials LK

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_	SEP		
5	14/18	REISSUED FOR DP	
4	AUG 16/18	REISSUED FOR DP	
3	APR 20/18	ISSUED FOR DP	
2	FEB 26/18	REISSUED FOR REVIEW	
1	FEB 01/18	ISSUED FOR REVIEW	
0	DATE	DESCRIPTION	



CLIENT:

M'AKOLA DEVELOPMENT SERVICES VICTORIA, B.C.

PROJECT:

PATHWAYS ABILITIES SOCIETY KELOWNA, B.C.

SHEET TITLE CONCEPTUAL LANDSCAPE PLAN

DESIGN BY	EB
DRAWN BY	EB
CHECKED BY	XS
PROJECT NO.	17-037
SCALE	1:125

L-1

SHEET NO.

DEVELOPMENT PERMIT NOTES:

A PLANT MATERIALS AND CONSTRUCTION METHODS SHALL CONFORM TO MINIMUM STANDARDS ESTABLISHED IN THE LATEST EDITION OF THE B.C. LANDSCAPE STANDARDS, PUBLISHED BY B.C.L.N.A. AND B.C.S.L.A. AS WELL AS THE CITY OF KELOWNA LANDSCAPE STANDARDS IN BYLAW 7900.

B THE LANDSCAPE DESIGN DESIGNATED HEREIN IS CONCEPTUAL BUT REFLECTS THE MINIMUM CITY OF KELOWNA FORM AND CHARACTER REQUIREMENTS C PLANT MATERIAL SELECTIONS ARE CONCEPTUAL ONLY. FINAL PLANTING SELECTIONS MAY VARY DEPENDING UPON AVAILABILITY AT THE TIME OF CONSTRUCTION.

D TREES SHALL BE INSTALLED IN DEFINED SOIL PITS OR PLANTING BED AREAS. ADEQUATE SOIL VOLUME SHALL BE PROVIDED BASED ON THE SPECIFIED TREE SPECIES AND LOCATION.

E ORNAMENTAL SHRUB, GRASS AND PERENNIALS ARE TO BE PLACED WITHIN DEFINED PLANTING BEDS. ALL PLANTING BEDS SHALL HAVE A MIN. OF 450mm (18") IMPORTED GROWING MEDIUM AND 75mm (3") OF COMPOSTED MULCH OR APPROVED EQUAL.

F DECORATIVE ROCK AREAS SHALL HAVE A MIN. OF 100mm (4") OF DECORATIVE ROUND ROCK. COMMERCIAL GRADE LANDSCAPE FABRIC SHALL BE INSTALLED BELOW ALL DECORATIVE ROCK AREAS.

G TURF AREAS SHALL BE LOW WATER USE 'NO. 1 PREMIUM FESCUE/MICROCLOVER BLEND' SOD WITH A MIN, OF 150mm (6") IMPORTED GROWING MEDIUM H A HIGH EFFICIENCY IRRIGATION SYSTEM SHALL BE INSTALLED FOR ALL ORNAMENTAL LANDSCAPE AREAS AND SHALL CONFORM TO THE CITY OF KELOWNA'S IRRIGATION STANDARDS IN BYLAW 7900.

