Development Permit & Development Variance Permit DP17-0247 & DVP17-0248



This permit relates to land in the City of Kelowna municipally known as 599 Clement Ave and legally known as Lot A, District Lot 139, ODYD, Plan EPP82176

and permits the land to be used for the following development:

Apartment Building

USE as per Zoning Bylaw

The present owner and any subsequent owner of the above described land must comply with any attached terms and conditions.

Date of Decision:

Decision By: CITY COUNCIL OR UP

Issued Date:

Development Permit Area: Comprehensive

This permit will not be valid if development has not commenced by December 5, 2019.

Existing Zone: RM6 Future Land Use Designation: MRH

This is NOT a Building Permit.

In addition to your Development Permit, a Building Permit may be required prior to any work commencing. For further information, contact the City of Kelowna, Development Services Branch.

NOTICE

This permit does not relieve the owner or the owner's authorized agent from full compliance with the requirements of any federal, provincial or other municipal legislation, or the terms and conditions of any easement, covenant, building scheme or agreement affecting the building or land.

Owner: Okanagan Opportunity GP INC., Inc.NO. BC1129792

Applicant: Anagram Properties Inc.

Ryan Smith Community Planning Department Manager Community Planning & Strategic Investments Date

1. SCOPE OF APPROVAL

This Development Permit applies to and only to those lands within the Municipality as described above, and any and all buildings, structures and other development thereon.

This Development Permit is issued subject to compliance with all of the Bylaws of the Municipality applicable thereto, except as specifically varied or supplemented by this permit, noted in the Terms and Conditions below.

The issuance of a permit limits the permit holder to be in strict compliance with regulations of the Zoning Bylaw and all other Bylaws unless specific variances have been authorized by the Development Permit. No implied variances from bylaw provisions shall be granted by virtue of drawing notations that are inconsistent with bylaw provisions and that may not have been identified as required Variances by the applicant or Municipal staff.

2. CONDITIONS OF APPROVAL

- a) The dimensions and siting of the building to be constructed on the land be in accordance with Schedule "A";
- b) The exterior design and finish of the building to be constructed on the land be in accordance with Schedule "B";
- c) Landscaping to be provided on the land be in accordance with Schedule "C"; and
- d) The applicant be required to post with the City a Landscape Performance Security deposit in the form of a "Letter of Credit" in the amount of 125% of the estimated value of the landscaping, as determined by a Registered Landscape Architect.

This Development Permit is valid for two (2) years from the date of December 5, 2017 approval, with no opportunity to extend.

3. PERFORMANCE SECURITY

As a condition of the issuance of this Permit, Council is holding the security set out below to ensure that development is carried out in accordance with the terms and conditions of this Permit. Should any interest be earned upon the security, it shall accrue to the Developer and be paid to the Developer or his or her designate if the security is returned. The condition of the posting of the security is that should the Developer fail to carry out the development hereby authorized, according to the terms and conditions of this Permit within the time provided, the Municipality may use enter into an agreement with the property owner of the day to have the work carried out, and any surplus shall be paid over to the property own of the day. Should the Developer carry out the development permitted by this Permit within the time set out above, the security shall be returned to the Developer or his or her designate. There is filed accordingly:

a) An Irrevocable Letter of Credit in the amount of **\$tbd**

Before any bond or security required under this Permit is reduced or released, the Developer will provide the City with a statutory declaration certifying that all labour, material, workers' compensation and other taxes and costs have been paid.

4. INDEMNIFICATION

Upon commencement of the works authorized by this Permit the Developer covenants and agrees to save harmless and effectually indemnify the Municipality against:

a) All actions and proceedings, costs, damages, expenses, claims, and demands whatsoever and by whomsoever brought, by reason of the Municipality said Permit.

All costs, expenses, claims that may be incurred by the Municipality where the construction, engineering or other types of works as called for by the Permit results in damages to any property owned in whole or in part by the Municipality or which the Municipality by duty or custom is obliged, directly or indirectly in any way or to any degree, to construct, repair, or maintain.

The PERMIT HOLDER is the <u>CURRENT LAND OWNER</u>. Security shall <u>ONLY</u> be returned to the signatory of the Landscape Agreement or their designates.

CLEMENT AVENUE RENTALS ANAGRAM PROPERTIES





KELOWNA, BC








CLEMENT AVENUE PROPERTY - ANAGRAM

This project is planned for 573 - 603 Clement Avenue in Kelowna. The proposed project is a 58 unit apartment building consisting of a ground floor of parking and building entrance and five floors of residential units. The following is a summary of the proposed zoning for this site:


	EXISITNG ZONING:	RU2 - MEDIUM LOT HOUSING	
	PROPOSED ZONING:	RM6 - HIGH RISE APARTMENT HOUS	SING
	ZONING REQUIREMENTS		
and the state of t	MINIMUM LOT MINIMUM AREA MAX FAR	RM6 30m X 35m 1700m2 1.5 +0.2 PARKING BELOW BLDG +0.1 PER 10% OPEN SPACE > 50%	PROPOSED 80.7m X 38.7m 3096.4m2 1.62
	SITE COVER SETBACKS	50%	79%
	FRONT	6.0m 4.5m (6.0m FLANKING STREET)	6.6m NORTH 0.2m WEST 1.5m EAST
	REAR PRIVATE OPEN SPACE	9.0m	4.0m SOUTH
	BACHELOR 1 BEDROOM 2+ BEDROOM	7.0m2 12.0m2 18.0m2	
-	PROPOSED BUILDING COM	IFIGURATION	
	PRIVATE OPEN SPACE	1137.1m2	
	UNITS	58 TOTAL (2 x 1BR, 45 x 2BR, 10 x 3B	R, 1 x 4BR)
	PARKING	39 REGULAR (54%), 28 MEDIUM (38%	%), 4 SMALL (6%) + 1 HC = 72 STALLS
	BICYCLE PARKING	30 CLASS I 6 CLASS II	
1		1	





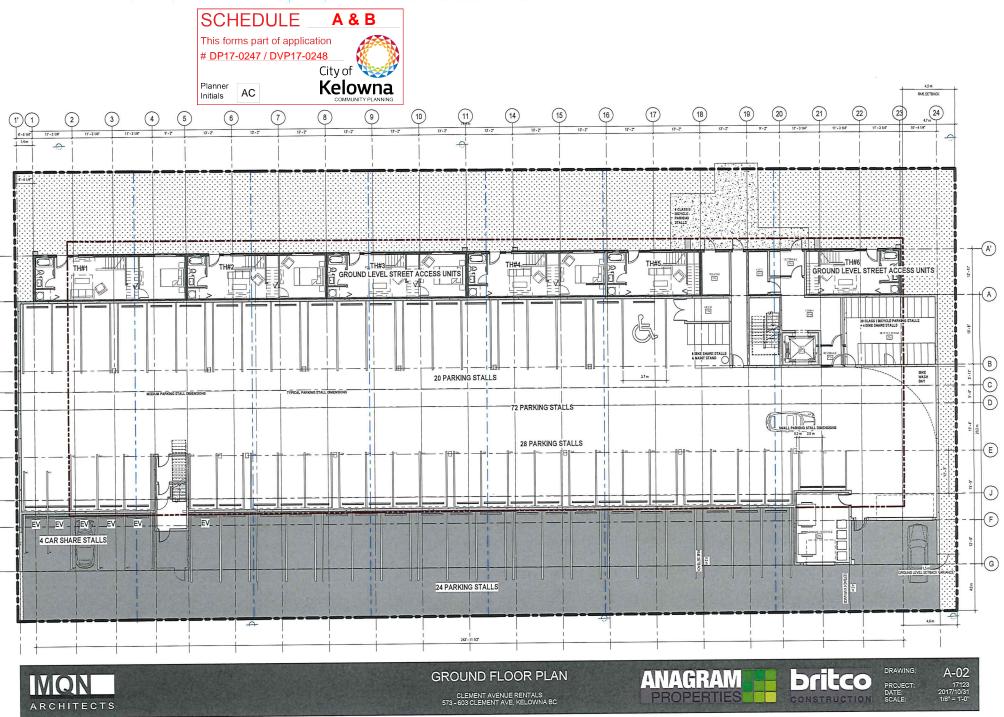



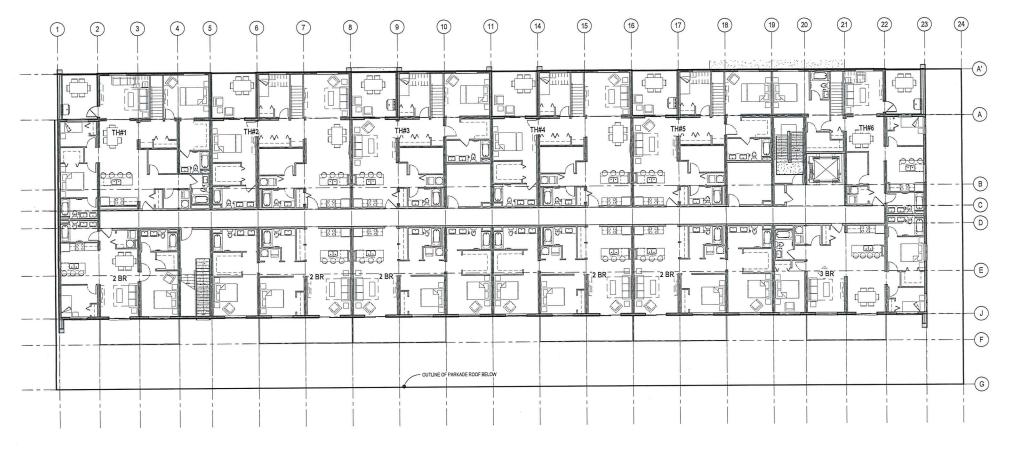



SECOND FLOOR PLAN

CLEMENT AVENUE RENTALS 573 - 603 CLEMENT AVE, KELOWNA BC


ANAGRAM PROPERTIES

A-03

britco

CONSTRUCTION



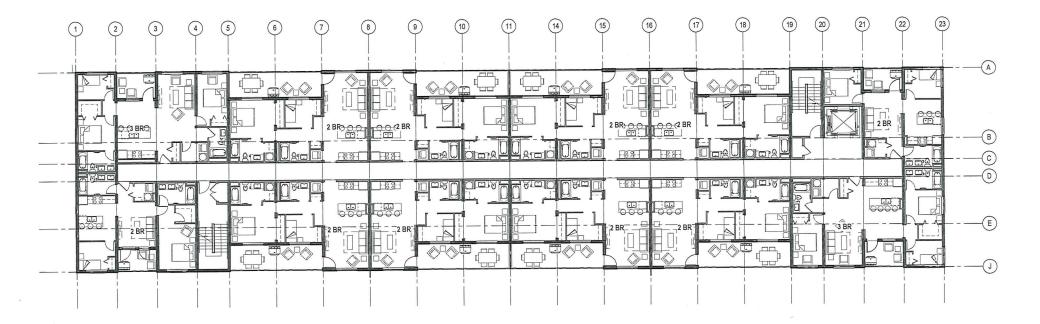

MQN ARCHITECTS

THIRD FLOOR PLAN

CLEMENT AVENUE RENTALS 573 - 603 CLEMENT AVE, KELOWNA BC


ANAGRAM PROPERTIES

A-04

17123 2017/10/31 1/8'' = 1'-0''

britco



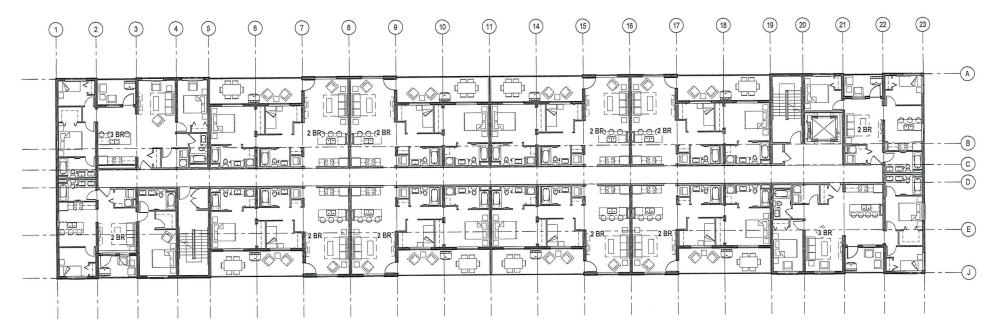



FOURTH FLOOR PLAN

CLEMENT AVENUE RENTALS 573 - 603 CLEMENT AVE, KELOWNA BC


ANAGRAM PROPERTIES CONSTRUCTION

britco

A-05

17123 2017/10/31 1/6" = 1'-0"



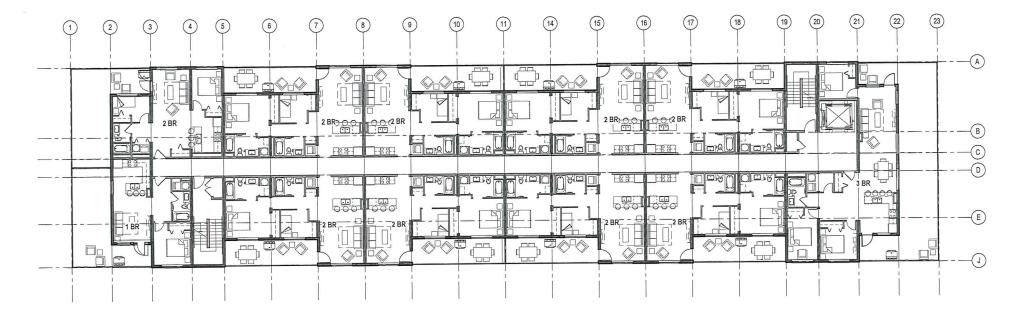


MQN ARCHITECTS FIFTH FLOOR PLAN CLEMENT AVENUE RENTALS 573 - 603 CLEMENT AVE, KELOWNA BC

ANAGRAM PROPERTIES

britco

A-06



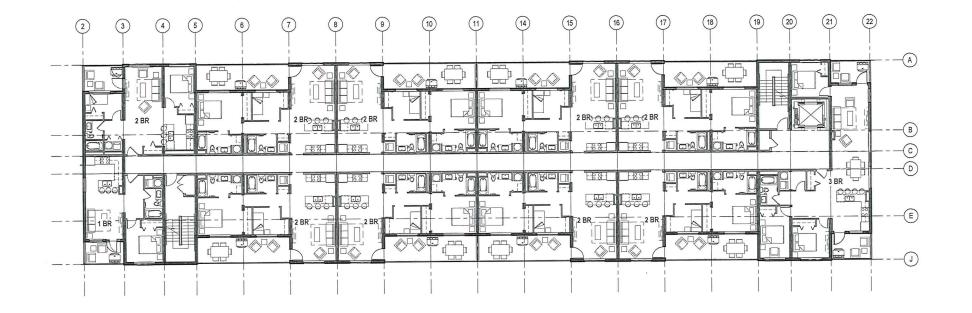



SIXTH FLOOR PLAN CLEMENT AVENUE RENTALS 573 - 603 CLEMENT AVE, KELOWNA BC

ANAGRAM PROPERTIES

britco

A-07 17123 2017/10/31 1/8" = 1'-0"





A-08









ARCHITECTS

PERSPECTIVE VIEWS CLEMENT AVENUE RENTALS 573 - 603 CLEMENT AVE, KELOWNA BC

ANAGRAM


britco PROPERTIES

PROJECT: DATE: SCALE:

A-09


17123 2017/10/31 NTS



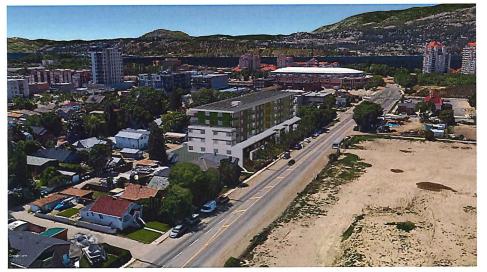





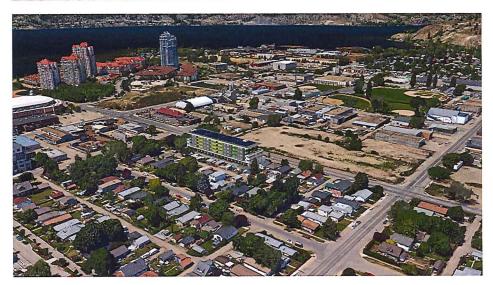




PERSPECTIVE VIEWS CLEMENT AVENUE RENTALS 573 - 603 CLEMENT AVE, KELOWNA BC

Dritco DONSTRUCTION DATE: SCALE: ANAGRAM PROPERTIES

A-10 17123 2017/10/31 NTS

DRAWING:



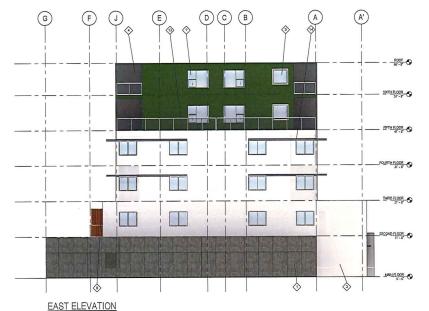

(G) ()(E) F (A')(A)(B) 14 ٢ 13 (5) RCOF O ST-IC RIFTH R COR FOLRTH FLOOR THERD FLOOR SECOND FLOOR MAIN FLOOR B 0 \Diamond

ANAGRAM

PROPERTIES



EXTERIOR FINISH LEGEND

- ARCHITECTURAL CONCRETE, CONE SNAP THE FORMING PROFILE: SMOOTH HORIZONITAL FORMS CAN 2" REVEALS COLOUR: NATURAL CONCRETE NO TINT OR SEALER) $\langle 1 \rangle$
- TAN FIBER CEMENT LAP SIDE PRODUCT: HARDIPLANK COLOUR: MONTEREY TAUPE $\langle 2 \rangle$
- 3 WHITE CEMENTITIOUS PANEL PRODUCT: HARDIEPANEL RNISH STUCCO RINSH
- LIGHT BLUE FIBER COMENT VERTICAL SIDING* PRODUCT: HARDPANEL COLOUR: BOOTHIAY BLUE $\langle 4 \rangle$
- \$
- LIGHT BLUE FIBER CEMENT VERTICAL SIDING* PRODUCT: HARDIPANEL COLOUR: BOOTHEAY BLUE

- 6 LIGHT BLUE FIBER CEMENT VERTICAL SIDING* PRODUCT: HARDIPANEL COLOUR: BOOTHEAY BLUE
- TOUT BLUE FIBER CEMENT V PRODUCT: HARDIPANEL COLOUR: BOOTHBAY BLUE

EXTERIOR CLEAR CLAZING RAMNO VINTL COLOUR: WHITE

- STAINED CEDAR CLADDING PROFILE: Them: Bitms RCUO-CLUT CEDAR SHPLAP COLUME: SIXKENE CETICUL LODA SIDING "SIXKID/ID INTURU" TRAVELUCENT FINISH 2 COATS
 - 9 EXTERIOR CLEAR GLAZING FRAMING VINIL COLOUR: WHITE

12

(13)

EXTERIOR INSULATED OVERHEAD DOOR FRAMING PRESSED STEEL FRAME COLOUR: WHITE

- 14 METAL CANOPY FRAMING ALLMINUM COLOUR: CLEAR ANODIZED

COLOR WHITE

EXTERIOR OLASS RAILING FRAMING: ALLMINUM COLOUR: OALVALLINE

ELEVATIONS

WEST ELEVATION



britco

CONSTRUCTION

A-12

17123 2017/10/31 1/8" = 1'-0"



MQN ARCHITECTS

CLEMENT AVENUE RENTALS 573 - 603 CLEMENT AVE, KELOWNA BC

FAR CALCULATION


3 THIRD FLOOR

			UNIT 15 m ²	
UNIT 1 76 m² 75 m² 76 m² 10 m² 76 m² 10 m²	UNIT 75 m 18 m ²	UNII) 75 m² 18 m²		

SECOND FLOOR

DECK 14 m²	DECK 16 m ²	DECK 16 m ³	DECK 16 m²	DECK 16 m ²	DECK 14 m ²
		TOWNHOUSE 110 m	TOWNHOUSE 125 m]	TOWNHOUSE	TOWNHOUSE 105 m'
				COMMON ARE 201 m ²	
	1 7	P P			



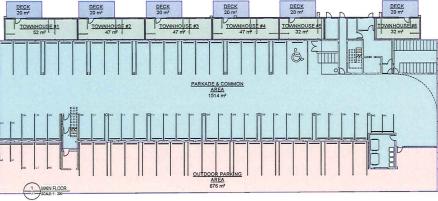

UNIT 76 m DECK DECK DECK DECK	UNIT P ⁹⁶ m ⁷

	UNIT 18 m ²		UNIT 103 m ² 200M/ON AREA 160 m ²
DECK 36 mr 36 mr			

DECK 18 m²

TH

LF

UNIT 75 m²

3096.4 m²

2376.3 m²

5023.0 m²

676.0 m²

britco

CONSTRUCTION

DECK

UNIT 103 m²

B m²

A-13 17123 2017/10/31 1 : 200

160 m²

LĽ

DECK 18 m²

H

UNIT 75 m²

DECK 18 m²

H

UNIT 75 m²

DECK 18 m

FAR CALCULATION

TOTAL SITE AREA

EXCLUDED AREA

INCLUDED AREA

PARKING AREA

PRIVATE OPEN SPACE 1137.1 m²

FLOOR AREA RATIO: 1.62

4-

4 FOURTH FLOOR

FIFTH FLOOR

E

+ DECK

6 SIXTH FLOOR

TOTAL SITE AREA

BUILDING AREA

PARKING AREA

BUILDING COVERAGE

PARKING COVERAGE

(BUILDINGS, DRIVEWAYS, & PARKING)

SITE COVERAGE CALCULATION

TOTAL SITE COVERAGE: 0.79

DECK 8 m²

n UNIT 52 m²

DECK 18 m²

75.m2

LF

UNIT]

DECK 18 m²

3096.4 m²

1771.4 m²

676.0 m²

0.57

0.22

ANAGRAM

PROPERTIES

City of Kelowna

A & B


This forms part of application # DP17-0247 / DVP17-0248

AC

SCHEDULE

Planner

Initials

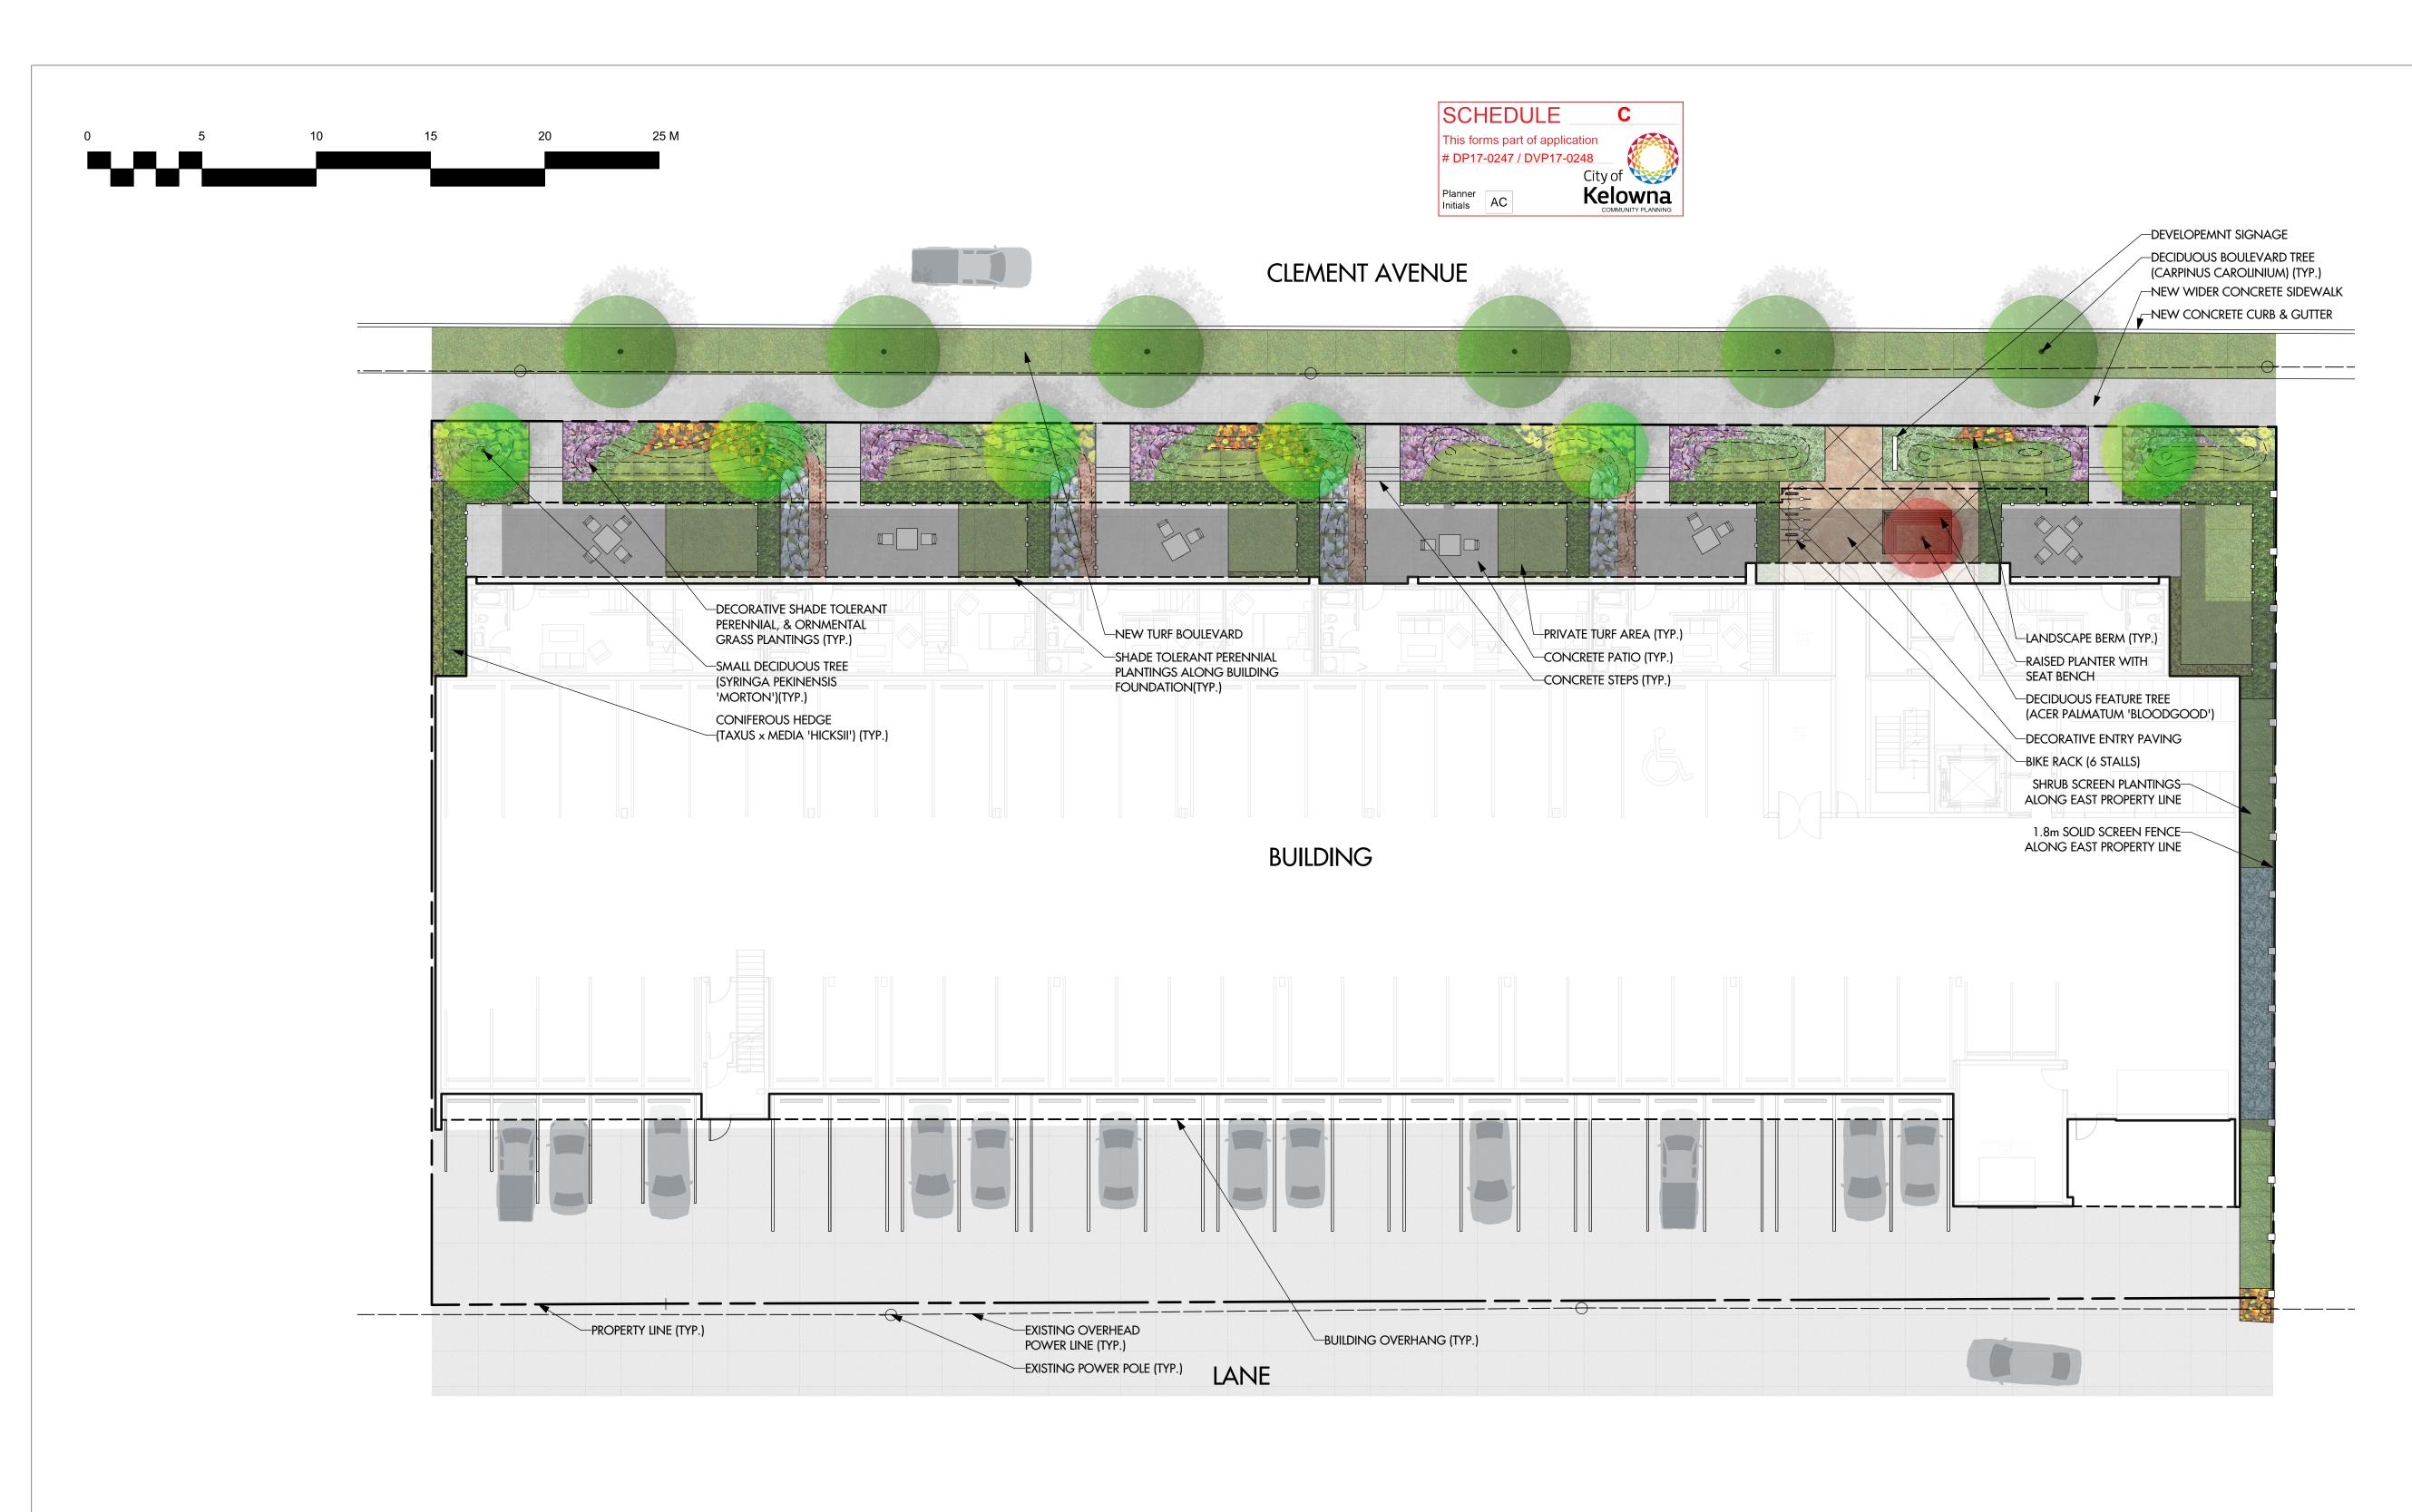

BOTANICAL NAME	COMMON NAME	QTY	SIZE/SPACING & REMARKS
TREES			
ACER PALMATUM 'BLOODGOOD'	BLOODGOOD JAPANESE MAPLE	1	6cm CAL.
CARPINUS CAROLINIANA	AMERICAN HORNBEAM	6	6cm CAL.
SYRINGA PEKINENSIS 'MORTON'	CHINA SHOW PEKING LILAC	6	6cm CAL.
SHRUBS			
CORNUS ALBA 'BAILHALO'	IVORY HALO DOGWOOD	10	#05 CONT. /1.5M O.C. SPACING
HYDRANGEA MACROPHYLLA 'BAILMER'	ENDLESS SUMMER BIGLEAF HYDRANGEA	12	#05 CONT. /1.5M O.C. SPACING
JUNIPERUS SCOPULORUM	ROCKY MOUNTAIN JUNIPER	7	#15 CONT. /1.5M O.C. SPACING
Taxus media 'hicksii'	HICKS YEW	100	#15 CONT. /0.9M O.C. SPACING
PERENNIALS, GRASSES & GROUNDCOVERS			
ASTILBE 'BRESSINGHAM BEAUTY'	BRESSINGHAM BEAUTY ASTILBE	40	#01 CONT. /0.75M O.C. SPACING
CAREX MORROWII 'ICE DANCE'	ICE DANCE JAPANESE SEDGE	33	#01 CONT. /0.6M O.C. SPACING
DICENTRA SPECTABILIS	BLEEDING HEART	33	#01 CONT. /0.9M O.C. SPACING
EUPHORBIA POLYCHROMA	CUSHION SPURGE	30	#01 CONT. /0.75M O.C. SPACING
HERMEROCALLIS 'FRANS HALS'	FRANS HALS DAYLILY	36	#01 CONT. /0.75M O.C. SPACING
HEUCHERA 'PLUM PUDDING'	PLUM PUDDING CORAL BELLS	56	#01 CONT. /0.75M O.C. SPACING
HOSTA 'BLUE MAMMOTH'	BLUE MAMMOTH HOSTA	45	#02 CONT. /1.0M O.C. SPACING
HOSTA FORTUNEI 'AUREOMARGINATA'	GOLD STANDARD HOSTA	38	#02 CONT. /0.6M O.C. SPACING
PACHYSANDRA TERMINALIS	JAPANESE SPURGE	8	#01 CONT. /0.6M O.C. SPACING

NOTES

1. PLANT MATERIAL AND CONSTRUCTION METHODS SHALL MEET OR EXCEED B.C.L.N.A. STANDARDS.

2. ALL SOFT LANDSCAPE AREAS SHALL BE WATERED BY A FULLY AUTOMATIC TIMED UNDERGROUND IRRIGATION SYSTEM.


3. TREE AND SHRUB BEDS TO BE DRESSED IN A MINIMUM 50mm WOOD MULCH. DO NOT PLACE WEED MAT UNDERNEATH TREE AND SHRUB BEDS.

4. TREE AND SHRUB BEDS TO RECEIVE A MINIMUM 450mm DEPTH TOPSOIL PLACEMENT.

5. TURF AREAS FROM SOD SHALL BE NO. 1 GRADE GROWN FROM CERTIFIED SEED OF IMPROVED CULTIVARS REGISTERED FOR SALE IN B.C. AND SHALL BE TOLERANT OF DROUGHT CONDITIONS. A MINIMUM OF 150mm DEPTH OF GROWING MEDIUM IS REQUIRED BENEATH TURF AREAS. TURF AREAS SHALL MEET EXISTING GRADES AND HARD SURFACES FLUSH.



206 - 1889 Spall Road Kelowna, BC V1Y 4R2 T (250) 868-9270 www.outlanddesign.ca

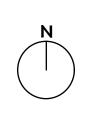

PROJECT TITLE

CLEMENT AVENUE APARTMENTS

Kelowna, BC DRAWING TITLE

CONCEPTUAL LANDSCAPE PLAN

ISSUED FOR / REVISION

1	18.04.09	Review
2		
3		
4		
5		

PROJECT NO	17-106
DESIGN BY	KM
DRAWN BY	MC
CHECKED BY	FB
DATE	APR. 9, 2018
SCALE	1:150

SEAL




DRAWING NUMBER



ISSUED FOR REVIEW ONLY


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206 - 1889 Spall Road Kelowna, BC V1Y 4R2 T (250) 868-9270 www.outlanddesign.ca

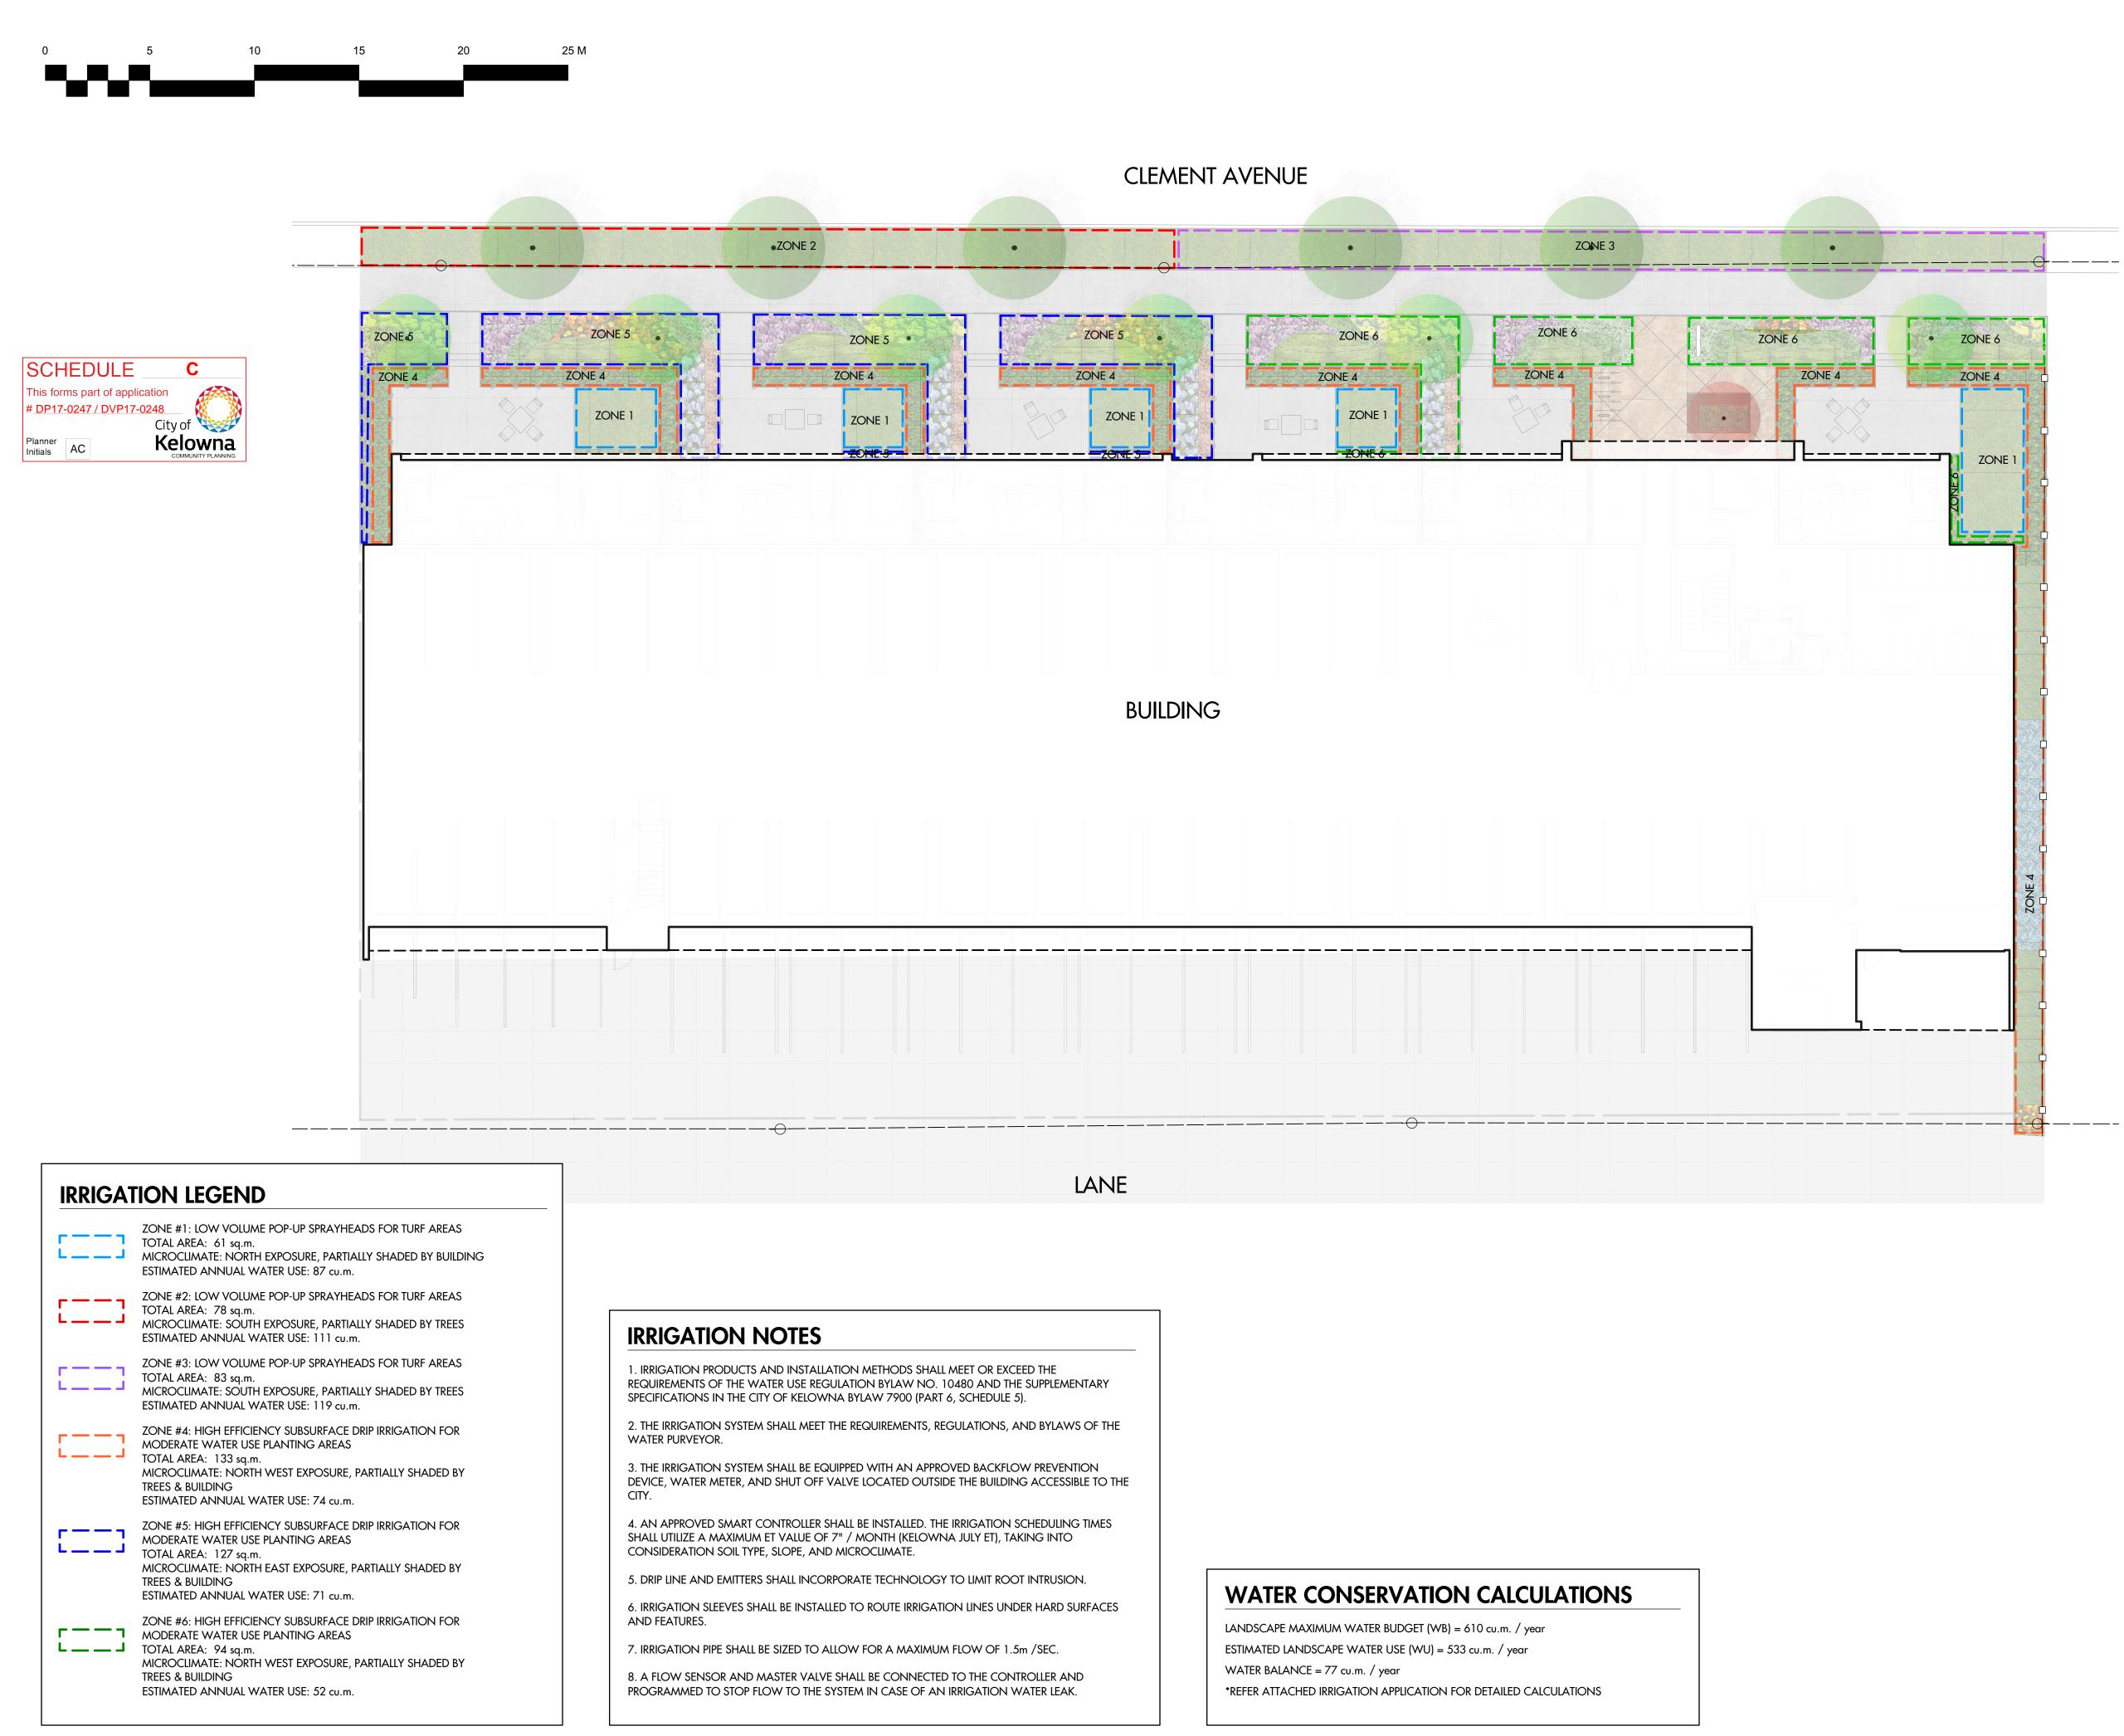

PROJECT TITLE

CLEMENT AVENUE APARTMENTS

DRAWING TITLE

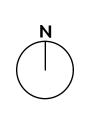Kelowna, BC

IRRIGATION/WATER CONSERVATION PLAN

ISSUED FOR / REVISION

1000		
1	18.04.09	Review
2		
3		
4		
5		

PROJECT NO	17-106
DESIGN BY	KM
DRAWN BY	MC
CHECKED BY	FB
DATE	APR. 9, 2018
SCALE	1:150

SEAL



DRAWING NUMBER



ISSUED FOR REVIEW ONLY

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Wednesday, November 1, 2017

Anagram Properties Incorporated

33-1818 Peak Pointe Crescent West Kelowna, BC, V1Z 4B8 Attn: Reg Hamilton, Founding Partner & Development Manager Via Email to: reg@anagramproperties.com

Re: Proposed Clement Avenue Apartments Development – Preliminary Cost Estimate for Bonding

Dear Reg:

Please be advised of the following preliminary cost estimate for bonding of the proposed landscape works shown in the **Clement Avenue Apartments** conceptual landscape plan dated 17.11.01;

• 582 square metres (6,265 square feet) of improvements = \$42,195.00

This preliminary cost estimate is inclusive of trees, shrubs, turf, mulch, topsoil & irrigation.

You will be required to submit a performance bond to the City of Kelowna in the amount of 125% of the preliminary cost estimate. Please do not hesitate to contact me with any questions about the landscape plan.

Best regards,

Fiona Barton, MBCSLA, CSLA *as per* Outland Design Landscape Architecture



206-1889 Spall Road, Kelowna, BC, V1Y 4R2 P 250.868.9270 **outlanddesign.ca**



November 24, 2017

Emily Williamson, Planner City of Kelowna Planning Department 1435 Water Street Kelowna, BC V1Y 1J4

Re:	Rezoning, and Development Application Development Rationale
	Anagram PROPERTIES Inc - Clement Avenue RENTALS

Address: 573 – 603 Clement Avenue

Dear Emily,

Following our meetings and correspondence, we are submitting the rationale below to support the proposed development by Anagram Properties. The proposed project includes the rezoning and development of properties at 573 - 603 Clement Ave into a multi-family development. This proposed project provides 58 units consisting of 1 - 3 bedroom units and 4 bedroom townhouse units. This project would involve the consolidation and rezoning of the existing properties to provide a 3096m2 site.

Design Rationale

MQN Architects is collaborating with Anagram PROPERTIES Inc. on the development of a multi-family rental development on Clement Avenue in downtown Kelowna. The proposed development follows Anagram's corporate strategy of providing smart, sustainable and attainable properties. This purpose built rental project is situated on the edge of the city centre of Kelowna enabling residents to walk to work and social activities. Clement Avenue is poised to change from a low-density corridor straddling between single family residential housing and industrial lands to a vibrant northern gateway to the city centre. This proposed project in conjunction with other developments planned within a two-block radius are set to redefine this area with increased density and livability.

Anagram PROPERTIES Inc. has selected this site in Kelowna for its prime location. Clement Avenue provides easy access to and from the city centre enabling residents reduce dependence on vehicular transit. To further enhance resident's ability to live car free, this project is providing four car share parking stalls which would be available to not just building residents but also residents of the surrounding neighbourhood. This site also provides



excellent access to the Waterfront Park and multiple arts and sporting venues balancing a live/work lifestyle. Proposed projects in the immediate vicinity of this project include commercial space increasing the potential for residents to shop in the immediate area. In addition to having a favourable proximity to the urban core, this site is also well positioned for a solar first approach. The selection of this site provided the client with a wide south facing roof location optimal for solar panel installation.

"My Downtown will include areas where citizens choose to live, shop, play and congregate and where businesses choose to do business and where developers choose to develop." – Vision Statement from My Downtown! 2012

The proposed site is designated in the OCP for building heights up to 37m or 12 stories. Recent proposals on adjacent properties have been targeted at the six-storey height. The Anagram property is also proposing a six-storey height consisting of a ground plane with parking and townhouses and five floors of residential housing above. The current zoning for this property is RU2 residential. Through discussions with the planning department RM6 multifamily zoning is proposed with variances and height restrictions. The increased height and mass of the project are consistent with the zoning of the neighbouring C7 property to the west and would be stepped at the east end to provide a transition to the existing neighbourhood.

The proposed massing for this project has been developed to break down the vertical scale into a two-level base with four levels of stepped housing above. From Clement Avenue this project has a two-level townhouse base which increases the connectivity of the ground floors of the project to the street and buffers the parkade behind. The townhouses are designed to provide the residents with flexibility on the ground floor level where the space could be used currently as a portion of the residence or in the future could potentially provide live/work space with direct street access. The four levels above the townhouses are stepped further back breaking down the scale of the development. The ends of the building have been also stepped at the fourth floor to decrease the massing from the east and west end. The balconies of the upper four floors have been aligned vertically to reduce the visual bulk of the project and to provide shade to the residents.

The use of massing and materials has been considered in the design to break down the scale and to provide visual strength to the architecture. The mass of the upper floors is accentuated through colour to the inset planes at the balcony locations. Following Anagram PROPERTIES Inc's brand imagery, the balcony insets have been coloured in a gradient. The primary materials on this project include cementitious panel to the upper levels along with stucco on the end masses. At the townhouse levels a cementitious horizontal siding has been utilized to provide additional texture and detail to the ground plane. Wood elements have been used in the design at locations of entry to the townhouses and the main entry to provide a warmth to the material palette.

This project proposes varying the rear and side yard setbacks for this building. This project has located the parking at grade due to the water table in the surrounding area. To achieve the



parking required for this project the side yards have been varied to enable the parking to fit. At the west end of the site this property is adjacent to a C7 zoned lot with a 0m lot line setback. The parkade proposed for Anagram is 0.2m off the west property line following which would be consistent with the neighbouring C7 requirements. Residential units from the ground to the fourth floor are stepped back to 1.5m from the property line and the fifth and sixth floors are 4.5m from the property line. The east side yard setback is proposed at 1.5m to the parkade. To address the scale difference from the RU2 properties at the east end to the proposed building, the setback for the units 4.5m for the first four floors and over 6m for the fifth and sixth floors. The rear yard of this project is varied to a 4m setback from the lane to optimize the ground level parking. The rear of the building above the parking level is set to the typical 9m setback from the laneway.

To achieve the proposed parking and massing of this project, the site coverage has been varied to 79%. The reduced ground plane has been compensated to the users through the inclusion of larger than typical decks to each unit with 46 of the units having over 180sf of deck area. In total, this project has provided 12,230sf of private outdoor space to the residents of the building. Recognizing the potential impact that an increased site coverage will have on the storm water flow into the municipal systems we have been working with New Town Planning Services to identify stormwater management options for this site. New Town has identified a preliminary concept which would include developing a storm detention tank beneath the proposed exterior parking (not parkade). The storm network would be composed of catchbasins, drywells, and a variety of storm detention tanks. The storm detention tank and drywells would be designed to disperse the storm water through infiltration with storage capacity adequate to attenuate the 100-year storm, as per the City of Kelowna servicing bylaw requirements. Roof leaders and foundation drains would be designed to disperse to either rock pits or the storm network, at which point it would be allowed to infiltrate.

The Anagram building for Clement Avenue has been designed to incorporate sustainability into project. Sustainable features for this project start from the location planning with the intent of providing housing within an urban location which reduces the need to vehicular travel. Four parking stalls have been included for car share parking providing residents and neighbours an option to owning a dedicated vehicle. The parking lot also includes six charging stations for electric vehicles spread between both the car share and private parking stalls. 184kw of solar power is being considered for the project which would connect to the electric vehicle charging as well as providing electricity back to the rental units.

To encourage alternative transit, a fully enclosed bicycle room for the residents providing secure, weather protected storage at the ground level. In addition to providing space for the storage of personal bikes, the client is also providing ten shared bicycles for the building tenants which will be located within the parkade area along with a bicycle maintenance space for tenants. The City of Kelowna has been described as having the most extensive bicycle network for a city of its size and intends to build on this with its 20-year transportation plan. The inclusion of innovative programs such as this facility's bike share will augment Kelowna's vision.



This project is designed to be built with modular construction. Anagram is working with Britco to build this project. Modular construction provides many benefits from both environmental and efficiency standpoints. Environmentally modular construction can reduce waste and improve material quality control through building in an environmentally controlled setting. The delivery of the project can also reduce impacts on the neighbours through the reduced construction time. Further information on the modular construction has been included in a separate attached document.

Anagram PROPERTIES has made the decision to proceed with this project as a purpose built rental housing project. This project has received approval from CMHC's (RCF) Rental Construction Financing program to offer market quality rental housing at 10% below market rental rates for 10 years. The project has also applied to the City of Kelowna's Rental Housing Grants Program to help offset DCC's. With recent rental rates in Kelowna hitting 0.5% in 2016, the need for both rental and affordable housing is apparent. This project is designed to provide a variety of housing types from 1-3 bedroom and including 4-bedroom townhouses, this mix can meet a diverse spectrum of needs for people seeking rental housing. The Clement Avenue Rentals help to solve the rental housing crisis currently being experienced by the City of Kelowna.

The Anagram project aligns with the City of Kelowna policies to encourage more housing diversity in the urban core, improve access to family-friendly rental housing and generally encourage more innovative housing approaches. The project also aligns with the City's policies to concentrate growth in the Urban Core.

– James Moore, Acting Department Manager, Policy and Planning (attached letter)

We believe that this project is consistent with the objectives of the Official Community Plan and can provide a building which meets the client's focus for smart, sustainable and attainable buildings. The urban location combined with family sized suites and sustainable features provides a residential product which can meet the needs of the community enabling people to live and work in the urban centre. The sustainable design approach for this building combined with the rental market in Kelowna, City of Kelowna Developer Incentives and CMHC's (RCF) Rental Construction Financing program support make this a project which is both desirable and needed for the City of Kelowna to meet current housing demands.

Regards,

Roger Green

Architect AIBC

CC: Reg Hamilton – Anagram Properties Tom Faliszewski – Britco Construction Vicki Topping – MQN Architects

CITY OF KELOWNA

MEMORANDUM

Date: November 21, 2017

File No.: DP17-0247

To: Community Planning (EW)

From: Development Engineering Manager (JK)

Subject: 573-603 Clement Ave

The Development Engineering Department has the following comments and requirements associated with this Development Application Permit to evaluate the form and character of an apartment building.

The Development Engineering Technologist for this project is Jason Angus

1. <u>General.</u>

All offsite infrastructure and services upgrades have been addressed in the Rezoning Application Engineering Report under file Z17-0103.

James Kay, P Eng. Development Engineering Manager

JA

CITY OF KELOWNA

MEMORANDUM

Date: November 21, 2017

File No.: DVP17-0248

To: Community Planning (EW)

From: Development Engineer Manager (JK)

Subject: 576-603 Clement Ave

The Development Engineering comments and requirements regarding this DVP application are as follows:

The request to vary the side yard setback, the rear yard setback, and site coverage does not compromise municipal services.

James Kay, P. Eng. Development Engineering Manager

JA