

This permit relates to land in the City of Kelowna municipally known as

1371 Bernard Avenue

and legally known as

Lot 7 District Lot 137 Osoyoos Division Yale District Plan 7936

and permits the land to be used for the following development:

Multiple Dwelling Housing

The present owner and any subsequent owner of the above described land must comply with any attached terms and conditions.

Date of Council Decision January 28, 2019

Decision By: Council

Development Permit Area: Comprehensive Development Permit Area

This permit will not be valid if development has not commenced by January 28, 2021.

Existing Zone: RM3 – low Density Multiple Housing Future Land Use Designation: MRL – Multiple Uni Residential (Low Density)

This is NOT a Building Permit.

In addition to your Development Permit, a Building Permit may be required prior to any work commencing. For further information, contact the City of Kelowna, Development Services Branch.

NOTICE

This permit does not relieve the owner or the owner's authorized agent from full compliance with the requirements of any federal, provincial or other municipal legislation, or the terms and conditions of any easement, covenant, building scheme or agreement affecting the building or land.

Owner: Miroslavka Gataric

Applicant: Miroslavka Gataric

Ryan Smith Community Planning Department Manager Community Planning & Strategic Investments Date

1. SCOPE OF APPROVAL

This Development Permit applies to and only to those lands within the Municipality as described above, and any and all buildings, structures and other development thereon.

This Development Permit is issued subject to compliance with all of the Bylaws of the Municipality applicable thereto, except as specifically varied or supplemented by this permit, noted in the Terms and Conditions below.

The issuance of a permit limits the permit holder to be in strict compliance with regulations of the Zoning Bylaw and all other Bylaws unless specific variances have been authorized by the Development Permit. No implied variances from bylaw provisions shall be granted by virtue of drawing notations that are inconsistent with bylaw provisions and that may not have been identified as required Variances by the applicant or Municipal staff.

2. CONDITIONS OF APPROVAL

- a) The dimensions and siting of the building to be constructed on the land be in accordance with Schedule "A";
- b) The exterior design and finish of the building to be constructed on the land be in accordance with Schedule "B";
- c) Landscaping to be provided on the land be in accordance with Schedule "C"; and
- d) The applicant be required to post with the City a Landscape Performance Security deposit in the form of a "Letter of Credit" in the amount of 125% of the estimated value of the landscaping, as determined by a Registered Landscape Architect.

This Development Permit is valid for two (2) years from the date of Council approval, with no opportunity to extend.

3. PERFORMANCE SECURITY

As a condition of the issuance of this Permit, Council is holding the security set out below to ensure that development is carried out in accordance with the terms and conditions of this Permit. Should any interest be earned upon the security, it shall accrue to the Developer and be paid to the Developer or his or her designate if the security is returned. The condition of the posting of the security is that should the Developer fail to carry out the development hereby authorized, according to the terms and conditions of this Permit within the time provided, the Municipality may use enter into an agreement with the property owner of the day to have the work carried out, and any surplus shall be paid over to the property own of the day. Should the Developer carry out the development permitted by this Permit within the time set out above, the security shall be returned to the Developer or his or her designate. There is filed accordingly:

a) An Irrevocable Letter of Creditor certified cheque in the amount of \$37,548.75

Before any bond or security required under this Permit is reduced or released, the Developer will provide the City with a statutory declaration certifying that all labour, material, workers' compensation and other taxes and costs have been paid.

5. INDEMNIFICATION

Upon commencement of the works authorized by this Permit the Developer covenants and agrees to save harmless and effectually indemnify the Municipality against:

a) All actions and proceedings, costs, damages, expenses, claims, and demands whatsoever and by whomsoever brought, by reason of the Municipality said Permit.

All costs, expenses, claims that may be incurred by the Municipality where the construction, engineering or other types of works as called for by the Permit results in damages to any property owned in whole or in part by the Municipality or which the Municipality by duty or custom is obliged, directly or indirectly in any way or to any degree, to construct, repair, or maintain.

The PERMIT HOLDER is the <u>CURRENT LAND OWNER</u>. Security shall <u>ONLY</u> be returned to the signatory of the Landscape Agreement or their designates.

DEVELOPMENT PERMIT GUIDELINES

Comprehensive Development Permit Area

Consideration has been given to the following guidelines as identified in Section 14.A. of the City of Kelowna Official Community Plan relating to Comprehensive Development Permit Areas:

COMPREHENSIVE DEVELOPMENT PERMIT AREA		NO	N/A
Authenticity and Regional Expression			
Do landscaping and building form convey a character that is distinct to Kelowna and the Central Okanagan?	\checkmark		
Are materials in keeping with the character of the region?	\checkmark		
Are colours used common in the region's natural landscape?	\checkmark		
Does the design provide for a transition between the indoors and outdoors?	\checkmark		
Context			
Does the proposal maintain the established or envisioned architectural character of the neighbourhood?	\checkmark		
Does interim development consider neighbouring properties designated for more intensive development?			\checkmark
Are façade treatments facing residential areas attractive and context sensitive?	\checkmark		
Are architectural elements aligned from one building to the next?			\checkmark
For exterior changes, is the original character of the building respected and enhanced?			\checkmark
Is the design unique without visually dominating neighbouring buildings?	\checkmark		
For developments with multiple buildings, is there a sense of architectural unity and cohesiveness?			\checkmark
Relationship to the Street			
Do buildings create the desired streetscape rhythm?	\checkmark		
Are parkade entrances located at grade?	\checkmark		
For buildings with multiple street frontages, is equal emphasis given to each frontage?	\checkmark		
Massing and Height			
Does the design mitigate the actual and perceived mass of buildings?	\checkmark		
Does the height consider shading and view impacts for neighbouring properties and transition to less intensive areas?	\checkmark		
Human Scale			
Are architectural elements scaled for pedestrians?	\checkmark		
Are façades articulated with indentations and projections?	\checkmark		

COMPREHENSIVE DEVELOPMENT PERMIT AREA	YES	NO	N/A
Are top, middle and bottom building elements distinguished?	\checkmark		
Do proposed buildings have an identifiable base, middle and top?	\checkmark		
Are building facades designed with a balance of vertical and horizontal proportions?	\checkmark		
Are horizontal glazed areas divided into vertically proportioned windows separated by mullions or building structures?	\checkmark		
Does the design incorporate roof overhangs and the use of awnings, louvers, canopies and other window screening techniques?	\checkmark		
Is the visual impact of enclosed elevator shafts reduced through architectural treatments?			\checkmark
Exterior Elevations and Materials			
Are buildings finished with materials that are natural, local, durable and appropriate to the character of the development?	\checkmark		
Are entrances visually prominent, accessible and recognizable?	\checkmark		
Are higher quality materials continued around building corners or edges that are visible to the public?	\checkmark		
Are a variety of materials used to create contrast, enhance the pedestrian environment and reduce the apparent mass of a building?	\checkmark		
Are elements other than colour used as the dominant feature of a building?	\checkmark		
Public and Private Open Space		L	
Does public open space promote interaction and movement through the site?			\checkmark
Are public and private open spaces oriented to take advantage of and protect from the elements?	\checkmark		
Is there an appropriate transition between public and private open spaces?	\checkmark		
Are amenities such as benches, garbage receptacles, bicycle stands and community notice boards included on site?			\checkmark
Site Access			
Is the safe and convenient movement of pedestrians prioritized?	\checkmark		
Are alternative and active modes of transportation supported through the site design?	\checkmark		
Are identifiable and well-lit pathways provided to front entrances?	\checkmark		
Do paved surfaces provide visual interest?	\checkmark		
Is parking located behind or inside buildings, or below grade?	\checkmark		
Are large expanses of parking separated by landscaping or buildings?			\checkmark
Are vehicle and service accesses from lower order roads or lanes?	\checkmark		

COMPREHENSIVE DEVELOPMENT PERMIT AREA	YES	NO	N/A
Do vehicle and service accesses have minimal impact on the streetscape and public views?			\checkmark
Is visible and secure bicycle parking provided in new parking structures and parking lots?			\checkmark
Environmental Design and Green Building			
Does the proposal consider solar gain and exposure?			\checkmark
Are green walls or shade trees incorporated in the design?			\checkmark
Does the site layout minimize stormwater runoff?			\checkmark
Are sustainable construction methods and materials used in the project?			\checkmark
Are green building strategies incorporated into the design?			\checkmark
Decks, Balconies, Rooftops and Common Outdoor Amenity Space			
Are decks, balconies or common outdoor amenity spaces provided?	\checkmark		
Does hard and soft landscaping enhance the usability of decks, balconies and outdoor amenity spaces?	\checkmark		
Are large flat expanses of roof enhanced with texture, colour or landscaping			\checkmark
where they are visible from above or adjacent properties? Amenities, Ancillary Services and Utilities			
Are loading, garage, storage, utility and other ancillary services located away from public view?	\checkmark		
Are vents, mechanical rooms / equipment and elevator penthouses integrated with the roof or screened with finishes compatible with the building's design?	\checkmark		
Landscape Development and Irrigation Water Conservation			
Does landscaping:	-	-	-
 Compliment and soften the building's architectural features and mitigate undesirable elements? 	\checkmark		
 Maintain the dominant pattern of landscaping along the street and surrounding properties? 	\checkmark		
• Enhance the pedestrian environment and the sense of personal safety?	\checkmark		
 Screen parking areas, mechanical functions, and garbage and recycling areas? 	\checkmark		
Respect required sightlines from roadways and enhance public views?	\checkmark		
Retain existing healthy mature trees and vegetation?		\checkmark	
Use native plants that are drought tolerant?	\checkmark		
• Define distinct private outdoor space for all ground-level dwellings?	\checkmark		
Do any fences and retaining walls create visual interest and enhance the pedestrian environment?	\checkmark		

COMPREHENSIVE DEVELOPMENT PERMIT AREA	YES	NO	N/A
Do parking lots have one shade tree per four parking stalls?			\checkmark
Does the Landscape Architect's Landscape Water Conservation Report:	-	-	-
 Meet the requirements for Landscape Water Budget calculations for the landscaped area? 	\checkmark		
 Indicate how the development complies with or varies from the Landscape Water Conservation Guidelines? 	\checkmark		
Landscape Water Conservation Guidelines			
Are plants grouped into "hydro-zones" of high, medium and low or unirrigated / unwatered areas?	\checkmark		
Does at least 25% of the total landscaped area require no irrigation / watering?		\checkmark	
Does at least 25% of the total landscaped area require low water use?	\checkmark		
Does at most 50% of the total landscaped area require medium or high water use?	\checkmark		
Is mulch cover provided for shrubs and groundcover to reduce soil evaporation?	\checkmark		
Do water features such as pools and fountains use recirculated water systems?			\checkmark
Do landscape installation standards meet the requirements of the BC Landscape Standard and / or the Master Municipal Construction Document?			\checkmark
Are the required written declarations signed by a qualified Landscape Architect?		\checkmark	
Irrigation System Guidelines		1	1
Is the Irrigation Plan prepared by a Qualified Professional?		\checkmark	
Are irrigation circuits grouped into "hydro-zones" of high, medium and low or unirrigated / unwatered areas consistent with the landscaping plan?	\checkmark		
Is drip or low volume irrigation used?		\checkmark	
Are the required written declarations signed by a qualified Certified Irrigation Designer?		\checkmark	
Crime prevention			
Are CPTED practices as related to landscaping, siting, form and exterior design included in the design?	\checkmark		
Are building materials vandalism resistant?		\checkmark	
Universal Accessible Design		·	•
Is access for persons with disabilities integrated into the overall site plan and clearly visible from the principal entrance?			\checkmark
Are the site layout, services and amenities easy to understand and navigate?			\checkmark
Lakeside Development			н
Are lakeside open spaces provided or enhanced?			\checkmark

COMPREHENSIVE DEVELOPMENT PERMIT AREA		NO	N/A
Are lake views protected?			\checkmark
Does lakeside development act as a transition between the lake and inland development?			\checkmark
Signs			-
Do signs contribute to the overall quality and character of the development?			\checkmark
Is signage design consistent with the appearance and scale of the building?			\checkmark
Are signs located and scaled to be easily read by pedestrians?			\checkmark
For culturally significant buildings, is the signage inspired by historical influences?			\checkmark
Lighting			
Does lighting enhance public safety?	\checkmark		
Is "light trespass" onto adjacent residential areas minimized?	\checkmark		
Does lighting consider the effect on the façade, neighbouring buildings and open spaces?			\checkmark
Is suitably scaled pedestrian lighting provided?			\checkmark
Does exterior street lighting follow the International Dark Sky Model to limit light pollution?			\checkmark

ZONING ANALYSIS: PROPOSED EXISTING

ZONING: RU6

RM3


UNIT TYPOLOGY & COUNT:


3 BEDROOM:


ALLOWED PR	ROPOSED	BUILDING AREA: 268.5 SM (2890.13 GROSS CONSTRUCTION AREA: 92
0.80	0.59	
NET BUILDING AREA:		
7943.8 SF BASED ON 0.80 FAR	6123.35 SF	
MAX SITE COVERAGE FOR BUILDINGS:		
40%	29%	
MAX SITE COVERAGE INCL PARKING & DRIVEWAYS:		
60%	59%	
BUILDING HEIGHT:		
3 STOREYS OR 10 m	3 STOREYS W/ LOCAL	IZED DEPRESSION
SETBACKS:	FOR ENTRY	
FRONT: 4.5m	4.5m	
SIDE: 2.5m FROM WEST 4.5m FROM LAKEVIEW S ⁻	7.75m FROM WEST T. 4.5m FROM LAKEVIEV	V ST.
REAR: 7.5m	8.3m	
PRIVATE OPEN SPACE:		
REQUIRED: 100.0 m2	BALCONIES/ PATIOS:	333.57 m2
PARKING AND LOADING:	PROVIDED:	
2 STALLS x 4 UNITS = 8 STALLS	8 STALLS	
	PROVIDED:	
BICYCLE PARKING: CLASS II: 0.1 x 4 UNITS = 0.4	2 STALLS	




PLAN. PLAN.

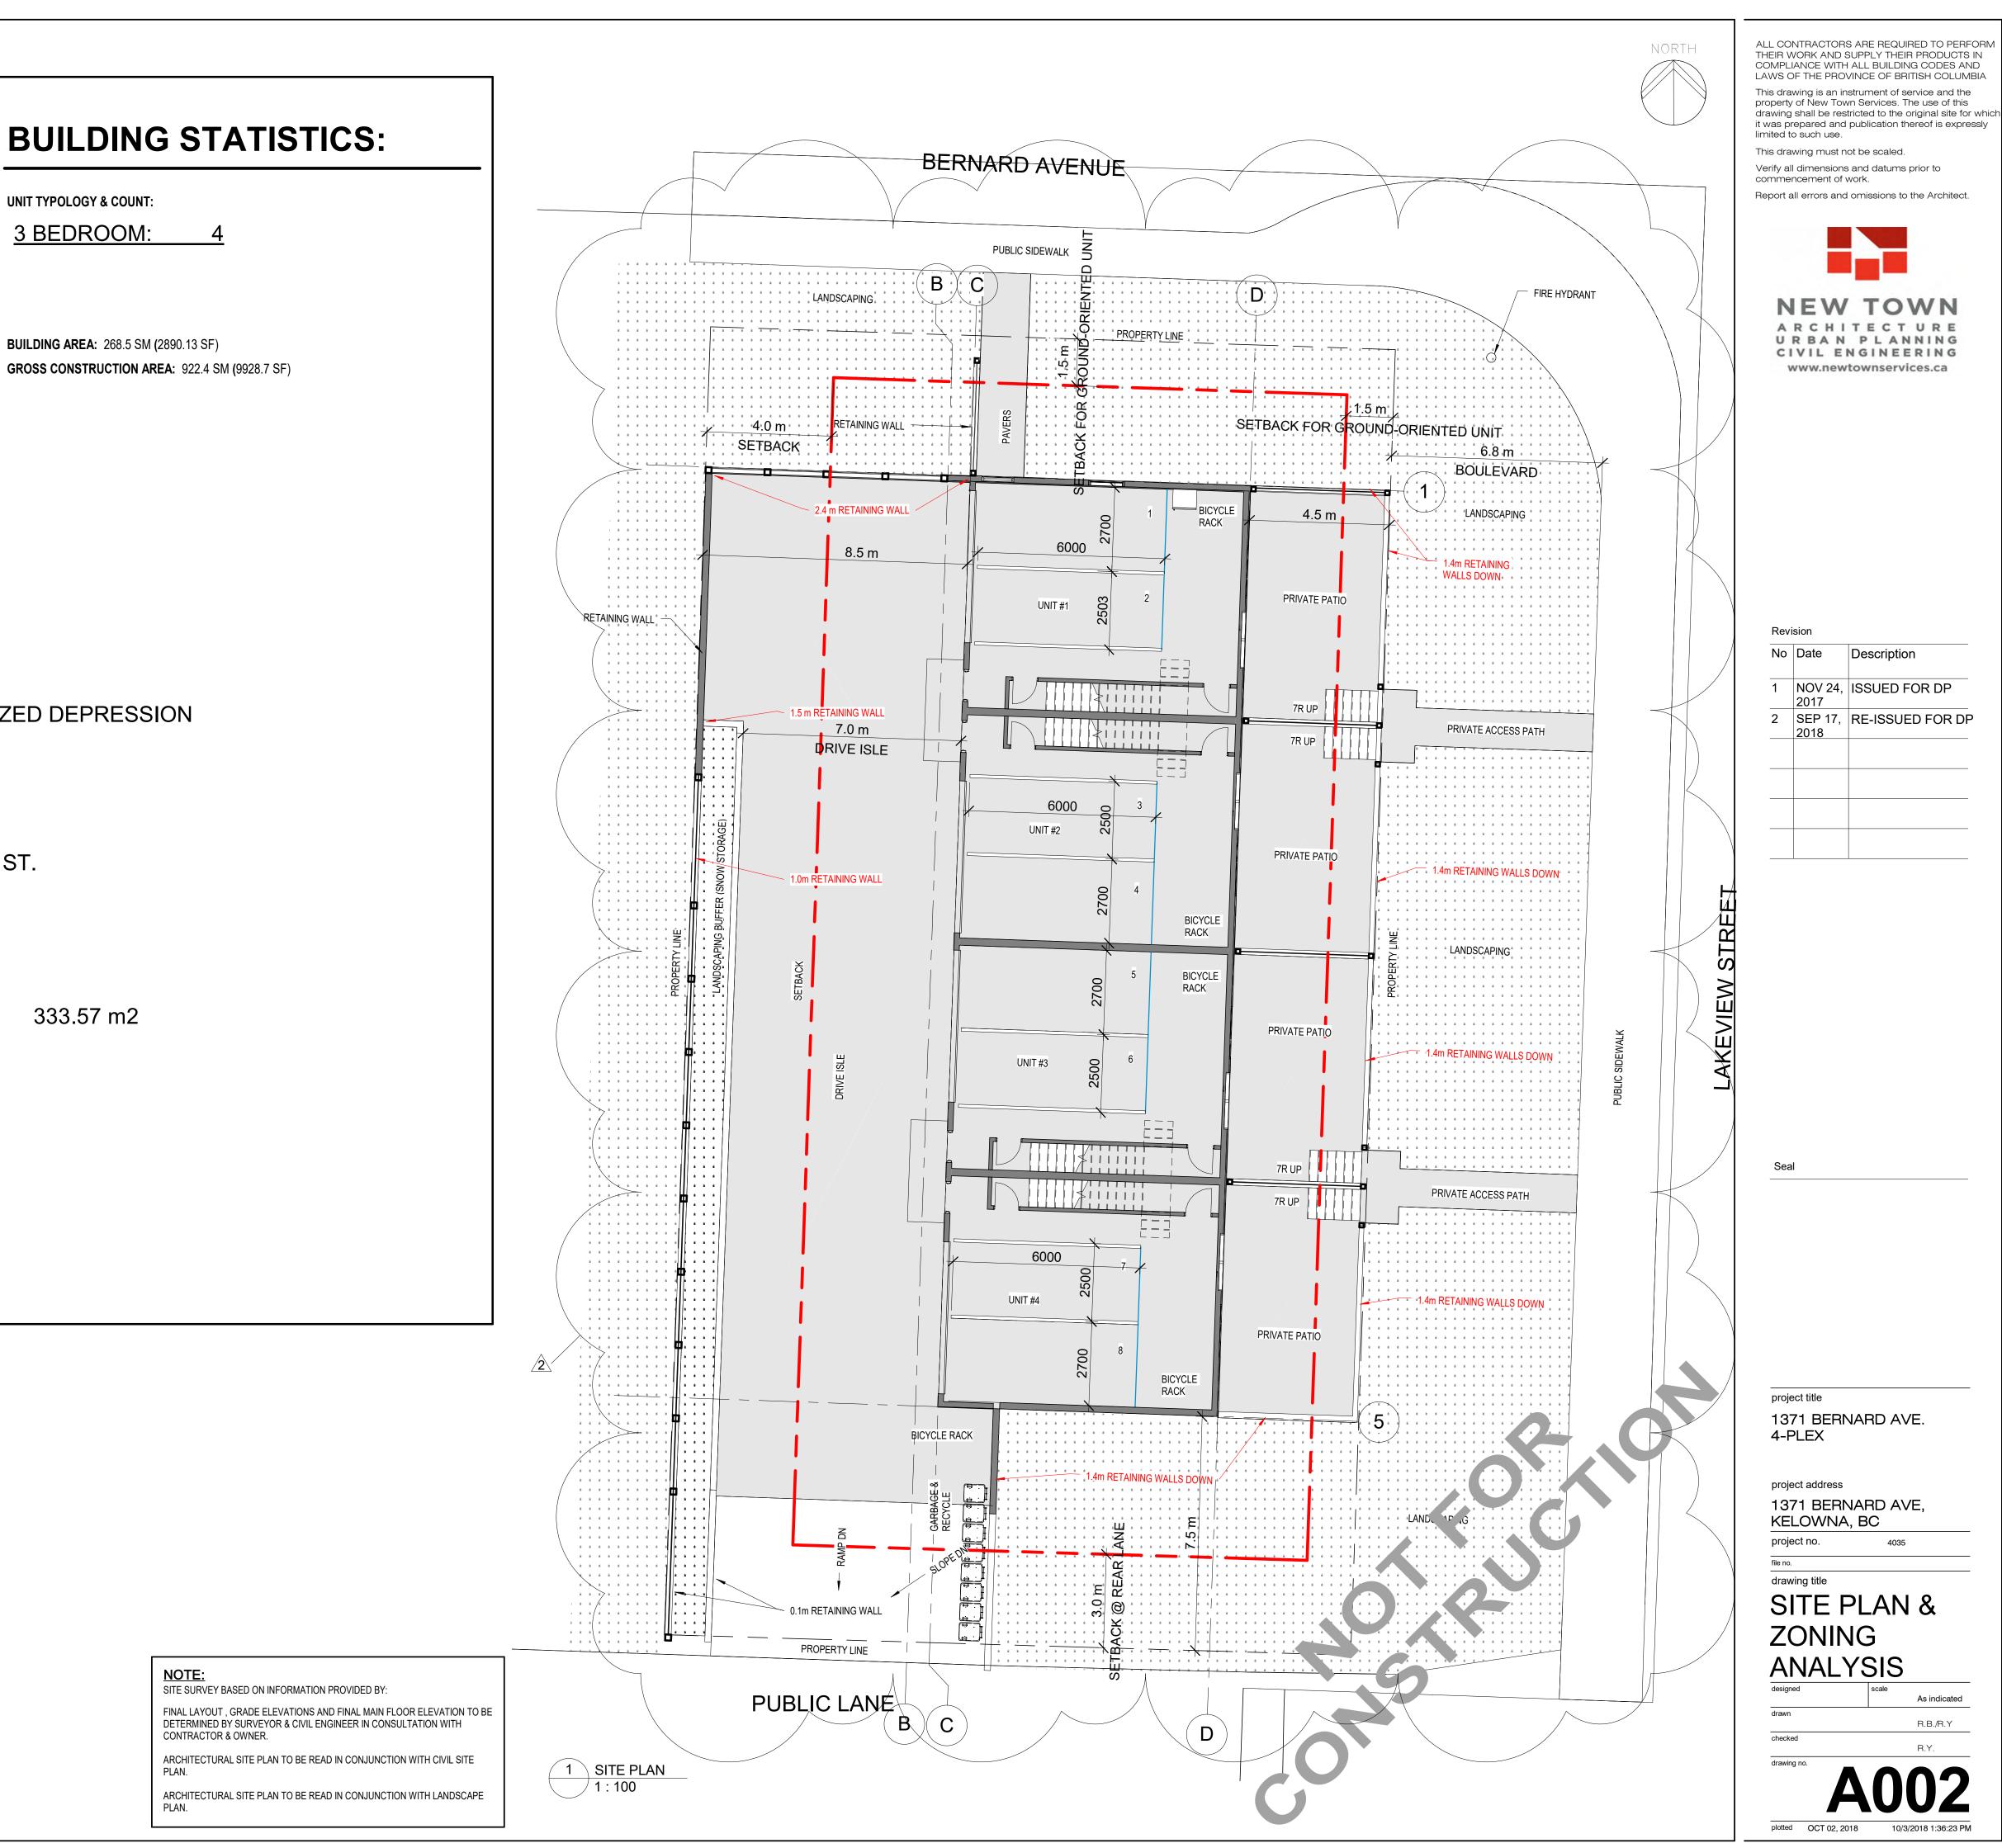

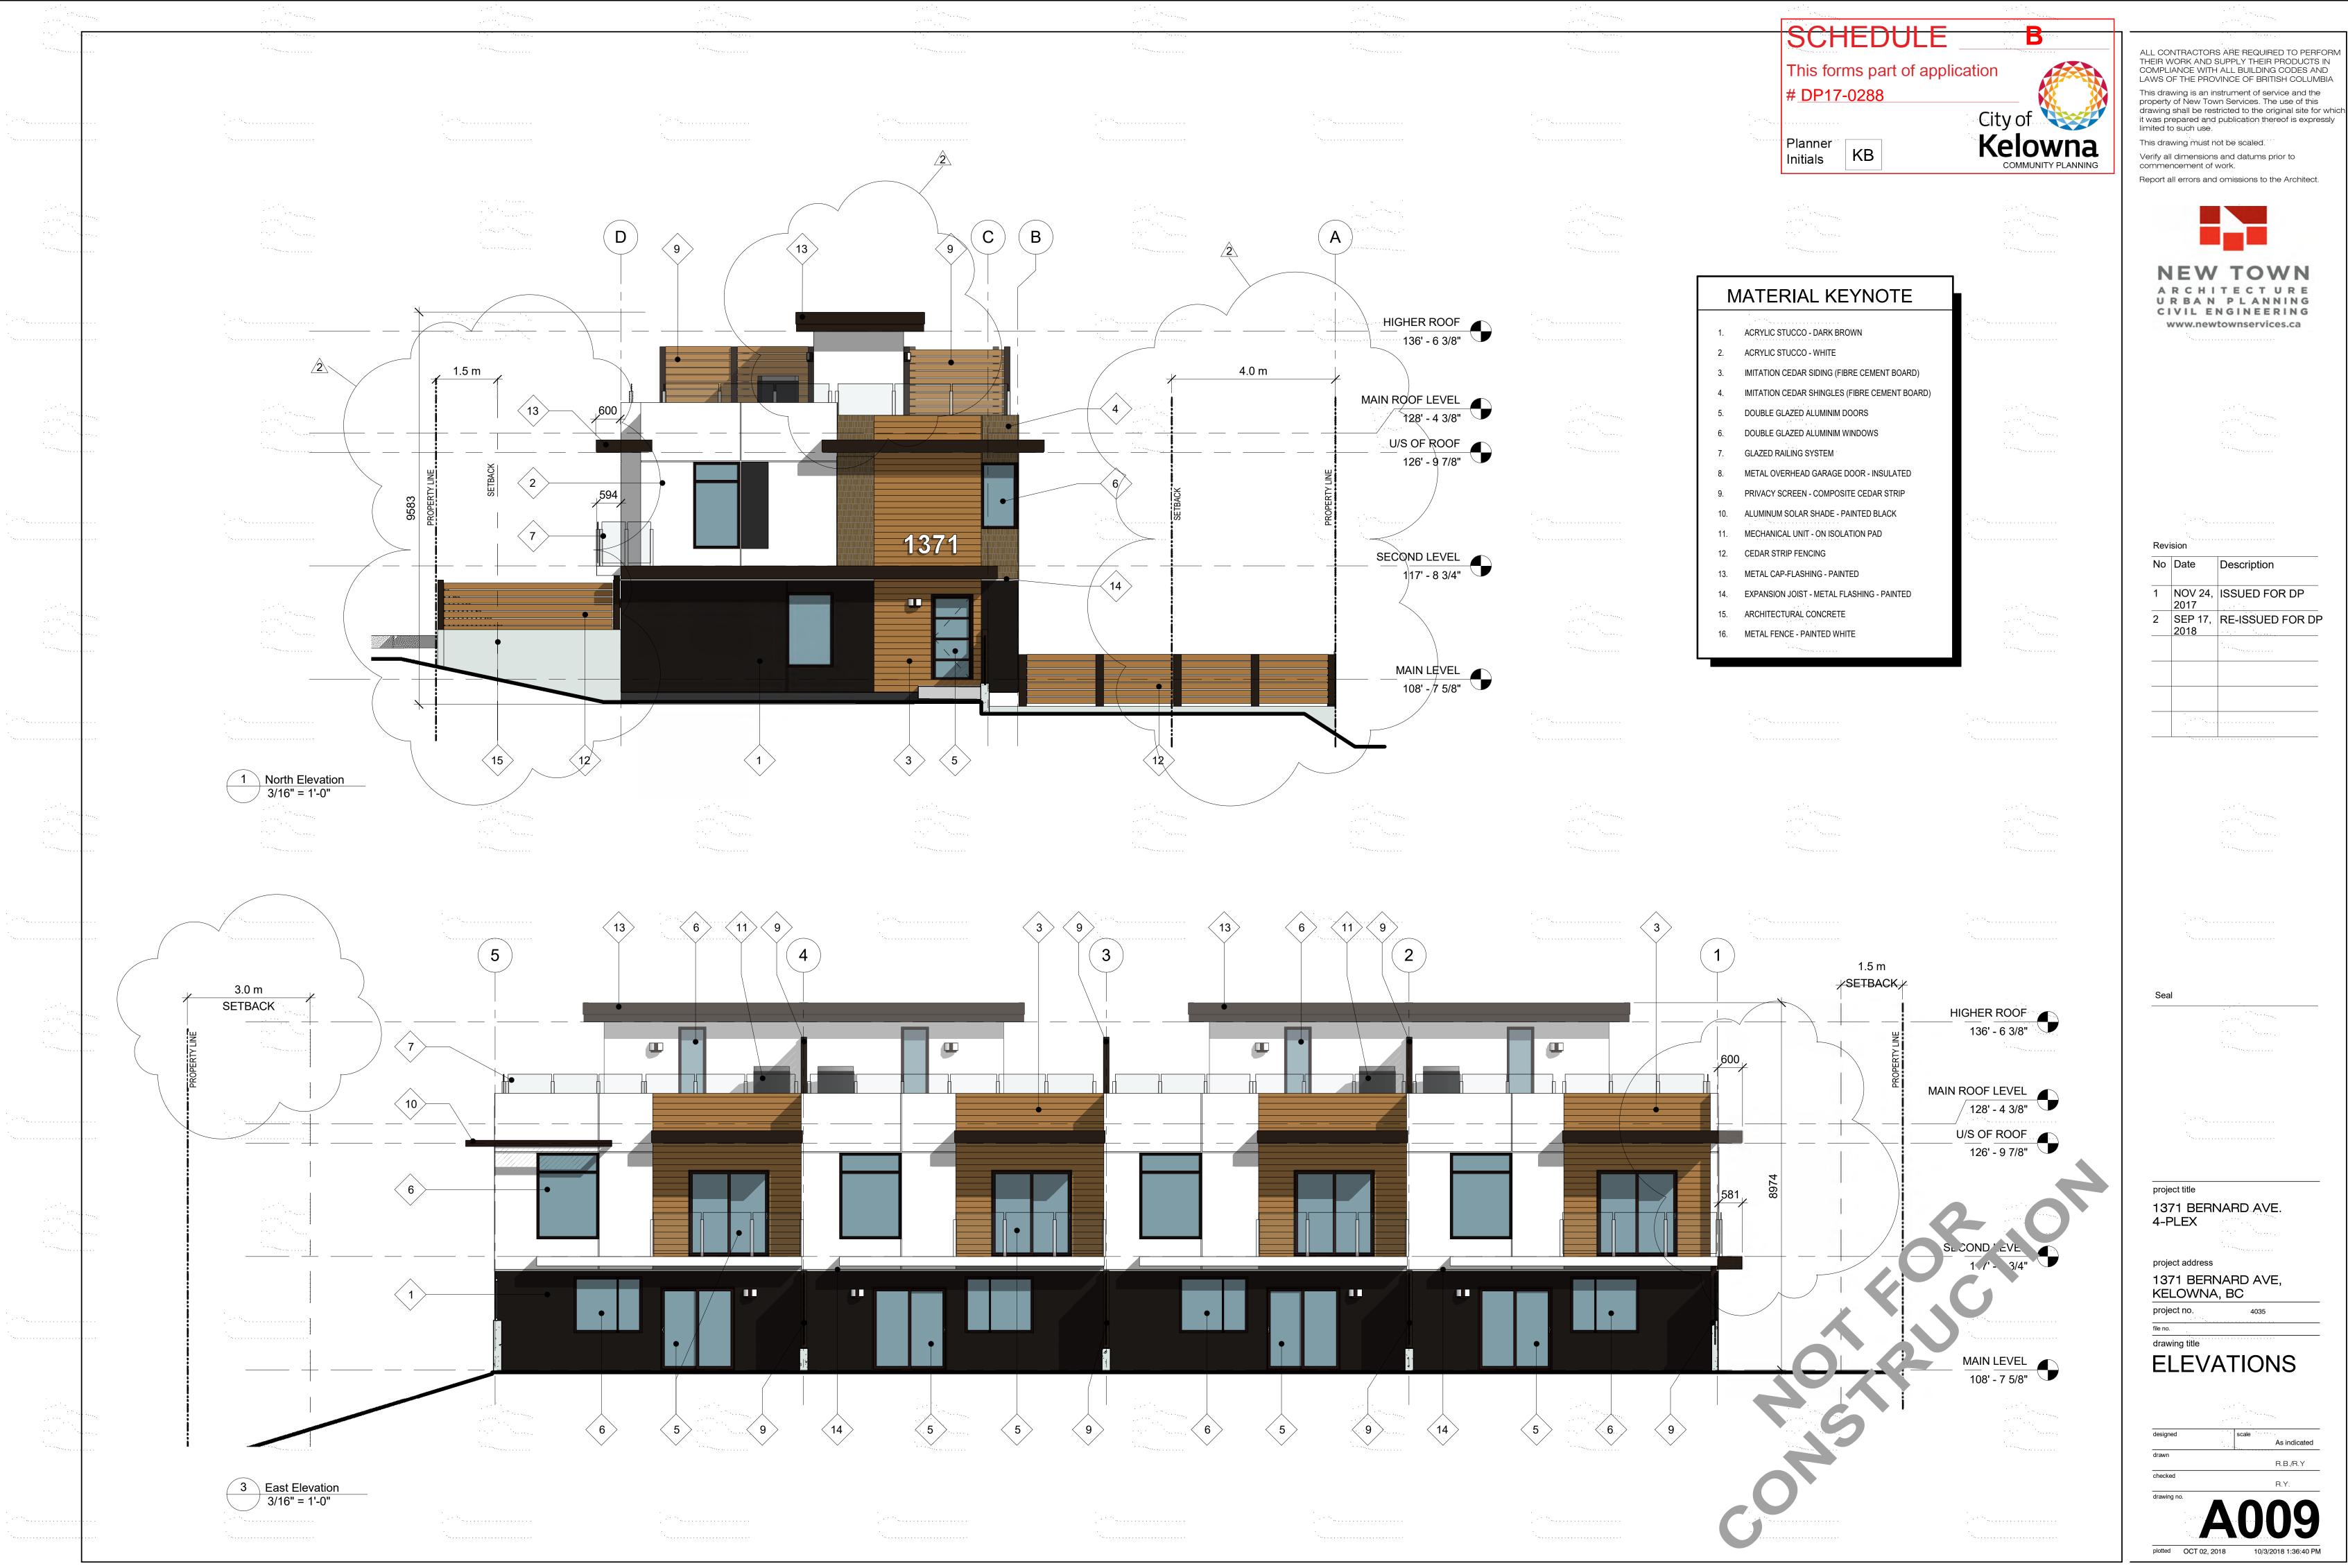

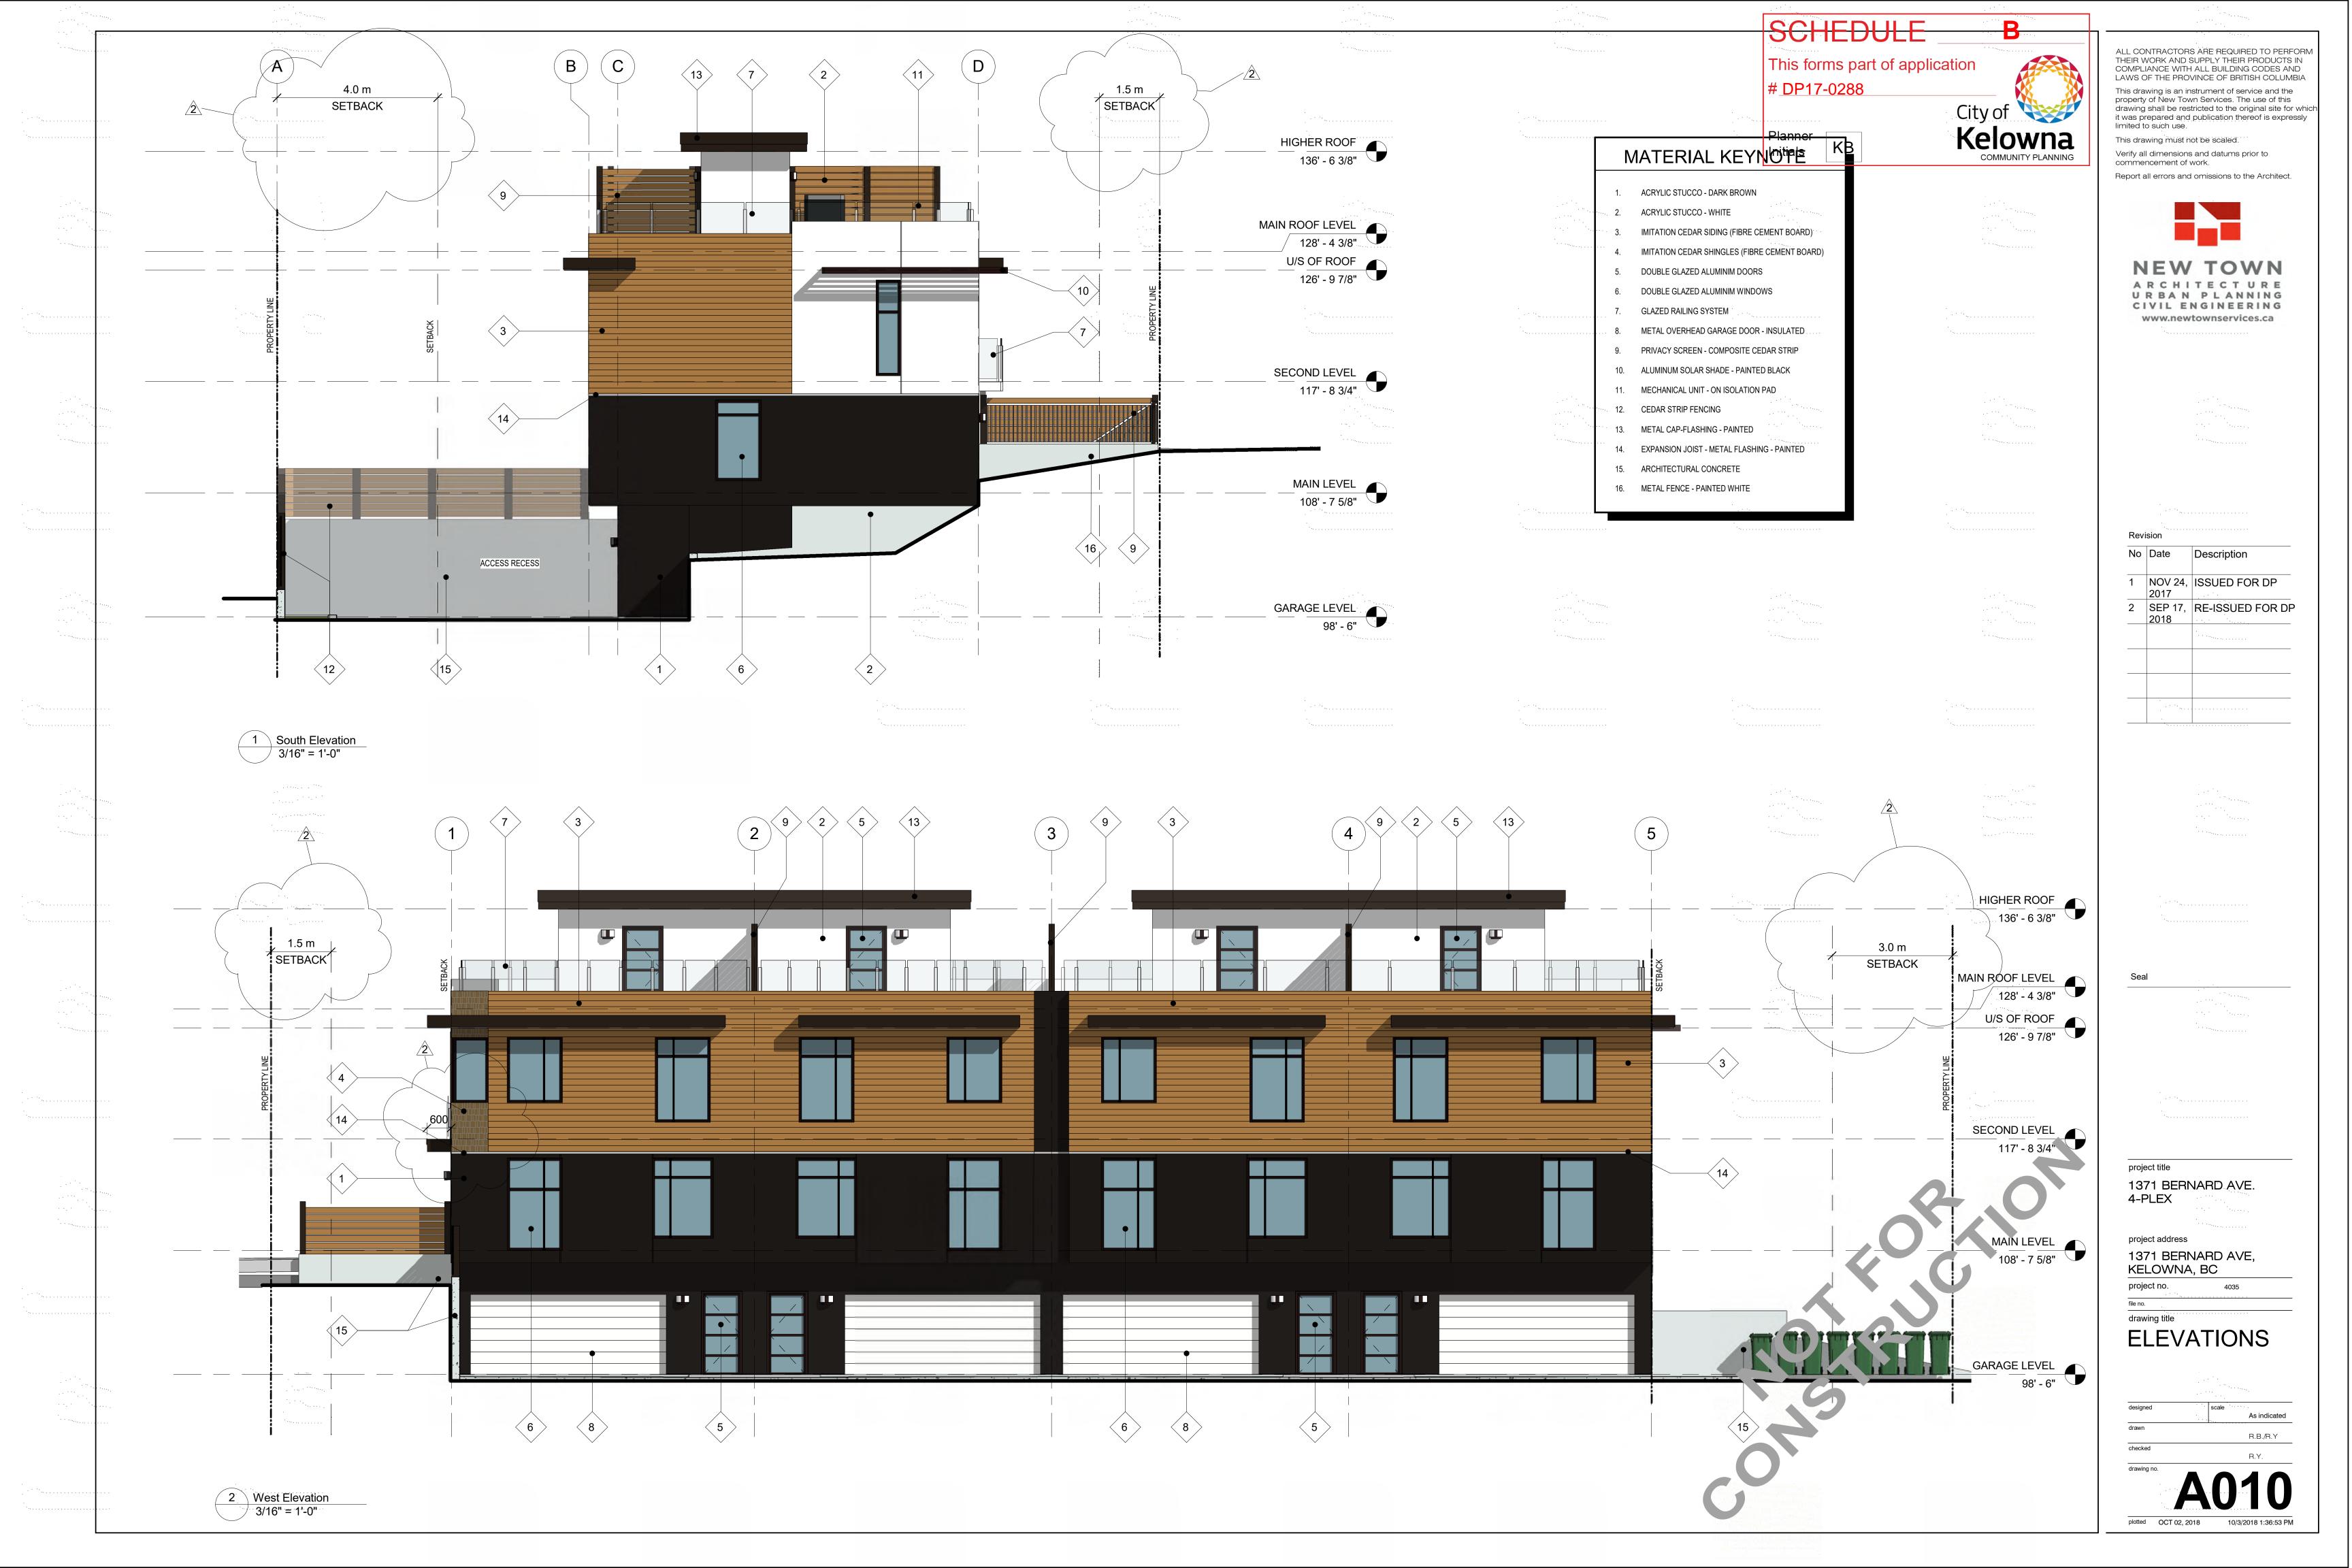

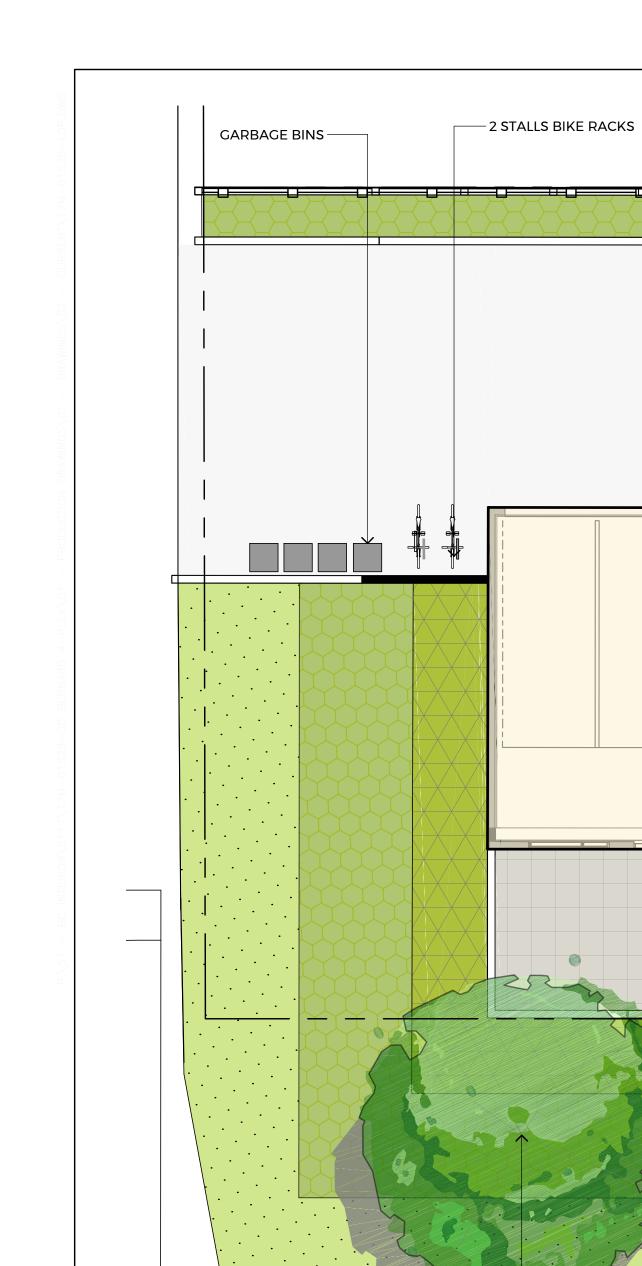



REPRESENTATIVE IMAGES





- CONCRETE STAIR

— 1.2m CONCRETE WALK

— TIMBER PRIVACY SCREEN (BY ARCHITECT)

– 1.2m TIMBER FENCE

- CONCRETE RETAINING WALL (BY STRUCTURAL)

ASPHALT PARKING (BY OTHERS)


PATIO BY ARCHITECT (TYP.)

PROPOSED 4-PLEX

(BY ARCHITECT)





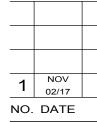

REVISIONS / ISSUED

ISSUED FOR DP DESCRIPTION

PROJECT

Cornus alba 'Bailhalo'

1371 BERNARD AVENUE 4-PLEX


LOCATION KELOWNA, B.C.


CLIENT

— (04) Cercidiphyllum japonicum



LAKEVIEW STREET

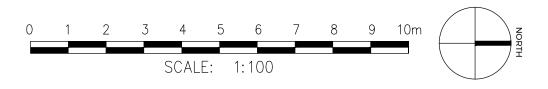

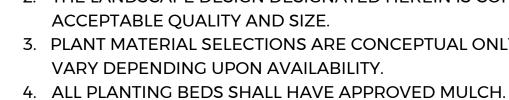

- SYSTEM.

REPRESENTATIVE PLANT	LIST			
BOTANICAL NAME		SIZE	ROOT	Mature Plant Size (Ht.xWd.)
Trees Deciduous				
Cercidiphyllum japonicum	Katsura Tree	6cm Cal	B&B	12.0m x 8.0m
Shrubs / Grasses				
Buxus "Green Gem'	Green Gem Boxwood	#01	Potted	1.0m x 1.0m
Cornus alba 'Bailhalo'	Ivory Halo Dogwood	#01	Potted	1.50m x 1.50m
Euonymus alatus 'Compactus'	Dwarf Burning Bush	#01	Potted	2.0m x 2.0m
Miscanthus sinensis 'Gracillimus'	Maiden Hair	#01	Potted	1.0m x 1.5m
Pennisetum alopecuroides 'Red Head'	Red Head Fountain Grass	#01	Potted	1.2m x 1.2m
Perennials				
Allium 'Globemaster'	Persian Onion		bulb	
Echinacea purpurea 'Magnus'	Magnus Coneflower	#01	Potted	1.0m x 0.75m
Nepeta x fassenii 'Walker's Low'	Walker 's Low Catmint	#01	Potted	0.90m x 0.90m
Rudbeckia hirta 'Indian Summer'	Goldsturm Coneflower	#01	Potted	0.75m x 1.0m

LANDSCAPE DEVELOPMENT DATA:


1. PLANT MATERIALS AND CONSTRUCTION METHODS SHALL CONFORM TO MINIMUM STANDARDS ESTABLISHED IN THE CANADIAN LANDSCAPE STANDARD (CURRENT EDITION). 2. THE LANDSCAPE DESIGN DESIGNATED HEREIN IS CONCEPTUAL BUT REFLECTS THE MINIMUM

3. PLANT MATERIAL SELECTIONS ARE CONCEPTUAL ONLY. FINAL PLANTING SELECTIONS MAY

5. ALL LANDSCAPE AREAS TO BE IRRIGATED WITH AN EFFICIENT AUTOMATIC IRRIGATION

6. THIS DRAWING DEPICTS FORM AND CHARACTER AND IS TO BE USED FOR DEVELOPMENT PERMIT SUBMISSION ONLY. IT IS NOT INTENDED FOR USE AS A CONSTRUCTION DOCUMENT.

SITE PLAN LEGEND:

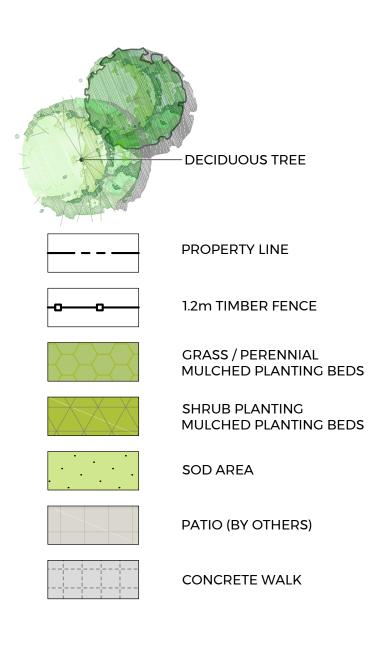



540 Leon Avenue, Kelowna, BC V1Y6J6

DESIGN BY BD DRAWN BY YY CHECKED BY BD PROJECT NO. 17M-01929 SHEET NO. SCALE

SITE PLAN


SHEET TITLE




1 OF 2

t. 250.869.1334, f. 250.862.4849, www.wsp.com

1:100

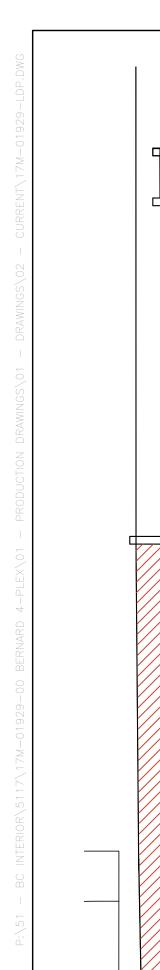

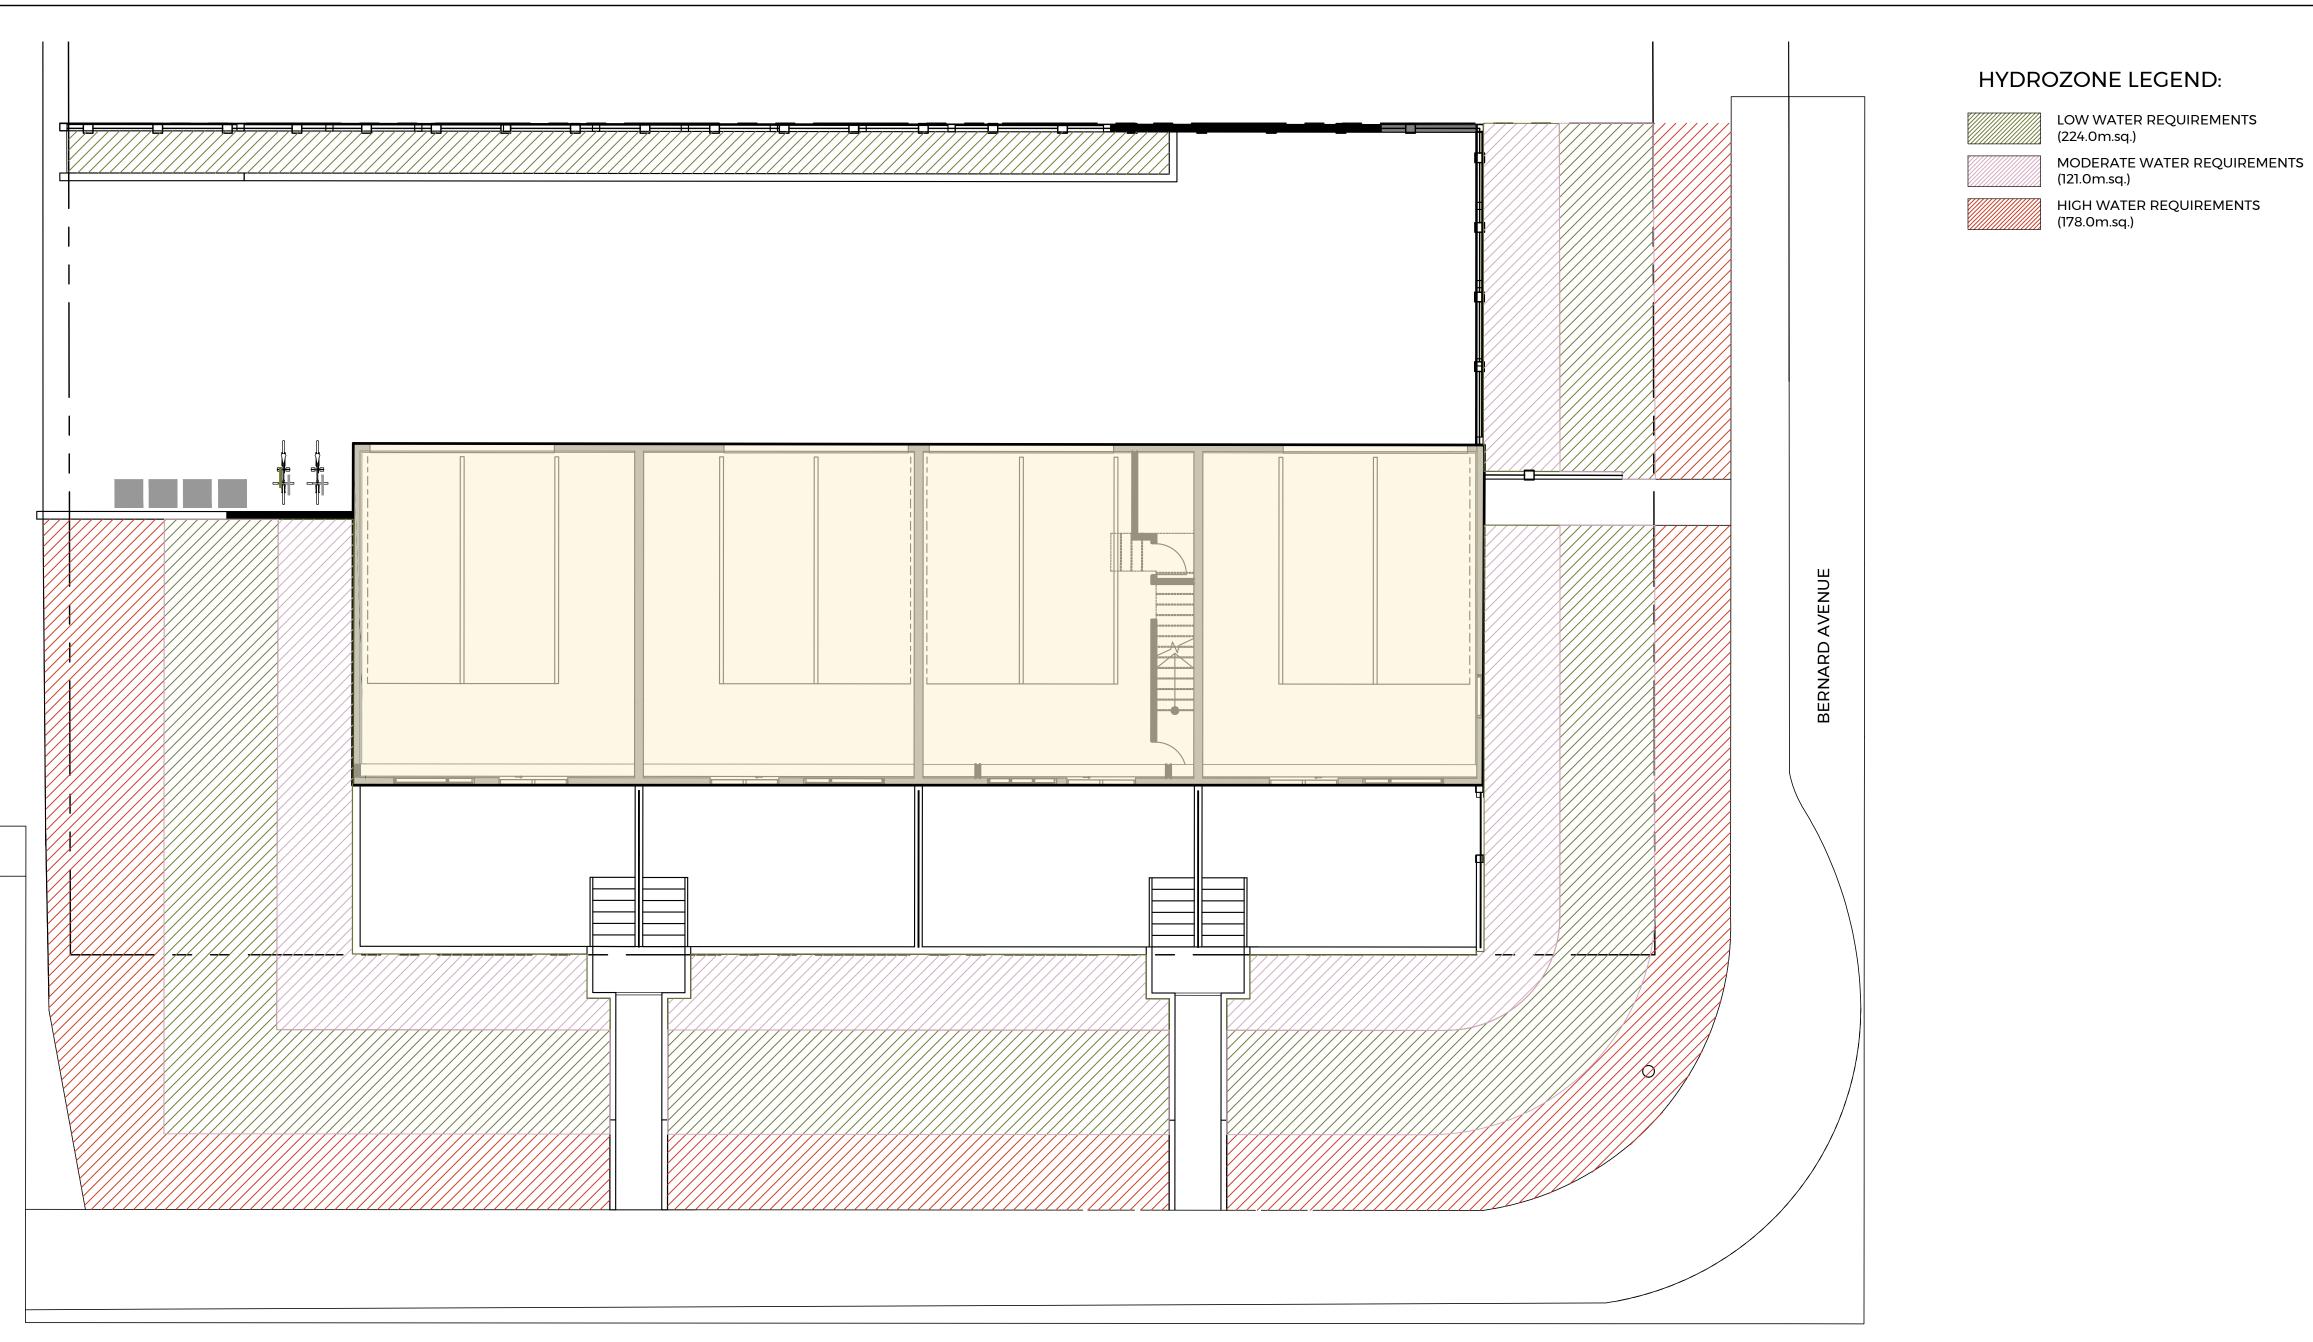





REVISIONS / ISSUED

1 NOV 02/17

NO. DATE


ISSUED FOR DP DESCRIPTION

PROJECT 1371 BERNARD AVENUE 4-PLEX

LOCATION KELOWNA, B.C.

CLIENT



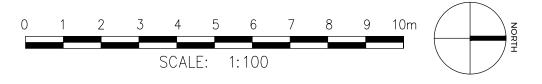





CHECKED BY BD PROJECT NO. 17M-01929 SHEET NO. SCALE 1:100

HYDROZONE PLAN

LDP-2 2 OF 2