CITY OF KELOWNA

MEMORANDUM

Date: August 07, 2018

File No.: DP18-0096

To: Community Planning (AC)

From: Development Engineering Manager (JK)

Subject: 1717 Harvey Ave (REVISED)

ATTACHMENT A

This forms part of application

LUC18-0005
DP18-0096
City of

Planner Initials

AC

Kelowna
COMMUNITY PLANNING

The Development Engineering Department has the following comments and requirements associated with this Development Permit application. The road and utility upgrading requirements outlined in this report will be a requirement of this development. The Development Engineering Technologist for this project is Jason Angus.

1. General.

- a. This Development Permit to convert the old Volkswagen dealership into six commercial retail units with the beginning of a pedestrian path from Harvey to Dickson will be required at Building Permit to complete the following works as laid out in this Engineering Memo:
 - i. Frontage Improvements on Harvey Ave
 - ii. Water service upgrade
 - iii. Sanitary service upgrade
- b. The discharge of the land use contract from the subject property does not compromise any City of Kelowna municipal infrastructure.
- c. Provide easements as may be required

2. Domestic Water and Fire Protection

a. Provide an adequately sized domestic water and fire protection system complete with individual lot connections. The water system must be capable of supplying domestic and fire flow demands of the project in accordance with the Subdivision, Development & Servicing Bylaw. Provide water calculations for this property to confirm this. Ensure every building site is located at an elevation that ensures water pressure is within the bylaw pressure limits.

3. Sanitary Sewer

a. Our records indicate that this property is currently serviced with a 150mm-diameter sanitary sewer service. The applicant's consulting mechanical engineer will determine the requirements of the proposed development and establish the service needs. Only one service will be permitted for this development. If required, the applicant will arrange for the removal and disconnection of the existing service and the installation of one new service at the applicant's cost.



4. Drainage

a. Provide a detailed Storm Water Management Plan for this development as per the Subdivision, Development and Servicing Bylaw #7900.

5. Road Improvements

a. Harvey Ave and the access road must be upgraded to an urban standard along the full frontage of this proposed development, including curb and gutter, sidewalk, drainage system including catch basins, manholes and pavement removal and replacement, street lighting and re-location or adjustment of utility appurtenances if required to accommodate the upgrading construction.

6. Development Permit and Site Related Issues

- a. By Registered plan to provide the following
 - i. Grant statutory rights-of-way if required for utility services and/or pedestrian access.
 - ii. Road dedication is needed for the right-in and right-out of the highway frontage lane. This will be deferred until a major development is proposed on the property or consolidation of 1717 Harvey Ave and 164-1710 Dickson Ave.

7. Power and Telecommunication Services and Street Lights

- a. All proposed distribution and service connections are to be installed underground. Existing distribution and service connections, on that portion of a road immediately adjacent to the site, are to be relocated and installed underground.
- b. Streetlights must be installed on all roads.
- c. Make servicing applications to the respective Power and Telecommunication utility companies. The utility companies are required to obtain the City's approval before commencing construction.
- d. Remove existing poles and utilities, where necessary. Remove aerial trespass (es)

8. Design and Construction

- a. Design, construction supervision and inspection of all off-site civil works and site servicing must be performed by a Consulting Civil Engineer and all such work is subject to the approval of the City Engineer. Drawings must conform to City standards and requirements.
- b. Engineering drawing submissions are to be in accordance with the City's "Engineering Drawing Submission Requirements" Policy. Please note the number of sets and drawings required for submissions.
- c. Quality Control and Assurance Plans must be provided in accordance with the Subdivision, Development & Servicing Bylaw No. 7900 (refer to Part 5 and Schedule 3).
- d. A "Consulting Engineering Confirmation Letter" (City document 'C') must be completed prior to submission of any designs.

e. Before any construction related to the requirements of this subdivision application commences, design drawings prepared by a professional engineer must be submitted to the City's Development Engineering Department. The design drawings must first be "Issued for Construction" by the City Engineer. On examination of design drawings, it may be determined that rights-of-way are required for current or future needs

9. Servicing Agreements for Works and Services

- a. A Servicing Agreement is required for all offsite works and services on City lands in accordance with the Subdivision, Development & Servicing Bylaw No. 7900. The applicant's Engineer, prior to preparation of Servicing Agreements, must provide adequate drawings and estimates for the required works. The Servicing Agreement must be in the form as described in Schedule 2 of the bylaw.
- b. Part 3, "Security for Works and Services", of the Bylaw, describes the Bonding and Insurance requirements of the Owner. The liability limit is not to be less than \$5,000,000 and the City is to be named on the insurance policy as an additional insured.

10. Bonding and Levy Summary

a. Bonding

To be Determined

James Kay, P. Eng.

Development Engineering Manager

JA



Development Permit DP18-0096



This permit relates to land in the City of Kelowna municipally known as

1717 Harvey Avenue

and legally known as

Lot B, District Lot 129, Plan KAP68674

and permits the land to be used for the following development: Retail Commercial and Resturant

The present owner and any subsequent owner of the above described land must comply with any attached terms and conditions.

Date of Decision:

<u>Decision By:</u> CITY COUNCIL OR UP

Issued Date:

<u>Development Permit Area:</u> (N/A for DVP's)

This permit will not be valid if development has not commenced by August 27, 2019.

Existing Zone: C10 – Service Commercial Future Land Use Designation: MXR – Mixed Use (Residential / Commercial)

This is NOT a Building Permit.

In addition to your Development Permit, a Building Permit may be required prior to any work commencing. For further information, contact the City of Kelowna, Development Services Branch.

NOTICE

This permit does not relieve the owner or the owner's authorized agent from full compliance with the requirements of any federal, provincial or other municipal legislation, or the terms and conditions of any easement, covenant, building scheme or agreement affecting the building or land.

Owner: Al Stober Construction Ltd	
Applicant: Meiklejohn Architects	
Ryan Smith	Date:
Community Planning Department Manager	
Community Planning & Strategic Investments	

1. SCOPE OF APPROVAL

This Development Permit applies to and only to those lands within the Municipality as described above, and any and all buildings, structures and other development thereon.

This Development Permit is issued subject to compliance with all of the Bylaws of the Municipality applicable thereto, except as specifically varied or supplemented by this permit, noted in the Terms and Conditions below.

The issuance of a permit limits the permit holder to be in strict compliance with regulations of the Zoning Bylaw and all other Bylaws unless specific variances have been authorized by the Development Permit. No implied variances from bylaw provisions shall be granted by virtue of drawing notations that are inconsistent with bylaw provisions and that may not have been identified as required Variances by the applicant or Municipal staff.

2. CONDITIONS OF APPROVAL

- a) The dimensions and siting of the building to be constructed on the land be in accordance with Schedule "A";
- b) The exterior design and finish of the building to be constructed on the land be in accordance with Schedule "B";
- c) Landscaping to be provided on the land be in accordance with Schedule "C"; and
- d) The applicant be required to post with the City a Landscape Performance Security deposit in the form of a "Letter of Credit" in the amount of 125% of the estimated value of the landscaping, as determined by a Registered Landscape Architect.

This Development Permit is valid for two (2) years from the date of August 27, 2017 approval, with no opportunity to extend.

3. PERFORMANCE SECURITY

As a condition of the issuance of this Permit, Council is holding the security set out below to ensure that development is carried out in accordance with the terms and conditions of this Permit. Should any interest be earned upon the security, it shall accrue to the Developer and be paid to the Developer or his or her designate if the security is returned. The condition of the posting of the security is that should the Developer fail to carry out the development hereby authorized, according to the terms and conditions of this Permit within the time provided, the Municipality may use enter into an agreement with the property owner of the day to have the work carried out, and any surplus shall be paid over to the property own of the day. Should the Developer carry out the development permitted by this Permit within the time set out above, the security shall be returned to the Developer or his or her designate. There is filed accordingly:

a) An Irrevocable Letter of Credit in the amount of \$174,300.00

Before any bond or security required under this Permit is reduced or released, the Developer will provide the City with a statutory declaration certifying that all labour, material, workers' compensation and other taxes and costs have been paid.

4. INDEMNIFICATION

Upon commencement of the works authorized by this Permit the Developer covenants and agrees to save harmless and effectually indemnify the Municipality against:

a) All actions and proceedings, costs, damages, expenses, claims, and demands whatsoever and by whomsoever brought, by reason of the Municipality said Permit.

All costs, expenses, claims that may be incurred by the Municipality where the construction, engineering or other types of works as called for by the Permit results in damages to any property owned in whole or in part by the Municipality or which the Municipality by duty or custom is obliged, directly or indirectly in any way or to any degree, to construct, repair, or maintain.

The PERMIT HOLDER is the <u>CURRENT LAND OWNER</u>. Security shall <u>ONLY</u> be returned to the signatory of the Landscape Agreement or their designates. Re: Development Permit Submission

Design Rationale – 1717 Harvey Ave.

April 11,2018

The latest addition to the Landmark Town Centre is going to be the development of the Landmark District Market. The design will provide for 6 new retail tenants that will create amenities to the Landmark area. It was an intentional decision to re-purpose the existing building in order give the area a more small scale pedestrian friendly experience.

Architectural Design

The building will be divided into smaller tenancies with the introduction of storefront openings along the east side of the building. The use of awnings and sign carriers will assist in defining the individual spaces. The north side of the building will remain relatively intact with paint and signage being applied. The intent is to give the project a bit of a warehouse/industrial character. The windows and storefronts will be introduced using black aluminium. Prominent architectural sign carriers that are positioned away from the building face will help to shield the past use and introduce a new focus to the building. The west side will be used to create a green pedestrian connection to the south side of the building. Two retail patio areas will be located on the south side and are anticipated that they will become perfect seasonal opportunity for the tenants.

Landscape Design

Because we are creating a pedestrian friendly realm, the landscape will include the introduction of walkways and patios all around the building that are intended to animate the space more effectively. This will include a mixture of materials including cast in place concrete, brick pavers and street furniture and trees. The greening up and reconfiguration of the existing parking lot will serve to diminish the importance of the car and emphasize the importance of the pedestrian. We are creating this as a walkable amenity for the tenants of the Landmark area.

Conclusion

In summary we feel that this unstructured design approach with a well design public realm and appropriately detailed storefronts will be a welcome evolution to one of Kelowna's premier urban neighbourhoods.







#<u>LUC18-0005</u> DP18-0096

Planner Initials





SC m+m a








1717 Harvey Ave



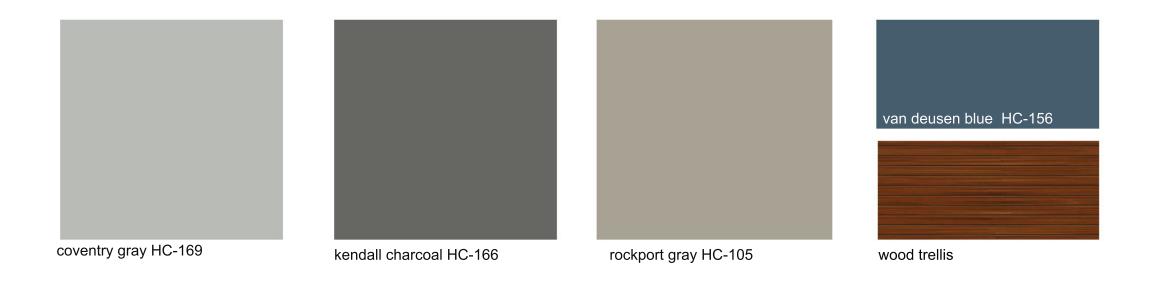





TURNER VOLKSWAGEN	T		
ADDRESS	1717 HARVEY AVE		
LEGAL DESCRIPTION	LOTS B&C, PLAN KAP68674 AND LOT 2, PLAN 25004		
DEVELOPMENT PERMIT AREA	N/A		
EXISTING ZONING	C10		
EXISTING LEGAL USE	AUTO DEALERSHIP		
GRADES	EXISTING AVERAGE - LEVEL	FINISH AVERAGE - LEVEL	
NUMBER OF BUILDINGS	1 STOREY COMMERCIAL BUILDING	j 	
CRITERIA FOR ALL TYPES OF APPLICATION:	C10 SERVICE COMMERC	CIAL	
	ZONING STANDARD	PROPOSAL	
SITE AREA (sm)	1000	±4026	
SITE WIDTH (m)	30	±76	
SITE DEPTH (m)	30	±51.6	
PARKING			
OFF-STREET PARKING	60 stalls min. (see parking calcs)	±60 stalls (EXIST.)	
HEIGHT OF BUILDING (S)/# OF STOREYS	12.0 m/ 3 storeys	±5.5 m/ 1 storey	
COVERAGE SITE COVERAGE OF BUILDING(S) (%)	60% MAX.	±1280/ ±4026 = ±31.8%	
SITE COVERAGE INCLUDING BUILDINGS, DRIVEWAYS AND PARKING (%)	N/A	N/A	
ADDITIONAL REQUIREMENTS FOR COMMERCIAL, INDUSTRIAL AND MULTIPLE UNIT / INTENSIVE RESIDENTIAL APPLICATIONS:	C10 SERVICE COMMERC	DIAL PROPOSAL	
NUMBER OF BICYCLE PARKING SPACES (COMMERCIAL)	Class I: 0.2 per 100sm x 1280sm Total = 3 bikes min.	Class I: 3 stall bike rack (confirm with tenants)	
	Class II: 0.6 per 100sm x 1280sm Total = 8 bikes min.	Class II: 8 stall bike racks (see site plan)	
NUMBER OF LOADING SPACES	1/ 1900sm = 1 space min	min 1 space (see site plan)	
DRIVE AISLE WIDTH (m) (IF PROPOSED)	7.0m	±7.0m (exist.)	
SETBACKS TO PARKING (m):			
NORTH (FRONT)	3.0m	±2.0m (exist.)	
SOUTH (REAR)	N/A	N/A	
WEST (SIDE)	N/A	N/A	
EAST (SIDE)	N/A	N/A	
FLOOR AREA NET	5,507sm max.	±1280sm	
FAR FLOOR AREA RATIO (F.A.R.)	0.65 MAX.	±1280/ ±4026 = 0,318	
BUILDING (S) SETBACKS (m):			
NORTH (FRONT)	2.0m	±7.58m	
SOUTH (REAR)	0.0m	±3.28m	
WEST (SIDE)	0.0m	±5.88m	
EAST (SIDE)	0.0m	±33.3m	
DAYLIGHT ANGLE (IF A TOWER)	N/A	N/A	
DATEIOTT ANOLE (II A TOWEN)	N/A	N/A	
PODIUM HEIGHT (IF PROPOSED)		. 1877	

PARKING CALCULATIONS									
STALL SIZE	WIE	WIDTH LENGTH HEIGHT P		PARKING RATIO	PARKING RATIO				
							required	proposed	
FULL SIZE STALL	8'-3"	2.5m	19'-8"	6.0m		2.0m	-		
MEDIUM SIZE STALL (40% max)	7'-6"	2.3m	15'-9"	4.8m	6'-6"		24	42 (EXIST.)	
COMPACT SIZE STALL (10% max)	6'-6"	2.0m	11'-2"	3.4m	0-0		2.0m	2.0m	6
DISABLED STALL	12'-2"	3.7m	19'-8"	6.0m			1	2	
DRIVE AISLES (2-way 90° pkg)	23'-0"	7.0m							
PARKING REQUIREMENTS:									
	COMM	1ERCIAL	.:				no of stalls		
	Liquor	Primary	Establis	hment, M	linor:				
	1 per 4	l seats o	f capacit	y x 183 p	pl		46 stalls		
	Retail	Store GF	A less th	nan 1,00	Osm:				
	2 stalls	s/ 100sm	x 660sn	า			14 stalls		
	TOTAL PARKING REQUIRED:			60 stalls					
	TOTAL PARKING PROVIDED:								
	PARK	ING @ G	RADE:				±60 stalls (EXIST.)		



FIRE PROTECTION:		3.2.4./ 3.2.5./ 3.2.6.	
LOCATION OF HYDRANT TO BUILDING ENTRY	90 m MAX.	3.2.5.5.	
STANDPIPE/HOSE	N/A	3.2.5.8.	
SPRINKLERED	N/A		
FIRE ALARM SYSTEM	N/A (CONFIRM ON SITE)	3.2.4.1.(2)(f)	
EXIT LIGHTS	YES		
EMERGENCY LIGHTING	YES		

OCCUPANT LOAD		SEE A201.1
LEVEL 1 (retail):		180 PERSONS
LEVEL 1 (restaurant):		183 PERSONS
	BUILDING TOTAL	363 PERSONS

EXIT FACILITIES		3.1 TO 3.6
REQUIRED EXITS	2 MIN.	
	REQUIRED WIDTHS	PROVIDED WIDTHS
	min. 800mm door width as per 3.4.3.2.(A)	
LEVEL 1 (doors)	6.1mm/ person X 363 persons max.	min.10 doors @ 3'-0"
	= 2,214mm MIN.	width = 30'-0" (9,144 mm)
EXIT THROUGH LOBBY	NO	3.4.4.2.
PANIC HARDWARE REQ'D	yes (at exterior doors - confirm with te	enants) 3.4.6.16.(2)
EXIT EXPOSURE	ok	3.2.3.13.
MAX. TRAVEL DISTANCE	30m (15m for single exit)	3.4.2.5.(1)
EXIT RATINGS REQUIRED:	•	
STAIR SHAFTS	N/A	3.4.4.1.
CORRIDORS	N/A	3.3.2.6.(4)

REQUIRED FIRE SEPARATIONS			3.1.3.1.
TENANTS / MAJOR OCCUPANCIES			
GROUP A2 TO E	2 HR		
SERVICES ROOMS	1 HR	3.6.2.	
JANITOR ROOM	1 HR		

BUILDING FIRE SAFETY				
SOFFIT PROTECTION	N/A	3.2.3.16.		
FLAME SPREAD RATINGS	COMPLY WITH	3.1.13.2		
METAL DECK ASSEMBLIES	N/A	3.1.14.2.		
ROOF COVERING CLASSIFICATION	CLASS "A"	3.1.15.2.		
ATTIC FIRESTOPS	N/A	3.1.11.		
MAX. ATTIC AREA	N/A	3.1.11.5.		
MAX. CRAWLSPACE AREA	N/A	3.1.11.6.		
CONCEALED FLOOR AREA	N/A	3.1.11.5.		

ACCESSIBILITY REQUIREMENTS				
	REQUIRED	PROVIDED		
ACCESS TO MAIN ENTRANCES	YES	YES		
ACCESS TO ALL FLOORS	YES	YES		
ACCESSIBLE WASHROOM	YES	YES		

WASHROOM FIXTURES REQUIREMENTS

WASHROOM REQUIREMENTS TO BE CONFIRMED BY FUTURE TENANTS AS PART OF THEIR LEASEHOLD IMPROVEMENTS PERMIT APPLICATION (N.I.C.)

BUILDING CODE REVIEW					
OCCUPANCY	GROUP A2	GROUP D	GROUP E	GROUP F2	
ARTICLE	3.2.2.25	3.2.2.58	3.2.2.64	3.2.2.74	
NO. OF STOREYS	1 STOREY	1 STOREY	1 STOREY	1 STOREY	
NO. OF STREETS FACING	2	2	2	2	
MAX. BUILDING AREA	PROPOSED		CODE MAXIMUM		
	±13,680 (±1,280sm)		1,500 sm (3.2.2.64.(1))		
CONSTRUCTION TYPE	COMBUSTIBLE / NON-COMBUST.				
SPRINKLERED	NO	NO			
ASSEMBLY RATINGS:					
FLOOR	N/A				
WALLS/ BEARING STRUCTURE	45 MINUTES				
ROOFS	45 MINUTES				

SPATIAL SEPARATION:			3.2.3.1.C
	NORTH (FRONT) & EAST WALL	WEST WALL	SOUTH WALL
WALL AREA	WINDOW OPENINGS & WALL CONSTRUCTION	±152.2sm	±89.4sm
OPENING AREA		±10.7sm	±13.3sm
% PROVIDED	UN-RESTRICTED. LIMITING DISTANCES	±7.1%	±14.9%
LIMITING DISTANCE	EXCEED 9.0m, OR BLDG	5.88m	3.28m
% PERMITTED	FACES A STREET IN ACCORDANCE WITH	±25%	±15.5%
CONSTRUCTION TYPE	3.2.3.10	Combust.	Combust.
CLADDING MATERIAL		Non combust.	Non combust.
REQUIRED RATINGS		45 MINUTES	1 HOUR

BUILDING FLOOR AREAS				
	GFA (±sf)	GFA (±sm)		
LEVEL 1	13,680	1,280		
BUILDING FOOTPRINT FOR SITE COVERAGE	13,680	1,280		
TOTAL FLOOR AREA FOR FAR	13,680	1,280		
(SEE A201.1 FOR LEASE AREA)				

233 BERNARD AVENUE KELOWNA, B.C. VIY 6N2 TEL: 250.762.3004 EMAIL: kel-mai@shaw.ca



2018-04-10



Copyright reserved. This plan and design is and at all times remains the exclusive property of Meiklejohn Architects Inc. and may not be used without the Architects' consent.

01 2018-04-10 issued DP

EXISTING BUILDING FACADE UPGRADE

1717 HARVEY AVE KELOWNA V1Y 6G3

LOT B DL 129 ODYD PLAN KAP68674

A2.01


DRAWINGS ARE NOT TO BE SCALED. ALL DIMENSIONS SHALL BE VERIFIED ON JOB

Drawing Title

ZONING & CODE SUMMARY

20'=12"

2018-04-10 m+m 17-1786 AS SHOWN Drawn Checked

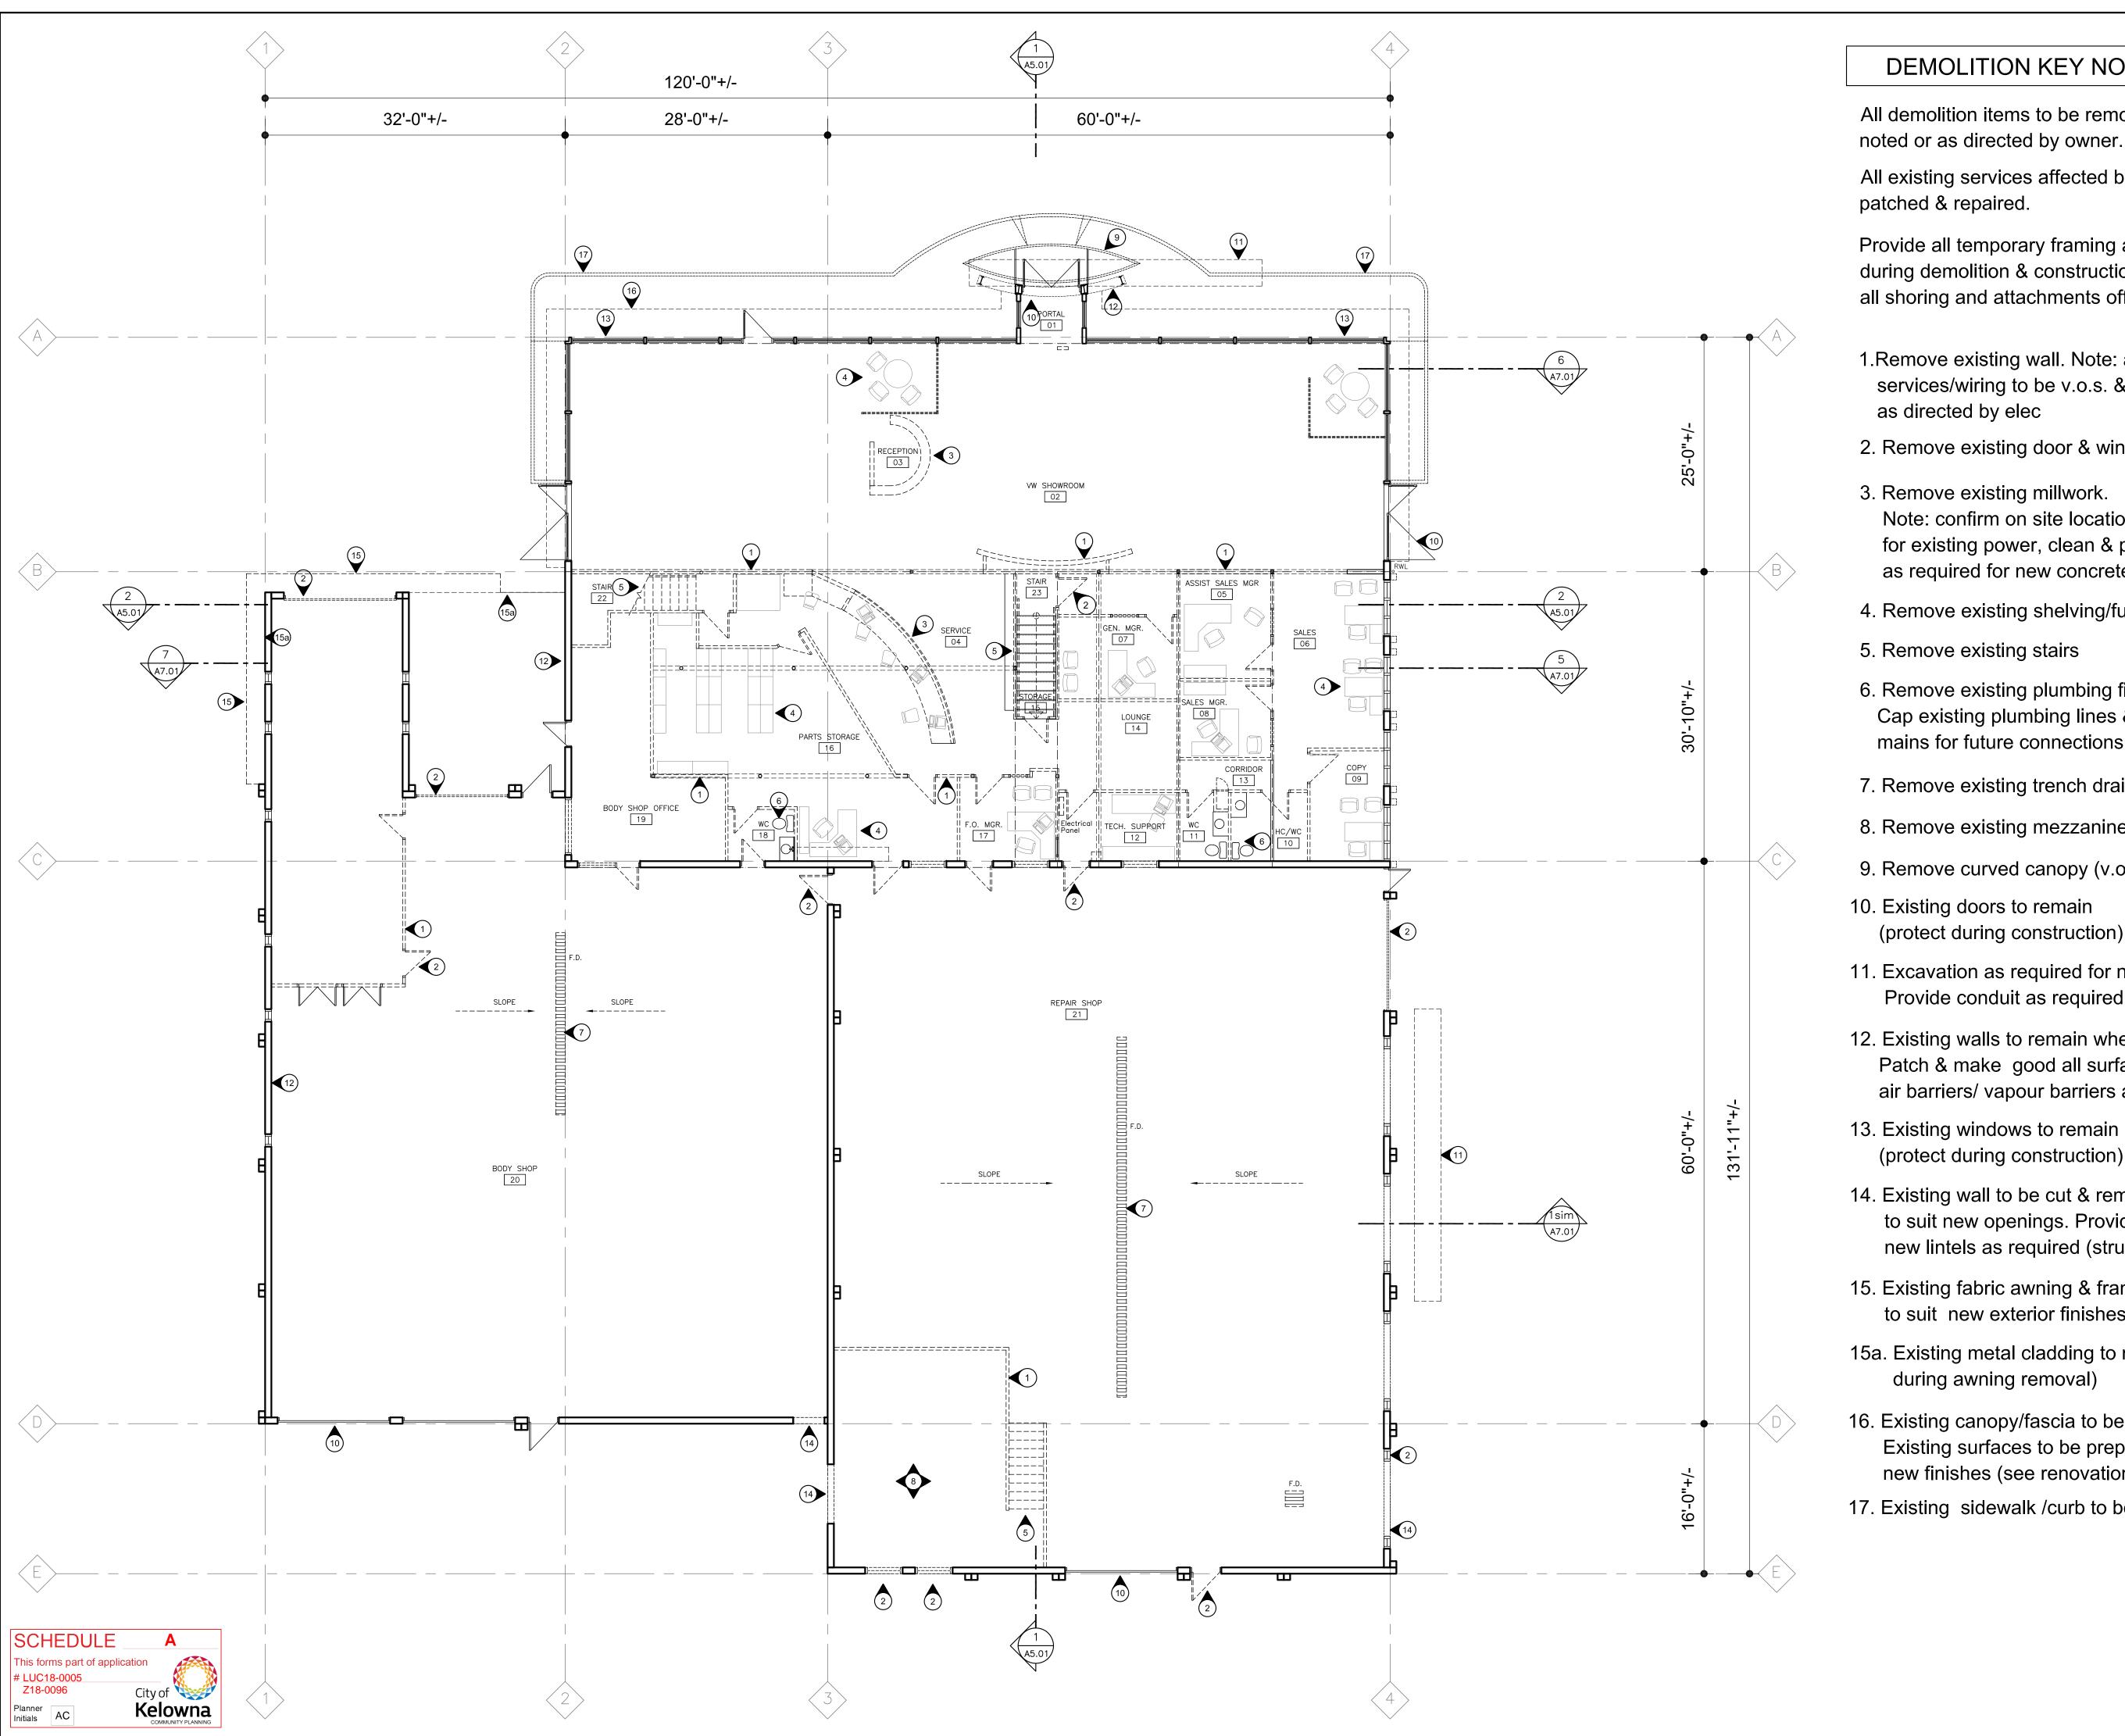

DEMOLITION KEY NOTE LEGEND:

KELOWNA, B.C. TEL: 250.762.3004 EMAIL: kel-mai@shaw.ca

All demolition items to be removed from site unless

All existing services affected by new construction to be patched & repaired.

Provide all temporary framing and support/shoring during demolition & construction. Remove and dispose all shoring and attachments off site upon completion.

- 1.Remove existing wall. Note: all existing services/wiring to be v.o.s. & capped/relocated as directed by elec
- 2. Remove existing door & window.
- 3. Remove existing millwork. Note: confirm on site locations of existing trenches for existing power, clean & prepare trenches as required for new concrete fill.
- 4. Remove existing shelving/furniture where applicable
- 5. Remove existing stairs
- 6. Remove existing plumbing fixtures. Cap existing plumbing lines & locate existing mains for future connections
- 7. Remove existing trench drain.
- 8. Remove existing mezzanine framing & sheathing
- 9. Remove curved canopy (v.o.s.)
- 10. Existing doors to remain (protect during construction)
- 11. Excavation as required for new exterior screens. Provide conduit as required for lighting.
- 12. Existing walls to remain where applicable. Patch & make good all surfaces & ensure all air barriers/ vapour barriers are sealed
- 13. Existing windows to remain (protect during construction)
- 14. Existing wall to be cut & removed as required to suit new openings. Provide shoring & new lintels as required (struct. to review on site)
- 15. Existing fabric awning & framing to be removed to suit new exterior finishes.
- 15a. Existing metal cladding to remain (protect during awning removal)
- 16. Existing canopy/fascia to be retained. Existing surfaces to be prepared for new finishes (see renovation elevations)
- 17. Existing sidewalk /curb to be removed.

2018-04-10

DP



at all times remains the exclusive property of Meiklejohn Architects Inc. and may not be used without the Architects' consent.

01 | 2018-04-10 | issued DP

EXISTING BUILDING FACADE UPGRADE


1717 HARVEY AVE KELOWNA V1Y 6G3 LOT B DL 129 ODYD PLAN KAP68674

A3.01


DRAWINGS ARE NOT TO BE SCALED. ALL DIMENSIONS SHALL BE VERIFIED ON JOB

MAIN FLOOR **DEMOLITION**

1/8"=1'0"

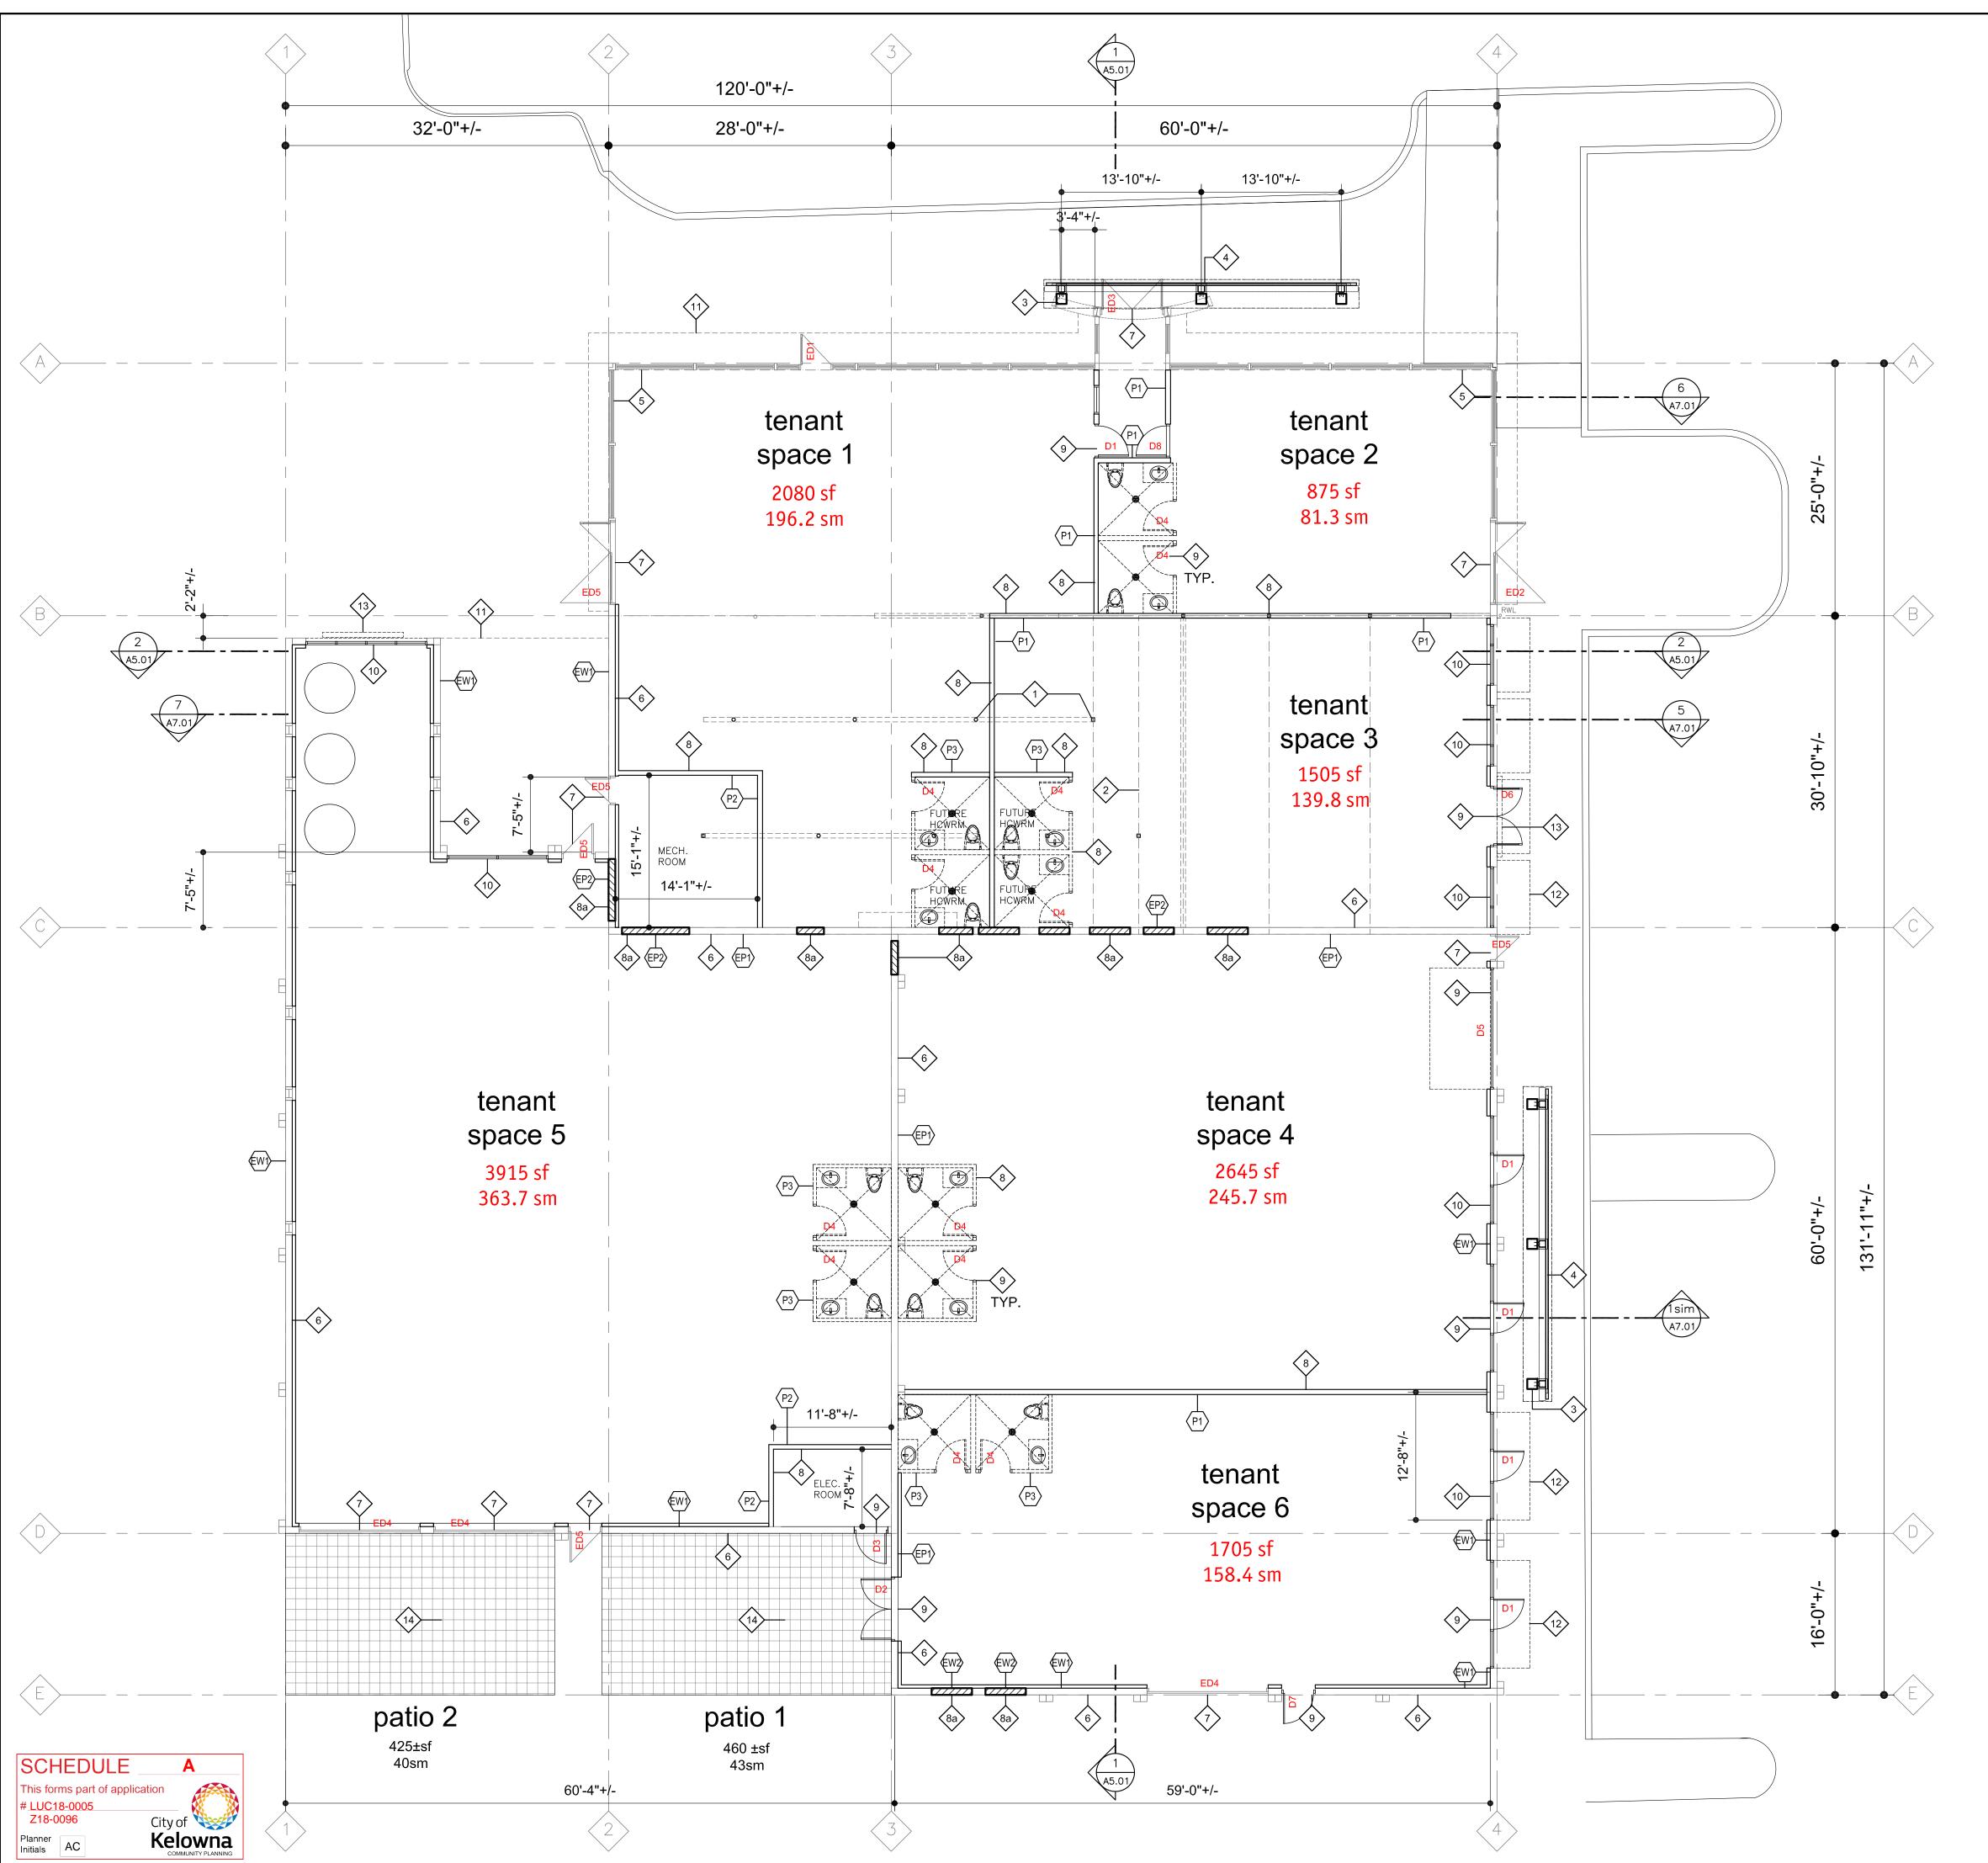

RENOVATION KEY NOTE LEGEND: -

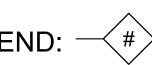

- 1. EXISTING COLUMN (V.O.S.)

 NOTE: ALL EXPOSED COLUMNS TO HAVE 1 HR RATED

 GWB ENCLOSURE (SEE WALL TYPES)
- 2. EXISTING BEAM (V.O.S.)
- 3. NEW CONC. PIERS FOR NEW TRELLIS (SEE DETAILS / STRUCT.)
- 4. NEW WOOD/ STEEL TRELLIS/ SCREEN (SEE DETAILS)
- 5. EXISTING WINDOW TO REMAIN, PROTECT DURING CONSTRUCTION & CLEAN ALL SURFACE AT COMPLETION OF WORK
- 6. EXISTING WALL TO REMAIN. PATCH & MAKE GOOD ALL SURFACES/ FINISHES
- 7. EXISTING DOOR TO REMAIN. PATCH & MAKE GOOD ALL SURFACES/ FINISHES. CLEAR ALL SURFACES AFTER CONSTRUCTION COMPLETION. CONDITION OF EXIST. HARDWARE TO BE SITE REVIEWED & REPLACED WITH NEW HARDWARE WHERE REQUIRED
- 8. NEW PARTITION WALL (SEE WALL ASSEMBLY TYPES)
- 8a. NEW INFILL WALL TO MATCH EXIST WALL THICKNESS & MATERIAL TYPES (V.O.S.)
- 9. NEW DOOR (SEE DOOR SCHEDULE)
- 10. NEW WINDOW (SEE WINDOW SCHEDULE)
- 11. EXISTING CANOPY ABOVE
- 12. NEW FABRIC AWNING SCREWED TO EXIST. WALL (CONFIRM ANCHOR DETAILS WITH AWNING MANUF. PROVIDE ENG. SHOP DWGS.)
- 13. CANOPY / SIGN BOX ABOVE (SEE DETAILS)
- 14. NEW C.I.P. CONC. PATIO(TO BE CONFIRMED BY TENANTS)

233 BERNARD AVENUE KELOWNA, B.C. VIY 6N2 TEL: 250.762.3004 EMAIL: kel-mai@shaw.ca



2018-04-10 **DP**



Copyright reserved. This plan and design is and at all times remains the exclusive property of Meiklejohn Architects Inc. and may not be used without the Architects' consent.

 No.
 Date
 Rev

 01
 2018-04-10
 issued DP

2010-04-10 Issued bi

EXISTING BUILDING FACADE UPGRADE

1717 HARVEY AVE KELOWNA V1Y 6G3 LOT B DL 129 ODYD PLAN KAP68674

Drawing Number


A3.02

DRAWINGS ARE NOT TO BE SCALED. ALL DIMENSIONS SHALL BE VERIFIED ON JOB

MAIN FLOOR RENOVATIONS

1/8"=1'0"

Date	2018-04-10	
Job No.	m+m 17-1786	
Scale	AS SHOWN	
Drawn	SN	
Checked	JM	

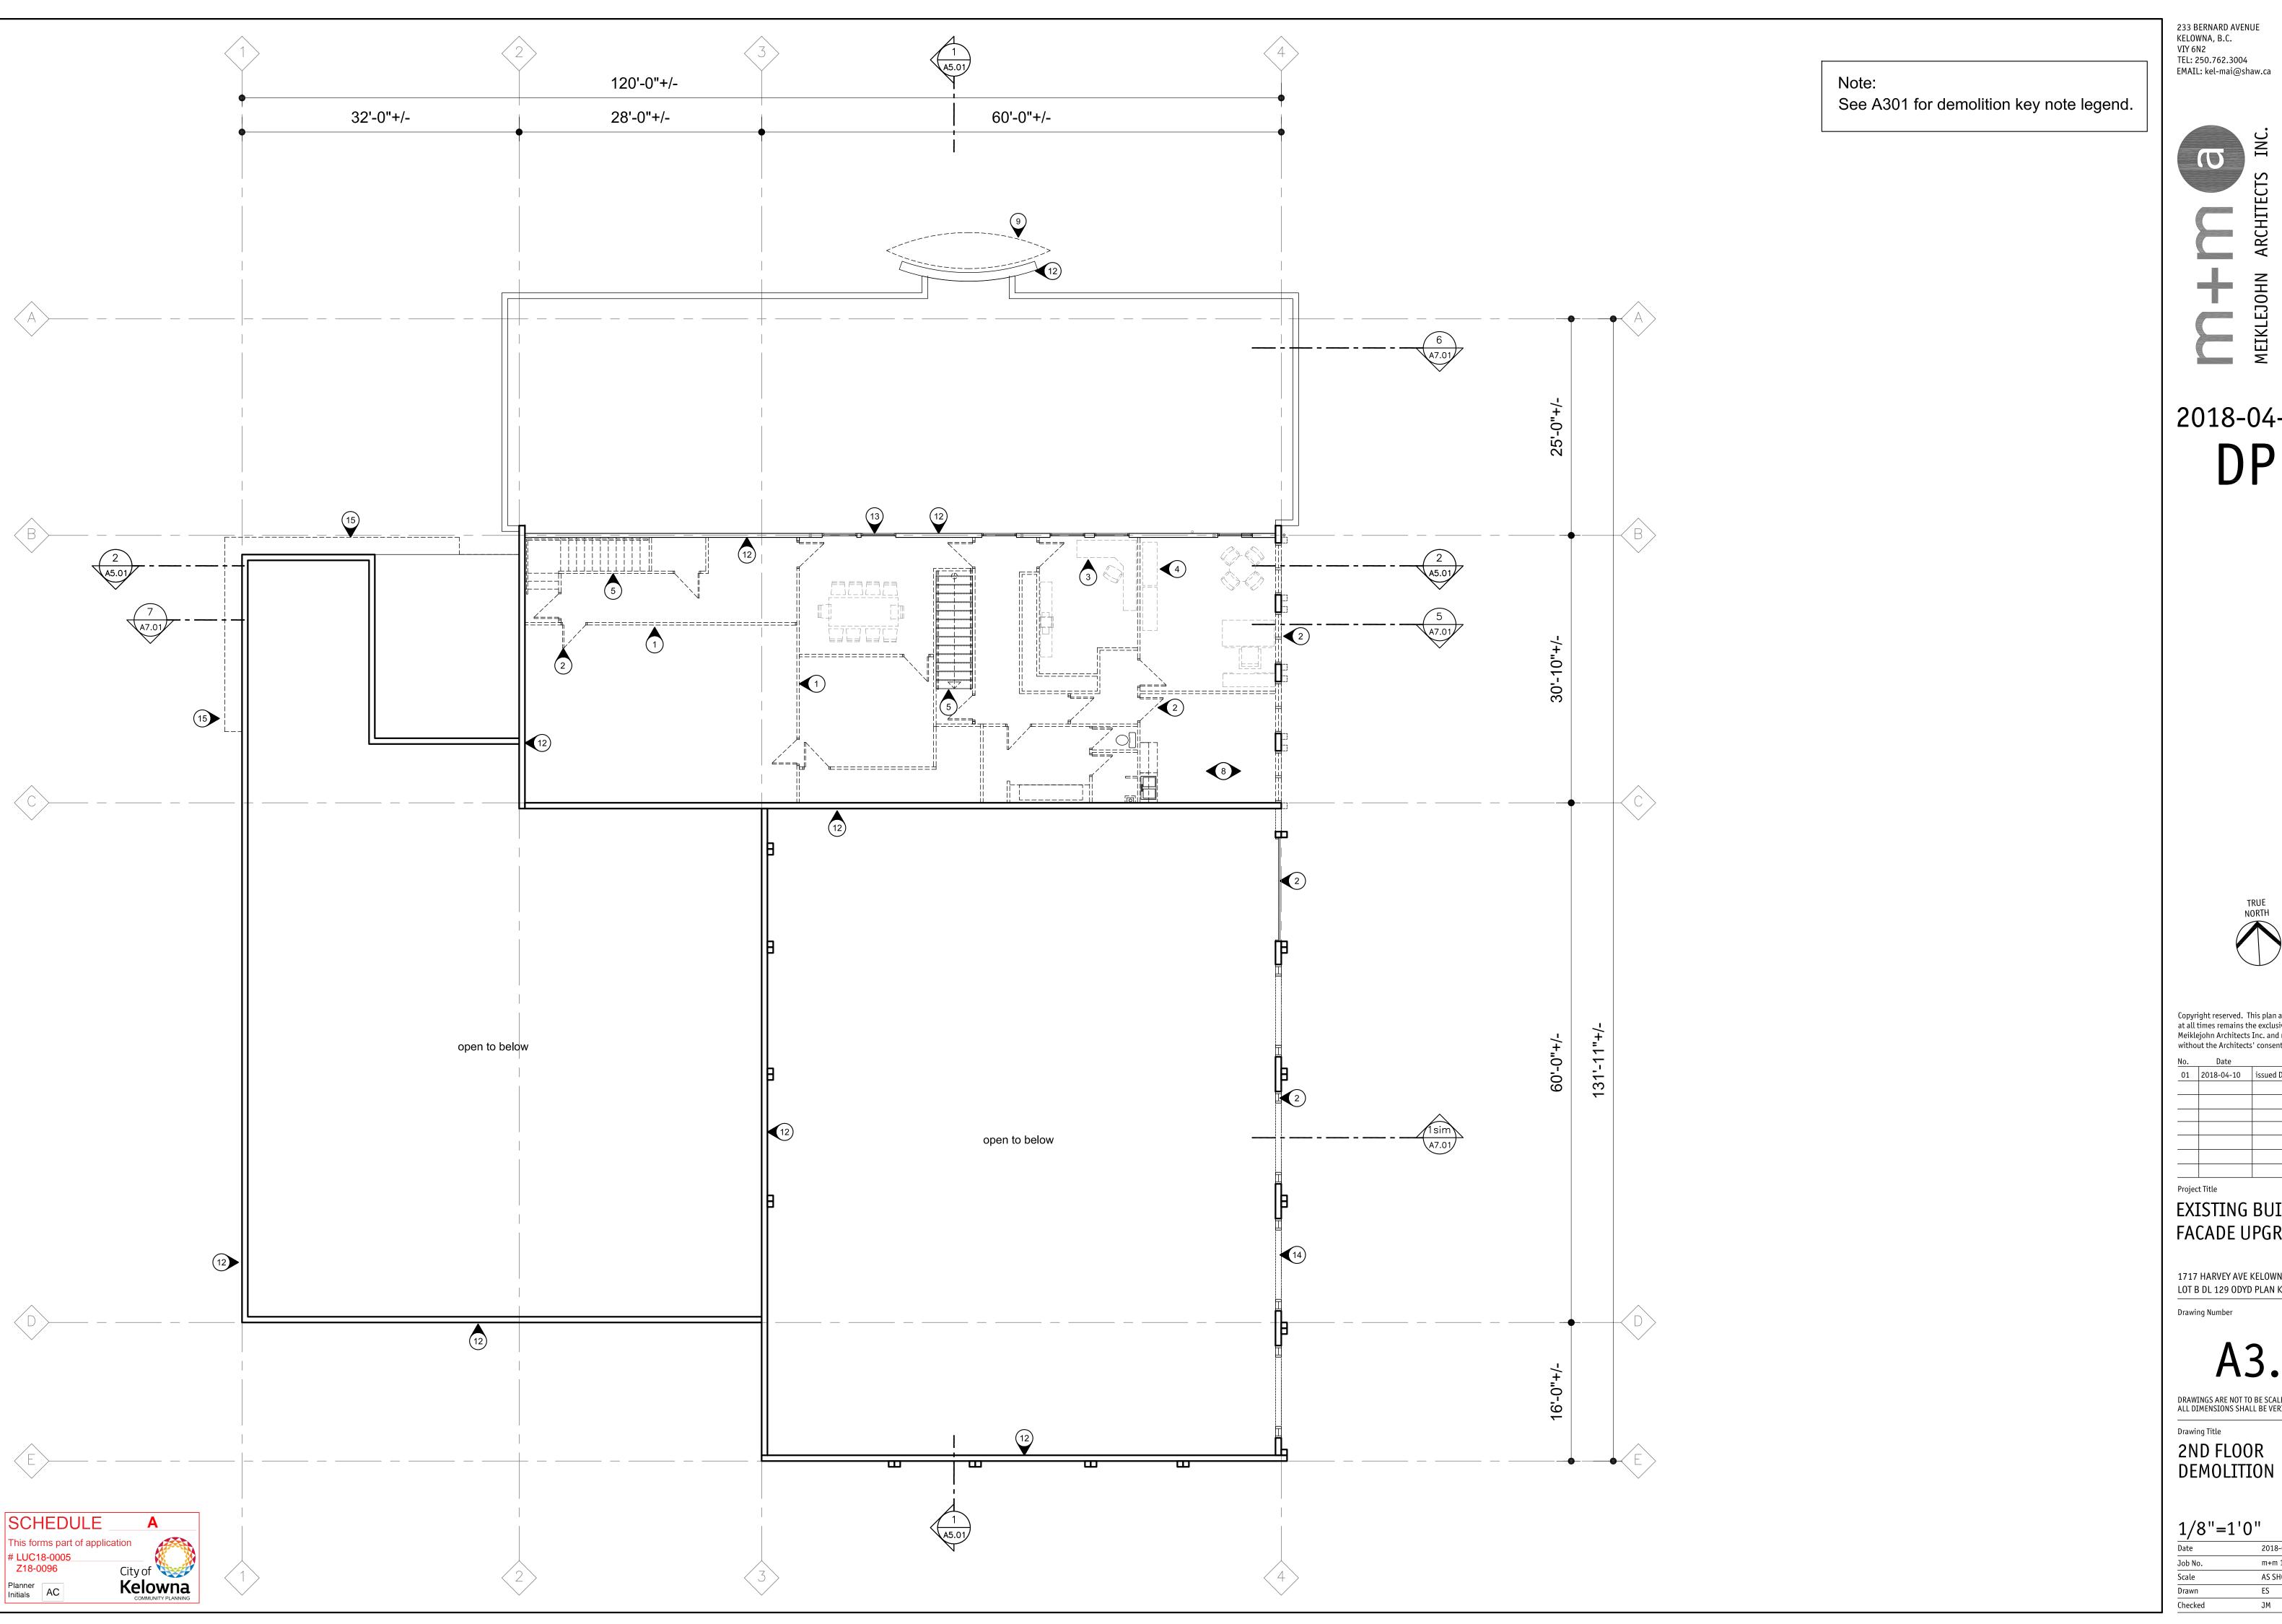



2018-04-10



Copyright reserved. This plan and design is and at all times remains the exclusive property of Meiklejohn Architects Inc. and may not be used without the Architects' consent.
 No.
 Date

 01
 2018-04-10
 issued DP

EXISTING BUILDING FACADE UPGRADE


1717 HARVEY AVE KELOWNA V1Y 6G3 LOT B DL 129 ODYD PLAN KAP68674

DRAWINGS ARE NOT TO BE SCALED. ALL DIMENSIONS SHALL BE VERIFIED ON JOB

2ND FLOOR **DEMOLITION**

1/8"=1'0"

1/0 -1 0	
Date	2018-04-10
Job No.	m+m 17-1786
Scale	AS SHOWN
Drawn	ES
Checked	JM

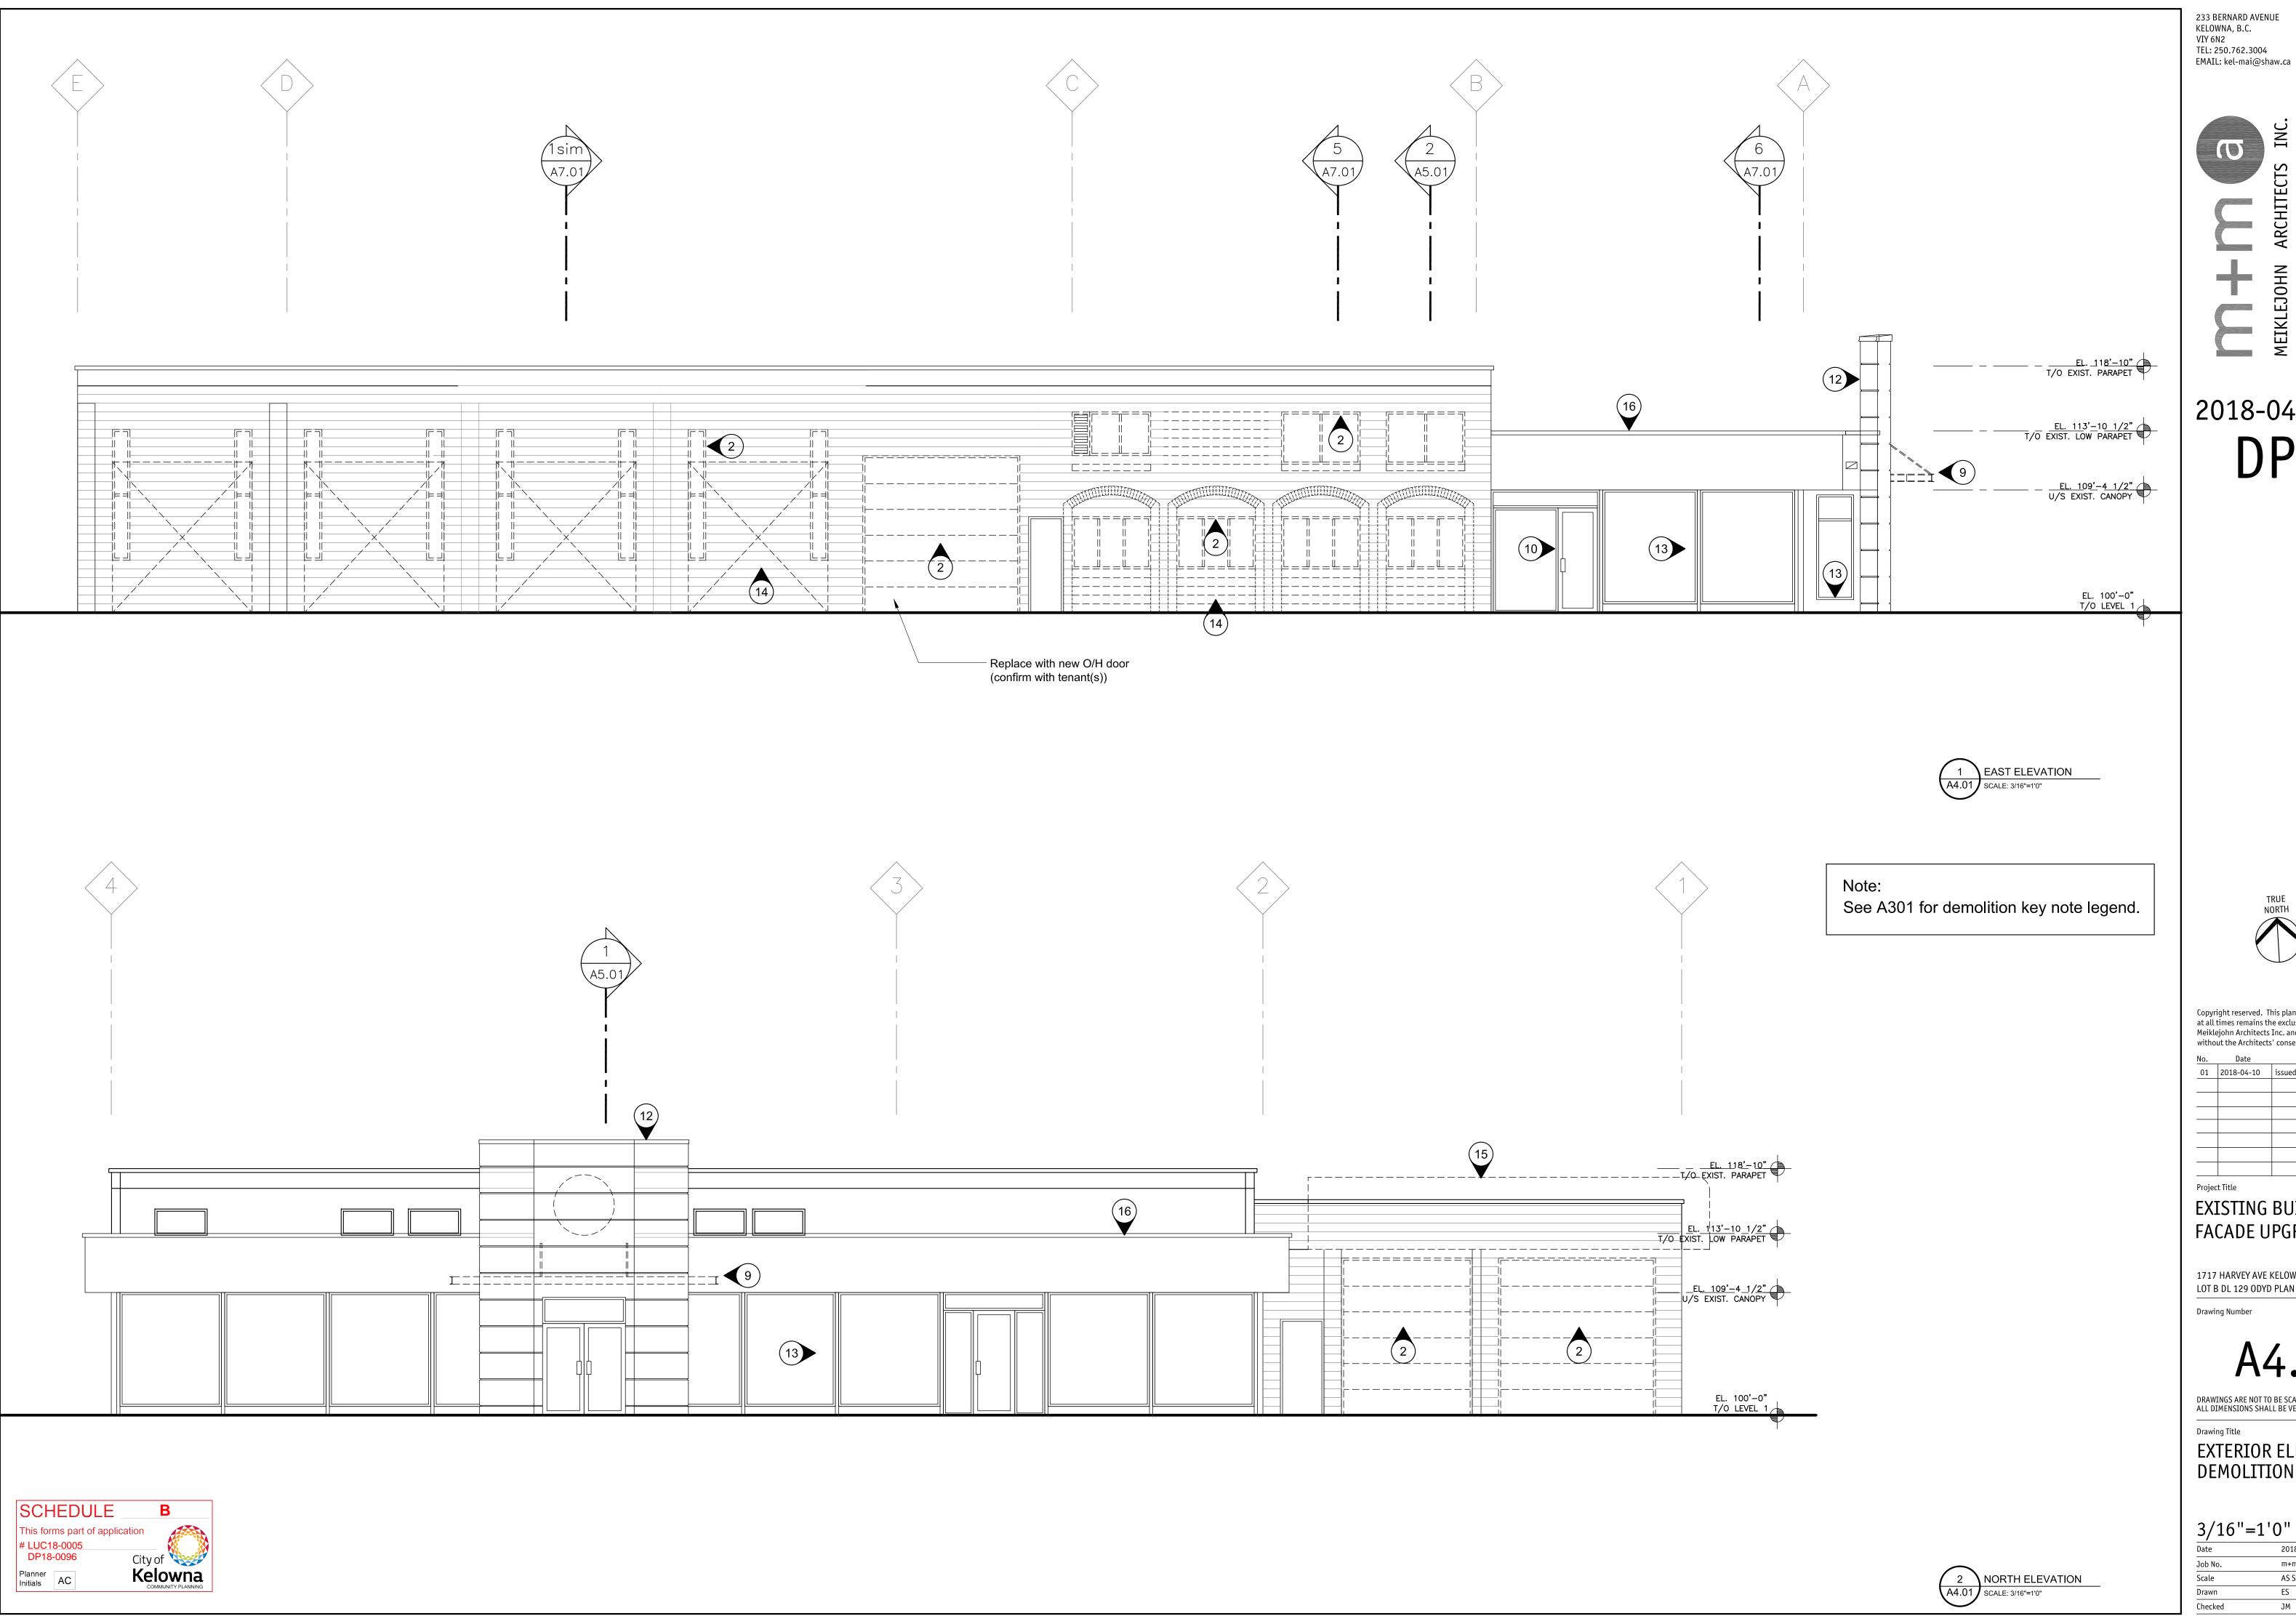

233 BERNARD AVENUE KELOWNA, B.C. TEL: 250.762.3004



2018-04-10



Copyright reserved. This plan and design is and at all times remains the exclusive property of Meiklejohn Architects Inc. and may not be used without the Architects' consent.

No. Date
01 2018-04-10 issued DP

EXISTING BUILDING FACADE UPGRADE


1717 HARVEY AVE KELOWNA V1Y 6G3 LOT B DL 129 ODYD PLAN KAP68674


Drawing Number

DRAWINGS ARE NOT TO BE SCALED. ALL DIMENSIONS SHALL BE VERIFIED ON JOB

EXTERIOR ELEVATION **DEMOLITION**

3/16"=1'0"

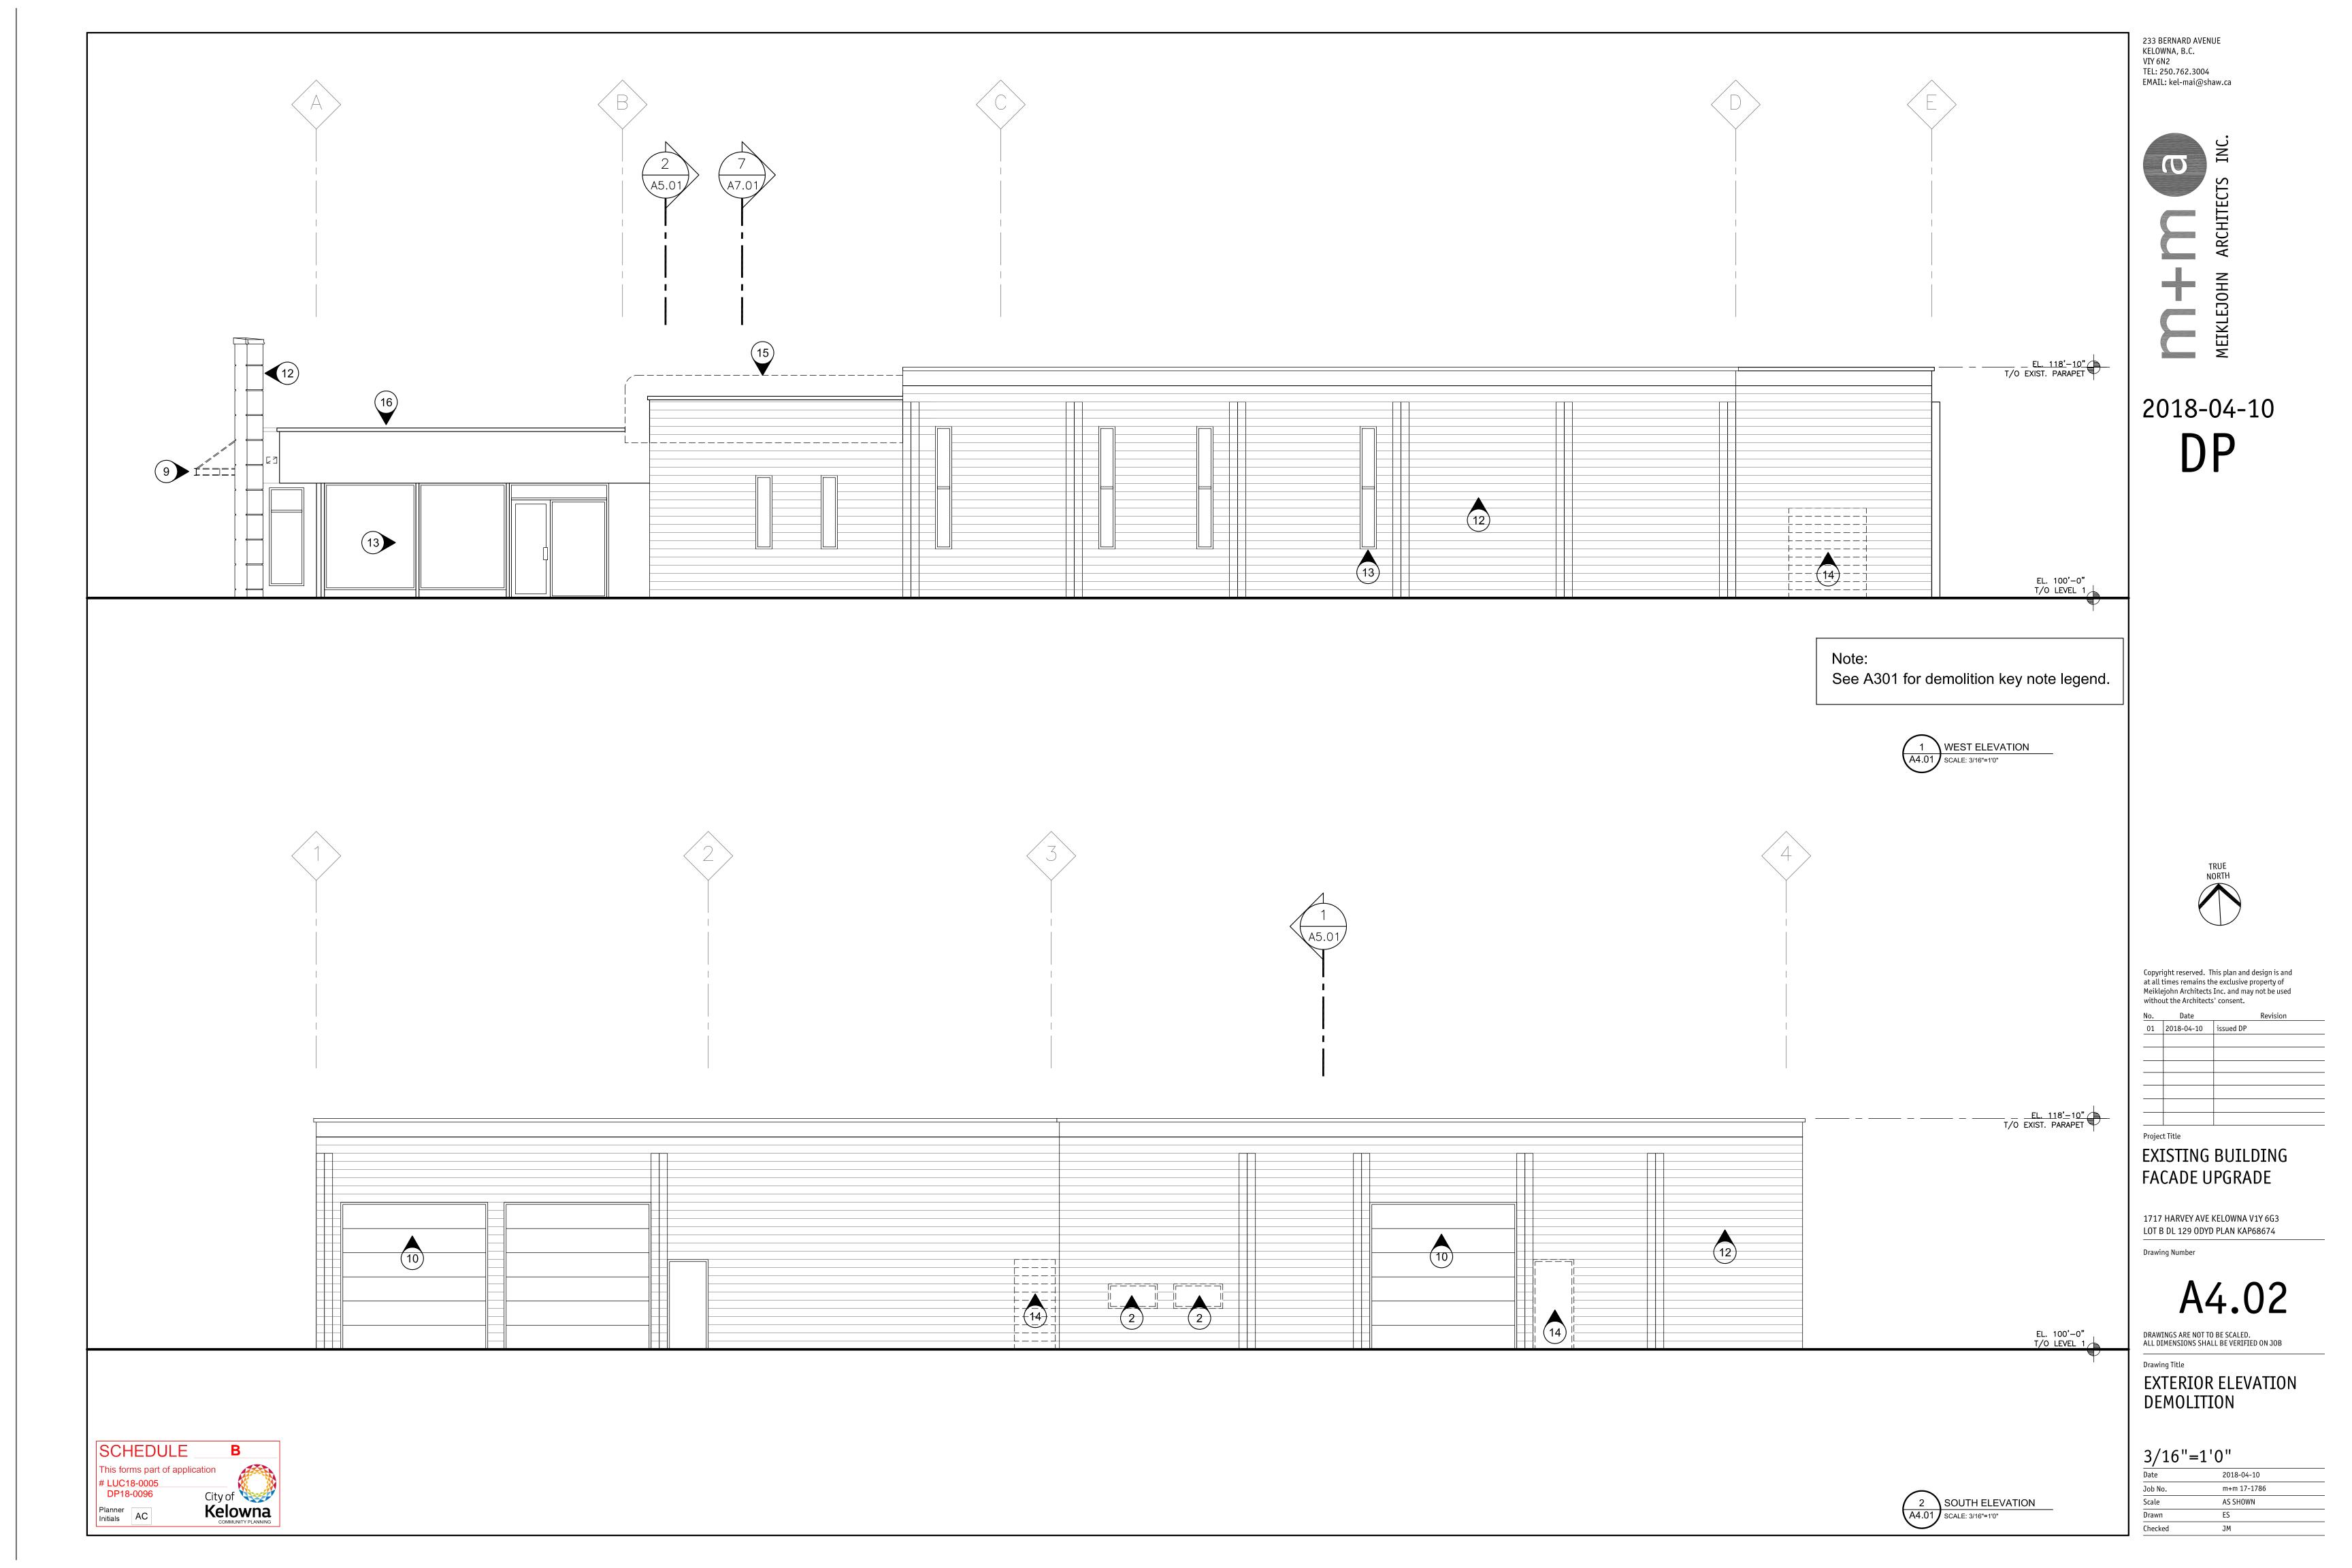

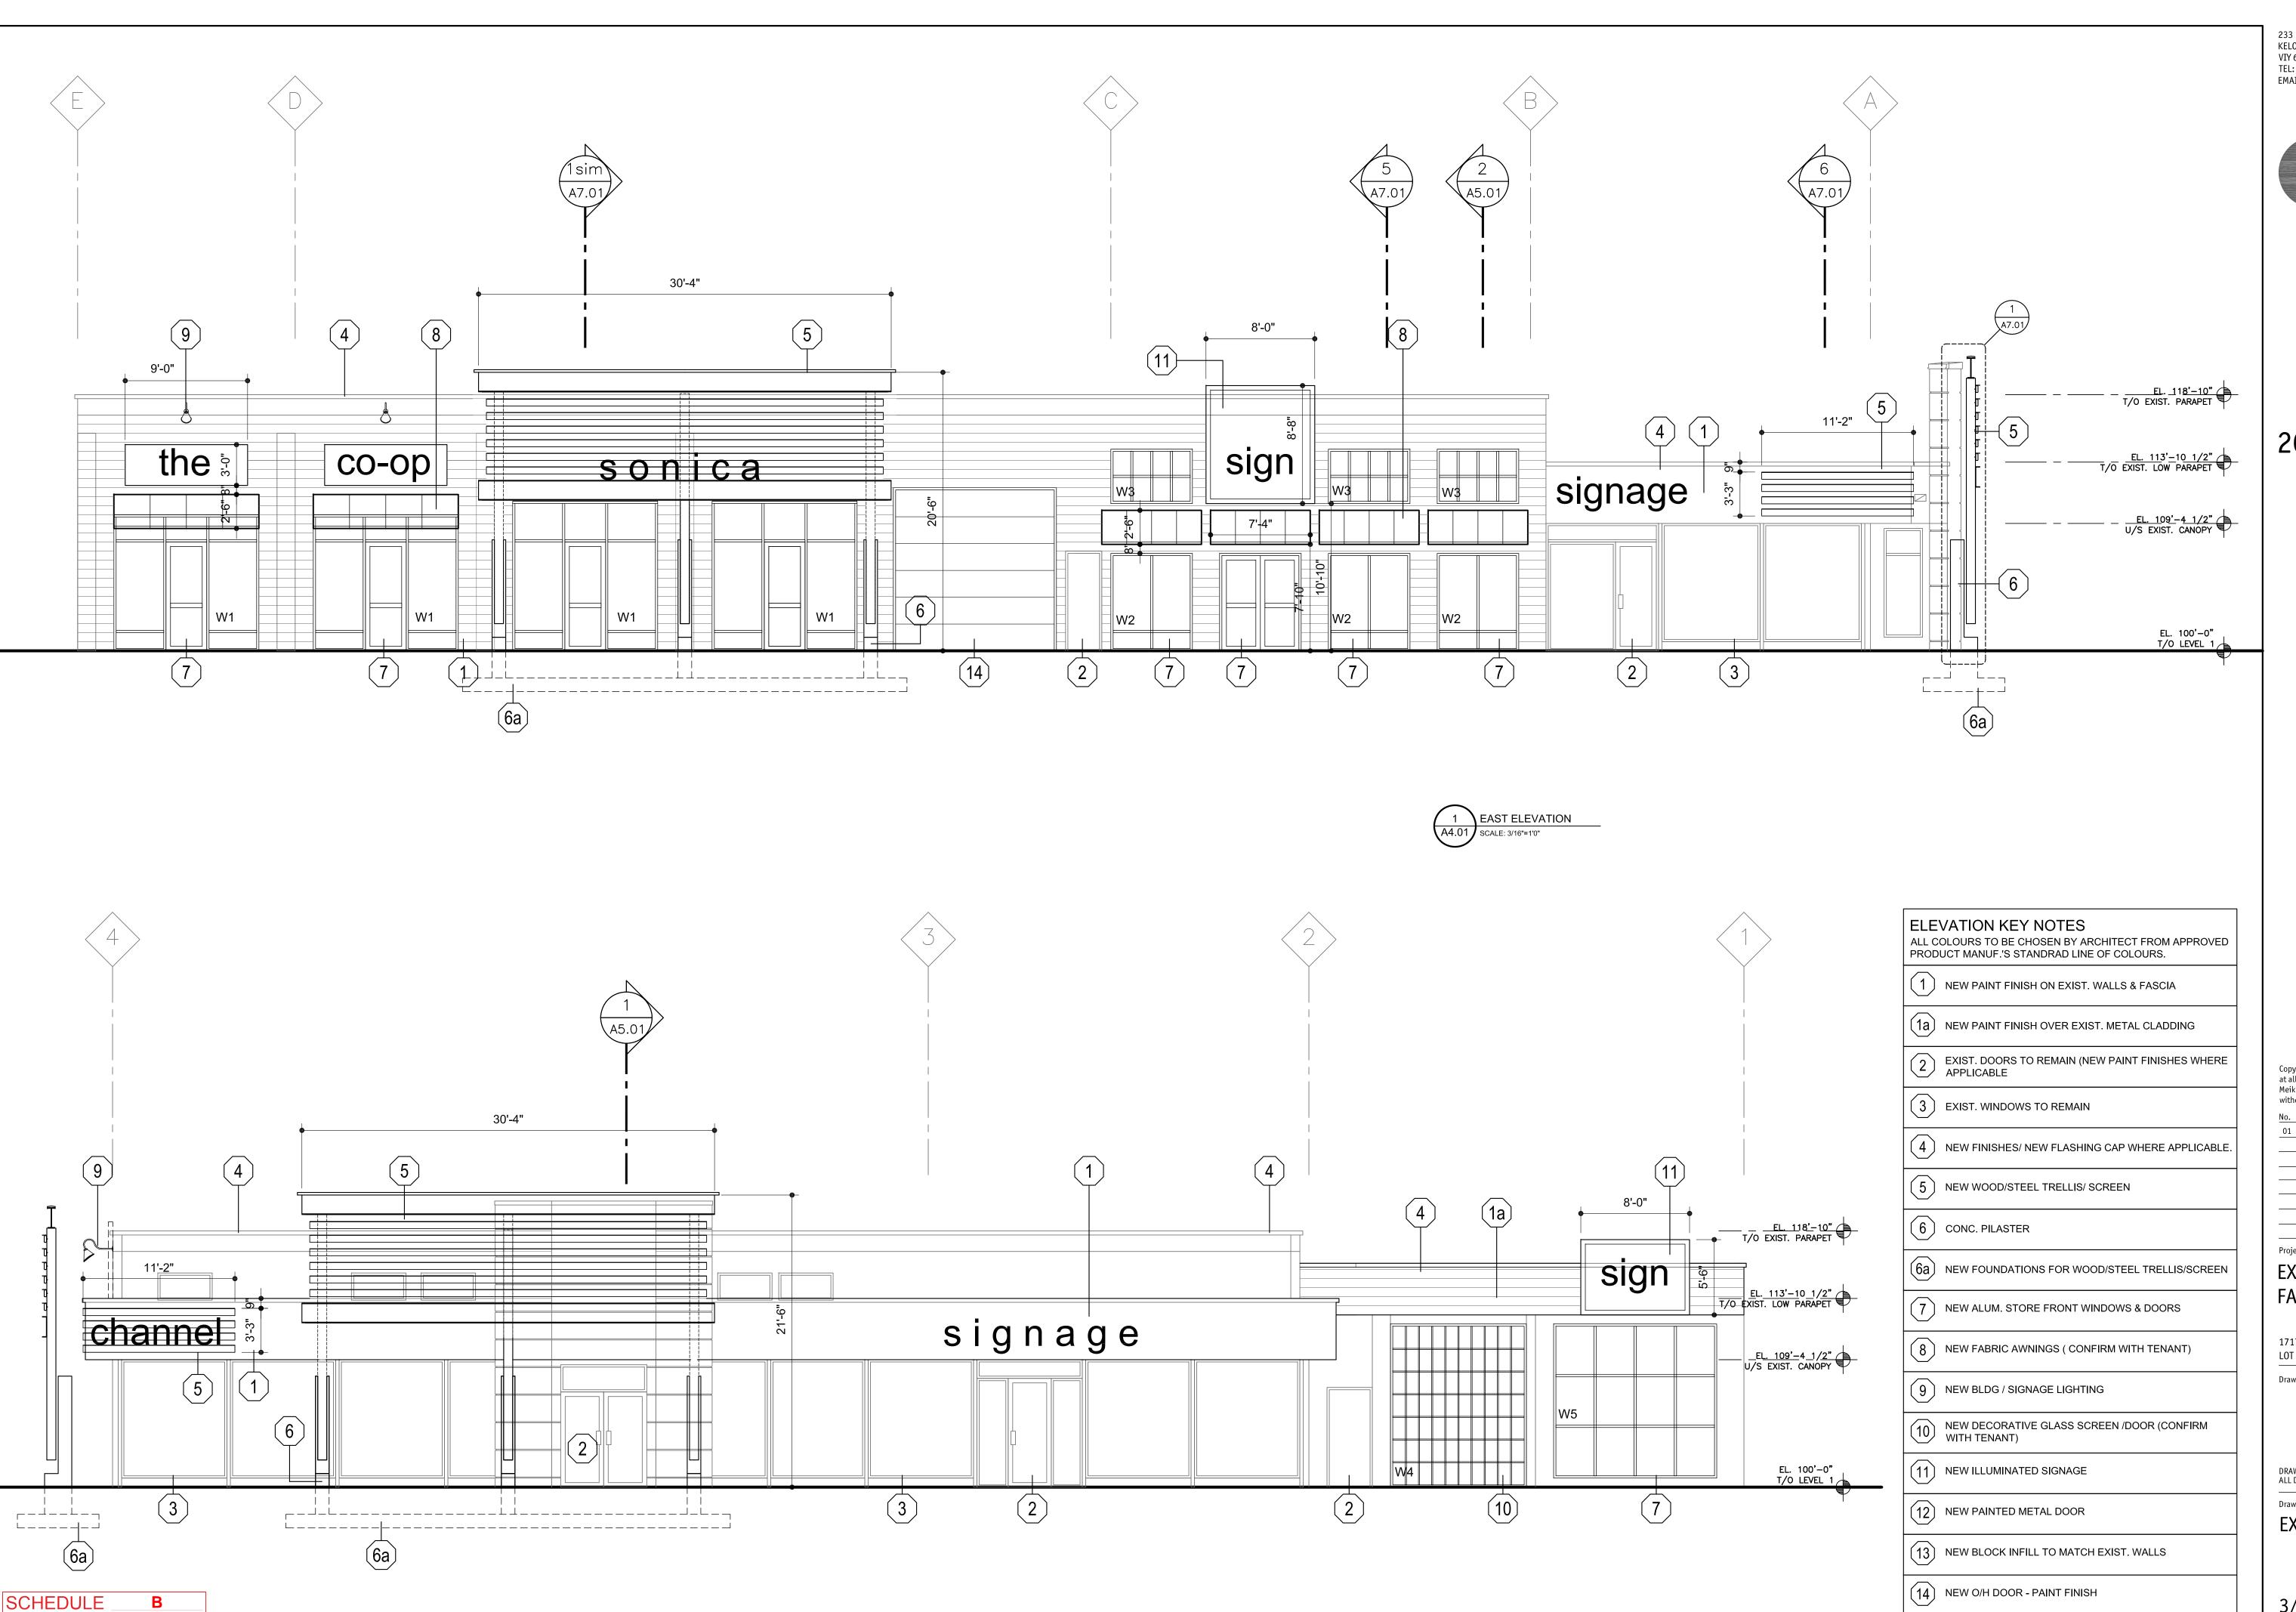

#<u>LUC18-0005</u> DP18-0096

Kelowna

233 BERNARD AVENUE KELOWNA, B.C. VIY 6N2 TEL: 250.762.3004 EMAIL: kel-mai@shaw.ca



2018-04-10



Copyright reserved. This plan and design is and at all times remains the exclusive property of Meiklejohn Architects Inc. and may not be used without the Architects' consent.

01 2018-04-10 issued DP

EXISTING BUILDING FACADE UPGRADE

1717 HARVEY AVE KELOWNA V1Y 6G3

LOT B DL 129 ODYD PLAN KAP68674


A4.03


DRAWINGS ARE NOT TO BE SCALED. ALL DIMENSIONS SHALL BE VERIFIED ON JOB

EXTERIOR ELEVATIONS

3/16"=1'0"

NEW SCREEN AROUND NEW PATIOS (CONFIRM WITH TENANT)

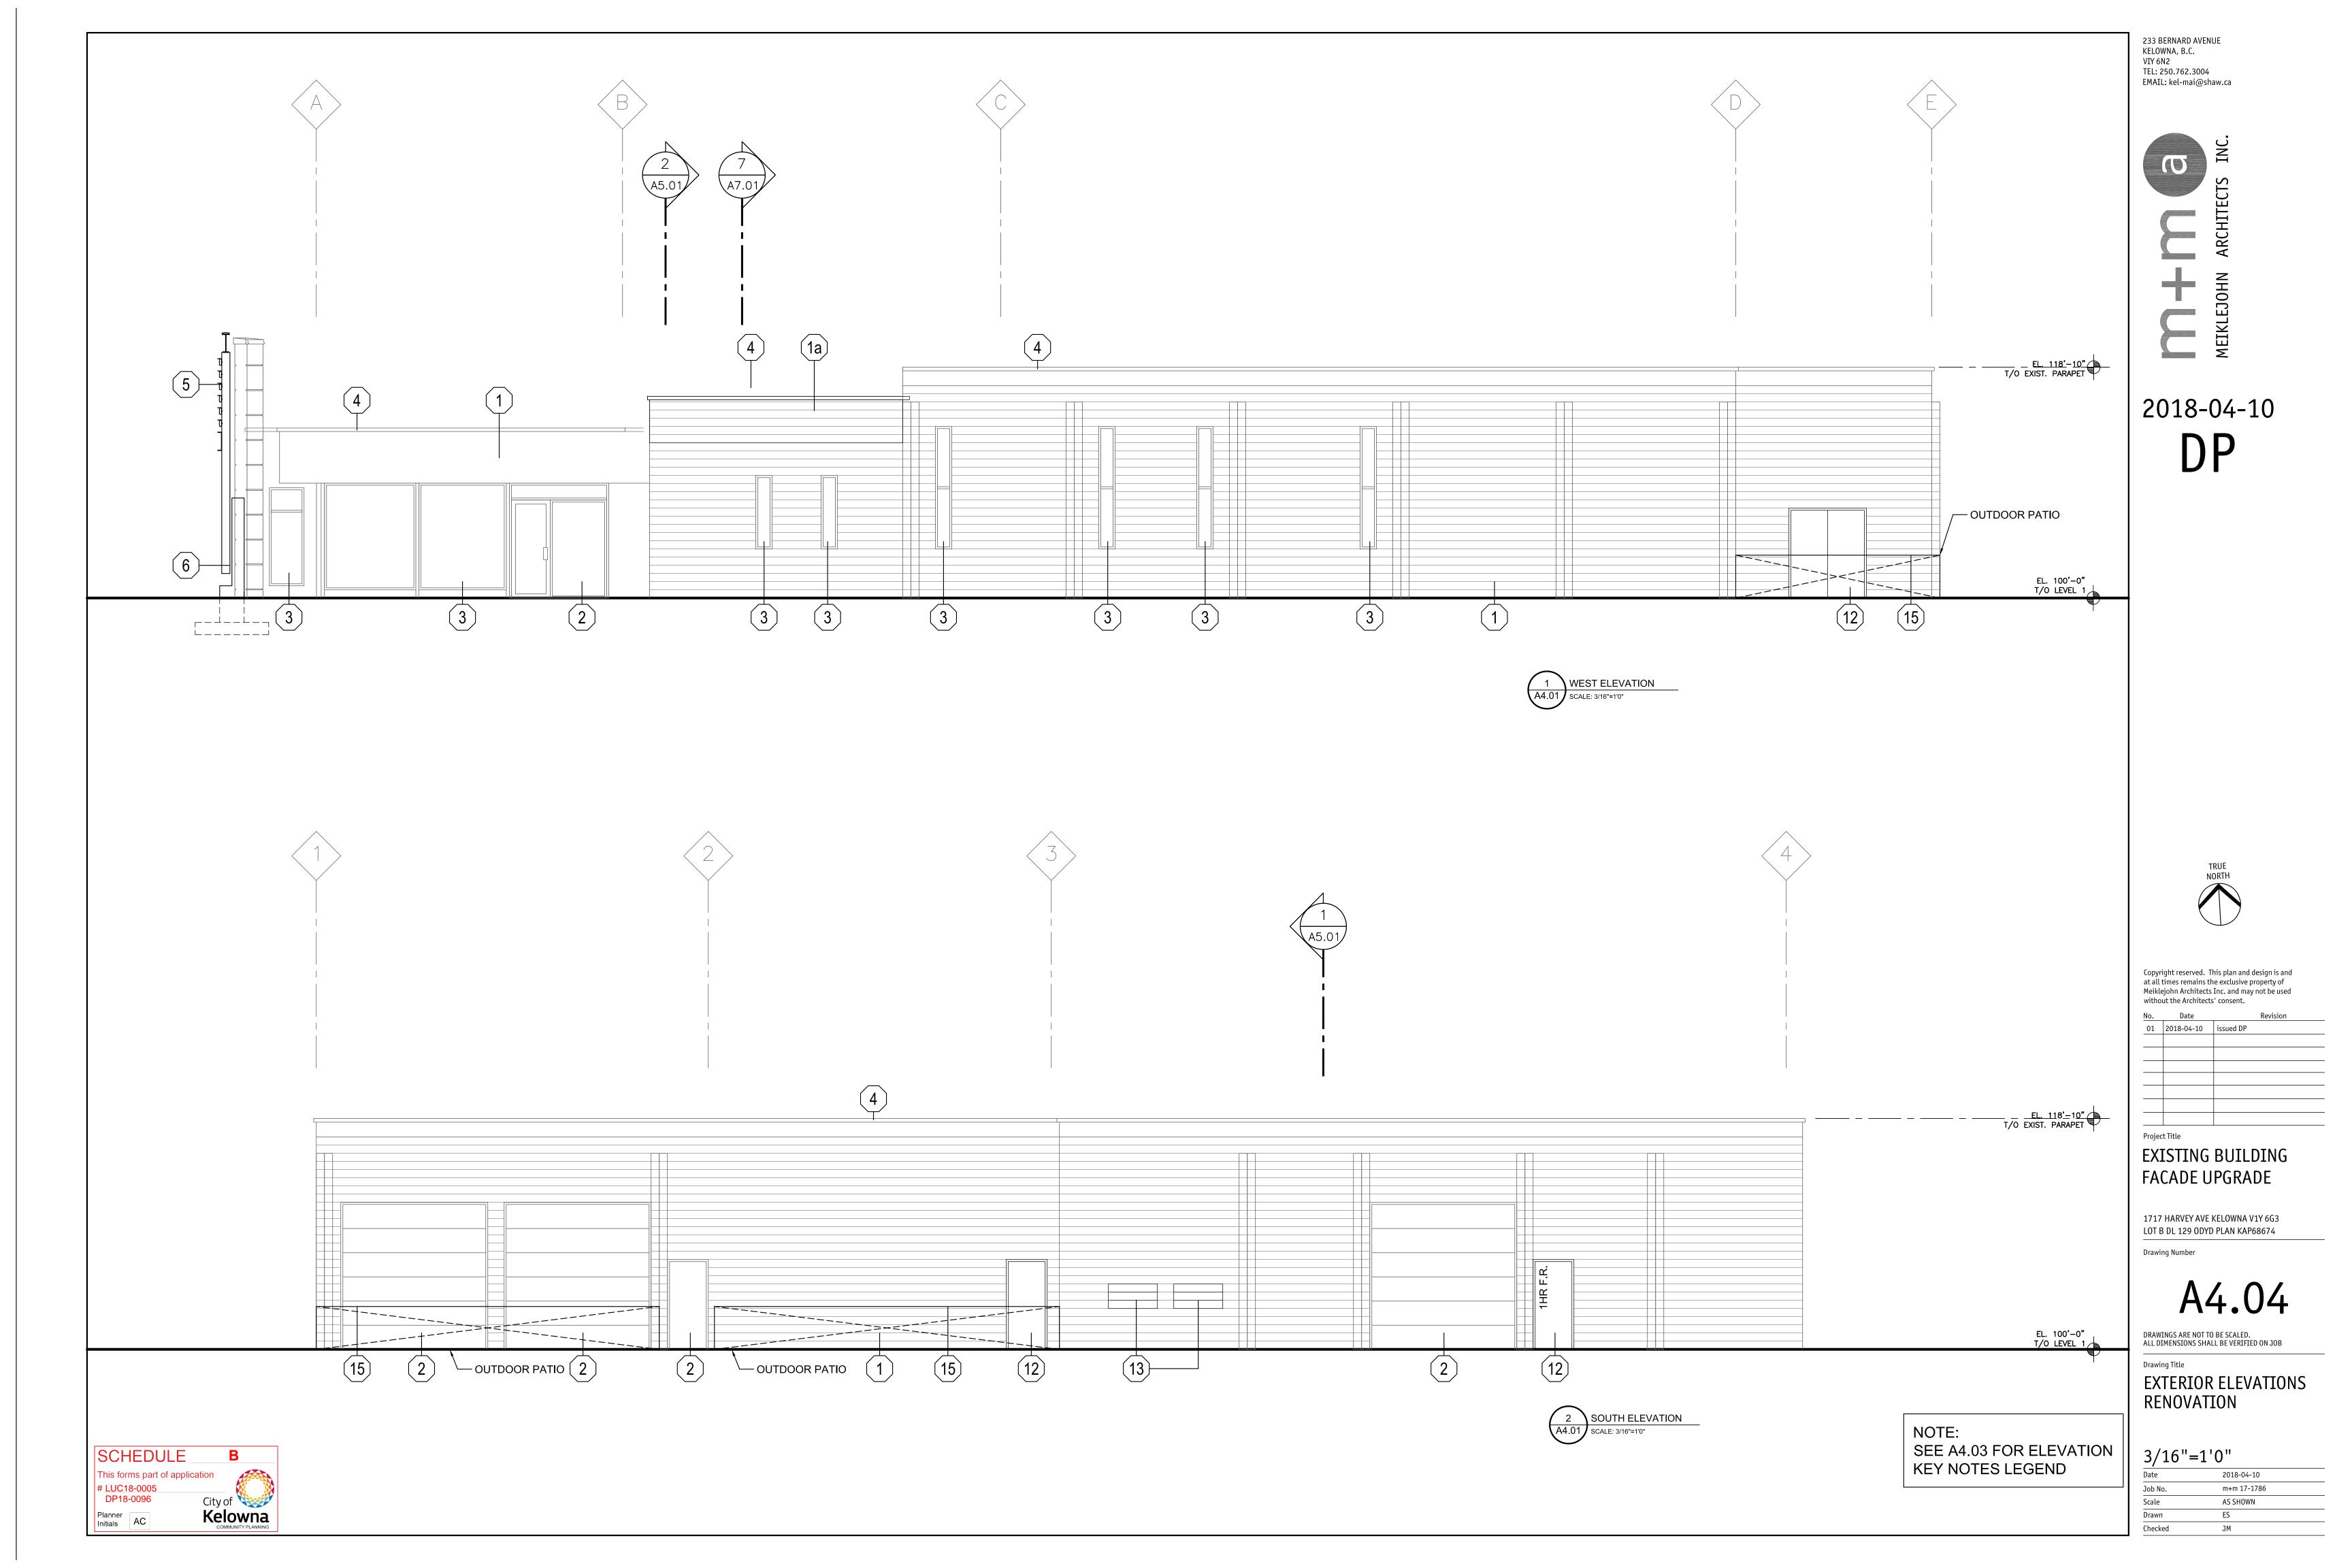

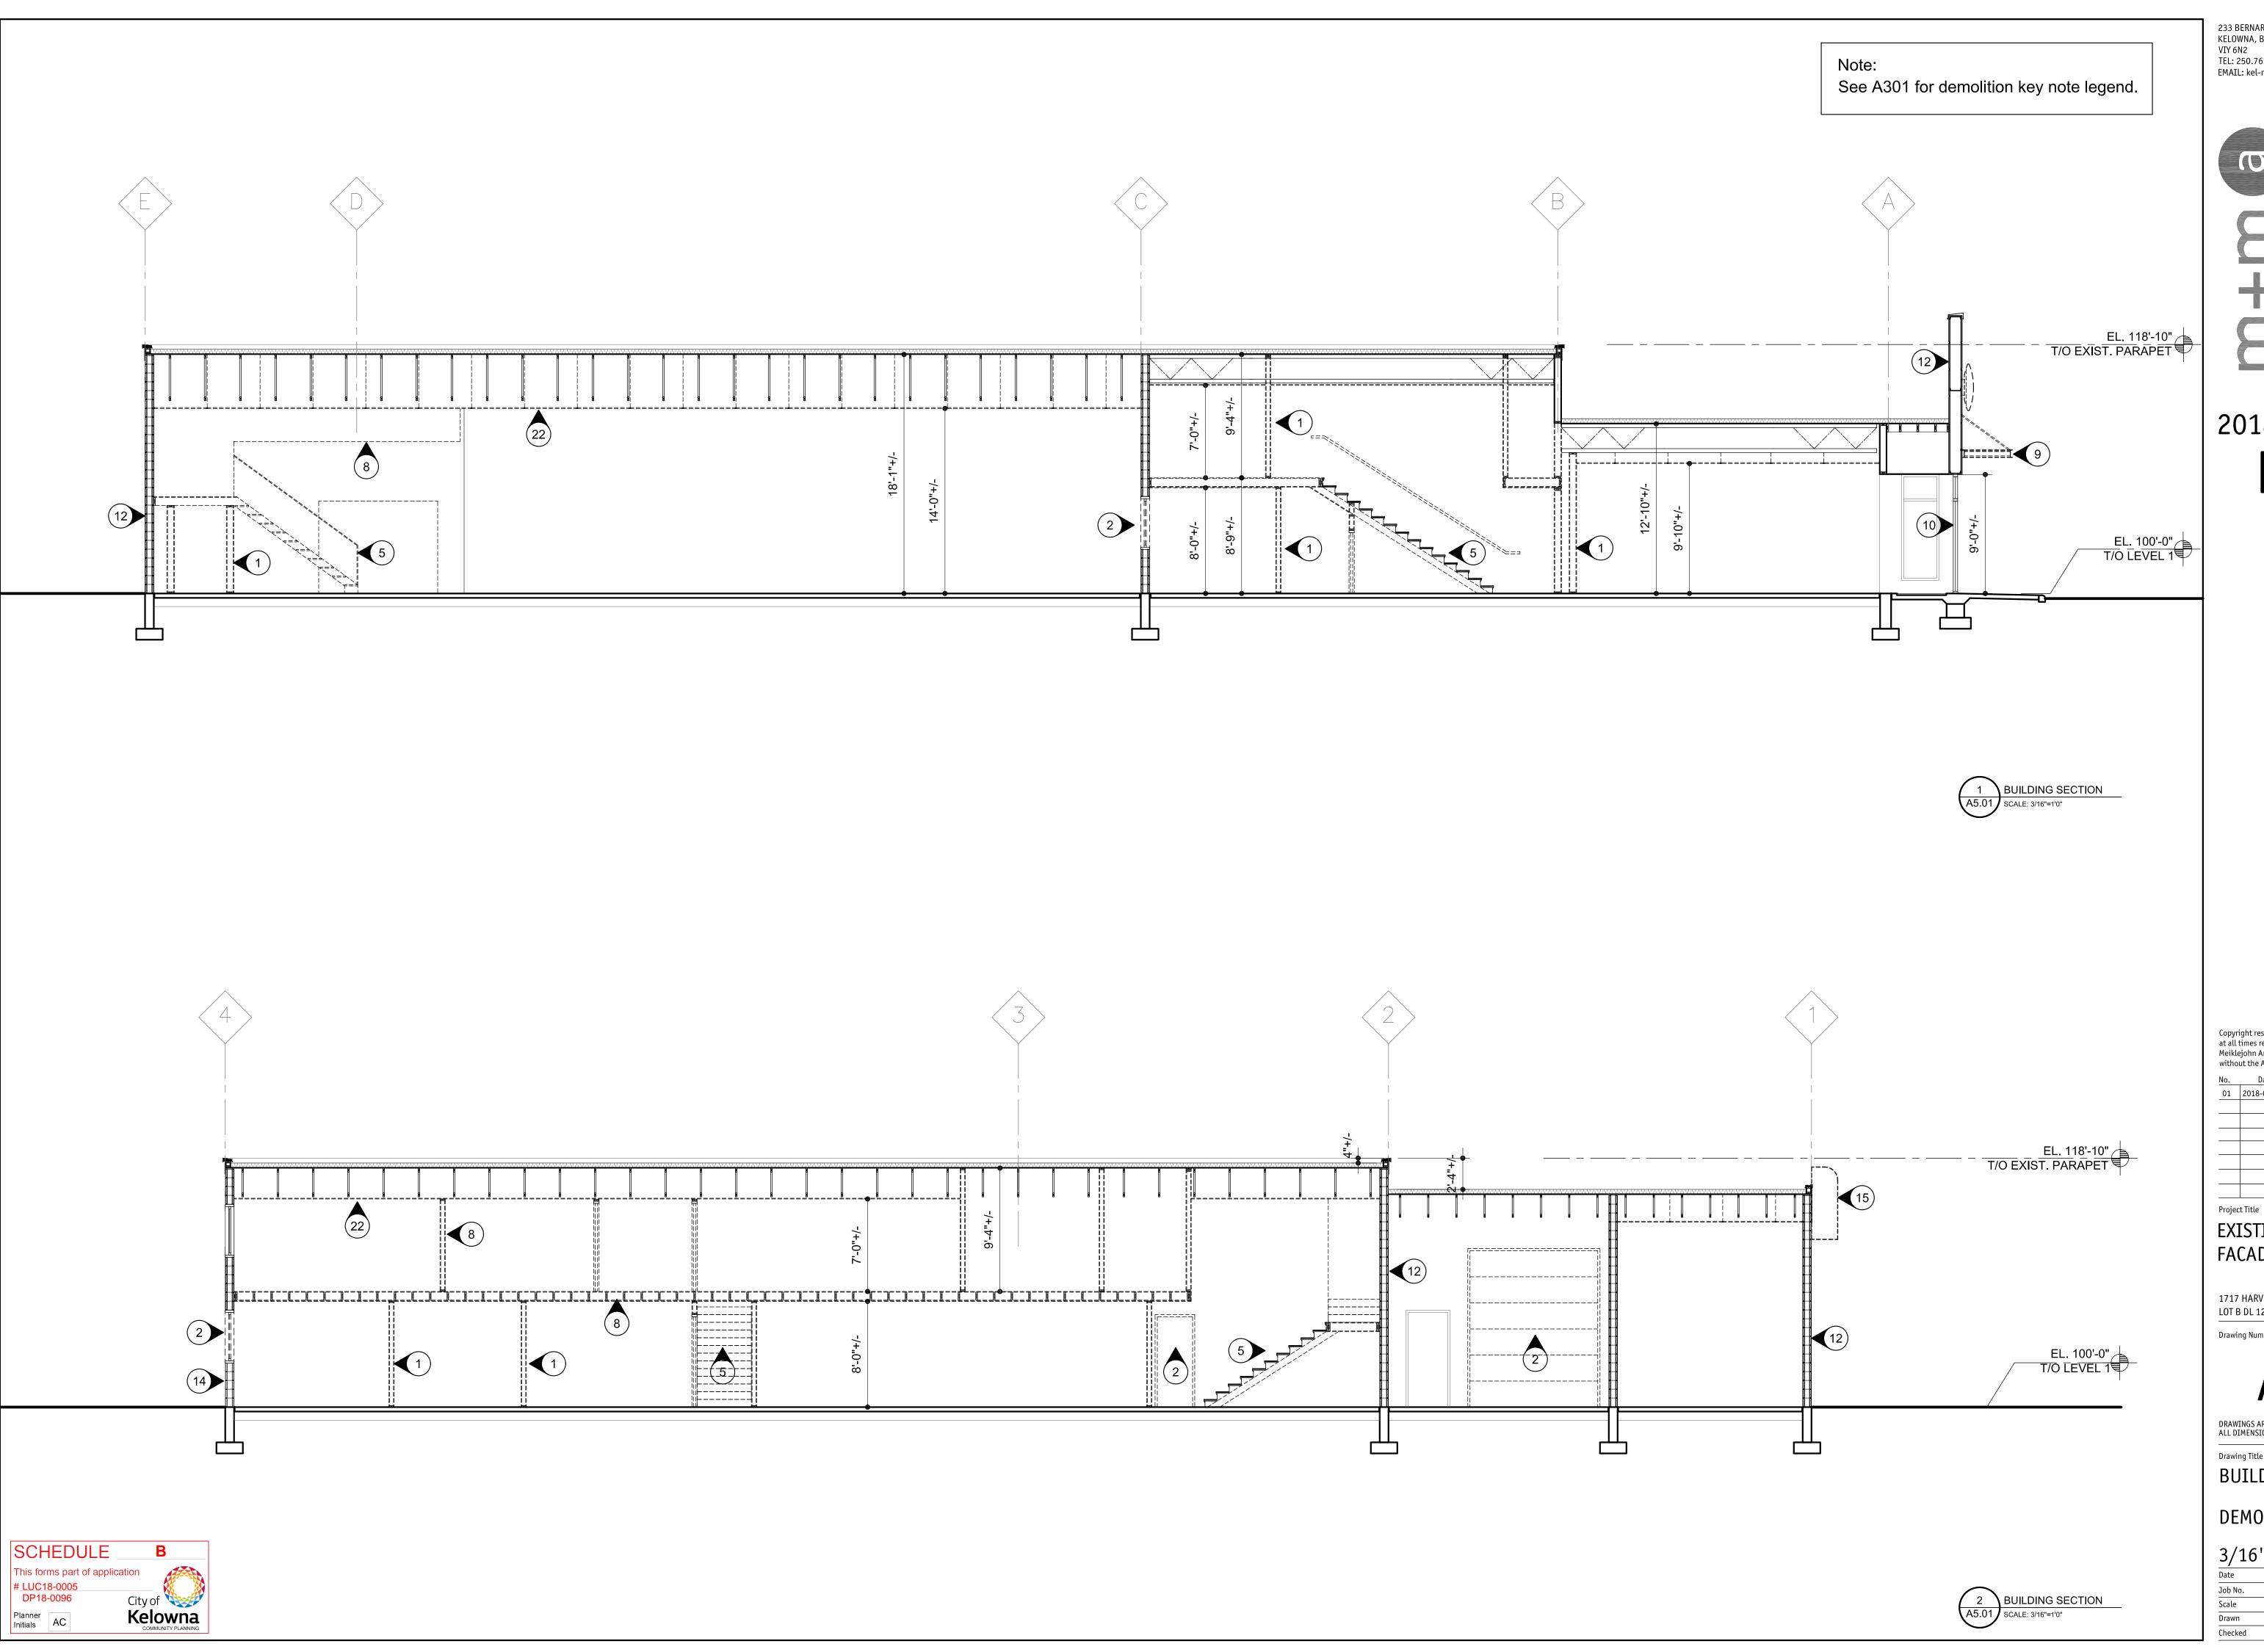

233 BERNARD AVENUE KELOWNA, B.C. VIY 6N2 TEL: 250.762.3004 EMAIL: kel-mai@shaw.ca



2018-04-10



Copyright reserved. This plan and design is and at all times remains the exclusive property of Meiklejohn Architects Inc. and may not be used without the Architects' consent.
 No.
 Date

 01
 2018-04-10
 issued DP

EXISTING BUILDING FACADE UPGRADE

1717 HARVEY AVE KELOWNA V1Y 6G3 LOT B DL 129 ODYD PLAN KAP68674

Drawing Number


A5.01

DRAWINGS ARE NOT TO BE SCALED. ALL DIMENSIONS SHALL BE VERIFIED ON JOB

BUILDING SECTION

DEMOLITION

3/16"=1'0"

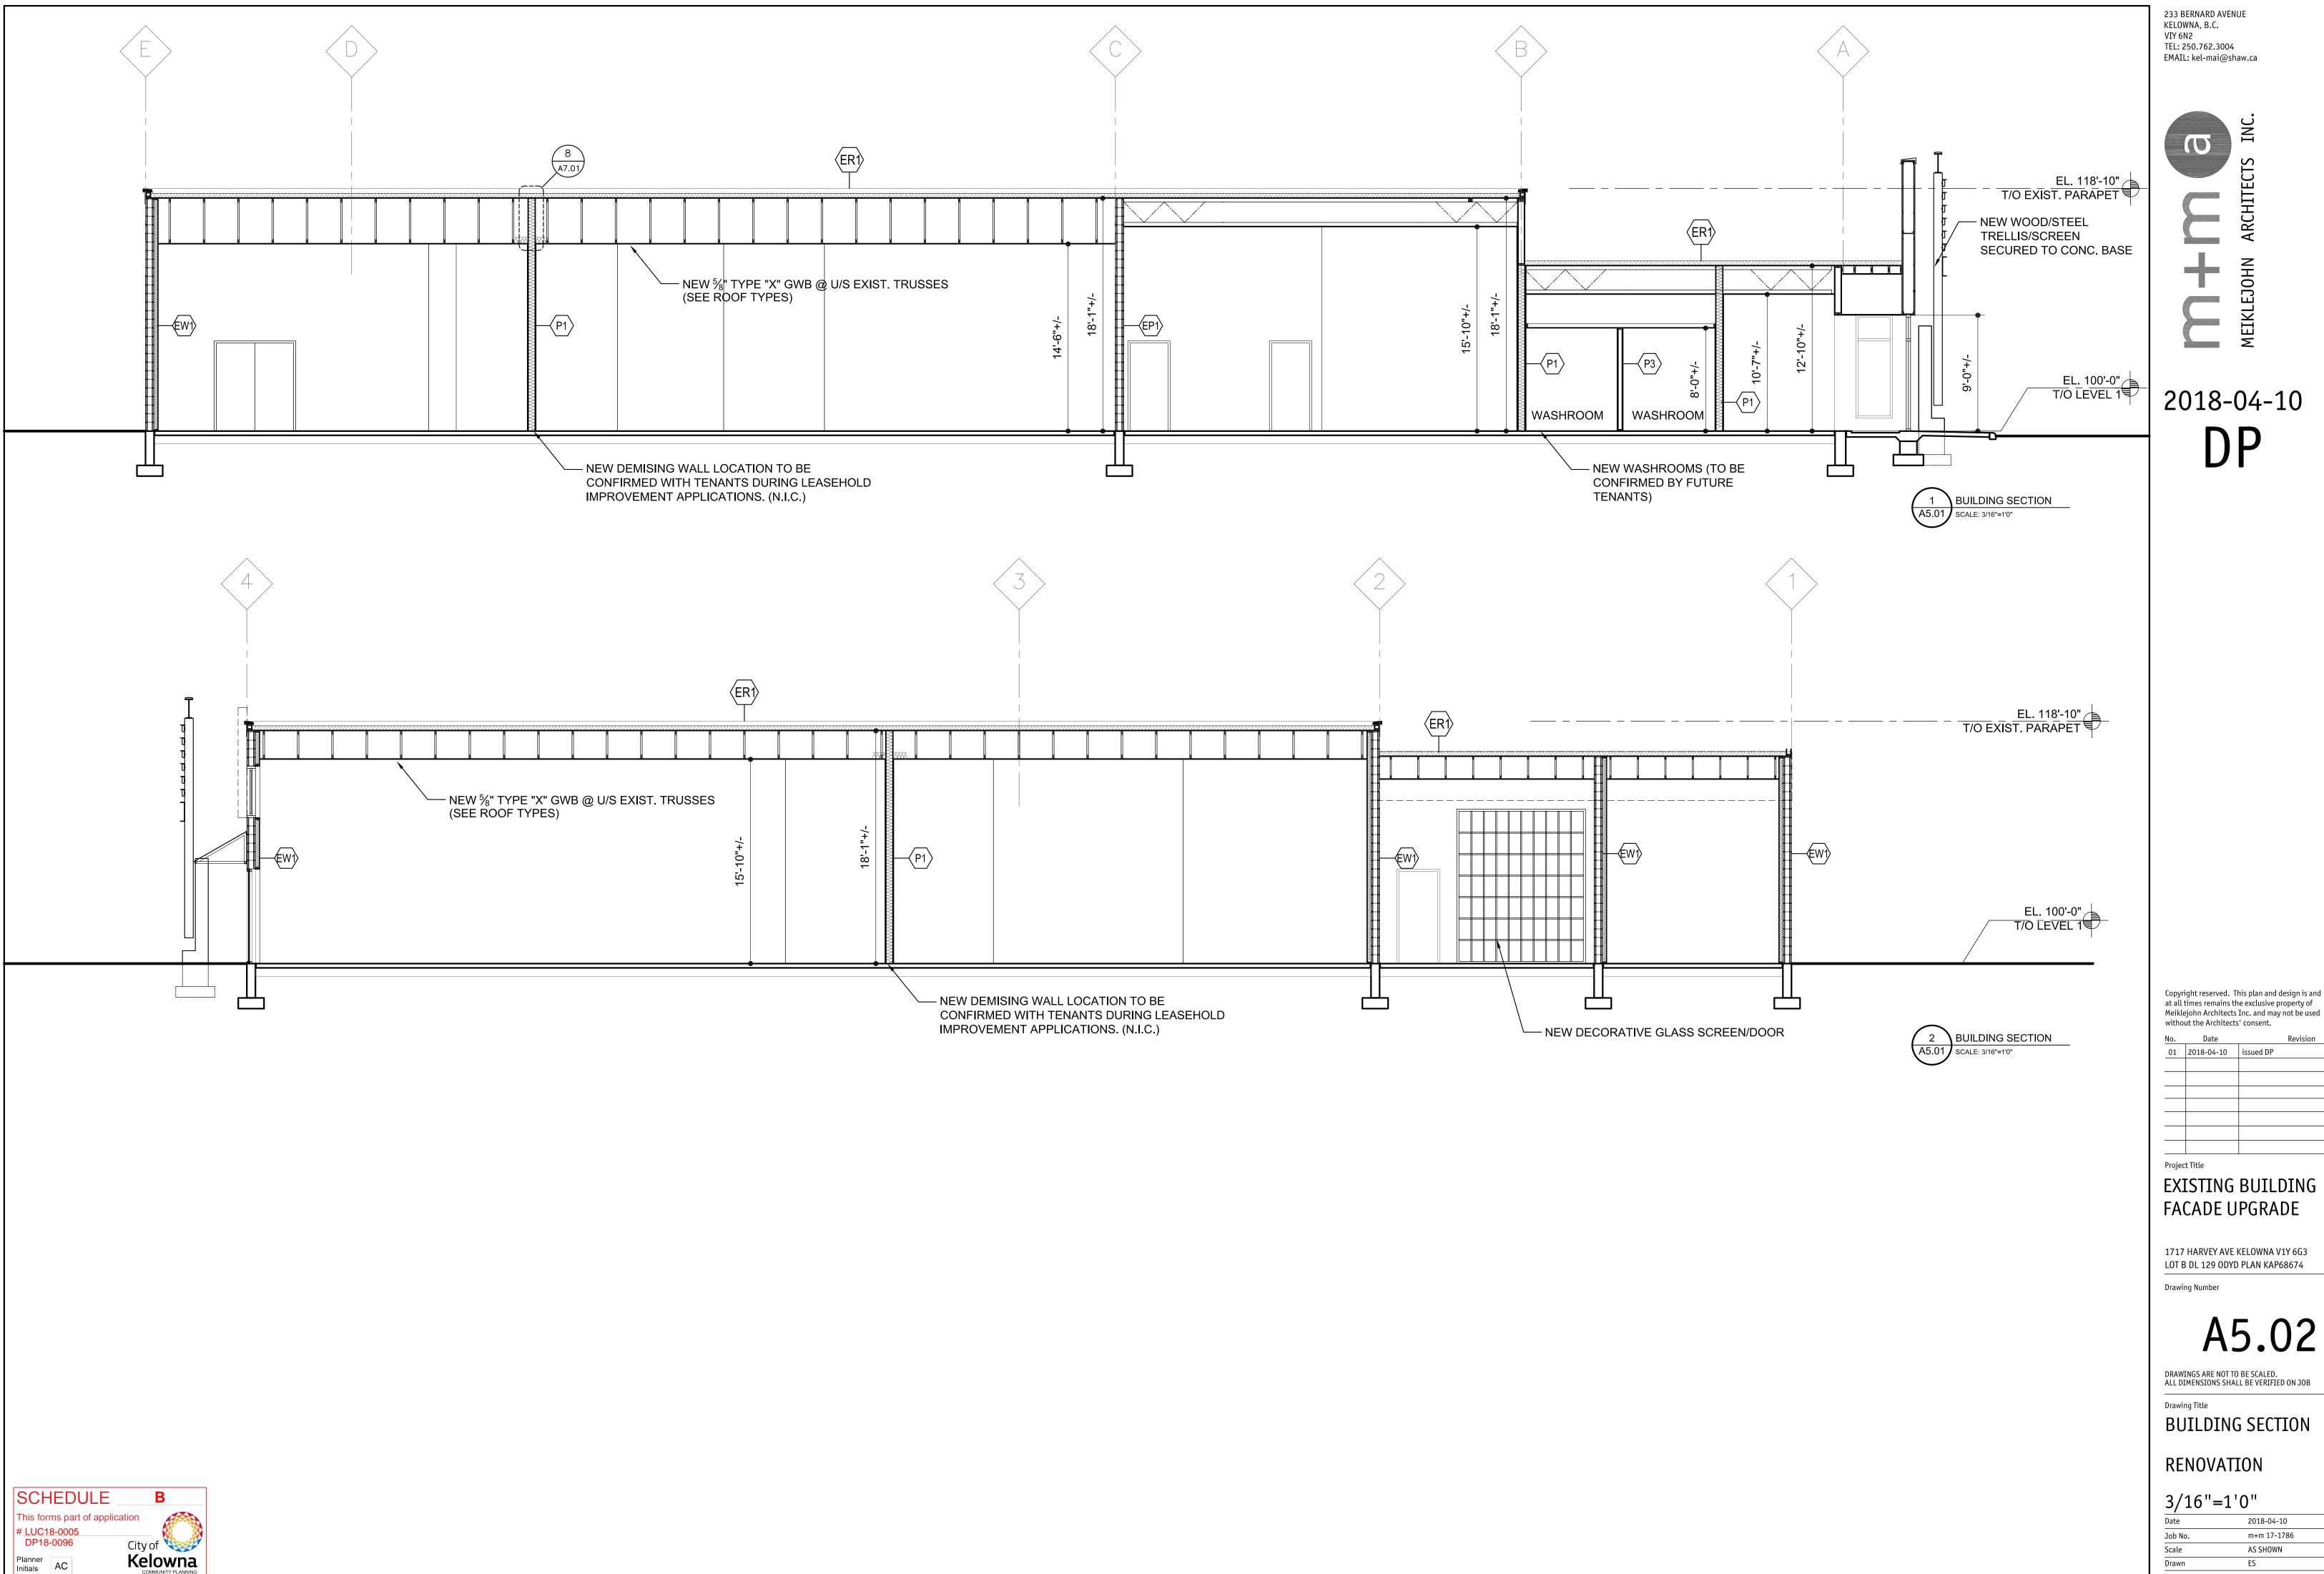



Copyright reserved. This plan and design is and at all times remains the exclusive property of Meiklejohn Architects Inc. and may not be used

EXISTING BUILDING

1717 HARVEY AVE KELOWNA V1Y 6G3

m+m 17-1786 Drawn Checked

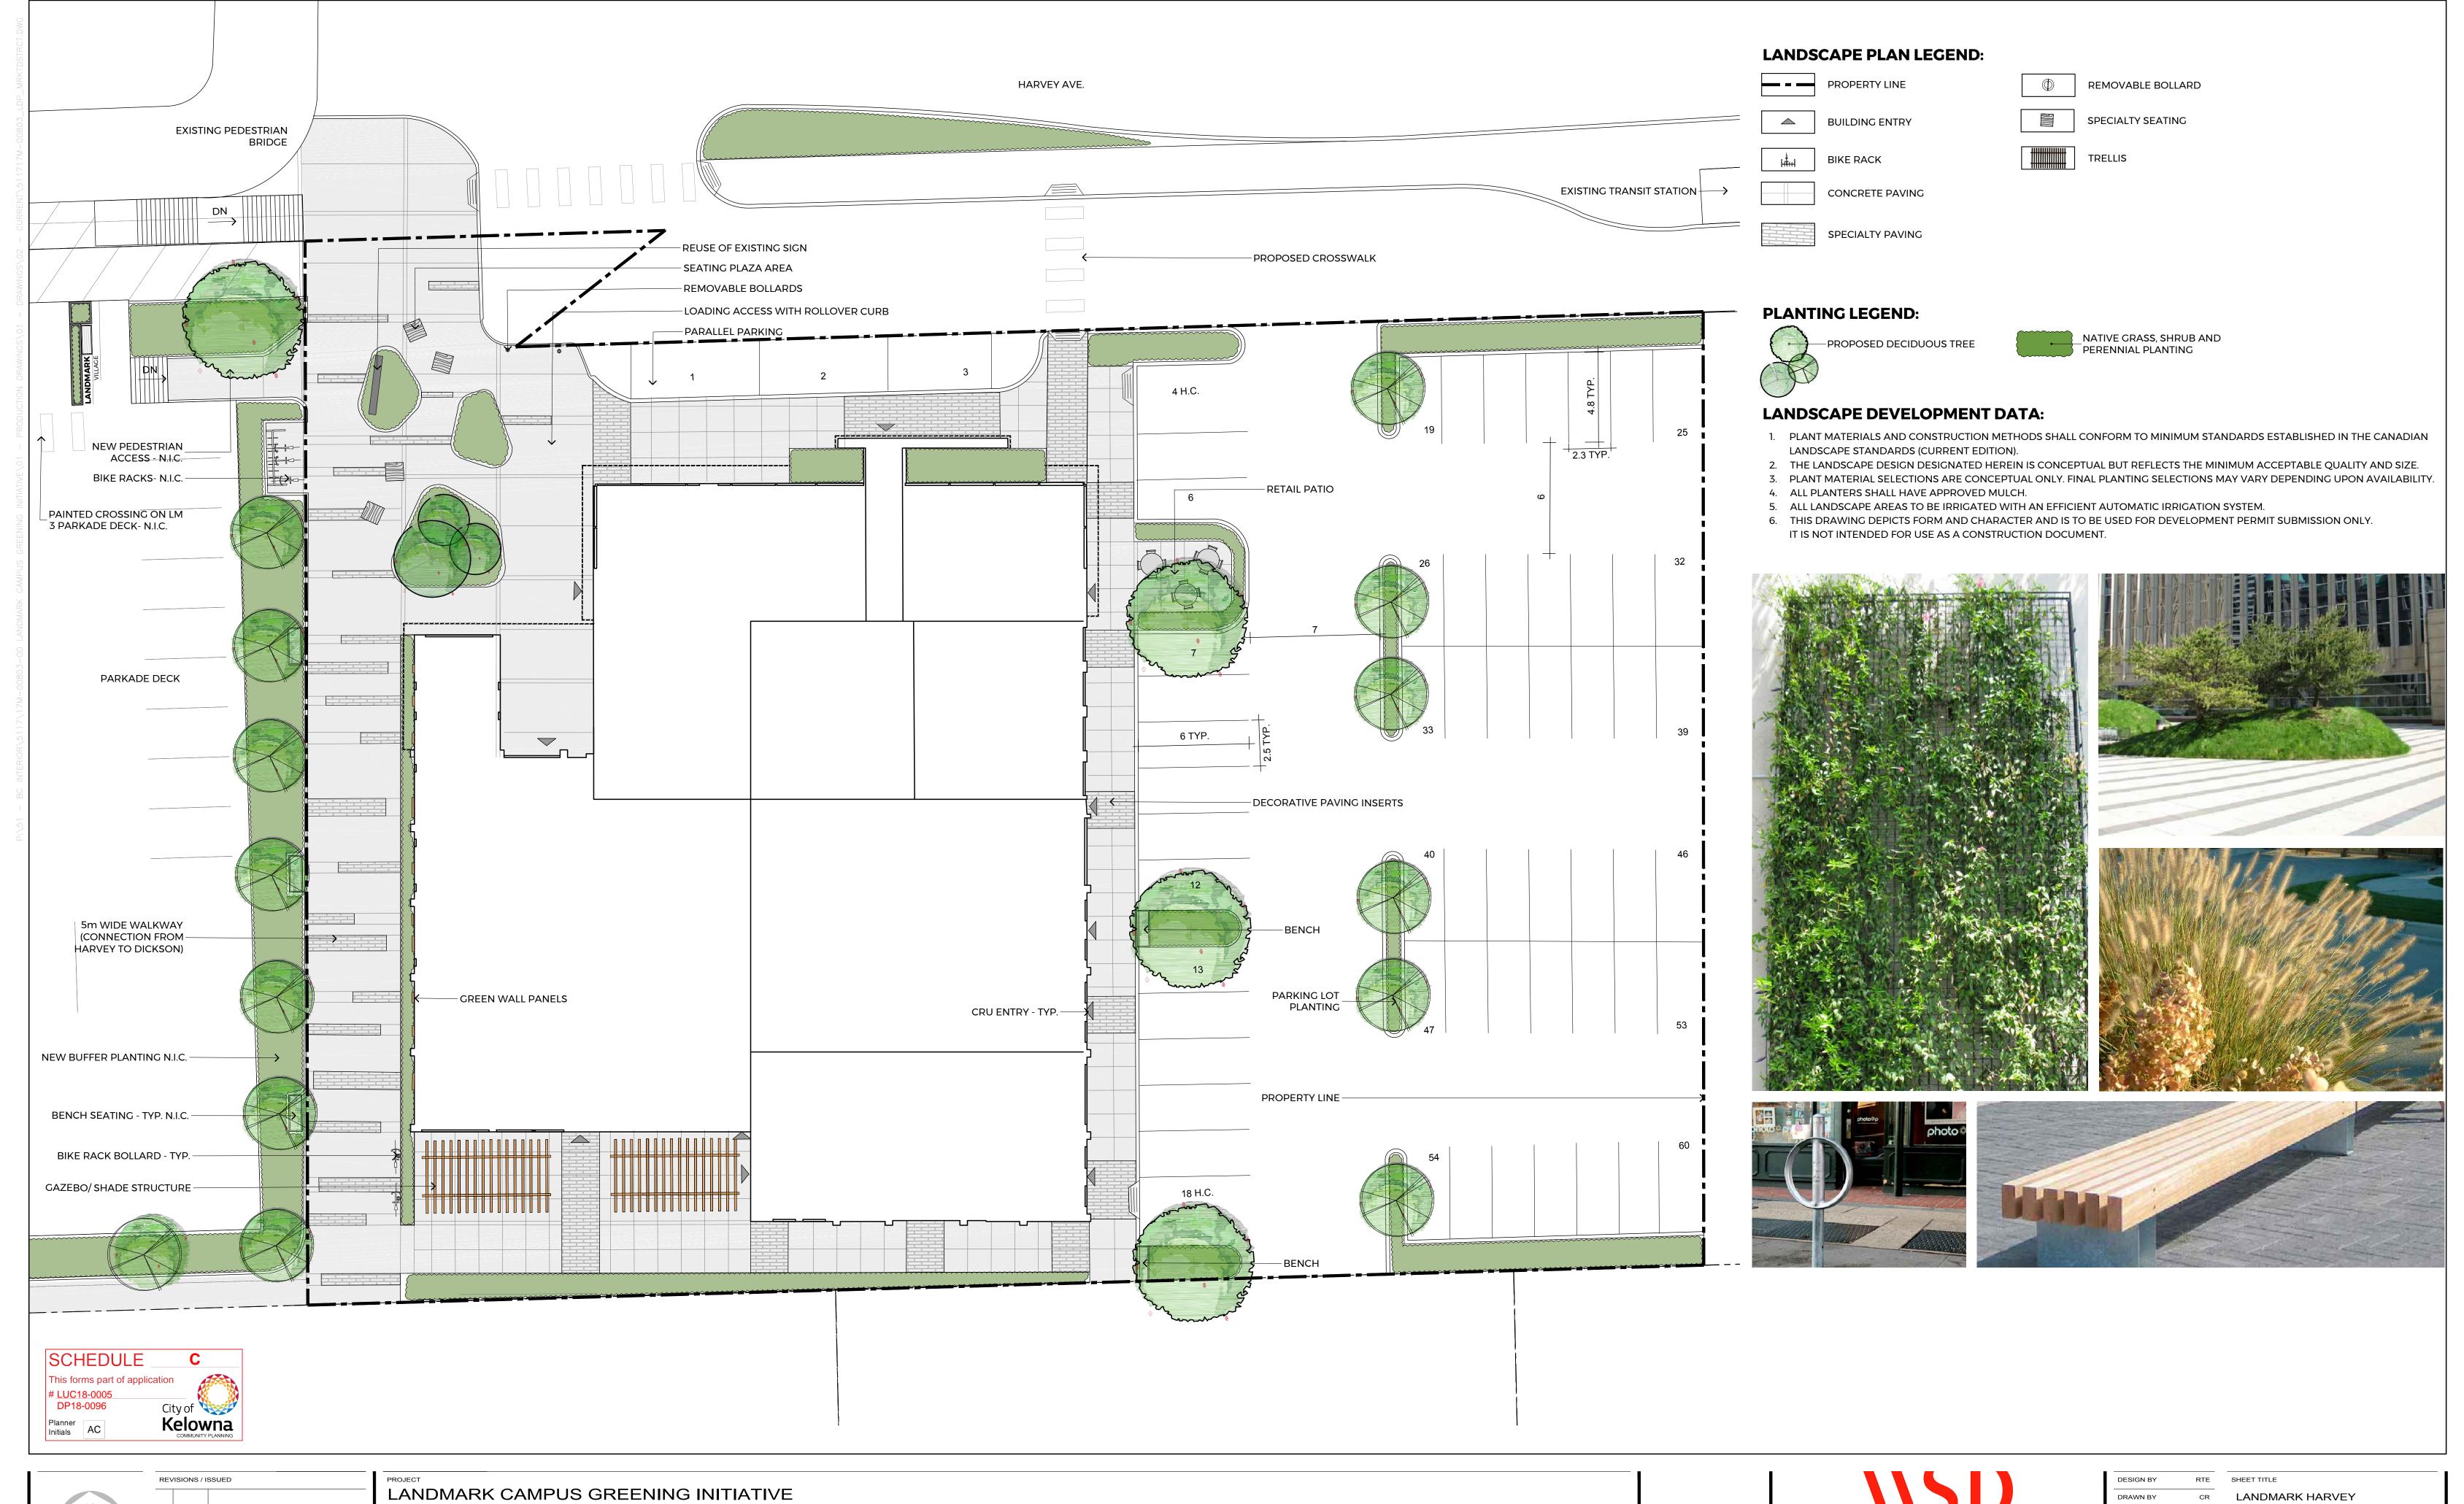

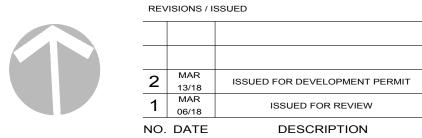

LANDMARK CAMPUS GREENING INITIATIV


CLIENT
AL STOBER CONSTRUCTION LTD.


CONSULTANT



_		
	DESIGN BY	RTE
	DRAWN BY	CR
	CHECKED BY	RF
	PROJECT NO.	17M-00803

LANDMARK HARVEY
LANDSCAPE PLAN
SHEET NO.

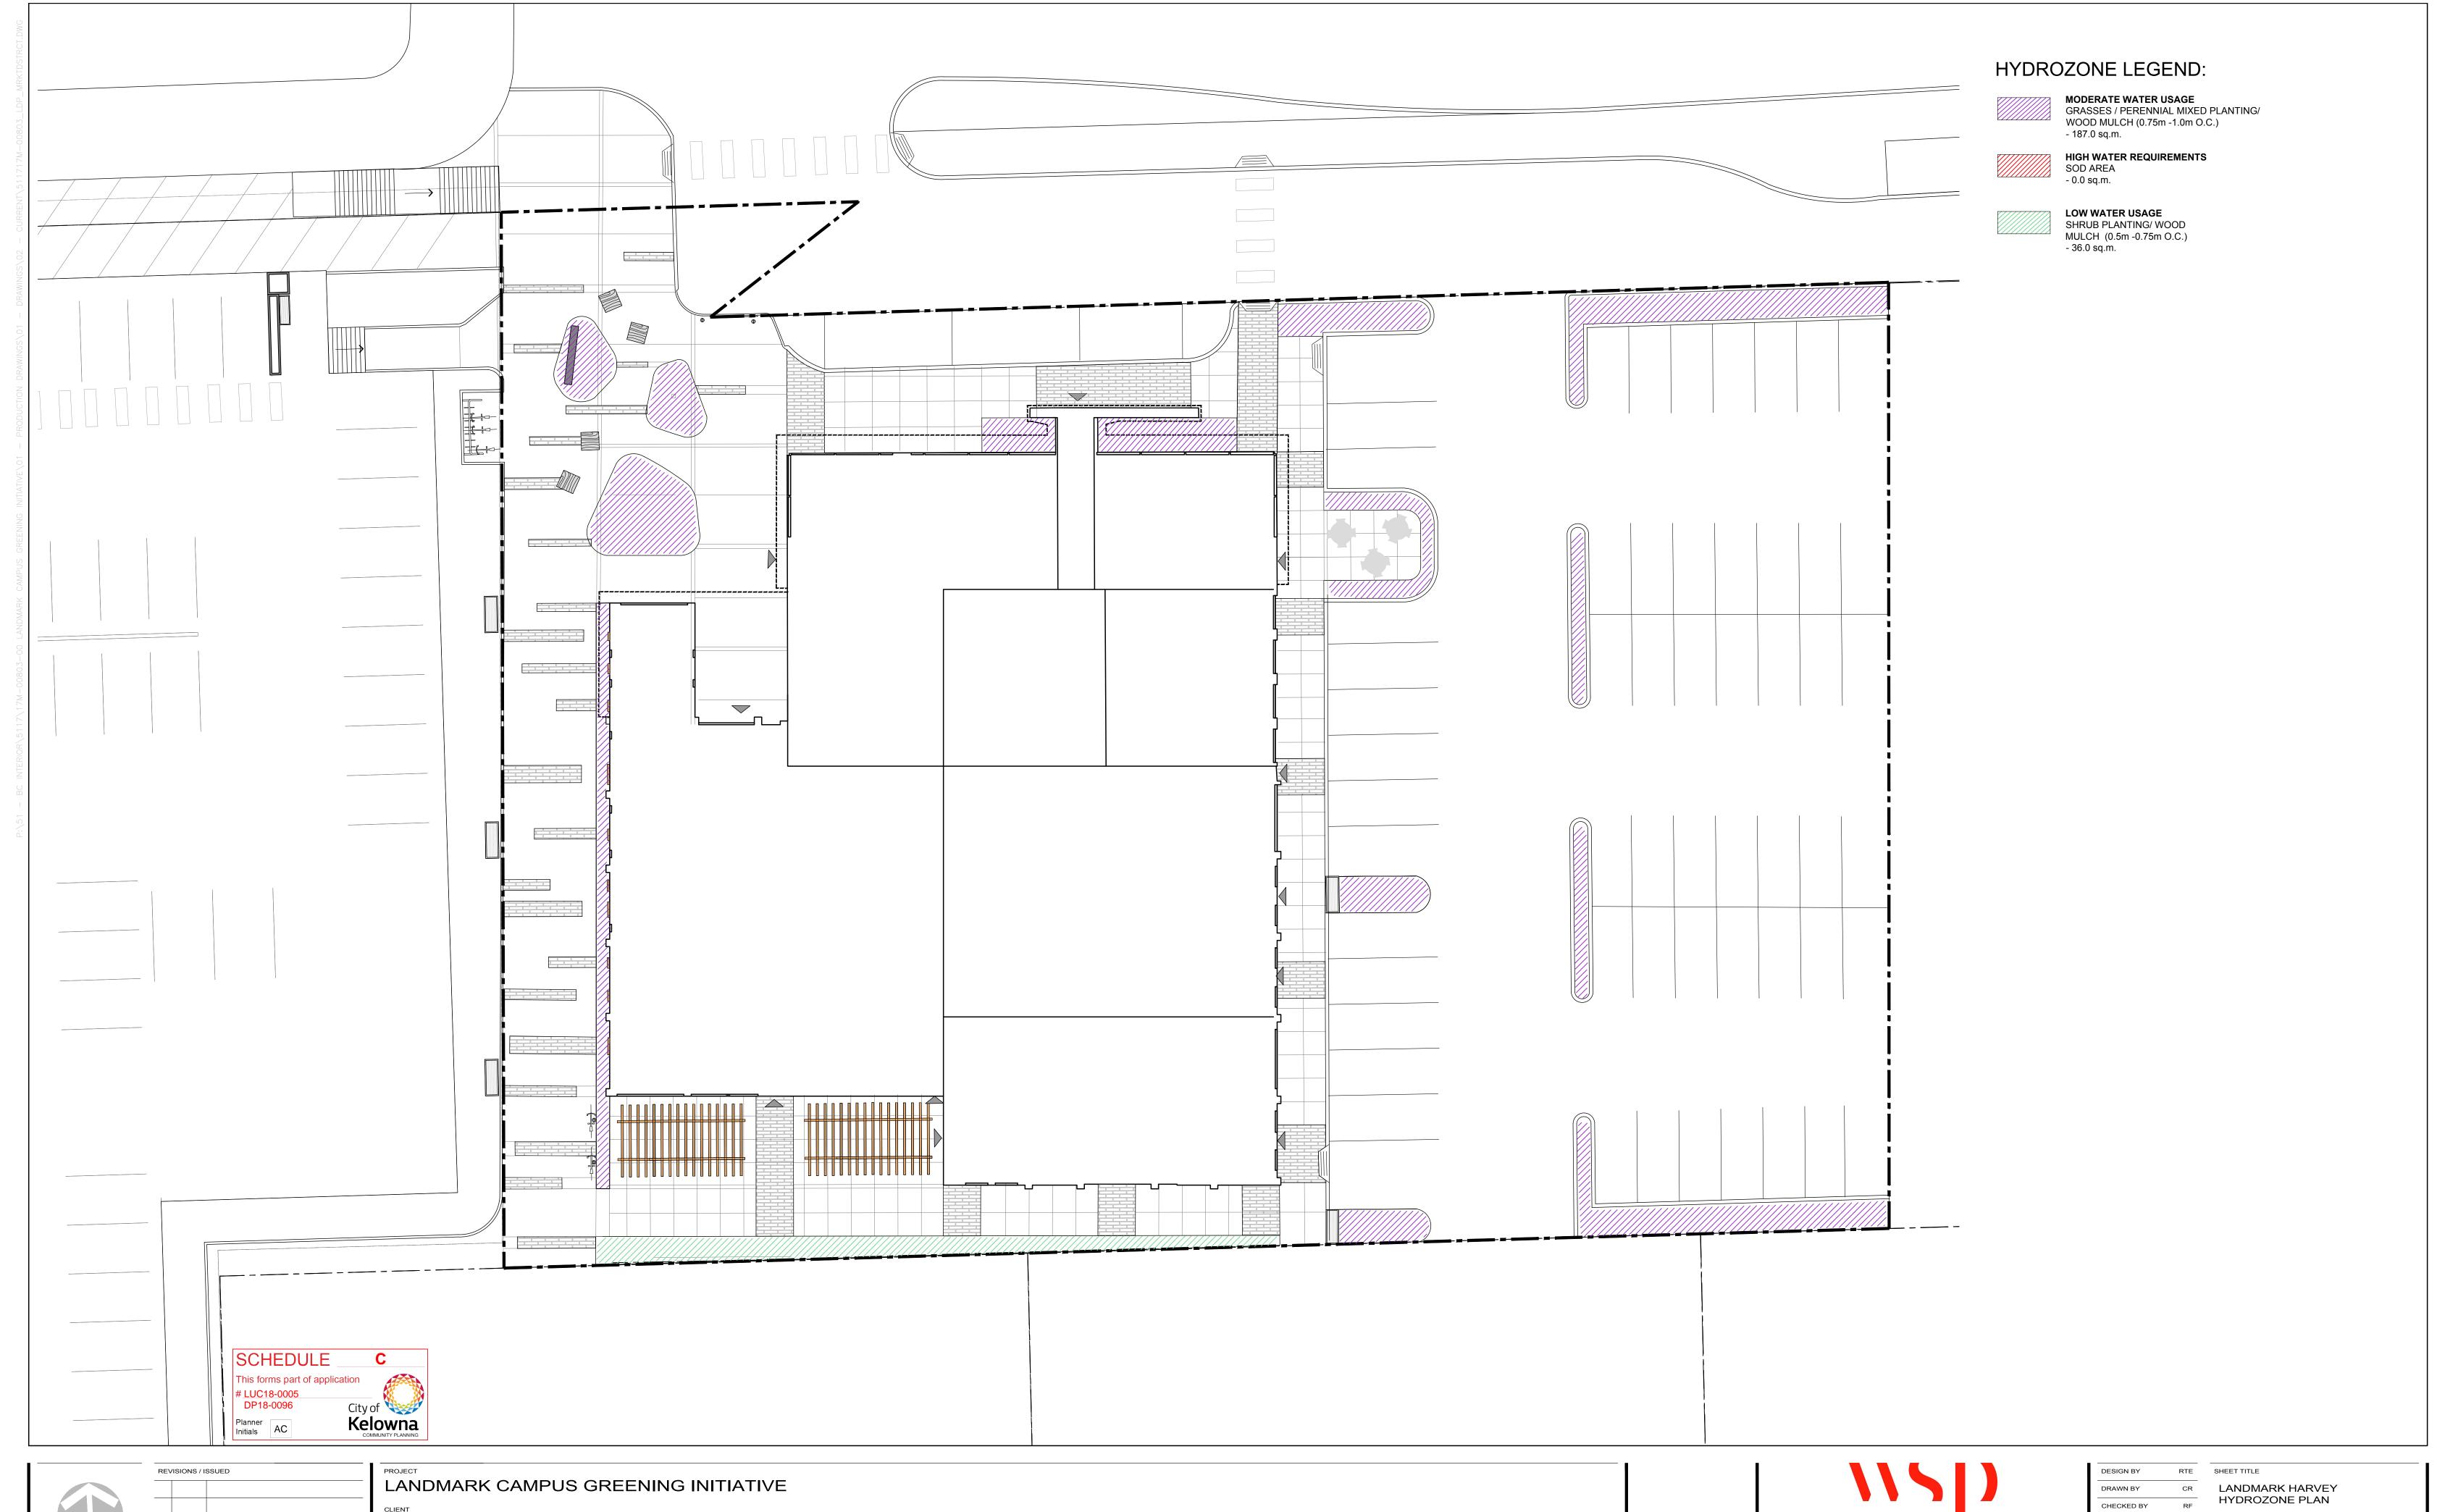

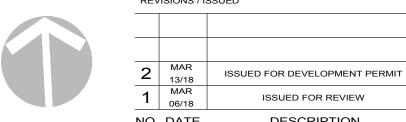

AL STOBER CONSTRUCTION LTD.

CONSULTANT

ISSUED FOR REVIEW

DESCRIPTION



DESIGN BY	RTE
DRAWN BY	CR
CHECKED BY	RF
PROJECT NO.	17M-00803
SCALE	

1:150 SHEET NO.

LDP- 2