CITY OF KELOWNA

MEMORANDUM

Date:

June 07, 2018

File No.:

Z18-0062

To:

Community Planning (LK)

From:

Development Engineering Manager (JK)

Subject:

555 Fuller Ave

ATTACHMENT A

This forms part of application

OCP18-0013 & Z18-0062

City of

Planner Initials

LK

Kelowna

RM5 to C7

Development Engineering Department have the following comments and requirements associated with this application. The road and utility upgrading requirements outlined in this report will be a requirement of this development. The Development Engineering Technologist for this project is Jason Angus.

.1) General

- a) Where there is a possibility of a high water table or surcharging of storm drains during major storm events, non-basement buildings may be required. This must be determined by the engineer and detailed on the Lot Grading Plan required in the drainage section.
- b) Provide easements as may be required.
- c) These are Development Engineering comments/requirements and are subject to the review and requirements from the Ministry of Transportation (MOTI) Infrastructure Branch.
- d) The address of this proposed development should be addressed off of Bertram St and not Fuller Ave.

.2) Road Dedication and Subdivision Requirements

- a) Access to the development should be via laneways.
- b) Laneway access from Bertram St should be designed to the SS-C7 standard with a continuous sidewalk at property line.

.3) Geotechnical Study.

(a) Provide a geotechnical report prepared by a Professional Engineer competent in the field of hydro-geotechnical engineering to address the items below: NOTE: The City is relying on the Geotechnical Engineer's report to prevent any damage to property and/or injury to persons from occurring as a result of problems with soil slippage or soil instability related to this proposed subdivision. The Geotechnical reports must be submitted to the Development Services Department for distribution to the Development Engineering Branch and Inspection Services Division prior

to submission of Engineering drawings or application for subdivision approval:

- i. Area ground water characteristics, including any springs and overland surface drainage courses traversing the property. Identify any monitoring required.
- ii. Site suitability for development.
- iii. Site soil characteristics (i.e. fill areas, sulphate content, unsuitable soils such as organic material, etc.).
- iv. Any special requirements for construction of roads, utilities and building structures.
- v. Recommendations for items that should be included in a Restrictive Covenant.
- vi. Recommendations for roof drains, perimeter drains and septic tank effluent on the site.
- vii. Any items required in other sections of this document.

Additional geotechnical survey may be necessary for building foundations, etc

.4) Water

- a) The property is located within the City of Kelowna service area. The existing lot is serviced with a small -diameter water service. Only one service will be permitted to the site or per property. The applicant, at his cost, will arrange for the removal of the existing service and the installation of one new larger metered water service.
- b) The developer's consulting engineer will determine the domestic and fire protection requirements of this proposed development and establish hydrant requirements and service needs. The bylaw requirement for commercial zoning is 150l/s and is available at the site. If it is determined that upgrades to any other existing water distribution system must be made to achieve the required fire flows, additional bonding will be required.
- c) An approved backflow protection devise must also be installed on site as required by the City Plumbing Regulation and Water Regulation bylaws.
- d) A water meter is mandatory for this development and must be installed inside a building on the water service inlet as required by the City Plumbing Regulation and Water Regulation bylaws. The developer or building contractor must purchase the meter from the City at the time of application for a building permit from the Inspection Services Department, and prepare the meter setter at his cost

.5) Sanitary Sewer

a) The developer's consulting mechanical engineer will determine the development requirements of this proposed development and establish the service needs. Only one service will be permitted for this development. The applicant, at his cost, will arrange for the removal and

disconnection of the existing service and the installation of one new larger service.

.6) Drainage

- a) The developer must engage a consulting civil engineer to provide a storm water management plan for the site, which meets the requirements of the City Storm Water Management Policy and Design Manual. The storm water management plan must also include provision of lot grading plan, minimum basement elevation (MBE), if applicable, and provision of a storm drainage service for the development and / or recommendations for onsite drainage containment and disposal systems.
- b) It will be necessary for the developer to construct storm drainage facilities on Bertram Street and the laneway to accommodate road drainage fronting the proposed development.
- c) Provide a detailed Stormwater Management Plan for this development as per the Subdivision, Development and Servicing Bylaw #7900.
- d) There is a possibility of a high water table or surcharging of storm drains during major storm events. This should be considered in the design of the onsite system.

.7) Roads

- a) Bertram Street is designated an urban collector road. Frontage improvements required include curb and gutter, separate sidewalk, piped storm drainage system, road works, landscaped boulevard complete with underground irrigation system, street lights. A modified SS-R5 cross section will be used and provided at the time of design. The design should include up to centreline of the Bertram Street ROW.
- b) The lane way is designated to be constructed to a commercial cross section of SS-R2. Storm drainage system will be required for this laneway.

.9) Power and Telecommunication Services and Street Lights

- a) All proposed distribution and service connections are to be installed underground. Existing distribution and service connections, on that portion of a road immediately adjacent to the site, are to be relocated and installed underground as the subject properties are within the "City Center Urban Center".
- b) Streetlights must be installed on all roads.
- c) Make servicing applications to the respective Power and Telecommunication utility companies. The utility companies are required to obtain the City's approval before commencing construction.
- d) Re-locate existing poles and utilities, where necessary. Remove aerial trespass (es).

.10) Design and Construction

a) Design, construction supervision and inspection of all off-site civil works and site servicing must be performed by a Consulting Civil Engineer and

- all such work is subject to the approval of the City Engineer. Drawings must conform to City standards and requirements.
- b) Engineering drawing submissions are to be in accordance with the City's "Engineering Drawing Submission Requirements" Policy. Please note the number of sets and drawings required for submissions.
- c) Quality Control and Assurance Plans must be provided in accordance with the Subdivision, Development & Servicing Bylaw No. 7900 (refer to Part 5 and Schedule 3).
- d) A "Consulting Engineering Confirmation Letter" (City document 'C') must be completed prior to submission of any designs.
- e) Before any construction related to the requirements of this subdivision application commences, design drawings prepared by a professional engineer must be submitted to the City's Development Engineering Department. The design drawings must first be "Issued for Construction" by the City Engineer. On examination of design drawings, it may be determined that rights-of-way are required for current or future needs.

.11) Other Engineering Comments

- a) Provide all necessary Statutory Rights-of-Way for any utility corridors required, including those on proposed or existing City Lands, and for public access to Vaughan Ave via the proposed lane.
- b) If any road dedication affects lands encumbered by a Utility right-of-way (such as Terasen, etc.) please obtain the approval of the utility prior to application for final subdivision approval. Any works required by the utility as a consequence of the road dedication must be incorporated in the construction drawings submitted to the City's Development Manager.

.12) Servicing Agreements for Works and Services

- b) A Servicing Agreement is required for all works and services on City lands in accordance with the Subdivision, Development & Servicing Bylaw No. 7900. The applicant's Engineer, prior to preparation of Servicing Agreements, must provide adequate drawings and estimates for the required works. The Servicing Agreement must be in the form as described in Schedule 2 of the bylaw.
- c) Part 3, "Security for Works and Services", of the Bylaw, describes the Bonding and Insurance requirements of the Owner. The liability limit is not to be less than \$5,000,000 and the City is to be named on the insurance policy as an additional insured.

.13) Charges and Fees

- a) Development Cost Charges (DCC's) are payable
- b) Fees per the "Development Application Fees Bylaw" include:
 - i) Street/Traffic Sign Fees: at cost if required (to be determined after design).
 - ii) Survey Monument, Replacement Fee: \$1,200.00 (GST exempt) only if disturbed.

Engineering and Inspection Fee: 3.5% of construction value (plus GST). iii)

James Kay, P.Eng. Development Engineering Manager

CITY OF KELOWNA

MEMORANDUM

Date:

June 06, 2018

File No.:

OCP18-0013

To:

Community Planning (LK)

From:

Development Engineering Manager (JK)

Subject:

555 Fuller Ave

ATTACHMENT

This forms part of application # OCP18-0013 & Z18-0062

Planner LK Initials

City of Kelowna

MRM - MXR

The Development Engineering Branch comments and requirements regarding this OCP amendment application are as follows:

1. General

All the offsite infrastructure and services upgrades are addressed in the Rezoning Engineering Report under file Z18-0062

James Kay, P. Eng. Development Engineering Manager

DEVELOPMENT APPROVALS PRELIMINARY BYLAW COMMUNICATION

Your File #: Z18-0062 eDAS File #: 2018-02840 Date: Jun/18/2018



City of Kelowna 1435 Water Street Kelowna, British Columbia V1Y 1J4 Canada

Re: Proposed Bylaw – RM5-C7:

555 Fuller Avenue, Kelowna

Preliminary Approval is granted for the rezoning for one year pursuant to Section 52(3)(a) of the *Transportation Act*.

If you have any questions please feel free to call Kelowna Development Approvals at (250) 712-3660.


Yours truly,

Audrie Henry

District Development Technician

subrile Hewry

Kelowna Area Office 300-1358 St. Paul Street Kelowna, BC V1Y 2E1 Canada Phone: (250) 712-3660 Fax: (250) 712-3669

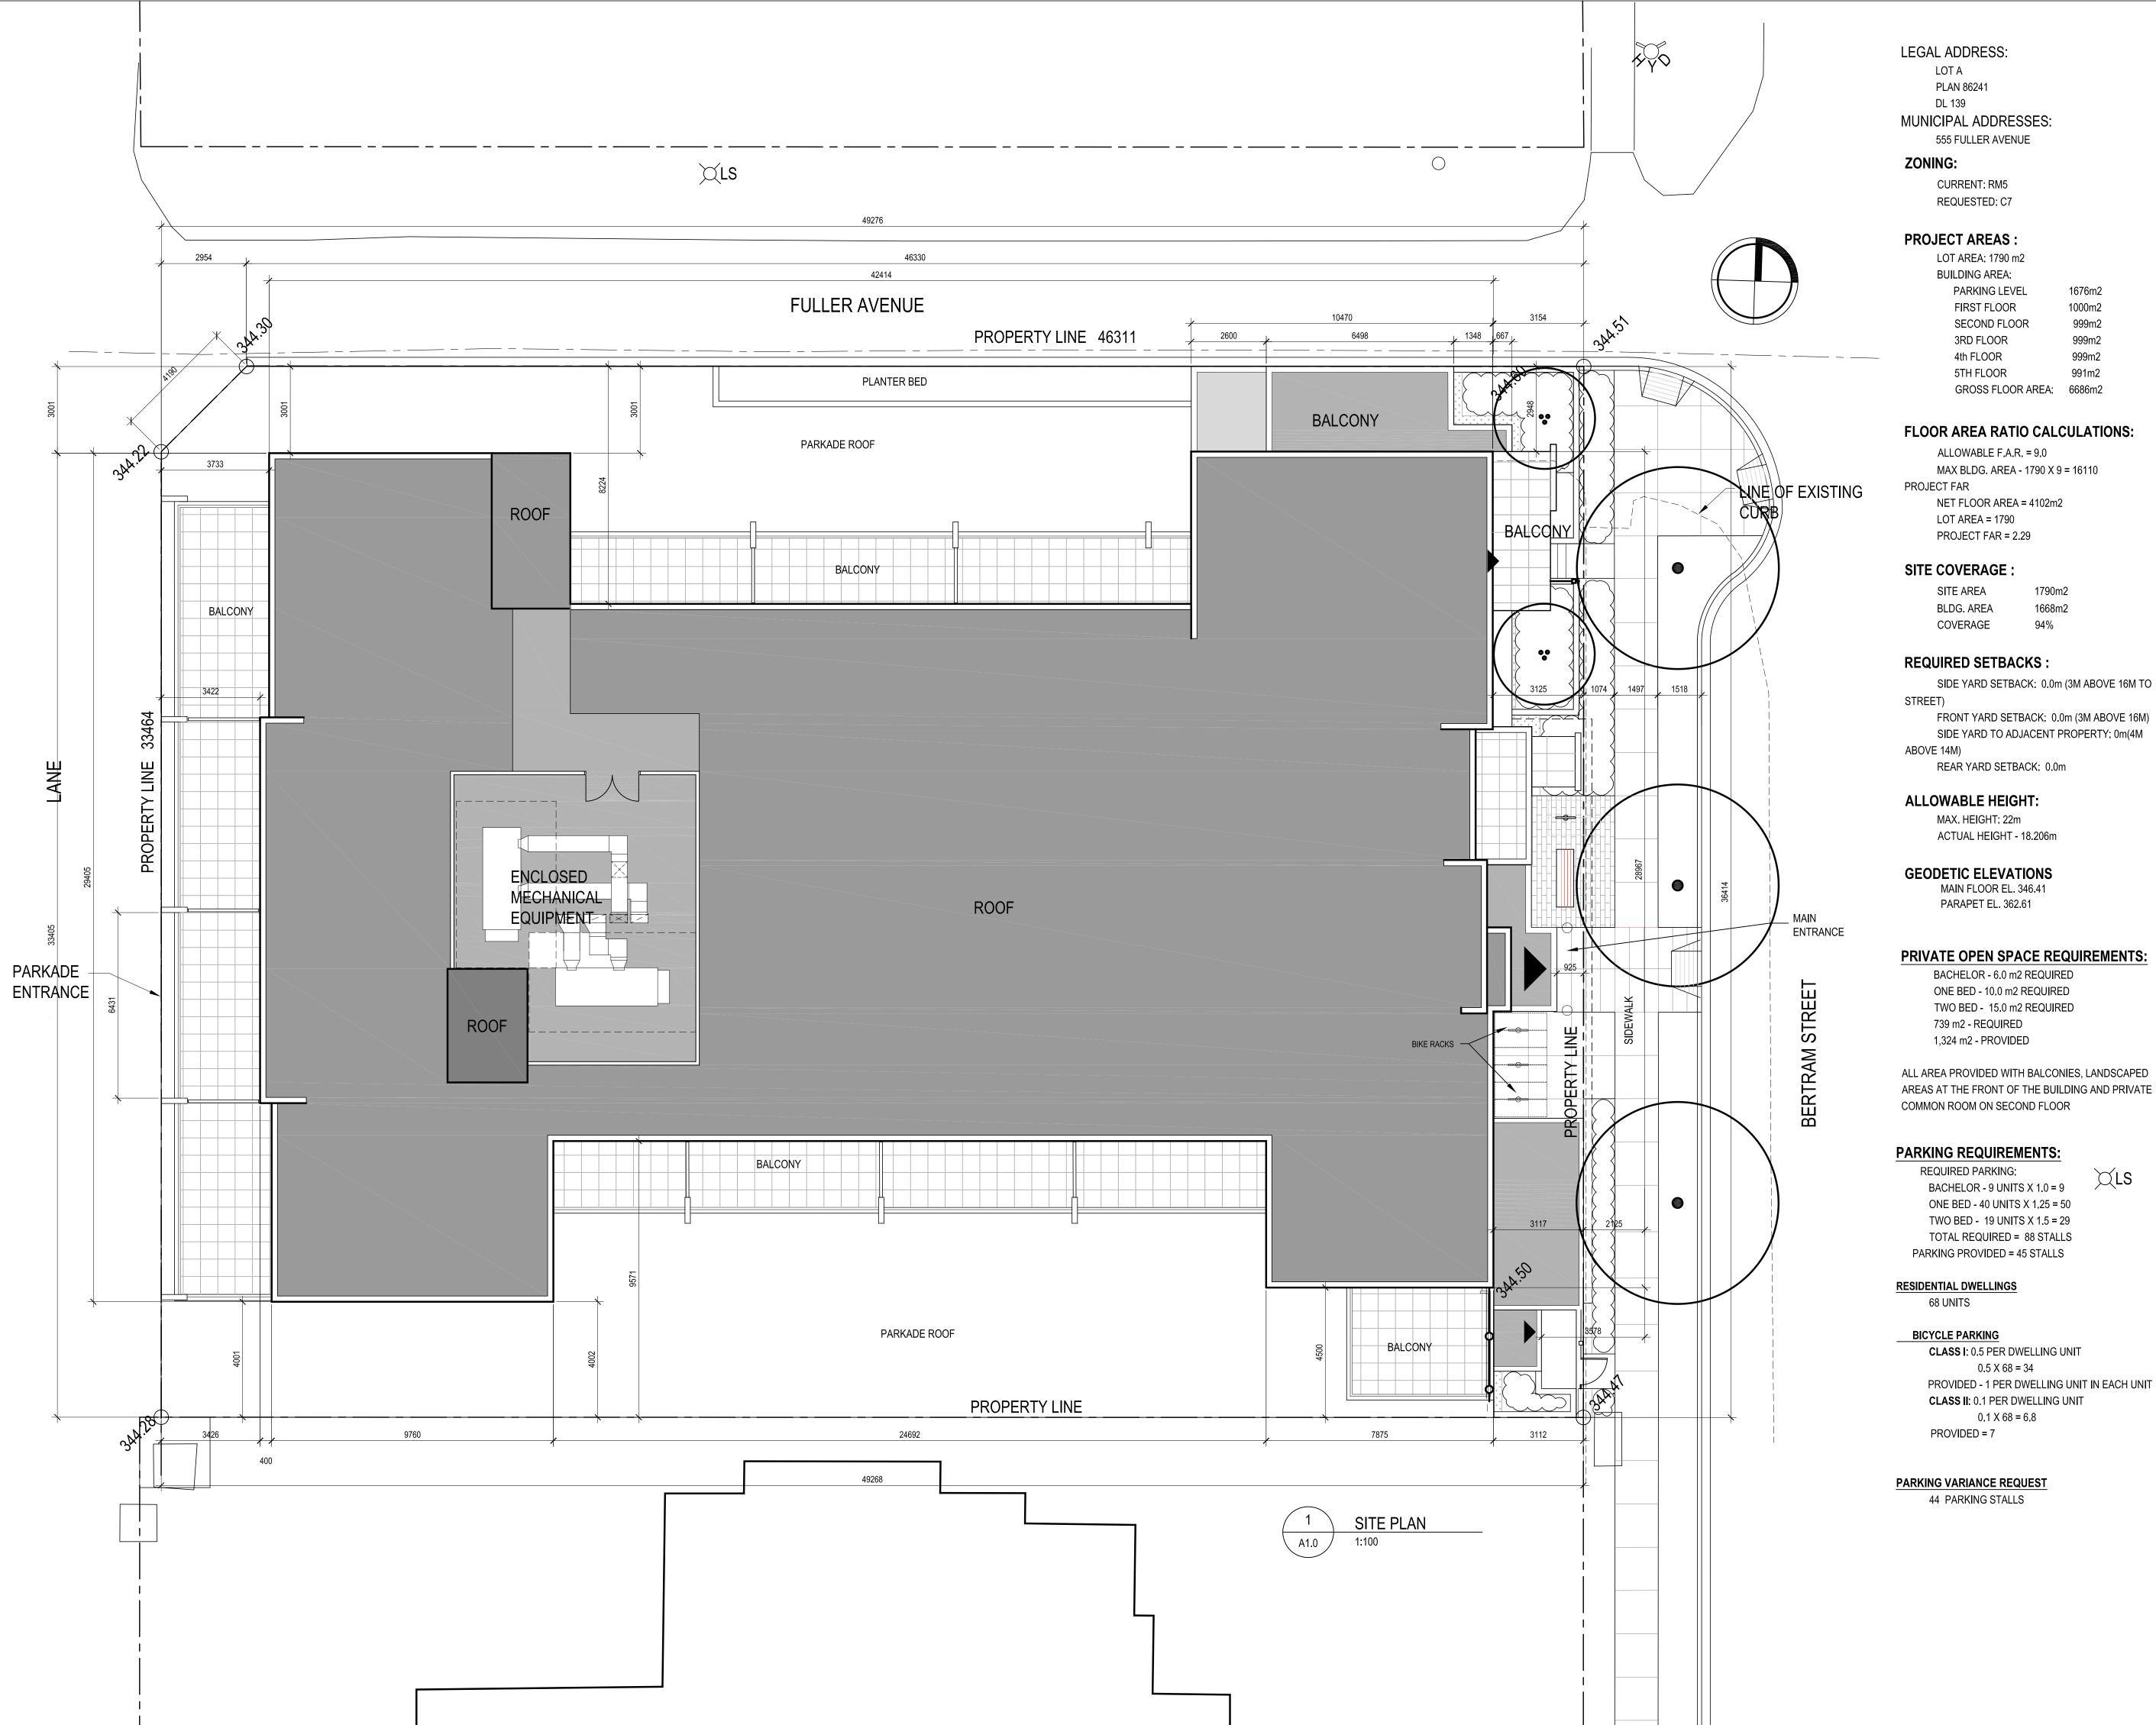

DATE BC Housing review
DP Submission
DP Revisions
DP Revisions
DP Revisions
DP Revisions April 6, 2018 May 5, 2018 August 16, 2018 September 17, 2018 October 2, 2018 October 15, 2018

PROFESSIONAL SEAL(s)

CONSULTANTS DiStefano Jaud, Architecture

1676m2

1000m2

999m2

999m2 999m2

991m2

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not be reproduced or used without the permission of the designer.

The contractor shall verify all dimensions and specifications before and during the construction project. Any errors, omissions and misunderstanding must be reported to the Architect.

PRIVATE OPEN SPACE REQUIREMENTS:

BACHELOR - 6.0 m2 REQUIRED ONE BED - 10.0 m2 REQUIRED TWO BED - 15.0 m2 REQUIRED

ALL AREA PROVIDED WITH BALCONIES, LANDSCAPED AREAS AT THE FRONT OF THE BUILDING AND PRIVATE

BACHELOR - 9 UNITS X 1.0 = 9ONE BED - 40 UNITS X 1.25 = 50 TWO BED - 19 UNITS X 1.5 = 29 TOTAL REQUIRED = 88 STALLS

CLASS I: 0.5 PER DWELLING UNIT

PROVIDED - 1 PER DWELLING UNIT IN EACH UNIT CLASS II: 0.1 PER DWELLING UNIT

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DISTEFANO JAUD ARCHITECTURE

3 - 1331 Ellis Street Kelowna, British Columbia, V1Y 1Z9 T 250 868-9278 F 250 868-9217 WWW.DISTEFANOJAUD.COM

Pathways Abilities

PROJECT NUMBER DJA 2017-24

PROJECT LOCATION

Kelowna

SHEET TITLE Site Plan

October 15, 2018


SHEET NUMBER

1:100

GENERAL NOTES:

PROJECT PROPERTY LIES OUTSIDE OF CIVIC PRECINCT BOUNDARY



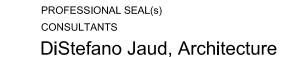

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Pathways Abilities

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PROJECT NUMBER DJA 2017-24

PROJECT LOCATION


Kelowna


SHEET TITLE Bylaw Review Diagrams

October 15, 2018

SHEET NUMBER

1:200

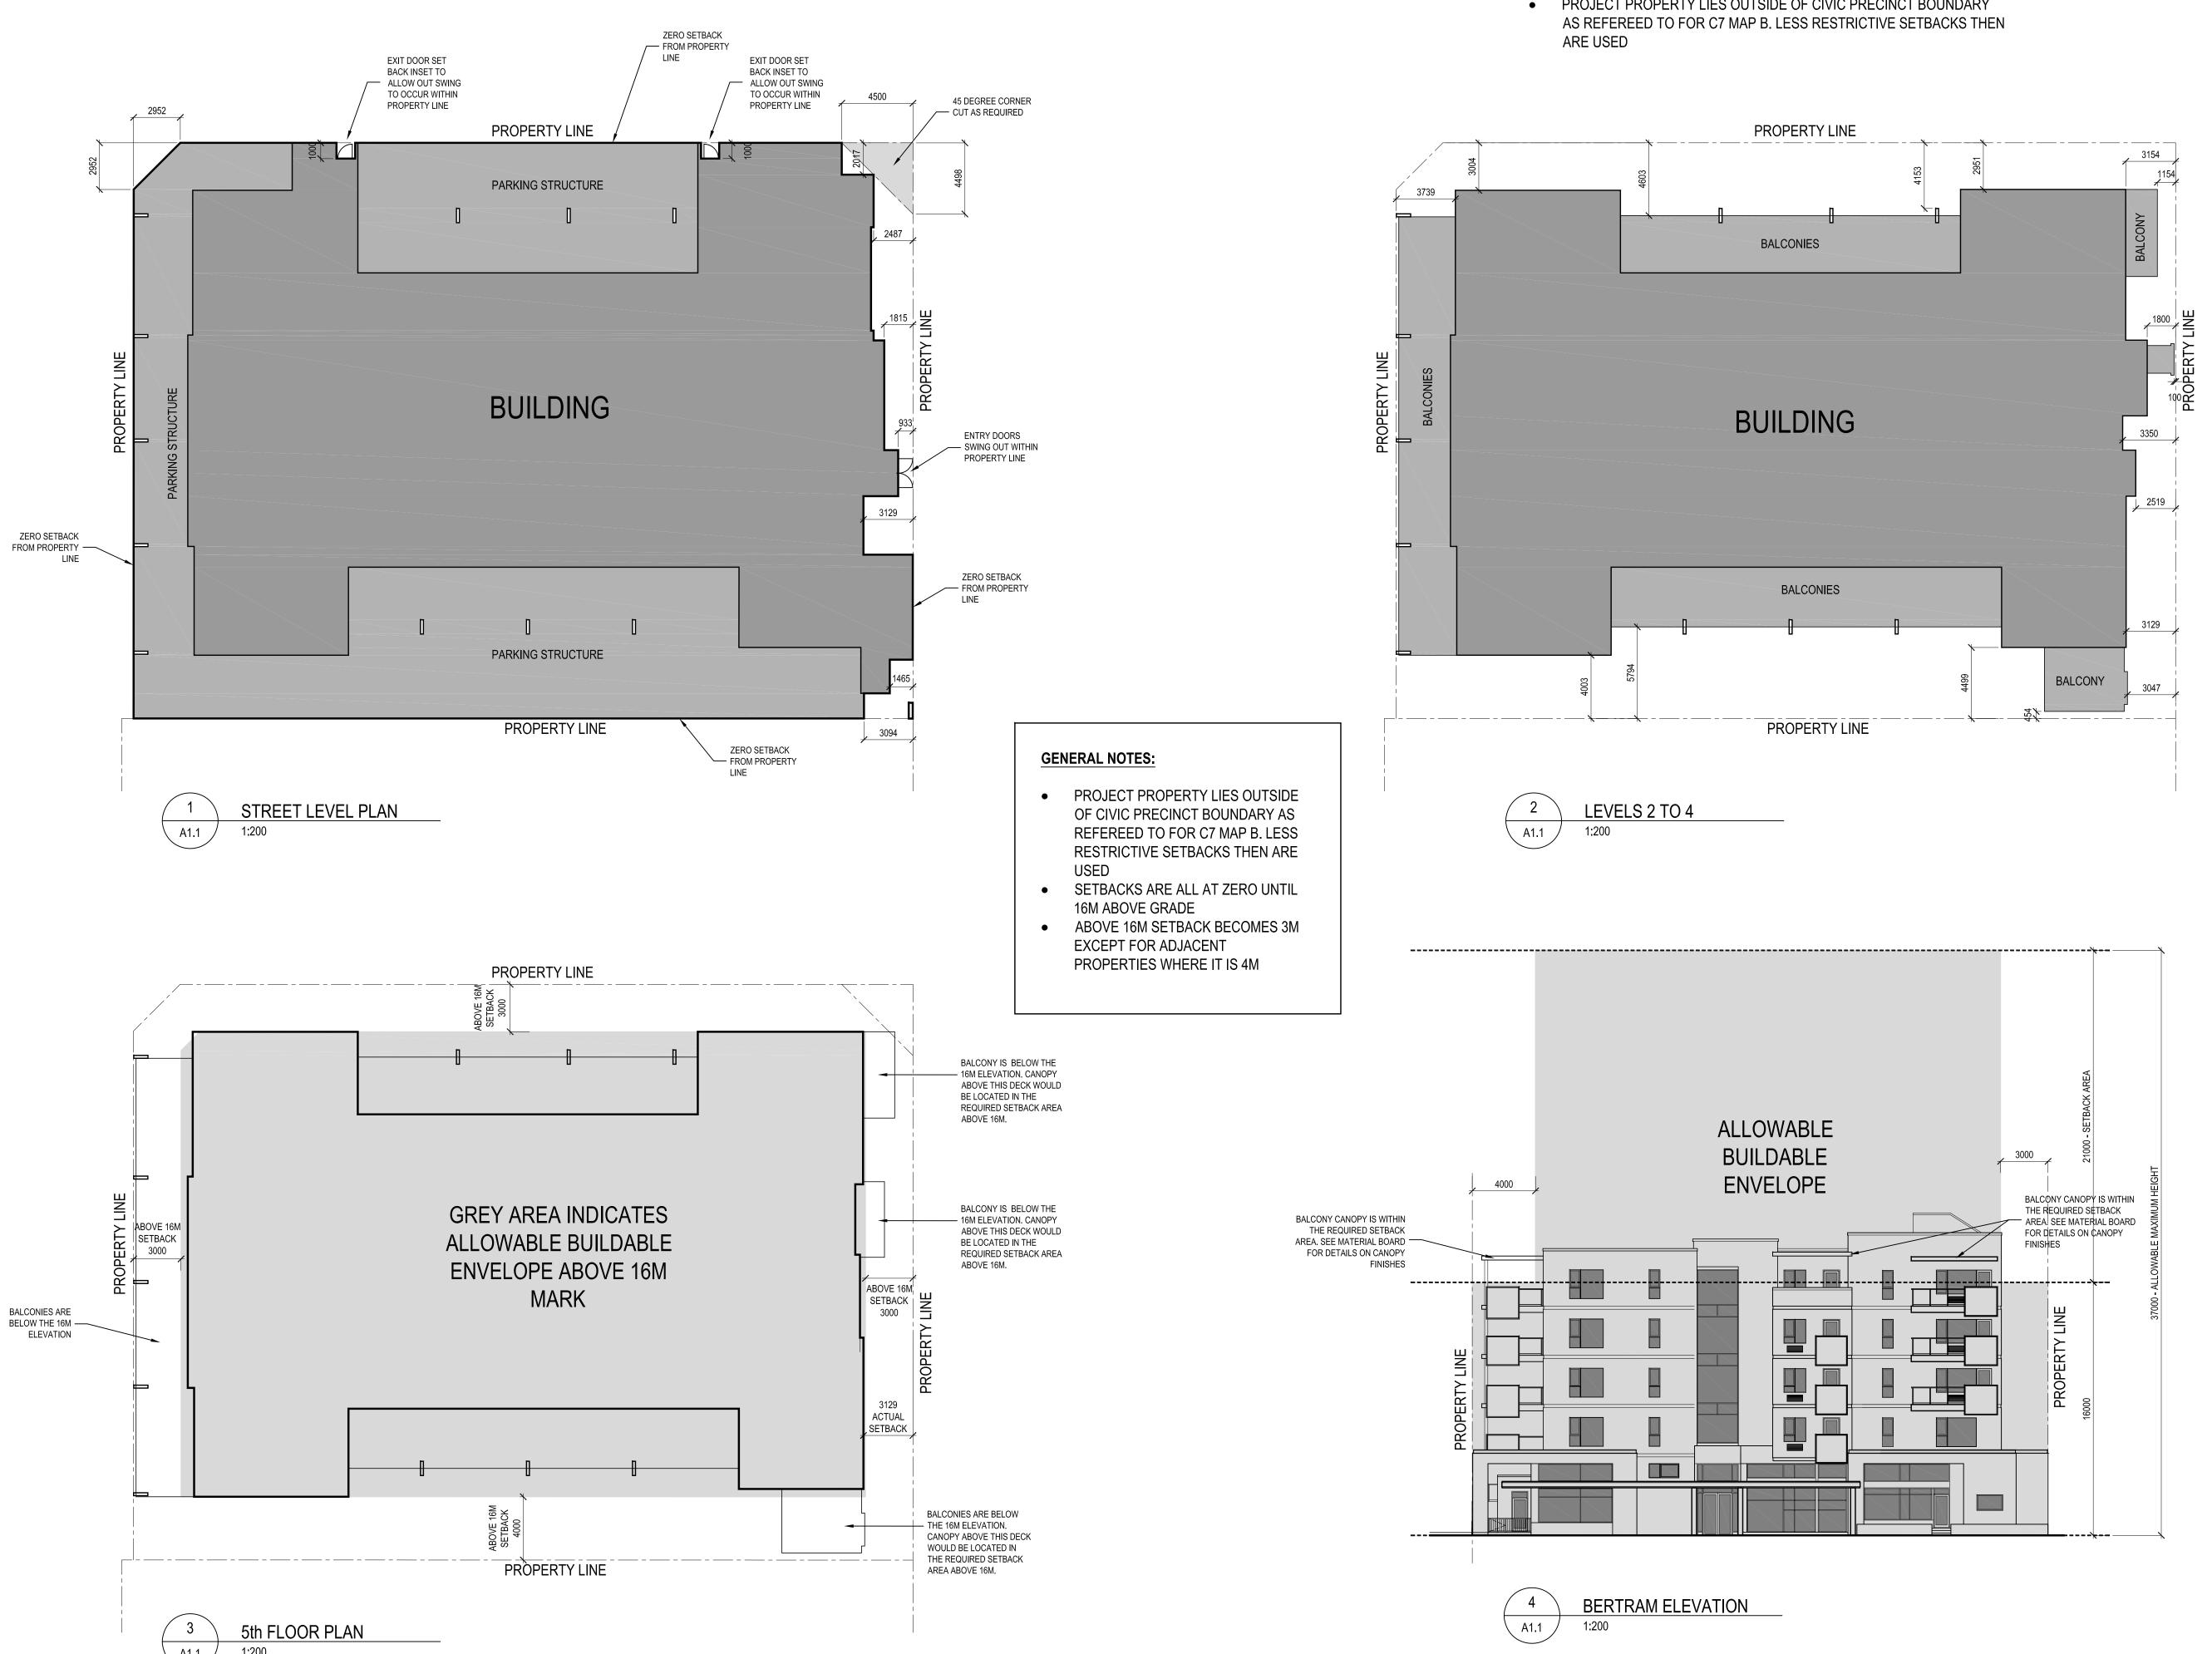

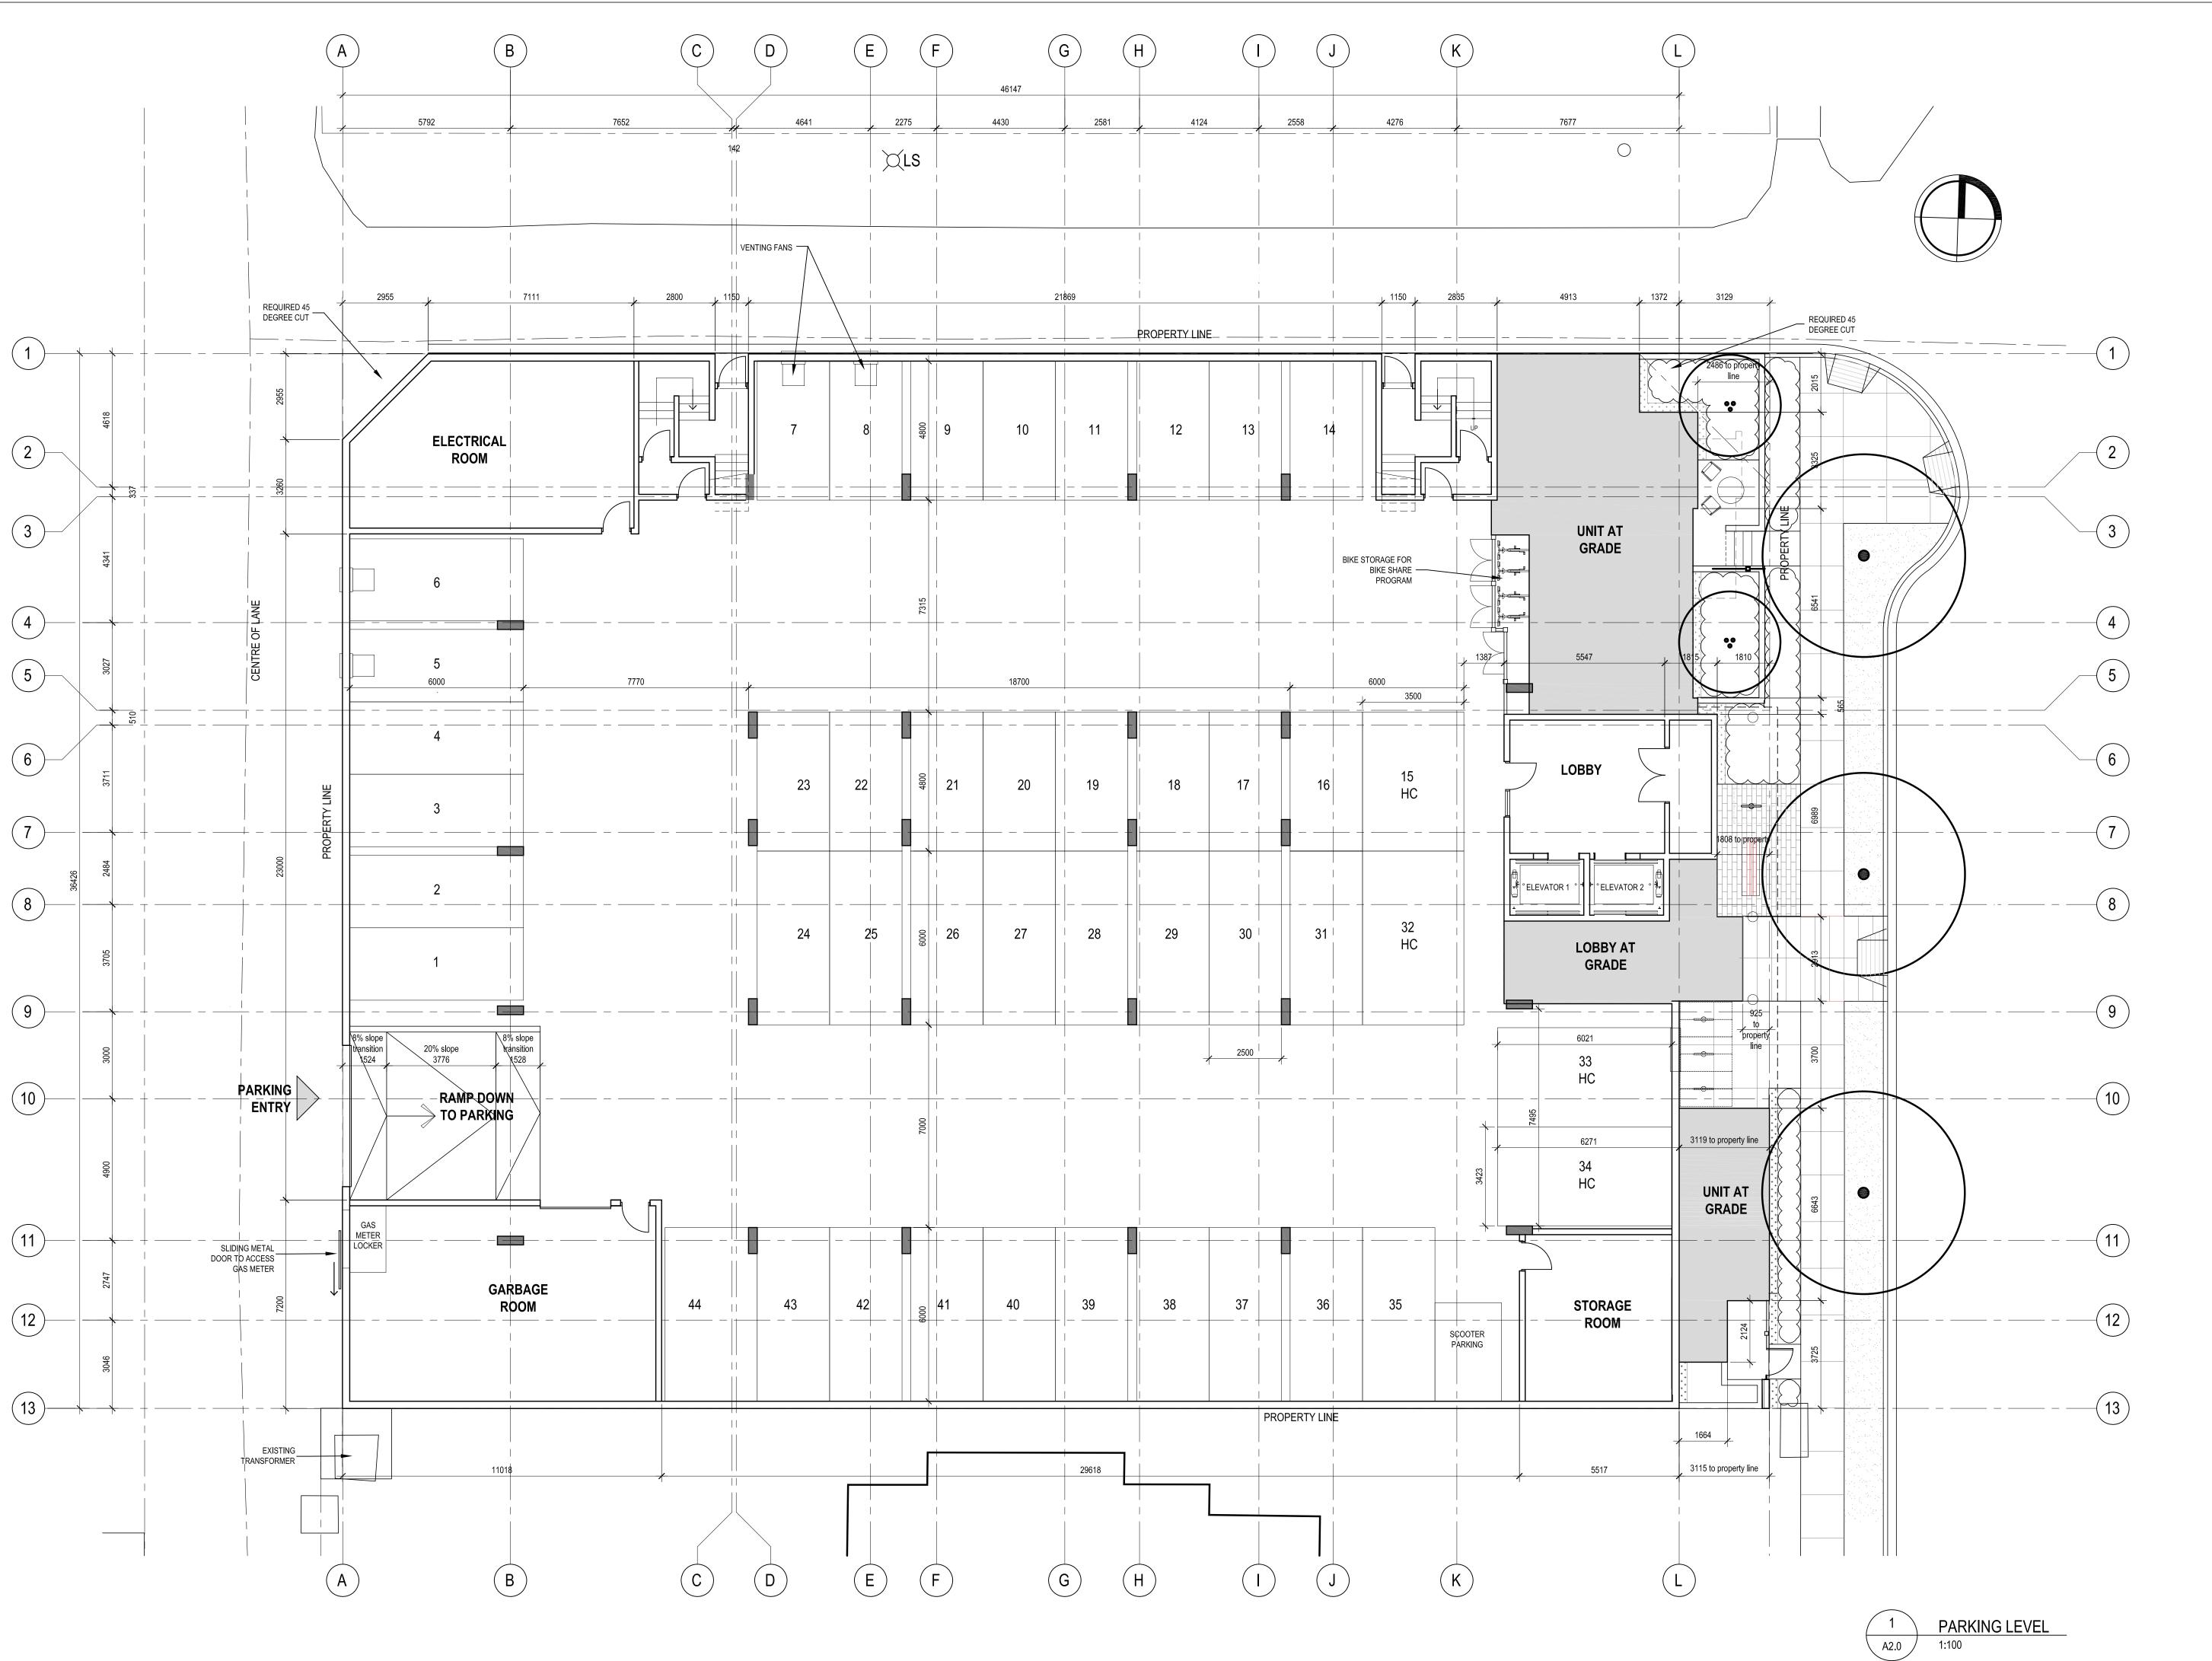

DATE Apr**il** 6, 2018 May 5, 2018 BC Housing review DP Submission
DP Revisions August 16, 2018 September 17, 2018 DP Revisions

October 15, 2018

PROFESSIONAL SEAL(s) CONSULTANTS DiStefano Jaud, Architecture

DP Revisions

Robert Turik (retired) CONSULTING ARCHITECT

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Kelowna, British Columbia, V1Y 1Z9 T 250 868-9278 F 250 868-9217 WWW.DISTEFANOJAUD.COM

Pathways Abilities Society

PROJECT NUMBER

DJA 2017-24 PROJECT LOCATION


Fuller Ave. Kelowna

SHEET TITLE Parking Plan

October 15, 2018

SHEET NUMBER

SCALE 1:100

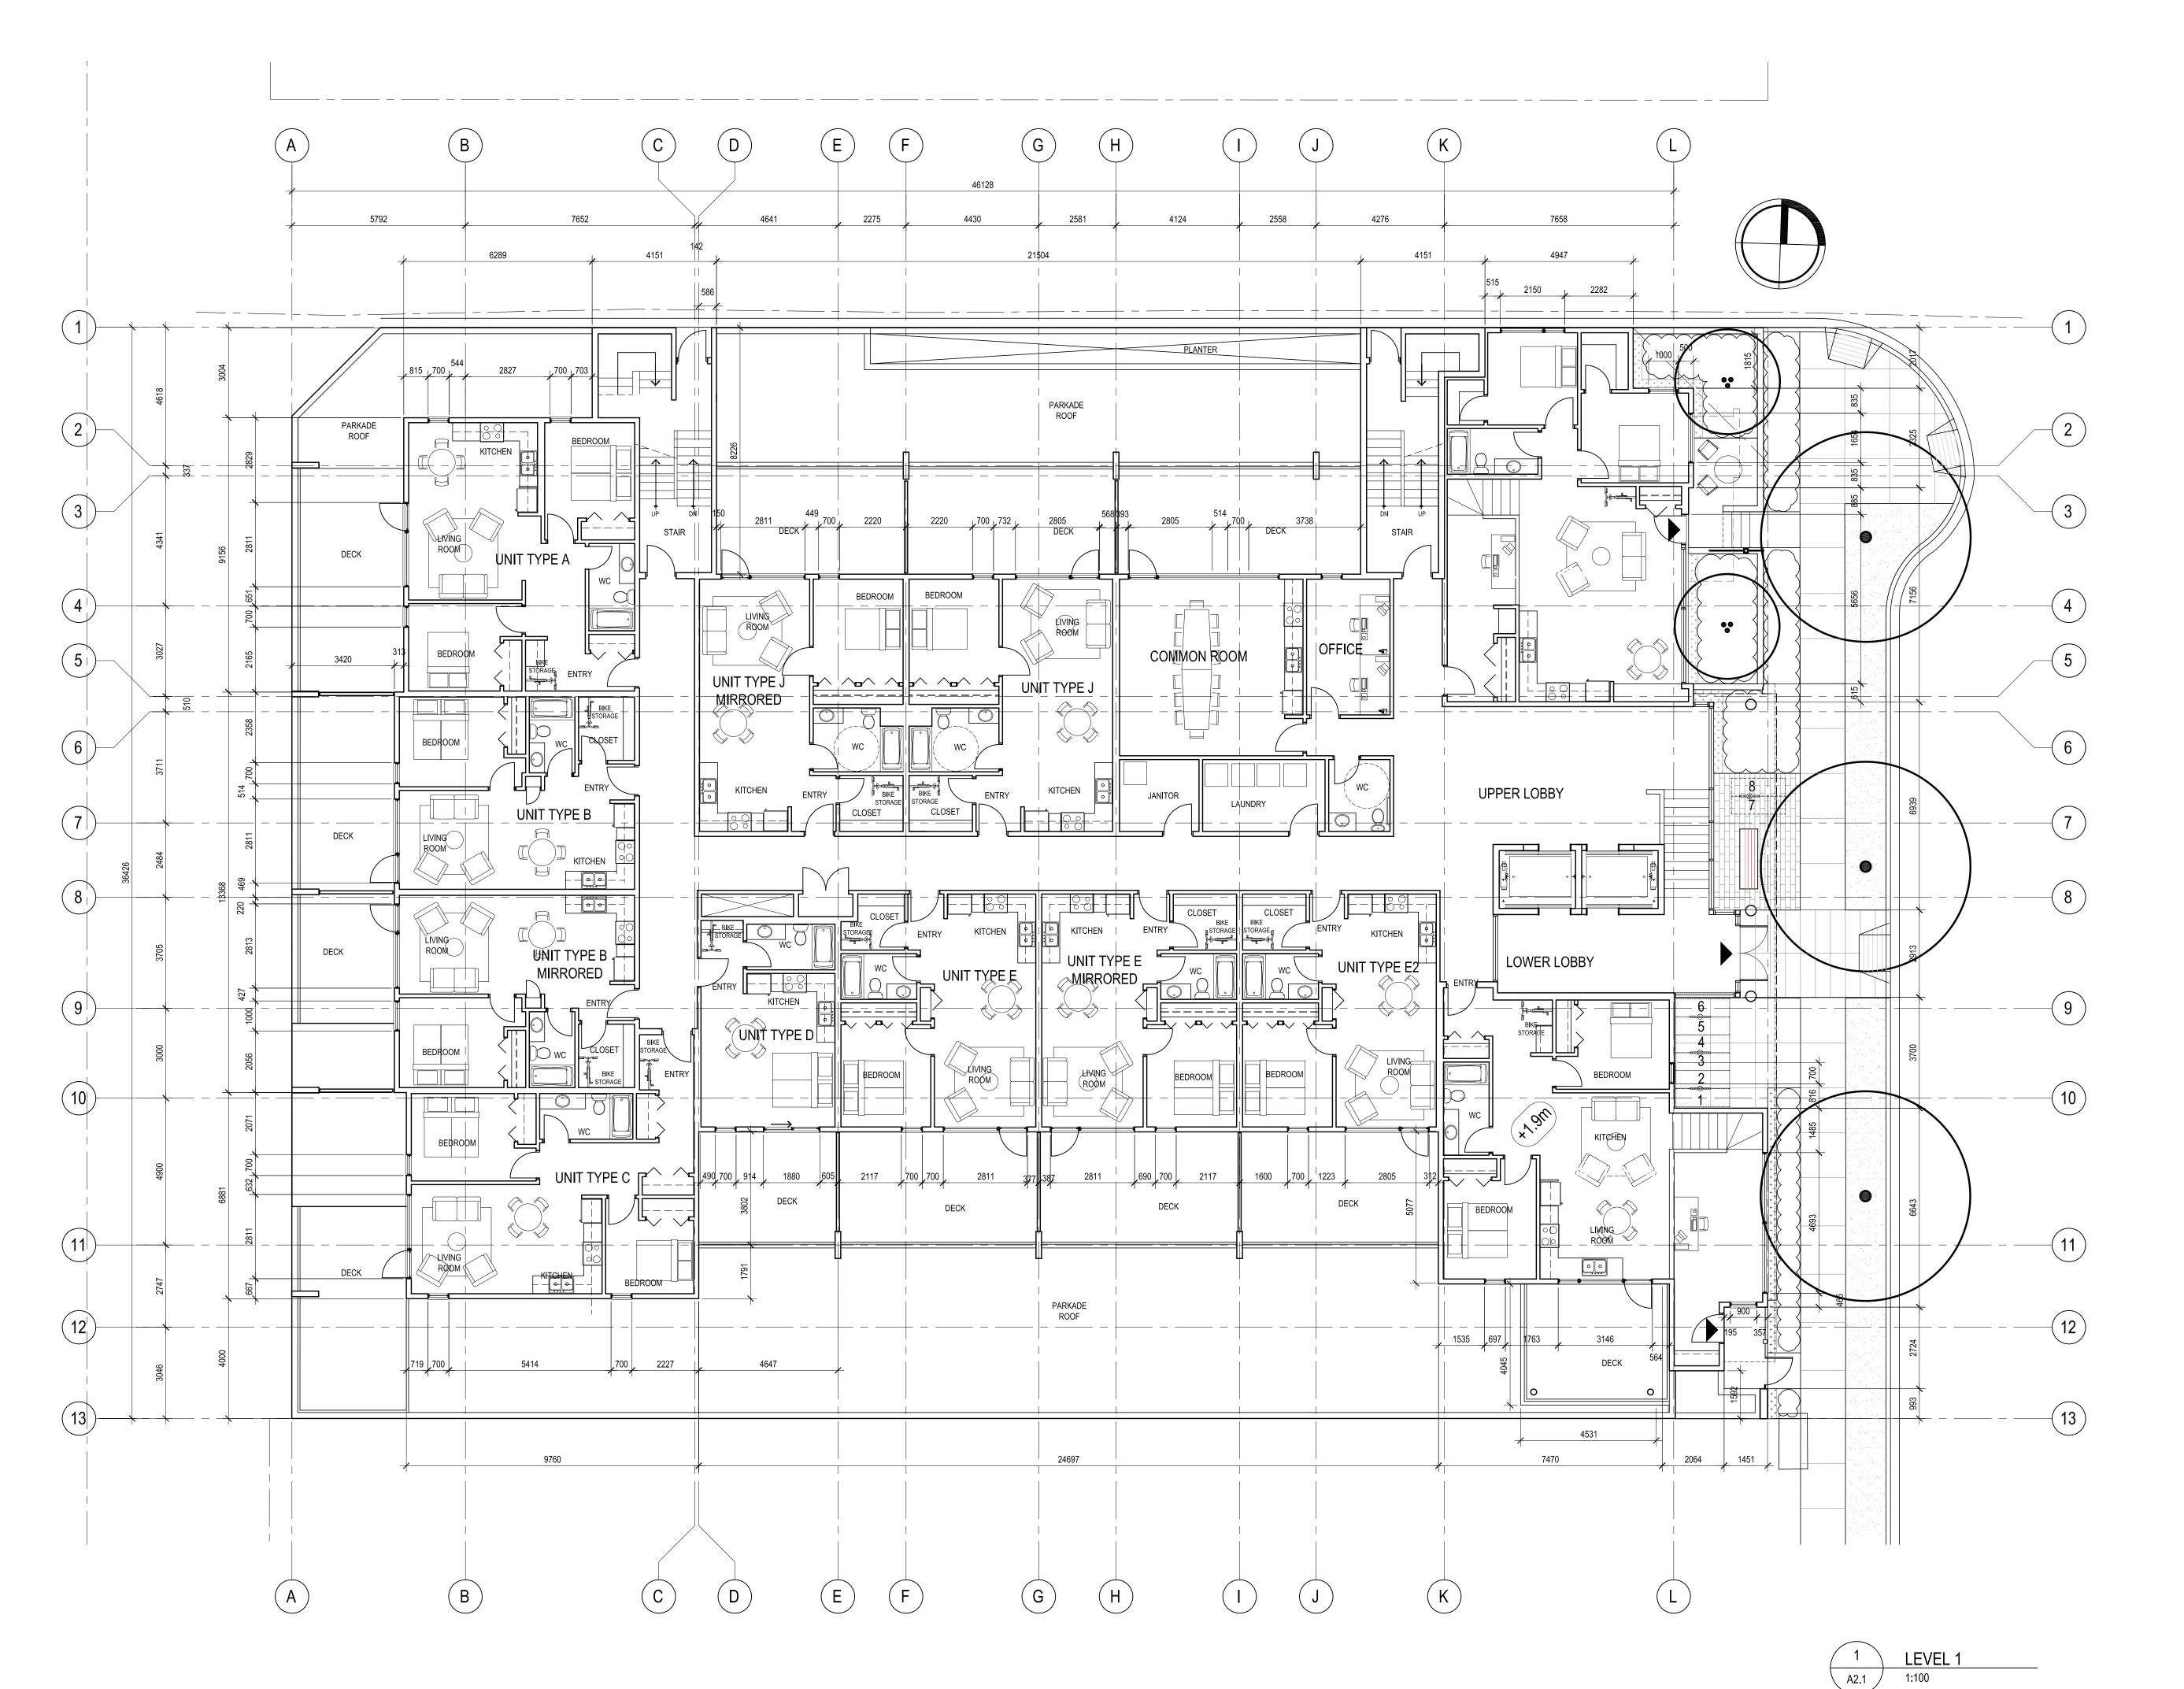

 ISSUE
 NO.
 DATE

 BC Housing review
 1
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PROJECT
Pathways Abilities Society

PROJECT NUMBER
DJA 2017-24

PROJECT LOCATION
Fuller ave. Kelowna


SHEET TITLE
First Floor Plan

October 15, 2018

SHEET NUMBER

A2.1

SCALE 1:100

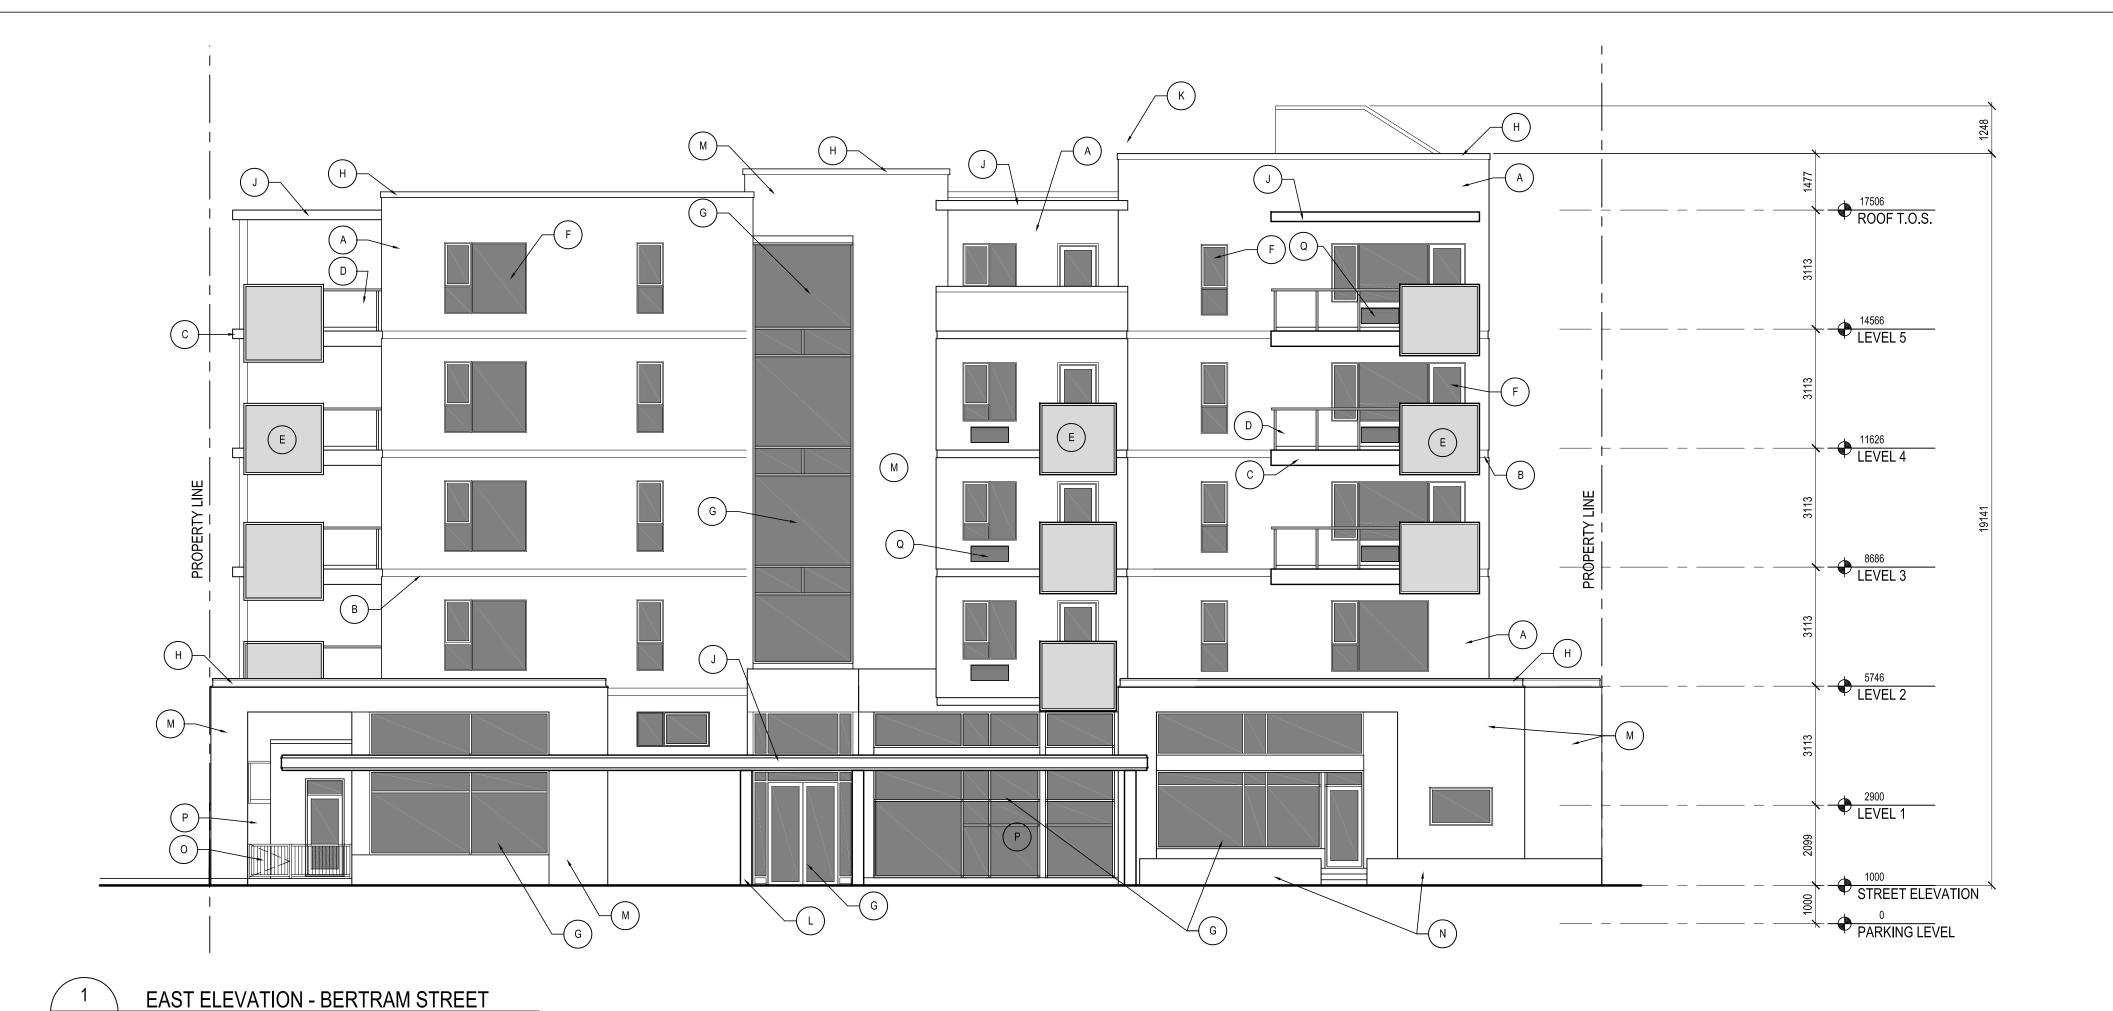

EXTERIOR CLADDING LEGEND		
	TYPE	DESCRIPTION
A		METAL SIDING
В		METAL FLASHING EXPANSION JOINT
С		METAL CLAD BALCONY EDGE
D		PAINTED METAL RAILING WITH GLASS PANEL
E		ALUMINUM FRAMED SPANDREL PANEL WITH COLOURED GLASS
F		VINYL WINDOWS / DOORS
G		ALUMINUM WINDOWS
H		METAL FLASHING
J		METAL CLAD CANOPY WITH STAINED WOOD SOFFIT
		STEEL COLUMN
M		STUCCO
$\left(N\right)$		RAISED CONCRETE PLANTER
0		DECORATIVE METAL FENCE AND GATE
Р		COLOURED CONCRETE WALL - TEXTURED
Q		THROUGH WALL AC UNITS
		WINDOWS

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April 6, 2018 May 5, 2018 August 16, 2018 September 17, 2018 October 2, 2018 October 15, 2018

BC Housing review DP Submission DP Revisions DP Revisions DP Revisions DP Revisions

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Pathways Abilities Society Apartment Complex

PROJECT NUMBER DJA 2017-24


PROJECT LOCATION 555 Fuller Avenue, Kelowna, BC

SHEET TITLE **Building Elevations**

DATE October 15, 2018

SHEET NUMBER

SCALE 1:100

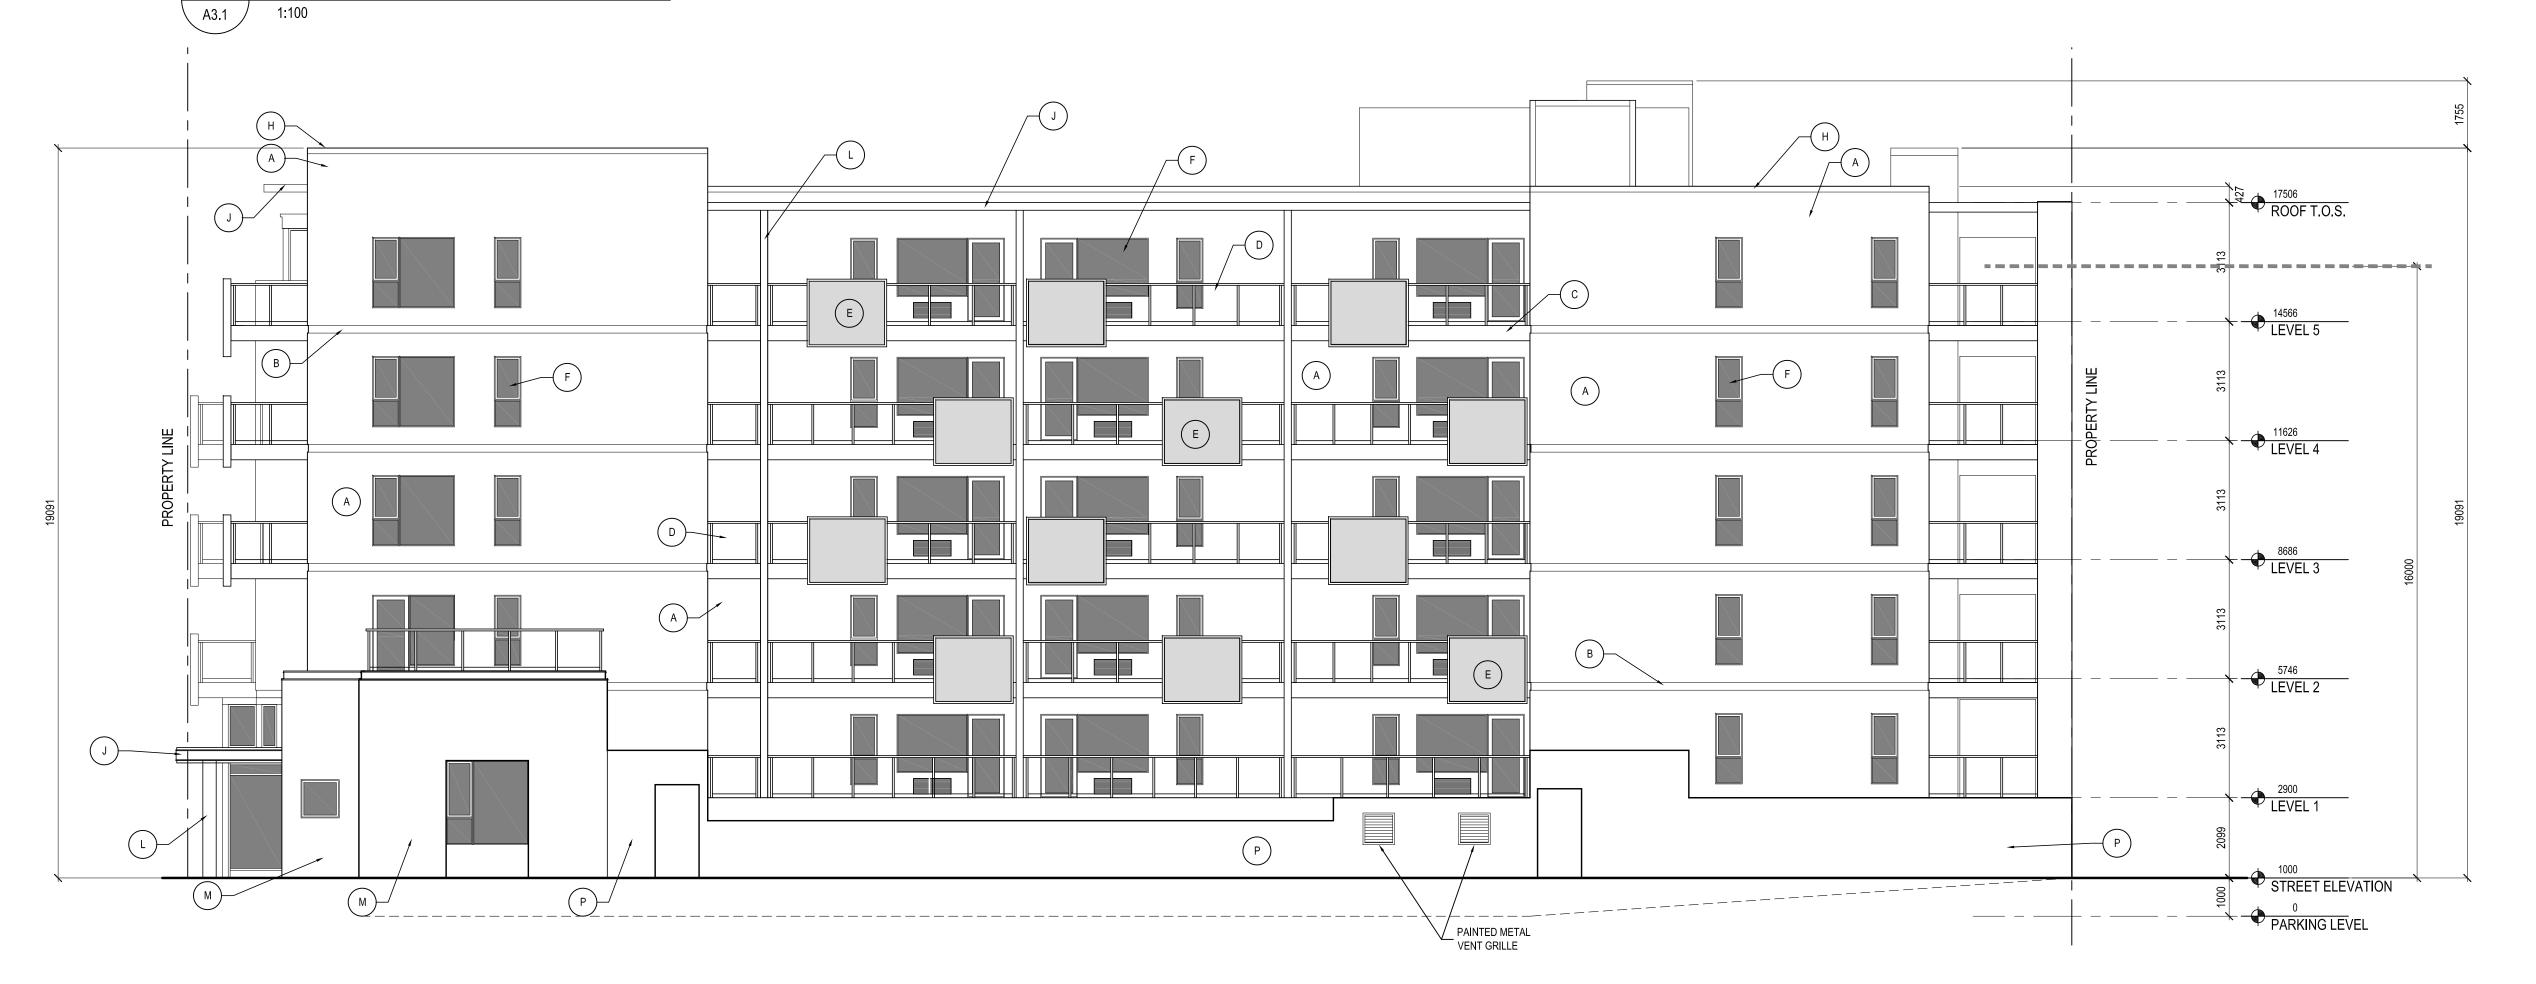

NORTH ELEVATION - FULLER STREET

A3.1



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 NO.
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Pathways Abilities Society
Apartment Complex

PROJECT NUMBER
DJA 2017-24

PROJECT LOCATION
555 Fuller Avenue, Kelowna, BC

SHEET TITLE
Building Elevations

October 15, 2018

SHEET NUM

A3.2

SCALE 1:100