DEVELOPMENT PERMIT APPLICATION / DESIGN RATIONALE





A17-47 Kelowna Ford Lincoln Kelowna, B.C.

July 2018

Prepared For:

Mr. Dan Assam & Dean Bradshaw Kelowna Ford Lincoln

To be Submitted to:

City of Kelowna Development Services Prepared by:

Architecture Interior Design and Planning Building Envelope Consulting



ARCHITECTURE

Garry Tomporowski Architect Ltd Kelowna, B.C. 250.979.1668

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1.0 OVERVIEW

The new Kelowna Ford Lincoln dealership presents a new generation dealership concept in one of Kelowna's old industrial zones. It joins other new auto dealerships and innovative designs in the area. Kelowna Ford Lincoln & PC Urban along with their consulting group headed by GTA Architects Ltd., are extending their expertise into the core of Enterprise Way & Dilworth Rd to expand a rapidly consolidated urban location.

Special attention has been paid to the landscaping both at the front edge (Enterprise) of the building and side yards (Dilworth). This helps to provide a gentle transition between the busy roads to the exciting facade and interior of the project.

2.0 PROJECT DESCRIPTION

The building and site will be located in the Industrial sections of the City close to both Hwy 97 and Enterprise Way. Both roads are major traffic arteries and see hundreds of vehicles every day. The site is flanked by existing industrial / commercial properties to either side yard and to the rear yard, which will through time, evolve.

The Kelowna Ford Lincoln dealership is currently located at 2540 Enterprise Way, in Kelowna, BC. The new dealership will be substantially different from the existing and the building footprint will be expanded to match the New Corporate Ford building template. The site is approximately 2.5 acres in size and the new building with the second level is 38,000 sq. ft. The ownership group has also acquired the property to the North of the building itself. This property will be used to provide additional staff & inventory parking (used and new). This site will undergo minor landscape improvements & renovations to visually tie it into the overall Kelowna Ford Lincoln concept design.

GTA has revised the Concept drawings and details for the main building as provided by R.H. Carter Ltd., and the Ford Canada Design Team. As such, GTA will incorporate the concepts of their designs with the Owners specific requirements.

The functions within the dealership are summarized in clearly defined modules, such as: the showroom, reception, workshop, parts service and minimal tire storage is part o the main floor. A small second floor is used for offices, a corporate board room and a staff lunch room with outdoor patio.

Outside, curtain wall glass is developed as part of the main facade of the building. This, along with the curved white frame provides the visual framework for the showroom. With its clear, simple shape, this design element is used in all the principal elements of the dealership branding.

The well articulated landscape plan will complement the building and define the parking and inventory area. A vegetative buffer along the fence separating the automobile areas and we will reduce the massing of these areas and soften them considerably.

GTA has reviewed the Sustainability Checklist in preparation of the project and we have included as many options as possible for consideration at this time, and many more will be considered during the Building Permit Drawings stage.



3.0 NO VARIANCES REQUESTED

4.0 SITE AND PARKING ACCESS

Required parking is located around the building. There are enough visitor and staff parking stalls on site. No off-street parking spots are required.

The design of the building in relation to the surrounding roads has been considered to accommodate all types of emergency and delivery vehicles, maintenance vehicles, garbage trucks and snow removal vehicles, which will be necessary from time to time. Pedestrian access to the site will be through a defined front entrance.

Site access is conceived of as entering/exiting off Dilworth road. The public face of the building and entry will be off Enterprise Way. The site access points will accommodate two-way driveway entries to the property. The entry off Enterprise will be situated away from the Dilworth/Enterprise intersection and West of the Main Fire hall entrance so as not to conflict with operations of either.

The parking is provided outside of the building, along the front and east side, occupying the closest rows of stalls which are accessed from either Dilworth or Enterprise Way.

The areas designated for the display and inventory vehicles are to be shaded with vegetation to reduce the heat island effect. In addition, the pavement will be treated with controlled cuts, and sloped towards the landscaped beds to avoid an excess of storm water runoff from the site to the seepage system.

Site lighting will be carefully designed and selected to assist in achieving as much of the 'dark sky' effect as possible.

5.0 URBAN CONNECTIVITY

The other major driver is access to shopping, and restaurants without the need to take a vehicle. Kelowna Ford Lincoln is well positioned to take advantage of the proximity of the services in the area.

In summary, the proposed building form for the Ford Lincoln dealership will provide an attractive and sensitive transition between the older buildings and zones in the area and the new updated facilities such as Turner Volkswagon. We ask that the City consider the benefits of this proposal and accept an application for rezoning as requested.

6.0 SUSTAINABILITY

The use of materials from natural sources is used to as large an extent as possible, and thereby reduces the carbon foot print as much as possible. Envelope details that prevent water and moisture ingress, yet still allow the assemblies to dry, prevent mold growth and healthy living is being incorporated. Reducing thermal bridging combined with appropriate thermal insulation will reduce heating and cooling loads. South and west facing windows will be specified to have appropriate shading and glazing coefficients to utilize the summer sun by blocking the heat while still allowing the winter sun to penetrate, reducing cooling and heating loads in the summer and winter seasons respectively. Providing windows in all of the occupied spaces allows natural day lighting and views reducing energy consumption required for illumination.



Other sustainable measures will include drought resistant landscaping. Eco-friendly waste receptacles and an electric vehicle charging stations will be incorporated into the parking area.

7.0 CRIME PREVENTION

The design of the building and landscaping promote natural surveillance and does not provide opportunistic hiding spaces. The entrances are clearly visible from the street and well lit sidewalks will surround the site & building.

Site lighting to the streetscape and pathways will be designed and located to illuminate the faces of users. It will provide illumination levels that do not create high contrast areas that could potentially conceal offenders, yet ensure safety for users and visitors.

8.0 LANDSCAPE

The Owner has selected Bench Landscape Architecture to create an interesting and articulate landscape solution which responds to the architectural style of the project. This will also compliment the governing character which has been previously established in the surrounding neighborhood. A number of the shrubs, both annual and perennial have been selected with these elements in mind and they appear as border plantings, plantings in pots and in shrub beds throughout the site to accentuate a relaxed and inviting atmosphere.

This unique and attractive project will endure due to its sense of community, and the fact that it presents a prominent streetscape and connection to the surrounding neighborhood. It provides an abundance of landscape features and carefully orchestrated internal traffic patterns and areas of repose to enrich and add to the buying experience.

9.0 SUMMARY

Kelowna Ford, PC Urban and the GTA design team feel that the combination of a cutting edge design coupled with leading edge technology, pedestrian-friendly landscape features, and modern building materials will provide for a very functional and highly desired neighbourhood project.

It is also our desire that this project will become one to set the standards for others in this area. It's critical to the continued sustainability and growth of our inner City, and to enrich the streetscape by "bridging" the massing between these two different zones.

We look forward to the enthusiastic support and recognition from staff and Council for all this project brings to our community.

10.0 APPENDIX AND ATTACHMENTS

- Letter of Agency
- Site Profile
- D.P Application Documents
- Soils Report
- State of Title Certificate
- Small and large scale drawings
- USB drive that contains all submission documents

END

CITY OF KELOWNA

MEMORANDUM

Date: August 13, 2018

File No.: DP18-0169

To: Community Planning (AC)

From: Development Engineering Manager (JK)

Subject: 1655 Dliworth Drive



Development Engineering Department have the following comments and requirements associated with this application. The road and utility upgrading requirements outlined in this report will be a requirement of this development. The Development Engineering Technologist for this project is Aaron Sangster. All Servicing and Road requirements will be address in S17-0057, Z17-0055

1. Domestic Water and Fire Protection

- (a) The existing lot is serviced with a 38mm copper diameter water service. The developer's consulting mechanical engineer will determine the domestic and fire protection requirements of this proposed development and establish hydrant requirements and service needs. The applicant, at his cost, will arrange for the removal of the existing service and the installation of one new larger metered water service.
- (b) A water meter is mandatory for this development and must be installed inside the building on the water service inlet as required by the City Plumbing Regulation and Water Regulation bylaws. The developer or building contractor must purchase the meter from the City at the time of application for a building permit from the Inspection Services Department, and prepare the meter setter at his cost.
- (c) Landscaped boulevards, complete with underground irrigation systems, must be integrated with the on-site irrigation system.

2. Sanitary Sewer

(a) The existing lot is serviced with 100mm diameter sanitary service. The developer's consulting mechanical engineer will determine the requirements of this proposed development and establish the required size and preferred location of the new service. Only one service will be permitted for this development. The applicant, at his cost, will arrange for the removal of all existing service and the installation of a new larger service.

3. Storm Drainage

(a) The developer must engage a consulting civil engineer to provide a storm water management plan for the site, which meets the requirements of the Subdivision, Development and Servicing Bylaw No. 7900. The storm water management plan must also include provision of lot grading plan, minimum basement elevation

(MBE), if applicable, and provision of a storm drainage service for the development and / or recommendations for onsite drainage containment and disposal systems. The existing lot is serviced with a 150mm diameter over-flow storm service.

- (b) Provide the following drawings:
 - (i) A detailed Stormwater Management Plan for this development; and,
 - (ii) An Erosion and Sediment Control Plan

3. Road Improvements

(a) All road requirements will be addressed in S17-0057 and in submitted TIA.

6. Subdivision

- (a) Grant Statutory Rights of Way if required for utility services.
- (b) If any road dedication or closure affects lands encumbered by a Utility right-of-way (such as Hydro, Telus, Gas, etc.) please obtain the approval of the utility. Any works required by the utility as a consequence of the road dedication or closure must be incorporated in the construction drawings submitted to the City's Development Manager.

7. Electric Power and Telecommunication Services

- (a) All proposed distribution and service connections are to be installed underground.
- (b) Streetlights must be installed on roads.
- (c) Make servicing applications to the respective Power and Telecommunication utility companies. The utility companies are required to obtain the City's approval before commencing construction.
- (d) Re-locate existing poles and utilities, where necessary. Remove aerial trespass (es).

8. <u>Engineering</u>

Road and utility construction design, construction supervision, and quality control supervision of all off-site and site services including on-site ground recharge drainage collection and disposal systems, must be performed by an approved consulting civil engineer. Designs must be submitted to the city engineering department for review and marked "issued for construction" by the City Engineer before construction may begin.

9. <u>Design and Construction</u>

- (a) Design, construction supervision and inspection of all off-site civil works and site servicing must be performed by a Consulting Civil Engineer and all such work is subject to the approval of the City Engineer. Drawings must conform to City standards and requirements.
- (b) Engineering drawing submissions are to be in accordance with the City's "Engineering Drawing Submission Requirements" Policy. Please note the number of sets and drawings required for submissions.



- (c) Quality Control and Assurance Plans must be provided in accordance with the Subdivision, Development & Servicing Bylaw No. 7900 (refer to Part 5 and Schedule 3).
- (d) A "Consulting Engineering Confirmation Letter" (City document 'C') must be completed prior to submission of any designs.
- (e) Before any construction related to the requirements of this subdivision application commences, design drawings prepared by a professional engineer must be submitted to the City's Works & Utilities Department. The design drawings must first be "Issued for Construction" by the City Engineer. On examination of design drawings, it may be determined that rights-of-way are required for current or future needs.

10. Servicing Agreements for Works and Services

- (a) A Servicing Agreement is required for all works and services on City lands in accordance with the Subdivision, Development & Servicing Bylaw No. 7900. The applicant's Engineer, prior to preparation of Servicing Agreements, must provide adequate drawings and estimates for the required works. The Servicing Agreement must be in the form as described in Schedule 2 of the bylaw.
- (b) Part 3, "Security for Works and Services", of the Bylaw, describes the Bonding and Insurance requirements of the Owner. The liability limit is not to be less than \$5,000,000 and the City is to be named on the insurance policy as an additional insured.

11. Geotechnical Report

As a requirement of this application the owner must provide a geotechnical report prepared by a Professional Engineer qualified in the field of hydro-geotechnical survey to address the following:

- (a) Area ground water characteristics.
- (b) Site suitability for development, unstable soils, etc.
- (c) Drill and / or excavate test holes on the site and install pisometers if necessary. Log test hole data to identify soil characteristics, identify areas of fill if any. Identify unacceptable fill material, analyse soil sulphate content, Identify unsuitable underlying soils such as peat, etc. and make recommendations for remediation if necessary.
- (d) List extraordinary requirements that may be required to accommodate construction of roads and underground utilities as well as building foundation designs.
- (e) Additional geotechnical survey may be necessary for building foundations, etc.



12. <u>Development Permit and Site Related Issues</u>

Access and Manoeuvrability:

- (i) Access to the site does not meet the throat length requirement of 15 m as laid out by TAC standard.
- (ii) A MSU standard size vehicle must be able to manoeuvre onto and off the site without requiring a reverse movement onto public roadways. If the development plan intends to accommodate larger vehicles movements should also be illustrated on the site plan.
- (iii) Perimeter access must comply with the BC Building Code. Fire Truck access designs and proposed hydrant locations will be reviewed by the Fire Protection Officer.
- (iv) The future, access and egress to the site may be restricted to right-in and right-out onto Enterprise Way with a future median.

James Kay, P. Eng.

Development Engineering Manager

AS



DRAFT Development Permit DP18-0169



This permit relates to land in the City of Kelowna municipally known as

2250 Enterprise Way

and legally known as

Lot B, District Lots 531 & 127, ODYD, Plan EPP82754

and permits the land to be used for the following development:

Car Dealership

The present owner and any subsequent owner of the above described land must comply with any attached terms and conditions.

<u>Date of Decision:</u> Oct 9th 2018

Decision By: CITY COUNCIL

Issued Date:

<u>Development Permit Area:</u> Comprehensive

This permit will not be valid if development has not commenced by two years after the Date of Decision by Council.

Existing Zone: I2 – General Industrial Future Land Use Designation: Industrial

This is NOT a Building Permit.

In addition to your Development Permit, a Building Permit may be required prior to any work commencing. For further information, contact the City of Kelowna, Development Services Branch.

NOTICE

This permit does not relieve the owner or the owner's authorized agent from full compliance with the requirements of any federal, provincial or other municipal legislation, or the terms and conditions of any easement, covenant, building scheme or agreement affecting the building or land.

Owner: PC Urban Enterprise Holdings Ltd. Inc. No. BC 1099976

Applicant: Ford Lincoln Dealership

Community Planning & Strategic Investments

Ryan Smith Date Community Planning Department Manager

SCOPE OF APPROVAL

This Development Permit applies to and only to those lands within the Municipality as described above, and any and all buildings, structures and other development thereon.

This Development Permit is issued subject to compliance with all of the Bylaws of the Municipality applicable thereto, except as specifically varied or supplemented by this permit, noted in the Terms and Conditions below.

The issuance of a permit limits the permit holder to be in strict compliance with regulations of the Zoning Bylaw and all other Bylaws unless specific variances have been authorized by the Development Permit. No implied variances from bylaw provisions shall be granted by virtue of drawing notations that are inconsistent with bylaw provisions and that may not have been identified as required Variances by the applicant or Municipal staff.

2. CONDITIONS OF APPROVAL

- a) The dimensions and siting of the building to be constructed on the land be in accordance with Schedule "A";
- b) The exterior design and finish of the building to be constructed on the land be in accordance with Schedule "B";
- c) Landscaping to be provided on the land be in accordance with Schedule "C"; and
- d) The applicant be required to post with the City a Landscape Performance Security deposit in the form of a "Letter of Credit" in the amount of 125% of the estimated value of the landscaping, as determined by a Registered Landscape Architect.

This Development Permit is valid for two (2) years from the Date of Decision by Council, with no opportunity to extend.

3. PERFORMANCE SECURITY

As a condition of the issuance of this Permit, Council is holding the security set out below to ensure that development is carried out in accordance with the terms and conditions of this Permit. Should any interest be earned upon the security, it shall accrue to the Developer and be paid to the Developer or his or her designate if the security is returned. The condition of the posting of the security is that should the Developer fail to carry out the development hereby authorized, according to the terms and conditions of this Permit within the time provided, the Municipality may use enter into an agreement with the property owner of the day to have the work carried out, and any surplus shall be paid over to the property own of the day. Should the Developer carry out the development permitted by this Permit within the time set out above, the security shall be returned to the Developer or his or her designate. There is filed accordingly:

a) An Irrevocable Letter of Credit in the amount of \$193,539.38

Before any bond or security required under this Permit is reduced or released, the Developer will provide the City with a statutory declaration certifying that all labour, material, workers' compensation and other taxes and costs have been paid.

4. INDEMNIFICATION

Upon commencement of the works authorized by this Permit the Developer covenants and agrees to save harmless and effectually indemnify the Municipality against:

a) All actions and proceedings, costs, damages, expenses, claims, and demands whatsoever and by whomsoever brought, by reason of the Municipality said Permit.

All costs, expenses, claims that may be incurred by the Municipality where the construction, engineering or other types of works as called for by the Permit results in damages to any property owned in whole or in part by the Municipality or which the Municipality by duty or custom is obliged, directly or indirectly in any way or to any degree, to construct, repair, or maintain.

The PERMIT HOLDER is the <u>CURRENT LAND OWNER</u>. Security shall <u>ONLY</u> be returned to the signatory of the Landscape Agreement or their designates.

NEW FORD&LINCOLN DEALERSHIP

SCHEDULE This forms part of application # DP18-0169 Initials

1655 Dilworth Drive, Kelowna, BC



CIVIL:

SURVEYORS

BC, V1Y 6L2

STRUCTURAL:

R&A ENGINEERS

CTQ CONSULTANTS LTD

CONTACT: NEIL DENBY

PHONE: (250) 763-7322

CONTACT: GREG WYLIE

BC V1Y 1J7, CANADA

PHONE: (250)-308-7911

202-3401 33rd STREET, VERNON

EMAIL: GREG@RAENGINEERING.CA

259A LAWRENCE AVENUE, KELOWNA,

EMAIL: ROB@RUNNALLSDENBY.COM



ELEVATIONS

INTERIOR ELEVATION

BUILDING SECTIONS

CONSULTANTS:

ARCHITECTURAL:

GTA ARCHITECTURE LTD. CONTACT: GARRY TOMPOROWSKI

243 - 1889 SPRINGFIELD ROAD KELOWNA, B.C., V1V 1S9 PHONE: (250) 979-1668, FAX: (250) 979-4366 EMAIL: garry@gtarch.ca

LANDSCAPE:

BENCH SITE DESIGN INC CONTACT: XENIA SEMENIUK

4-1562 WATER STREET, KELOWNA BC V1Y 1J7. CANADA PHONE: (250)-808-5113 EMAIL: XEINA@BENCHDESIGN.COM

MECHANICAL:

WILLIAMS ENGINEERING


CONTACT: MARTINO FANFANI 1912 ENTERPRISE, KELOWNA BC V1Y 1J7, CANADA PHONE: (778)-484-2981 EMAIL: MFANFANI@WILLIAMS.COM

ELECTRICAL:

WILLIAMS ENGINEERING


CONTACT: MARTIN LINDQUIST 4-1562 WATER STREET, KELOWNA BC V1Y 1J7, CANADA PHONE: (250)-808-5113 EMAIL: MLINDQUIST@WILLIAMS.COM

SYMBOL LEGEND:

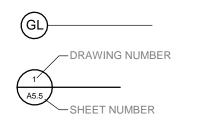

BUILDING SECTION REFERENCE MARKER

GRID LINE:

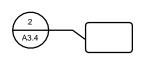

DETAIL REFERENCE



ASSEMBLY TYPE REFERENCE

LIST OF DRAWINGS:

CONTACT: MURRAY NOBLE		ARCHITECTURAL LIST			
1334 ST. PAUL STREET, KELOWNA, BC V1Y 2E1, CANADA		SHEET NUMBER	SHEET NAME		
,		A0.0	COVER SHEET		
PHONE: (250)-979-1221 EMAIL: MNOBLE@CTQCONSULTANTS.CA		A0.1	PERSPECTIVE VIEWS		
EMAIL. MINOBLE @ CTQCONSULTANTS.CA		A0.2	PERSPECTIVE VIEWS B		
	⋠ ┃┃	A1.0	SITE PLAN		
OUDVEVOD		A2.0	MAIN FLOOR PLAN - OVERALL		
SURVEYOR:		A2.3	SECOND FLOOR OVERALL		
RUNNALLS DENBY-BRITISH COLUMBIA LAND		A2.8	AREA PLAN		

A3.51

PROJECT INFO:

LOT AREA:

1655 Dilworth Dr, Kelowna, BC

LEGAL DESCRIPTION:

KID: 806047 Plan #: EPP67320

Lot#: 1 Block: District Lot 127&531.

I-3(REZONE TO I-2) ZONING:

21,911m²

FLOOR AREAS:

GROSS FLOOR AREA

AREA LEVEL NAME GROUND FLOOR GROSS AREA 3,313.7 m² SECOND FLOOR GROSS AREA 957.2 m² TOTAL GROSS AREA 4,270.9 m²

NET FLOOR AREA

OCCUPANCY AREA

OCCUPANCY TYPE	AREA
OCCUPANCY D	1,299.5 m ²
OCCUPANCY E	937.5 m ²
OCCUPANCY F-1	151.5 m ²
OCCUPANCY F-2	1.880.8 m ²

LEVEL NAME	AREA
GROUND FLOOR NET AREA	3,278.2 m ²
2nd FLOOR NET AREA	915.0 m ²
TOTAL NET AREA:	4,193.3 m ²

OCCUPANCY TYPE	AREA
OCCUPANCY D	1,299.5 m ²
OCCUPANCY E	937.5 m ²
OCCUPANCY F-1	151.5 m ²
OCCUPANCY F-2	1.880.8 m ²

NOT FOR CONSTRUCTION

THIS DRAWING MUST NOT BE SCALED. - VERIFY ALL DIMENSIONS AND DATUMS

PRIOR TO COMMENCEMENT OF WORK.

- THIS DRAWING IS THE EXCLUSIVE

1 2018.07.30 MA ISSUED FOR D.P.

DESIGN CONSULTANT

NO. DATE BY DESCRIPTION

- ANY REPRODUCTION MUST BEAR THEIR

PROPERTY OF THE ARCHITECT.

FROM THE ARCHITECT.

NAME AS ARCHITECT.

REPORT ALL ERRORS AND OMMISIONS

VARIATIONS AND MODIFICATIONS ARE NOT ALLOWED WITHOUT WRITTEN PERMISSION

CITY OF KELOWNA ZONING BYLAW NO. 8000 ANALYSIS:

SECTION 7 – LANDSCAPING AND SCREENING

7.3 REFUSE AND RECYCLING BINS 7.3.2 REFUSE & RECYCLING BINS SCREENING FROM ADJACENT STREETS AND LOTS (PROPOSED: BINS SCREENED)

7.6 MINIMUM LANDSCAPE BUFFERS

b)LEVEL 2: MIN 3.0m BUFFER c)LEVEL 3: MIN 3.0m BUFFER OR OPAQUE BARRIER

TABLE 7.1 MIN. LANDSCAPE BUFFER TREATMENT LEVELS SCHEDULE FRONT: **LEVEL 2** 3.0m

REAR YARD: **LEVEL 3** 3.0m NORTH SIDE YARD: LEVEL 3 3.0m SOUTH SIDE YARD: LEVEL 3 3.0m

SECTION 9 - PARKING AND LOADING

8.1 OFF-STREET VEHICLE PARKING

8.1.2. MIN NUMBER SPACES

TABLE 8.1 -GENERAL INDUSTRIAL USE:

2.0 PER 100m² GFA

TOTAL PARKING REQUIRED: 86 (4270/50=86) TOTAL PARKING PROPOSED: 463 (UNCOVERED) TOTAL VISITOR PARKING REQUIRED:

8.1.7 PARKING SPACES FOR THE DISABLED

a) PER B.C. BUILDING CODE(3.8.3.4.2): 1/100

2(182 VISITOR AND EMPLOYEE PARKING STALLS)

PROP: >50m

370

8.1.11 SIZE AND RATIO

FULL SIZE: MIN WIDTH: 2.5m

PROP: 2.5m MIN LENGTH: 6m PROP: 6.0m MIN HEIGHT: 2.0m PROP: 2.0m

MID SIZE: MAX NUMBER: 40% PROP: 91 (20%) **SMALL SIZE:** MAX NUMBER: 10% PROP: 0 (0%)

8.4 OFF-STREET BICYCLE PARKING

8.4.1 NUMBER OF SPACES TABLE 8.3: GENERAL INDUSTRIAL USE

CLASS I: N/R CLASS II: 0.30 PER 100m² GFA: 13 SPACES REQUIRED **PROP: 13**

8.4.6 DEVELOPMENT STANDARDS BICYCLE PARKING

MIN WIDTH: 0.6m MIN LENGTH: 1.8m MIN HEIGHT: 1.9m

SECTION 15.2 - I5 - GENERAL INDUSTRIAL

15.2.2. PRINCIPLE USES:

(d) AUTOMOTIVE AND EQUIPMENT REPAIR SHOPS (e) AUTOMOTIVE AND MINOR RECREATION VEHICLE SALES/RENTALS

15.2.4 SUBDIVISION REGULATIONS

MINIMUM LOT WIDTH: 40.0m. (EXISTING: 195.9m) MINIMUM LOT DEPTH: 35.0m (EXISTING: 165.4m) MINIMUM LOT AREA: 10,000 m². (**EXISTING: 21,911m²**)

15.2.5 DEVELOPMENT REGULATIONS

PROP: 9.8m MAX HEIGHT: 14.0m PROP: 15% SITE COVERAGE: 60% MAX FLOOR AREA RATIO: 1.5 PROP: 0.19 MIN FRONT YARD: 7.5m PROP: 18.7m PROP: 21.0m(E) MIN SIDE YARD: 0.0m EAST SIDE(ABUT C-10)

6.0m WEST SIDE(FLANKING STREET) PROP: >50m(W)

MIN REAR YARD: 0.0m(ADJACENT TO INDUSTRIAL)

B.C. BUILDING CODE (2012) ANALYSIS:

MAJOR OCCUPANCY CLASSIFICATION: D, E, F1, F2

GOVERNING CODE PART: PART 3 **GRADE ELEVATION: BUILDING HEIGHT** 2 STORIES **BUILDING AREA:** 3,313m² SPRINKLERS: NFPA 13

FACING NO. OF STREETS: **BASIC CODE CLASSIFICATION:**

3.2.2.61. GROUP D, up to 2 Storeys, Sprinklered

- SPRINKLERED - MAX. 2 STOREYS

- MAX. AREA: 3,000 m2 IF 1 STOREY

- COMBUSTIBLE OR NONCOMBUSTIBLE - FLOORS: 45 min FRR

- LOADBEARING WALLS: 45 min FRR, OR BE NONCOMBUSTIBLE CONSTRUCTION

3.2.2.67. GROUP E, up to 2 Storeys, Sprinklered

- SPRINKLERED

- MAX. 2 STOREYS - MAX. AREA: 3,000 m2 IF 1 STOREY

- COMBUSTIBLE OR NONCOMBUSTIBLE

- FLOORS: 45 min FRR

- LOADBEARING WALLS: 45 min FRR

3.2.2.70. GROUP F DIV. 1, up to 2 Storeys, Sprinklered

- SPRINKLERED

- MAX. 2 STOREYS

- MAX. AREA: **2,400 m2 IF 1 STOREY** - COMBUSTIBLE OR NONCOMBUSTIBLE

- FLOORS: 45 min FRR

- LOADBEARING: 45 min FRR, OR BE NONCOMBUSTIBLE CONSTRUCTION

3.2.2.77. GROUP F DIV. 2, up to 2 Storeys, Sprinklered

- SPRINKLERED

- MAX. 2 STOREYS

- MAX. AREA: **4,500 m2 IF 1 STOREY** - COMBUSTIBLE OR NONCOMBUSTIBLE

- FLOORS: 45 min FRR - LOADBEARING: 45 min FRR, OR BE NONCOMBUSTIBLE CONSTRUCTION

3.1.3.1 FIRE SEPARATION

BETWEEN OCCUPANCY D AND E: N/R BETWEEN OCCUPANCY D AND F-2: N/R BETWEEN OCCUPANCY E AND F-2: N/R BETWEEN OCCUPANCY F-2 AND F-1: 2HR

GTA ARCHITECTURE LTD.

243 1889 SPRINGFIELD ROAD Kelowna, British Columbia. TELEPHONE: (250)979-1668

DEVELOPED BY:

PROJECT

NEW FORD LINCOLN

1655 DILWORTH DR, KELOWNA, BC

SHEET TITLE

COVER SHEET

FF DRAWING NO. Designer Designer

SCALE: As indicated

01/29/18 FILE: A17-47

Project File Name and Location: P:\2017 Architecture\A17-47 New Ford Lincoln - Enterprise Way\3.0 Drawings\Model\A17-47(JUL 20) .rvt







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1 2018.07.30 MA ISSUED FOR D.P.

NO. DATE BY DESCRIPTION

DESIGN CONSULTANT

GTA ARCHITECTURE LTD.

243 1889 SPRINGFIELD ROAD Kelowna, British Columbia. TELEPHONE: (250)979-1668

DEVELOPED BY:

PROJECT

NEW FORD LINCOLN
1655 DILWORTH DR, KELOWNA, BC

SHEET TITLE

PERSPECTIVE VIEWS

04/18/18 FILE: A17-47











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ISSUED FOR REVISED DEVELOPMENT PERMIT

NO.	DATE	ву	REVISION
05	FEB 15, 2018	FF	ISSUE FOR REVISED DEV. PERMIT
04	FEB 06, 2018	FF	ISSUE FOR REVISED DEV. PERMIT
03	NOV 23, 2017	FF	ISSUE FOR DEVELOPMENT PERMIT
02	NOV 10, 2017	FF	ISSUE FOR REVIEW
01	NOV 07, 2017	FF	ISSUE FOR DEVELOPMENT PERMIT

DESIGN CONSULTANT

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GTA ARCHITECTURE LTD.

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DEVELOPED BY:

PROJECT

NEW FORD
LINCOLN
1655 DILWORTH DR, KELOWNA, BC

SHEET TITLE

PERSPECTIVE VIEWS

DRAWN BY: Auth

GNED BY: Designer

LE: 12" = 1'-0"

DATE: 2018-08-01 9:51:13 AM FILE: A17-47

Project File Name and Location: P:\2017 Architecture\A17-47 New Ford Lincoln - Enterprise Way\3.0 Drawings\Model\A17-47(JUL 20) .rvt















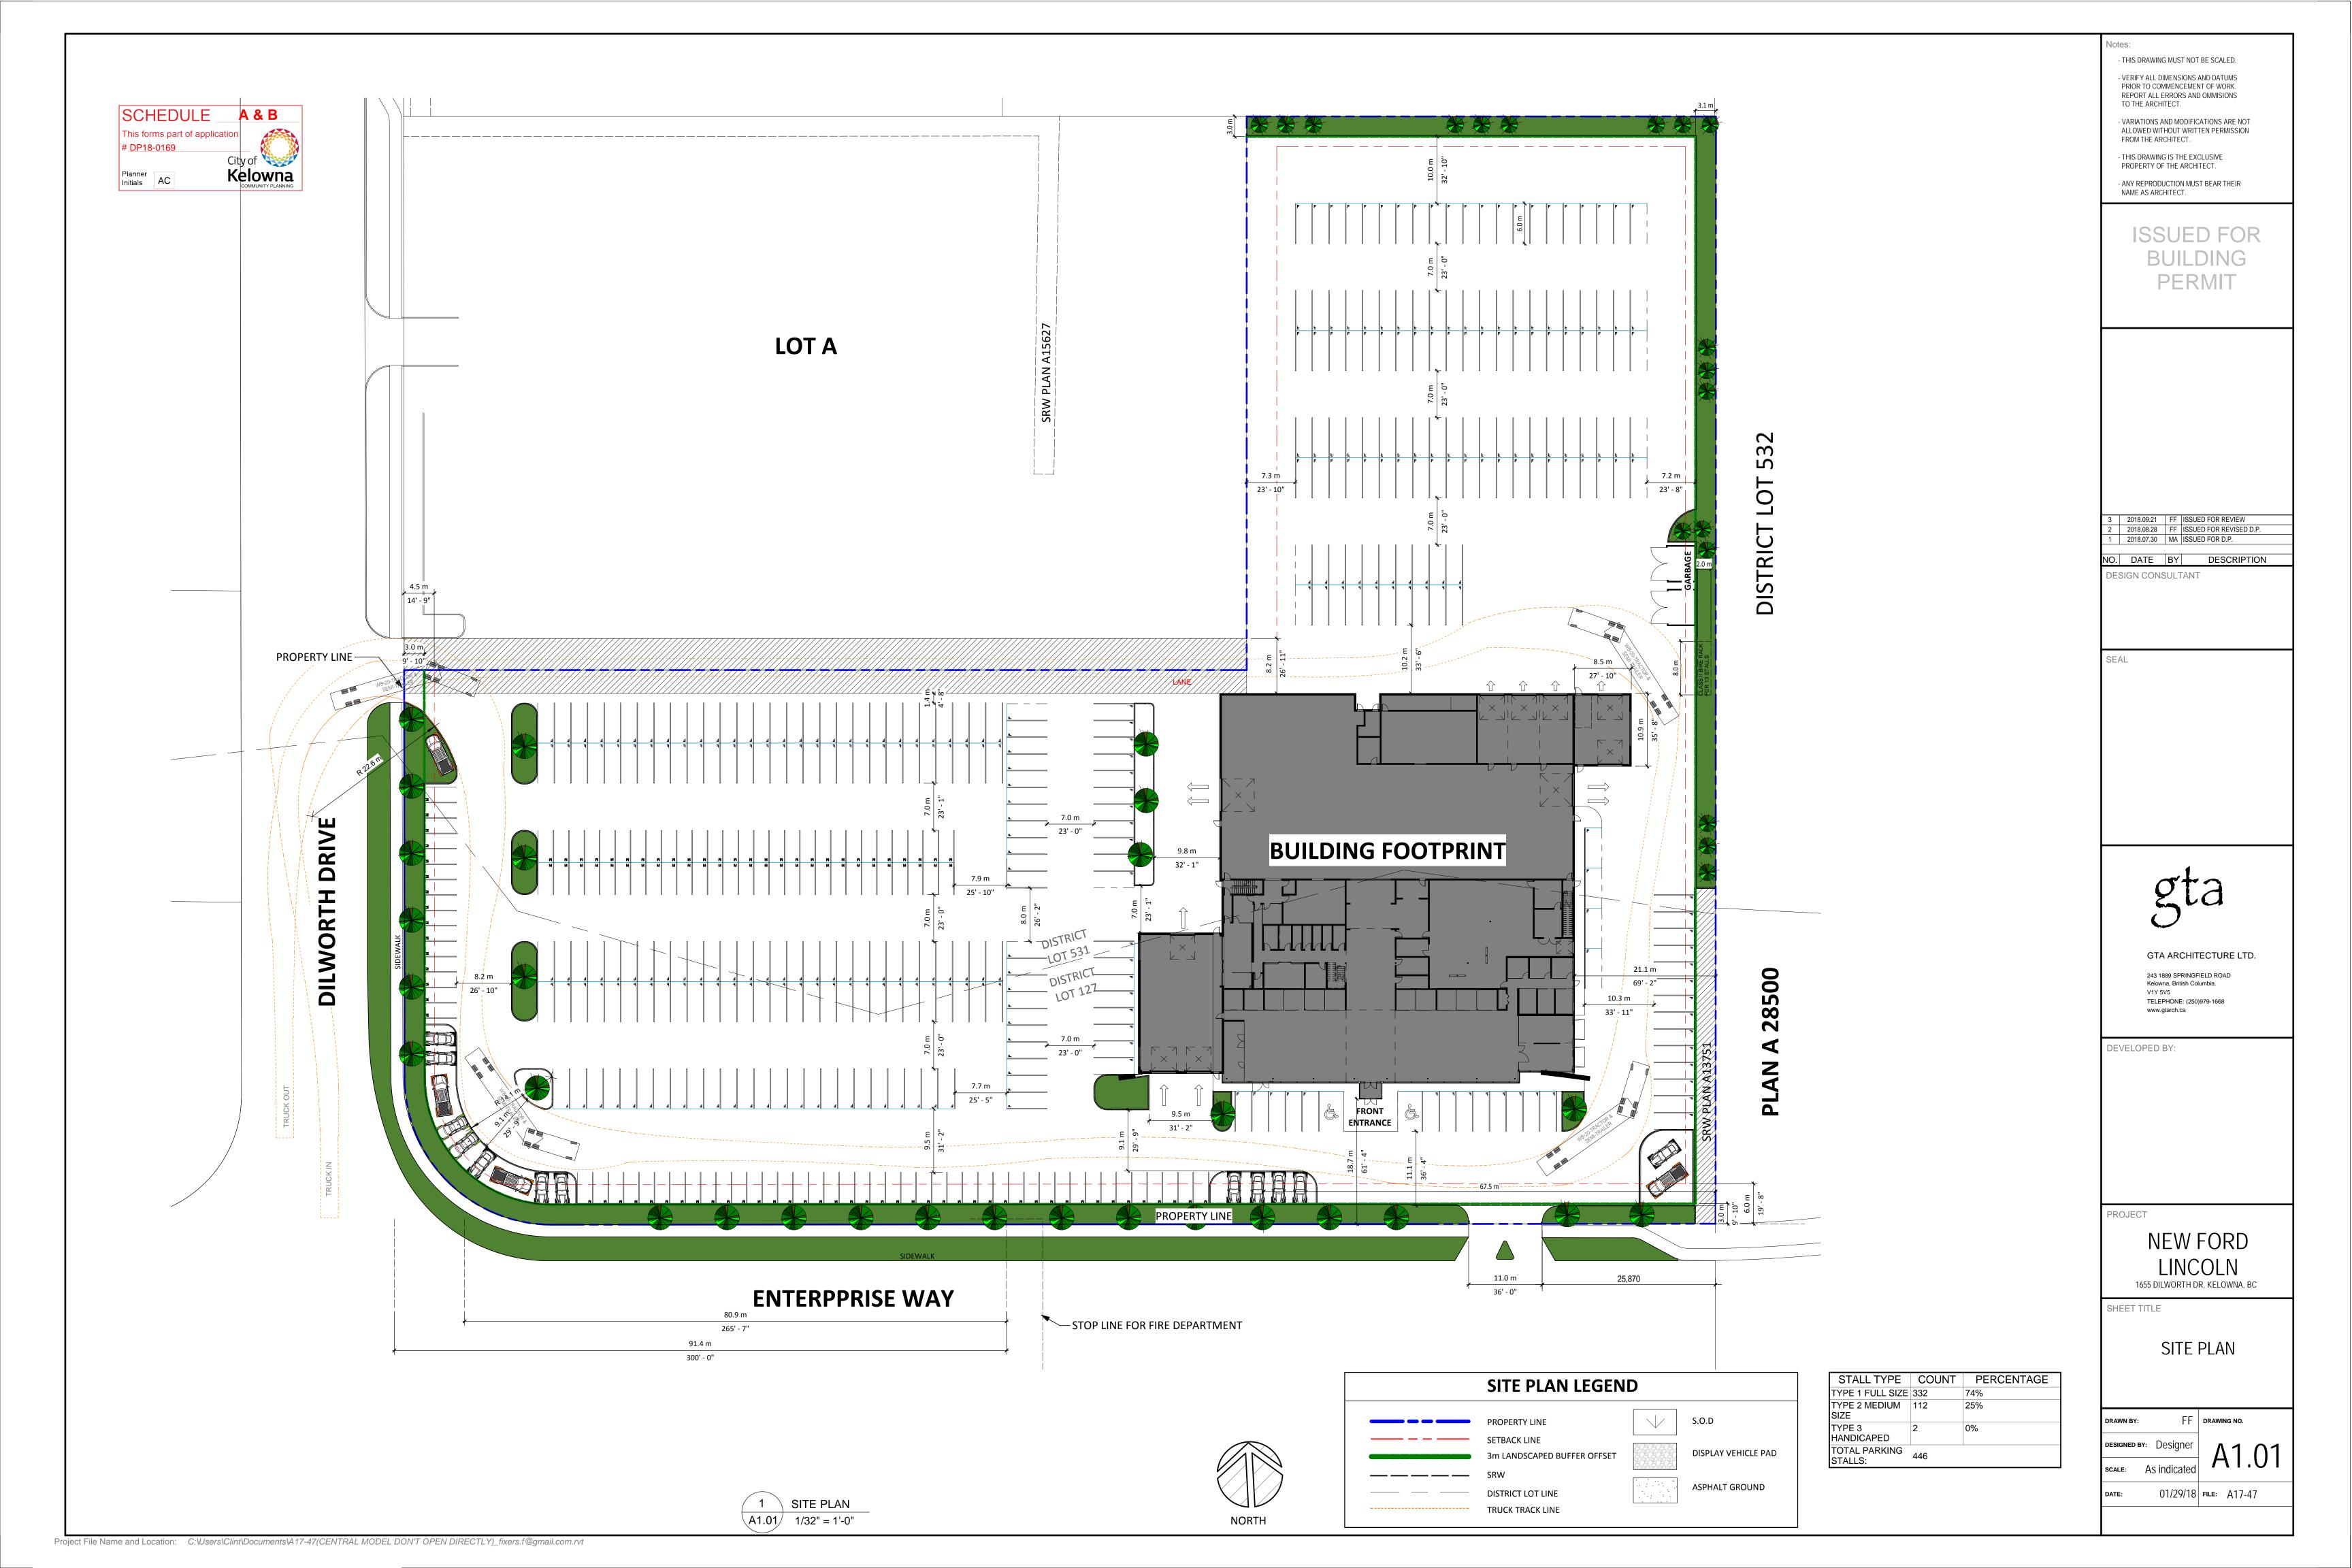

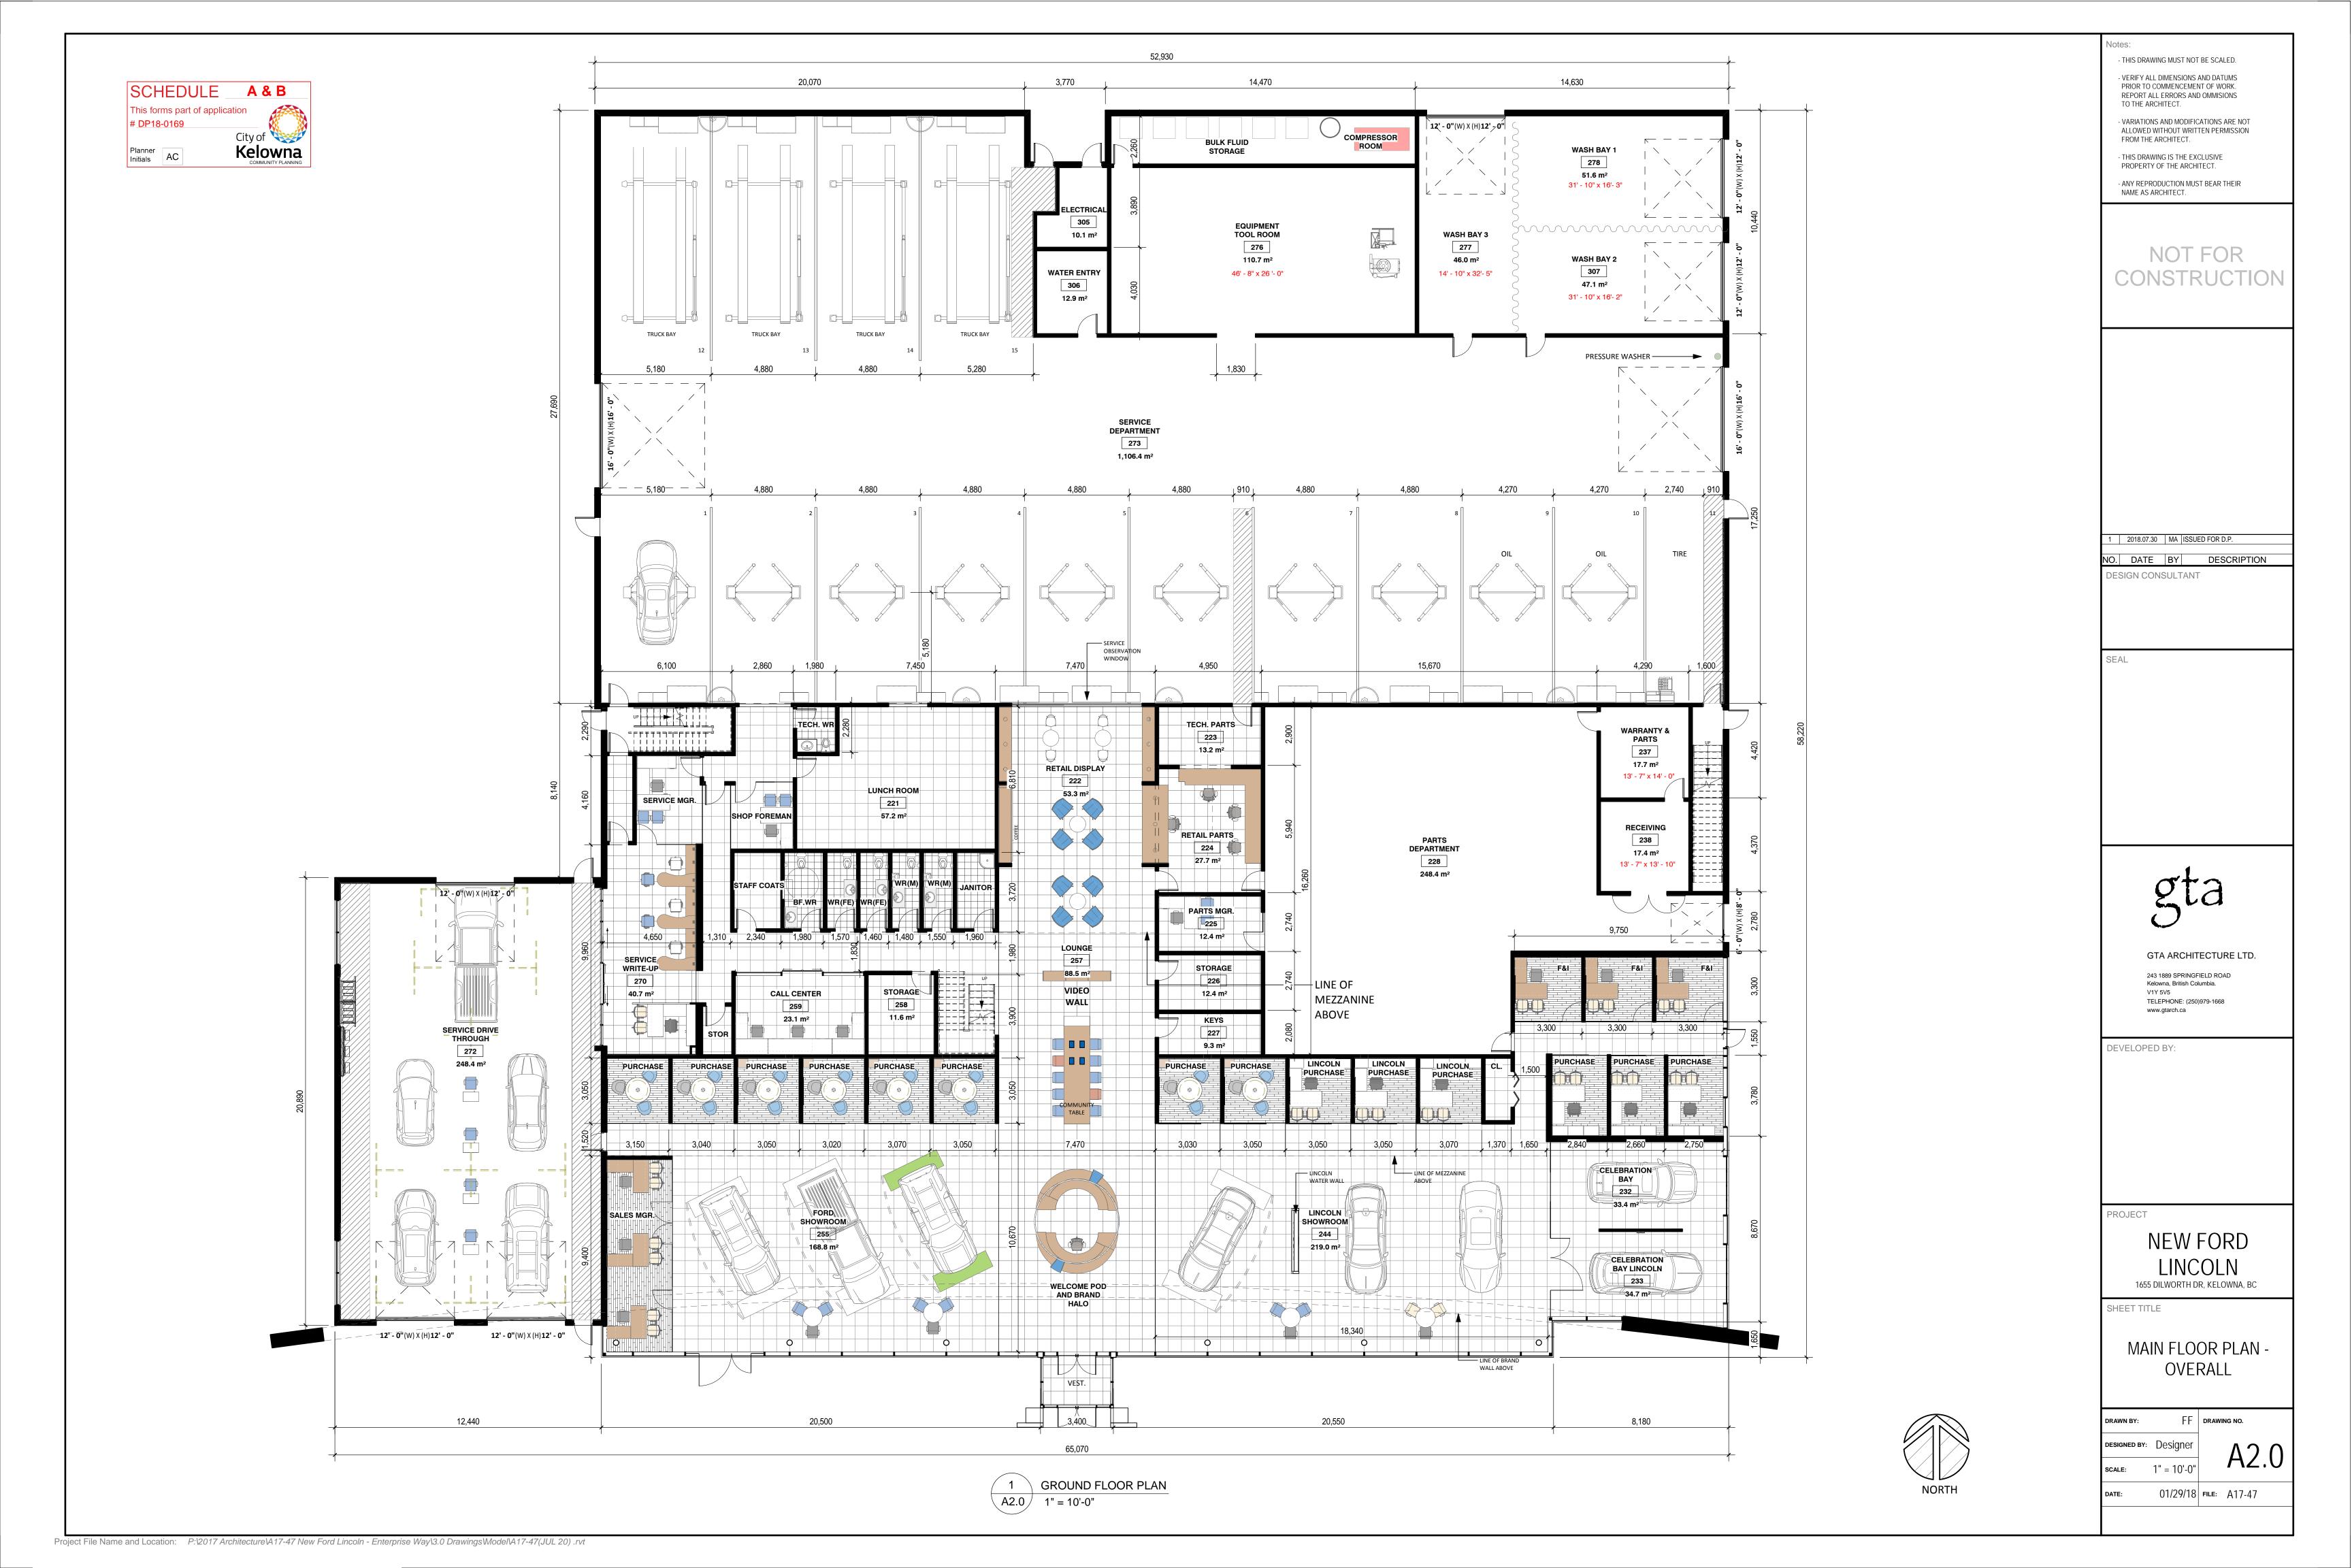


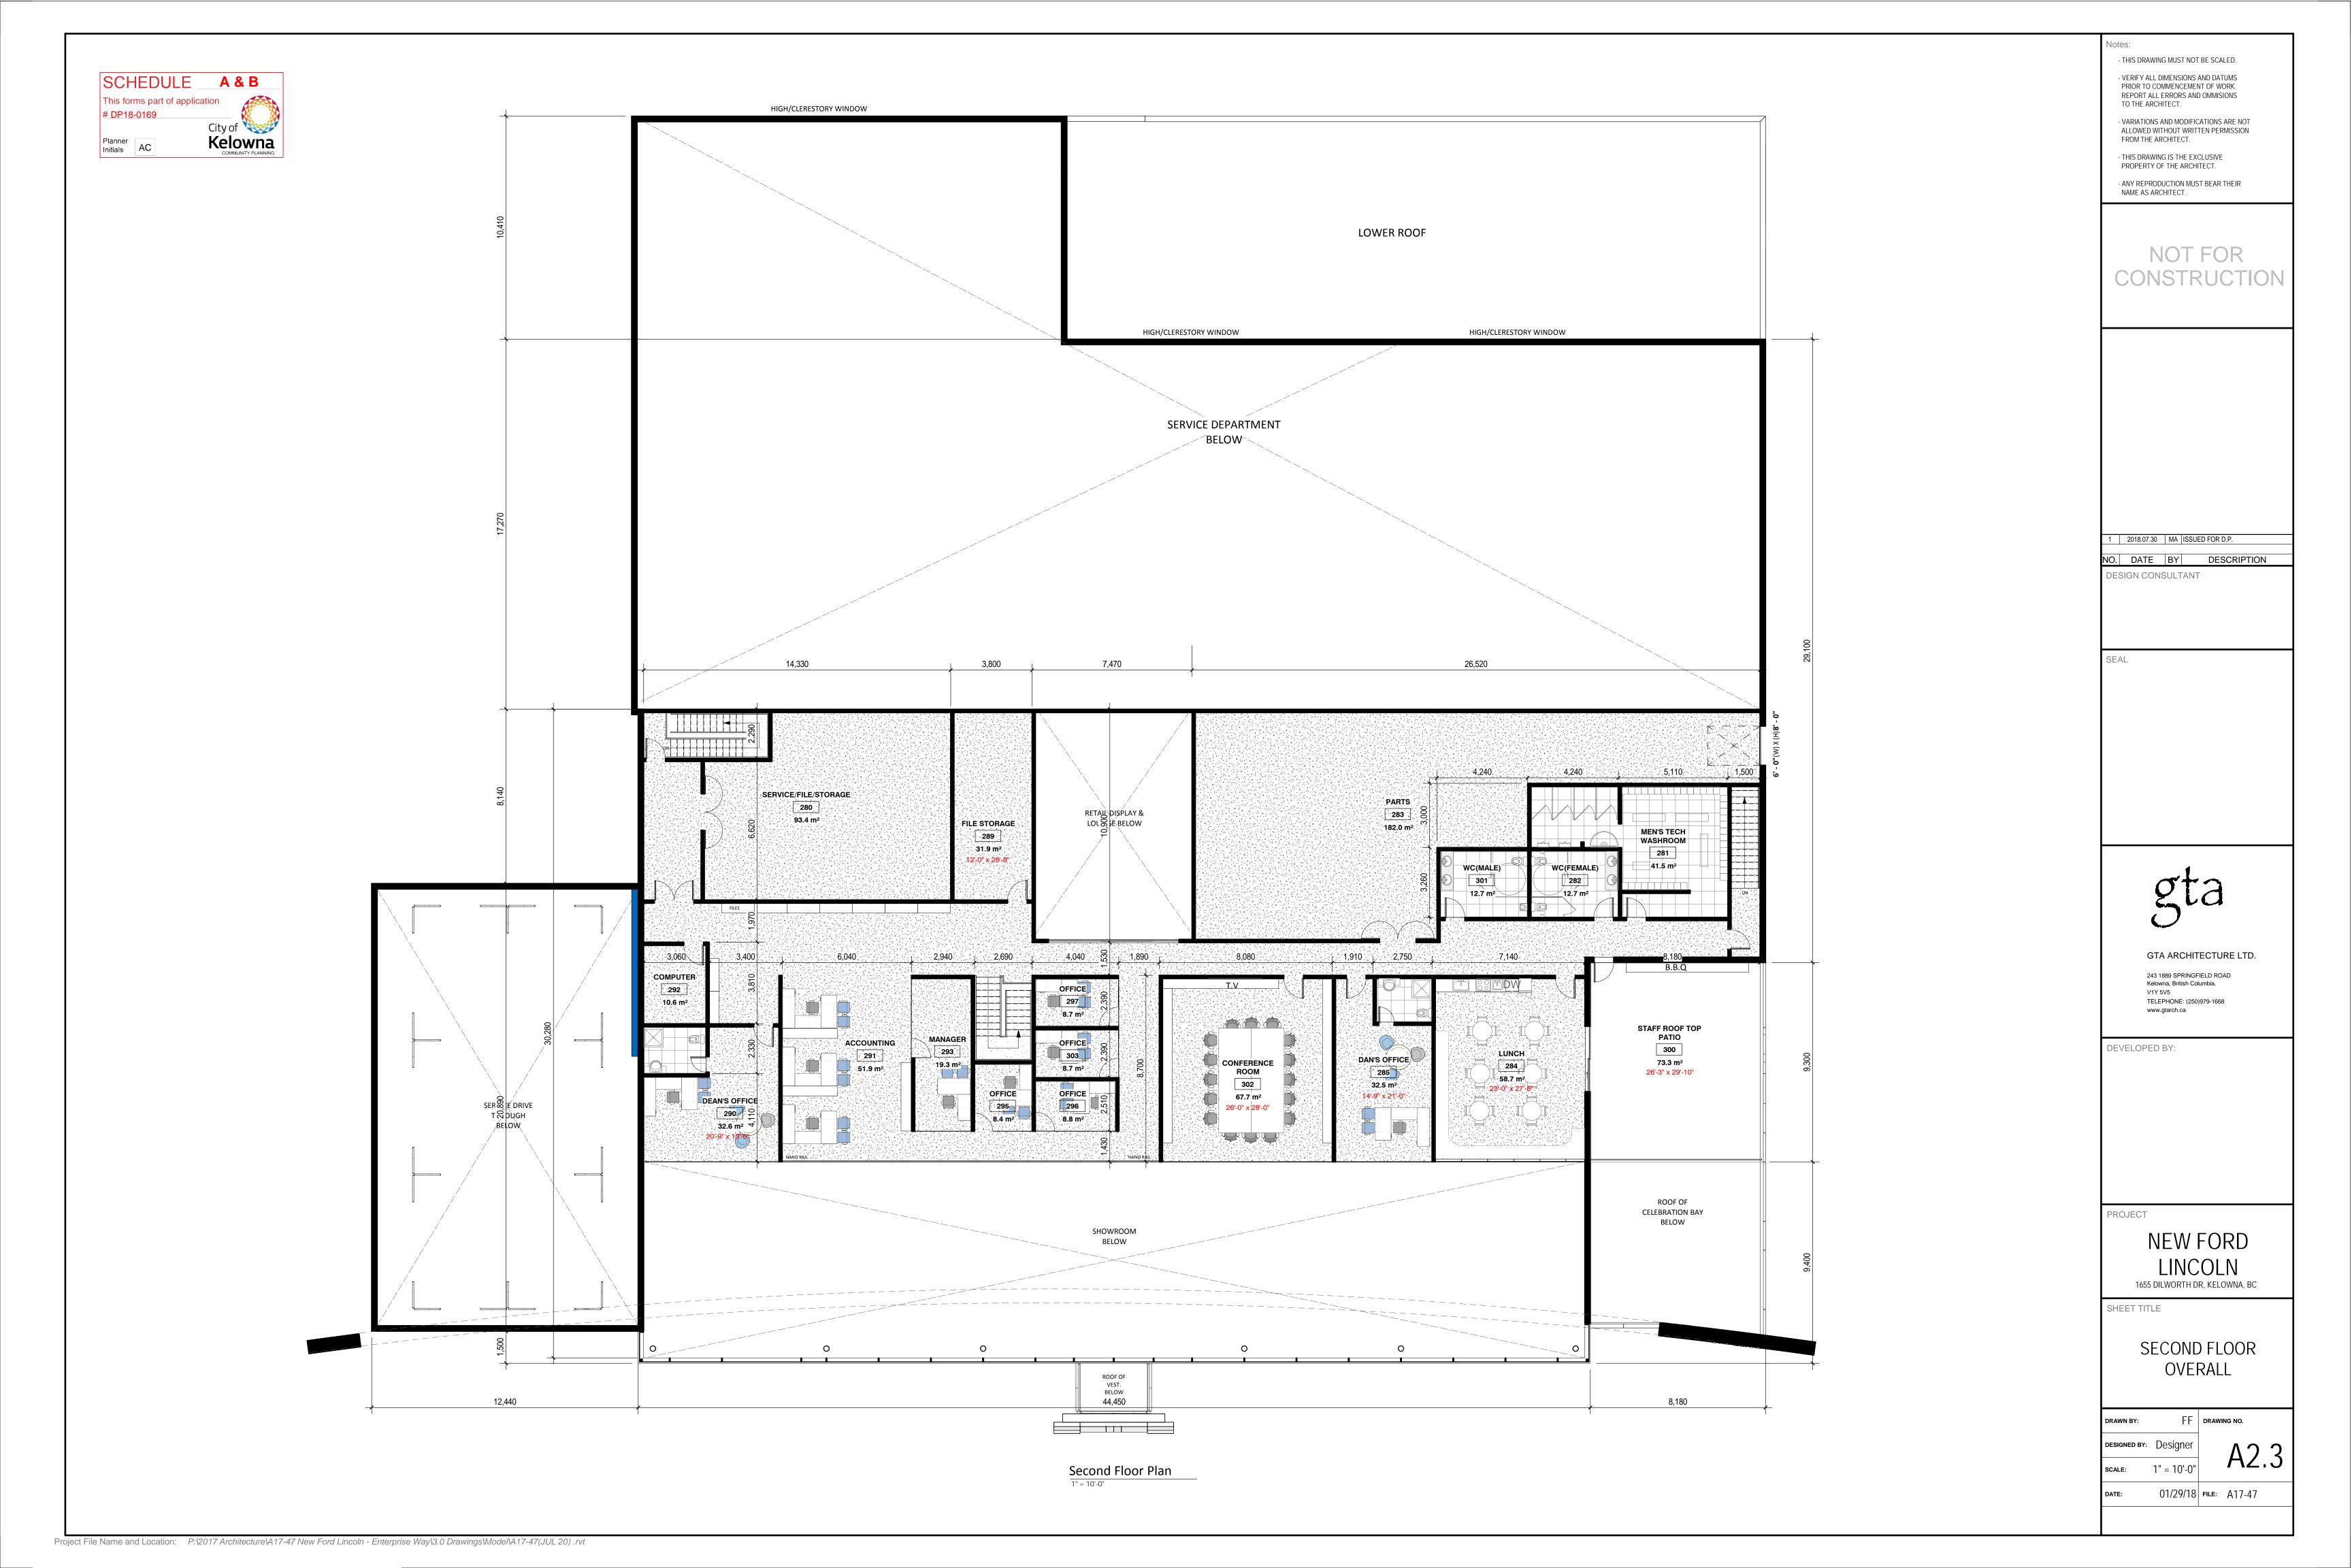



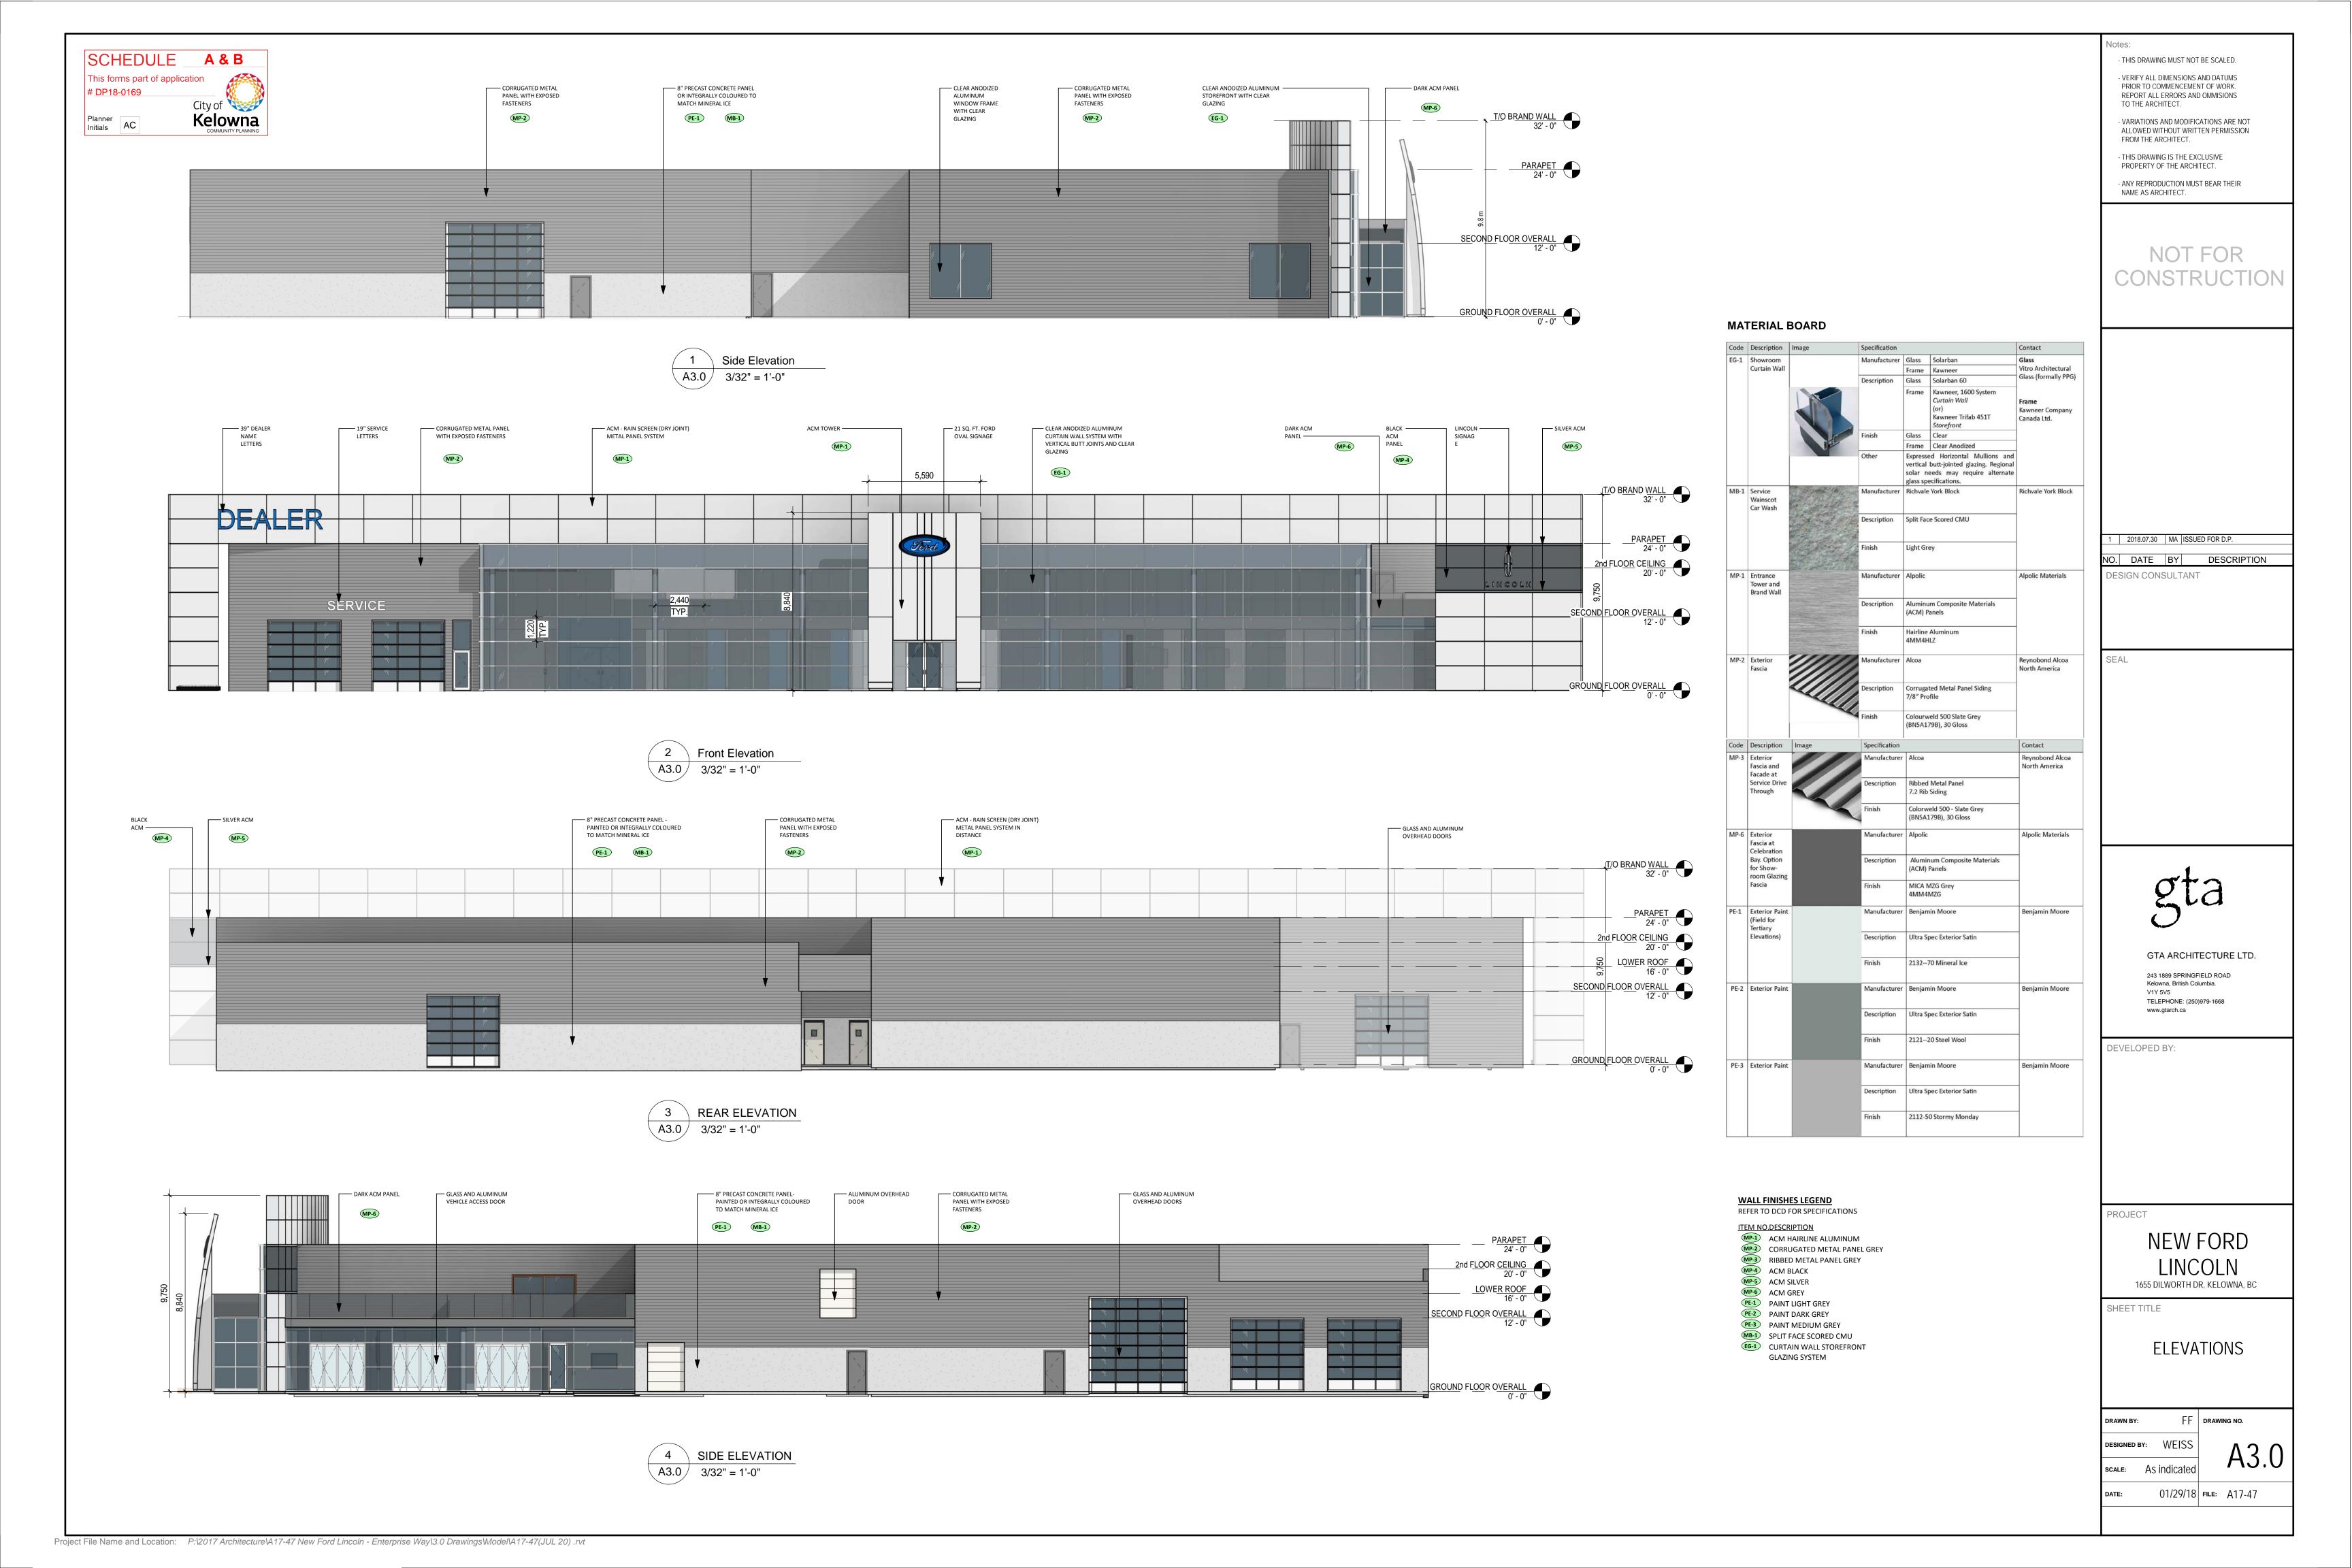



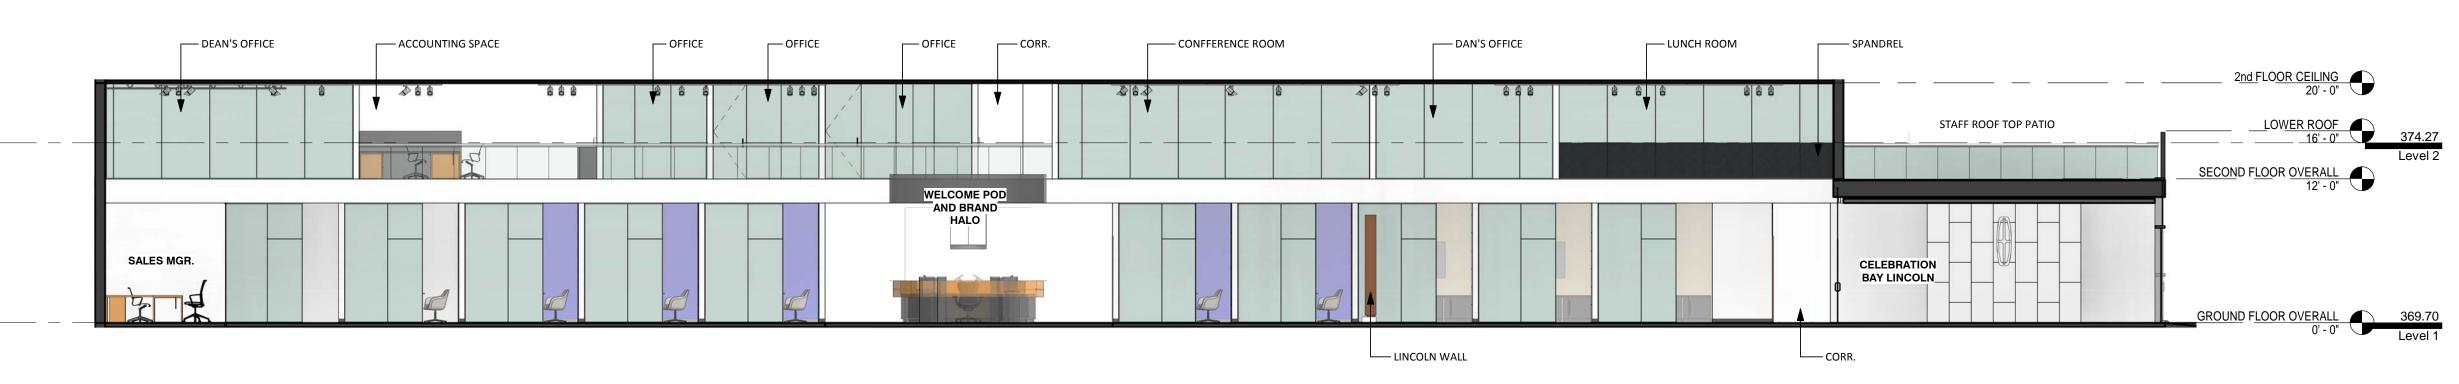







4 3D View 10 A3.51 Notes:

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gta

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DEVELOPED BY:

PROJECT

NEW FORD LINCOLN 1655 DILWORTH DR, KELOWNA, BC

SHEET TITLE

INTERIOR ELEVATION

DRAWN BY: Author Drawing No.

DESIGNED BY: Designer

SCALE: 1/8" = 1'-0"

A3.5

03/06/18 FILE: A17-47

Project File Name and Location: P:\2017 Architecture\A17-47 New Ford Lincoln - Enterprise Way\3.0 Drawings\Model\A17-47(JUL 20) .rvt





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NEW FORD LINCOLN 1655 DILWORTH DR, KELOWNA, BC


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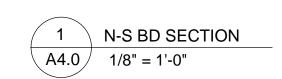
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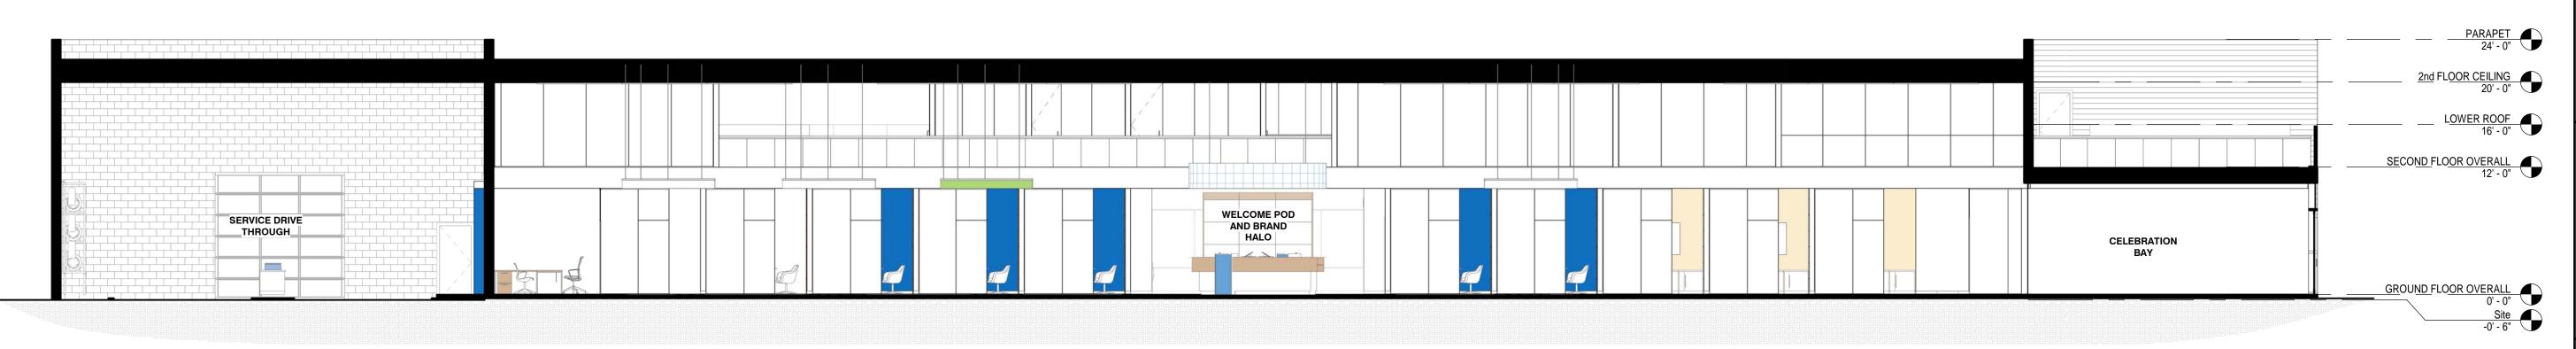
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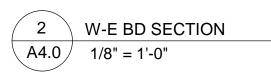
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01/29/18 FILE: A17-47









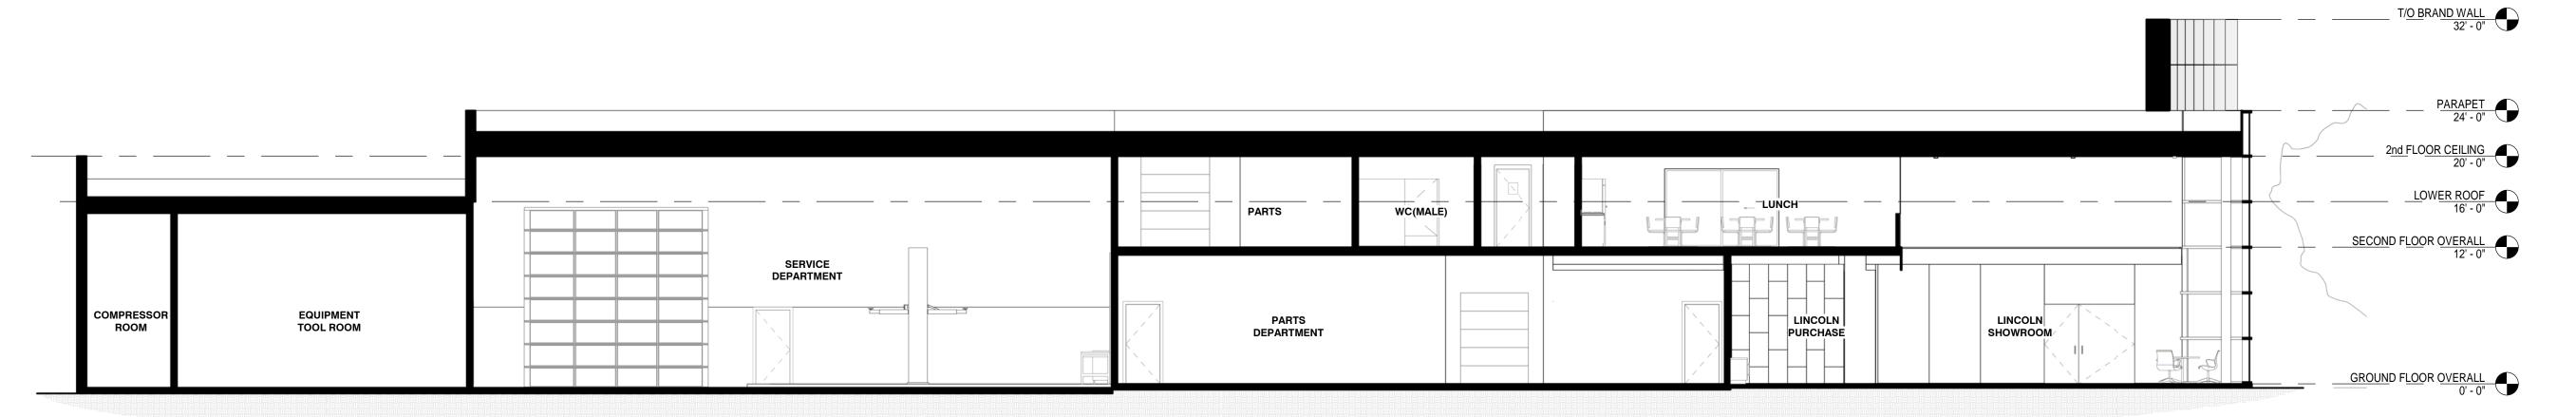



September 21, 2018

City of Kelowna 1435 Water Street Kelowna, B.C. V1J 1J4

Attention: Community Planning & Real Estate Division

Project: Trophy Ford Lincoln Commercial Development

Please be advised that a landscape security bond of \$193,539.38 will be required for the Trophy Ford Lincoln Commercial Development project. This sum is equal to 125% of the estimated installed cost for all soft landscape. The estimate includes trees, shrubs, grasses, perennials, topsoil, mulch, irrigation and bicycle racks. Please see the attached Estimate of Probable Costs for Bonding for a detailed breakdown of these costs.

Should you require any additional information, please do not hesitate to contact me.

Sincerely,

Keith Nyhof, BCSLA, CSLA

Registered Landscape Architect

СС

Mark Aquilon, GTA Architecture Ltd.







Trophy Ford Lincoln Commercial Development

Estimate of Probable Costs for Bonding

Prepared on: September 21, 2018

ems Description	Units	Qty.	Price	Item Tota
1.0 Plant Material				
1.1 Trees				
1.1.1 6cm Cal.: Deciduous Tree	ea.	41	\$550.00	\$22,550.00
			Sub-Total	\$22,550.00
1.2 Shrubs, Perennials, Grasses				
1.2.1 #5 Pot: Shrubs (3.0m O.C.)	ea.	20	\$45.00	\$900.00
1.2.2 #2 Pot: Shrubs (1.8m O.C.)	ea.	355	\$25.00	\$8,875.00
1.2.3 #1 Pot: Grasses (0.75m O.C.)	ea.	347	\$15.00	\$5,205.00
1.2.4 #1 Pot: Perennials (0.9m O.C.)	ea.	710	\$15.00	\$10,650.00
			Sub-Total	\$25,630.00
1.3 Seed & Sod				
1.3.1 Sodded Lawn	m ²	817	\$8.00	\$6,536.00
			Sub-Total	\$6,536.00
			1.0 Total	\$54,716.00
2.0 Topsoil & Mulch				
2.1 Topsoil				
2.1.1 Tree Pit Topsoil (900mm Depth)	m ³	37	\$45.00	\$1,660.50
2.1.2 Shrub Bed Topsoil (450mm Depth)	m ³	821	\$45.00	\$36,945.0
2.1.3 Lawn Topsoil (150mm Depth)	m ³	122	\$45.00	\$5,490.00
2.1.3 Lawii Topsoii (130iiiiii Deptii)		122	Sub-Total	\$44,095.50
2.2 Mulch			Sub rotur	<i>\$44,033.3</i> 0
2.2.1 Decorative Stone Mulch (75mm Depth)	m ³	137	\$55.00	\$7,535.00
			Sub-Total	\$7,535.00
			2.0 Total	\$51,630.50
				, -, -,
3.0 Servicing				
3.1 Irrigation				
3.1.1 Sleeving	l.s.	1	\$1,250.00	\$1,250.00
3.1.2 Point of Connection	l.s.	1	\$750.00	\$750.00
3.1.3 Control System	l.s.	1	\$1,500.00	\$1,500.00
3.1.4 Irrigation System (heads, pipes, valves)	m ²	2649	\$15.00	\$39,735.00
			Sub-Total	\$43,235.00
			3.0 Total	\$43,235.00
4.0 Site Construction				
4.1 Site Furniture				
4.1.1 Bike Rack (2 bikes per bike rack)	ea.	7	\$750.00	\$5,250.00
2	- Cu.	<u> </u>	Sub-Total	\$5,250.00
			4.0 Total	\$5,250.00
			Subtotal	\$154,831.50
		Securit	y Total (125%)	\$193,539.38

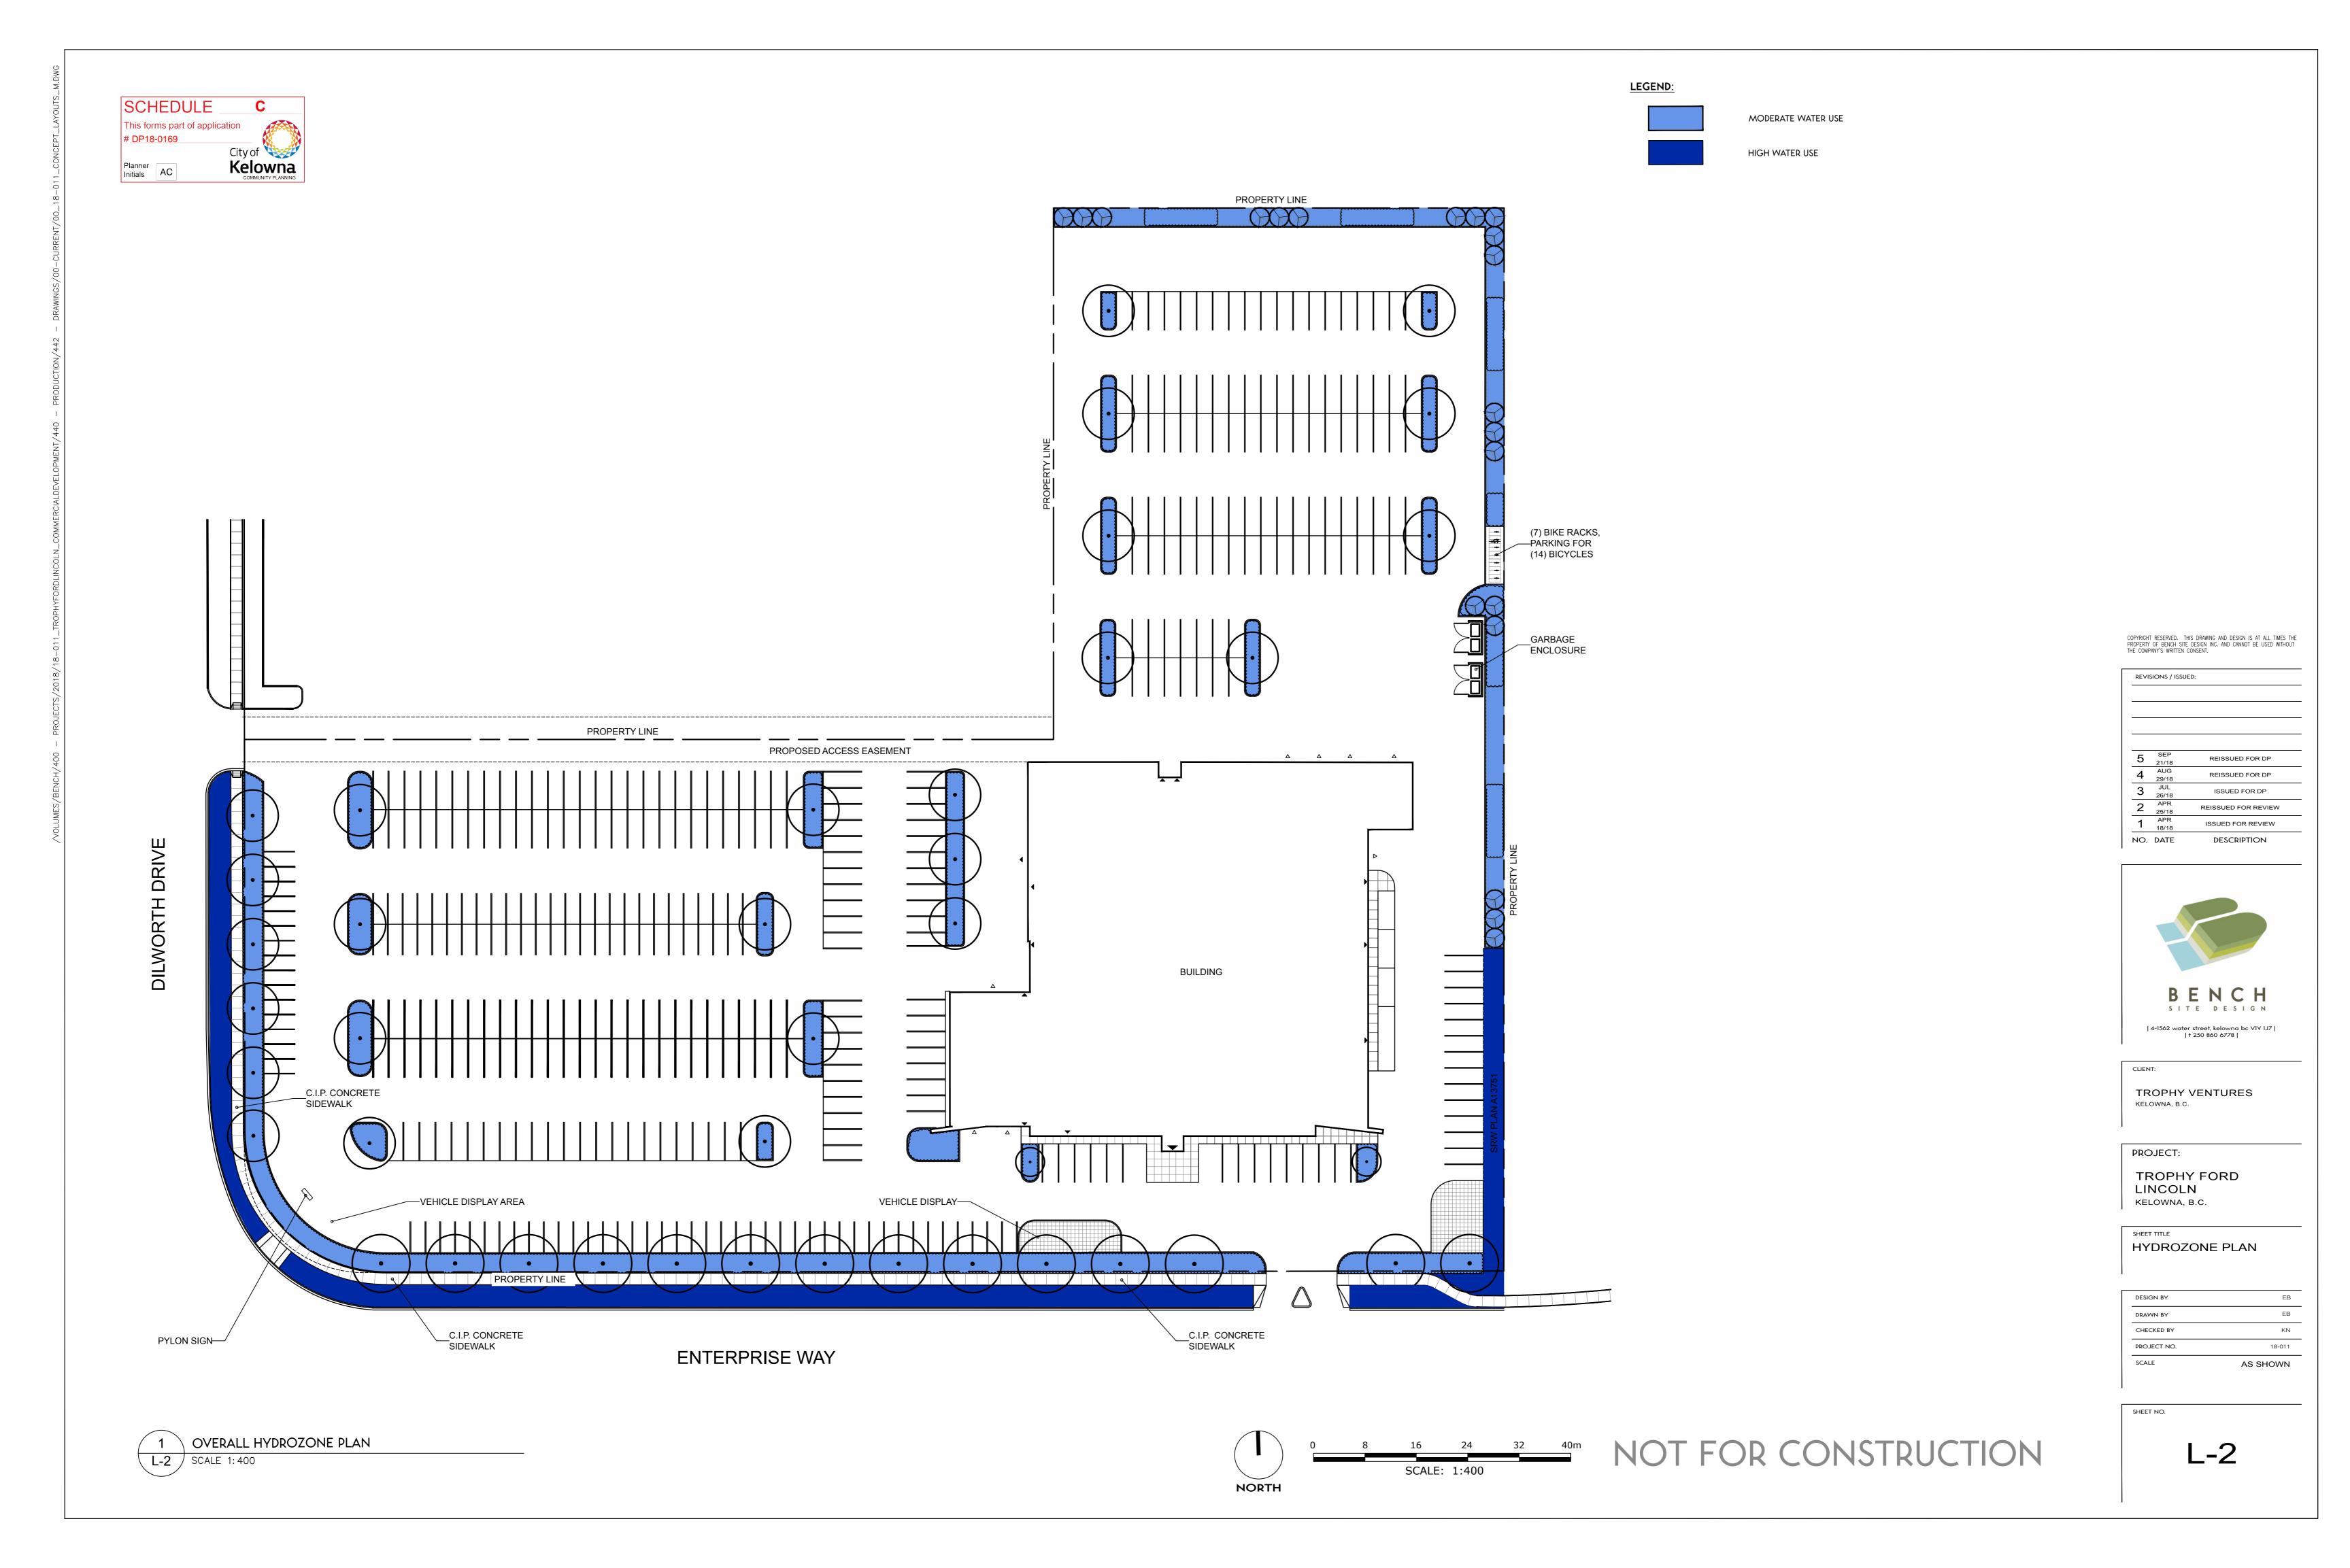

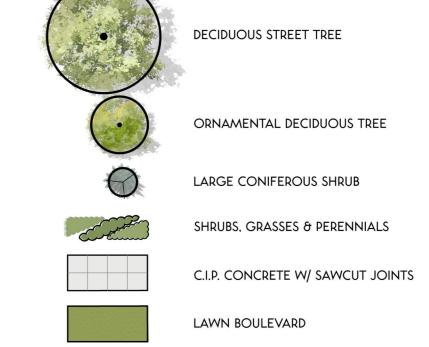

DEVELOPMENT PERMIT NOTES:

- A PLANT MATERIALS AND CONSTRUCTION METHODS SHALL CONFORM TO MINIMUM STANDARDS ESTABLISHED IN THE LATEST EDITION OF THE B.C. LANDSCAPE STANDARDS, PUBLISHED BY B.C.N.T.A. AND B.C.S.L.A. AS WELL AS THE CITY OF KELOWNA LANDSCAPE
- B THE LANDSCAPE DESIGN DESIGNATED HEREIN IS CONCEPTUAL BUT REFLECTS THE MINIMUM CITY OF KELOWNA FORM AND CHARACTER REQUIREMENTS
- C PLANT MATERIAL SELECTIONS ARE CONCEPTUAL ONLY. FINAL PLANTING SELECTIONS MAY
- VARY DEPENDING UPON AVAILABILITY AT THE TIME OF CONSTRUCTION.
- D TREES SHALL BE INSTALLED IN DEFINED SOIL PITS OR PLANTING BED AREAS. ADEQUATE SOIL VOLUME SHALL BE PROVIDED BASED ON THE SPECIFIED TREE SPECIES AND LOCATION.
- E ORNAMENTAL SHRUB, GRASS AND PERENNIAL CLUSTERS ARE TO BE PLACED WITHIN DEFINED PLANTING BEDS. ALL PLANTING BEDS SHALL HAVE A MIN. OF 450mm (18")
- IMPORTED GROWING MEDIUM AND 75mm (3") OF DECORATIVE ROCK. F DECORATIVE ROCK AREAS SHALL HAVE A MIN. OF 75mm (3") OF 25mm (1") DECORATIVE
- CRUSHED ROCK. COMMERCIAL GRADE LANDSCAPE FABRIC SHALL BE INSTALLED BELOW ALL DECORATIVE ROCK AREAS.
- G TREE SOIL PITS TO HAVE 75mm (3") OF OGOGROW MULCH.
- H TURF AREAS SHALL BE LOW WATER USE 'NO. 1 PREMIUM' SOD WITH HAVE A MIN, OF 150mm (6") IMPORTED GROWING MEDIUM
- I A HIGH EFFICIENCY IRRIGATION SYSTEM SHALL BE INSTALLED FOR ALL ORNAMENTAL LANDSCAPE AREAS AND SHALL CONFORM TO THE CITY OF KELOWNA'S IRRIGATION

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REVISIONS / ISSUED: REISSUED FOR DP REISSUED FOR DP ISSUED FOR DP REISSUED FOR REVIEW ISSUED FOR REVIEW NO. DATE DESCRIPTION



TROPHY VENTURES KELOWNA, B.C.

PROJECT:

TROPHY FORD LINCOLN KELOWNA, B.C.

LANDSCAPE PLAN

EB
KN
18-011
AS SHOWN

SHEET NO.

L-1

SCALE: 1:400 NORTH

NOT FOR CONSTRUCTION

SCALE 1: 400



1435 Water Street Kelowna, BC V1Y 1J4 250 469-8500 kelowna.ca

IRRIGATION APPLICATION

APPLICATION IDENTIFICATION

Oumari	Trophy Ventures	Cubiost Address	16EE Dilysonth Dri	ive Valeuma PC		
Agent if applicable:	Trophy Ventures		1655 Dilworth Dri (250) 979-1668	ive, Relowiid, DC		
	Project Manager	Fax No:	(230) 979-1668			
	GTA Architecture Ltd.		mark@gtarch.ca	gfield Road, Kelowna		
City:	Kelowna			Postal Code: V1Y 5V5		
		Province	ВС	Postal Code: V11 5V5		
LANDSCAPE WA	TER CONSERVATION CHECKLIST					
Note: all boxes are to be	e checked - see instruction page					
\boxtimes	Install Backflow prevention devices to meet City of Kelowna standards to isolat	e the outdoor irrigation syst	em from the potab	le water system.		
\boxtimes	Group planting into 'hydrozones' of high, medium and low water-use plants or	unirrigated/unwatered area	s.			
	Minimize mown turf areas that are high water use areas - ideally to 50% of the meadow, mulch, spaced wood deck, pervious paving.	landscape area or less - subs	stitute with areas o	of lower water use treatments like unwatered native woods o	r	
	Povide adequate topsoil or growing medium of depth and quality to meet the B Association. General minimum depths over poor subsoils are 150mm for lawn an			ciety of Landscape Architects and the BC Landscape and Nurs	ery	
	Group irrigation circuits/zones into 'hydrozones' of high, medium, and low or u irrigated hydrozone.	inirrigated areas consistent v	with the landscape	planting plan. Provide a separate irrigation valve for each		
\boxtimes	Minimize use of high-volume spray heads, and employ drip or low volume irriga	tion where practical.				
\boxtimes	When spray or rotor irrigation is used, design and install head to head coverage in accordance with manufacturer's specifications, and avoid overspray outside landscape areas.					
\boxtimes	Ensure matched precipitation rates within all irrigation circuits.					
	Design and install pipe and head layout so flow velocity does not exceed 1.5 m. drainage.	/s, and to minimize elevatio	n change or pressu	re variation in circuits. Provide check valves to stop low head	d	
\boxtimes	Ensure irrigation mainlines are proved leak-free with hydrostatic tests.					
\boxtimes	Provide pressure regulating devices to ensure irrigation outlets are operating at	t the manufacturer's optimu	m pressure range.			
\boxtimes	Install - and program to minimize water use - 'Smart Controllers' to meet stand	lards of the City of Kelowna	Water Regulation B	iylaw.		
	Install an irrigation master shut-off valve (isolation valve) located outside the be water supply to the outdoor irrigation system and shall be capable of being closester to the outdoor irrigation system and shall be capable of being closester.			: when closed shall stop the supply of water from the potable	е	
Applicant Notes on the L	andscape Water Conservation Checklist:					

Page 1 of 3





IRRIGATION APPLICATION

1435 Water Street Kelowna, BC V1Y 1J4 250 469-8500 kelowna.ca

LANDSCAPE WATER CONSERVATION TABLE

Applicant: BENCH Site Design Inc. on Behalf of Trophy Ventures and GTA Architecture Inc.

Address: 4 - 1562 Water Street, Kelowna BC V1Y 1J7

Step 1: Measure Total Landscape Area (LA)

Area of site that will absorb water:

2686 sq.n

Note: INCLUDE BOULEVARD, and proposed lawn, plants, mulch, PERVIOUS decks or paving. Do not include building areas, driveways, patios, decks or walks unless pervious.

Step 2: Divide Into Landscape Treatments*		Plant Factor	Irrig Efficiency	Hydrozone Area (Sq.m.)	% of Total LA	Estimated Water Use (cu.m.)
Note: each of the areas below are a 'HYDROZONE'		(PF)	(IE)	(HA)		(WU)
Lauraharad Damiiana Araaa (aab irraamiiana						
Unwatered Pervious Areas (not impervious p	aving)					
Mulch (Stone, bark or sand)		N/A	N/A	0	0%	N/A
Pervious deck (Spaced wood deck)		N/A	N/A	0	0%	N/A
Pervious paving (Granular paving)		N/A	N/A	0	0%	N/A
laturalized meadow (wildflowers)		N/A	N/A	0	0%	N/A
laturalized area (Existing natural area)		N/A	N/A	0	0%	N/A
Other: Restoration Area		N/A	N/A	0	0%	N/A
wimming or ornamental pool		1	1	0	0%	0
Natered Planting Beds (shrubs or groundcov	er)					
Planting Type	Irrig Efficiency					
ow water use plants	High (Drip or Bubbler)	0.3	0.9	0	0%	0
ow water use plants	Low (Spray orRotor)	0.3	0.7	0	0%	0
Moderate water use plants	High (Drip or Bubbler)	0.5	0.9	1690	63%	939
Moderate water use plants	Low (Spray orRotor)	0.5	0.7	0	0%	0
ligh water use plants	High (Drip or Bubbler)	0.7	0.9	0	0%	0
ligh water use plants	Low (Spray orRotor)	0.7	0.7	0	0%	0
Watered Mown Lawn Areas	Low	1	0.7	996	37%	1423
Special Landscape Areas (SLA)						
egetable Garden	High (Drip or Bubbler)	1	0.9	0	0%	0
egetable Garden	Low (Spray orRotor)	1	0.7	0	0%	0
ports Lawn	Low (Spray orRotor)	1	0.7	0	0%	0
ainwater or Recycled Water Use		0.3	1	0	0%	0
Totals				2686	100%	2362
pecial Landscape Area (SLA) Sub total				l ol		

^{*}If proposed design conditions are not shown on the form please contact Water Smart at 250-868-3339

Page 2 of 3





1435 Water Street Kelowna, BC V1Y 1J4 250 469-8500 kelowna.ca

IRRIGATION APPLICATION

Page 3 of 3

CALCULATE & COMPARE WATER BUDGET TO ESTIMATED WATER USE

NOTE: Post Signed and approved application at Smart Controller for future reference

Note: For Evapotranspiration (ETo) in Kelowna use 10	00mm/yr	Amount	Units		
Total Landscape Area		2686	sq.m.		
Landscape Maximum Water Budget (WB)		2686	cu.m./yr.		
Estimated Landscape Water Use (WU)		2362	cu.m./yr.		
Under (-OVER) Budget (Must be under Water Budget WB)		324	cu.m./yr.		
		OK			
	ed 'Landscape Water Conservation Checklist' above, that the le landscape treatments of the project will conform to the H				
			Date:	21-Sep-18	
Signature of Applicant	-				
,					
FOR CITY OF KELOWNA OFFICE USE ONLY					
The Irrigation Application and calculations above satisfy th designate.	e requirements of the Water Regulation Bylaw 10480 Section	n 4.4.2 and 4.4.3	and is hereby APPROVE	ED with the signature of the Water	Manager or
Signature of Kelowna Water Smart designate	-		Date:		
For Water Manager			bate.		
Print Name	-				
ri iit name					

