

Page 4 of 7

Similar to the request for a variance for the triplex, we are requesting a variance for the number of stories for two fourplex buildings at The Site. Flanked by single family buildings of similar height and number of stories, the fourplexes have been designed as a continuation of form and character in keeping with the streetscape established by the flanking homes. The location of the fourplexes is such that they back onto steep grades and do not impact views from homes above. Additionally, single family homes on the opposite side of the same street have their views oriented from the opposite side of the homes. Accordingly, the location of the fourplexes is ideally suited to limit the impact on the remainder of the neighbourhood while again, offering a diversity of housing types in a development that is mostly single family. Further to the original design, our team has responded to comments from the City regarding the design of the fourplexes noting the following:

- Stepping back portions of the second floor and third floor 1.2m back from the garage and front doors.
- Reducing the overhang at the upper level to avoid reducing the 1.2m setback at the upper levels.
- Accentuating the 1.2m step back through the use of lighter finished siding colour.
- Articulating the 4 separate units more clearly by giving space between decks and the central decks and railings. As per our illustrations, the requested variance is minor in character; all buildings in the above study will comply with the maximum building height
- Developing a more comprehensive landscape scheme in order to soften the impact of the building facade from the street. Landscaping strategies include:
 - DP drawings already have narrow street trees between the units which will
 provide vertical softening, but minimally impact the views from the balconies.
 Consistent with the design of the previous Phase, there will be a cobble mulch
 that edges the street mixed with some feature boulders to provide interest, in
 addition to a mixed palette of shrubs and ornamental grasses. The
 surrounding slopes are hydroseeded with native grasses and wildflowers.
 - Against the side elevations and in the upslope buffer planting (irrigated) we
 will supplement with additional native large shrubs/ small trees such as
 Douglas Maple, Saskatoon Berry and Western Mock Orange to enhance the
 vertical visual buffering, while not impacting the views from above.

The revised colour/massing study and sketch landscape concept drawings have been included on the following pages.



Page 5 of 7




Revised Fourplex Design




Revised Fourplex Design



Page 6 of 7

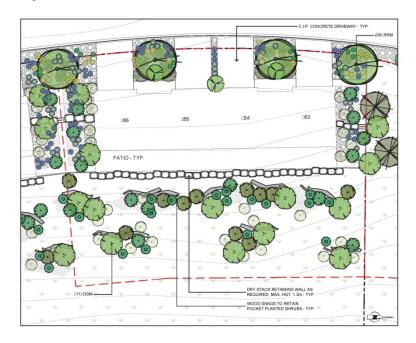

Proposed Landscape treatment for the Fourplex Design

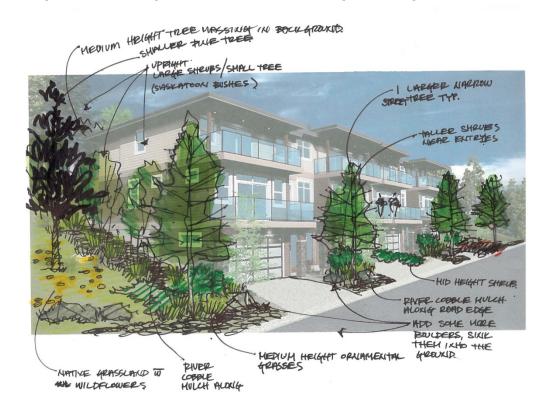

Proposed Design treatment for the Fourplex Design



Page 7 of 7



Proposed Design treatment for the Fourplex Design

Thank you for the time and effort to work with our team as it pertains to the building designs for the tri and fourplexes at Solstice, Phase 2.

We look forward to your support in response to the DVP for this project.

Sincerely,

Matt Johnston Architect AIBC, LEED AP Architecturally Distinct Solutions Inc.

Development Permit & Development Variance Permit DP17-0291 & DVP18-0140



This permit relates to the following subject properties:

- Strata Lot 63, Sec 31, TWP 27, ODYD, Strata Plan EPS2195, together with an interest in the common property in proportion to the unit entitlement of the strata lot as shown on Form V; located at 1540 Tower Ranch Dr, Kelowna, BC
- Strata Lot 64, Sec 31, TWP 27, ODYD, Strata Plan EPS2195, together with an interest in the common property in proportion to the unit entitlement of the strata lot as shown on Form V; located at 1544 Tower Ranch Dr, Kelowna, BC
- Strata Lot 65, Sec 31, TWP 27, ODYD, Strata Plan EPS2195, together with an interest in the common property in proportion to the unit entitlement of the strata lot as shown on Form V; located at 1548 Tower Ranch Dr, Kelowna, BC
- Strata Lot 66, Sec 31, TWP 27, ODYD, Strata Plan EPS2195, together with an interest in the common property in proportion to the unit entitlement of the strata lot as shown on Form V; located at 1552 Tower Ranch Dr, Kelowna, BC
- Strata Lot 67, Sec 31, TWP 27, ODYD, Strata Plan EPS2195, together with an interest in the common property in proportion to the unit entitlement of the strata lot as shown on Form V; located at 1556 Tower Ranch Dr, Kelowna, BC
- Strata Lot 68, Sec 31, TWP 27, ODYD, Strata Plan EPS2195, together with an interest in the common property in proportion to the unit entitlement of the strata lot as shown on Form V; located at 1560 Tower Ranch Dr, Kelowna, BC
- Strata Lot 69, Sec 31, TWP 27, ODYD, Strata Plan EPS2195, together with an interest in the common property in proportion to the unit entitlement of the strata lot as shown on Form V; located at 1564 Tower Ranch Dr, Kelowna, BC
- Strata Lot 70, Sec 31, TWP 27, ODYD, Strata Plan EPS2195, together with an interest in the common property in proportion to the unit entitlement of the strata lot as shown on Form V; located at 1568 Tower Ranch Dr, Kelowna, BC

and permits the land to be used for the following development:

Multi-family development (Row Housing)

The present owner and any subsequent owner of the above described land must comply with any attached terms and conditions.

<u>Date of Decision:</u> September 18, 2018

<u>Decision By:</u> CITY COUNCIL

Issued Date:

<u>Development Permit Area:</u> Hillside Development Permit Area

This permit will not be valid if development has not commenced by September 18, 2020.

Existing Zone: RM2 – Low Density Row Housing

This is NOT a Building Permit.

In addition to your Development Permit, a Building Permit may be required prior to any work commencing. For further information, contact the City of Kelowna, Development Services Branch.

NOTICE

This permit does not relieve the owner or the owner's authorized agent from full compliance with the requirements of any federal, provincial or other municipal legislation, or the terms and conditions of any easement, covenant, building scheme or agreement affecting the building or land.

Owner: Parkbridge Lifestyle Communities Inc.

Applicant: Matt Johnston, Architecturally Distinct Solutions Inc.

Ryan Smith Community Planning Department Manager Community Planning & Strategic Investments Date

1. SCOPE OF APPROVAL

This Development Permit applies to and only to those lands within the Municipality as described above, and any and all buildings, structures and other development thereon.

This Development Permit is issued subject to compliance with all of the Bylaws of the Municipality applicable thereto, except as specifically varied or supplemented by this permit, noted in the Terms and Conditions below.

The issuance of a permit limits the permit holder to be in strict compliance with regulations of the Zoning Bylaw and all other Bylaws unless specific variances have been authorized by the Development Permit. No implied variances from bylaw provisions shall be granted by virtue of drawing notations that are inconsistent with bylaw provisions and that may not have been identified as required Variances by the applicant or Municipal staff.

2. CONDITIONS OF APPROVAL

- a) The dimensions and siting of the building to be constructed on the land be in accordance with Schedule "A";
- b) The exterior design and finish of the building to be constructed on the land be in accordance with Schedule "B";
- c) Landscaping to be provided on the land be in accordance with Schedule "C"; and
- d) The applicant be required to post with the City a Landscape Performance Security deposit in the form of a "Letter of Credit" in the amount of 125% of the estimated value of the landscaping, as determined by a Registered Landscape Architect.

AND THAT variances to the following sections of Zoning Bylaw No. 8000 be granted:

Section 13.8.6(c): RM2 - Low Density Row Housing Development Regulations

To vary the required maximum height from 2 ½ storeys or 9.5m to 3 storeys or 10.1m proposed;

This Development Permit is valid for two (2) years from the date of September 18, 2020 approval, with no opportunity to extend.

3. PERFORMANCE SECURITY

As a condition of the issuance of this Permit, Council is holding the security set out below to ensure that development is carried out in accordance with the terms and conditions of this Permit. Should any interest be earned upon the security, it shall accrue to the Developer and be paid to the Developer or his or her designate if the security is returned. The condition of the posting of the security is that should the Developer fail to carry out the development hereby authorized, according to the terms and conditions of this Permit within the time provided, the Municipality may use enter into an agreement with the property owner of the day to have the work carried out, and any surplus shall be paid over to the property own of the day. Should the Developer carry out the development permitted by this Permit within the time set out above, the security shall be returned to the Developer or his or her designate. There is filed accordingly:

a) An Irrevocable Letter of Credit in the amount of \$65466.25

Before any bond or security required under this Permit is reduced or released, the Developer will provide the City with a statutory declaration certifying that all labour, material, workers' compensation and other taxes and costs have been paid.

4. INDEMNIFICATION

Upon commencement of the works authorized by this Permit the Developer covenants and agrees to save harmless and effectually indemnify the Municipality against:

a) All actions and proceedings, costs, damages, expenses, claims, and demands whatsoever and by whomsoever brought, by reason of the Municipality said Permit.

All costs, expenses, claims that may be incurred by the Municipality where the construction, engineering or other types of works as called for by the Permit results in damages to any property owned in whole or in part by the Municipality or which the Municipality by duty or custom is obliged, directly or indirectly in any way or to any degree, to construct, repair, or maintain.

The PERMIT HOLDER is the <u>CURRENT LAND OWNER</u>.
Security shall <u>ONLY</u> be returned to the signatory of the Landscape Agreement or their designates.

LOTS 63,64,65,66 SOLSTICE

PHASE 2

GENERAL NOTES - ARCHITECTURAL:

ALL WORK SHALL CONFORM TO THE STANDARDS OF THE N.B.C. OF CANADA 2010 (of applicable section), THE B.C. BUILDING CODE (BCBC) 2012 AND ALL LOCAL CODES,

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- PRINCED GRADE.

- ANNIMUM CONCRETE STRENGTH AT 28 DAYS: FOOTINGS, SLABS, FOUNDATION WALLS: 8000PSI, LIGHTWEIGHT CONCRETE TOPPING: 4000PSI.

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-ALARMS AND DETECTION SYSTEMS TO BE AS PER 3.2.4.1 OF THE BOBC.

DRAWINGS:

A-001 SITE PLAN AND PROJECT INFORMATION A-002 ASSEMBLES A-101 ENTRY LEVEL PLAN

A-101 ENTRY LEVEL FAIN
A-102 MIDDLE IEVEL FAIN
A-103 LOWER LEVEL PLAN
A-200 ELEVATIONS
A-300 SECTIONS
A-501 DETAILS
A-501 DETAILS
A-502 PARTY WALL DETAILS
A-600 RENDERS

SITE STATISTICS:

SUBDIMSION OF LOT 3; SEC. 27, TWP. 27 ODYD DISTRICT PLAN KAP 80993

ZONING:

ZONING CALCULATIONS:


CURRENT: City of Kelowna RM2H Zoning

SITE INFORMATION:

Gross Site Are	10=	13,679 sf 1,248 sm)		
Allowable Site	Coverage=		50% (6,840sf)	28.3% 3,876st
Coverage + H	Hardscoping=		56% (7,523s)	37% (5,000sf)
F.A.R. =			.65 (8,891.4sf)	.53 (7,240sl)
Unit Net Floor UNIT 1 UNIT 2 UNIT 3 UNIT 4	Area Calculations: ENTRY LEVEL 50 50 50 50	MIDDLE FLOOR 890 890 890 890	UPPER LEVEL 870 870 870 870	TOTAL 1,810 1,810 1,810 1,810 7,240
		Allowed		Proposed
Max. Height =		9.5m (31.16 ff) or 2.5 storeys		7.9m (25.9 ft) or 3 storeys VARIANCE
Yard setbacks				







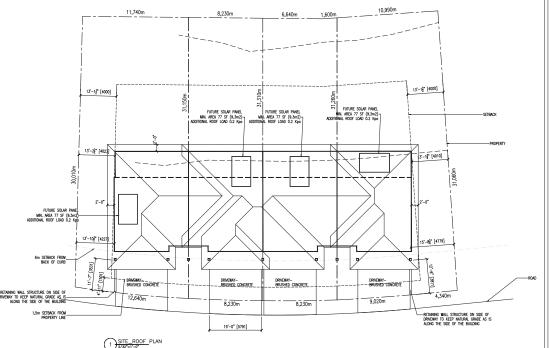




DRAWING TITLE ITE_ROOF PLAN

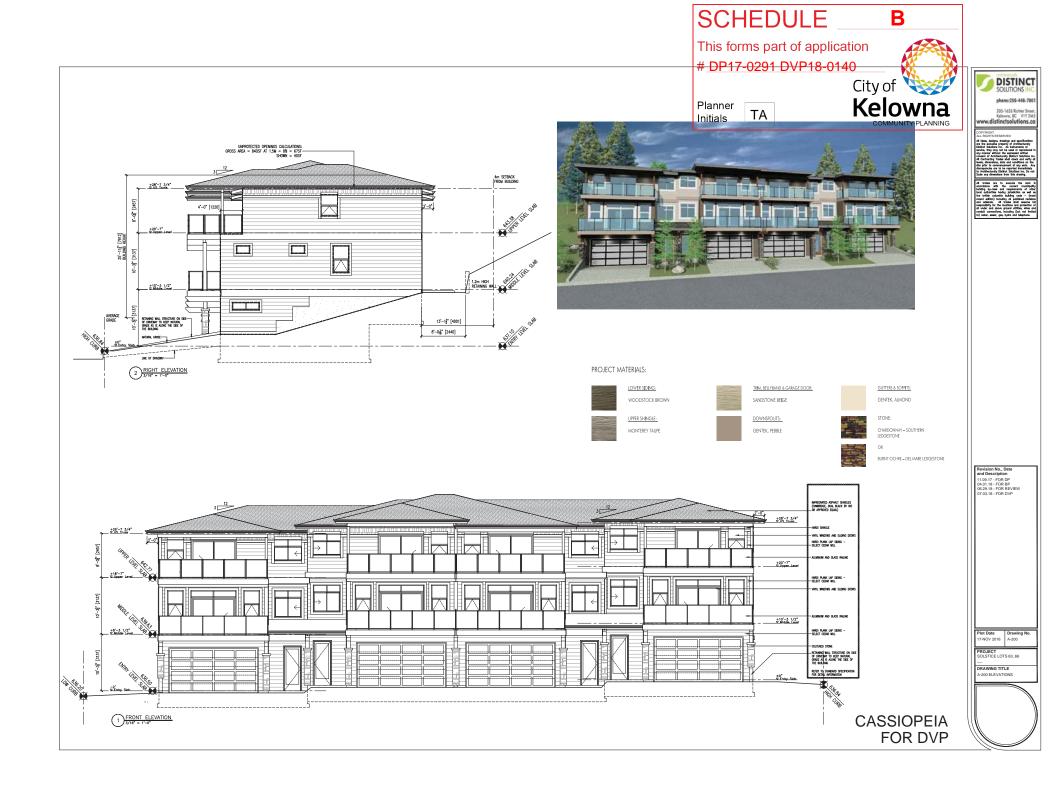

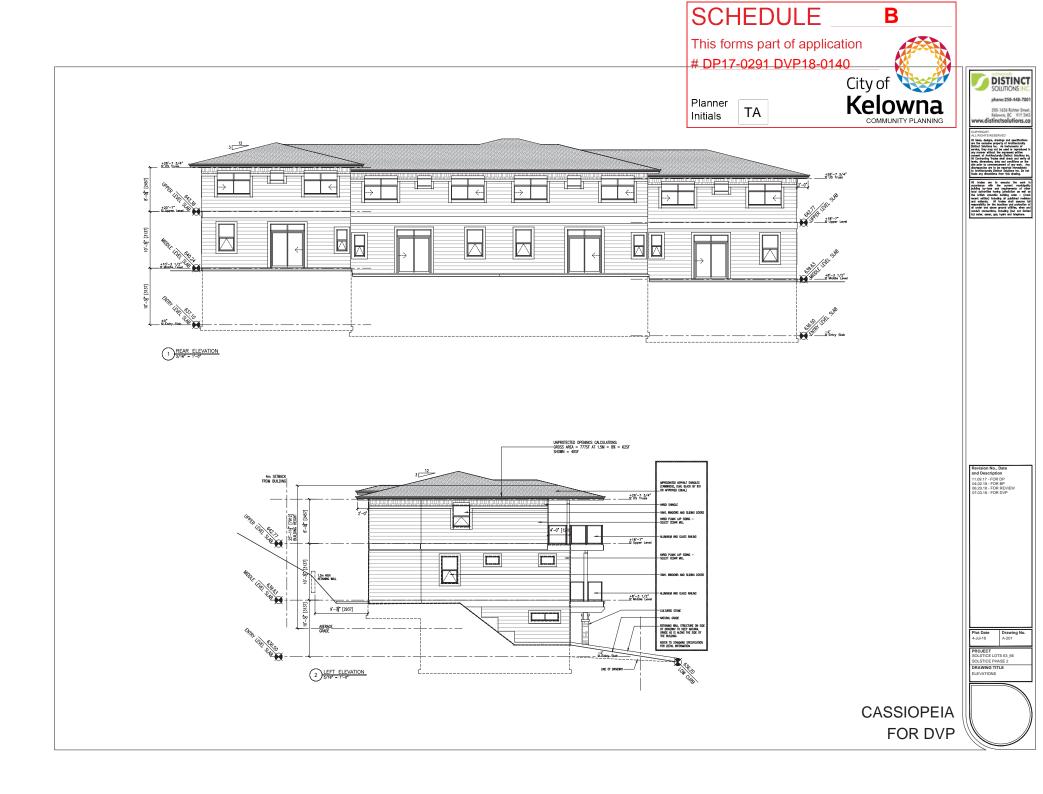

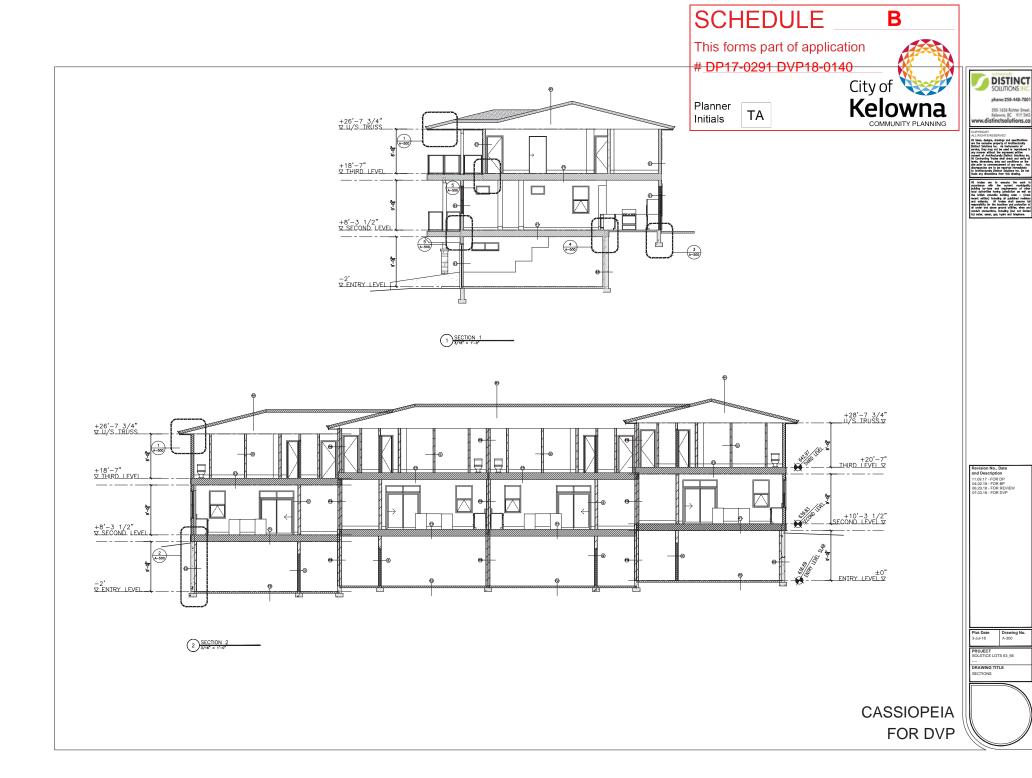



VIEW 1 - FRONT VIEW FROM STREET



VIEW 2 - FRONT VIEW FROM LEFT






Revision No., Date and Description 11.09.17 - FOR DP 04.02.18 - FOR BP 06.29.18 - FOR REVIEW 07.03.18 - FOR DVP

Plot Date Drawing N 3-Jul-18 A-RENDER

PROJECT
SOLSTICE LOTS 63_66
SOLSTICE PHASE 2
DRAWING TITLE
RENDERINGS

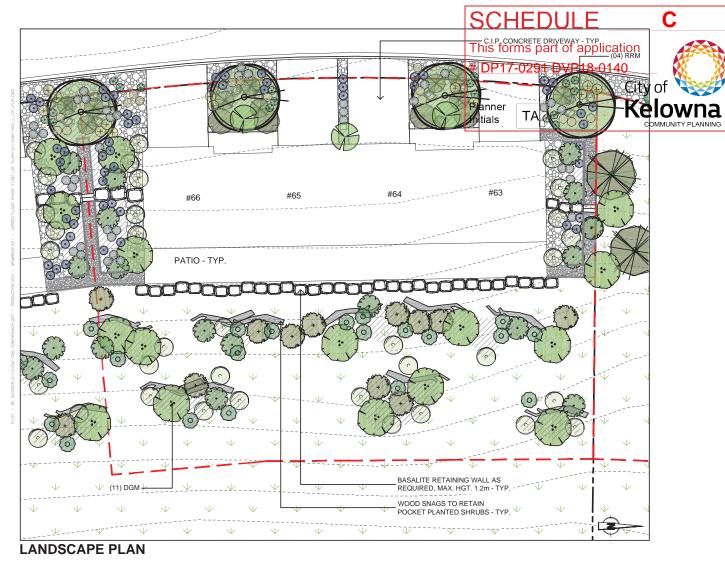

PLANT LIST

SYMBOL	QUANTITY	BOTANICAL NAME	COMMON NAME	SIZE	ROOT	MATURE PLANT SIZE (Ht. x Wd.)
TREES						
DGM	11	Acer glabrum	Douglas Maple	#05		12.0m x 6.0m
RRM	4	Acer rubrum 'Red Rocket'	Red Rocket Maple	60mm Cal.	B.&B.	9.00m x 2.50m
SHRUBS						
sks	14	Amelanchier alnifolia	Saskatoon Serviceberry	#02	Potted	1.8m x 1.8m
dbb	3	Euonymus alatus 'Compacta'	Dwarf- Winged Burning Bush	#05	Potted	3.0m x 3.0m
sjr	9	Juniperus sabina	Savin Juniper	#01	Potted	1.25m x 2.50m
mel	40	Lavandula angustifolia `Munstead`	Munstead English Lavender	#01	Potted	0.40m x0.60m
org	26	Mahonia aquifolium	Oregon Grape	#01	Potted	1.8m x 1.5m
mup	4	Pinus mugo 'Mughus'	Mugo Pine	#05	Potted	1.5m x 1.5m
mco	11	Philadelphus lewisii	Mock Orange	#02	Potted	1.8m x 1.8m
snb	16	Symphoricarpos albus	Snowberry	#01	Potted	1.8m x 1.8m
GRASSES / F	PERENNIAL	S				
msy	15	Achillea x 'Moonshine'	Moonshine Yarrow	#01	Potted	0.6m x 0.6m
blg	12	Bouuteloua gracilis	Blue Grama	#01	Potted	0.6m x 0.6m
thg	10	Deschamsia cespitosa	Tufted Hair Grass	#01	Potted	0.8m x 0.75m
bog	29	Helictotrichon sempervirens	Blue Oat Grass	#01	Potted	0.75m x 0.75m

SHRUBS LEGEND

BOTANICAL NAME









PERENNIALS / GRASSES

LEGEND









Helictotrichon sempervirens Lavandula angustifolia `Munstead'

PLANT LEGEND





Juniperus sabina



Pinus mugo 'Mughus

LEGEND



BARK MULCH - 75mm DEEP TYPE: BLACK BARK MULCH / COARSE SUPPLIER: BETTER EARTH (250-861-1881) QUANTITY: 151m²



DECORATIVE COBBLE - 200mm DEEP OVER FABRIC TYPE: WASHED RIVER ROCK - 1 PART 100mm, 1 PART 100mm, 1 PART 150mm, 1 PART 150mm SUPPLIER: TO BE DETERMINED BY CONTRACTOR AND APPROVED BY LANDSCAPE ARCHITECT QUANTITY: 79m²



CRUSHED STONE
TYPE: 3/4* MINUS
SUPPLIER: TO BE DETERMINED BY CONTRACTOR AND
APPROVED BY LANDSCAPE ARCHITECT
QUANTITY: 17m²



FEATURE BOULDERS
TYPE: STONE BOULDERS
(750mm - 1500mm (L/W/H) OR APPROVED EQUALS
SUPPLIER: CLIENT
QUANTITY: 12



HYDROSEED - BY OTHERS






EDGER A
TYPE: 2º 4º BEND-A-BOARD PLASTIC HEADER
W: STAKES @ 3-0º O.C.
SUPPLIER: BASALITE CONC. PRODUCTS OR APPROVED EQUAL
QUANTITY: 46 l.m.

QUANTITIES NOTED ARE PER THE EXTENTS SHOWN ON DRAWING. QUANTITIES FOR STREETSCAPE WORK AND HYDROSEEDING ARE NOT INCLUDED. REFER TO STREETSCAPE DRAWING AND S.O.Q. FOR INFORMATION.

MULTI FAMILY LOT 63-66 LANDSCAPE PLAN	wsp		
SOLSTICE PHASE 2 - INDIVIDUAL LOT PLANTING PLANS	scale 1:200	DATE 29/06/18	

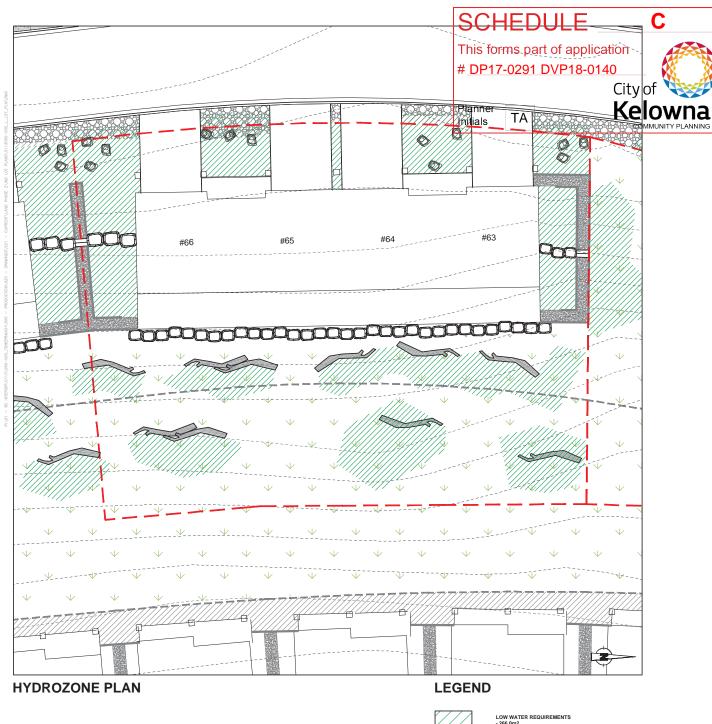

LOTS 67,68,69,70 SOLSTICE

PHASE 2

GENERAL NOTES - ARCHITECTURAL:

ALL WORK SHALL CONFORM TO THE STANDARDS OF THE N.B.C. OF CANADA 2010 foll conditions section. THE B.C. BUILDING CODE (BCBC) 2012 AND ALL LOCAL CODES.

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DWELLING GLAZING SECURITY REQUIREMENTS TO CONFORM TO BCBC 9.7.6 AND APPENDIX (A) 9.7.5.3.0 AMERICA OSUPOR SCULPE OCUPATO I TRANSPORMO S DE COMPONA DE OSUPEZA POR POR POPURA (1947) - 35.4 (1).

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**ALAMAS AND ERECTION STSTEMS TO BE AS PER 3.2.4.1 OF THE BESC.

DRAWINGS:

A-001 SITE PLAN AND PROJECT INFORMATION

A-001 STE PLAN AND PROJE
A-002 ASSEMBLES
A-101 ENTRY LEVEL PLAN
A-102 MIDDLE LEVEL PLAN
A-103 LOWER LEVEL PLAN
A-200 ELEVATIONS
A-200 SECTIONS
A-500 DETAILS
A-501 DETAILS
A-501 PARTY WALL DETAILS

SITE STATISTICS:

SUBDIVISION OF LOT 3; SEC. 27, TWP. 27 ODYD DISTRICT PLAN KAP 80993

ZONING CALCULATIONS:

City of Kelowna RM2H Zoning

SITE INFORMATION:

			Allowed .	Proposed
Gross Site Ar	rea=	13,434 sf (1,248 sm)		
A l owable S≇	e Coverage=		50% (6,717st)	28.8% (3,876sf)
Coverage +	Hordscaping-		55% (7,3884)	37% 5,000sf
AR =			.65 (8,732.1st)	.54 (7,240sf)
Jnit Net Floo	or Area Calculations: ENTRY LEVEL	MIDDLE LEVEL	LIPPER LEVEL	TOTAL
INITT	50	MODIE IEVEL	B70	1,810
JNIT 2	50	890	870	1,810
JNIT3	50	890	870	1,810
JNT 4	50	890	870	7,240
		Allowed		Proposed

9.5m (31.16 ft) or 2.5 stores 7.9m (25.9 ft) or 3 storeys VARIANCE

SCHEDULE


This forms part of application # DP17-0291 DVP18-0140









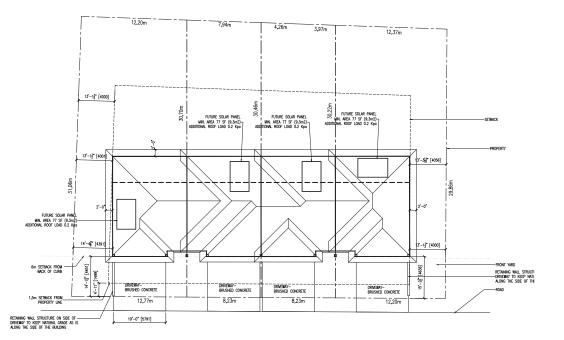




DISTINCT


phone:250-448-780


205-1626 Richter Stre

Kelowno, BC VIY 2M3 rww.distinctsolutions.co

DRAWING TITLE ITE_ROOF PLAN

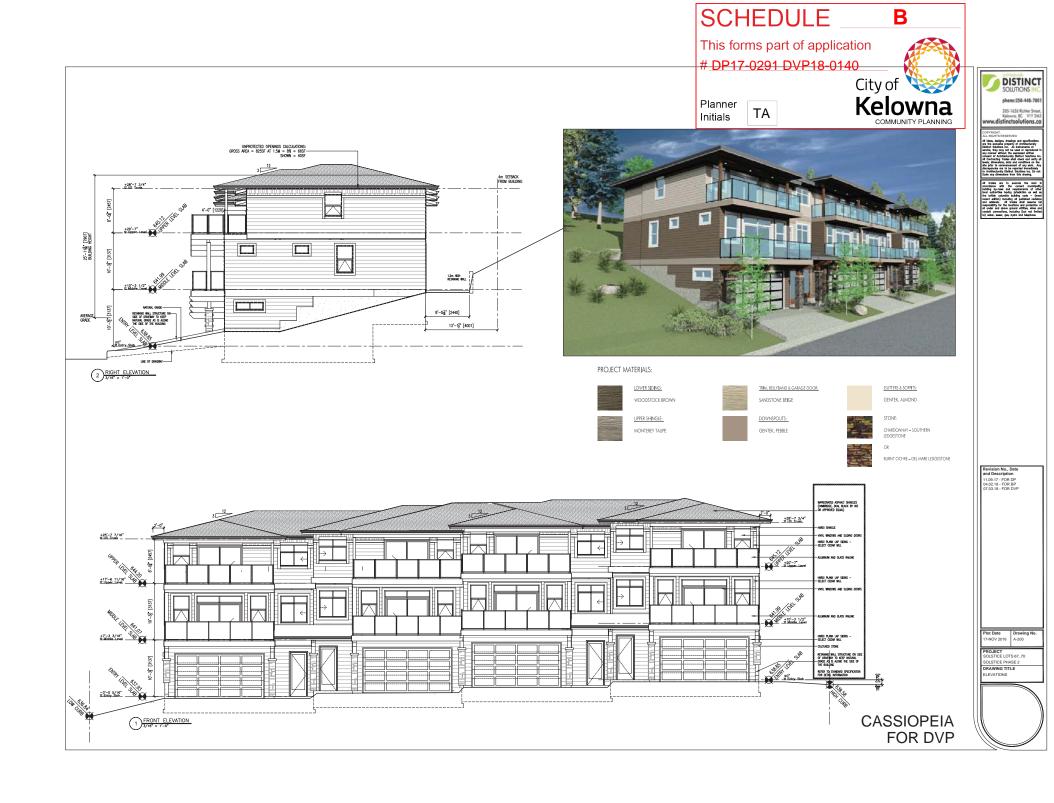

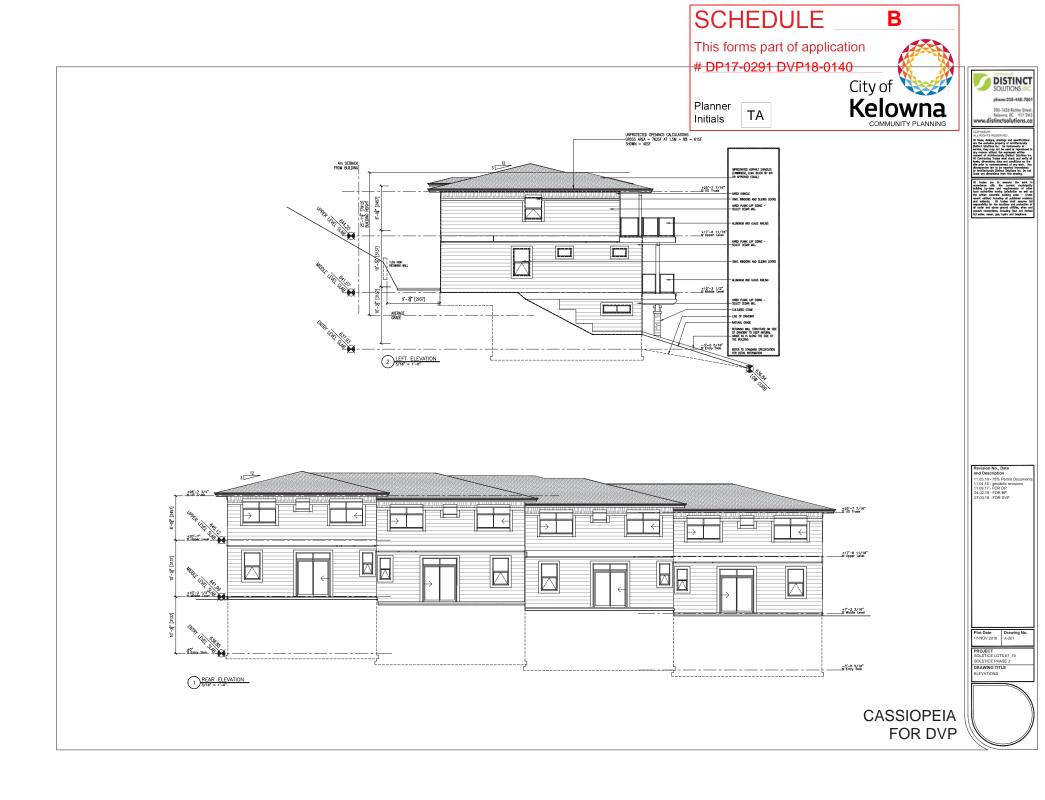

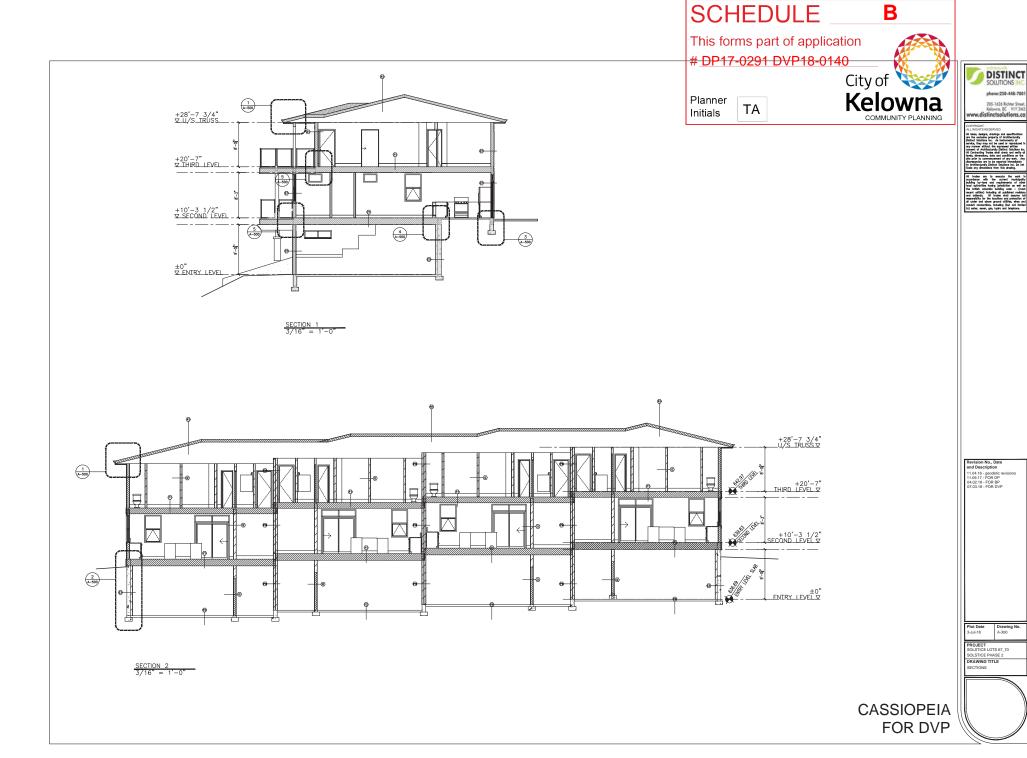









VIEW 1 - FRONT VIEW FROM STREET



VIEW 2 - FRONT VIEW FROM LEFT

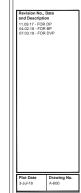

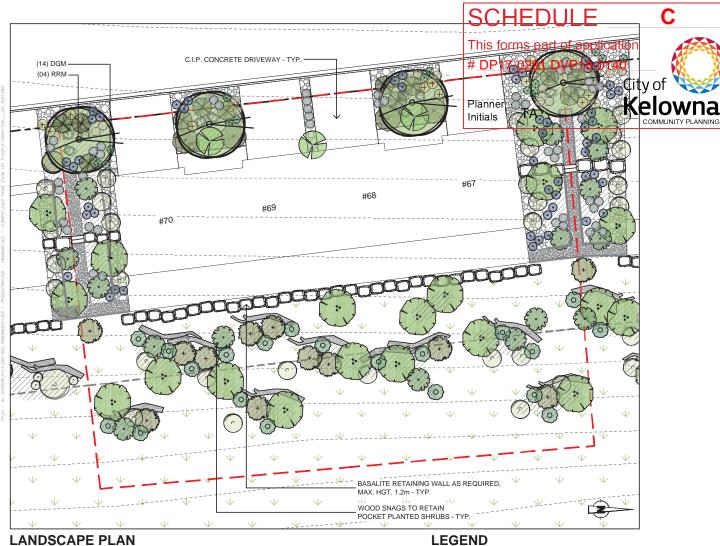

PLANT LIST

		• .				
SYMBOL	QUANTITY	BOTANICAL NAME	COMMON NAME	SIZE	ROOT	MATURE PLANT SIZE (Ht. x Wd.)
TREES						
DGM	14	Acer glabrum	Douglas Maple	#05		12.0m x 6.0m
RRM	4	Acer rubrum 'Red Rocket'	Red Rocket Maple	60mm Cal.	B.&B.	9.00m x 2.50m
SHRUBS						
sks	10	Amelanchier alnifolia	Saskatoon Serviceberry	#02	Potted	1.8m x 1.8m
dbb	3	Euonymus alatus 'Compacta'	Dwarf- Winged Burning Bush	#05	Potted	3.0m x 3.0m
sjr	10	Juniperus sabina	Savin Juniper	#01	Potted	1.25m x 2.50m
mel	34	Lavandula angustifolia `Munstead`	Munstead English Lavender	#01	Potted	0.40m x0.60m
org	19	Mahonia aquifolium	Oregon Grape	#01	Potted	1.8m x 1.5m
mup	4	Pinus mugo 'Mughus'	Mugo Pine	#05	Potted	1.5m x 1.5m
mco	11	Philadelphus lewisii	Mock Orange	#02	Potted	1.8m x 1.8m
snb	19	Symphoricarpos albus	Snowberry	#01	Potted	1.8m x 1.8m
GRASSES / P	ERENNIAL	S				
msy	11	Achillea x 'Moonshine'	Moonshine Yarrow	#01	Potted	0.6m x 0.6m
blg	9	Bouuteloua gracilis	Blue Grama	#01	Potted	0.6m x 0.6m
thg	8	Deschamsia cespitosa	Tufted Hair Grass	#01	Potted	0.8m x 0.75m
bog	27	Helictotrichon sempervirens	Blue Oat Grass	#01	Potted	0.75m x 0.75m

SHRUBS LEGEND

BOTANICAL NAME









PERENNIALS / GRASSES **LEGEND**





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Lavandula angustifolia 'Munstead'



BARK MULCH - 75mm DEEP TYPE: BLACK BARK MULCH / COARSE SUPPLIER: BETTER EARTH (250-861-1881) QUANTITY: 151m²



DECORATIVE COBBLE - 200mm DEEP OVER FABRIC TYPE: WASHED RIVER ROCK - 1 PART 100mm, 1 PART 150mm, 1 PART 150mm, 1 PART 150mm SUPPLIER: TO BE DETERMINED BY CONTRACTOR AND APPROVED BY LANDSCAPE ARCHITECT QUANTITY: 75m²



CRUSHED STONE
TYPE: 3/4" MINUS
SUPPLIER: TO BE DETERMINED BY CONTRACTOR AND
APPROVED BY LANDSCAPE ARCHITECT
QUANTITY: 17m²



FEATURE BOULDERS
TYPE: STONE BOULDERS
(750mm - 1500mm (L/W/H) OR APPROVED EQUALS
SUPPLIER: CLIENT
QUANTITY: 12



HYDROSEED - BY OTHERS



EDGER A
TYPE: 2" x4" BEND-A-BOARD PLASTIC HEADER
W STAKES @ 3-0" O.C.
SUPPLIER: BASALITE CONC. PRODUCTS OR APPROVED EQUAL
QUANTITY: 36 Im.


QUANTITIES NOTED ARE PER THE EXTENTS SHOWN ON DRAWING, QUANTITIES FOR STREETSCAPE WORK AND HYDROSEEDING ARE NOT INCLUDED. REFER TO STREETSCAPE DRAWING AND S.O.Q. FOR INFORMATION.

MULTI FAMILY LOT 67-70 LANDSCAPE PLAN	//sp		
SOLSTICE PHASE 2 - INDIVIDUAL LOT PLANTING PLANS	SCALE	1:200 DATE	29/06/18

PLANT LEGEND

BOTANICAL NAME

Pinus mugo 'Mughus

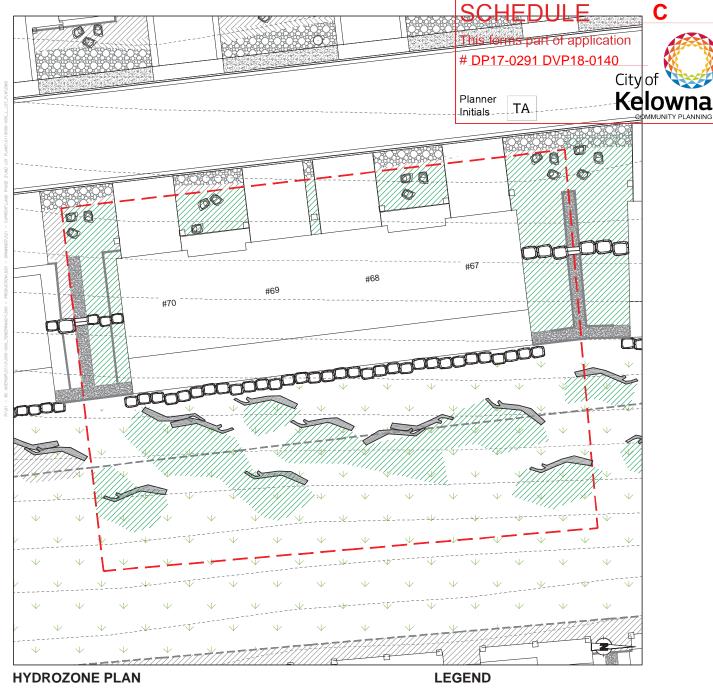

LOW WATER REQUIREMENTS - 233.0m2