

# **CITY OF KELOWNA**

**MEMORANDUM** 

Date: May 30, 2018

File No.: Z18-0055

To: Community Planning (LK)

From: Development Engineering Manager (JK)

Subject: 2251-2312 Pandosy Street

HD1 to HD2

ATTACHMENT

# OCP18-0011

LΚ

Z18-0055

Planner

Initials

This forms part of application

Α

Citv of

Kelow

Development Engineering Department have the following comments and requirements associated with this application. The road and utility upgrading requirements outlined in this report will be a requirement of this development. The Development Engineering Technologist for this project is Jason Angus.

- 1. <u>General</u>
  - a. Where there is a possibility of a high water table or surcharging of storm drains during major storm events, non-basement buildings may be required. This must be determined by the engineer and detailed on the Lot Grading Plan required in the drainage section.
  - b. Provide easements as may be required.
  - c. This proposed subdivision may require the installation of centralized mail delivery equipment. Please contact Rick Ould, Delivery Planning Officer, Canada Post Corporation, 530 Gaston Avenue, Kelowna, BC V1Y 2K0 to obtain further information and to determine suitable location(s) within the development.

# 2. Water

- a. The developer's consulting engineer will determine the domestic and fire protection requirements of this proposed development and establish hydrant requirements and service needs. The bylaw requirement for zone is 150l/s and is available at the site. If it is determined that upgrades to any other existing water distribution system must be made to achieve the required fire flows, additional bonding will be required.
- b. An approved backflow protection devise must also be installed on site as required by the City Plumbing Regulation and Water Regulation bylaws.
- c. A water meter is mandatory for this development and must be installed inside a building on the water service inlet as required by the City Plumbing Regulation and Water Regulation bylaws. The developer or building contractor must purchase the meter from the City at the time of application for a building permit from the Inspection Services Department, and prepare the meter setter at his cost

## 3. Sanitary Sewer

a. The developer's consulting mechanical engineer will determine the development requirements of this proposed development and establish the service needs. Only one service will be permitted for this development. The applicant, at his cost, will arrange for the removal and disconnection of the existing services and the installation of one new larger service.

### 4. Drainage

- a. The developer must engage a consulting civil engineer to provide a storm water management plan for the site, which meets the requirements of the City Storm Water Management Policy and Design Manual. The storm water management plan must also include provision of lot grading plan, minimum basement elevation (MBE), if applicable, and provision of a storm drainage service for the development and / or recommendations for onsite drainage containment and disposal systems.
- b. Provide a detailed Stormwater Management Plan for this development as per the Subdivision, Development and Servicing Bylaw #7900.
- c. There is a possibility of a high water table or surcharging of storm drains during major storm events. This should be considered in the design of the onsite system

### 5. Roads

- a. Royal Ave has been upgraded to an collector standard along the full frontage of this proposed development. No further upgrades are needed at this time.
- b. Abbott street has been upgraded to an collector standard along the full frontage of this proposed development. No further upgrades are needed at this time.

### 6. Power and Telecommunication Services and Street Lights

a. The electrical and telecommunication services to this building must be installed in an underground duct system, and the building must be connected by an underground service. It is the developer's responsibility to make a servicing application with the respective electric power, telephone and cable transmission companies to arrange for these services, which would be at the applicant's cost.

### 7. Development Permit and Site Related Issues

a. Access to the property will be lane access only

### 8. Design and Construction

- a. Design, construction supervision and inspection of all off-site civil works and site servicing must be performed by a Consulting Civil Engineer and all such work is subject to the approval of the City Engineer. Drawings must conform to City standards and requirements.
- b. Engineering drawing submissions are to be in accordance with the City's "Engineering Drawing Submission Requirements" Policy. Please note the number of sets and drawings required for submissions.
- c. Quality Control and Assurance Plans must be provided in accordance with the Subdivision, Development & Servicing Bylaw No. 7900 (refer to Part 5 and Schedule 3).

- d. A "Consulting Engineering Confirmation Letter" (City document 'C') must be completed prior to submission of any designs.
- e. Before any construction related to the requirements of this subdivision application commences, design drawings prepared by a professional engineer must be submitted to the City's Development Engineering Department. The design drawings must first be "Issued for Construction" by the City Engineer. On examination of design drawings, it may be determined that rights-of-way are required for current or future needs.

### 9. Servicing Agreements for Works and Services

- a. A Servicing Agreement is required for all works and services on City lands in accordance with the Subdivision, Development & Servicing Bylaw No. 7900. The applicant's Engineer, prior to preparation of Servicing Agreements, must provide adequate drawings and estimates for the required works. The Servicing Agreement must be in the form as described in Schedule 2 of the bylaw.
- b. Part 3, "Security for Works and Services", of the Bylaw, describes the Bonding and Insurance requirements of the Owner. The liability limit is not to be less than \$5,000,000 and the City is to be named on the insurance policy as an additional insured

### 10. Geotechnical Study.

- a. Provide a geotechnical report prepared by a Professional Engineer competent in the field of hydro-geotechnical engineering to address the items below: NOTE: The City is relying on the Geotechnical Engineer's report to prevent any damage to property and/or injury to persons from occurring as a result of problems with soil slippage or soil instability related to this proposed subdivision.
  - i. The Geotechnical report must be submitted prior to submission of Engineering drawings or application for subdivision approval.
  - ii. Area ground water characteristics, including any springs and overland surface drainage courses traversing the property. Identify any monitoring required.
  - iii. Site suitability for development.
  - iv. Site soil characteristics (i.e. fill areas, sulphate content, unsuitable soils such as organic material, etc.).
  - v. Any special requirements for construction of roads, utilities and building structures.
  - vi. Recommendations for items that should be included in a Restrictive Covenant.
  - vii. Recommendations for roof drains, perimeter drains and septic tank effluent on the site.
  - viii. Any items required in other sections of this document.
  - ix. Additional geotechnical survey may be necessary for building foundations, etc

# 11. Charges and Fees

- a. Development Cost Charges (DCC's) are payable
- b. Fees per the "Development Application Fees Bylaw" include:
  - i. Street/Traffic Sign Fees: at cost if required (to be determined after
  - design).ii. Survey Monument, Replacement Fee: \$1,200.00 (GST exempt) only if disturbed.

Engineering and Inspection Fee: 3.5% of construction value (plus GST)

James Kay, P.Eng. Development Engineering Manager

JA/

	CITY OF KELOWNA	
	MEMORANDUM	ATTACHMENT A
	MEMORANDON	This forms part of application
Date:	May 30, 2018	# OCP18-0055 Z18-0055 City of
File No.:	OCP18-0011	Planner Initials LK Kelowna
То:	Community Planning (LK)	
From:	Development Engineering Manager (JK)	
Subject:	2251-2312 Pandosy Street	EDINST - HLTH

The Development Engineering Branch comments and requirements regarding this OCP amendment application are as follows:

1. <u>General</u>

JA

All the offsite infrastructure and services upgrades are addressed in the Rezoning Engineering Report under file Z18-0055

James Kay, P. Eng. Development Engineering Manager

	CITY OF KELOWNA	ATTACHMENT A	
	MEMORANDUM	This forms part of application #_OCP18-0055	
Date:	May 30, 2018	Z18-0055   City of     Planner   Kelowna	
File No.:	S18-0045	Initials LK COMMUNITY PLANNING	
То:	Community Planning (LK)		
From:	Development Engineering Manager (JK)		
Subject:	2251-2312 Pandosy Street		

The Development Engineering comments and requirements regarding this technical subdivision application to unhook the indicated site form the larger Hospital site are as follows:

1. General.

All the offsite infrastructure and services upgrades are addressed in the Zoning Engineering Report under the zoning application file number Z18-0055.

James Kay, P. Eng. Development Engineering Manager

 $\mathsf{JA}^{l}$ 

	CITY OF KELOWNA	
	MEMORANDUM	ATTACHMENT A
	WEWORANDOW	This forms part of application
Date:	May 30, 2018	# <u>OCP18-0055</u> Z18-0055 City of
File No.:	HAP18-0010	Planner Initials LK Kelowna
То:	Community Planning (LK)	
From:	Development Engineer Manager (JK)	
Subject: Alteration	2251-2312 Pandosy Street	Heritage

The Development Engineering comments and requirements regarding this HAP application are as follows:

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- 1. <u>General.</u>
  - a) The application for a heritage alteration permit for the form and character of congregate housing on the subject property does not trigger any offsite requirements.

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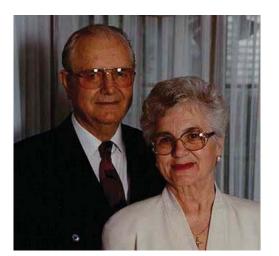
James Kay, P. Eng. Development Engineering Manager





**JoeAnna's House** Development Permit Application Design Rationale Report





Josef and Anna Huber

# Since 1908, Kelowna General Hospital has been a pillar in this community.

Today, it is a centre of health care excellence, serving as the referral hospital for close to 750,000 residents in BC's southern interior. It is the common belief that all patients requiring specialized care are travelling to Vancouver, Calgary or Victoria. But that is usually not the case.

# 1 in 4 beds at KGH is occupied by a patient travelling for care.

At any given time, one in four hospital beds is occupied by someone from outside the Central Okanagan. The reasons for health-related travel vary from emergency trauma to acute mental health; neonatal to cardiac. But all too often, visits are unplanned and increasingly lengthy. Accommodation is expensive and, in popular summer months, nearly impossible to find.



Introduction

Every year, thousands of families from across the interior of British Columbia must travel from their homes in order for a loved one to receive life-saving specialist care at Kelowna General Hospital. For many families wanting to maintain a presence at KGH for the period of their loved ones treatment, the lack of affordable short-term accommodation in Kelowna adds significantly to their hardship.

400

Total number of hospital beds

25%

Overnight cases from outside the

Central Okanagan

43,501

Population of KGH

referral region

JoeAnna's house will be managed by the Kelowna General Hospital Foundation (KGHF) and provides a home away from home for those individuals as research shows that patients heal faster and more effectively when surrounded by their loved ones. And family members bond with others through a shared experience.

Josef & Anna Huber settled their family in the Okanagan in the 1960s. With all family members contributing to their early endeavours in the hospitality industry, they felt very blessed to build a life that would allow them to serve others. With their giving spirit in mind, and to demonstrate kindness and caring for others, the family is proud to honour their legacy by partnering with the KGH Foundation to build JoeAnna's House.







# Site | Location

The project is sited on the southeast corner lot of the Royal Avenue and Abbott Street intersection on what is currently a parking lot serving Interior Health Authority (IHA).

The site is blessed by its proximity to Okanagan Lake and it is envisioned that families will be able to make use of Strathcona park almost as an extension of the house. That proximity to the Lake and Park greatly enhances the therapeutic aspect of the project both by offering calming and relaxing views of the water as well as an amenity to enjoy when the weather permits.

The site also provides pedestrian connections and easy access to the Abbott Street multi-use corrdidor, Kelowna General Hospital, and Pandosy Street.



Photo 1



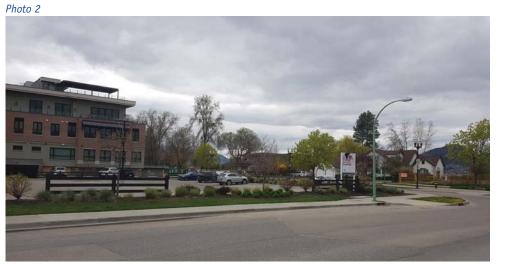


Photo 3

Photo 4



Photo 3 & 4 show existing curb, fence, and asphalt of east side of existing parking lot intended to be retained, resurfaced and repainted - refer to drawing A2.01

# Site | Parking

From its outset the intent of JoeAnna's House was **not** to reduce the number of stalls currently provided for IHA and the neighbourhood so KGHF has been working with IHA to ensure that there is not a net loss of stalls. The text quoted below is from IHA and summarizes the parking replacement strategy underway.

"IH is proceeding with the development of new parking near the KGH campus to replace the impending loss of parking stalls currently located at the site of JoeAnna's Place. Completion of this new parking is anticipated to coincide with the decommissioning of the existing stalls."





# 2251-2312 PANDOSY STREET, KELOWNA BC LOT A, DISTRICT LOT 14, O.D.Y.S., PLAN EPP18664 2018-05-07 ISSUED FOR DEVELOPMENT PERMIT

# JOEANNA'S HOUSE

# 3-05-07 ISSUED FOR DEVELOPMENT PERMIT 2018-05-07

# ARCHITECTURAL

A0.00	COVER SHEET & DRAWING LIST
A1.01	ZONING, CODE REVIEW, LOCATION PLAN
A1.02	ASSEMBLIES
A1.03	DOOR SCHEDULE
A1.04	CODE PLANS
A2.01	SITE PLAN
A2.02	SURVEY PLAN
A2.03	PARKING PHOTOS
A3.00	1ST FLOOR SLAB PLAN
A3.01	1ST FLOOR PLAN
A3.02	2ND FLOOR PLAN
A3.03	ROOF PLAN
A3.11	1ST FLOOR REFLECTED CEILING PLAN
A4.01	EXTERIOR ELEVATIONS
A4.02	EXTERIOR ELEVATIONS
A4.03	3D VIEWS
A4.11	GLAZING ELEVATIONS
A4.12	GLAZING ELEVATIONS
A5.01	BUILDING SECTIONS
A6.01	FEATURE STAIR & EXIT STAIR 1
A6.02	EXIT STAIR 2 & DETAILS
A7.01	PLAN DETAILS
A7.10	SECTION DETAILS
A8.01	UNIT PLANS
A9.01	INTERIORS

# LANDSCAPE

L1 CONCEPTUAL LANDSCAPE PLAN



233 BERNARD AVENUE KELOWNA, B.C. VIY 6N2 TEL: 250.762.3004 FAX: 250.762.8707 EMAIL: kel-mai@shaw.ca





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No.	Date	Revision
01	2018-05-07	ISSUE FOR DEVELOPMENT PERMIT
	1	

\_\_\_\_\_ Project Title

JOEANNA'S HOUSE

2251-2312 PANDOSY STREET, KELOWNA BC LOT A, DISTRICT LOT 14, O.D.Y.S., PLAN EPP18664 Drawing Number



COVER SHEET & DRAWING LIST

Job No	1788
Scale	1/4" = 1'-0"
Drawn	СМ
Checke	JM JM

DDRESS	2251-2312 PAND
EGAL DESCRIPTION	LOT A, DISTRICT
EVELOPMENT PERMIT AREA	YES
ONING	HD-2 (PENDING F
RINCIPAL USE	CONGREGATE H
RADES	LEVEL
UMBER OF BUILDINGS	ONE 2 STOREY (

PROJECT DATA										
				BUILDING FLOOR AREAS				REQUIRED FIRE SEPARATIONS3.1.3.1.		
ADDRESS	2251-2312 PANDOSY STREET				GFA (sm)	GFA (s	,	TENANTS / MAJOR OCCUPANCIES		
	LOT A, DISTRICT LOT 14, O.D.Y.S., PL	AN EPP18664	LEVEL 1		±593.4sm	±6,387		GROUP C TO C (SUITE TO SUITE)	1 HR	3.3.1.1
DEVELOPMENT PERMIT AREA	YES		LEVEL 2		±687.1sm	±7,396	sf	SERVICES ROOMS WITH FUEL FIRED EQUIPMENT	1 HR	3.6.2.
ZONING	HD-2 (PENDING REZONING FROM HE	9-1)	BUILDING FOOTPRINT FOR SITE C	OVERAGE	±687.1sm	±7,396	sf	JANITOR ROOM	N/A IF SPRINKLERED	
PRINCIPAL USE	CONGREGATE HOUSING		TOTAL FLOOR AREA FOR FAR		±1,280sm	±13,78	3sf			
GRADES	LEVEL							<b>BUILDING FIRE SAFETY</b>		
NUMBER OF BUILDINGS	ONE 2 STOREY CONGREGATE HOUS	ING BUILDING	BUILDING CODE S	SUMMARY	/					
			OCCUPANCY		GROUP C			SOFFIT PROTECTION	N/A	3.2.3.16.
ZONING SUMMARY			ARTICLE		3.2.2.53			FLAME SPREAD RATINGS	COMPLY WITH	3.1.13.2
	HD-2 ZONE	PROPOSAL	NO. OF STOREYS		2 STOREY			METAL DECK ASSEMBLIES	N/A	3.1.14.2.
SITE AREA (sm)	900sm MIN.	±2,132.5sm	NO. OF STREETS FACING		2			ROOF COVERING		0.4.45.0
SITE WIDTH (m)	30m MIN.	±57.6m	MAX. BUILDING AREA			PROPO	SED	CLASSIFICATION	CLASS "A"	3.1.15.2.
SITE DEPTH (m)	30m MIN.	±37.0m			2,700 sm (3.2.2.53.(1Cii))	±687.1s		ATTIC FIRESTOPS	N/A	3.1.11.
HEIGHT OF BUILDING (S)/# OF STOREYS	16.0m	±10.8m / 2 storey	CONSTRUCTION TYPE PERMITTEI		COMBUSTIBLE / NON-COM			MAX. ATTIC AREA	N/A	3.1.11.5.
SITE COVERAGE OF BUILDING(S) (%)	55% MAX.	±539.4 sm = ±28%	CONSTRUCTION TYPE PROPOSE		COMBUSTIBLE / NON-CO	IDUSTIDULE		MAX. CRAWLSPACE AREA	N/A	3.1.11.6.
SITE COVERAGE INCLUDING BUILDINGS,			SPRINKLERED	, 	YES			CONCEALED FLOOR AREA	N/A	3.1.11.5.
DRIVEWAYS AND PARKING (%)	N/A	±1,358.2 sm = ±64%	ASSEMBLY RATINGS:		REQUIRED	PROPO	SED			
TOTAL NUMBER & TYPES OF UNITS	N/A	20 FAMILY BEDROOMS	FLOOR		45 MINUTES	1 HR		ACCESSIBILITY REQUIREN	/IENIS	3.8.
GROSS FLOOR AREA	N/A	±1,280sm	LOAD BEARING WALLS, COLUMNS	S, ARCHES	45 MINUTES	1 HR			REQUIRED	PROVIDED
FLOOR AREA RATIO (F.A.R.)	1.2 MAX. (2,559sm)	0.60	ROOFS		N/A			ACCESS TO MAIN ENTRANCES	YES	YES
BUILDING (S) SETBACKS (m):								ACCESS TO ALL FLOORS	YES	YES
NORTH (FRONT)	4.5m	±4.8m		N		371/	3.2.5./ 3.2.6.	ACCESSIBLE WASHROOM	YES	YES
SOUTH (REAR)	3.0m	±3.2m					5.2.5.7 5.2.0.			
WEST (SIDE)	4.5m	±5.4m		REQUIRE		D				
EAST (SIDE)	4.5m	±15.4m	HYDRANT TO BUILDING ENTRY	90m MAX.	K. 90m MAX.		3.2.5.5.	WASHROOM FIXTURES RE	-QUIREMENTS	
PUBLIC OPEN SPACE AREA	150sm (7.5sm PER BEDROOM)	±380sm	STANDPIPE/HOSE	N/A	N/A		3.2.5.8.		REQUIRED	PROVIDED
DAYLIGHT ANGLE (IF A TOWER)	N/A	N/A	SPRINKLERED	YES	YES			BEDROOM UNITS	MIN. 1 PER UNIT	1 PER UNIT
PODIUM HEIGHT (IF PROPOSED)	N/A	N/A	FIRE ALARM SYSTEM	YES	YES		3.2.4.1.(4)(i)	LEVEL 1 DINING & LIVING ROOM	1 MALE AND 1 FEMALE	2 UNIVERSAL WASHROOM
FLOOR PLATE SIZE (IF REQUIRED)	N/A	N/A	EXIT LIGHTS	YES	YES				(FOR VISITORS)	
SETBACKS TO PARKING (m):			EMERGENCY LIGHTING	YES	YES			LEVEL 1 STAFF OFFICE	1 (STAFF LESS THAN 10)	1
NORTH (FRONT)	N/A	N/A								
SOUTH (REAR)	N/A	N/A				TAF	BLE 3.1.17.1.			
WEST (SIDE)	N/A	N/A								
EAST (SIDE)	N/A	N/A	LEVEL 1: DINING & LIVING ROOM		N/ 0.75sm X ±1,501 sm		186 PERSONS			
		1			N/ 9.3sm X ±466 sm		5 PERSONS			
PARKING SUMMARY			LEVEL 1: BEDROOMS	4 PERSON	N PER BEDROOM X 3		12 PERSONS			
		0000000				EL 1 TOTAL	201 PERSONS			
CAR PARKING SUMMARY: (CONGREGATE HOUSING)	REQUIRED	PROPOSED	LEVEL 2: BEDROOMS	4 PERSON	N PER BEDROOM X 17		61 PERSONS			
· · ·	2 5741 5	2 67411 0				EL 2 TOTAL	61 PERSONS			
3.0 SPACES OR 1.0 SPACE PER RESIDENT STAFF MEMBER (WHICHEVER IS GREATER)	3 STALLS	3 STALLS			BU	LDING TOTAL	262 PERSONS			
· · · · · ·	20.07411.0	25 STALLS	EXIT FACILITIES				3.1 TO 3.6			
1.0 SPACE PER 3 BEDS	20 STALLS (ASSUMES 3 GUESTS PER ROOM PER NI		REQUIRED EXITS	2 MIN.						
TOTAL PARKING CAR STALLS	23 STALLS	28 STALLS		REQUIRED WIDT		PROVID	ED WIDTHS			
BICYCLE PARKING SUMMARY: (CONGREGATE HOUSING)	REQUIRED	PROPOSED	LEVEL 1 DOORS		N X 201 PERSONS = 1,226mm N X 61 PERSONS = 372mm		@ 915mm = 4,575mm @ 915mm = 1,830mm			
	0 STALLS	0 STALLS	BEDROOM UNIT DOORS		00mm WIDE) EA. UNIT		(915mm WIDE) EA. UNIT			
CLASS I: 1 PER 25 EMPLOYEES	10 STALLS	10 STALLS	LEVEL 2 STAIRS		X 61 PERSONS = 1,608mm		0mm = 2,440mm			
CLASS II: 5 PER BUILDING ENTRANCE			EXIT THROUGH LOBBY	NO			3.4.4.2.			
NUMBER OF LOADING SPACES		N/A	PANIC HARDWARE		BUT PROVIDED AT EXT. DO	ORS	3.4.6.16.(2)			
CAR PARKING STALL SIZE SUMMARY:	WIDTH LENGTH HEIGH		EXIT EXPOSURE	N/A	UUT NOVIDED AT EAL DU		3.4.0.10.(2)			
FULL SIZE STALL	8'-3" 2.5m 19'-8" 6.0m	16	MAX. TRAVEL DISTANCE	45m			3.4.2.5.(1)			
MEDIUM SIZE STALL (40% max)	7'-6" 2.3m 15'-9" 4.8m 6'-6"	2.0m		45m 1 HR.						
DISABLED STALL	12'-2" 3.7m 19'-8" 6.0m	1	STAIR SHAFTS RATING CORRIDORS TO SUITE RATING	1 HR.			3.4.4.1. 3.3.2.6.(4)			
DRIVE AISLES (2-WAY 90° PKG)	23'-0" 7.0m	i i i i i i i i i i i i i i i i i i i		I HK		1	3376(1)			




262 MAIN STREET PENTICTON, B.C. V2A 1H2 TEL: 250.492.3143 FAX: 250.492.0318 EMAIL: pen-mai@shaw.ca


233 BERNARD AVENUE KELOWNA, B.C. VIY 6N2 TEL: 250.762.3004 FAX: 250.762.8707 EMAIL: kel-mai@shaw.ca





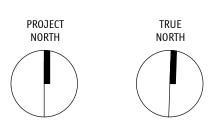


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Project Title

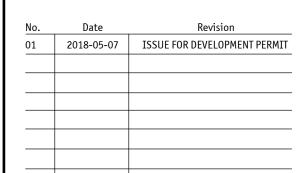JOEANNA'S HOUSE

2251-2312 PANDOSY STREET, KELOWNA BC LOT A, DISTRICT LOT 14, O.D.Y.S., PLAN EPP18664 Drawing Number




DRAWINGS ARE NOT TO BE SCALED. ALL DIMENSIONS SHALL BE VERIFIED ON JOB Drawing Title

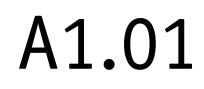
ZONING, CODE REVIEW, LOCATION PLAN

Job No.	1788
Scale	
Drawn	СМ
Checked	JM

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		0	
	Checked	JM	
-1788 J	JoeAnna's House\1.0 Drawings\1.1 C	urrent\1788	Revit\1788 JoeAnna's House Master File.rv

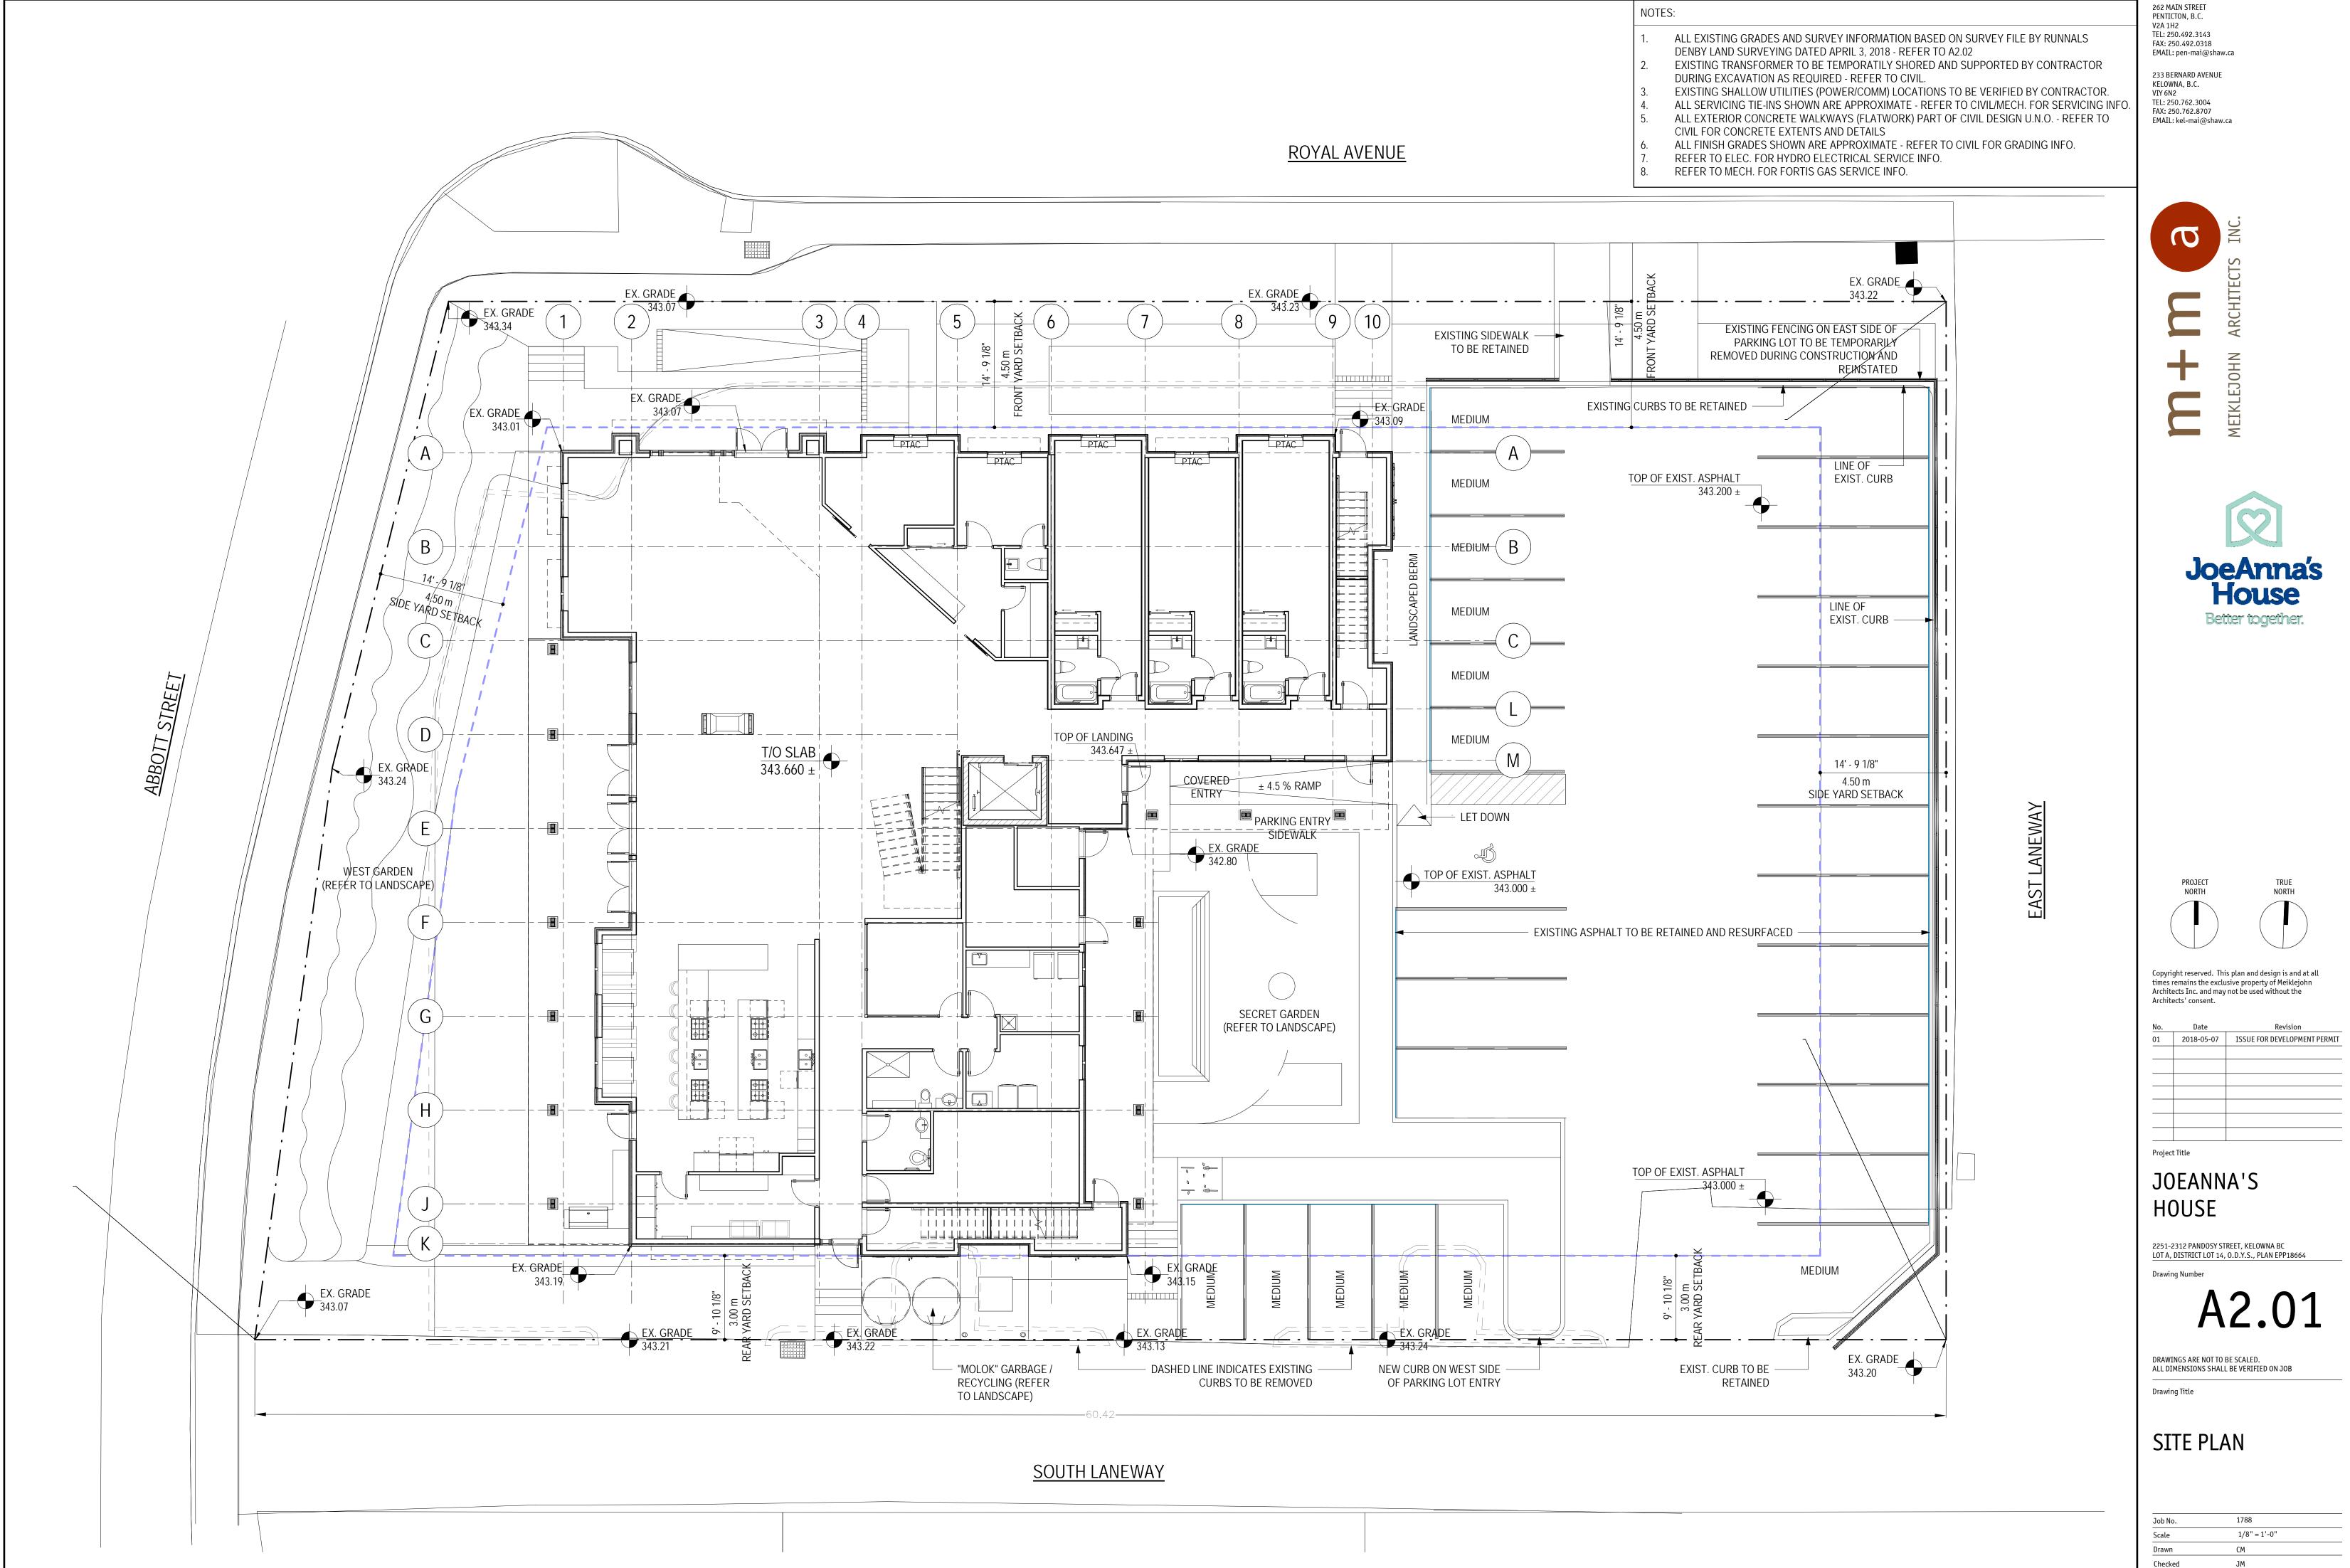

6 VIEW FROM INTERSECTION OF WEST A2.03 LANEWAY AND ROYAL AVE TO PROJECT SITE

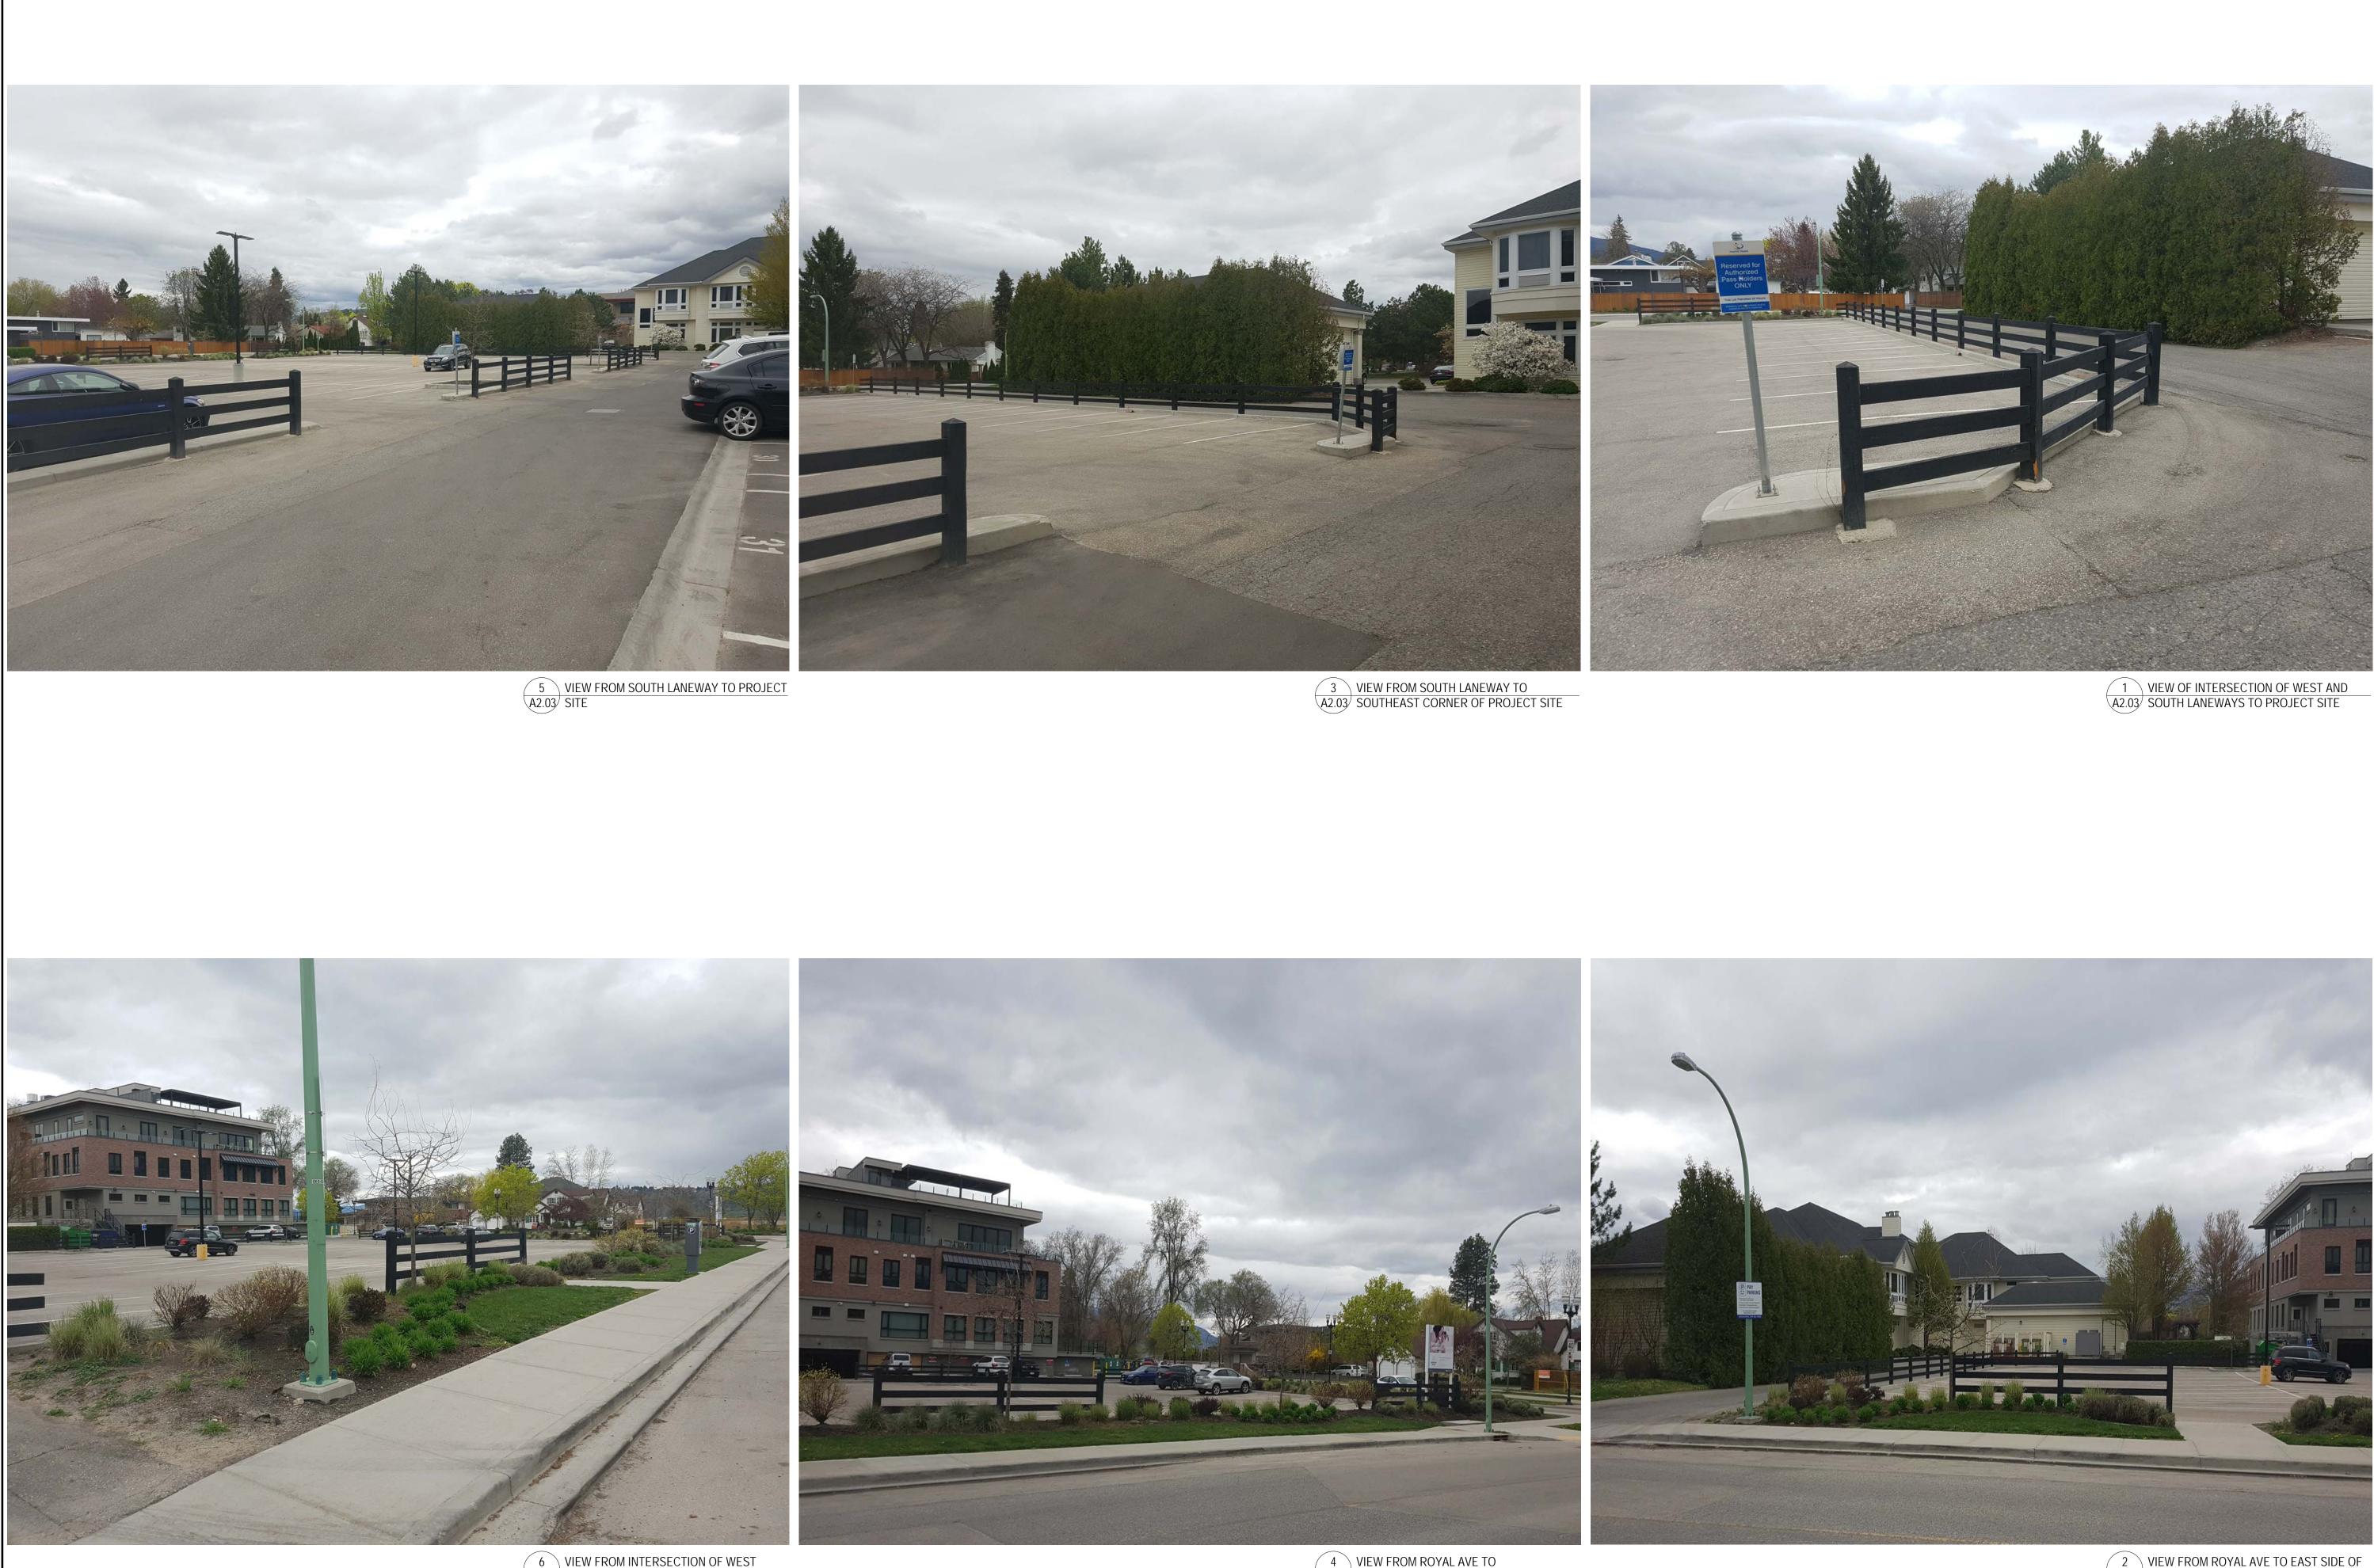4 VIEW FROM ROYAL AVE TO A2.03 PROJECT SITE

2 VIEW FROM ROYAL AVE TO EAST SIDE OF A2.03 PROJECT SITE

262 MAIN STREET PENTICTON, B.C. V2A 1H2 TEL: 250.492.3143 FAX: 250.492.0318 EMAIL: pen-mai@shaw.ca

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No.	Date	Revision
01	2018-05-07	ISSUE FOR DEVELOPMENT PERMIT
-		

Project Title JOEANNA'S HOUSE

2251-2312 PANDOSY STREET, KELOWNA BC LOT A, DISTRICT LOT 14, O.D.Y.S., PLAN EPP18664 Drawing Number



DRAWINGS ARE NOT TO BE SCALED. ALL DIMENSIONS SHALL BE VERIFIED ON JOB Drawing Title

# PARKING PHOTOS

Job No.	1788
Scale	
Drawn	Author
Checked	Checker



BUI	LDING ELEVATION KEY NOTE:
NOTE	S:
1. REF	FER TO PLANS & SECTIONS & SPECS DETAILED INFORMATION
2. REF	FER TO SPECIFICATION SECTION 08800 FOR GLASS TYPES
	PREFABRICATED WOOD & METAL CLAD VINYL WINDOWS C/W LOW E VISION GLASS
2	PREFABRICATED BLACK METAL CLAD VINYL WINDOWS C/W LOW E VISION GLASS
3	PRE-FINISHED HARDIE WINDOW OR STAINED WOOD TRIM AND PTAC SURROUND
4	PACKAGE TERMINAL AIR CONDITIONER (PTAC) C/W BLACK METALLIC EXTERIOR GRILL
5	WOOD CLAD FOLDING SLIDING GLASS DOOR
6	STAINED VENEERED WOOD DOOR C/W GLAZED LITE AND SIDELITE
$\langle 7 \rangle$	PAINTED METAL DOOR
8	PAINTED OR STAINED WOOD FAUX SWINGING BARN DOOR
9	PRE-FINISHED HARDIE TRIM & FASCIA
(10)	STAINED WOOD TRIM
(11)	STAINED WOOD DOUBLE DECK POST (TWO 5x5 POSTS) C/W PAINTED BASE
(12)	STAINED WOOD CANOPY FRAMING, BRACKETS & FASCIA
(13)	PRE-FINISHED HARDIE BOARD & BATTEN SIDING
(14)	THIN STONE VENEER CLADDING
(15)	STANDING SEAM ROOFING
(16)	FARMHOUSE LIGHT FIXTURE
(17)	PRE-FINISHED METAL FLASHING
(18)	MOLOK GARBAGE / RECYLING
(19)	HARD + SOFT SCAPING (REFER TO LANDSCAPE)

262 MAIN STREET PENTICTON, B.C. V2A 1H2 TEL: 250.492.3143 FAX: 250.492.0318 EMAIL: pen-mai@shaw.ca

233 BERNARD AVENUE KELOWNA, B.C. VIY 6N2 TEL: 250.762.3004 FAX: 250.762.8707 EMAIL: kel-mai@shaw.ca





Refer to landscape and site plan for grading and proposed landscape treatment - 3d views / Elevations shown summarize architectural form and character only.

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No.	Date	Revision
01	2018-05-07	ISSUE FOR DEVELOPMENT PERMIT

Project Title

JOEANNA'S HOUSE

2251-2312 PANDOSY STREET, KELOWNA BC LOT A, DISTRICT LOT 14, O.D.Y.S., PLAN EPP18664 Drawing Number



DRAWINGS ARE NOT TO BE SCALED. ALL DIMENSIONS SHALL BE VERIFIED ON JOB Drawing Title

# EXTERIOR ELEVATIONS

Job	No.	1788
Sca	le	As indicated
Dra	wn	СМ
Che	ecked	JM
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2 SOUTH ELEVATION A4.02 3/16" = 1'-0"

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Refer to landscape and site plan for grading and proposed landscape treatment – 3d views / Elevations shown summarize architectural form and character only.

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No.	Date	Revision
01	2018-05-07	ISSUE FOR DEVELOPMENT PERMIT
Projec	t Title	
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H(	OUSE	
		REET, KELOWNA BC 0.D.Y.S., PLAN EPP18664
Drawi	ng Number	



# EXTERIOR ELEVATIONS

	Job No.	1788
	Scale	3/16" = 1'-0"
	Drawn	СМ
	Checked	JM
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