

Revised October 30, 2017
Proposal for Rezoning & Development Permit
Existing Zone: RU6
Proposed Zone: RM5
Legal Description: Lots 34 & 35 D.L.
139 ODYD Plan 2085
1304 & 1308 Richter Street
Kelowna, BC

Introduction

This is an application for both a rezoning and a development permit to accommodate a 12 unit multi-unit building located at 1304 & 1308 Richter Street. The proposed building consists of 12 ground orientated townhouse units. These applications are being submitted concurrently, with the intent that they will be processed together.

Site Context

The subject site consists of 2 lots that total approximately 1200.59 SM and is prominently located at the SW corner of the intersection of Richter Street and Cawston Ave.

The proposed revised zoning classification is RM5 with minor variances proposed in support of this unique project.

The property is currently zoned RU6, Two Dwelling Housing.





Overview

This proposed infill development is located on an underutilized property bordered on 1 side by an existing multifamily building which also falls under RM5 zoning guidelines. Two single family homes are currently situated on the property. The two lots are "orphaned" by the adjacent multifamily higher density development.

The site is well positioned near the rapid transit bus route system. It is also located on the Cawston community system bike path which is part of the overall Active Transportation Corridor. The increasing number of jobs and overall activity in Downtown Kelowna has inspired us to look at a higher density project to meet the growing demand for well conceived downtown housing. In support of this higher density project, rezoning will be required together with minor variances. A development permit will also be required. We have contemplated RM5 Guidelines with specific variance approvals in support of our rezoning application.

Cawston Avenue is a prominent downtown street with the improved bike lane. Our primary design objective has been to create curb appeal, street presence, and separate street and ground oriented townhouse entrances for all units.

In support of this application, both properties fall within the Multiple Unit Residential (Medium Density) land use designation as prescribed by the City of Kelowna's Official Community Plan. We are proposing that the site be rezoned to RM5 to accommodate 12 ground oriented townhouse units. Variances that are required to facilitate this design are detailed in an attached schedule.

The parking structure roof slab is used as a base for the townhouse "mews" style units as well as an elevated pedestrian park environment providing direct access to the main living floor of each unit. In addition each unit has direct access to grade on each of the side yards which are also richly landscaped. All units are two bedroom with upper level dens (potential 3rd bedroom) and private rooftop patios. Each unit is provided with two indoor parking stalls with immediate and direct access for residents to their own unit.

It is important to know that the builder has to contend with a high water table. The high water table prohibits development of a sub-grade parking structure. Accordingly, the parking structure is proposed to be developed at grade. In order to facilitate street oriented unit design, variances are proposed to some bylaw site setback requirements. These are detailed in the attached schedules. It is important to note that the need for variance approvals is almost wholly driven by the high water table and the resultant need to locate the parking structure at grade.

Variances Requested

The site layout substantially fits within the prescribed guidelines of the RM5 zone and the proposed rezoning is consistent with the Future Land Use prescribed in the Official Community Plan.



Bylaw Summary: RM5 Guidelines (Revised Oct 30/17)

Criteria Item	Regulation	Proposed	Variance
Min Site Area	1400 SM	1200.59 SM	Required
Min Lot Width	30 M	26.29 M	Required
Min Lot Depth	35 M	45.70 M	N/A
Maximum FAR (not including covered parking)	1.4 F.A.R.	1644.81 SM	
1,680.83 SM (Max)	(1.2 + 0.2)	1.37 F.A.R.	N/A
Max Site Coverage: 840.4 SM	70%	70%	
(Building, Parking & Paving)	(50% + 20%)	840 SM	N/A
Maximum Height	4.5 Storeys	4 Storeys/12.548	N/A
	18 M		
Net Unit Area	(1.4 x 1200.59 SM)		
	1680.83 SM	1644.81 SM	N/A
Front Yard (at Richter St.) under 2 ½ storeys			
@ Ground Floor & 2 nd Floor	1.5 M	1.5 M	N/A
Front Yard (at Richter St.) over 2 ½ storeys			
@ 3 rd Floor	6.0 M	4.181 M	1.819 M
@ 4 th Floor	6.0 M	9 M	N/A
North Side Yard (at Cawston) under 2 1/2 storeys			
@ Ground Floor	1.5 M	0.928 M	0.572 M
@ 2 nd Floor	1.5 M	0.470 M	1.03 M
North Side Yard (at Cawston) over 2 ½ storeys			
@ 3 rd Floor	6.0 M	0.470 M	5.53 M
@ 4 th Floor	6.0 M	3.170 M	2.83 M
South Side Yard (joint P.L.) under 2 ½ storeys			
@ Ground Floor	4.5 M	2.760 M	1.749 M
South Side Yard (joint P.L.) over 2 ½ storeys			
@ 3 rd Floor	7.0 M	2.7 M	4.3 M
@ 4 th Floor	7.0 M	4.056 M	2.944 M
Rear Yard (at lane) @ Car Port Structure at grade	1.5 M	1.190 M	0.310 M
@ 2 nd , 3 rd and 4 th Floors	6.0 M	6.0 M	N/A
(See shared 2 nd floor shared garden areas and	See Bylaw		See Bylaw
shared green roof areas on plans)	#13.11.6.h		#13.11.6.h

Please see attached Setback Plans attached in this package for your reference.



Criteria Item	Regulation	Proposed	Variance
Parking Stalls	18 (150%)	24 (200%)	N/A
Bicycle Parking	6 Class 1 & 3	Class 1 = 24 (2 per unit)	
	Class 2	Class 2 = 10	N/A
Private Amenity Space		Balconies, Patios & Decks - 359.96 SM	
(25 SM x 12)	300 SM	Passive Private Space – 74.72 SM	
		Extensive Green Roof - 137.89 SM	
		Total Amenity Space – 572.57 SM	N/A

RESIDENTIAL AREA SUMMARY BY UNIT (NOT INCLUDING PARKING)

UNIT TYPE	TOTAL UNIT AREA	# OF UNITS	TOTAL NEW UNIT AREAS
UNIT A	147.78 SM	X 1	147.78 SM
UNIT B	148.18 SM	Х3	444.54 SM
UNIT C	148.35 SM	X 1	145.35 SM
UNIT D	145.17 SM	X 1	145.17 SM
UNIT E	144.96 SM	Х3	434.88 SM
UNIT F	145.12 SM	X 1	145.12 SM
UNIT G	136.27 SM	X 2	272.54 SM
TOTAL NET RESIDENTAL			RESIDENTAL AREA
UNIT AREA		12 UNITS	1,738.38 SM

RESIDENTIAL AREA SUMMARY BY FLOOR (NOT INCLUDING PARKING)

GROUND FLOOR	195.19 SM
SECOND FLOOR	636.26 SM
THIRD FLOOR	586.83 SM
FOURTH FLOOR	320.10 SM
TOTAL RESIDENTIAL FLOOR AREA	1,738.38 SM

F.A.R CALCULATION

SITE AREA	1200.59 SM
REGULATION F.A.R.	1.4 OF SITE AREA
REGULATION MAX UNIT AREA	(1.4 X 1200.59 SM) = 1,680.82 SM
ACTUAL RESIDENTIAL AREA (FROM ABOVE)	1,738.38 SM
DEDUCT 50% OF EACH INTERIOR STAIR AREA IN EACH UNIT	
ON EACH FLOOR OF EACH UNIT	= 92.52 SM NET DEDUCTIBLE
NET RESIDENTIAL AREA (1,738.38 SM LESS 92.52 SM)	= 1,645.86 NET
F.A.R. PROPOSED 1,645.86 SM / 1,200.59 SM	1.370 F.A.R.
CONCLUSION F.A.R. PROVIDED AND NO VARIANCE REQ'D	0.03 LESS THAN MAX ALLOWABLE



As previously stated, the exceptionally high water table on this site has prevented construction of a subgrade parking structure leaving the builder no choice but to develop the parking structure at grade. In developing the parking structure at grade and clear of the water table, the above variances are required for a functional and working project. Having said that, it should be noted that the above grade density (F.A.R.) and site coverage proposed are both bylaw compliant with no variance required to render this project functional.

We have also had productive consultation with our neighbors to the South living in "The Cambridge." Their basic concerns of life safety (fire spread) have been addressed two fold. Once by decreasing the proposed setback variances on our joint property line and again by proposing that the construction of our South exterior wall be constructed as wall assembly with a 2 hour fire resistance rating compliant with the current BC Building Code. The combination of these two measures provide the added assurance and exceed the applicable Building Code requirements by a considerable margin.


Conclusion


Maximizing the efficiency of infill development has been identified by the City of Kelowna as a priority to help avoid urban sprawl. This project strives to help fulfill that goal while promoting an active lifestyle for residents. A priority is also given by the architect to ground and street orientation and pedestrian relevant design in this project on multiple levels. The applicant seeks support from staff and council for this rezoning and development permit application complete with all required variances.


Best Regards, **DW Architecture**


David Watkin


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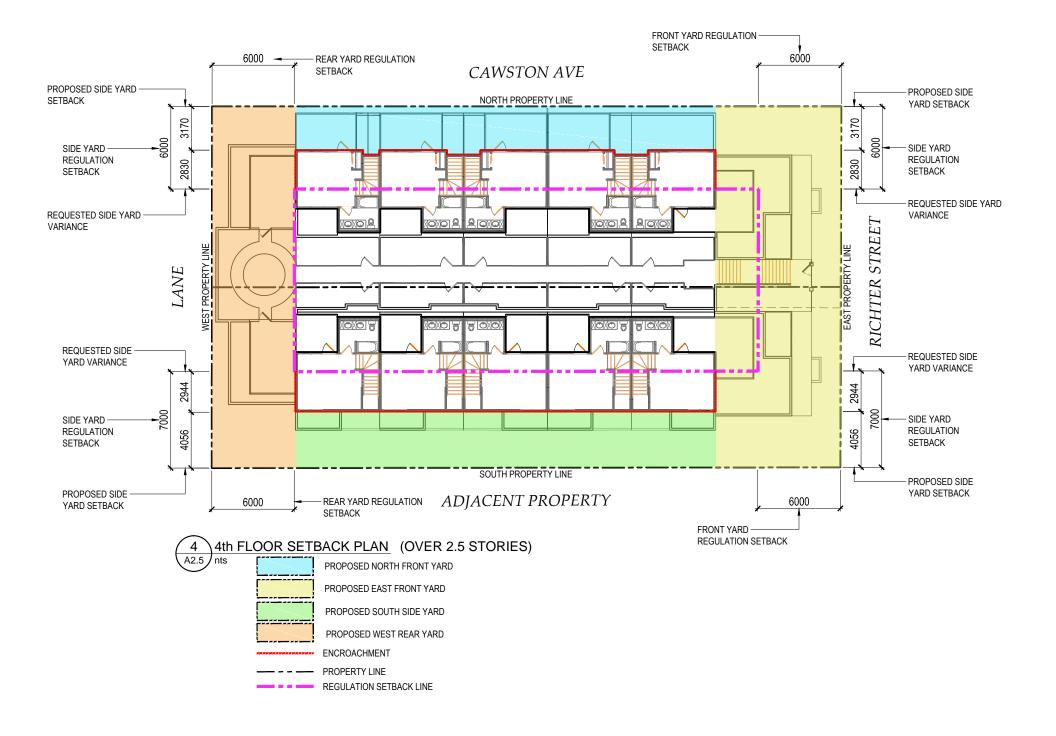


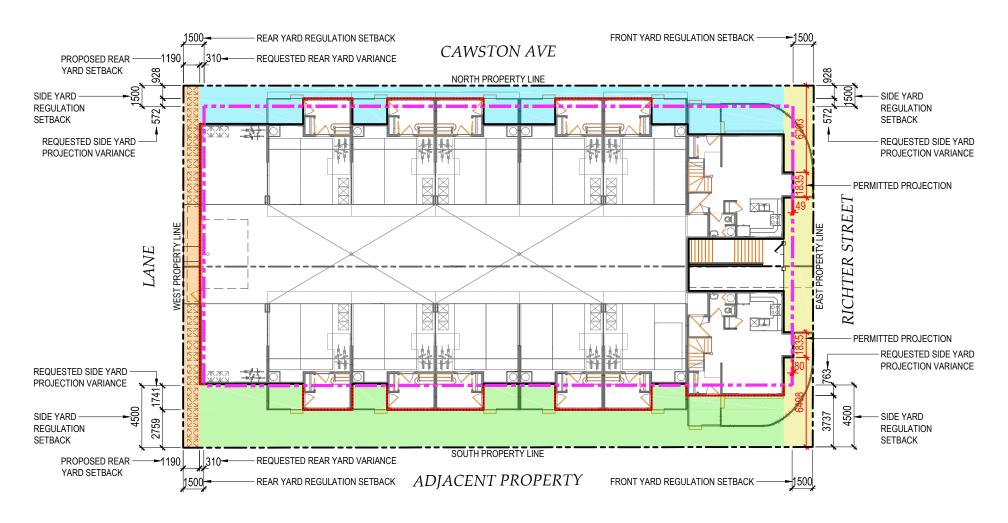

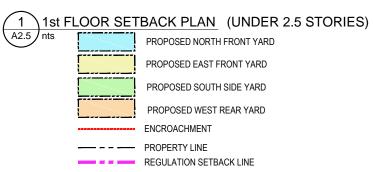

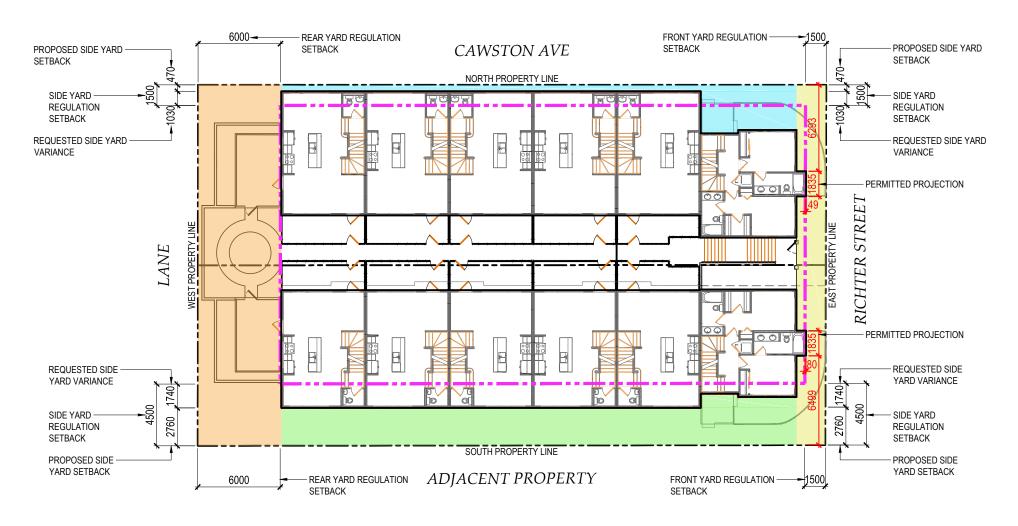

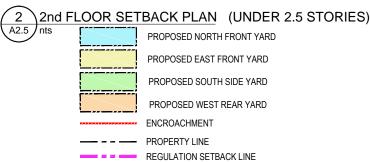

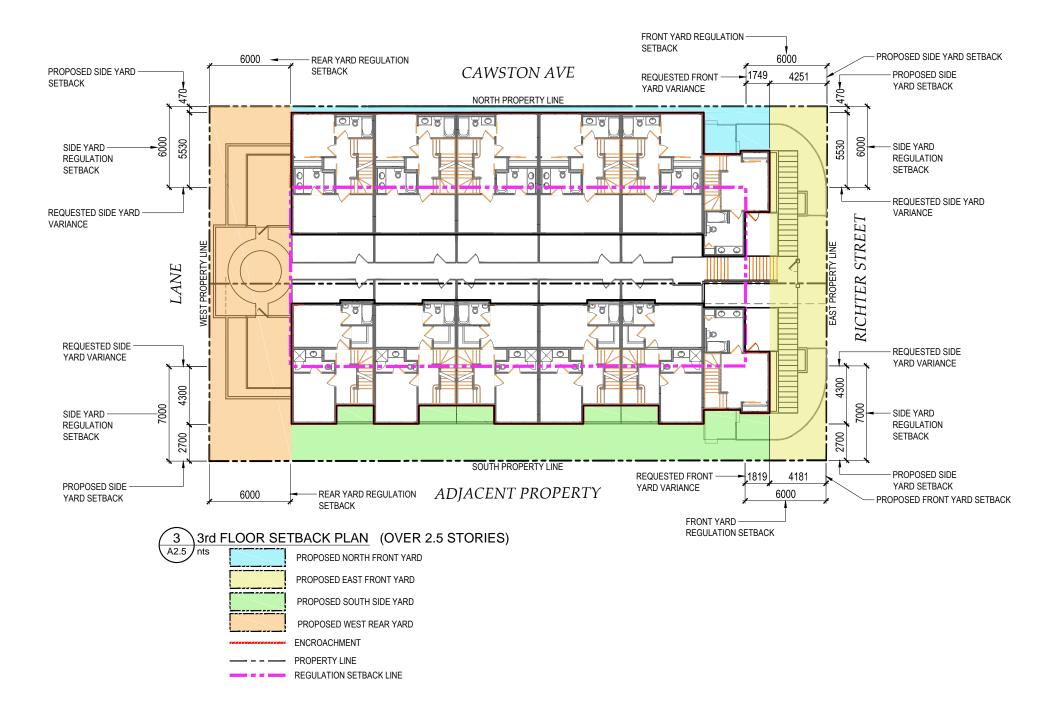

Development & Development Variance Permit DP17-0249 & DVP17-0250



This permit relates to land in the City of Kelowna municipally known as

1304 & 1308 Richter Street

and legally known as

Lot A District Lot 139 ODYD Plan EPP81393

The development has been approved subject to any attached terms and conditions, and to full compliance with the approved plans bearing the stamp of approval and the above described development permit number.

The present owner and any subsequent owner of the above described land must comply with any attached terms and conditions.

<u>Date of Decision:</u> June 12, 2018

Decision By: CITY COUNCIL

<u>Issued Date:</u> TBD

<u>Development Permit Area:</u> Comprehensive Development Permit Area

<u>File Manager:</u> Alec Warrender

This permit will not be valid if development has not commenced by June 12, 2020.

Existing Zone: RM5 – Medium Density Multiple Housing Future Land Use Designation: Multiple Unit Residential (Medium Density)

This is NOT a Building Permit.

In addition to your Development & Development Variance Permit, a Building Permit may be required prior to any work commencing. For further information, contact the City of Kelowna, Development Services Branch.

NOTICE

This permit does not relieve the owner or the owner's authorized agent from full compliance with the requirements of any federal, provincial or other municipal legislation, or the terms and conditions of any easement, covenant, building scheme or agreement affecting the building or land.

Owner: 1139096 BC Ltd Address: 1593 Klein Road City: West Kelowna, BC

Ryan Smith, Community Planning Department Manager Community Planning & Strategic Investments Date

1. SCOPE OF APPROVAL

This Development Permit applies to and only to those lands within the Municipality as described above, and any and all buildings, structures and other development thereon.

This Development Permit is issued subject to compliance with all of the Bylaws of the Municipality applicable thereto, except as specifically varied or supplemented by this permit, noted in the Terms and Conditions below.

The issuance of a permit limits the permit holder to be in strict compliance with regulations of the Zoning Bylaw and all other Bylaws unless specific variances have been authorized by the Development Permit. No implied variances from bylaw provisions shall be granted by virtue of drawing notations that are inconsistent with bylaw provisions and that may not have been identified as required Variances by the applicant or Municipal staff.

2. CONDITIONS OF APPROVAL

- a) The dimensions and siting of the building to be constructed on the land be in accordance with Schedule "A";
- b) The exterior design and finish of the building to be constructed on the land be in accordance with Schedule "B";
- c) Landscaping to be provided on the land be in accordance with Schedule "C"; and
- d) The applicant be required to post with the City a Landscape Performance Security deposit in the form of a "Letter of Credit" in the amount of 125% of the estimated value of the landscaping, as determined by a Registered Landscape Architect.
- e) Council approved variances:

Section 13.11.6 (d) Development Regulations – Front Yard Setback

To vary the front yard setback for a portion of the building above 2 ½ storeys (3rd storey) from 6.om required to 4.18m proposed.

Section 13.11.6 (e) Development Regulations – Side Yard Setback (South)

To vary the side yard setback for portions of the building below 2 ½ storeys from 4.5 m required to 2.76 m proposed.

To vary the side yard setback for portions of the building above 2 $\frac{1}{2}$ storeys from 7.0 m required to 2.7 m for the 3rd storey and 4.05 m for the 4th storey.

Section 13.11.6 (e) Development Regulations - Side Yard Setback (North)

To vary the side yard setback for portions of the building below 2 ½ storeys from 1.5 m required to 0.47 m proposed.

To vary the side yard setback for portions of the building above 2 $\frac{1}{2}$ storeys from 6.0 m required to 0.47 m for the 3rd and 4th storeys.

Section 13.11.6 (f) Development Regulations – Rear Yard Setback

To vary the rear yard setback from 7.om required to 1.19m proposed.

This Development Permit and Development Variance Permit is valid for two (2) years from the date of Council approval, with no opportunity to extend.

3. PERFORMANCE SECURITY

As a condition of the issuance of this Permit, Council is holding the security set out below to ensure that development is carried out in accordance with the terms and conditions of this Permit. Should any interest be earned upon the security, it shall accrue to the Developer and be paid to the Developer or his or her designate if the security is returned. The condition of the posting of the security is that should the Developer fail to carry out the development hereby authorized, according to the terms and conditions of this Permit within the time provided, the Municipality may use enter into an agreement with the property owner of the day to have the work carried out, and any surplus shall be paid over to the property own of the day. Should the Developer carry out the development permitted by this Permit within the time set out above, the security shall be returned to the Developer or his or her designate. There is filed accordingly:

a) A Certified Cheque in the amount of TBD.

Before any bond or security required under this Permit is reduced or released, the Developer will provide the City with a statutory declaration certifying that all labour, material, workers' compensation and other taxes and costs have been paid.

4. Indemnification

Upon commencement of the works authorized by this Permit the Developer covenants and agrees to save harmless and effectually indemnify the Municipality against:

a) All actions and proceedings, costs, damages, expenses, claims, and demands whatsoever and by whomsoever brought, by reason of the Municipality said Permit.

All costs, expenses, claims that may be incurred by the Municipality where the construction, engineering or other types of works as called for by the Permit results in damages to any property owned in whole or in part by the Municipality or which the Municipality by duty or custom is obliged, directly or indirectly in any way or to any degree, to construct, repair, or maintain.

The PERMIT HOLDER is the <u>CURRENT LAND OWNER</u>. Security shall <u>ONLY</u> be returned to the signatory of the Landscape Agreement or their designates.





3800 Point McKay Road NW, Calgary, Alberta, T3B 5B8

DESCRIPTION 09/29/2017 PROJECT START DP SUBMISSION 10/27/2017

CONSULTANTS

1304 & 1308 Richter Street

DRAWING LIST

- ARCHITECTURAL: A0 - COVER SHEET & INFO
- A2 PARKING/MAIN FLOOR PLAN A2.1 - SECOND FLOOR PLAN
- A2.2 THIRD FLOOR PLAN
- A2.3 FOURTH FLOOR PLAN
- A2.4 ROOF PLAN A2.5 - SETBACK PLAN
- A3 UNIT TYPE A FLOOR PLANS
- A3.1 UNIT TYPE B FLOOR PLANS A3.2 - UNIT TYPE C FLOOR PLANS
- A3.3 UNIT TYPE D FLOOR PLANS
- A3.4 UNIT TYPE E FLOOR PLANS A3.5 - UNIT TYPE F FLOOR PLANS
- A3.6 UNIT TYPE G FLOOR PLANS
- A4 ELEVATIONS A4.1 - ELEVATIONS
- A4.2 SECTIONS
- A4.3 RENDERINGS

BYLAW SUMMARY: RM5 GUIDELINES			
CRITERIA	REGULATION	PROPOSED	VARIANCE
SITE AREA:	1,400 m²	1,200.59 m²	Required
LOT WIDTH:	30 m	26.29 m	Required
LOT DEPTH:	35 m	45.70 m	N/A
MAXIMUM FAR: (not including covered parking)	1.4	1.37	N/A
MAXIMUM SITE COVERAGE: (Building, Parking & Paving)	70%	70%	N/A
MAXIMUM HEIGHT:	4.5 Storeys/18 m	4 Storeys/12.5 m	N/A
FRONT YARD: (Richter St.)	1.5 m & 6 m	1.5 m & 4.1 m	Required
SIDE YARD: (South) Shared property line	4.5 m & 7 m	2.7 m & 2.7m	Required
SIDE YARD: (Cawston Ave.)	1.5 m & 6 m	1.5 m - Varies 0.47 m - 3.17 m	Required
REAR YARD: (West) Laneway	1.5 m & 6 m	1.19 m at grade 6 m (Above Parkade)	Required
PARKING STALLS:	18 (150%)	24 (200%)	N/A
BICYCLE PARKING:	6 Class 1 & 3 Class 2	24 Class 1(2 per unit) & 10 Class 2	N/A
PRIVATE AMENITY SPACE: (25 sq.m x 12)	300 m²	359.96 m² Balconies, Patios & Decks	N/A
		74.72 m² Passive Private Space	
		137.89 m² Extensive Green Roof	
		572.57 m² Total Private Space	

LANDSCAPE:

L1 / 2 - CONCEPTUAL LANDSCAPE PLAN

F.A.R. CALCULATION

NET FLOOR AREA

NET FLOOR AREA

PROPOSED F.A.R.

SITE AREA

REGULATION MAXIMUM

ALLOWABLE DEDUCTABLE (50% Stair Area)

L2 / 2 - WATER CONSERVATION & IRRIGATION PLAN

UNIT & AREA	A SCHEDULE			NE
UNIT TYPE	TOTAL UNIT AREA	# OF UNITS	TOTAL NET UNIT AREAS	GI
UNIT A	147.78 m²	x1	147.78 m²	SE
UNIT B	148.18 m²	x 3	444.54 m²	TH
UNIT C	148.35 m²	χ1	148.35 m²	FC
UNIT D	145.17 m²	χ1	145.17 m²	NE
UNIT E	144.96 m²	х 3	434.88 m²	
UNIT F	145.12 m²	χ1	145.12 m²	
UNIT G	136.27 m²	х 2	272.54 m²	
TOTAL NET U	JNIT AREA	12 Units	1,738.38 m ²	

NET AREA SUMARY GROUND FLOOR - Residential Net Area 195.19 m² 636.26 m² SECOND FLOOR - Residential Net Area THIRD FLOOR - Residential Net Area 586.83 m² FOURTH FLOOR - Residential Net Area 320.10 m² NET FLOOR AREA 1,738.38 m²

1.4


1,738.38 m²


1,645.86 m²

1,200.59 m²

92.52 m²

1.37

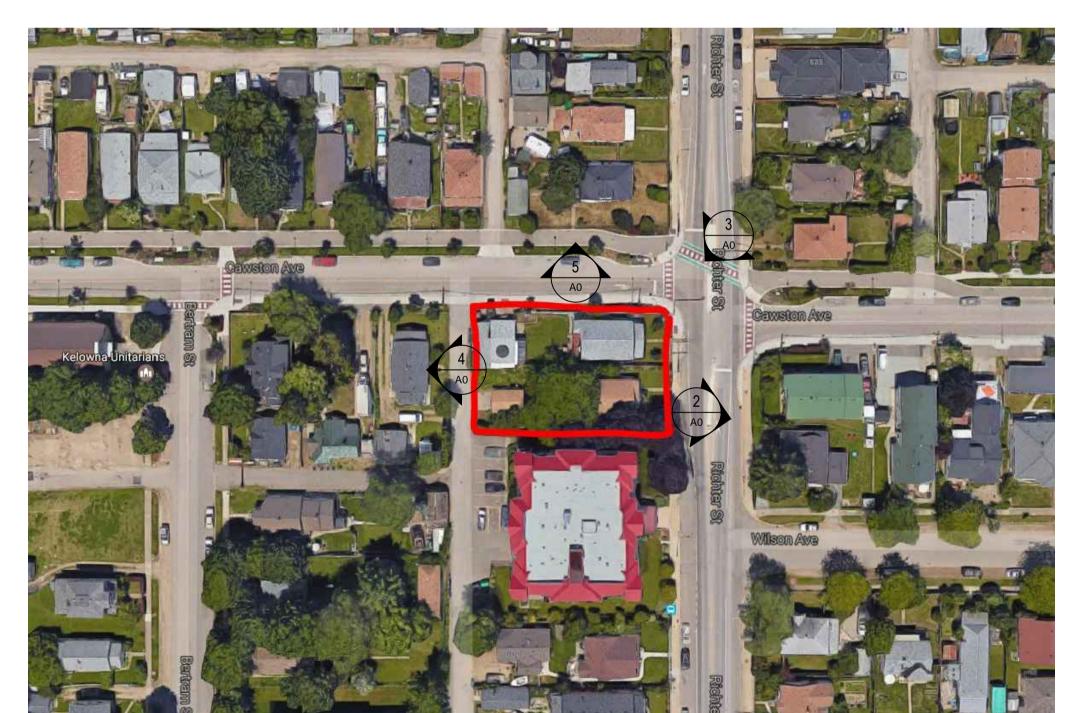

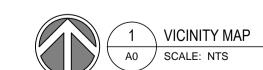














5 \ NORTH ADJACENT PROPERTY A0 SCALE: NTS

4 \ WEST ADJACENT PROPERTY

A0 SCALE: NTS

3 \ SOUTH ADJACENT PROPERTY

A0 SCALE: NTS

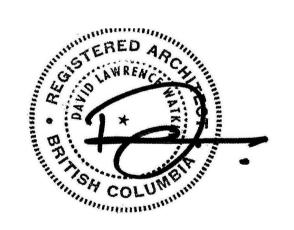

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PROJECT ----

PROJECT NAME 1304 & 1308 Richter Street Kelowna, B.C.

Cover Sheet

DRAWING NUMBER —


BUILDING PERMIT -BP2017-XX


DEVELOPMENT PERMIT -DP2017-XX FILE ----- DRAWN BY -

2017-12-RK HA

2017/10/27 AS INDICATED

A0

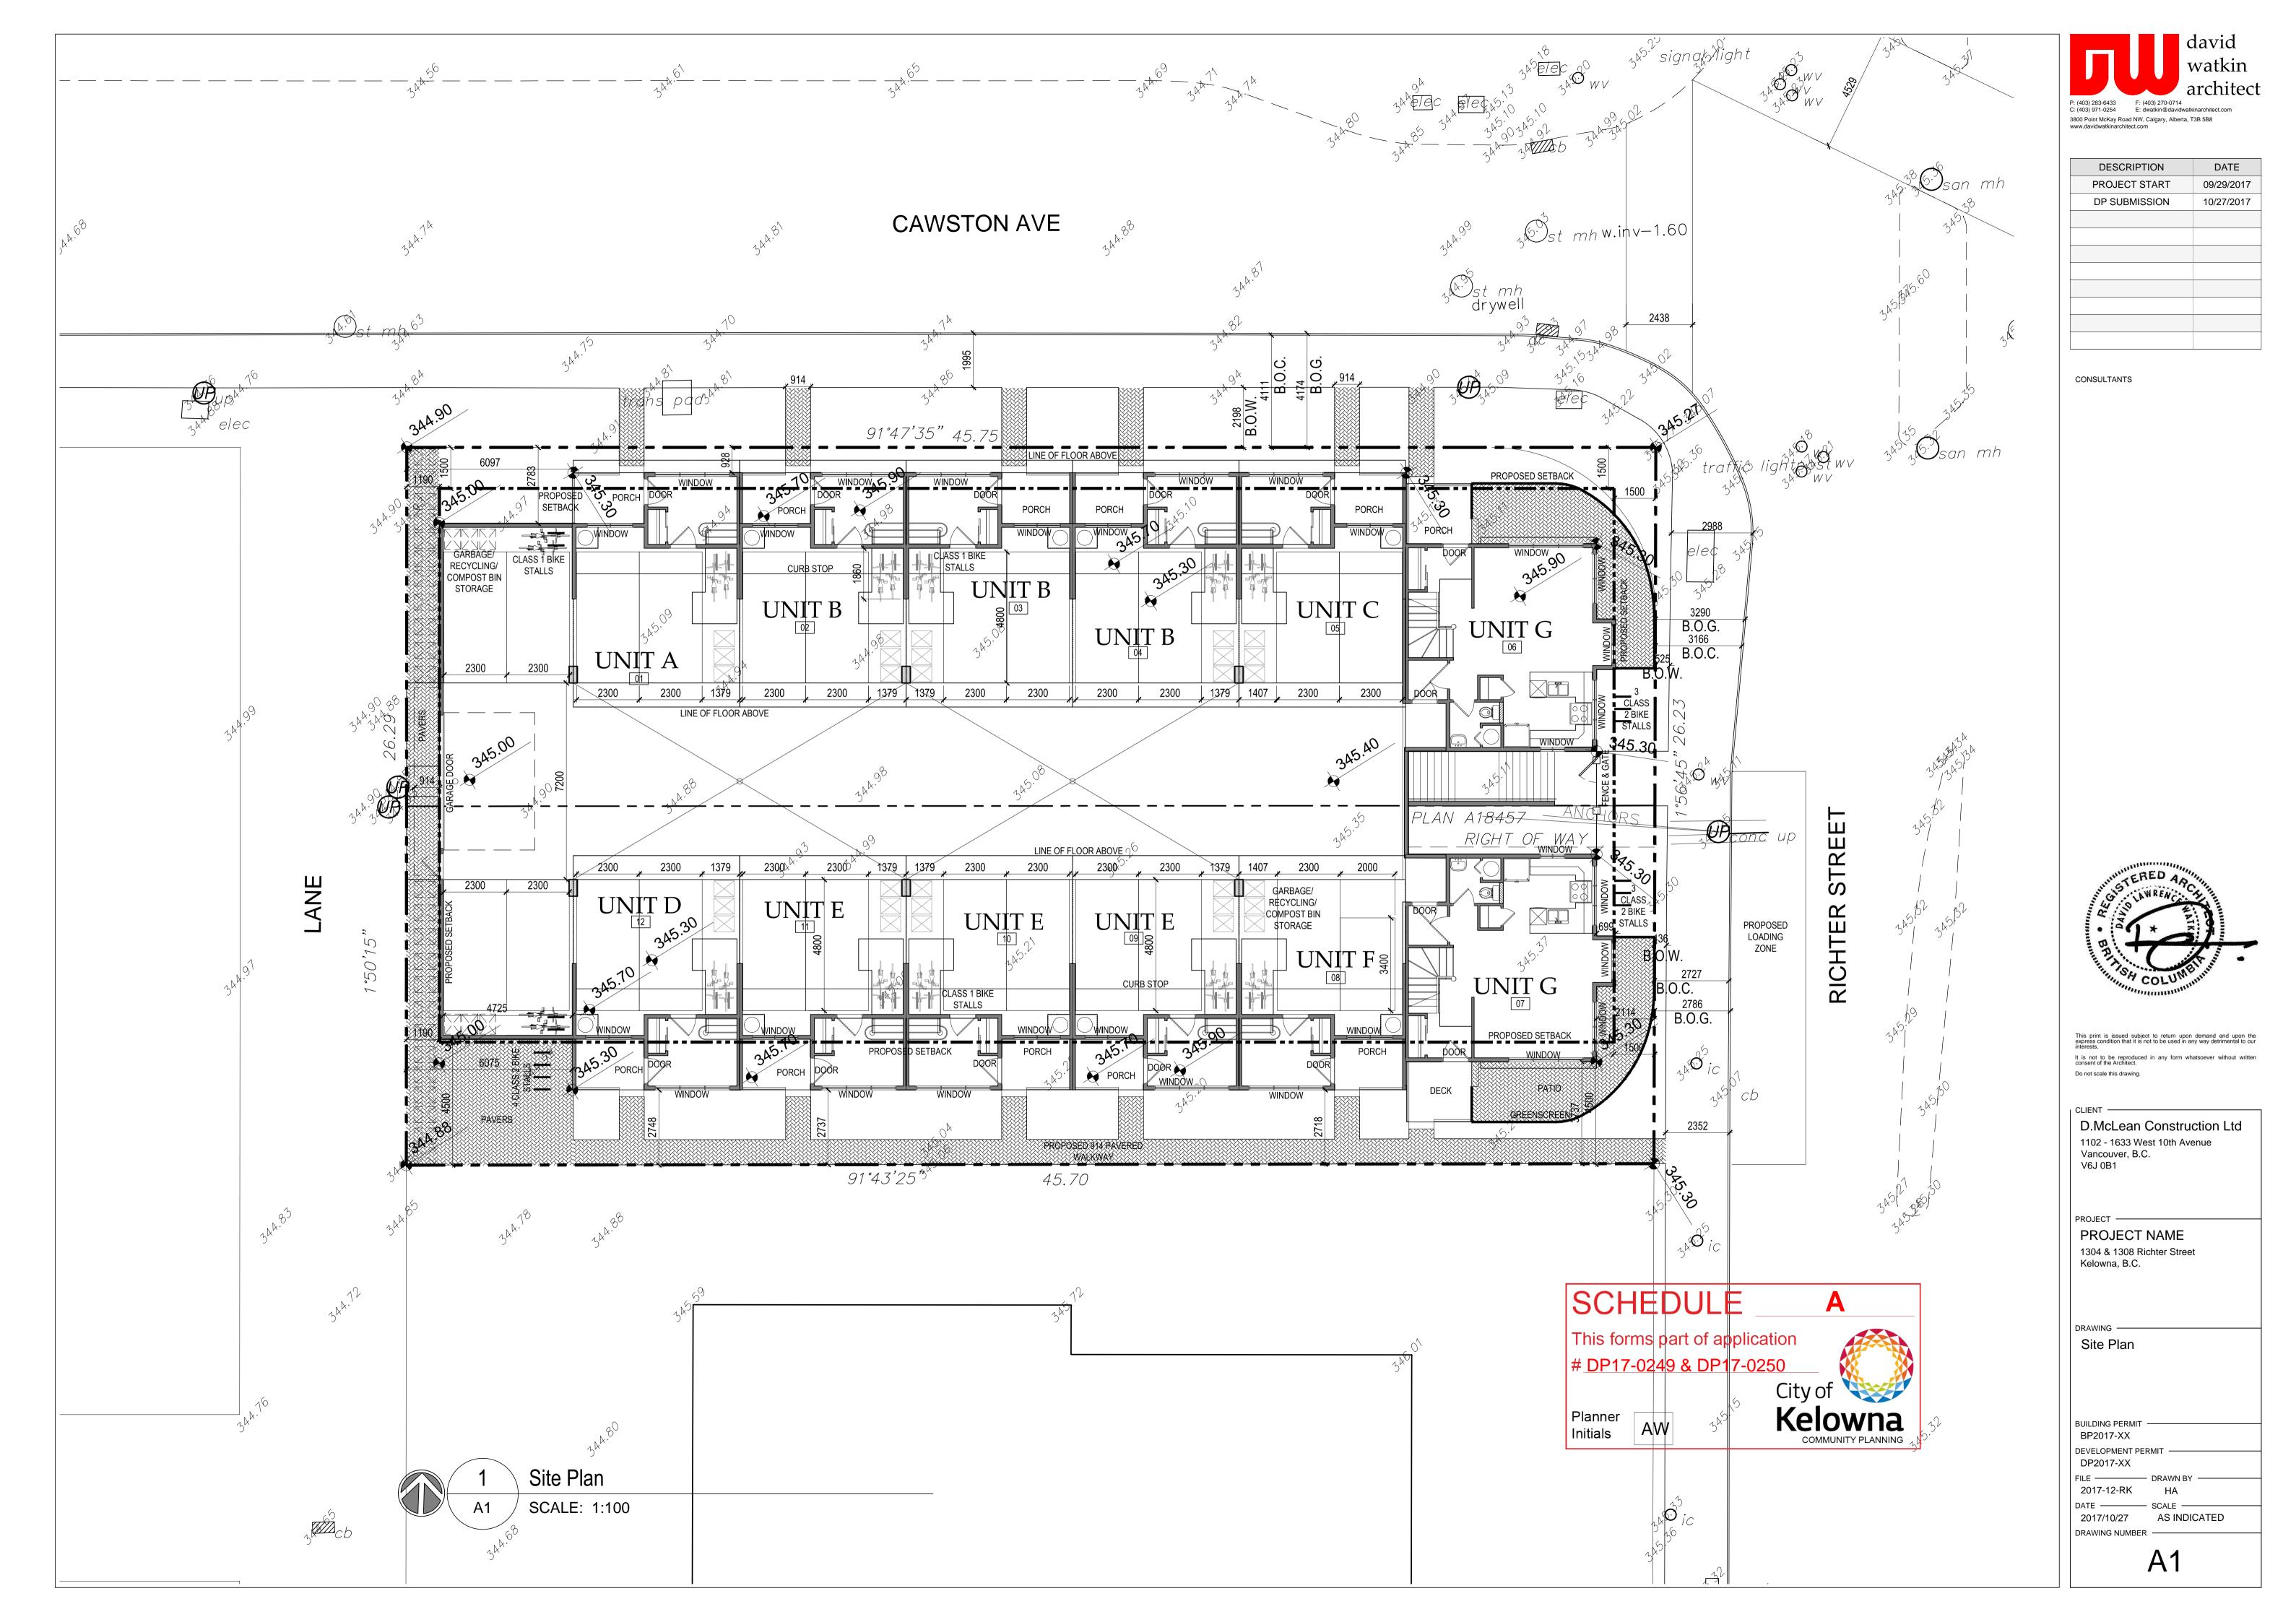

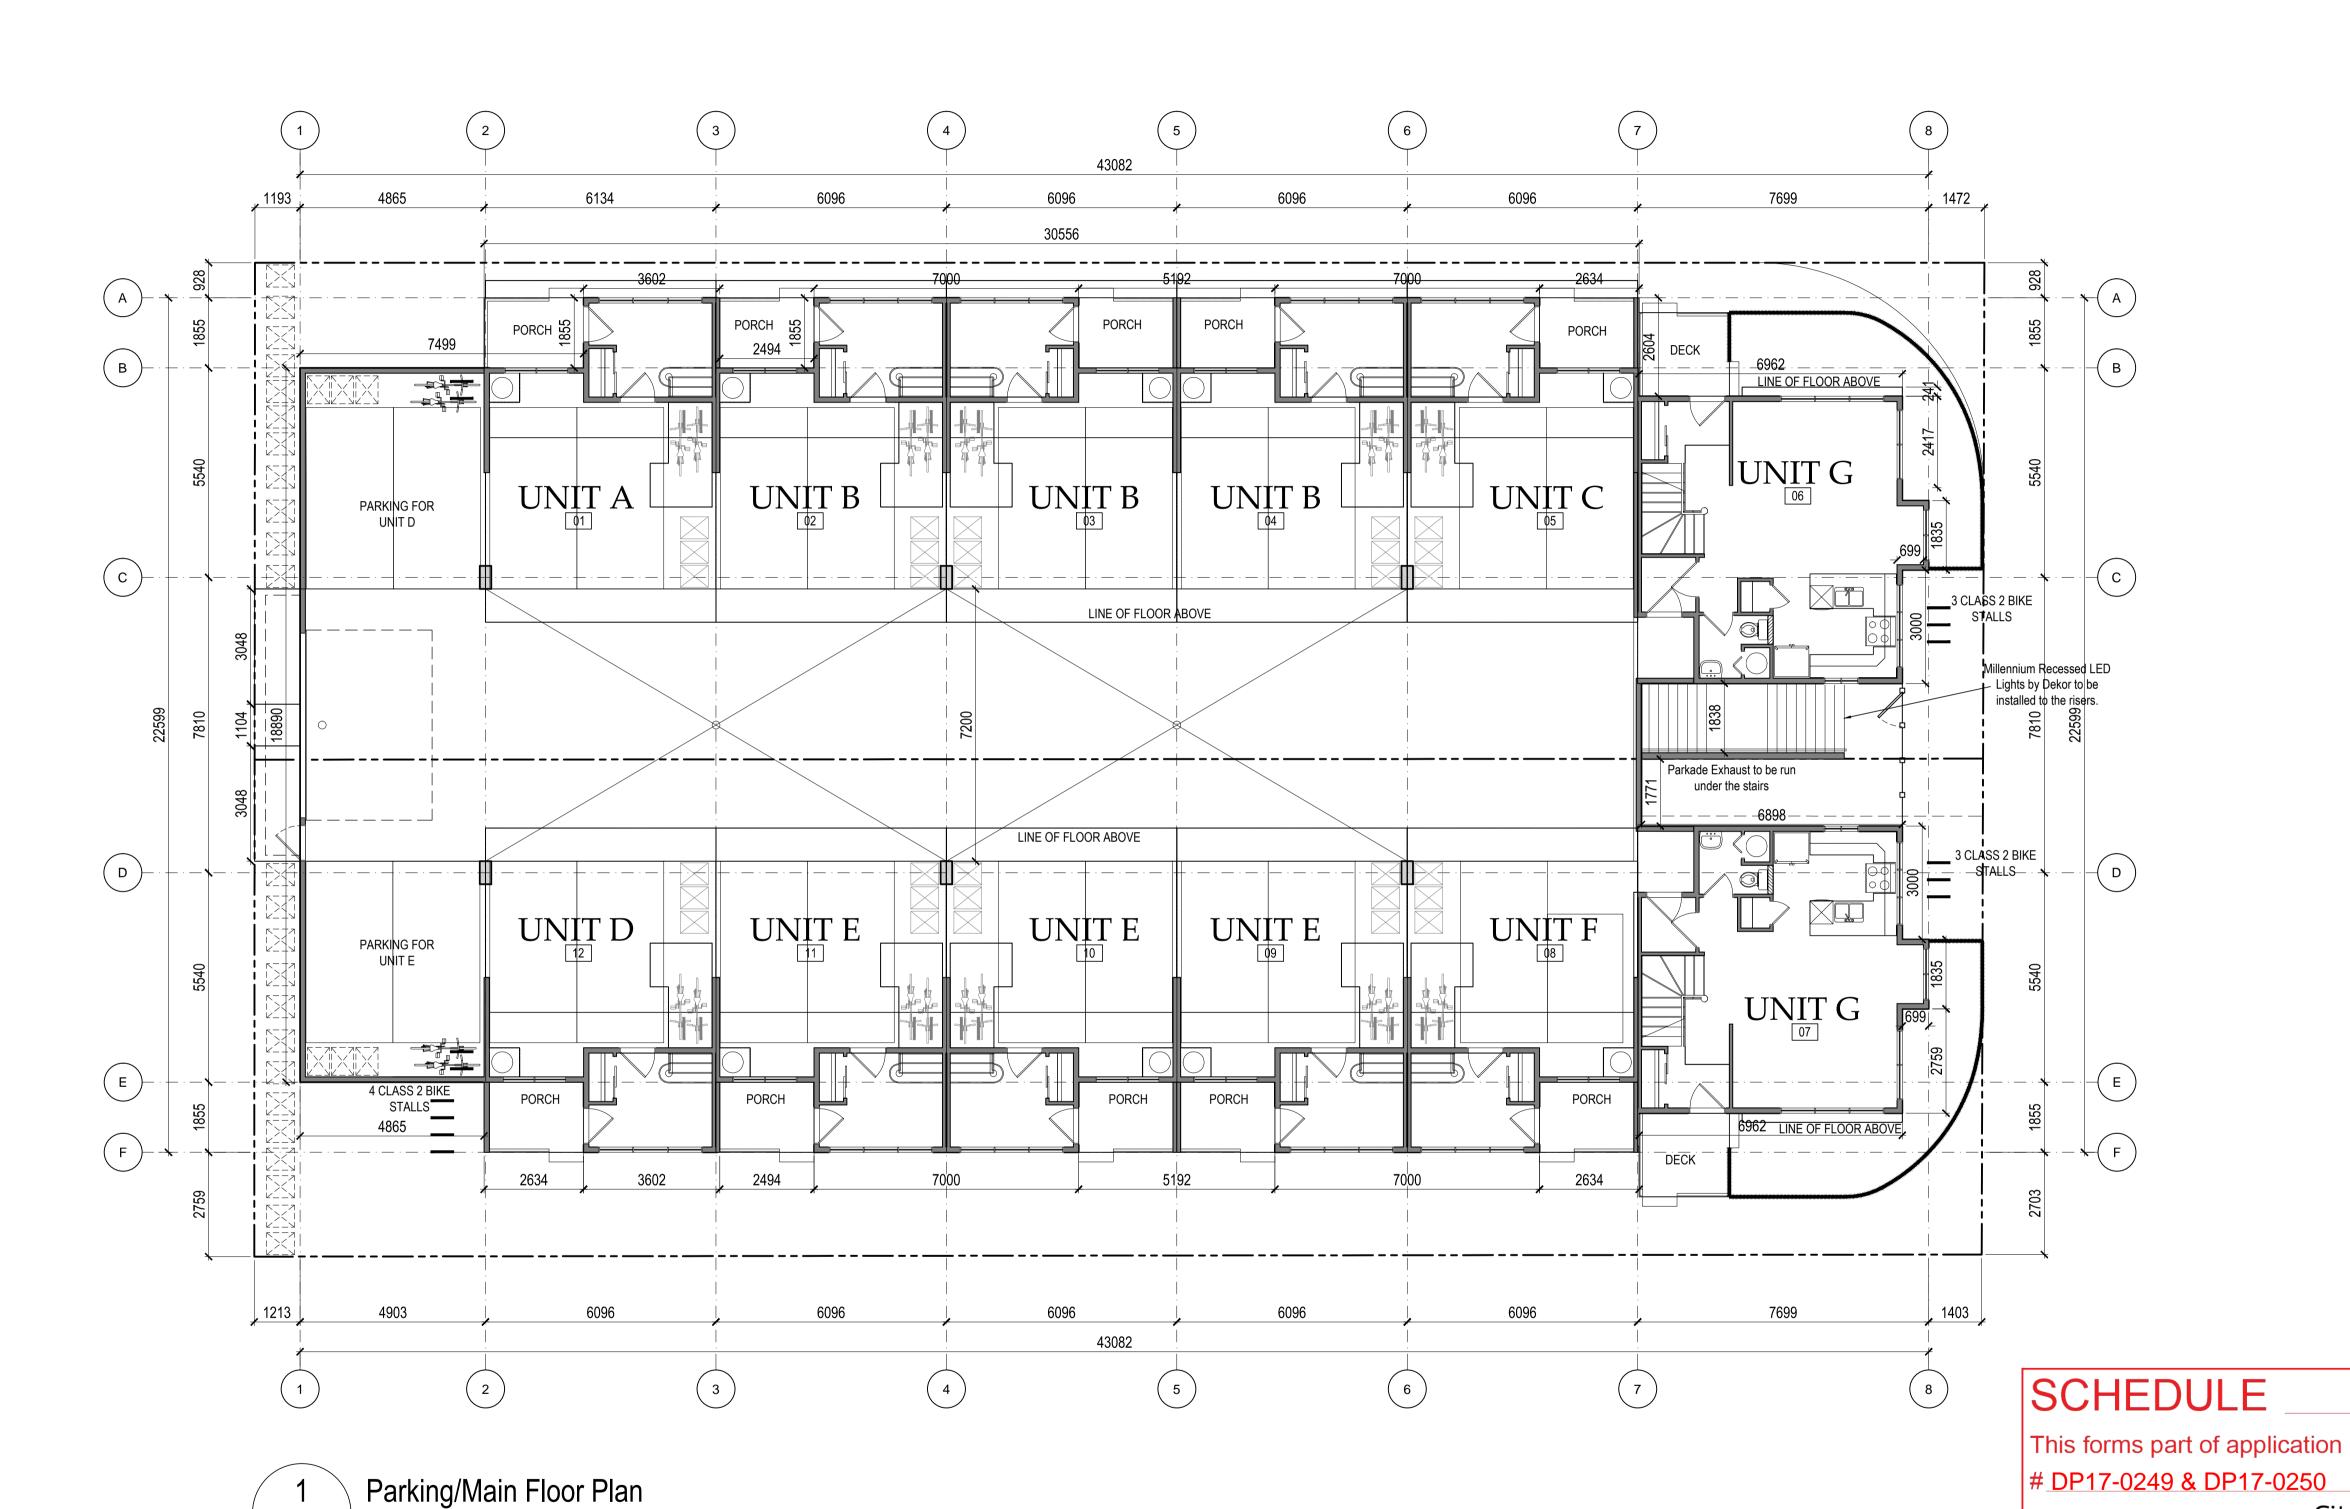

A2

SCALE: 1:100

FAR CALCULATION SITE AREA: 1,200.59 m² Main Floor Area: 195.19 m² 2nd Floor Area: 636.26 m² 3rd Floor Area: 586.83 m² 4th Floor Area: 320.10 m² Total Net Floor Area: 1738.38 m² Allowable Deductible (50% of stairs): 92.52 m² Planner Initials

AW

SITE AREA: 1,200.59 m²

Main Floor Area: 842.73 m²

SITE COVERAGE CALCULATION

842.73 / 1200.59 = 0.70 x 100 = 70%

Total Net Floor Area - Deductible = 1645.86

1645.86/1200.59 = 1.37 F.A.R.



DESCRIPTION	DATE
PROJECT START	09/29/2017
DP SUBMISSION	10/27/2017

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PROJECT ---PROJECT NAME 1304 & 1308 Richter Street Kelowna, B.C.

Parking/Main Floor Plan

BUILDING PERMIT


City of **Kelowna**

BP2017-XX DEVELOPMENT PERMIT · DP2017-XX

---- DRAWN BY -2017-12-RK HA 2017/10/27 AS INDICATED

DRAWING NUMBER -

A2

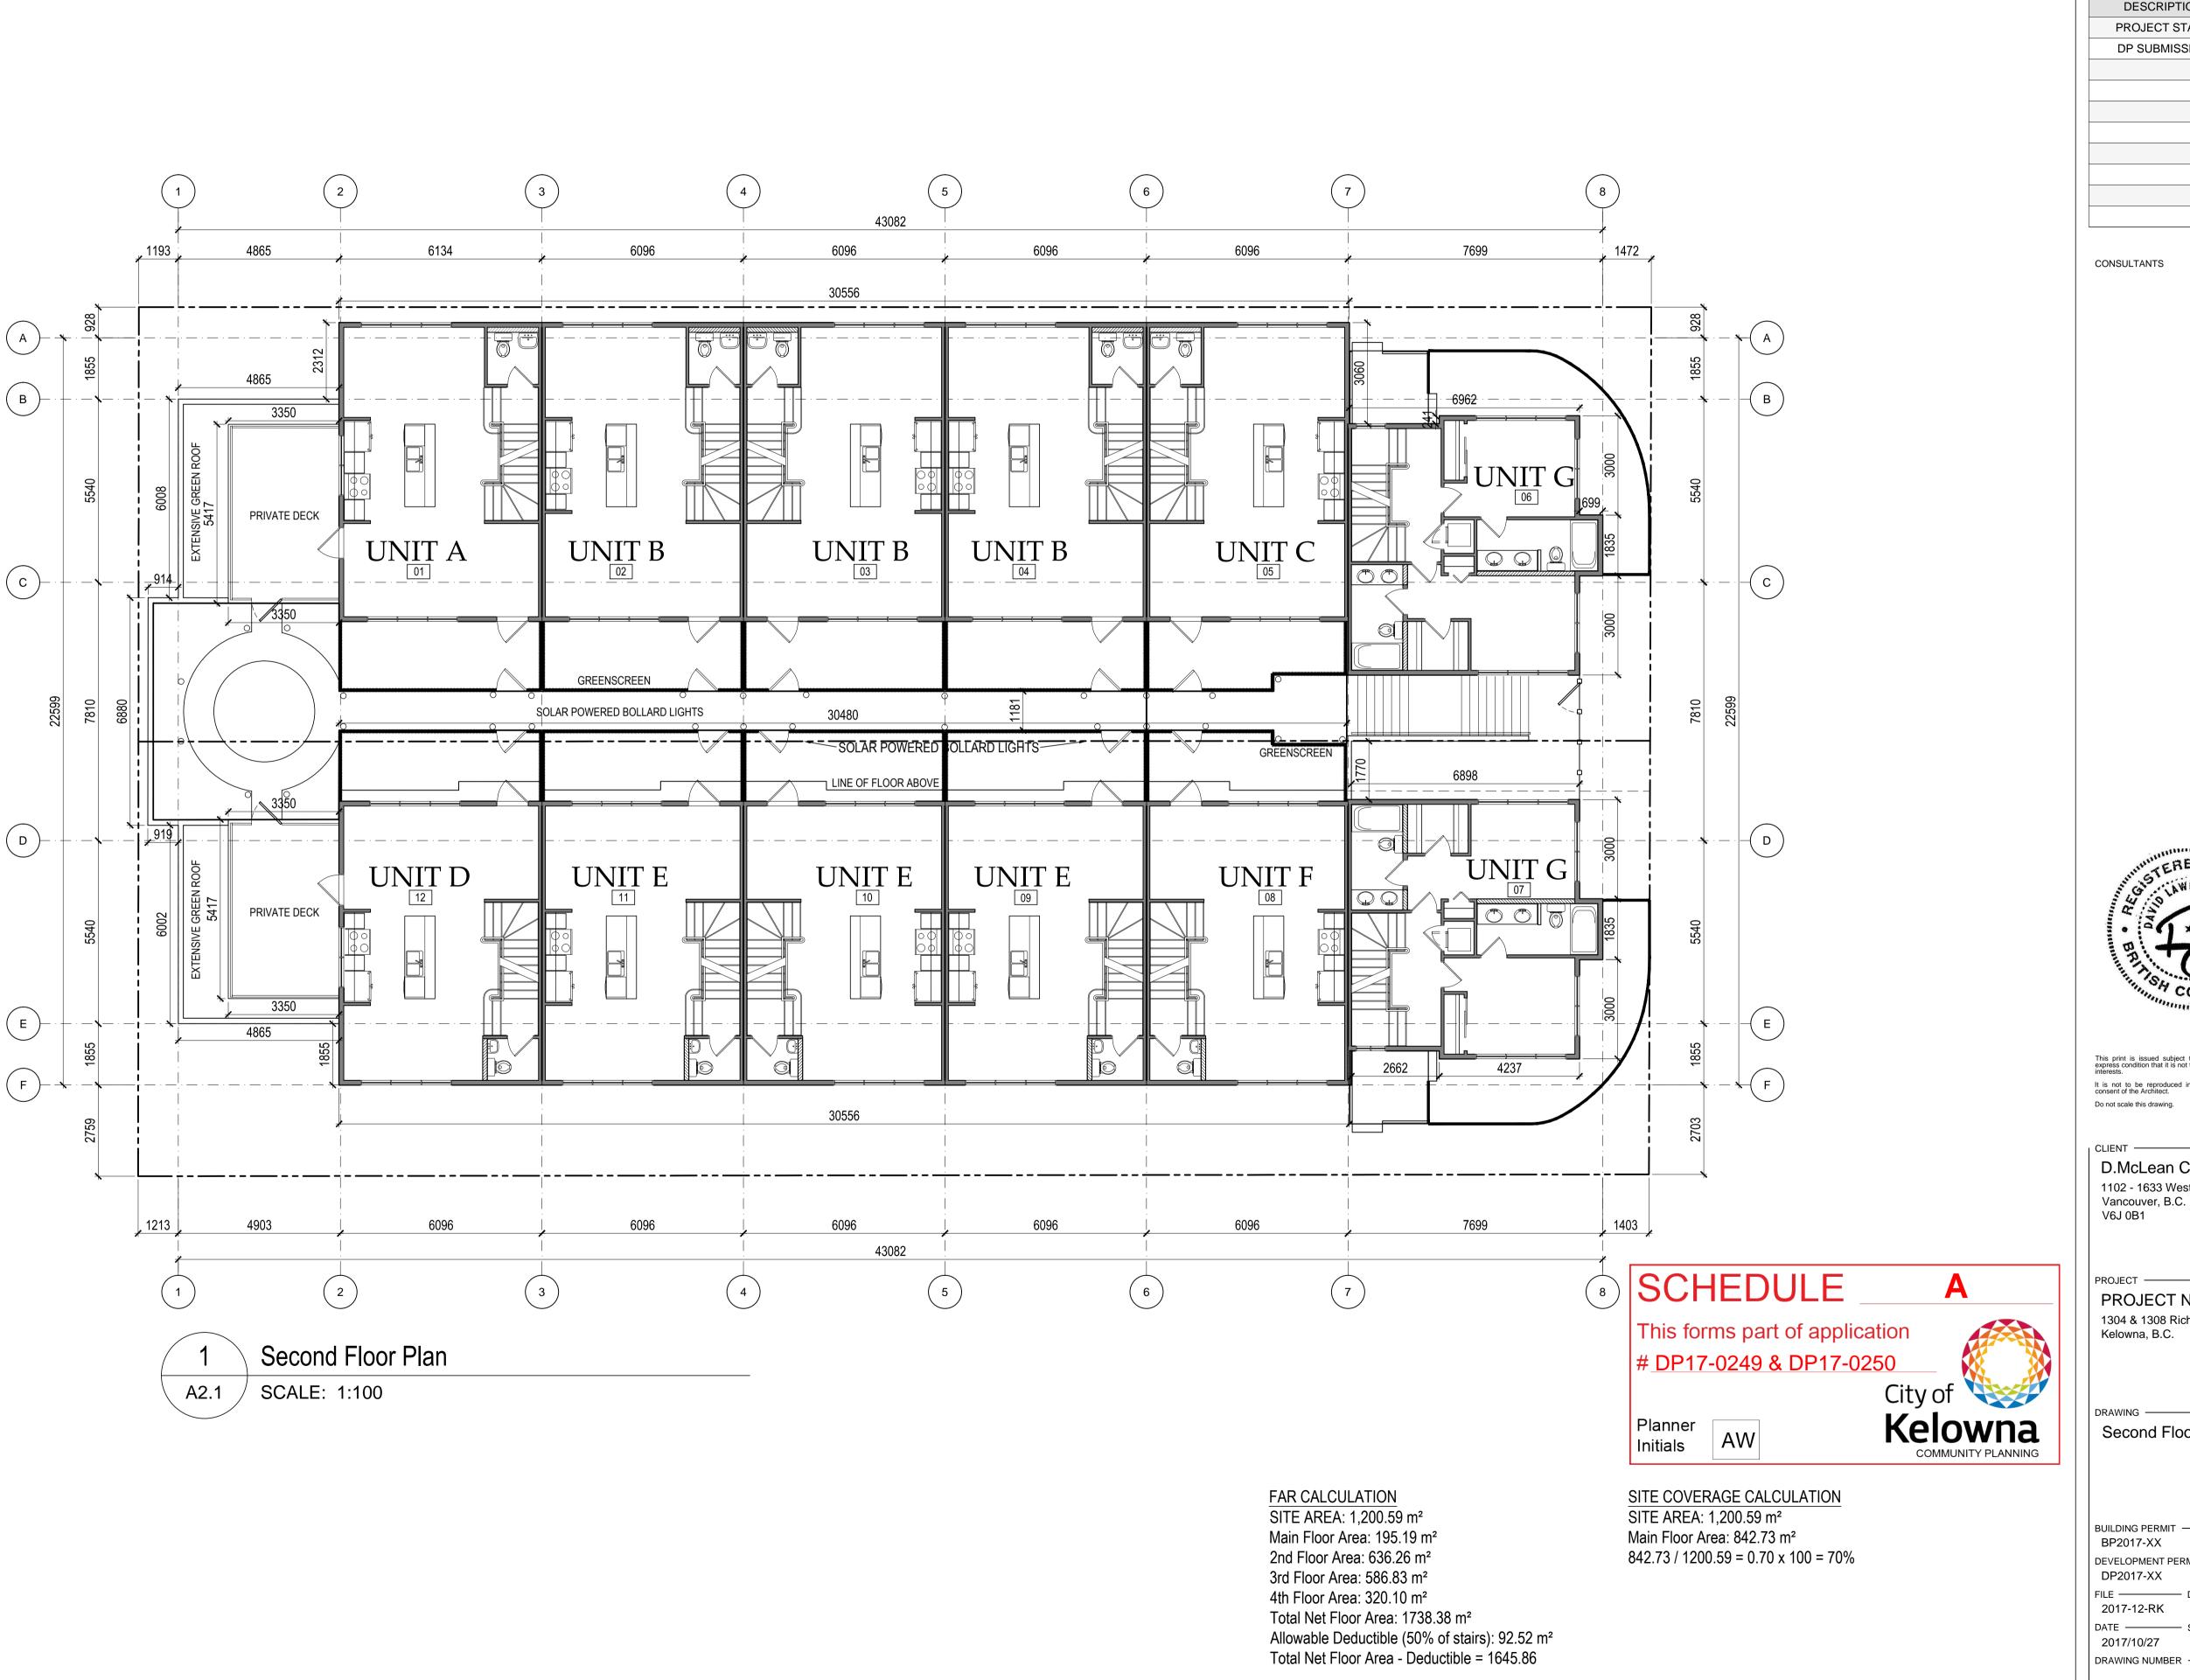


1645.86/1200.59 = 1.37 F.A.R.



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PROJECT -


PROJECT NAME 1304 & 1308 Richter Street Kelowna, B.C.

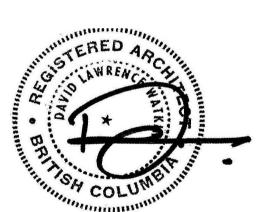Second Floor Plan

BUILDING PERMIT -BP2017-XX DEVELOPMENT PERMIT -DP2017-XX — DRAWN BY -

2017-12-RK HA 2017/10/27 AS INDICATED

A2.1

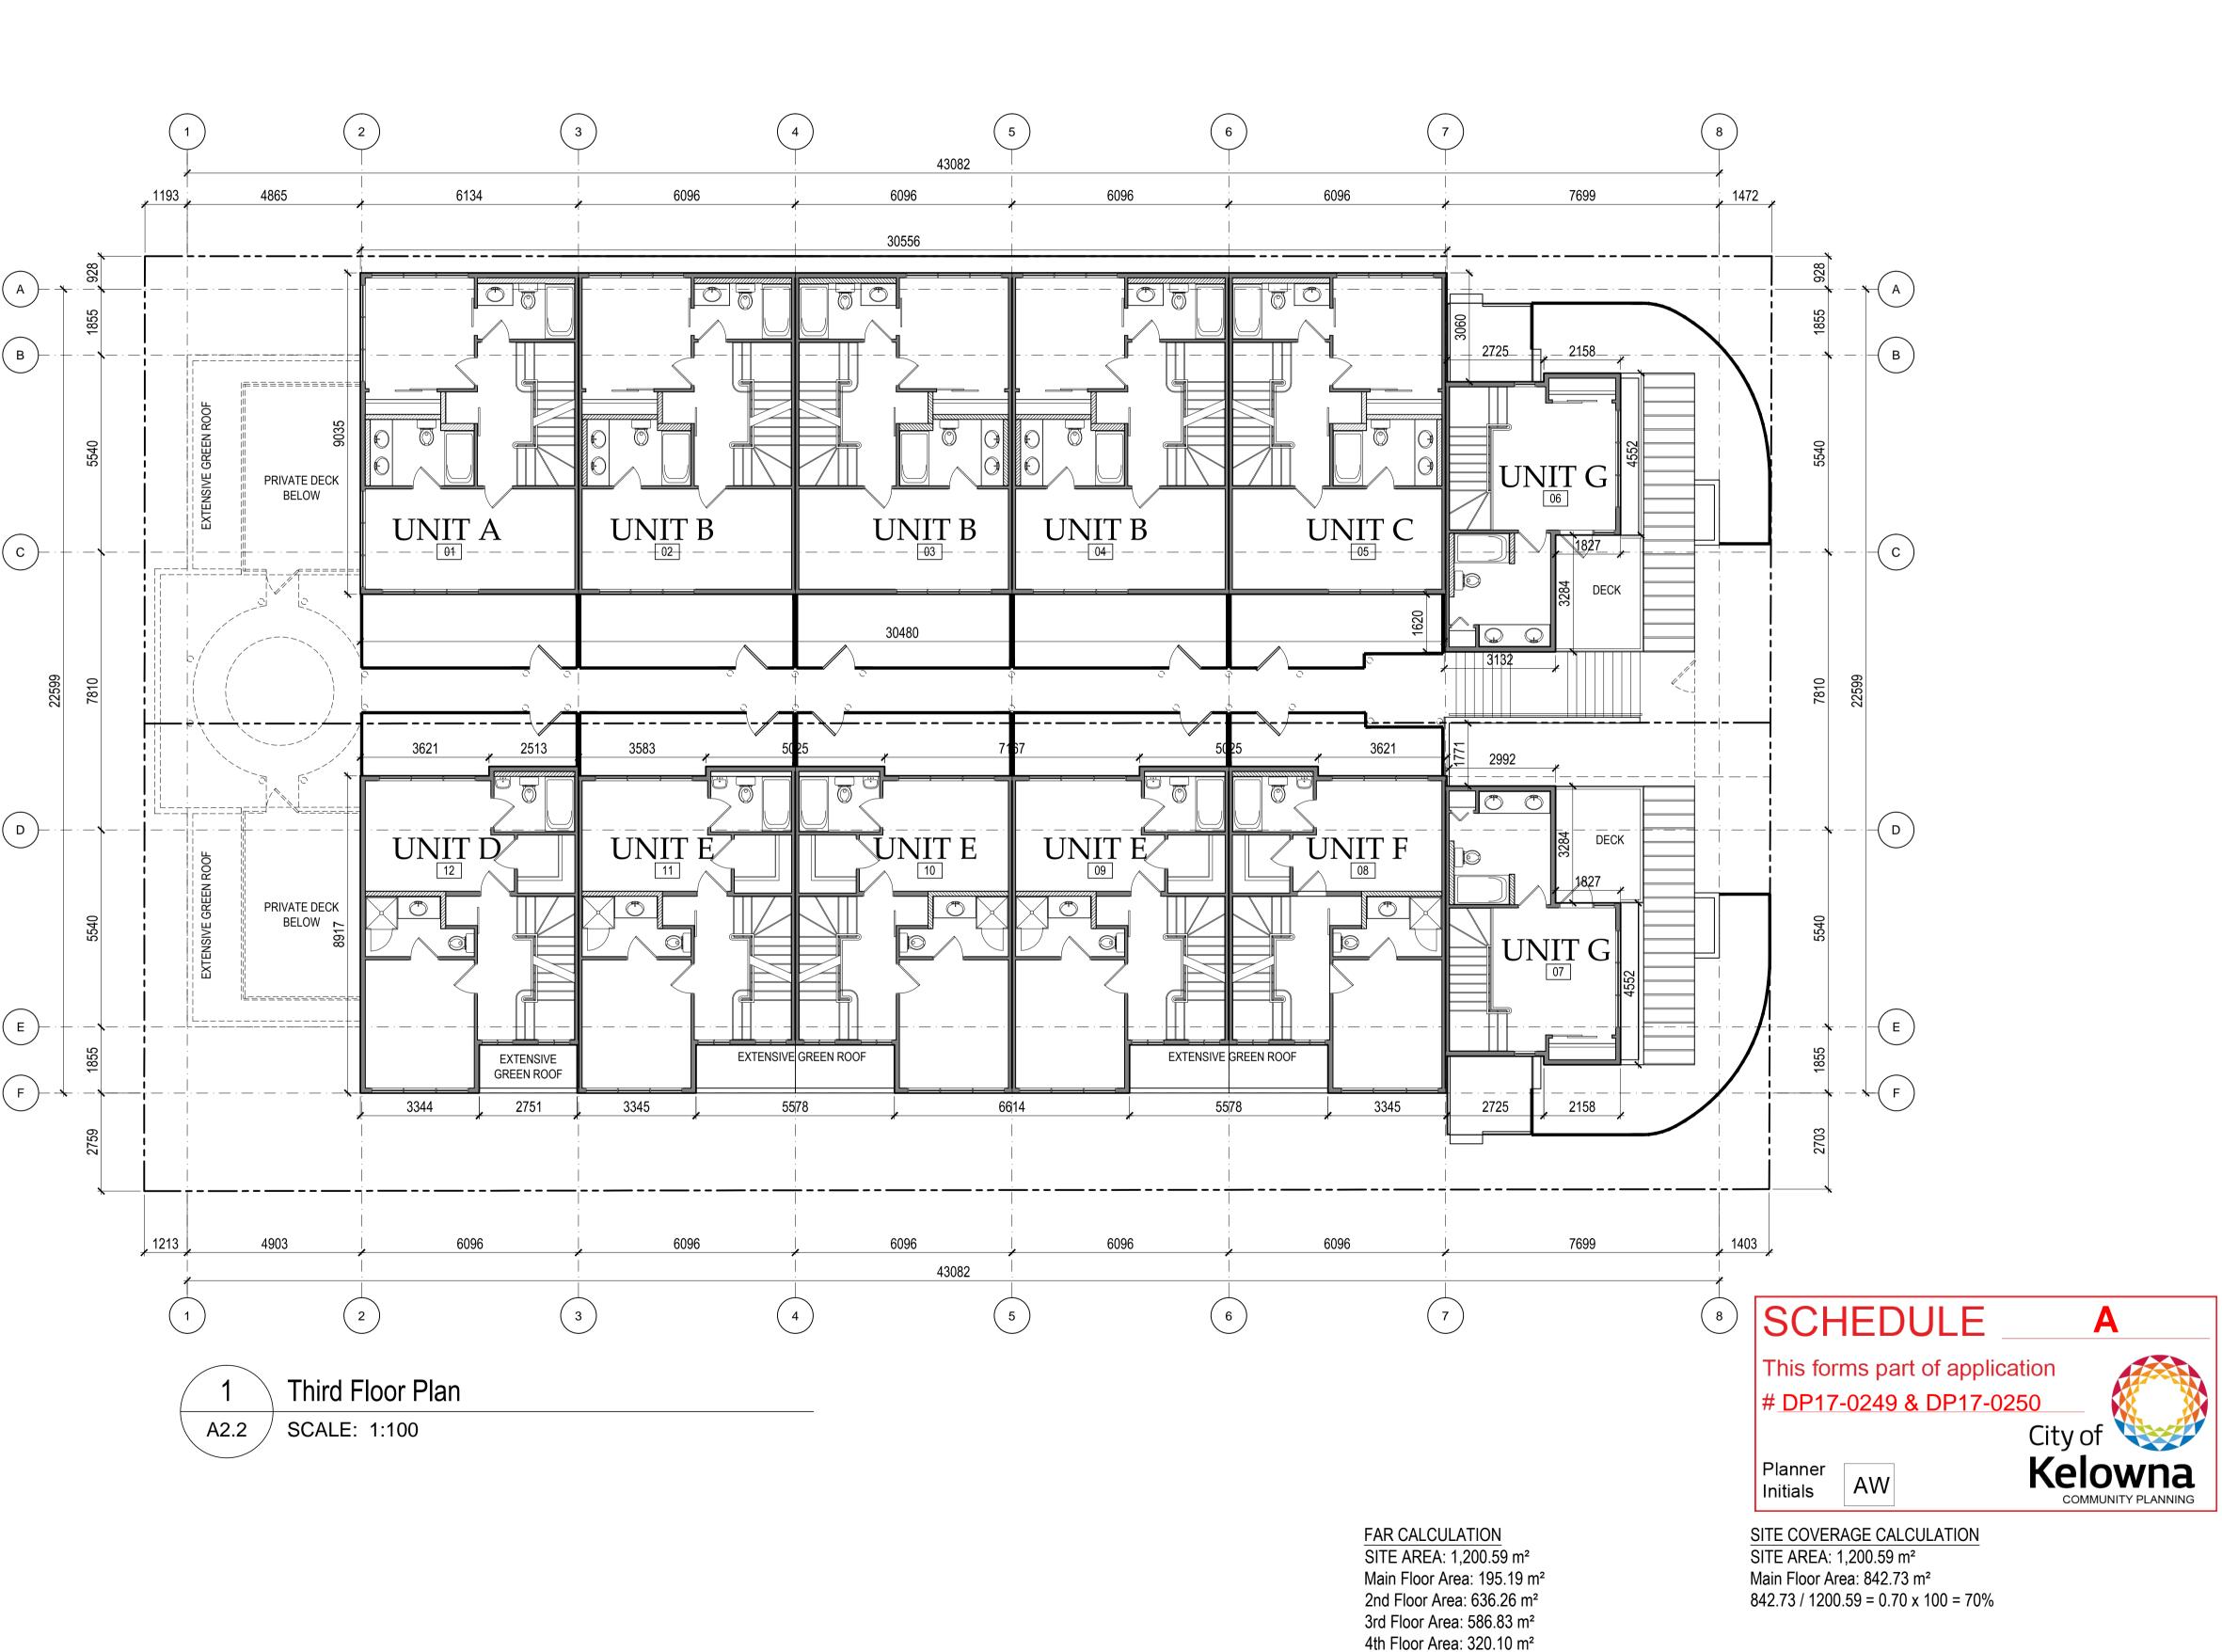

Total Net Floor Area: 1738.38 m²

1645.86/1200.59 = 1.37 F.A.R.

Allowable Deductible (50% of stairs): 92.52 m²

Total Net Floor Area - Deductible = 1645.86



DESCRIPTION	DATE
PROJECT START	09/29/2017
DP SUBMISSION	10/27/2017

CONSULTANTS



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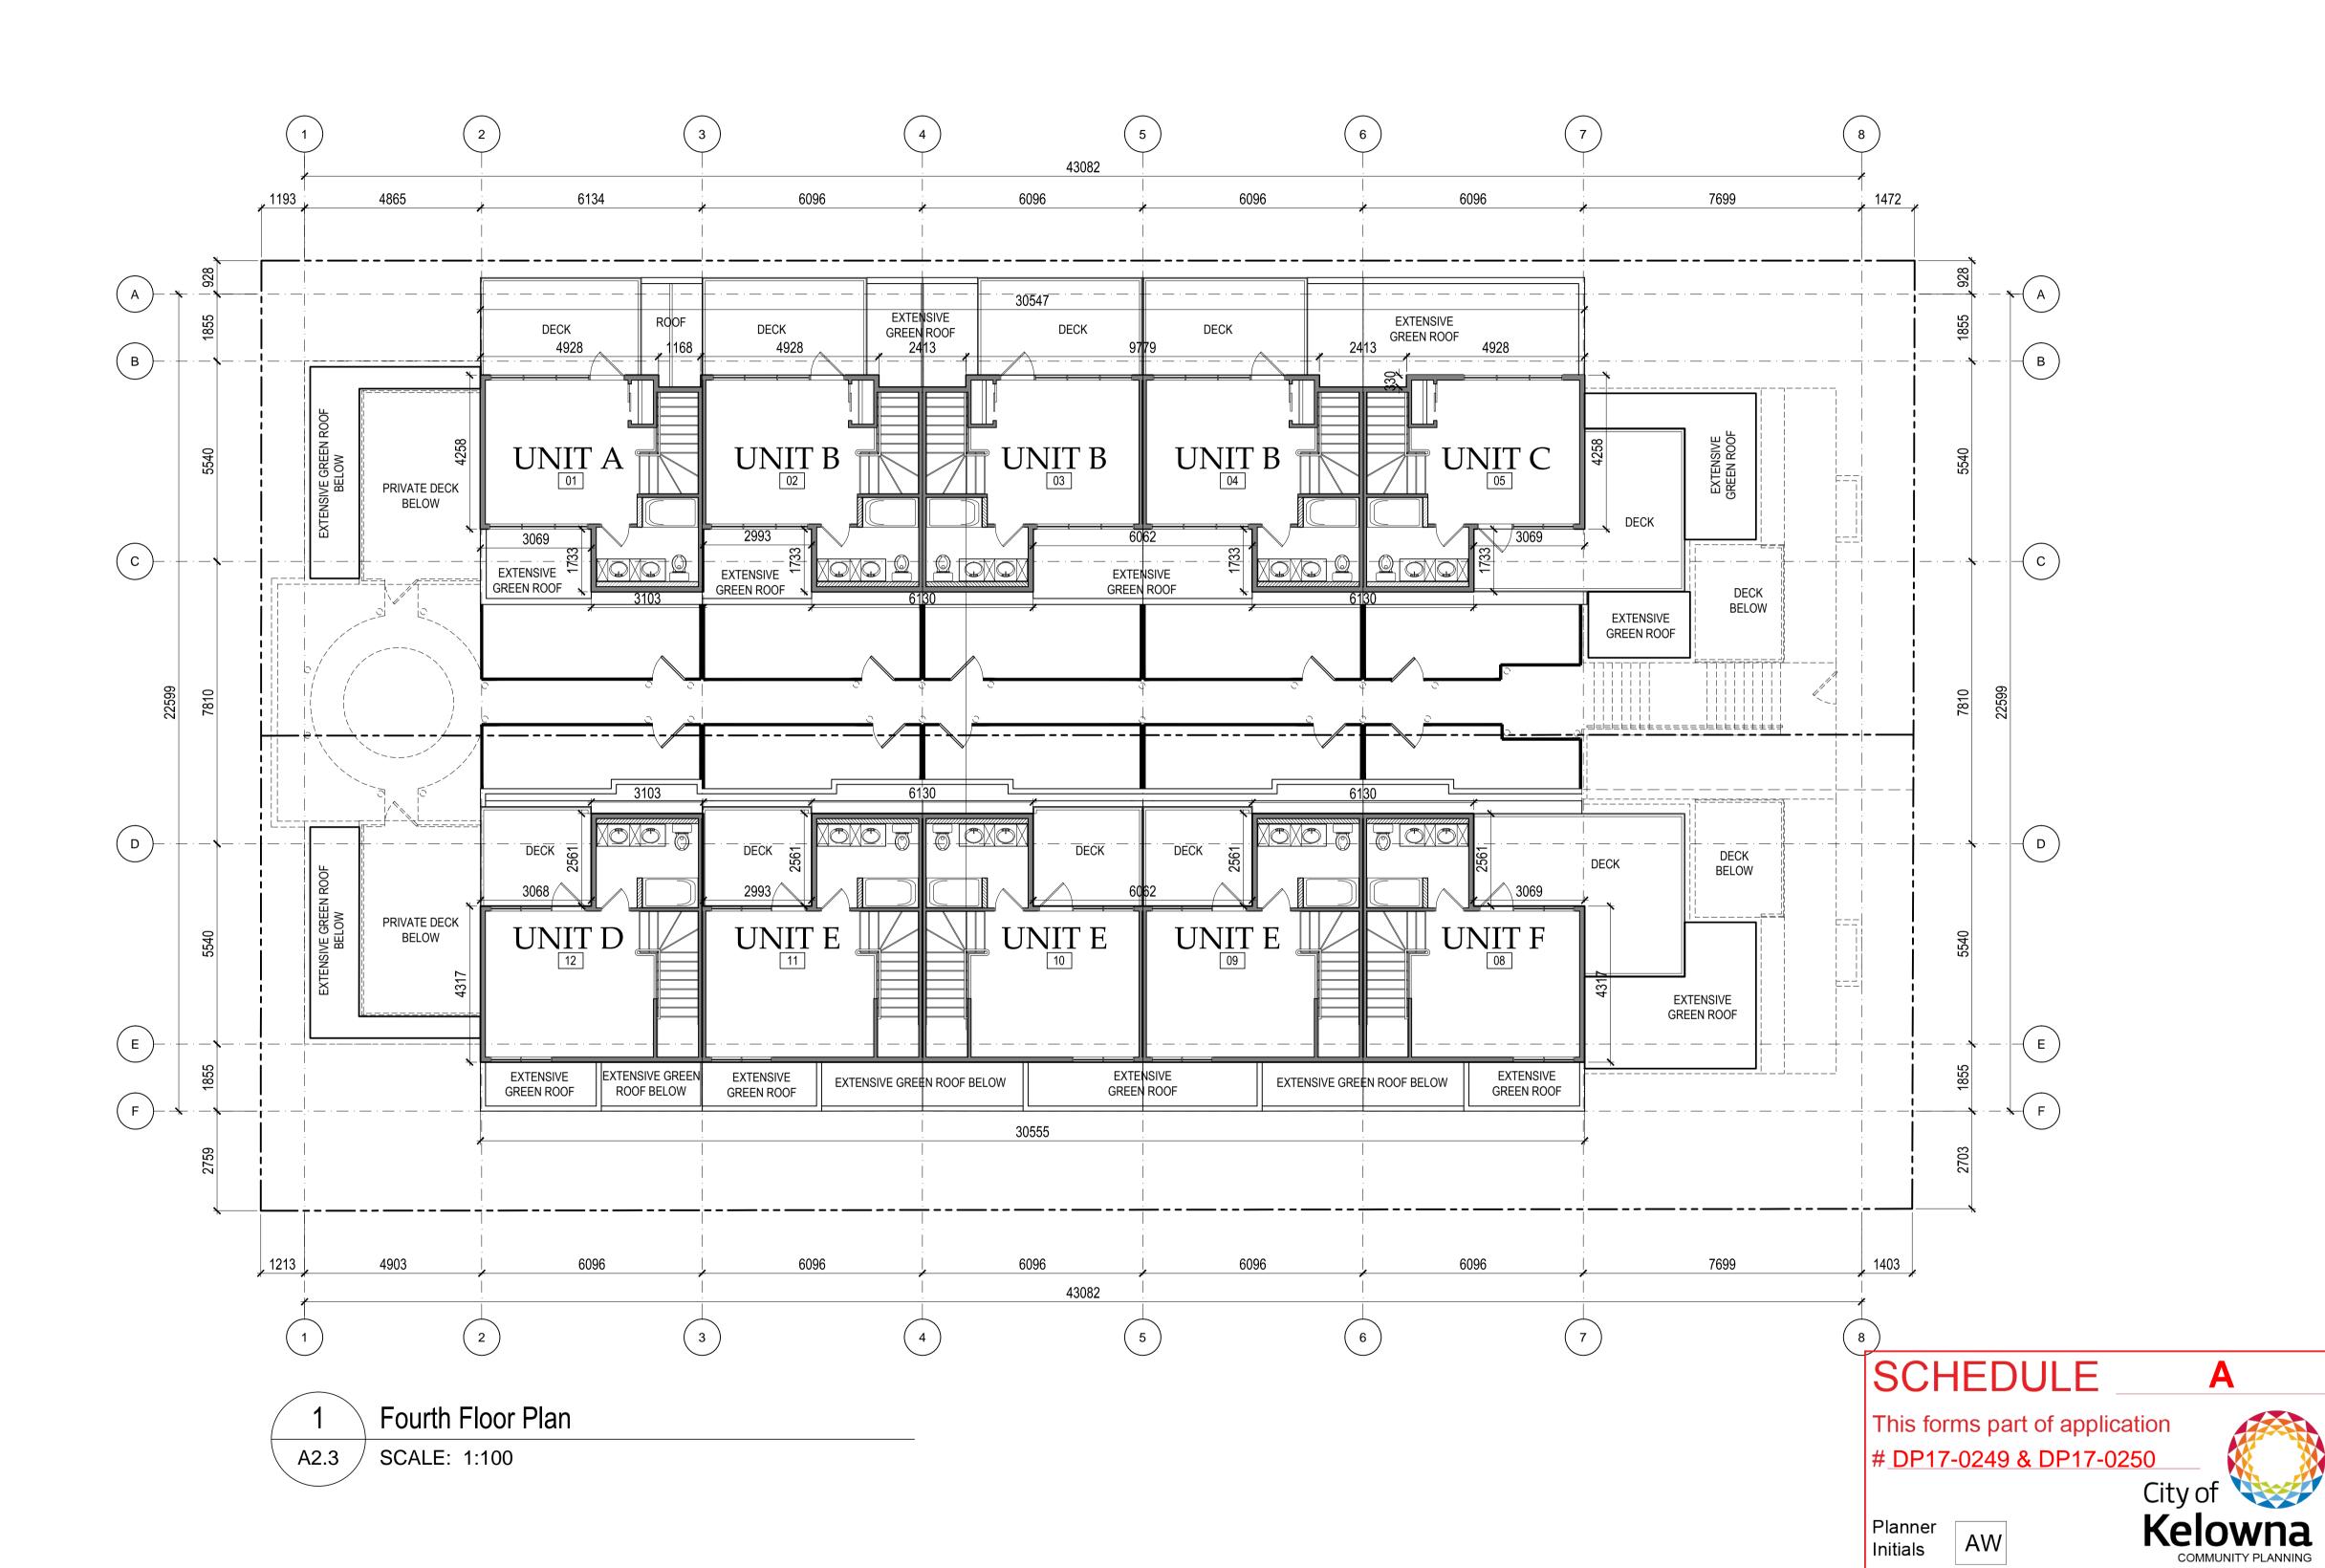
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D.McLean Construction Ltd
1102 - 1633 West 10th Avenue
Vancouver, B.C.
V6J 0B1

PROJECT NAME
1304 & 1308 Richter Street
Kelowna, B.C.

Third Floor Plan

A2.2



david watkin architect

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F: (403) 270-0714
E: dwatkin@davidwatkinarchitect.com

3800 Point McKay Road NW, Calgary, Alberta, T3B 5B8

DESCRIPTION	DATE
PROJECT START	09/29/2017
DP SUBMISSION	10/27/2017

CONSULTANTS



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1102 - 1633 West 10th Avenue
Vancouver, B.C.
V6J 0B1

PROJECT NAME
1304 & 1308 Richter Street
Kelowna, B.C.

DRAWING -

Fourth Floor Plan

BUILDING PERMIT
BP2017-XX

DEVELOPMENT PERMIT
DP2017-XX

FILE ______ DRAWN BY ____
2017-12-RK HA

FILE — DRAWN BY — 2017-12-RK HA

DATE — SCALE — AS INDICATED

A2.3

1645.86/1200.59 = 1.37 F.A.R.

Total Net Floor Area: 1738.38 m²

Allowable Deductible (50% of stairs): 92.52 m²

Total Net Floor Area - Deductible = 1645.86

FAR CALCULATION

SITE AREA: 1,200.59 m²

Main Floor Area: 195.19 m²

2nd Floor Area: 636.26 m²

3rd Floor Area: 586.83 m²


4th Floor Area: 320.10 m²

SITE COVERAGE CALCULATION

842.73 / 1200.59 = 0.70 x 100 = 70%

SITE AREA: 1,200.59 m²

Main Floor Area: 842.73 m²

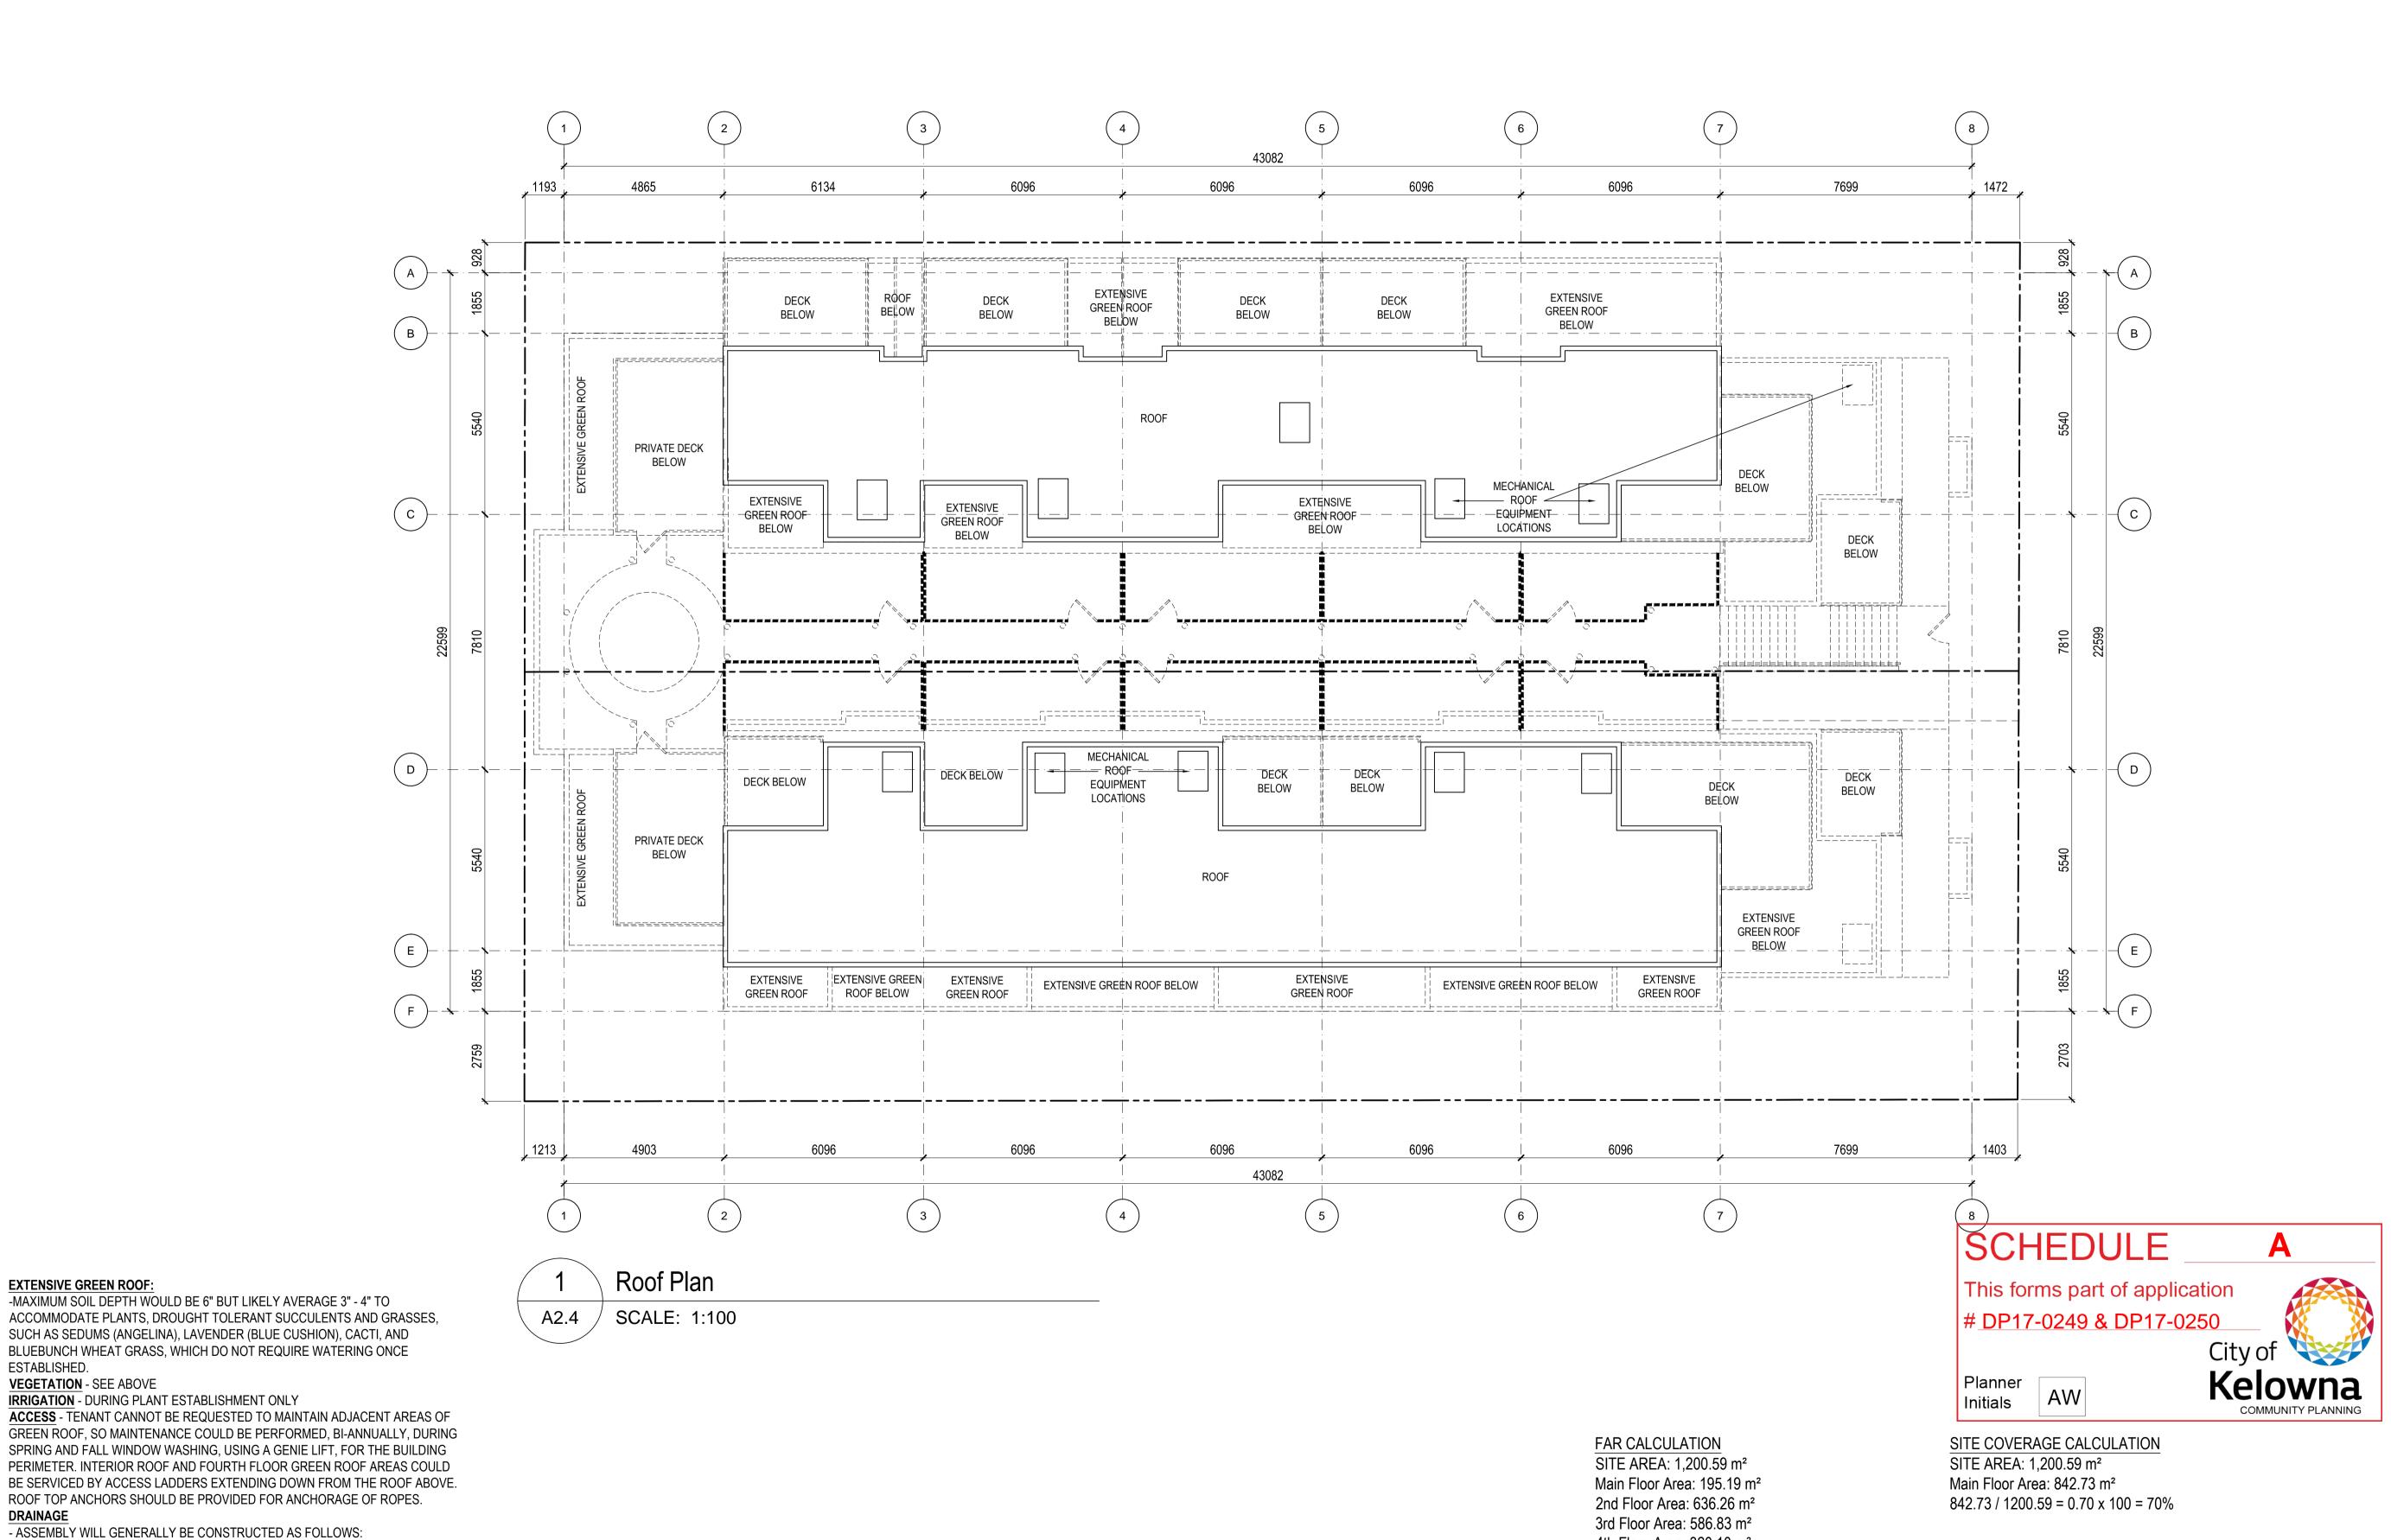

4th Floor Area: 320.10 m²

Total Net Floor Area: 1738.38 m²

1645.86/1200.59 = 1.37 F.A.R.

Allowable Deductible (50% of stairs): 92.52 m²

Total Net Floor Area - Deductible = 1645.86

EXTENSIVE GREEN ROOF:

VEGETATION - SEE ABOVE

PLANTS/GROUNDCOVER

DRAIN SHEET/DIMPLE-BOARD

2 PLY ROOFING MEMBRANE

IRRIGATION - DURING PLANT ESTABLISHMENT ONLY

ROOF DRAINS TO BE WATTS TYPE ROOF DRAINS W/ FILTER BASKET

ESTABLISHED.

DRAINAGE

TOPSOIL

ROOT BARRIER

FILTER CLOTH



P: (403) 283-6433 F: (403) 270-0714 3800 Point McKay Road NW, Calgary, Alberta, T3B 5B8

DESCRIPTION	DATE
PROJECT START	09/29/2017
DP SUBMISSION	10/27/2017

CONSULTANTS



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D.McLean Construction Ltd 1102 - 1633 West 10th Avenue

Vancouver, B.C. V6J 0B1

PROJECT -

PROJECT NAME 1304 & 1308 Richter Street Kelowna, B.C.

Roof Plan


BUILDING PERMIT BP2017-XX

DEVELOPMENT PERMIT -DP2017-XX — DRAWN BY -FILE ----

2017-12-RK HA DATE - SCALE -

2017/10/27 AS INDICATED DRAWING NUMBER -

A2.4

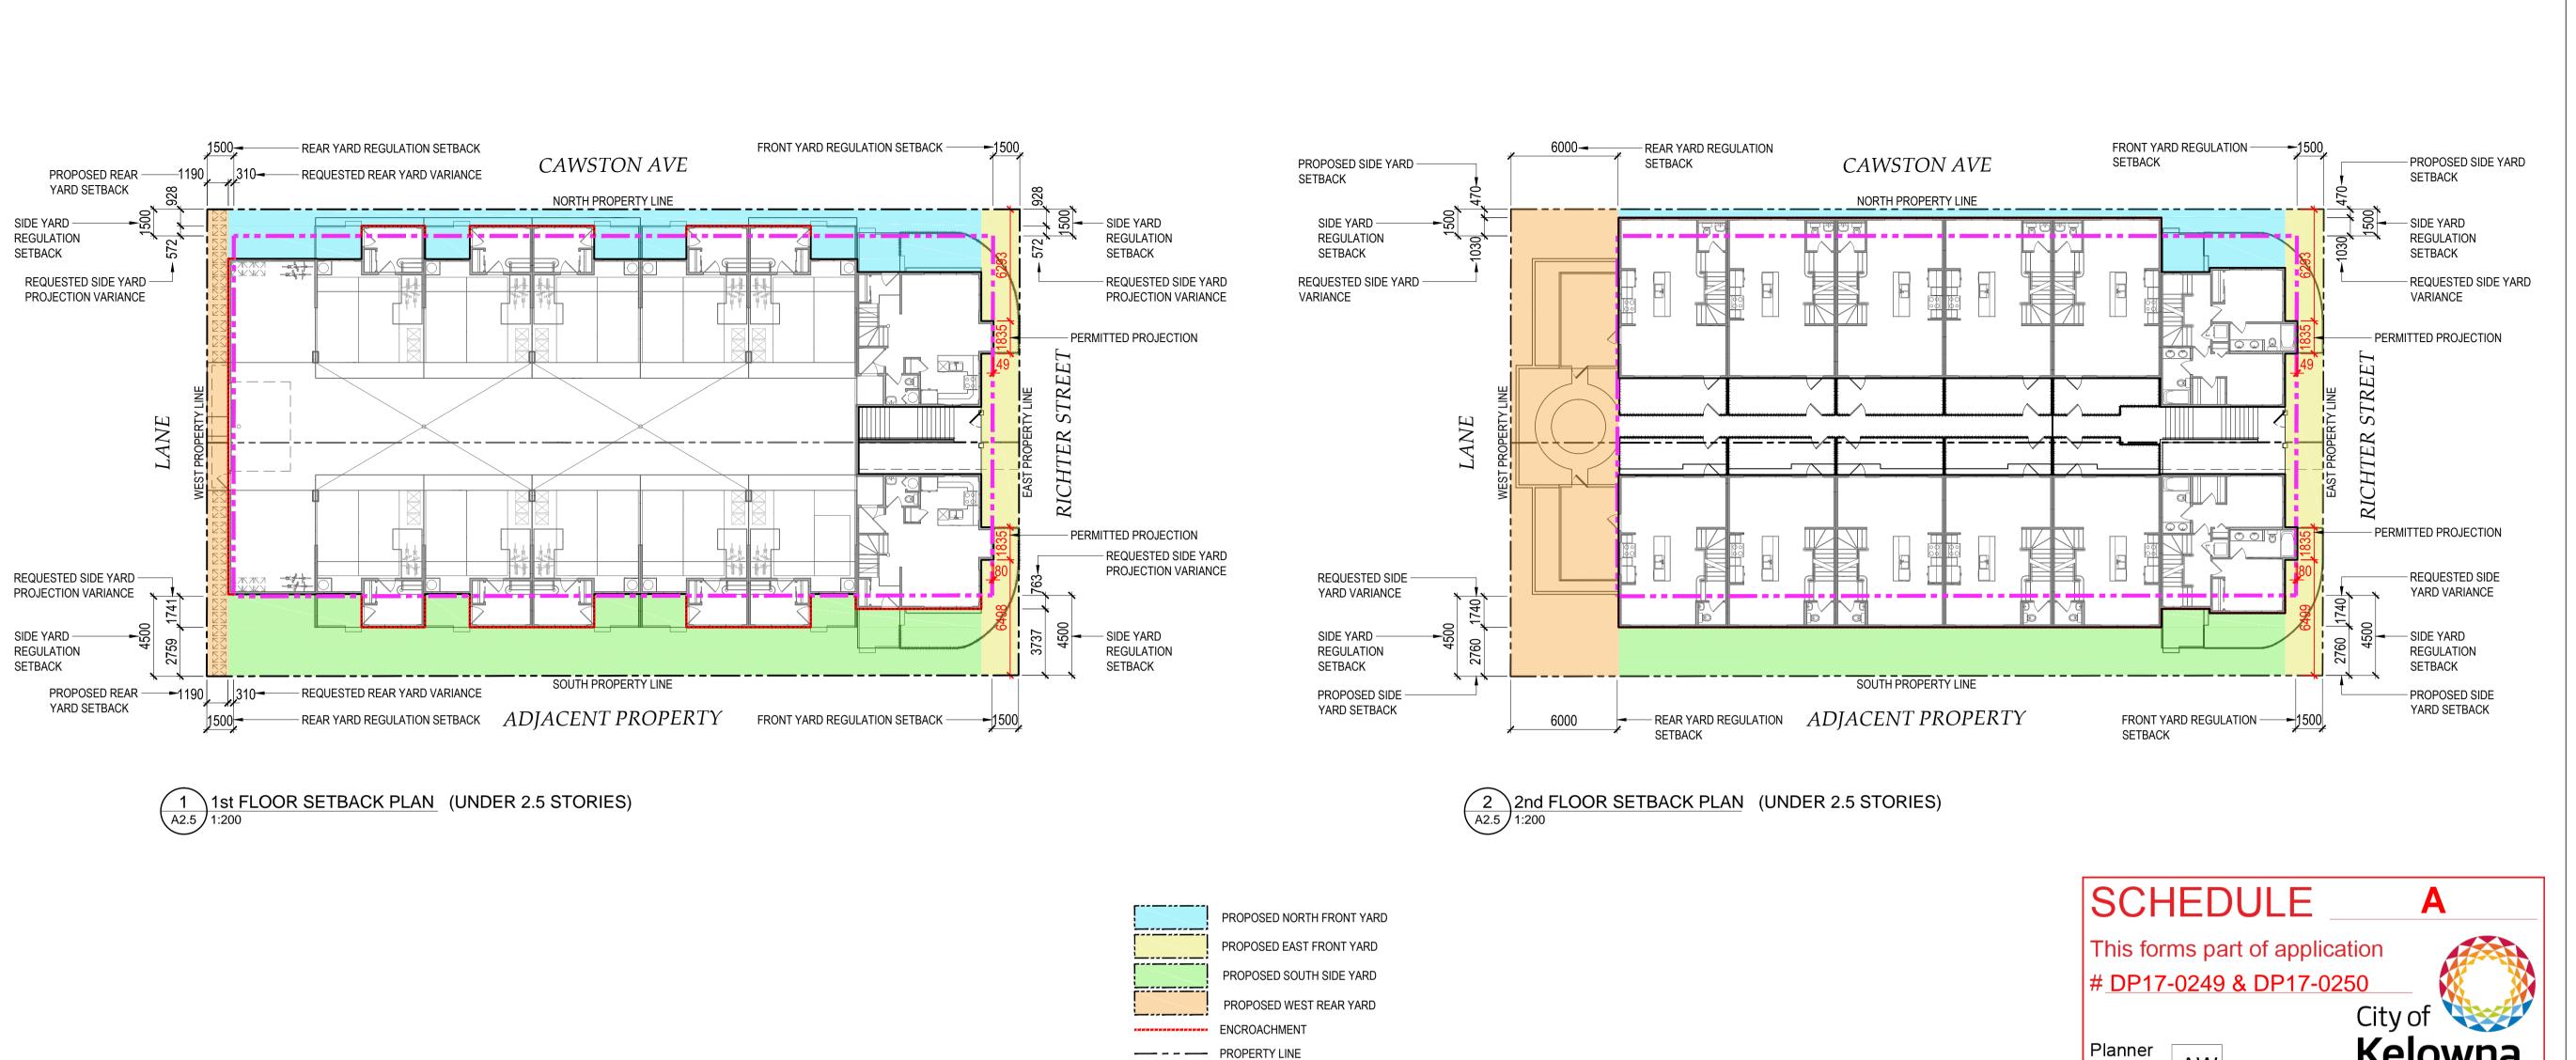

REGULATION SETBACK LINE

PROPOSED SIDE YARD SETBACK

REQUESTED SIDE YARD

PROPOSED SIDE

YARD SETBACK

— SIDE YARD

SETBACK

VARIANCE

REQUESTED SIDE

YARD VARIANCE

- SIDE YARD

SETBACK

REGULATION

- PROPOSED SIDE

YARD SETBACK

PROPOSED FRONT YARD SETBACK

REGULATION

FRONT YARD REGULATION -

REQUESTED FRONT -

YARD VARIANCE

-1749

4251

4181

6000

SETBACK

SOUTH PROPERTY LINE

YARD VARIANCE

FRONT YARD -

REGULATION SETBACK

CAWSTON AVE

NORTH PROPERTY LINE

REAR YARD REGULATION $ADJACENT\ PROPERTY$

REAR YARD REGULATION

SETBACK

3 3rd FLOOR SETBACK PLAN (OVER 2.5 STORIES)

PROPOSED SIDE YARD -

SIDE YARD

SETBACK

VARIANCE

REGULATION

REQUESTED SIDE YARD -

REQUESTED SIDE

YARD VARIANCE

SIDE YARD

SETBACK

REGULATION

PROPOSED SIDE

YARD SETBACK

SETBACK



DESCRIPTION	DATE
PROJECT START	09/29/2017
DP SUBMISSION	10/27/2017

CONSULTANTS



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Vancouver, B.C.
V6J 0B1

PROJECT
PROJECT NAME
1304 & 1308 Richter Street
Kelowna, B.C.

DRAWING
Setback Plan

BUILDING PERMIT

BP2017-XX

DEVELOPMENT PERMIT

DP2017-XX


FILE ______ DRAWN BY ______

2017-12-RK HA

DATE _____ SCALE

A2.5


2017/10/27 AS INDICATED

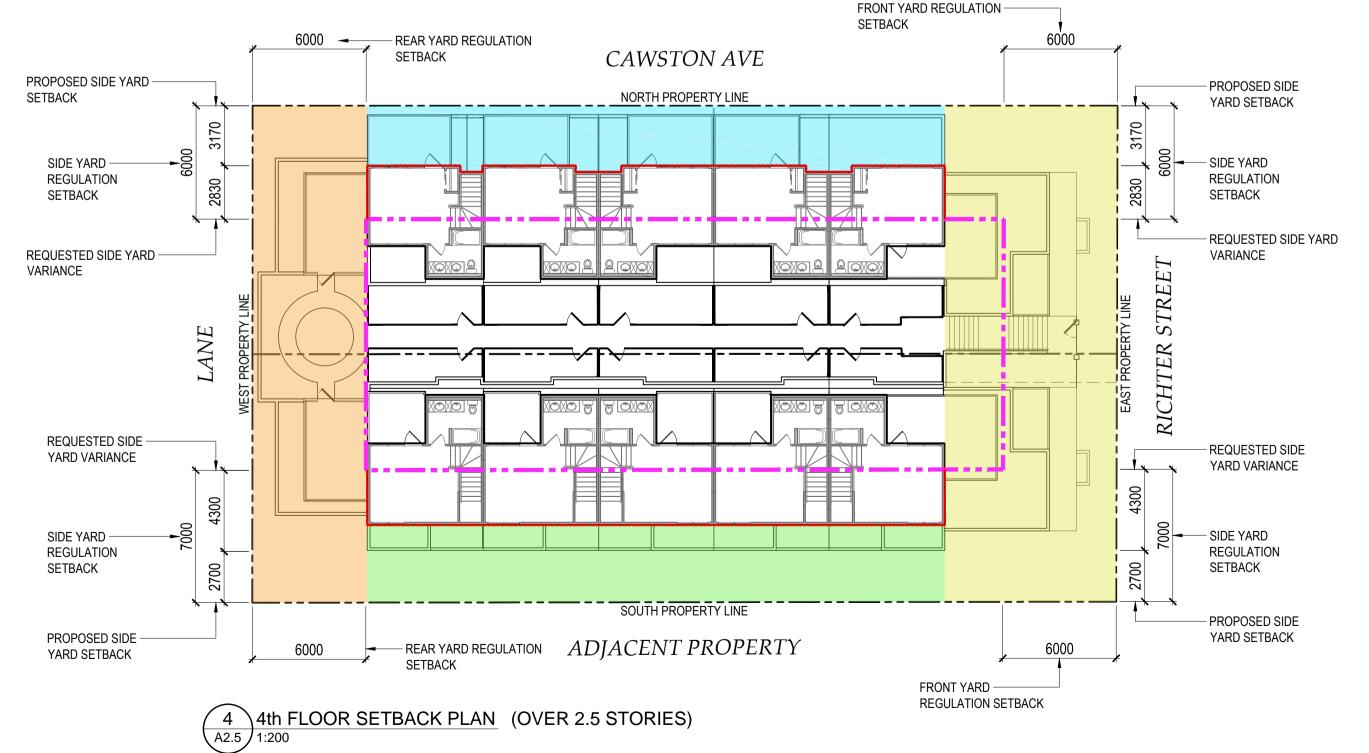

AW

COMMUNITY PLANNING

Initials

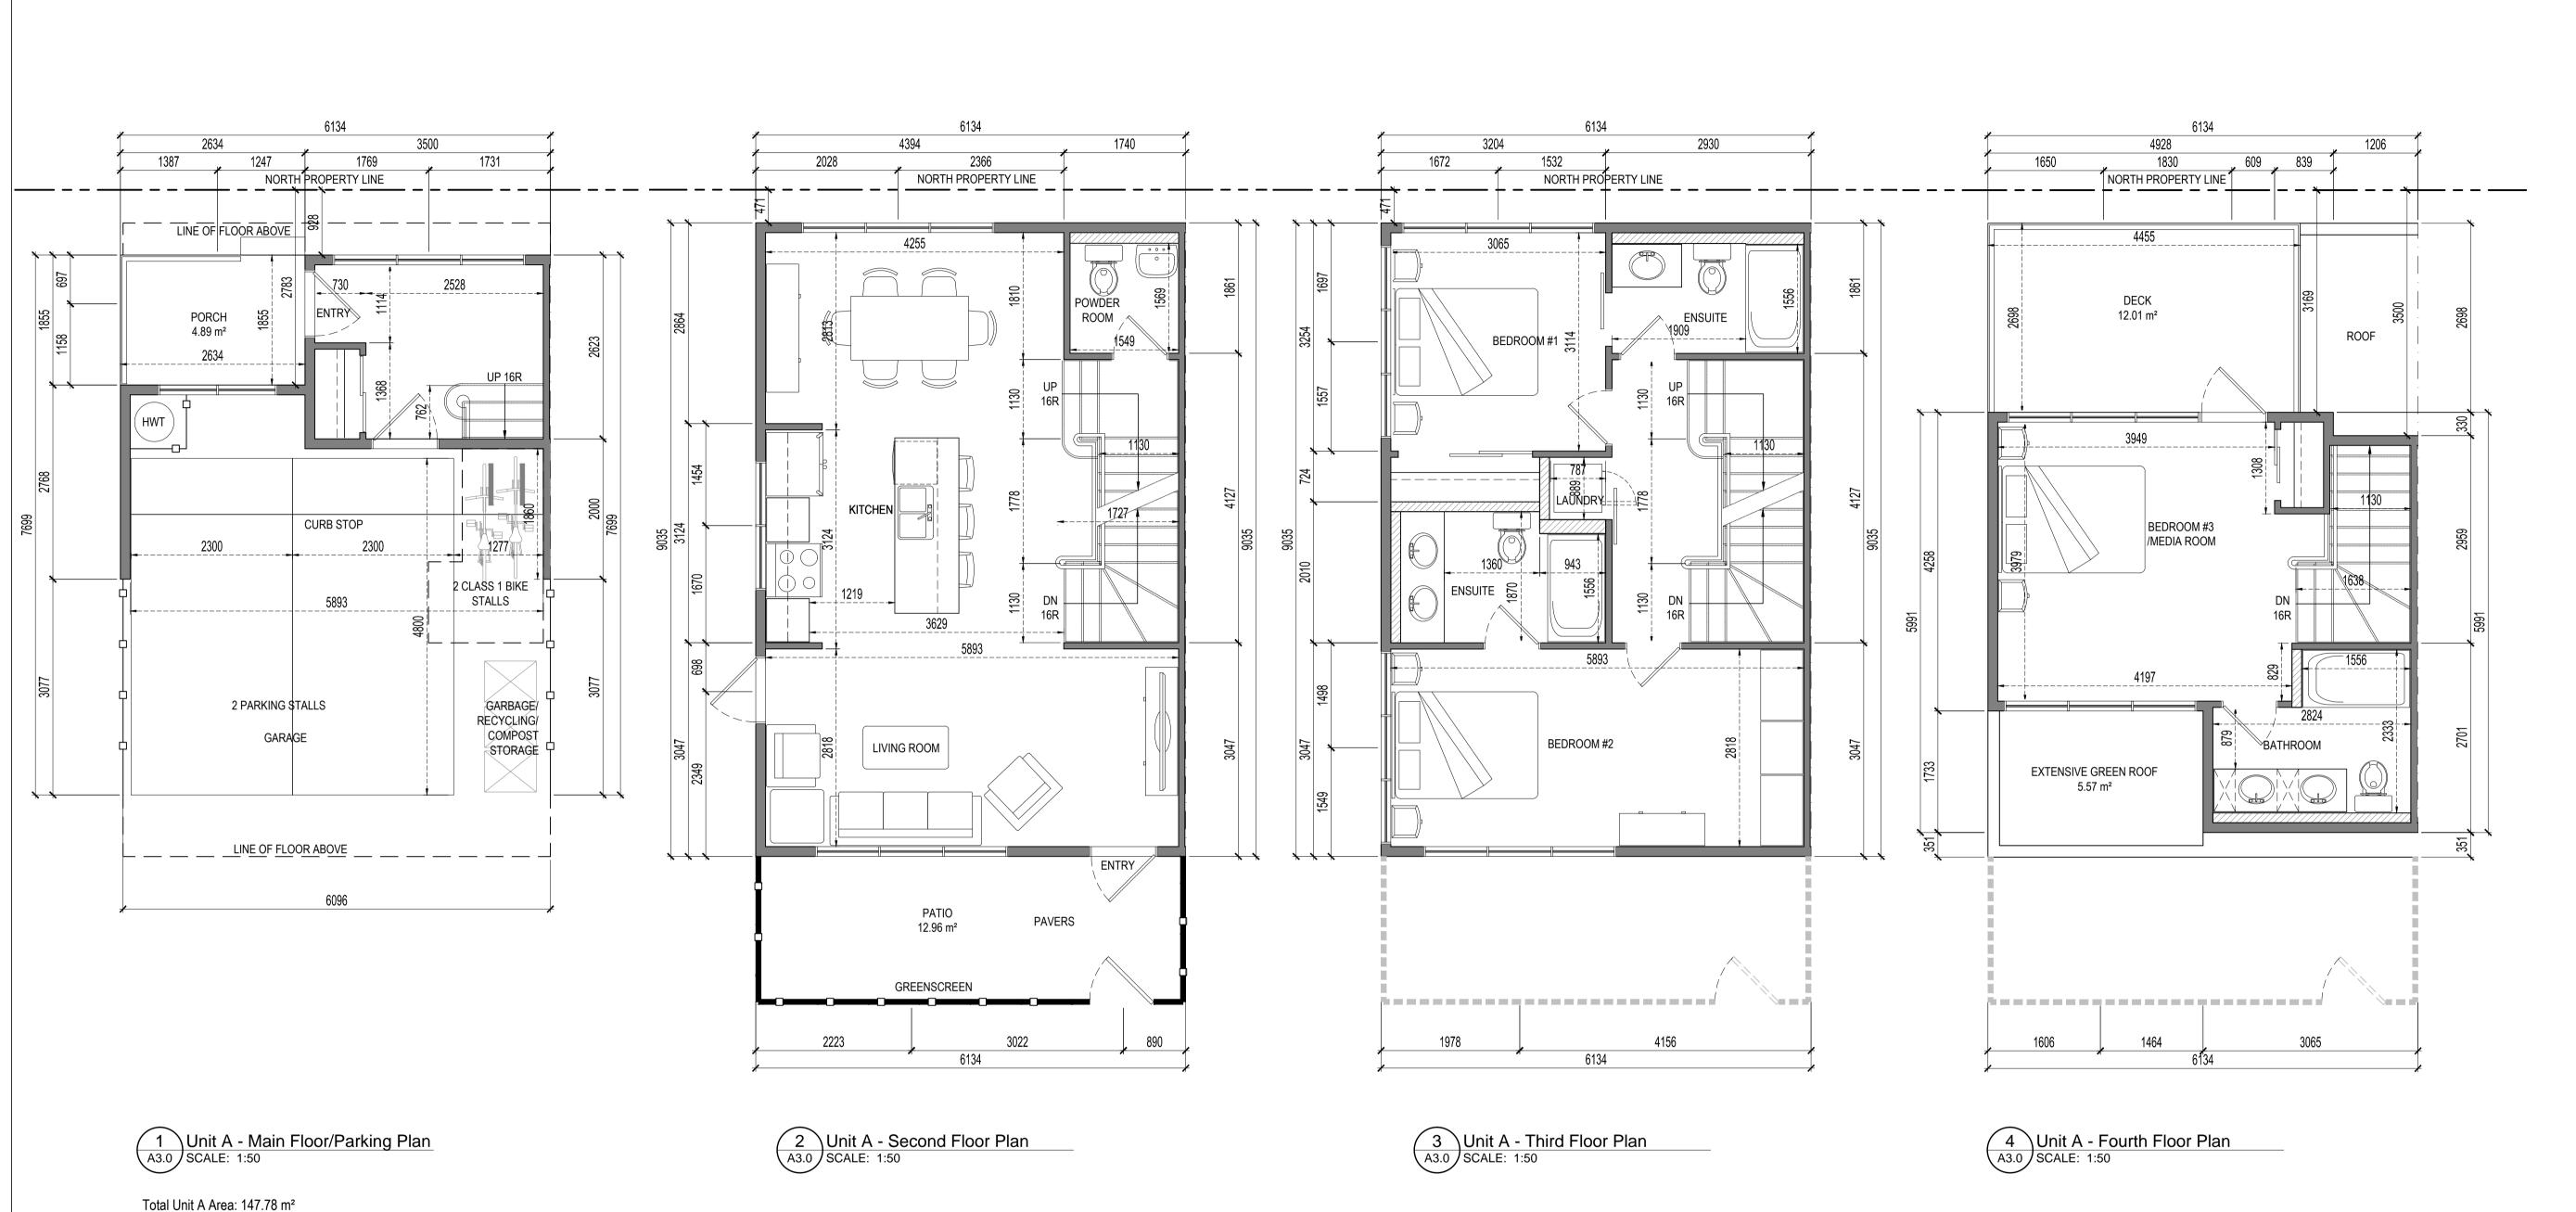



DESCRIPTION DATE PROJECT START 09/29/2017 **DP SUBMISSION** 10/27/2017

CONSULTANTS



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CLIENT ---D.McLean Construction Ltd 1102 - 1633 West 10th Avenue Vancouver, B.C. V6J 0B1

PROJECT ----PROJECT NAME

1304 & 1308 Richter Street Kelowna, B.C.

Unit Type A Floor Plans

BUILDING PERMIT -BP2017-XX


DEVELOPMENT PERMIT -DP2017-XX

FILE — DRAWN BY — 2017-12-RK НА DATE — SCALE — 2017/10/27 AS INDICATED

DRAWING NUMBER -A3.0

SCHEDULE This forms part of application # DP17-0249 & DP17-0250 Kelowna COMMUNITY PLANNING

Planner AW Initials

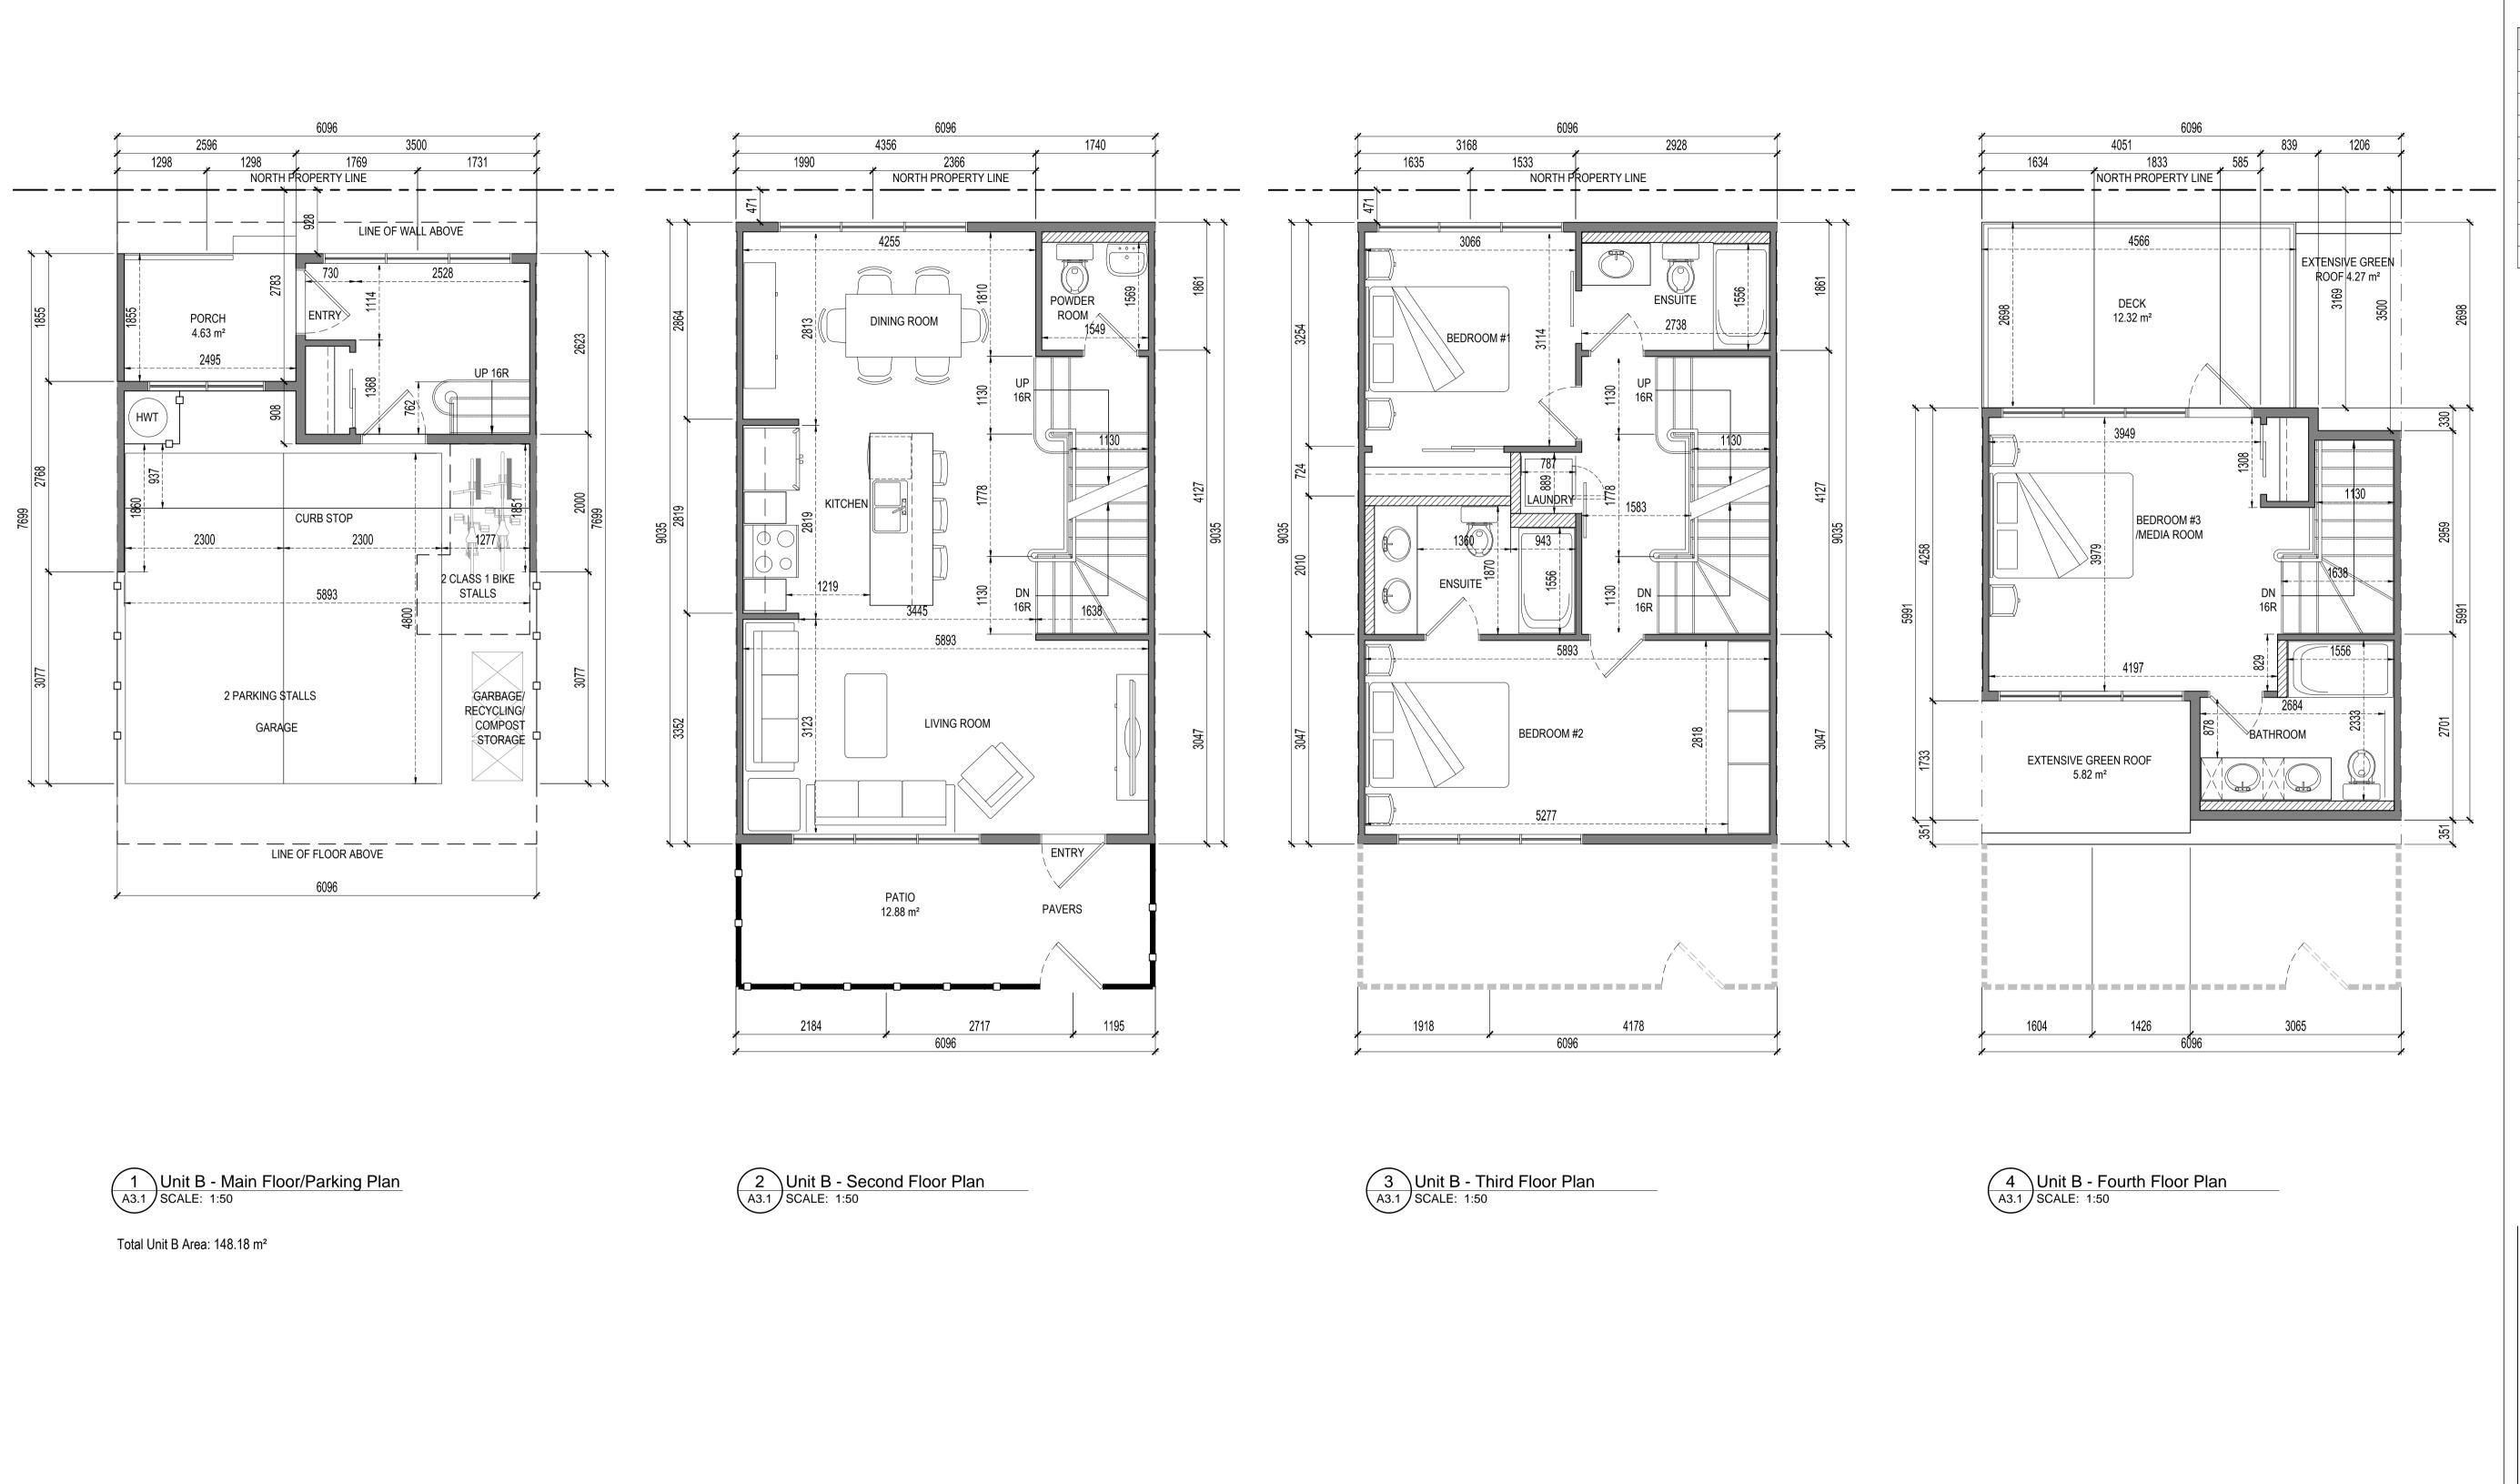

P: (403) 283-6433 F: (403) 270-0714 C: (403) 971-0254 E: dwatkin@davidwatkinarchitect.com

3800 Point McKay Road NW, Calgary, Alberta, T3B 5B8

DESCRIPTION	DATE
PROJECT START	09/29/2017
DP SUBMISSION	10/27/2017

CONSULTANTS



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D.McLean Construction Ltd 1102 - 1633 West 10th Avenue Vancouver, B.C. V6J 0B1

PROJECT -

PROJECT NAME 1304 & 1308 Richter Street Kelowna, B.C.

Unit Type B Floor Plans

BUILDING PERMIT — BP2017-XX

SCHEDULE

AW

Planner

Initials

This forms part of application

City of


<u>DP17-0249 & DP17-0250</u>

DEVELOPMENT PERMIT -DP2017-XX

FILE — DRAWN BY — 2017-12-RK HA DATE — SCALE —


2017/10/27 AS INDICATED DRAWING NUMBER -

A3.1

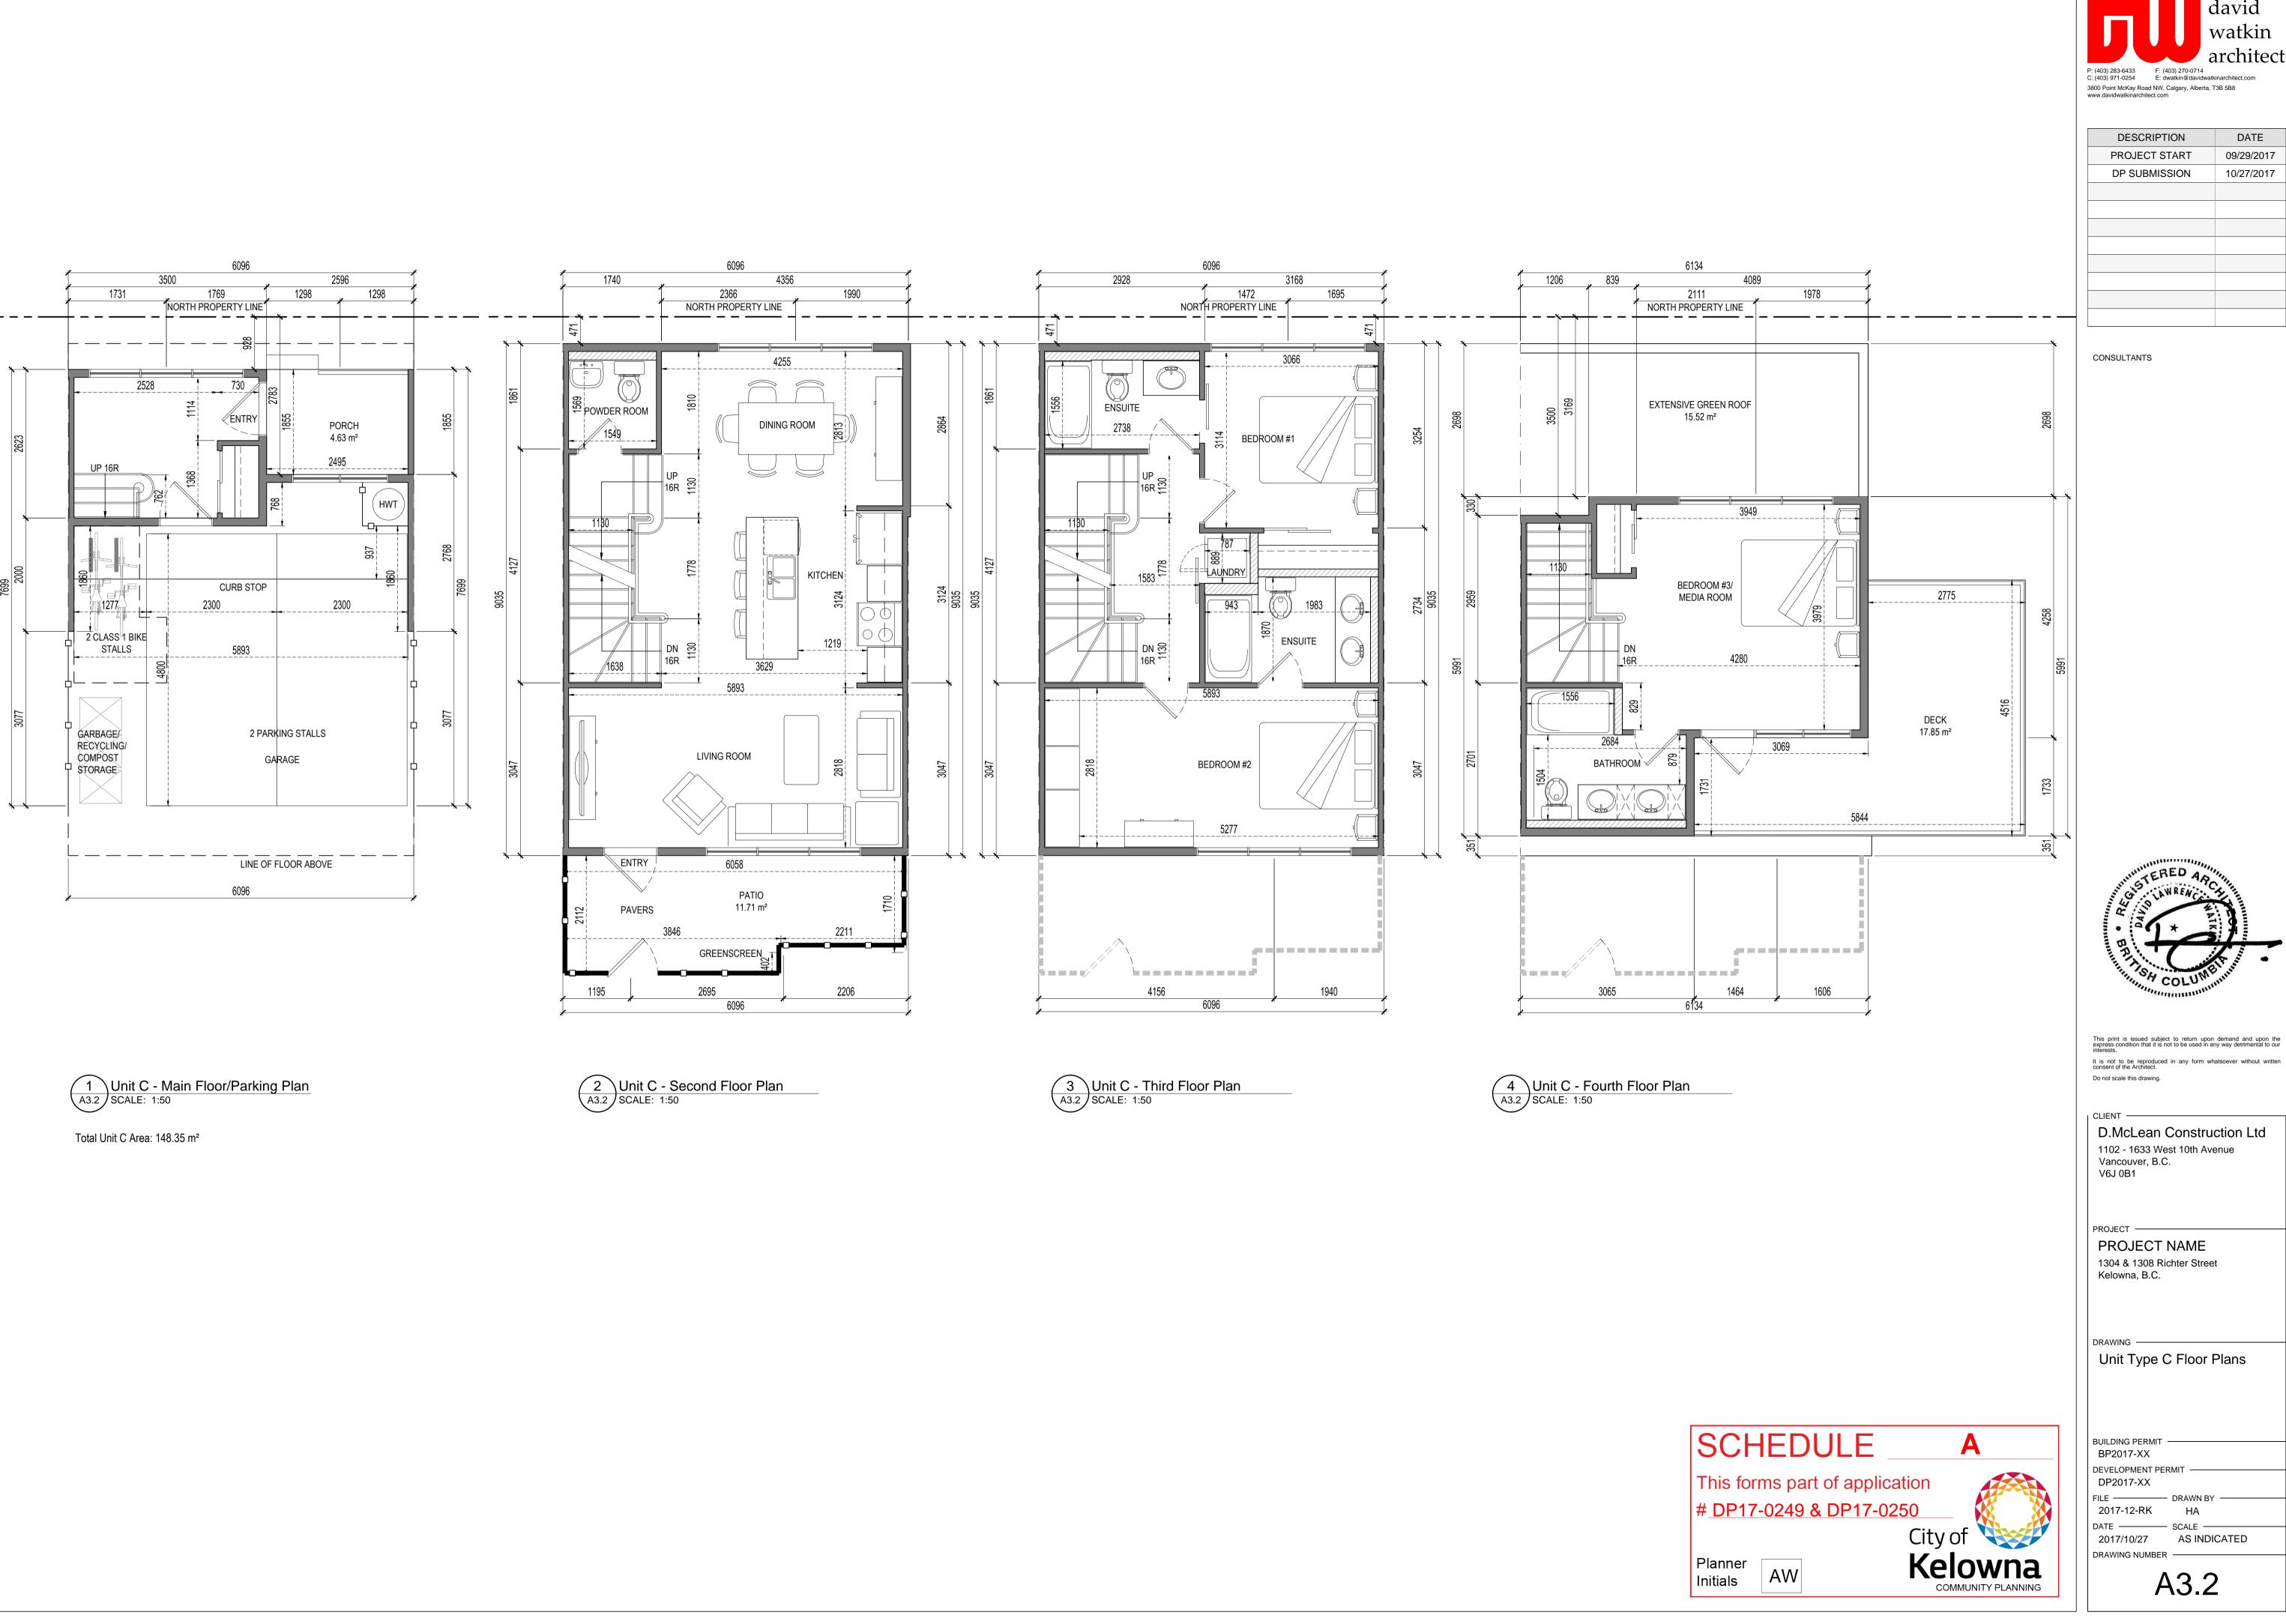

DESCRIPTION	DATE
PROJECT START	09/29/2017
DP SUBMISSION	10/27/2017



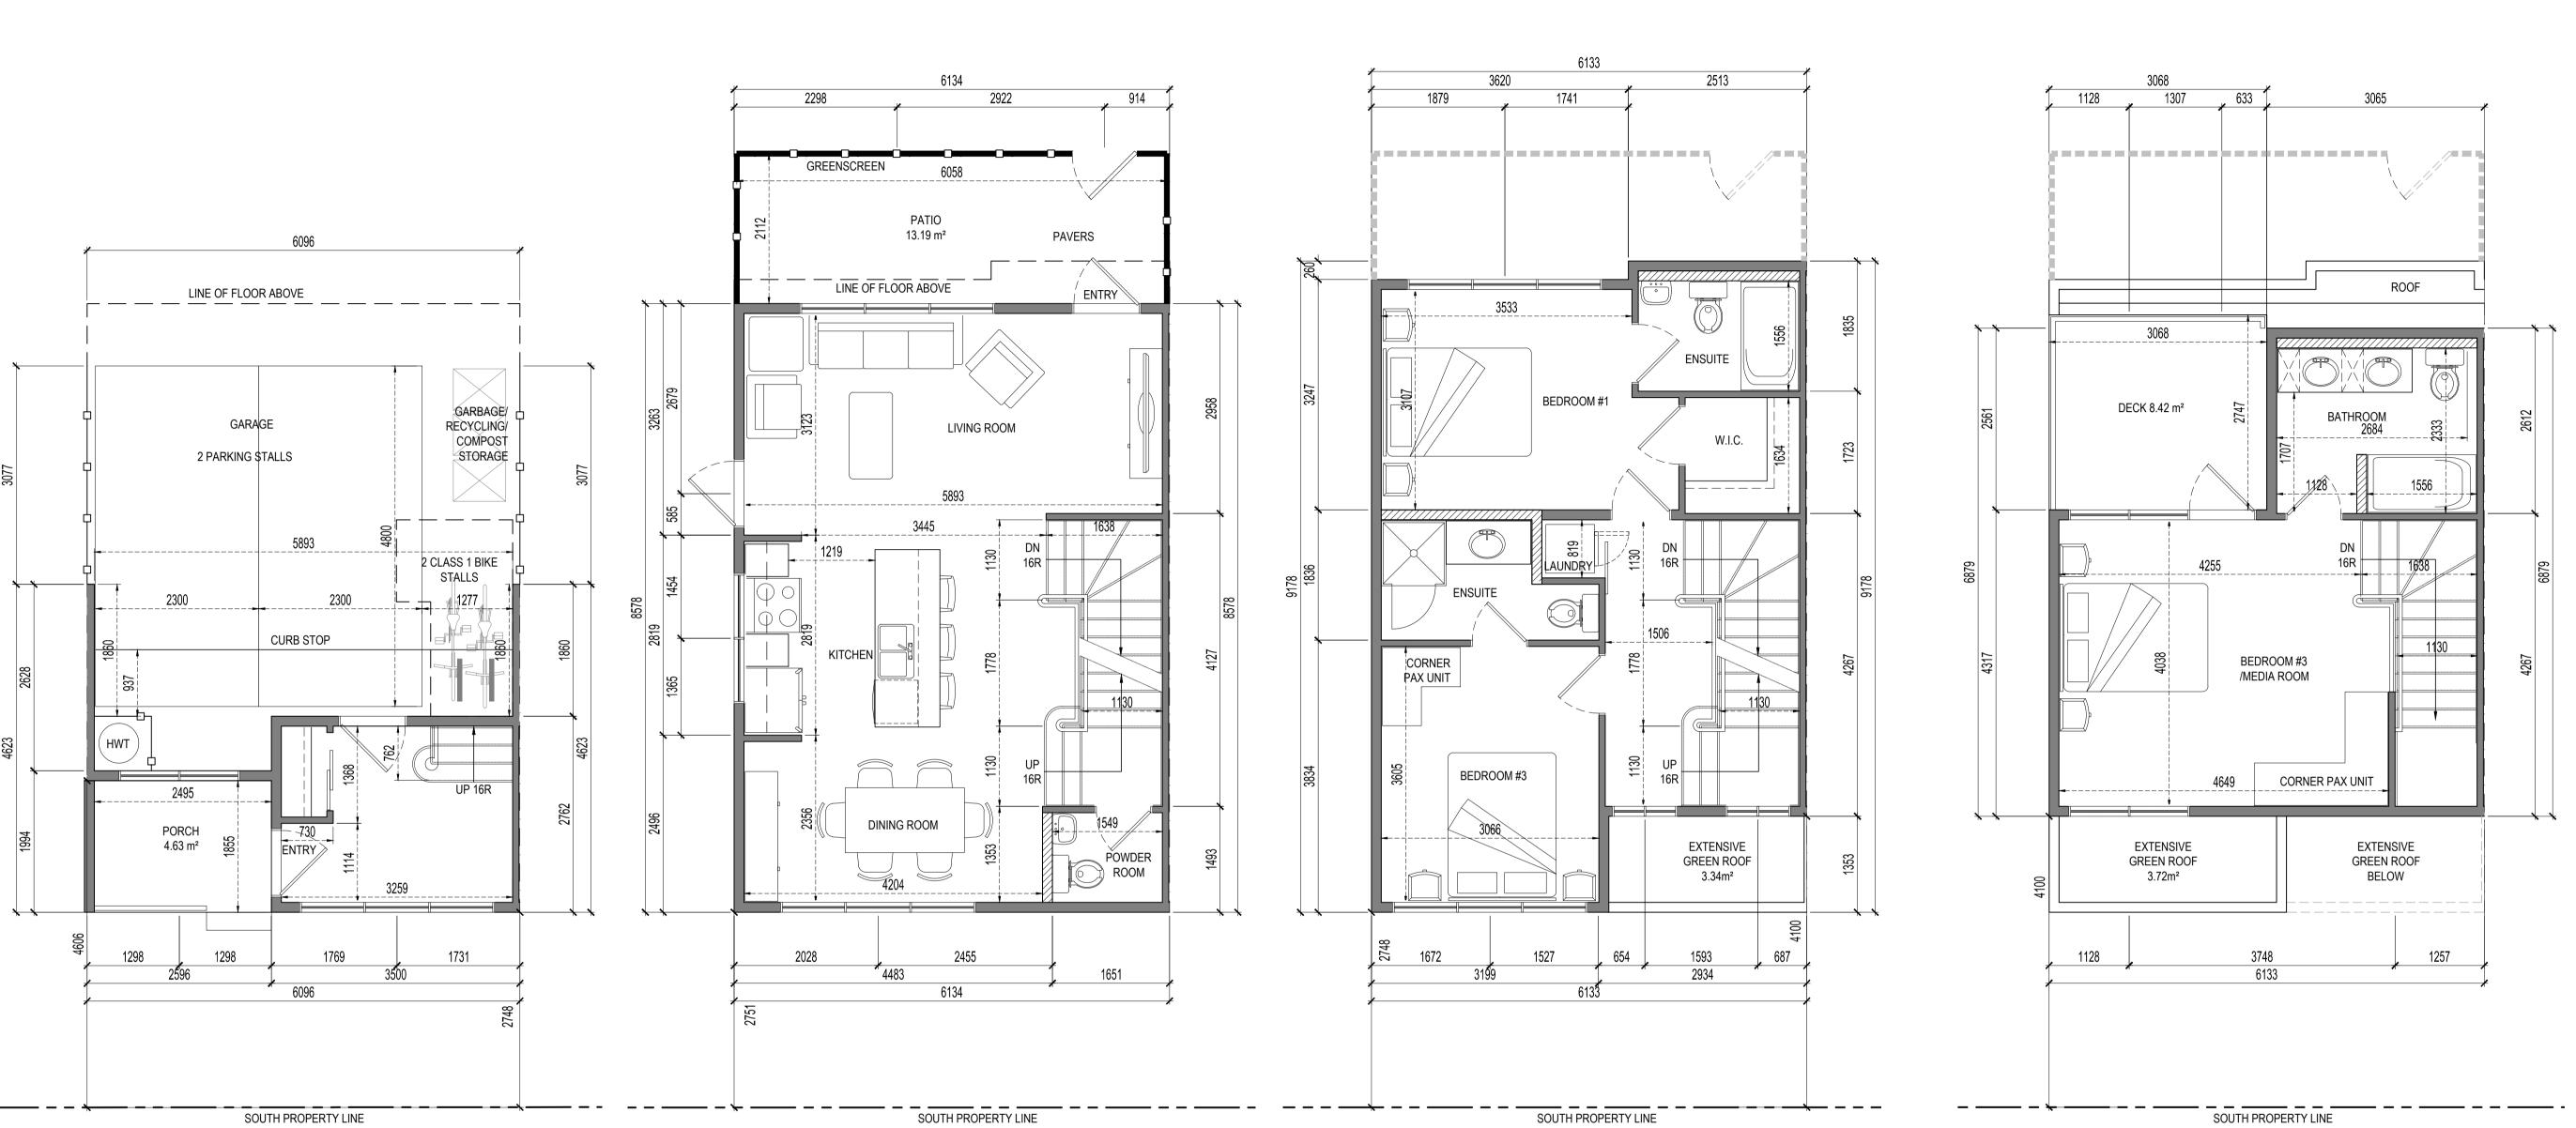

2 Unit D - Second Floor Plan SCALE: 1:50

1 Unit D - Main Floor/Parking Plan SCALE: 1:50

Total Unit D Area: 145.17 m²

P: (403) 283-6433 F: (403) 270-0714 C: (403) 971-0254 E: dwatkin@davidwatkinarchitect.com 3800 Point McKay Road NW, Calgary, Alberta, T3B 5B8

DESCRIPTION DATE 09/29/2017 PROJECT START **DP SUBMISSION** 10/27/2017

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PROJECT -PROJECT NAME 1304 & 1308 Richter Street Kelowna, B.C.

Unit Type D Floor Plans

BUILDING PERMIT -BP2017-XX DEVELOPMENT PERMIT -DP2017-XX FILE -2017-12-RK HA DATE ———— SCALE — 2017/10/27 AS INDICATED


> DRAWING NUMBER -A3.3

SCHEDULE

4 Unit D - Fourth Floor Plan SCALE: 1:50



3 Unit D - Third Floor Plan A3.3 SCALE: 1:50

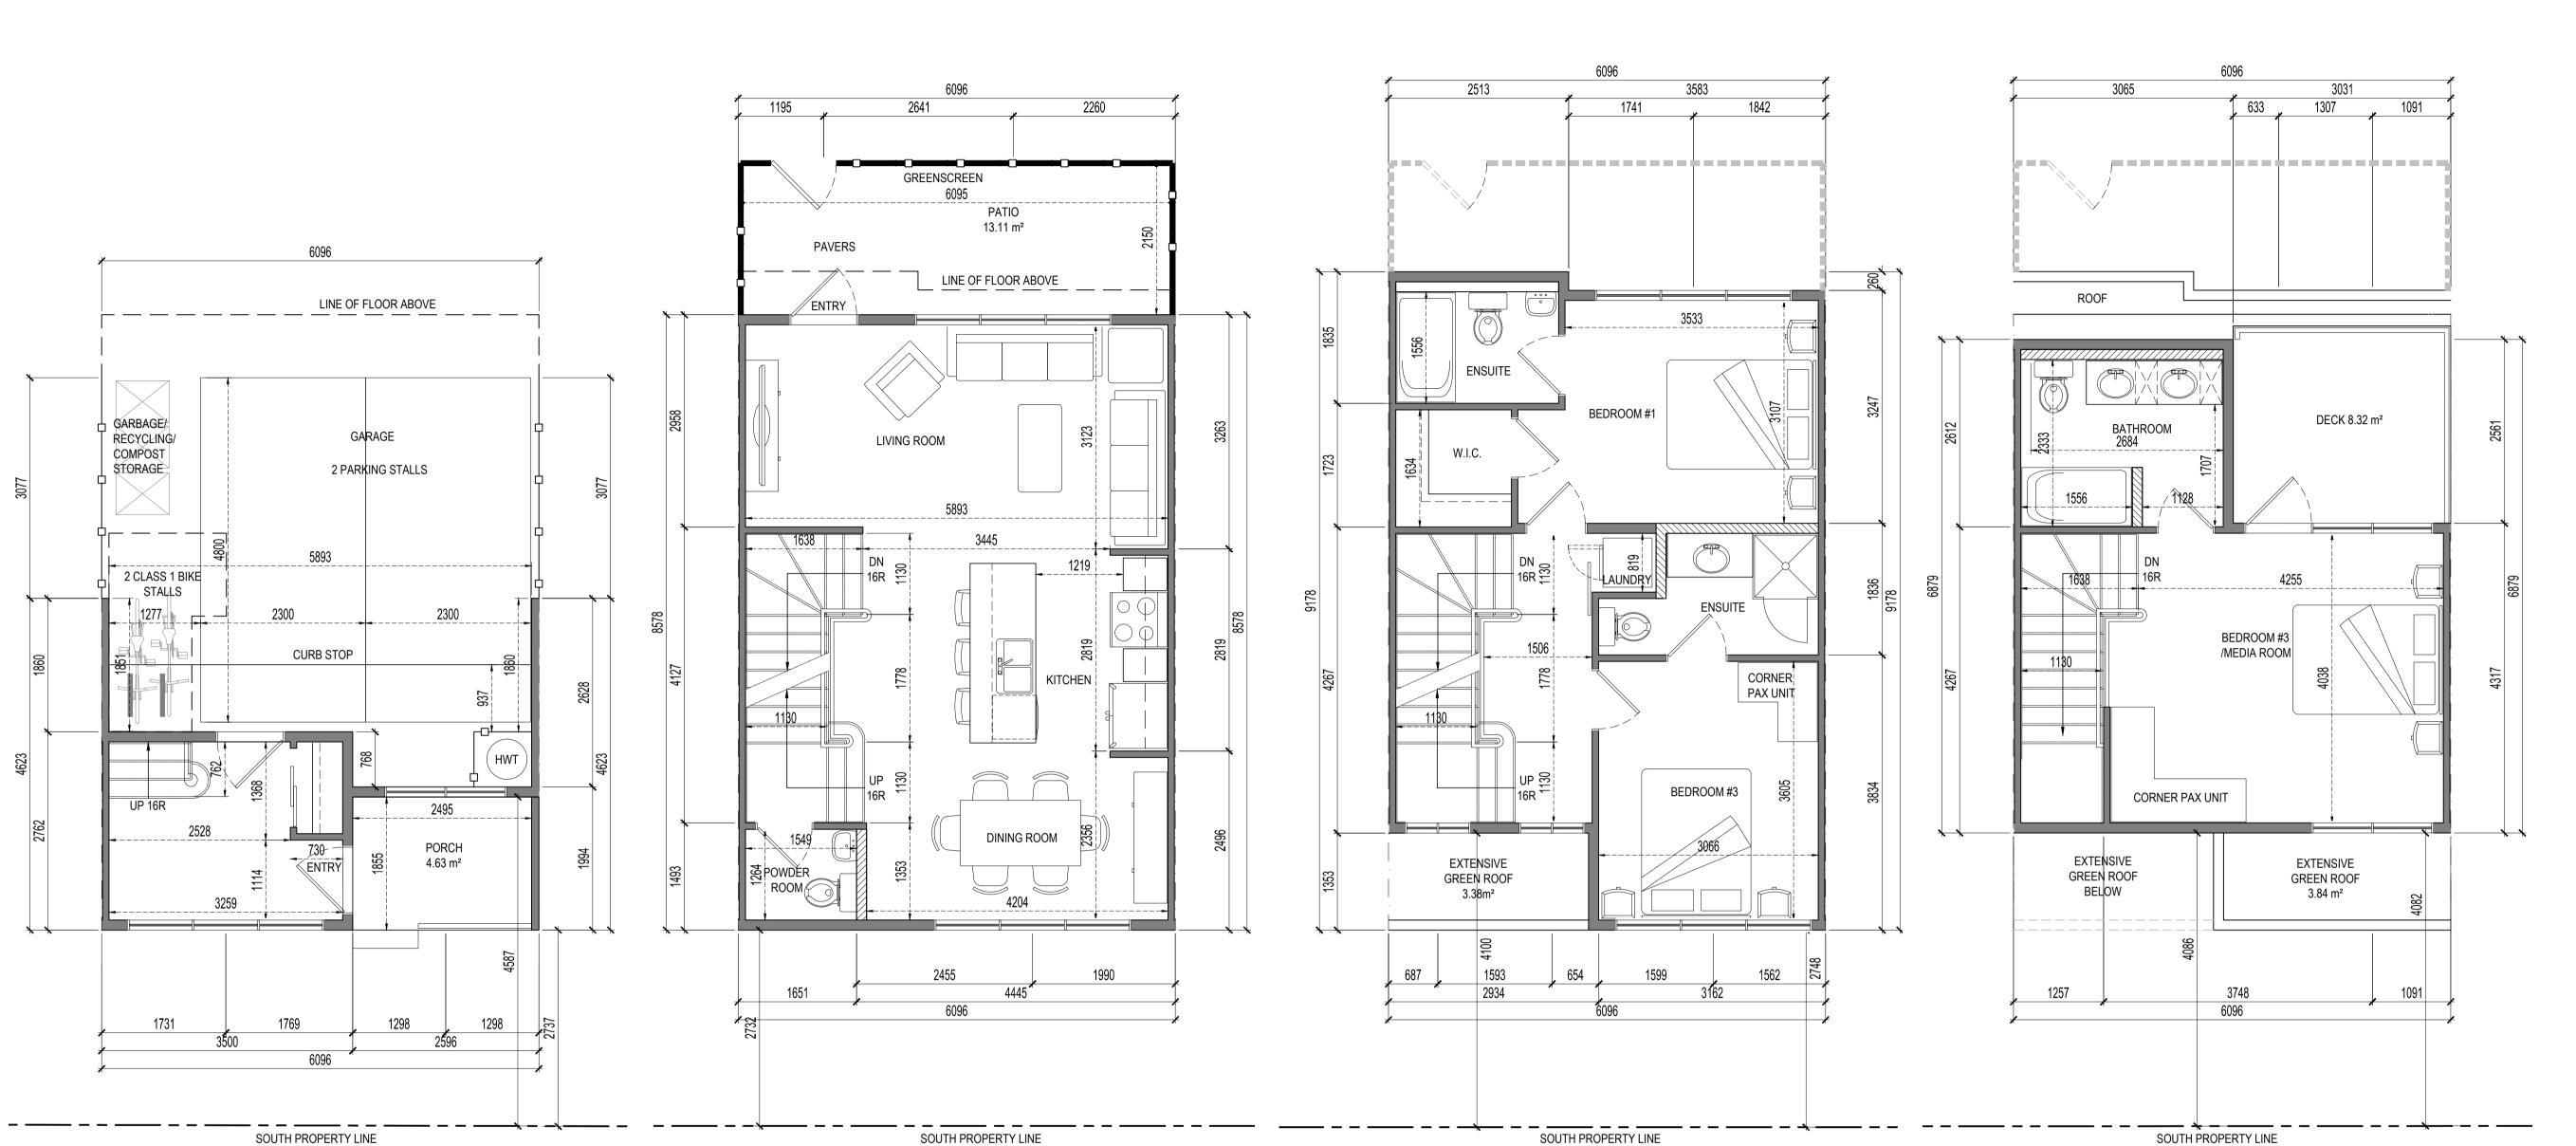

david watkin archited

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C: (403) 971-0254

F: (403) 270-0714
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3800 Point McKay Road NW, Calgary, Alberta, T3B 5B8

DESCRIPTION DATE
PROJECT START 09/29/2017
DP SUBMISSION 10/27/2017

CONSULTANTS

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PROJECT NAME

1304 & 1308 Richter Street Kelowna, B.C.

DRAWING ----

Unit Type E Floor Plans

BUILDING PERMIT

BP2017-XX

DEVELOPMENT PERMIT —

DP2017-XX

FILE — DRAW

2017-12-RK HA

DRAWING NUMBER -

A3.4

Unit E - Second Floor Plan SCALE: 1:50 3 Unit E - Third Floor Plan SCALE: 1:50

SCHEDULE _

This forms part of application
DP17-0249 & DP17-0250

Planner Initials AW

4 Unit E - Fourth Floor Plan SCALE: 1:50



1 Unit E - Main Floor/Parking Plan
SCALE: 1:50

Total Unit E Area: 147.37 m²


1:50





DESCRIPTION	DATE
PROJECT START	09/29/2017
DP SUBMISSION	10/27/2017

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CLIENT ---D.McLean Construction Ltd 1102 - 1633 West 10th Avenue

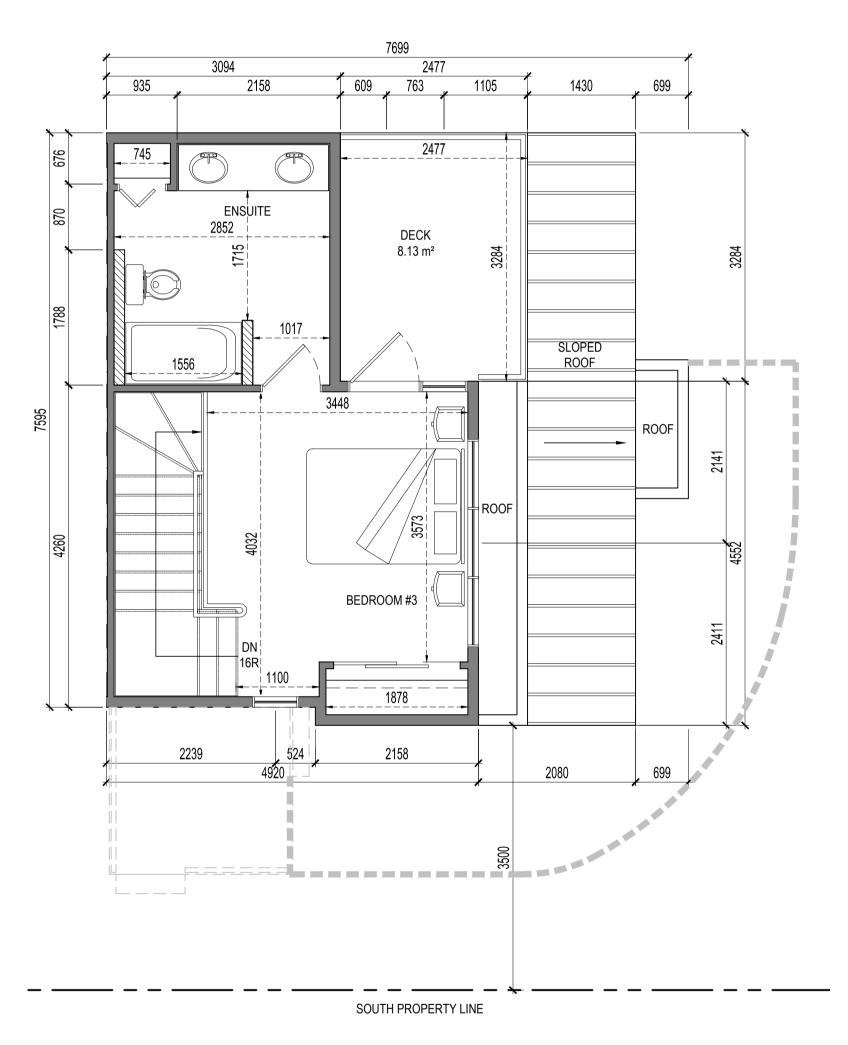PROJECT ----

Vancouver, B.C.

V6J 0B1


PROJECT NAME 1304 & 1308 Richter Street Kelowna, B.C.


Unit Type G Floor Plans

BUILDING PERMIT -BP2017-XX DEVELOPMENT PERMIT -DP2017-XX

FILE — DRAWN BY — 2017-12-RK HA DATE ———— SCALE — 2017/10/27 AS INDICATED

DRAWING NUMBER -A3.6

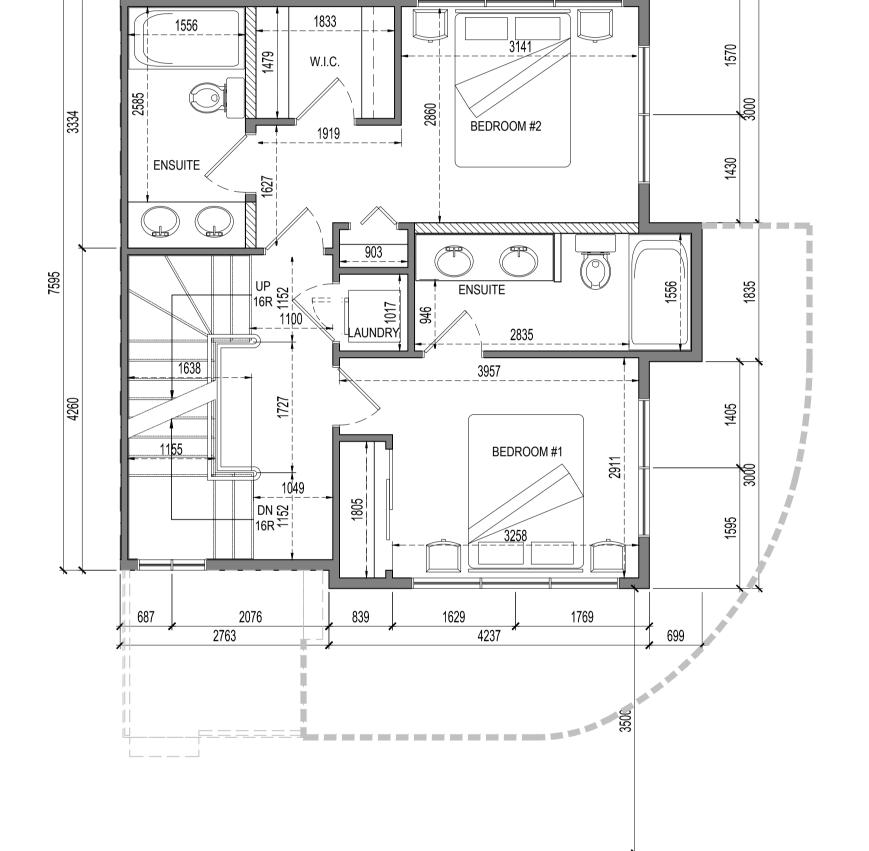

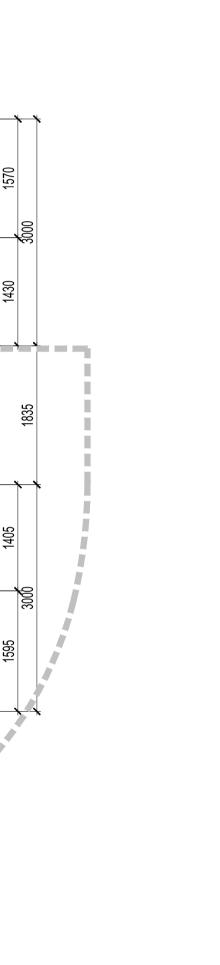

1 Unit G - Main Floor Plan A3.6 SCALE: 1:50

SOUTH PROPERTY LINE

5514

LINE OF FLOOR ABOVE

1614

DINING ROOM

1852

(LIVING ROOM)

PATIO 19.01 m²

Total Unit G Area: 139.18 m²

1003

PORCH

5.28 m²

2388

800

2 Unit G - Second Floor Plan SCALE: 1:50

SOUTH PROPERTY LINE

This forms part of application City of Kelowna COMMUNITY PLANNING

SCHEDULE

DP17-0249 & DP17-0250


Planner AW Initials

3 Unit G - Third Floor Plan SCALE: 1:50








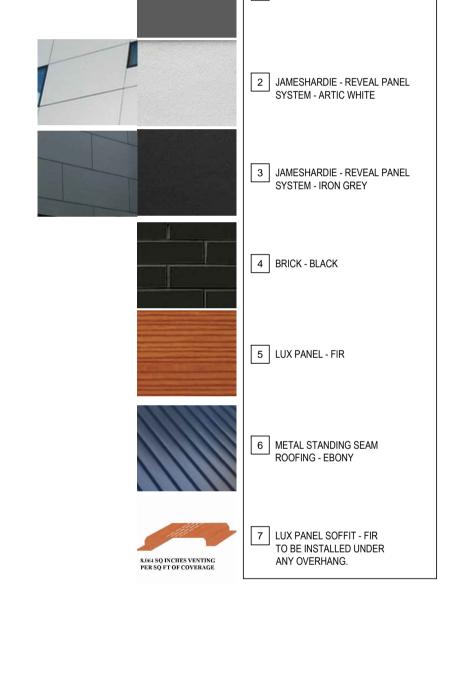

FINISH LEGEND

1 METAL FLASHING - CHARCOAL

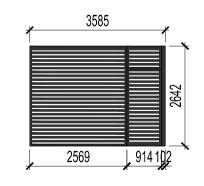

3 Fence & Gate Elevation A4.1 SCALE: 1:100

SCHEDULE

Planner Initials

This forms part of application

2017-04-KR 05/30/2017

DP17-0249 & DVP17-0250 City of Kelowna COMMUNITY PLANNING

B

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REVISION PROJECT START

DP APPLICATION

03/03/2017

05/30/2017



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Avenue on Cawston
1304 & 1308 Richter Street
Kelowna, BC

Innocept Development & Real Estate Outsourcing 1240 Industrial Road Kelowna, BC

Elevations

BUILDING PERMIT -DEVELOPMENT PERMIT -

AS INDICATED DRAWING NUMBER -

DRAWN BY -

A4.1







2 Southeast Rendering
A4.2 SCALE: NTS

TEDULE B

orms part of application

17-0249 & DVP17-0250

Planner Initials AW City of Kelowna COMMUNITY PLANNING

	NO.	REVISION	DATE
	1	PROJECT START	03/03/2017
	2	DP APPLICATION	05/30/2017
	3		
	4		
	5		
	6		
	7		
	8		
	9		
	10		

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Avenue on Cawston
1304 & 1308 Richter Street
Kelowna, BC

LIENT -

Innocept Development & Real Estate Outsourcing

1240 Industrial Road
Kelowna, BC

RAWING ————

Renderings

BUILDING PERMIT

DEVELOPMENT PERMIT

-FILE DRAW

DATE

2017-04-KR


DATE

05/30/2017

DRAWING NUMBER

DRAWING NUMBER

A4.2

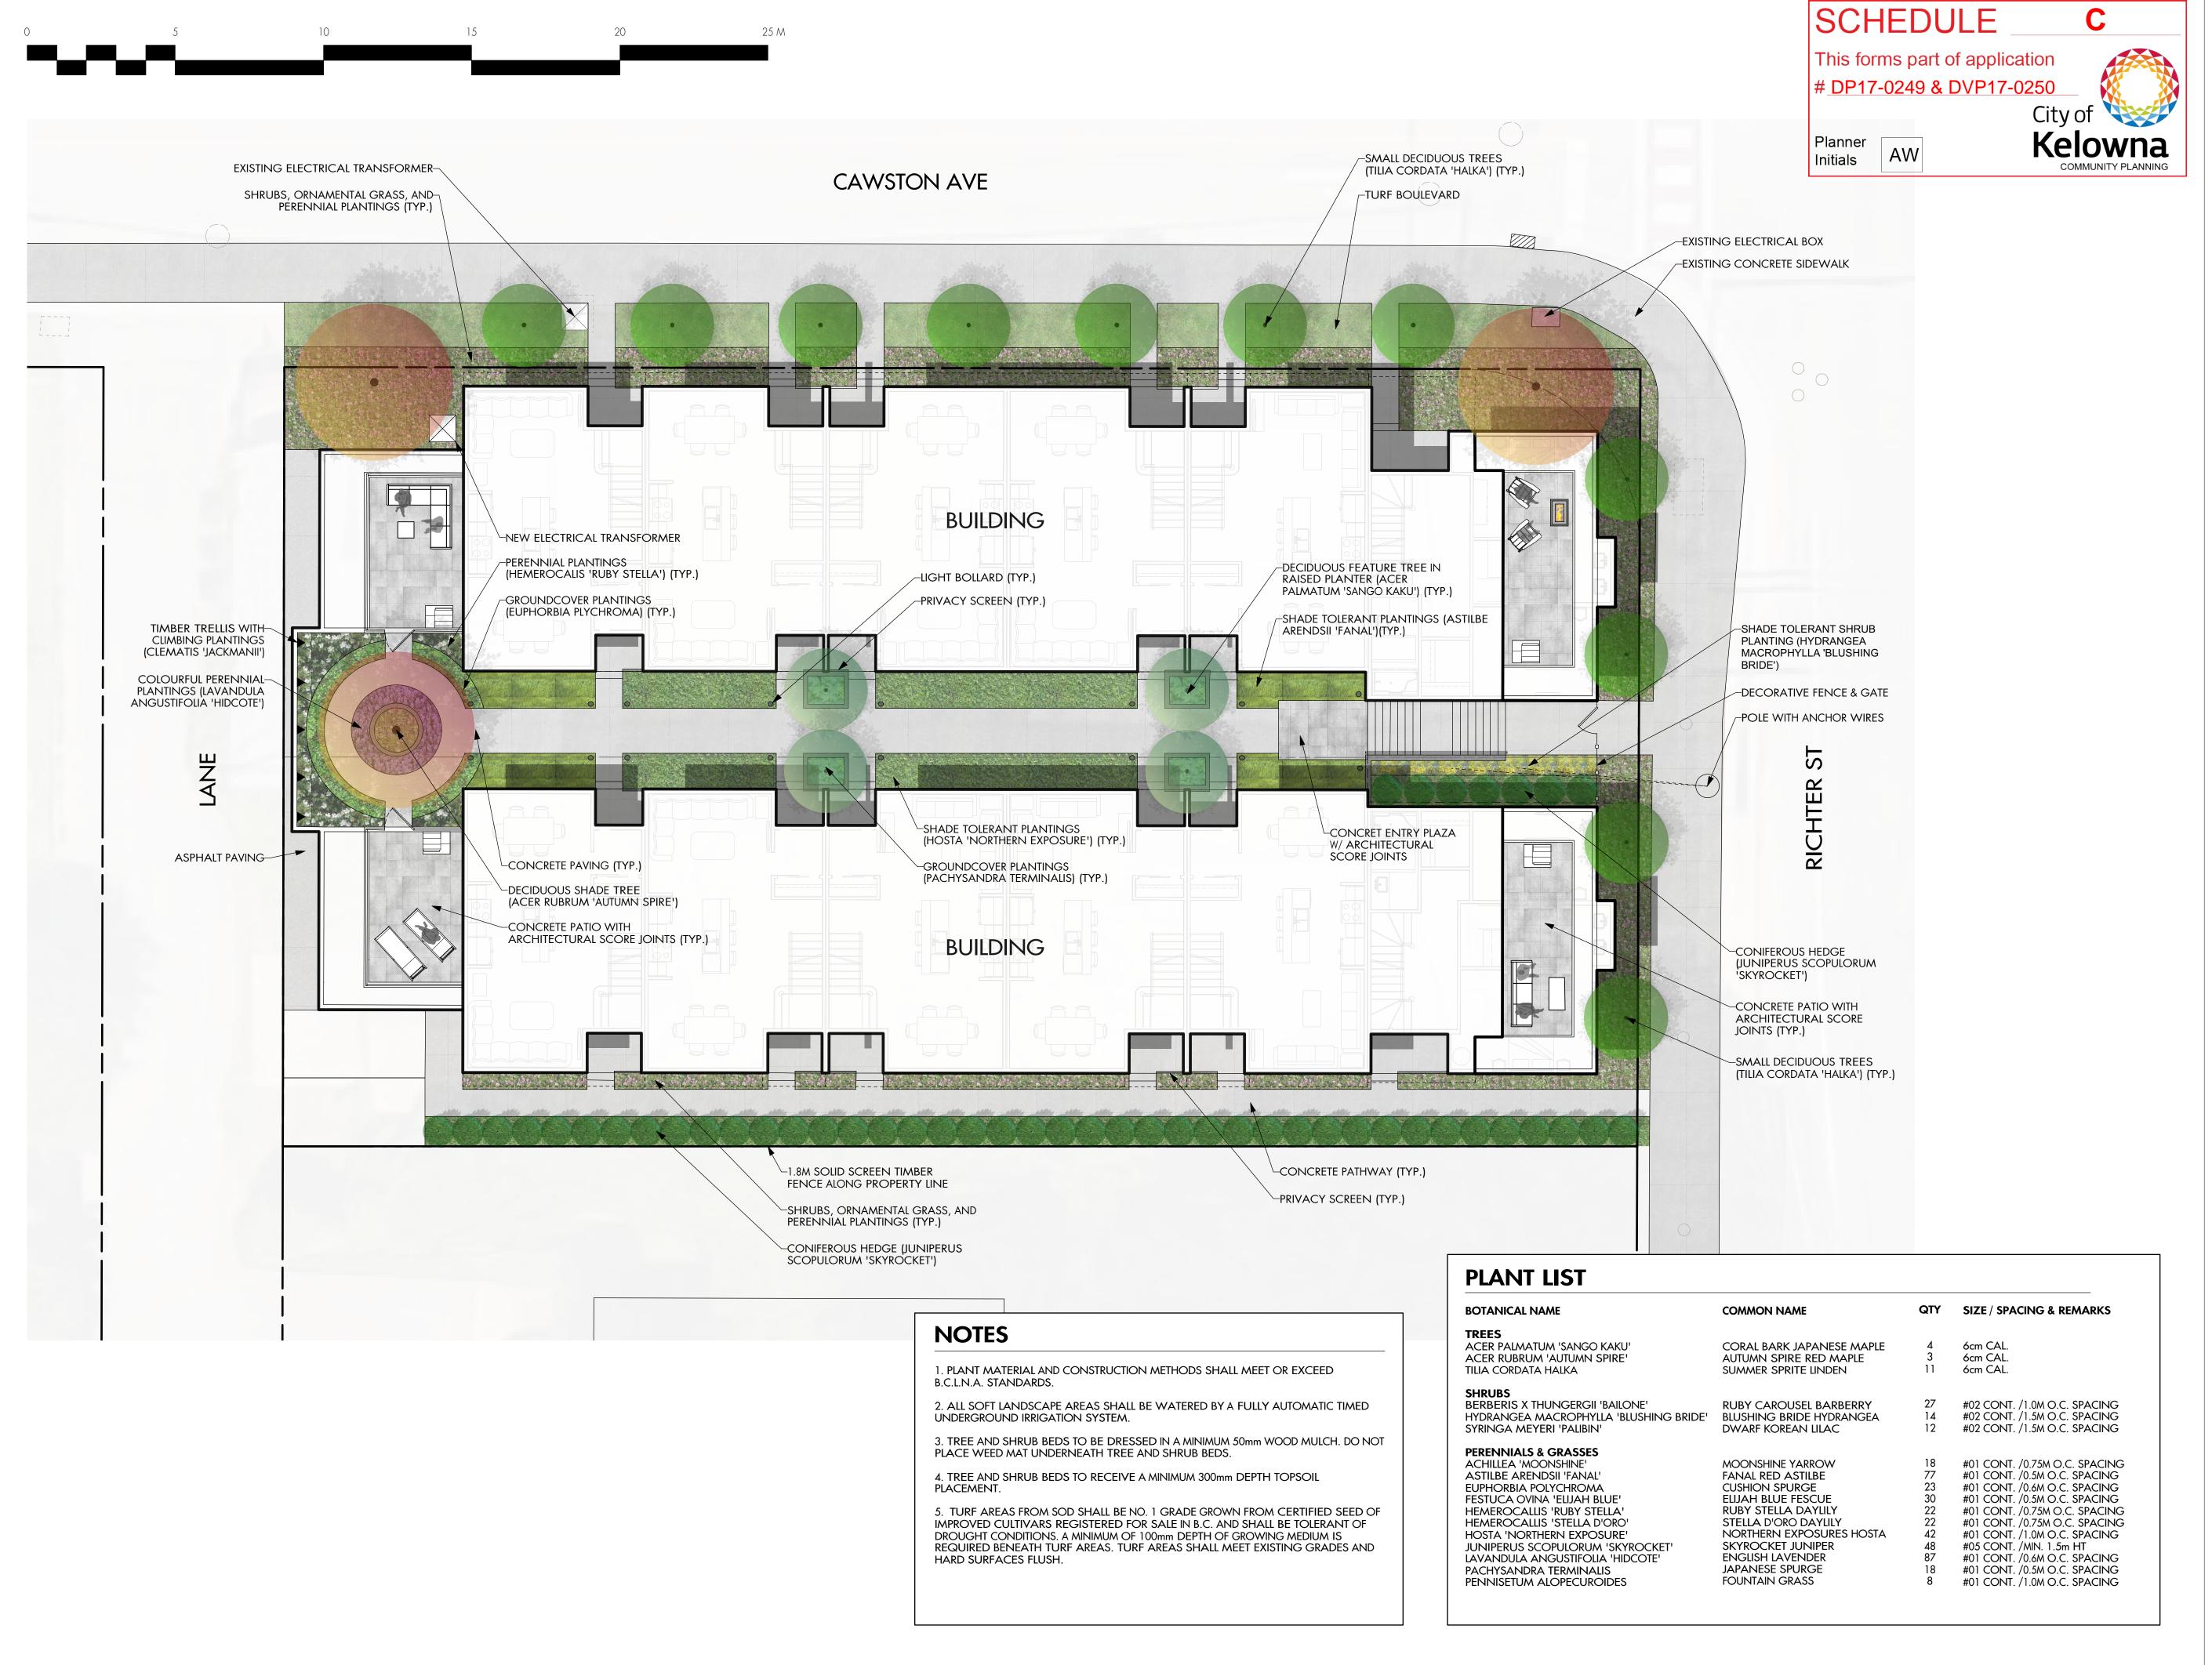



206 - 1889 Spall Road Kelowna, BC V1Y 4R2 T (250) 868-9270 www.outlanddesign.ca



PROJECT TITLE

1304-1308 RICHTER STREET

Kelowna, BC

DRAWING TITLE

ISSUED FOR / REVISION

CONCEPTUAL LANDSCAPE PLAN

3	
4	
5	

17-053 KG
KG
NG
FB
MAY 16, 2017
1:100

SEAL




Drawing Number

L1/2

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PROJECT TITLE

1304-1308 RICHTER **STREET**

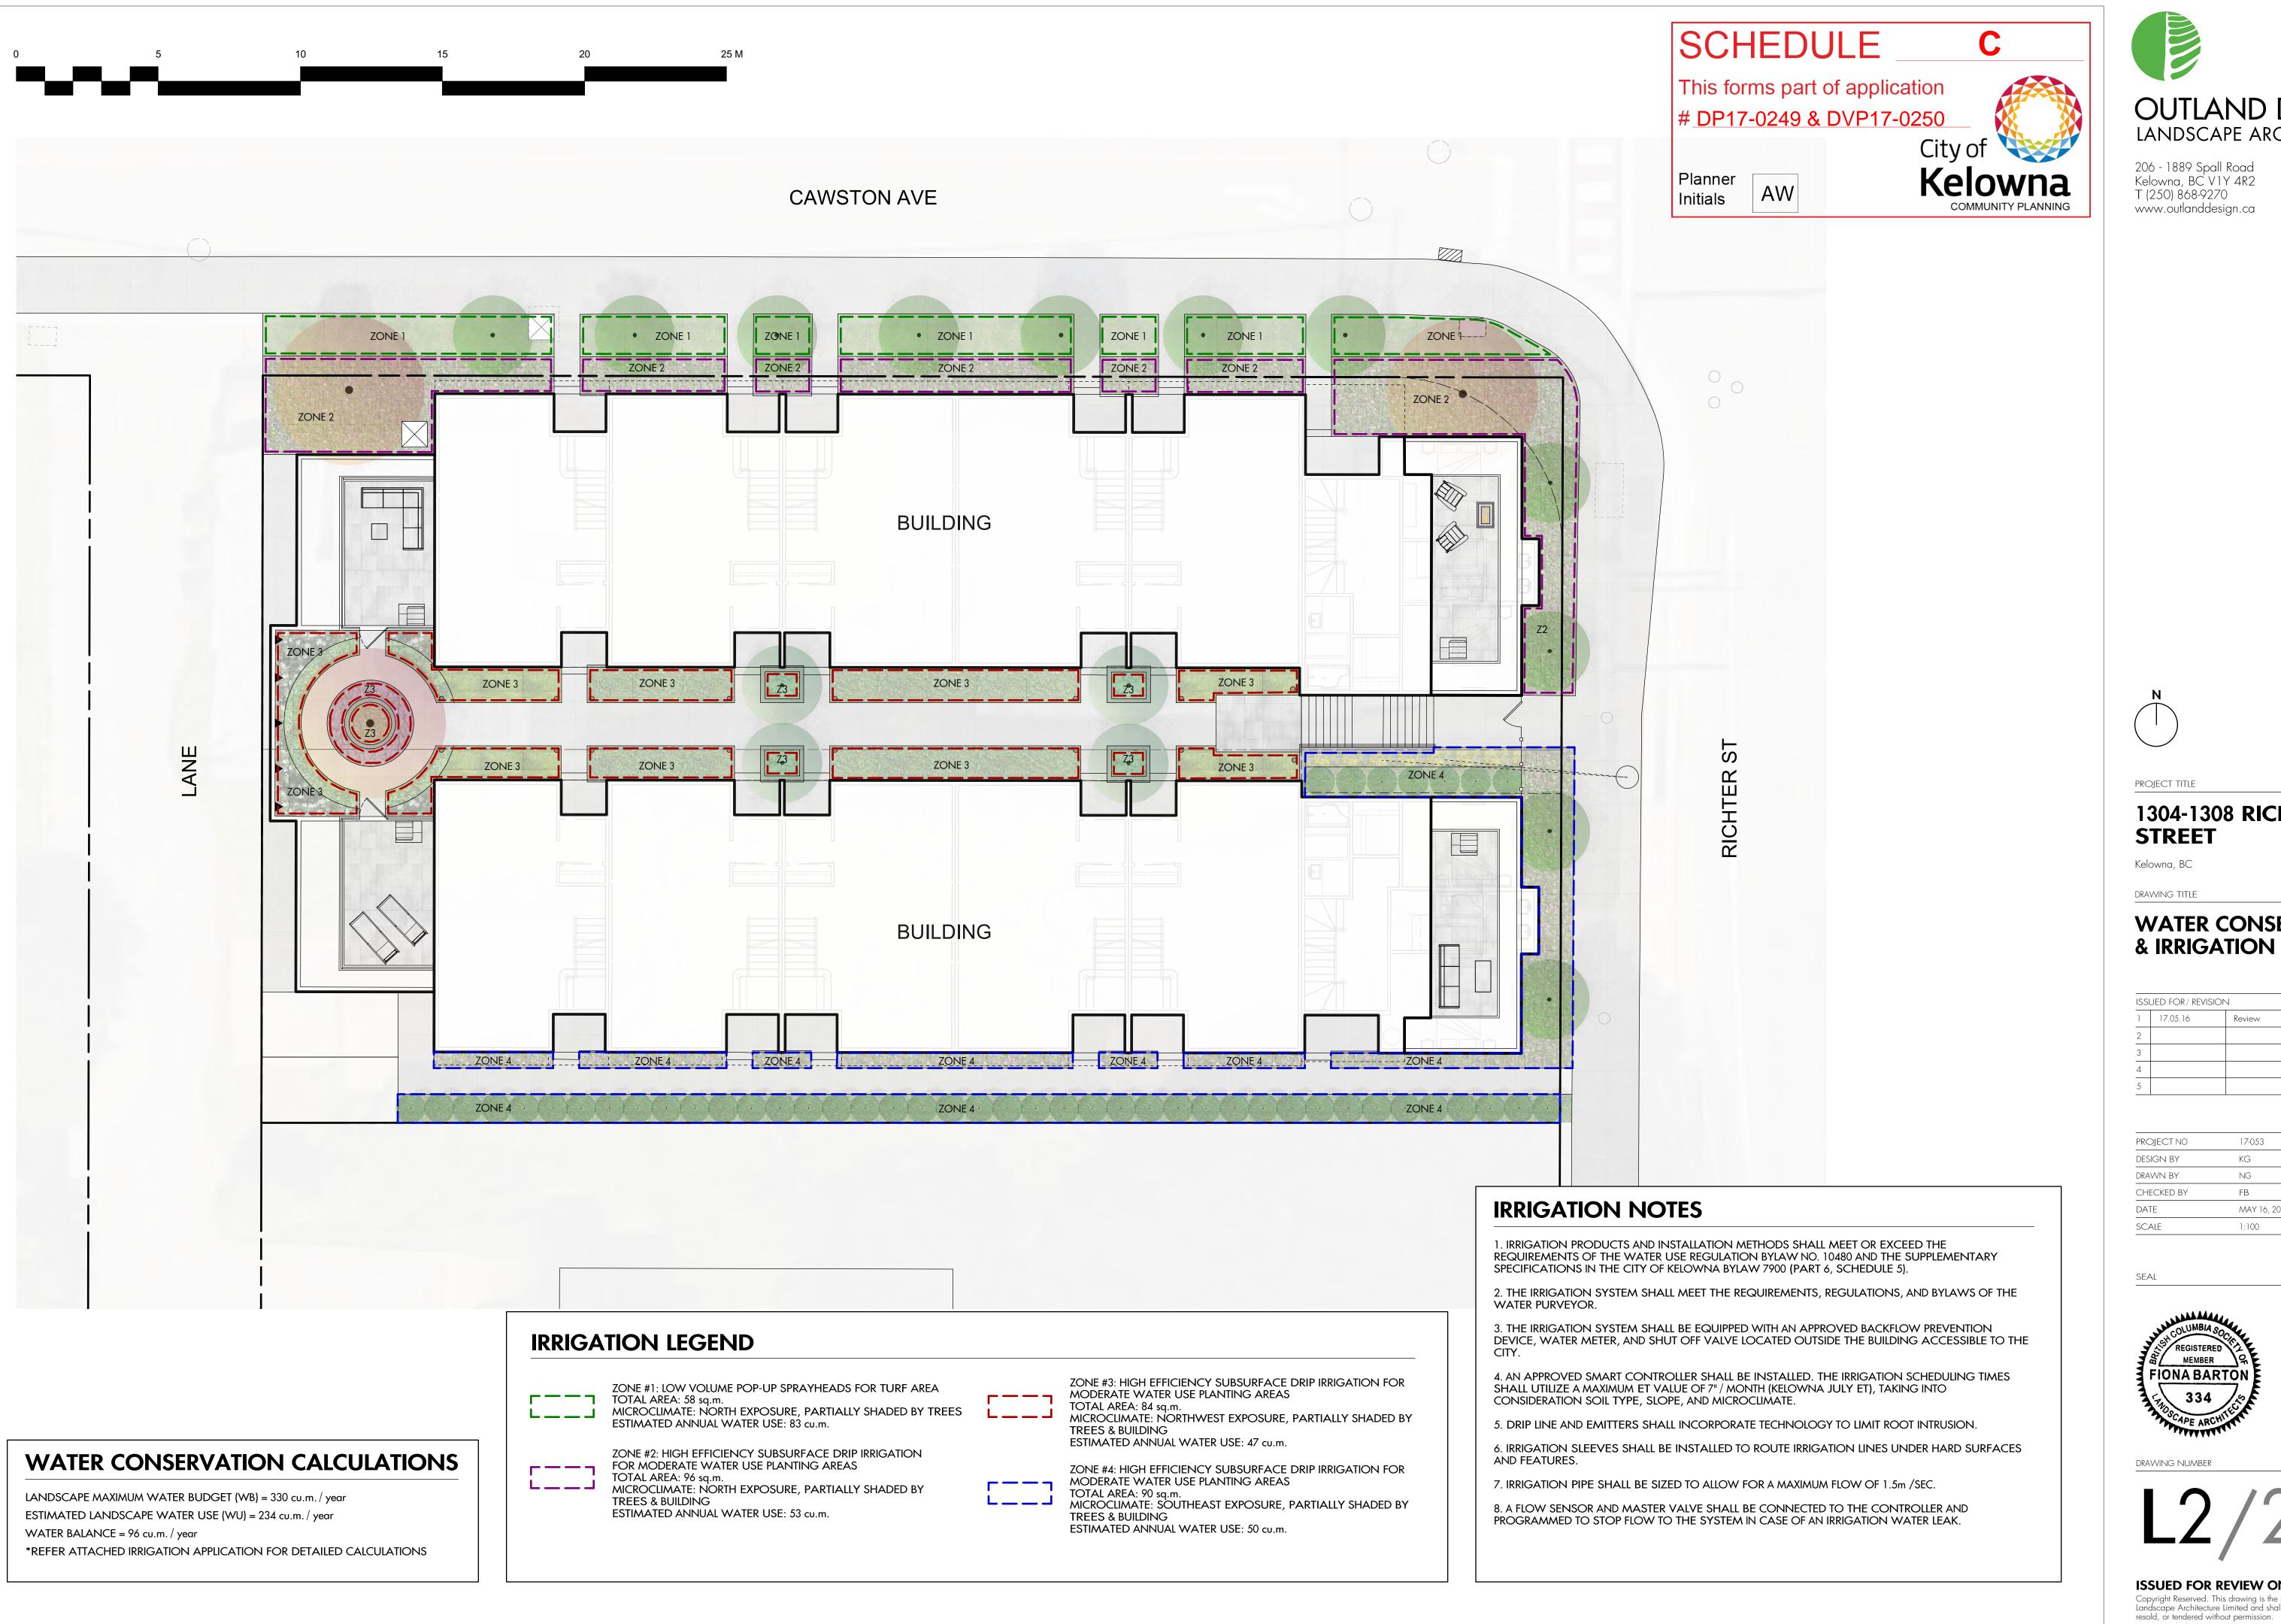Kelowna, BC

DRAWING TITLE

WATER CONSERVATION & IRRIGATION PLAN

3	
4	
5	

PROJECT NO	17-053
DESIGN BY	KG
DRAWN BY	NG
CHECKED BY	FB
DATE	MAY 16, 2017
SCALE	1:100



DRAWING NUMBER

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