

CITY OF KELOWNA

MEMORANDUM

Date:

January 3, 2018 (REVISED)

File No.:

Z17-0116

To:

Community Planning (KB)

From:

Development Engineering Manager(JK)

Subject:

1371 Bernard Avenue

RU6 to RM3

Development Engineering has the following requirements associated with this application. The road and utility upgrading requirements outlined in this report will be a requirement of this development.

The Development Engineering Technologist for this project is Aaron Sangster.

.1) <u>Domestic Water and Fire Protection</u>

(a) The development site is presently serviced with a 19mm diameter water service. The developer's consulting mechanical engineer will determine the domestic, fire protection requirements of this proposed development and establish hydrant requirements and service needs. Only one service will be permitted for this development.

.2) Sanitary Sewer

(a) The development site is presently serviced with a 100mm diameter sanitary sewer service. Only one service will be permitted for this development. The developer's consulting civil engineer will determine sanitary sizing for this development. The applicant, at his cost, will arrange for the removal of the existing service and the installation of a new larger service if required.

.3) Storm Drainage

(a) The developer must engage a consulting civil engineer to provide a storm water management plan for these sites which meets the requirements of the City Subdivision Development and Servicing Bylaw 7900. The storm water management plan must also include provision of lot grading plans, minimum basement elevations (MBE), if applicable, and provision of a storm drainage service and recommendations for onsite drainage containment and disposal systems.

.4) Road Improvements

(a) Lakeview Street fronting this development must be upgraded to an Local – Class 1 (SS-R5) to included barrier curb & gutter, pave the unpaved gravel area adjacent to the existing sidewalk, remove and replace existing sidewalk if required to accommodate proposed curb & gutter, and relocation or adjustment of existing utility appurtenances if required to accommodate the upgrading construction. No retaining walls or structures permitted in City ROW.



Z17-0116 1371 Bernard Ave. RU6 - RM3 AS.doc

(b) The lane fronting this development is required to be constructed to a paved standard. A cross section of SS-R2 should be used for design and costing.

.5) Road Dedication and Subdivision Requirements

By registered plan to provide the following:

(a) Grant statutory rights-of-way if required for utility services.

.6) <u>Electric Power and Telecommunication Services</u>

- (a) All proposed distribution and service connections are to be installed underground. Existing distribution and service connections, on that portion of a road immediately adjacent to the site, are to be relocated and installed underground as this site is located adjacent to the South Pandosy urban town centre.
- (b) Make servicing applications to the respective Power and Telecommunication utility companies. The utility companies are required to obtain the City's approval before commencing construction.
- (c) Re-locate existing poles and utilities, where necessary. Remove aerial trespass (es).

.7) Engineering

Road and utility construction design, construction supervision, and quality control supervision of all off-site and site services including on-site ground recharge drainage collection and disposal systems, must be performed by an approved consulting civil engineer. Designs must be submitted to the City Engineering Department for review and marked "issued for construction" by the City Engineer before construction may begin.

.8) Design and Construction

- (a) Design, construction supervision and inspection of all off-site civil works and site servicing must be performed by a Consulting Civil Engineer and all such work is subject to the approval of the City Engineer. Drawings must conform to City standards and requirements.
- (b) Engineering drawing submissions are to be in accordance with the City's "Engineering Drawing Submission Requirements" Policy. Please note the number of sets and drawings required for submissions.
- (c) Quality Control and Assurance Plans must be provided in accordance with the Subdivision, Development & Servicing Bylaw No. 7900 (refer to Part 5 and Schedule 3).
- (d) A "Consulting Engineering Confirmation Letter" (City document 'C') must be completed prior to submission of any designs.
- (e) Before any construction related to the requirements of this subdivision application commences, design drawings prepared by a professional engineer must be submitted to the City's Works & Utilities Department. The design drawings must first be "Issued for Construction" by the City Engineer. On examination of design drawings, it may be determined that rights-of-way are required for current or future needs.

Z17-0116 1371 Bernard Ave. RU6 - RM3 AS.doc

.9) <u>Servicing Agreements for Works and Services</u>

- (a) A Servicing Agreement is required for all works and services on City lands in accordance with the Subdivision, Development & Servicing Bylaw No. 7900. The applicant's Engineer, prior to preparation of Servicing Agreements, must provide adequate drawings and estimates for the required works. The Servicing Agreement must be in the form as described in Schedule 2 of the bylaw.
- (b) Part 3, "Security for Works and Services", of the Bylaw, describes the Bonding and Insurance requirements of the Owner. The liability limit is not to be less than \$5,000,000 and the City is to be on the insurance policy as an additional insured.

.10) Survey Monuments and Iron Pins

If any legal survey monuments or property iron pins are removed or disturbed during construction, the developer will be invoiced a flat sum of \$1,200.00 per incident to cover the cost of replacement and legal registration. Security bonding will not be released until restitution is made.

.11) Bonding and Levy Summary

(a) Bonding

Lakeview Street upgrade Lane Frontage Improvements

To be determined To be determined

Total Bonding

To be determined

.12) Administration Charge

An administration charge will be assessed for processing of this application, review and approval of engineering designs and construction inspection. The administration charge is calculated as (3.5% of Total Off-Site Construction Cost plus GST).

14) <u>Development Permit and Site Related Issues</u>

Access and Manoeuvrability

(a) The access to this site must be from the lane. Access from Bernard Avenue is not permitted as per bylaw.

15. Geotechnical Report

As a requirement of this application the owner must provide a geotechnical report prepared by a Professional Engineer qualified in the field of hydro-geotechnical survey to address the following:

- (a) Area ground water characteristics.
- (b) Site suitability for development, unstable soils, etc.
- (c) Drill and / or excavate test holes on the site and install pisometers if necessary. Log test hole data to identify soil characteristics, identify areas of fill if any. Identify unacceptable fill material, analyse soil sulphate content, identify unsuitable underlying soils such as peat, etc. and make recommendations for remediation if necessary.



Z17-0116 1371 Bernard Ave. RU6 - RM3 AS.doc

- (d) List extraordinary requirements that may be required to accommodate construction of roads and underground utilities as well as building foundation designs.
- (e) Additional geotechnical survey may be necessary for building foundations,

James Kay, P. Eng. Development Engineering Manager

BERNARD AVE. 4-PLEX



ARCHITECTURAL

NEW TOWN ARCHITECTURE & ENGINEERING 200-1464 ST. PAUL STREET KELOWNA, BC V1Y 2E6 ROMAN YAMCHSHIKOV Roman@newtownservices.net T. (250) 860 8185 F. (250) 860 0985

DRAWING LIST:

A001 COVER SHEET & DRAWING LIST
A002 SITE PLAN & ZONING ANALYSIS
A003 SURVEY

A004 RENDERINGS A005 RENDERINGS

A006 FOUNDATION & GARAGE LEVEL PLANS
A007 MAIN & SECOND LEVEL PLANS
A008 ROOF DECK & UPPER ROOF PLANS

A009 ELEVATIONS A010 ELEVATIONS A011 SECTIONS

CIVIL

NEW TOWN ARCHITECTURE & ENGINEERING 200-1464 ST. PAUL STREET KELOWNA, BC V1Y 2E6 JACOB PAUL Jacob@newtownservices.net T. (250) 860 8185

DRAWING LIST:

F. (250) 860 0985

SERVICING PLAN
 GRADING PLAN

LANDSCAPE

WSP
540 LEON AVENUE
KELOWNA, BRITISH COLUMBIA, V1Y 6J6
BYRON DOUGLAS
BYRON.DOUGLAS@WSP.COM
T. (250) 469 7730
M. (250) 826 7728

DRAWING LIST:

LDP-1 SITE PLAN LDP-2 HYDROZONE PLAN



CONTEXT PLAN: 1371 BERNARD AVE.

ATTACHMENT

This forms part of application # Z17-0116



ALL CONTRACTORS ARE REQUIRED TO
THEIR WORK AND SUPPLY THEIR PRODUCTS
COMPLIANCE WITH ALL BUILDING CODES
LAWS OF THE PROVINCE OF BRITISH
This drawing is an instrument of service and
property of New Town Services. The use of

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Verify all dimensions and datums prior commencement of

Report all errors and omissions to the



NEW TOWN

ARCHITECT URE

URBAN PLANNING

CIVIL ENGINEERING

www.newtownservices.ca

No Date Description

1 NOV 24, ISSUED FOR DP 2017

Seal

project title

BERNARD AVE. 4-PLEX

project address

1371 BERNARD AVE,
KELOWNA, BC

project no.

file no.

drawing title

COVER SHEET & DRAWING

LIST
designed scale

checked R.Y.

plotted NOV 24, 2017 11/24/2017 2:00:08 I

ZONING ANALYSIS: BUILDING STATISTICS: EXISTING PROPOSED **UNIT TYPOLOGY & COUNT: ZONING:** 3 BEDROOM: RM3 ZONING REQUIREMENTS: PROPOSED **BUILDING AREA:** 268.5 SM **(**2890.13 SF) ALLOWED **GROSS CONSTRUCTION AREA:** 922.4 SM (9928.7 SF) 0.59 **NET BUILDING AREA:** 7943.8 SF BASED ON 0.80 FAR 6123.35 SF MAX SITE COVERAGE FOR BUILDINGS: MAX SITE COVERAGE INCL PARKING & DRIVEWAYS:

3 STOREYS W/ LOCALIZED DEPRESSION

SIDE: 2.5m FROM WEST 7.75m FROM WEST 4.5m FROM LAKEVIEW ST. 4.5m FROM LAKEVIEW ST.

REAR: 7.5m 8.3m

PRIVATE OPEN SPACE:

60%

SETBACKS:

BUILDING HEIGHT:

3 STOREYS OR 10 m

FRONT: 4.5m

REQUIRED: 100.0 m2 BALCONIES/ PATIOS: 333.57 m2

59%

4.5m

FOR ENTRY

PARKING AND LOADING: PROVIDED: 2 STALLS x 4 UNITS = 8 STALLS 8 STALLS

PROVIDED:

BICYCLE PARKING:

CLASS II: 0.1×4 UNITS = 0.42 STALLS



ATTACHMENT

This forms part of application

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Revision No Date Description 1 NOV 24, ISSUED FOR DP

BERNARD AVE. 4-PLEX

project address 1371 BERNARD AVE,

KELOWNA, BC

drawing title


SITE PLAN & ZONING

ANALYSIS

SITE SURVEY BASED ON INFORMATION PROVIDED BY: FINAL LAYOUT, GRADE ELEVATIONS AND FINAL MAIN FLOOR ELEVATION TO BE DETERMINED BY SURVEYOR & CIVIL ENGINEER IN CONSULTATION WITH CONTRACTOR & OWNER.

ARCHITECTURAL SITE PLAN TO BE READ IN CONJUNCTION WITH CIVIL SITE

ARCHITECTURAL SITE PLAN TO BE READ IN CONJUNCTION WITH LANDSCAPE

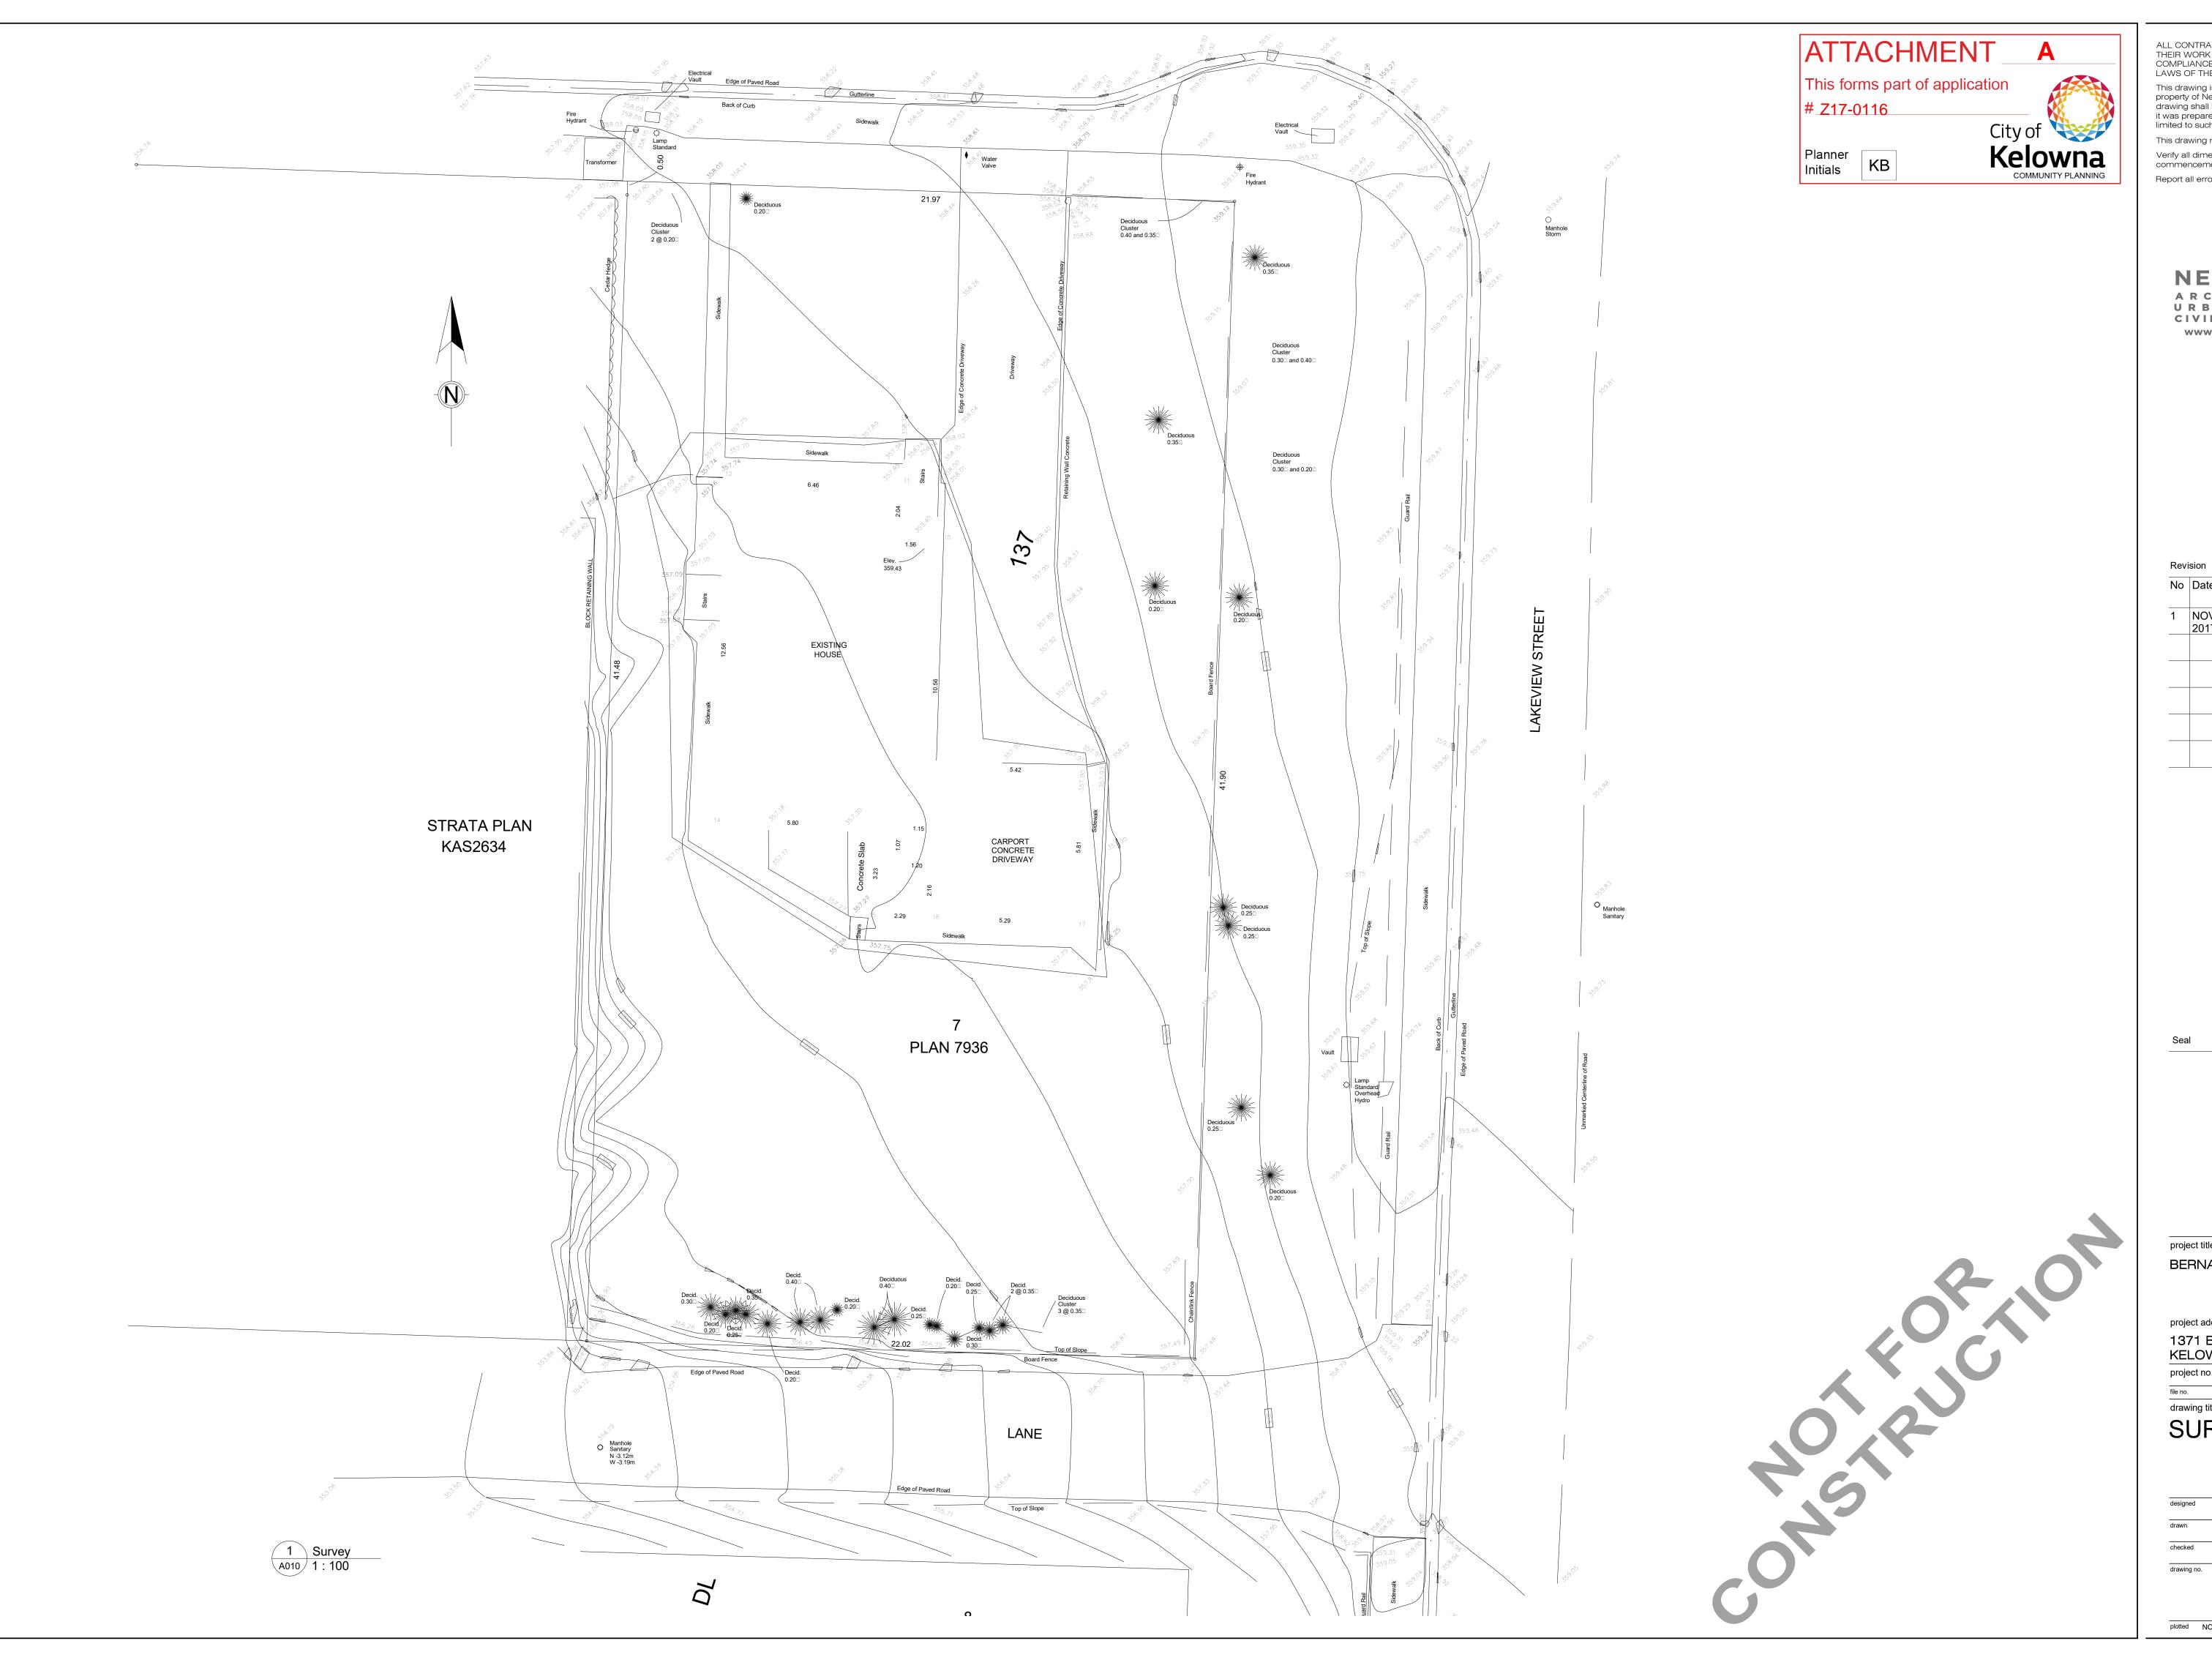

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BERNARD AVE. 4-PLEX

project address

1371 BERNARD AVE, KELOWNA, BC

drawing title SURVEY

1:100



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CIVIL ENGINEERING

www.newtownservices.ca

No Date Description

1 NOV 24, ISSUED FOR

I	NOV 24, 2017	ISSUED FOR DP



project title

BERNARD AVE. 4-PLEX

project address
1371 BERNARD AVE,
KELOWNA, BC

project no.

project no.

drawing title

RENDERINGS

designed scale

drawn


R.B./R.Y

checked

R.Y.

drawing no.

A004

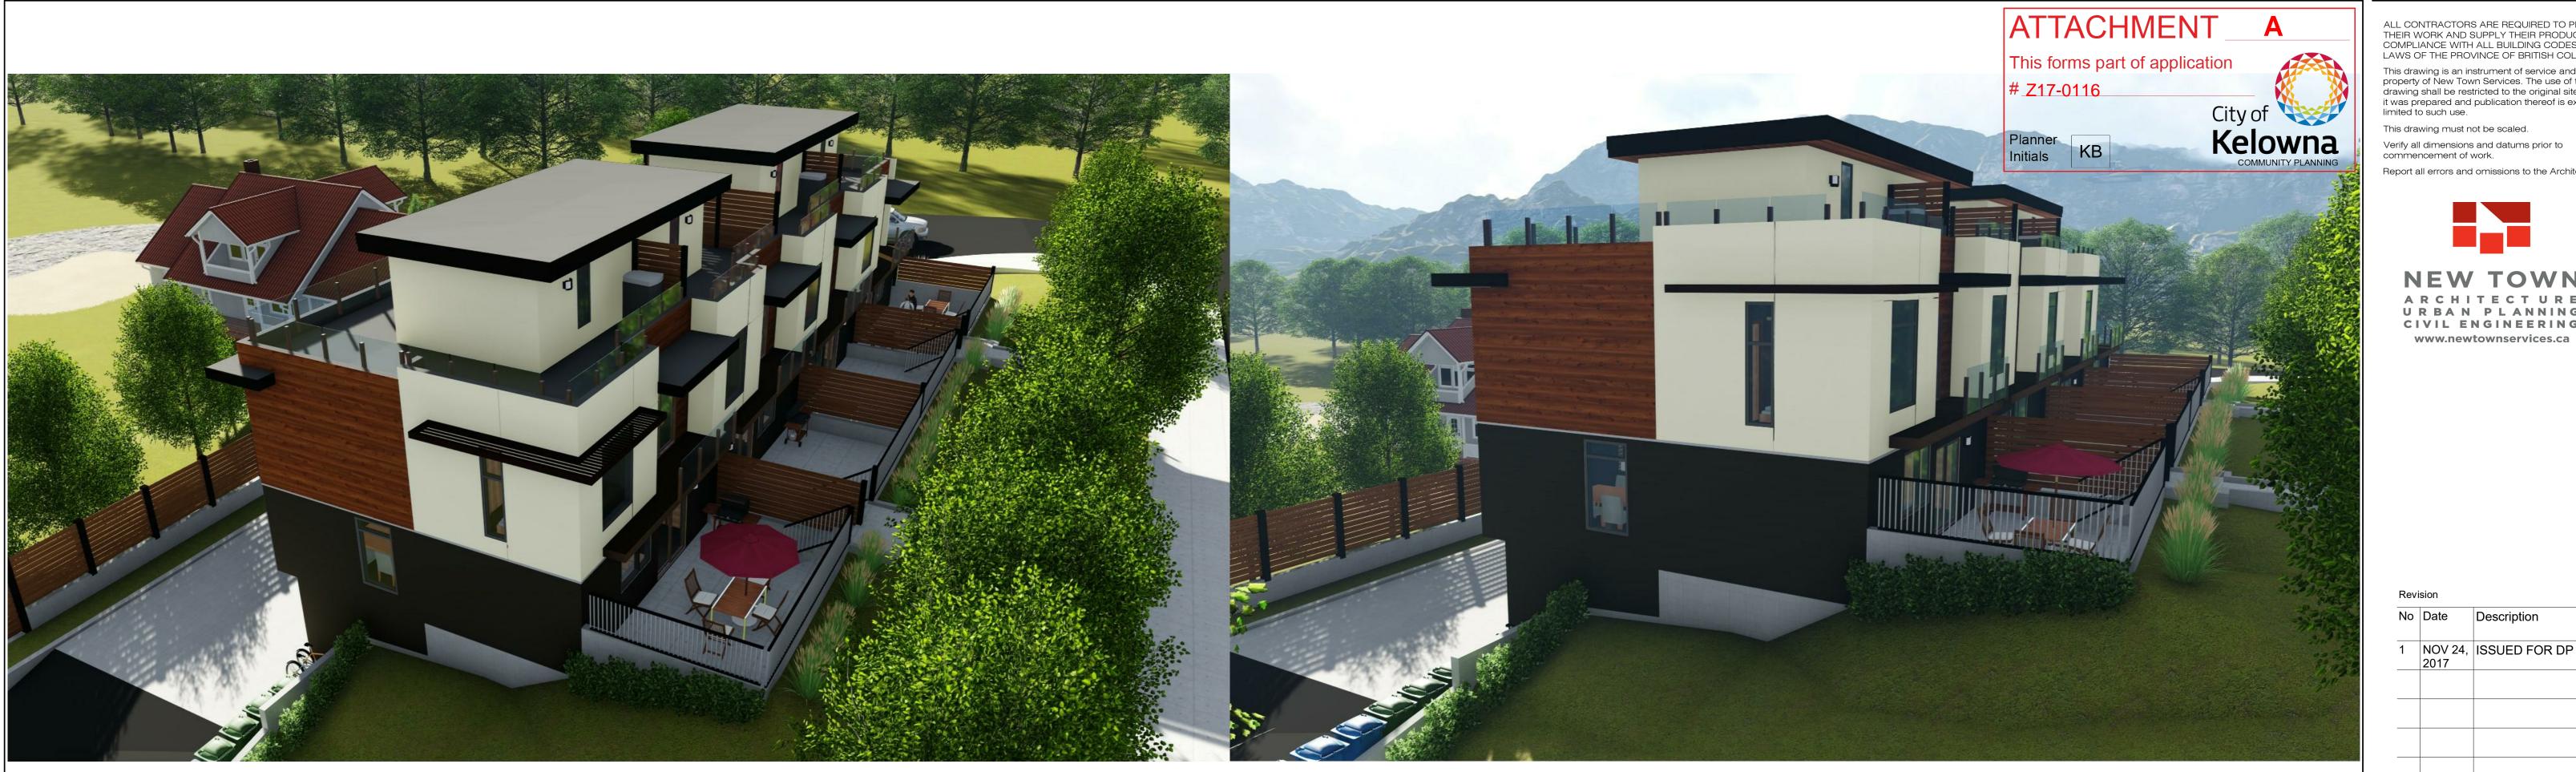

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Date	Description
NOV 24, 2017	ISSUED FOR DP
	NOV 24,




BERNARD AVE. 4-PLEX

1371 BERNARD AVE, KELOWNA, BC

drawing title

RENDERINGS

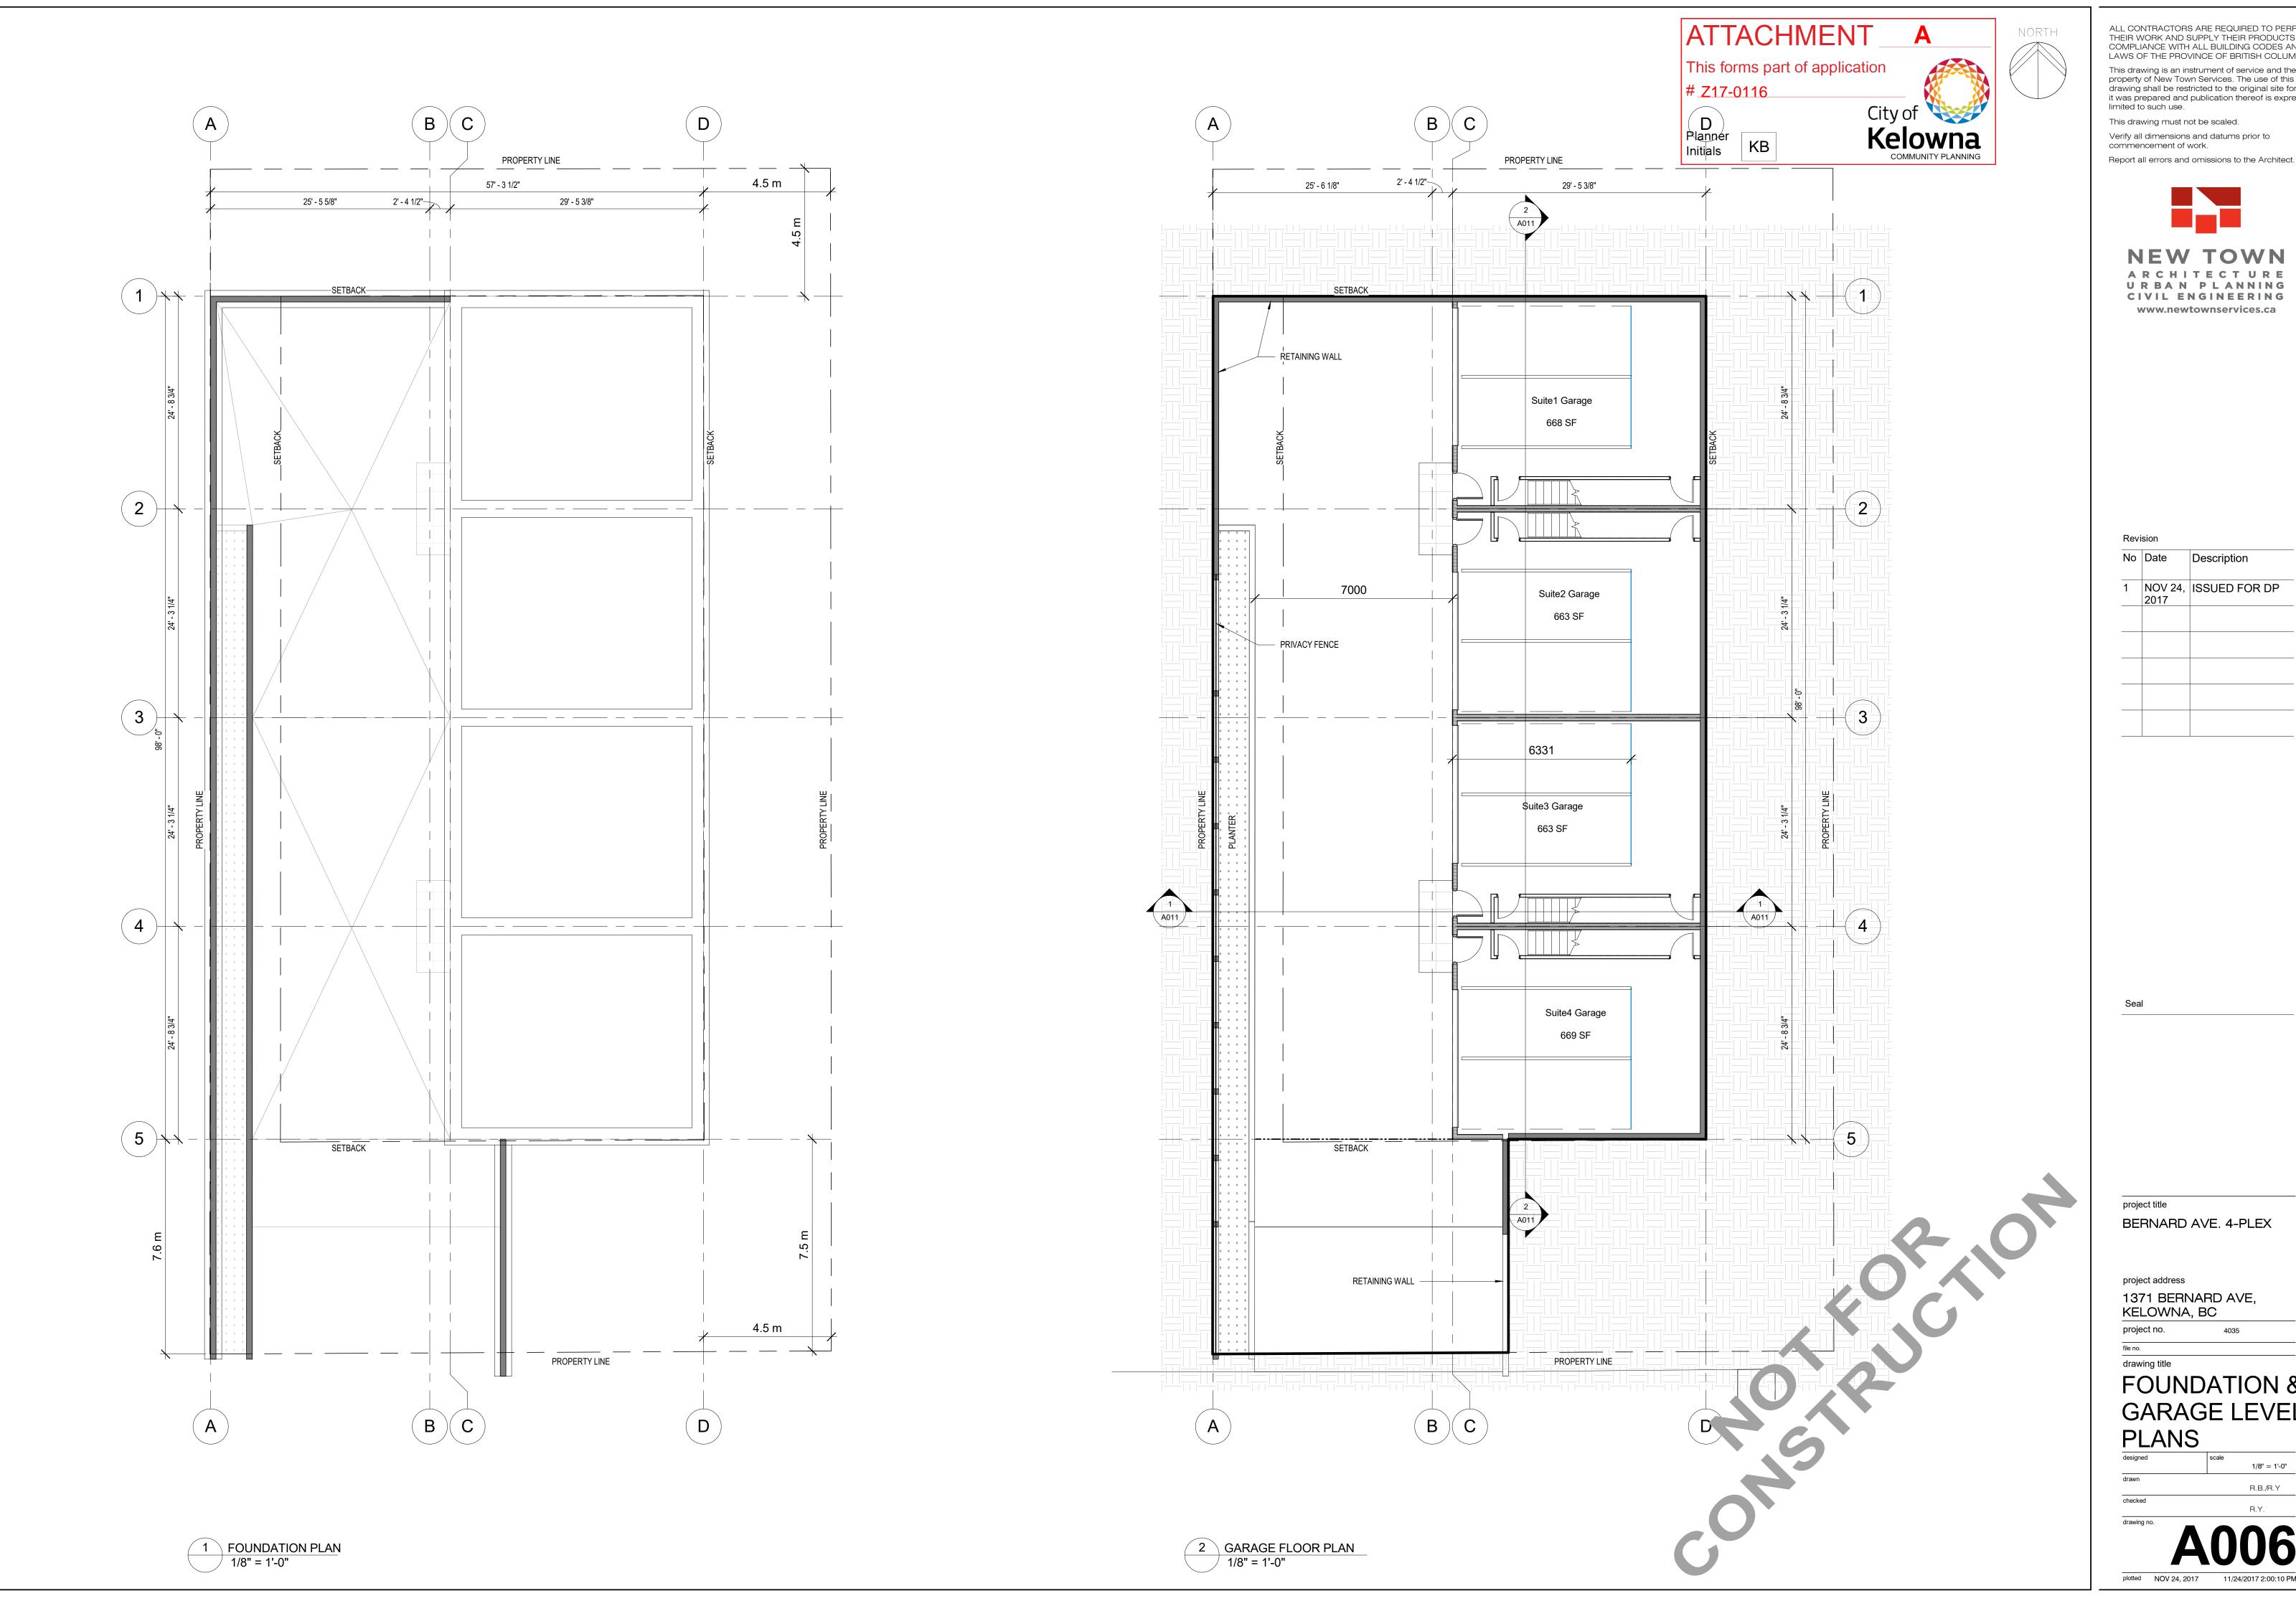

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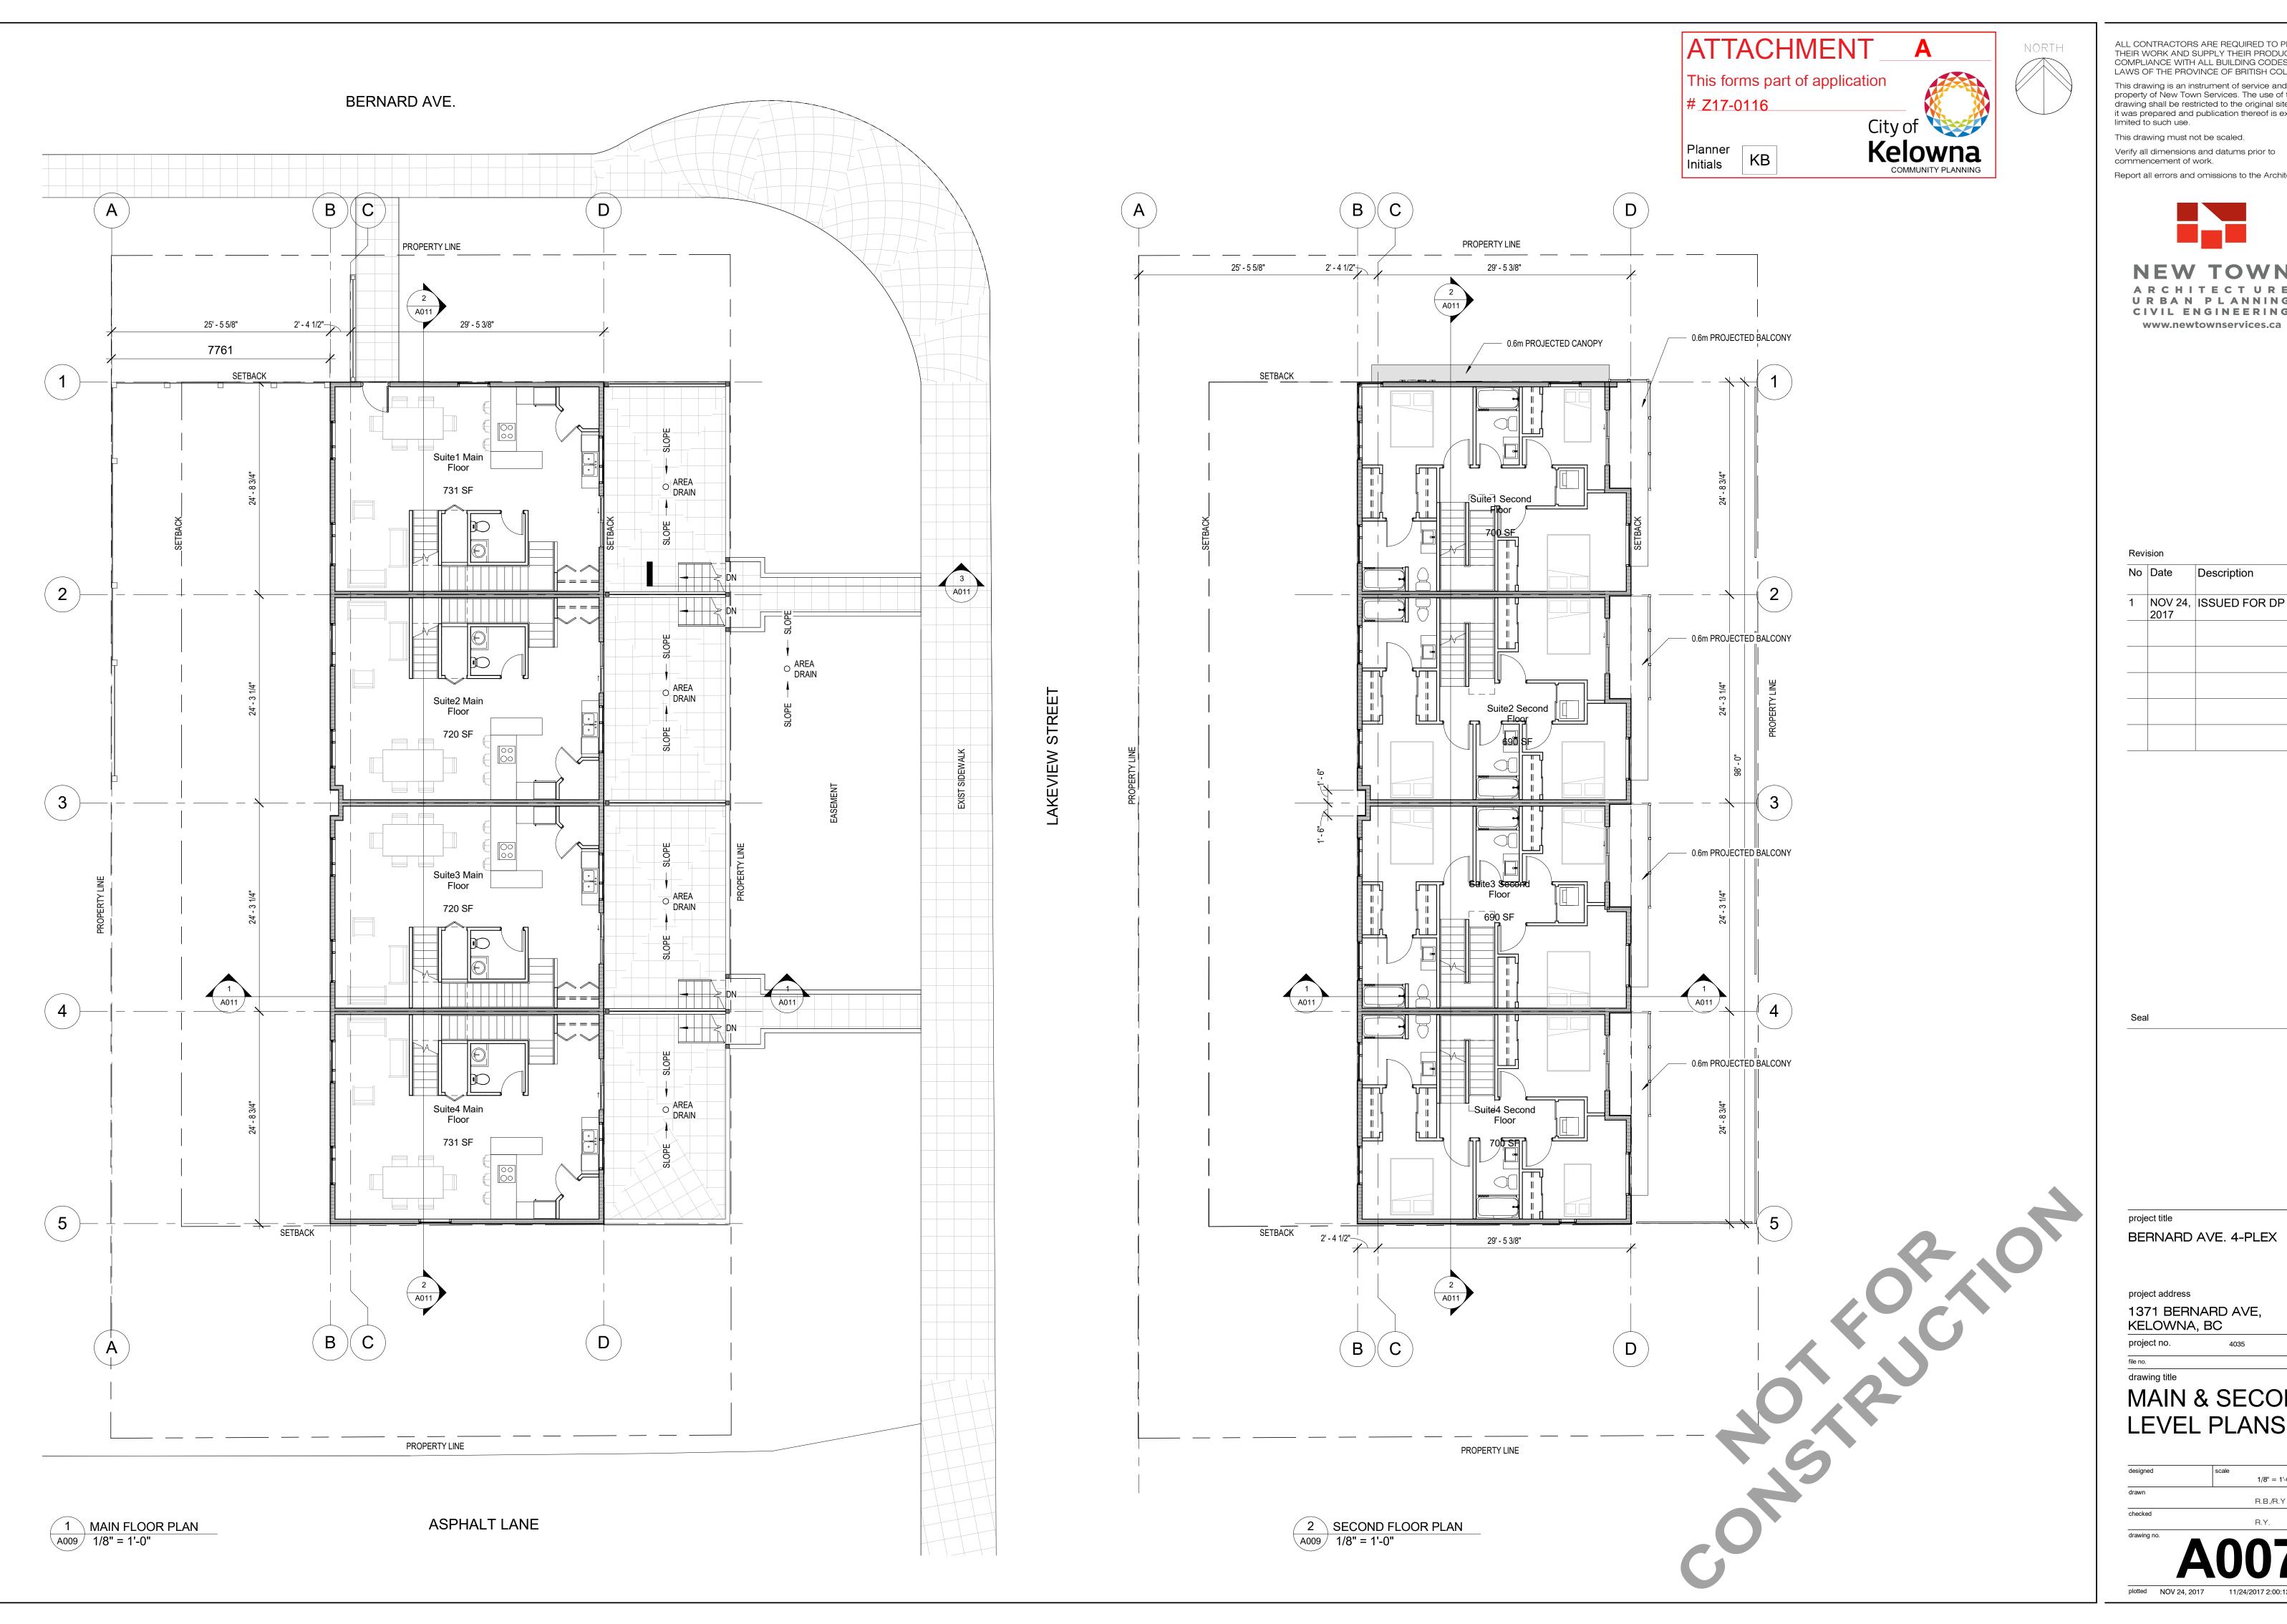
BERNARD AVE. 4-PLEX

project address

1371 BERNARD AVE, KELOWNA, BC

drawing title

FOUNDATION & **GARAGE LEVEL PLANS**



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BERNARD AVE. 4-PLEX


project address

1371 BERNARD AVE, KELOWNA, BC

drawing title

MAIN & SECOND LEVEL PLANS

1/8" = 1'-0" R.B./R.Y

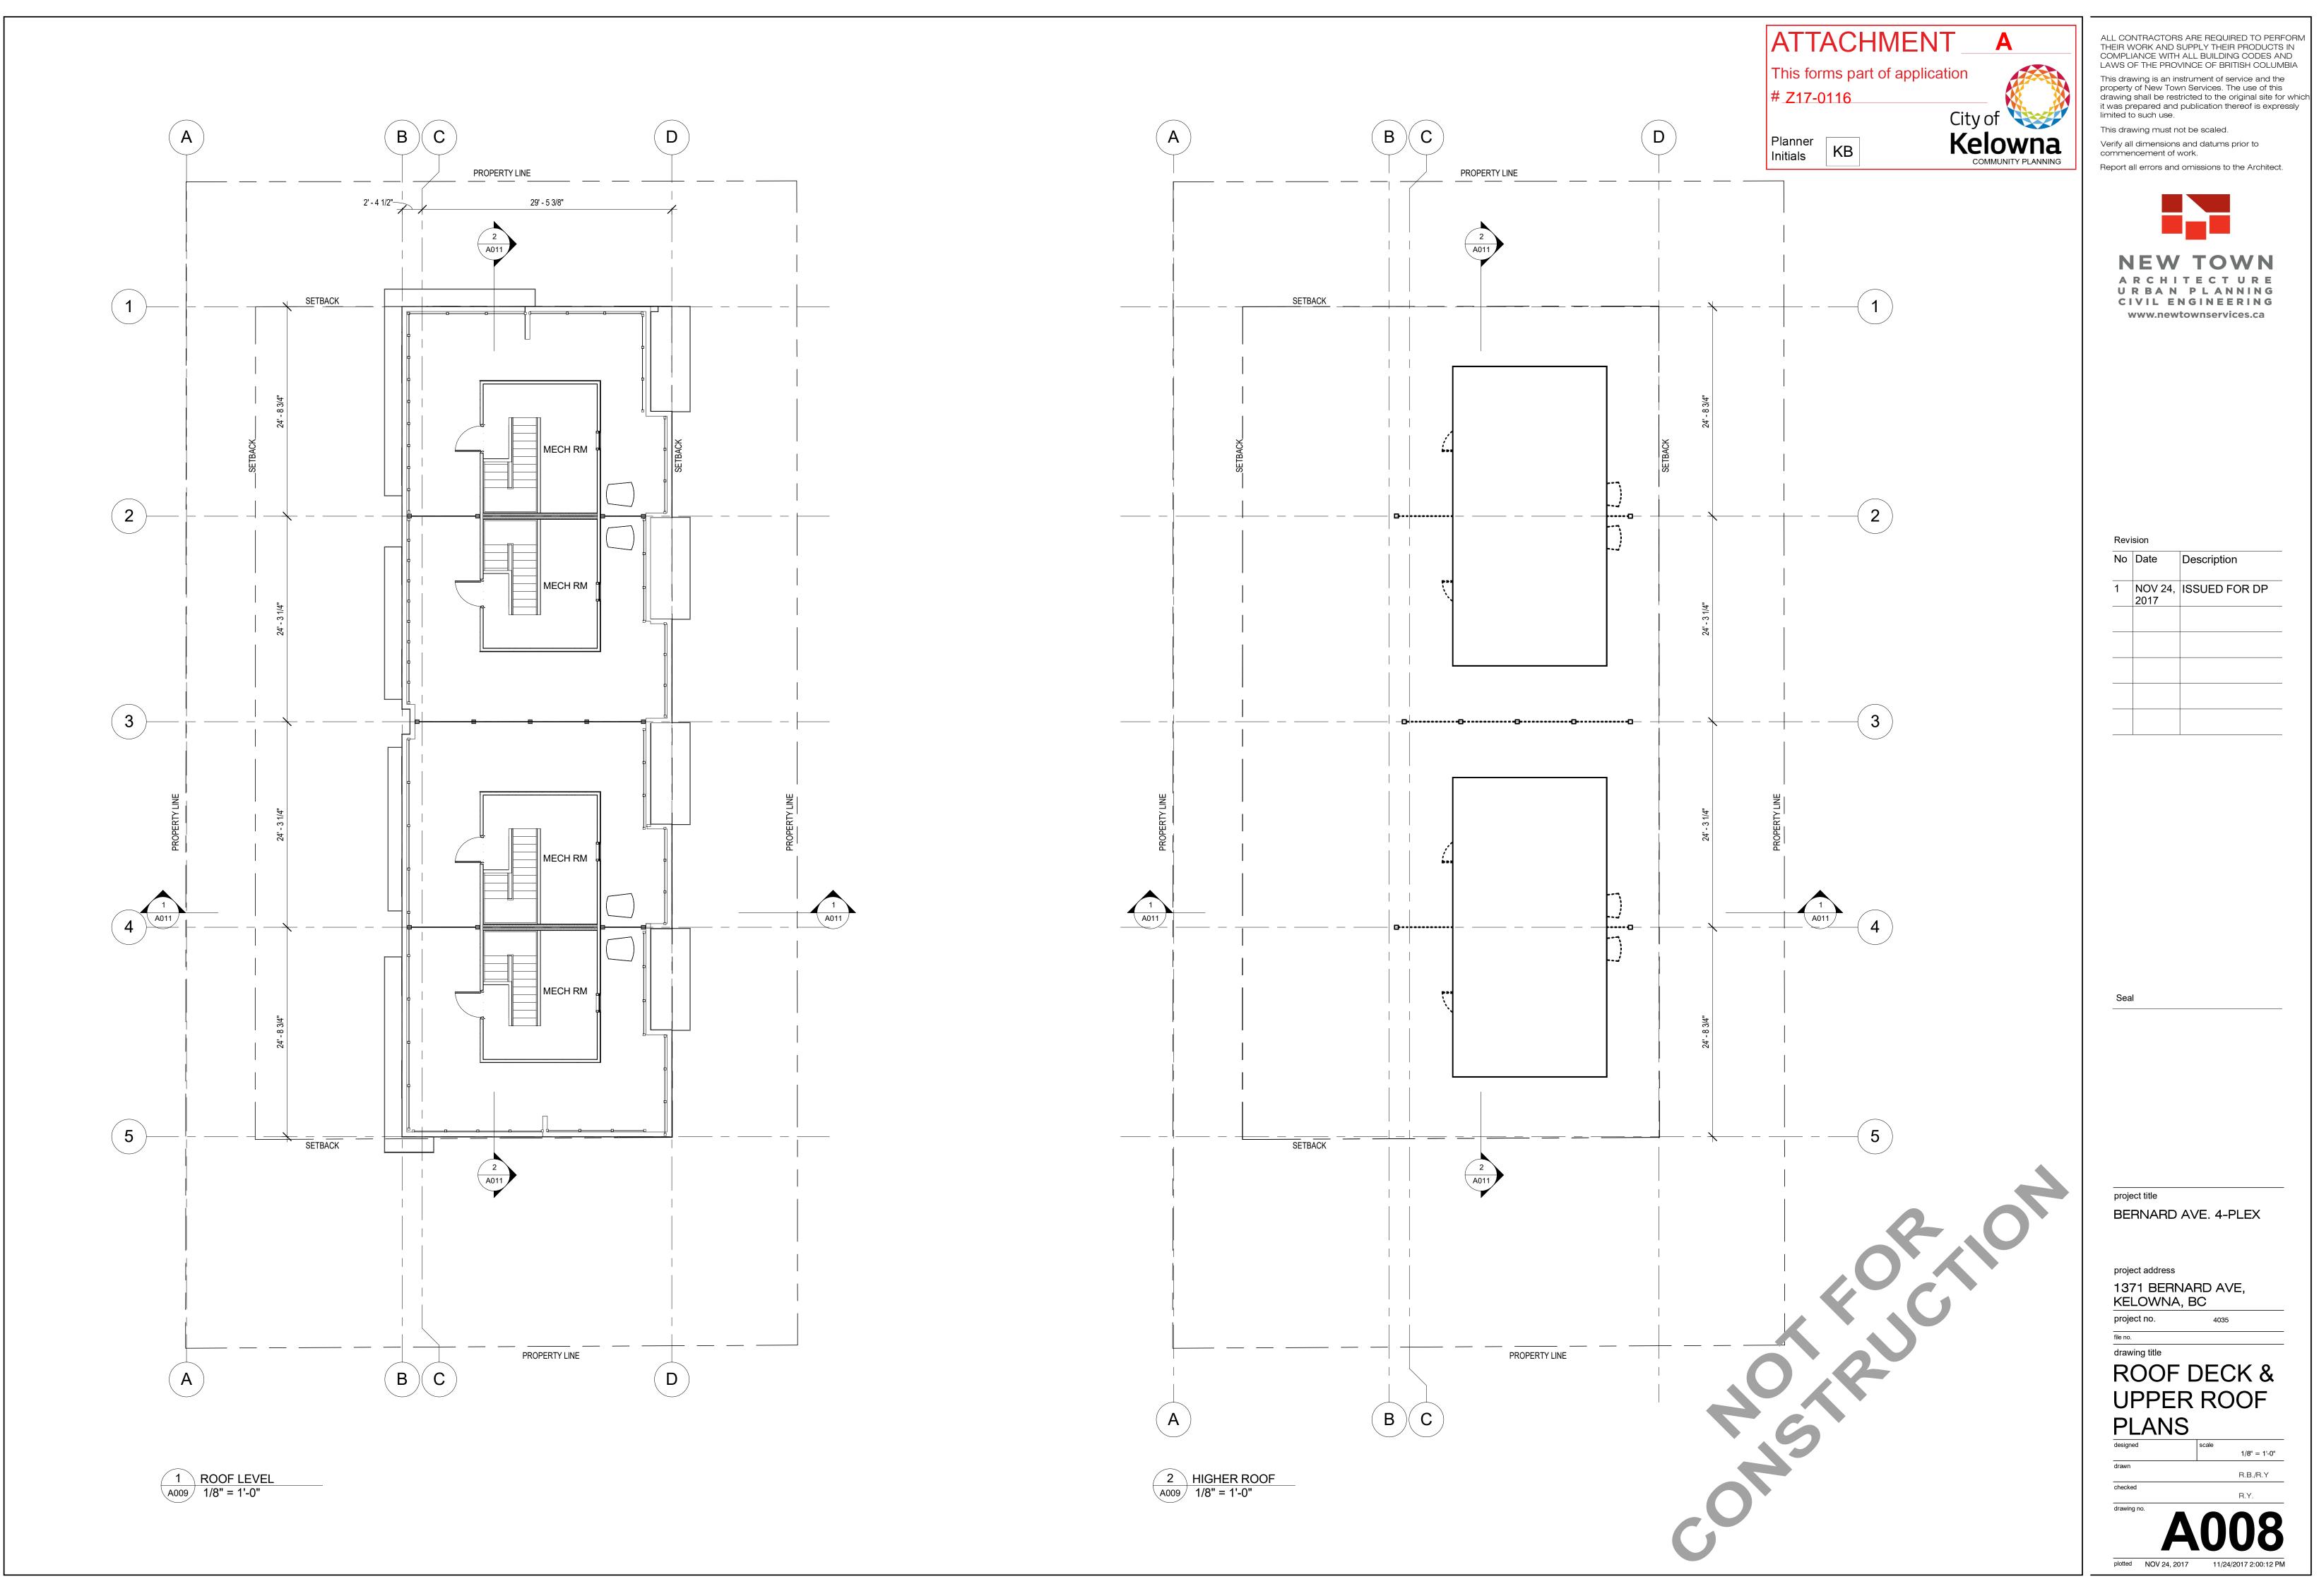


ALL CONTRACTORS ARE REQUIRED TO PERFORM THEIR WORK AND SUPPLY THEIR PRODUCTS IN COMPLIANCE WITH ALL BUILDING CODES AND LAWS OF THE PROVINCE OF BRITISH COLUMBIA



NEW TOWN ARCHITECT URE URBAN PLANNING CIVIL ENGINEERING

No Date Description 1 NOV 24, ISSUED FOR DP

ROOF DECK &

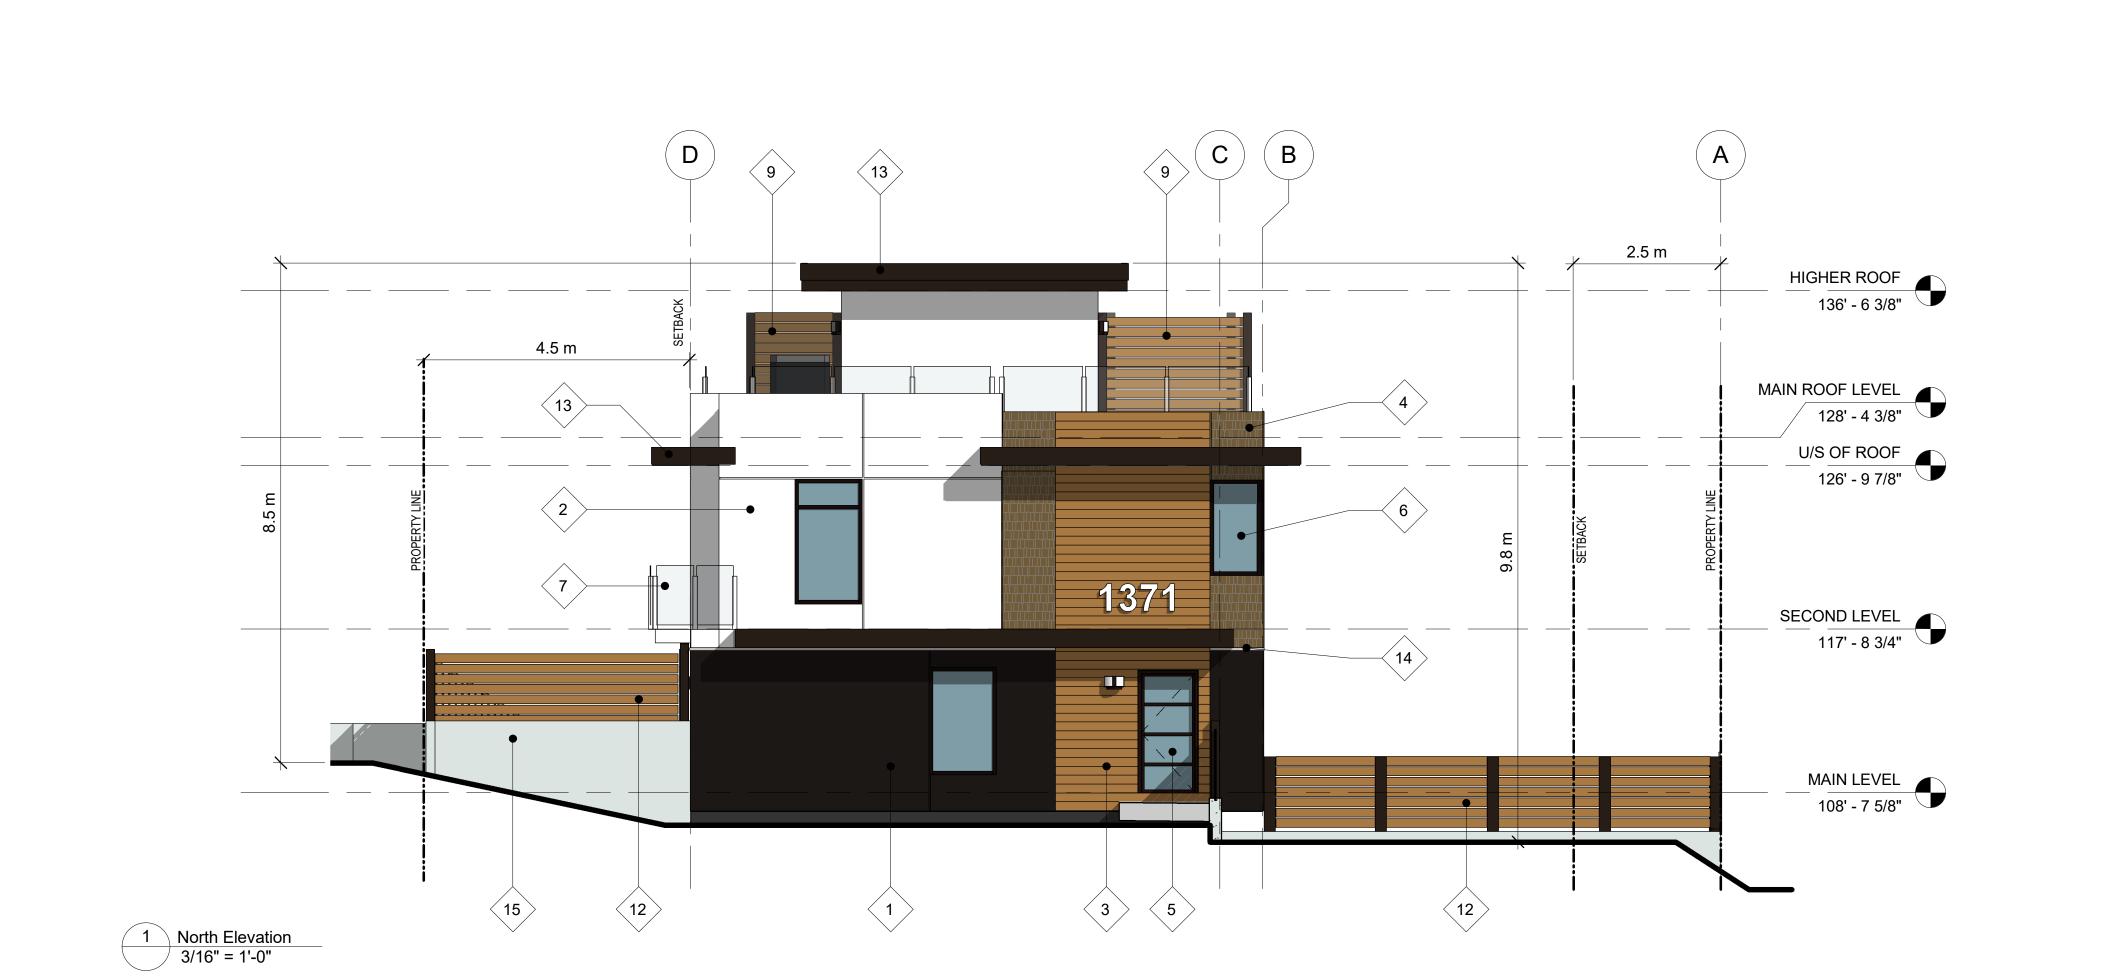



This forms part of application #_Z17-0116

Planner

Initials

MATERIAL KEYNOTE

3. IMITATION CEDAR SIDING (FIBRE CEMENT BOARD)

4. IMITATION CEDAR SHINGLES (FIBRE CEMENT BOARD)

1. ACRYLIC STUCCO - DARK BROWN

5. DOUBLE GLAZED ALUMINIM DOORS

6. DOUBLE GLAZED ALUMINIM WINDOWS

8. METAL OVERHEAD GARAGE DOOR - INSULATED

9. PRIVACY SCREEN - COMPOSITE CEDAR STRIP

10. ALUMINUM SOLAR SHADE - PAINTED BLACK

14. EXPANSION JOIST - METAL FLASHING - PAINTED

11. MECHANICAL UNIT - ON ISOLATION PAD

ACRYLIC STUCCO - WHITE

GLAZED RAILING SYSTEM

12. CEDAR STRIP FENCING

13. METAL CAP-FLASHING - PAINTED

15. ARCHITECTURAL CONCRETE

16. METAL FENCE - PAINTED WHITE

City of

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Seal

project title

BERNARD AVE. 4-PLEX


project address 1371 BERNARD AVE,


KELOWNA, BC project no.

drawing title **ELEVATIONS**

As indicated R.B./R.Y



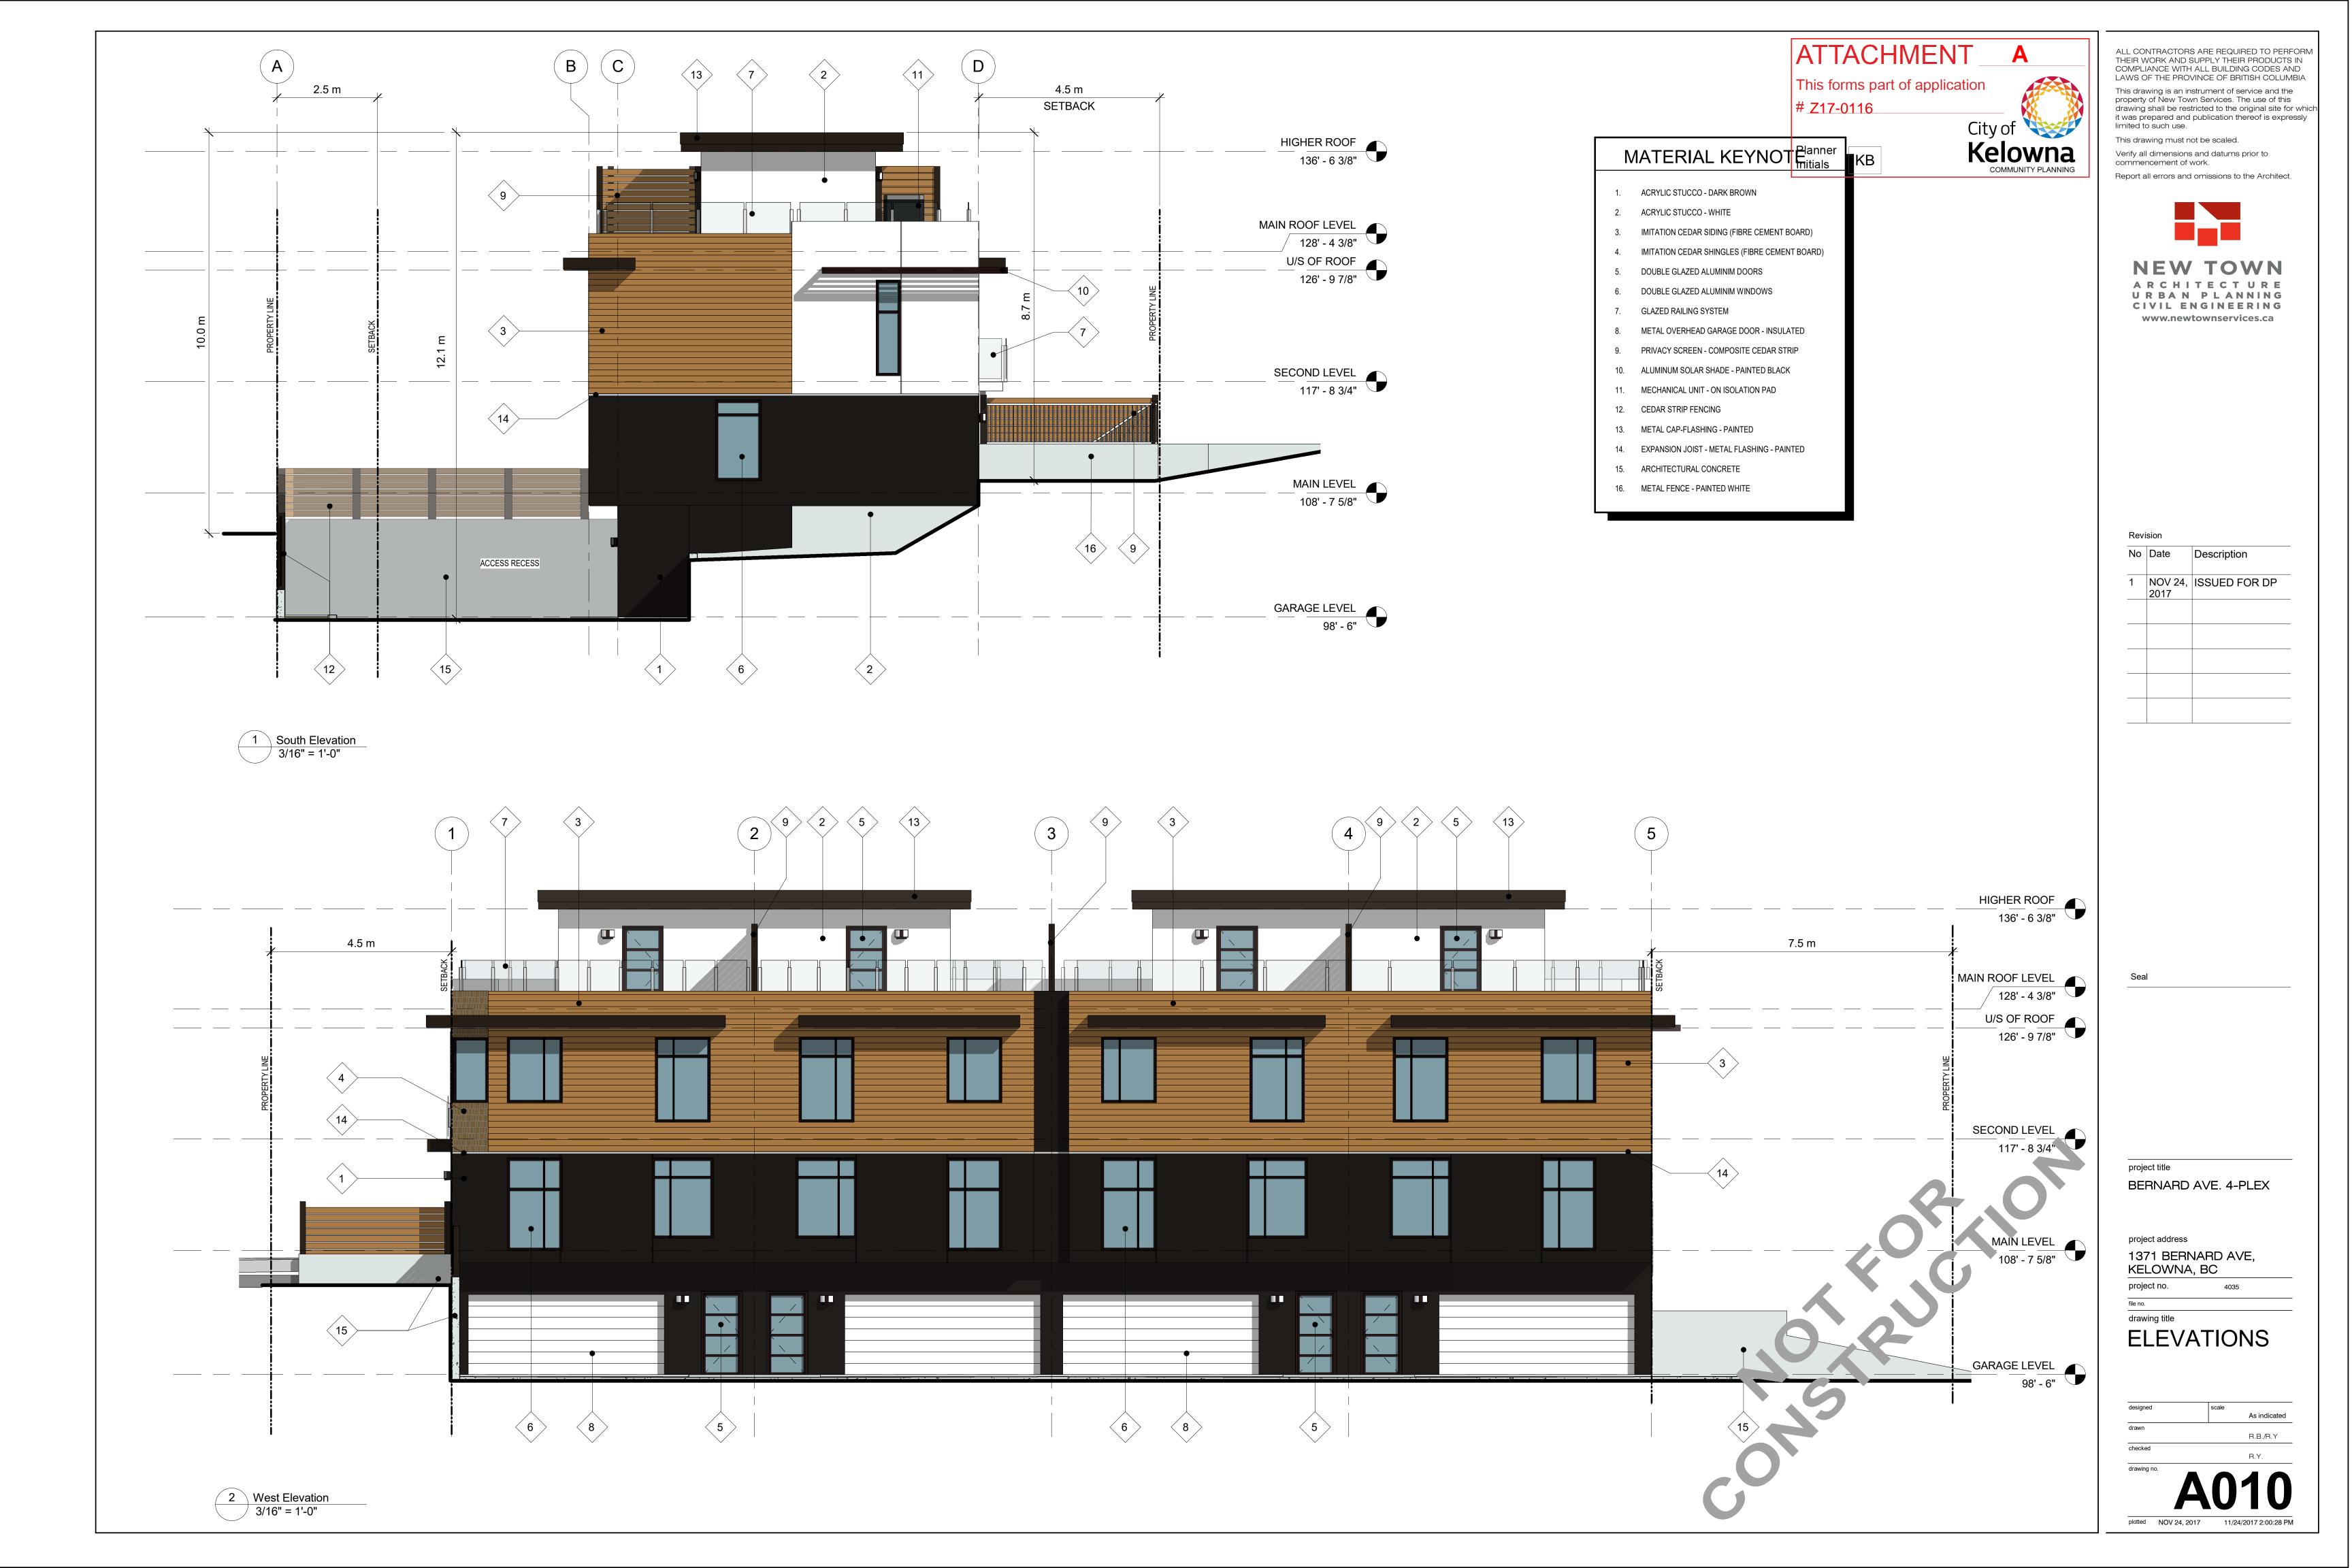

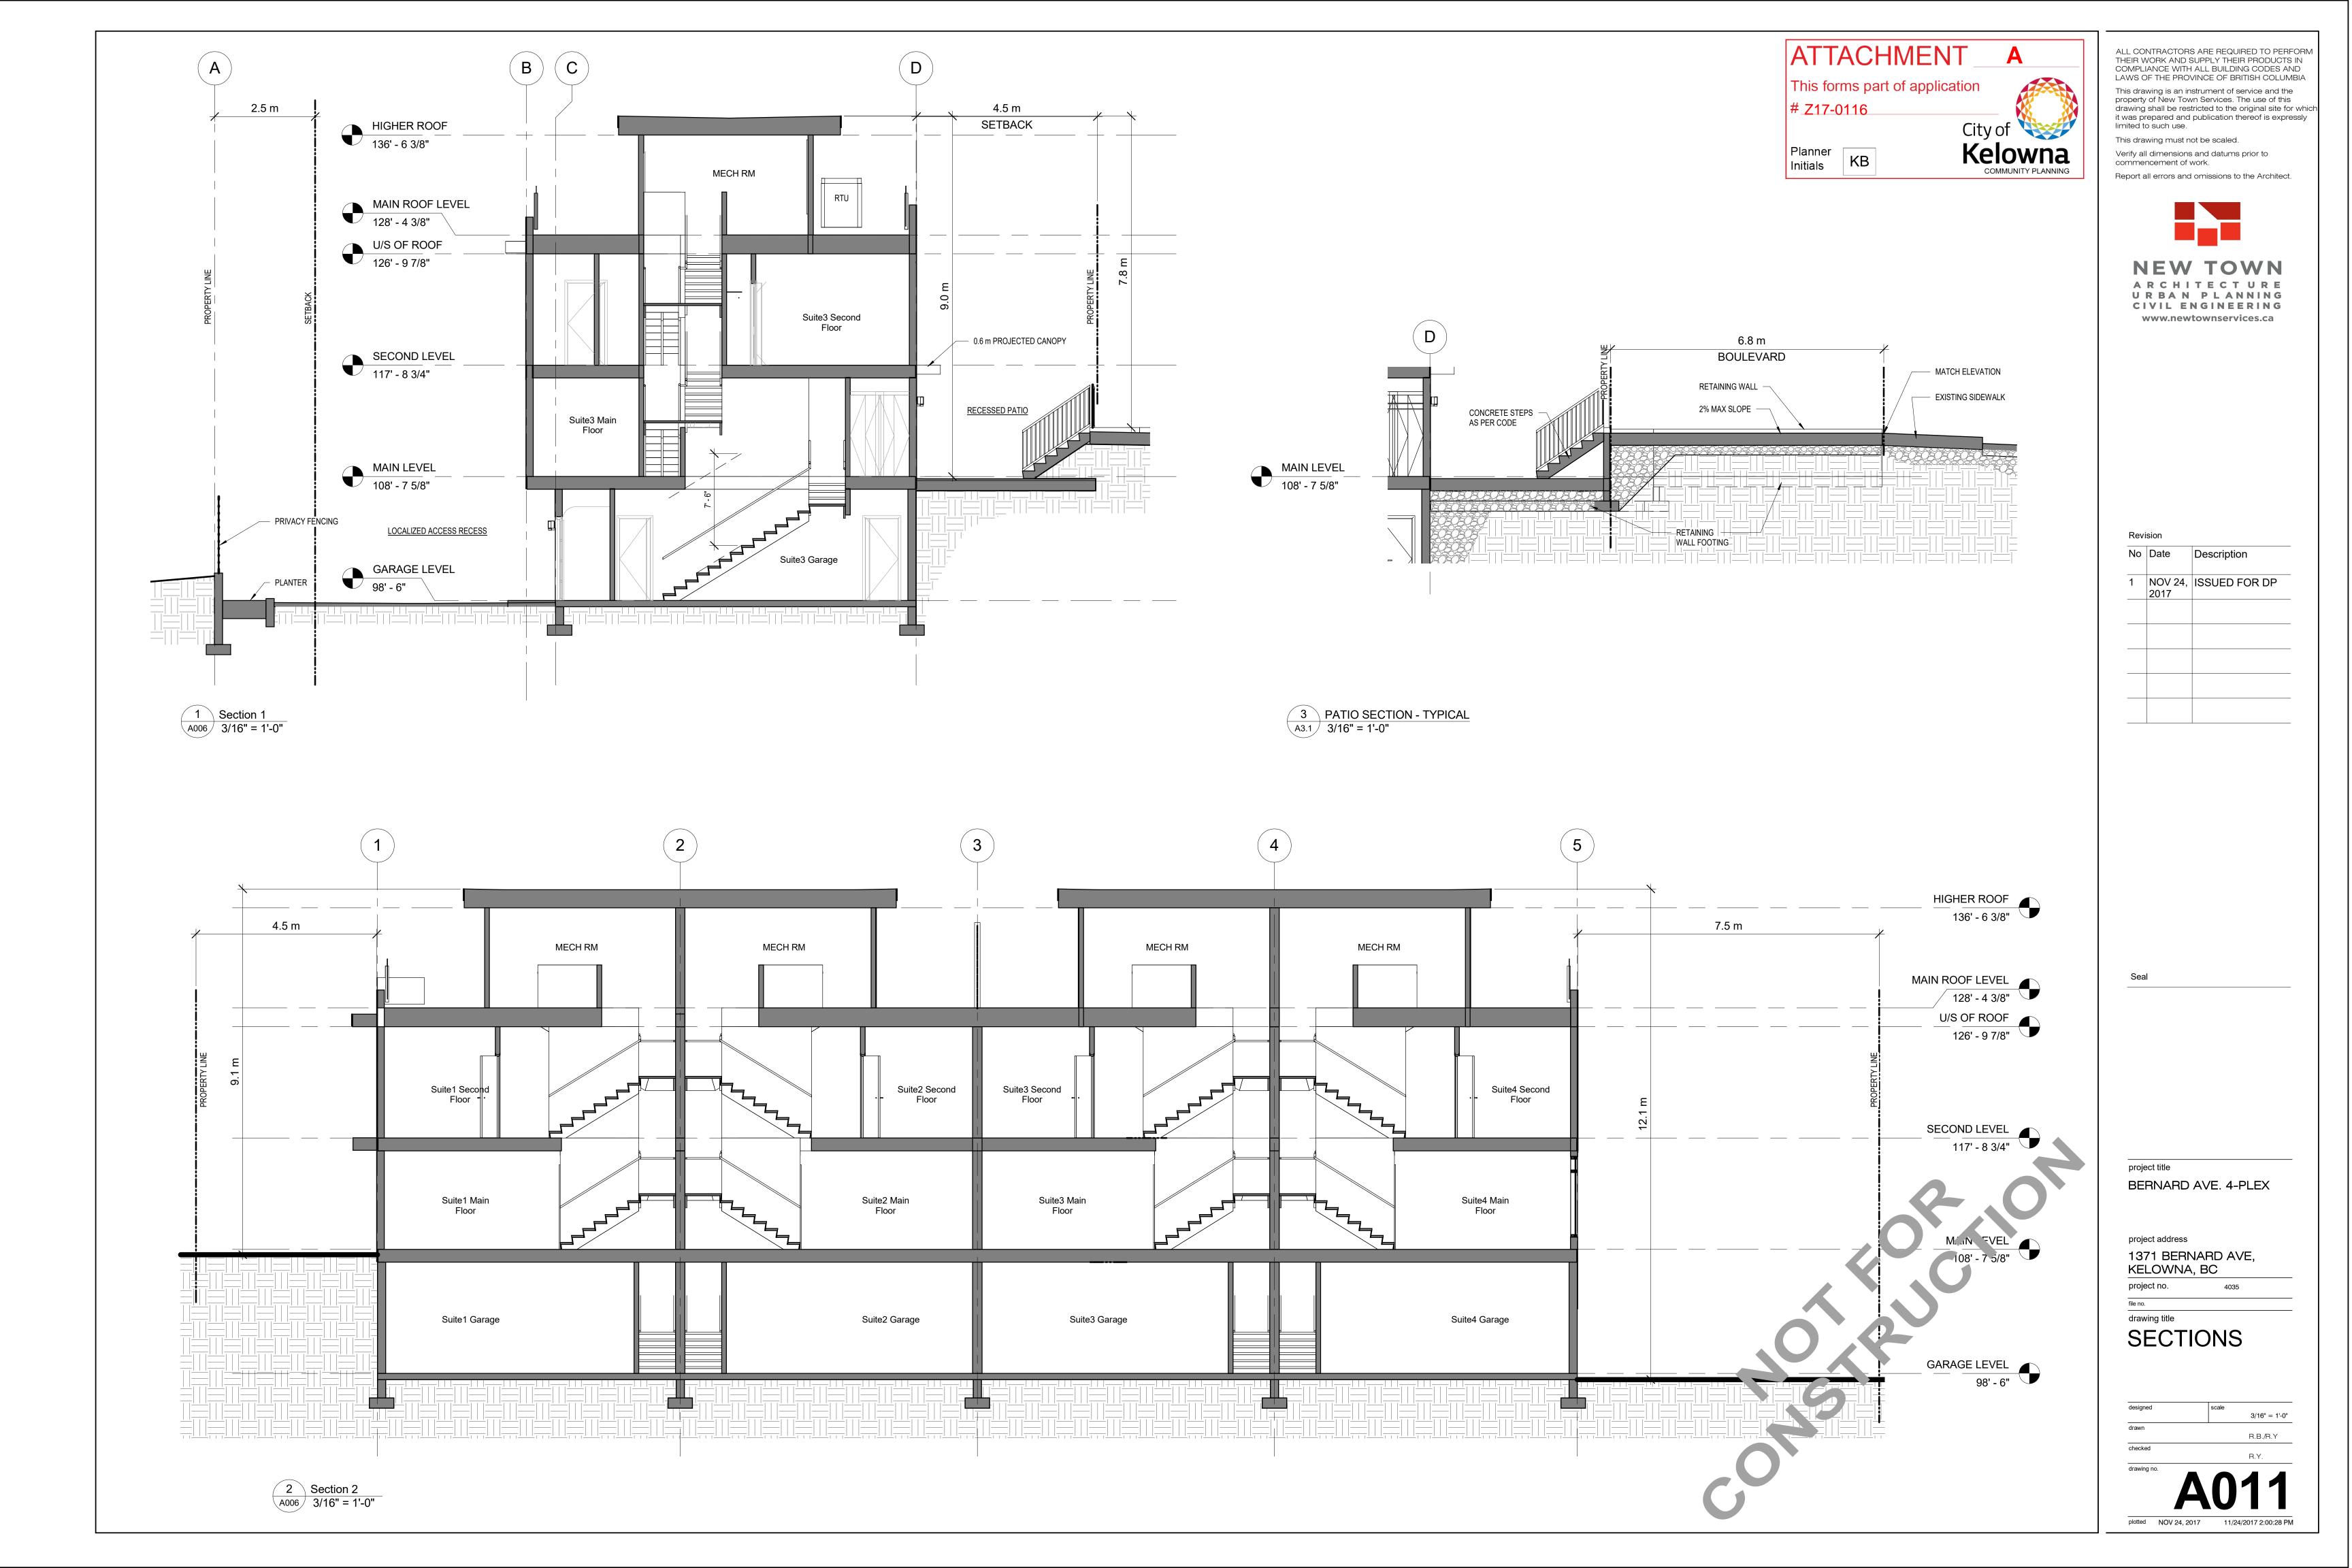




LANDSCAPE DEVELOPMENT DATA:

- 1. PLANT MATERIALS AND CONSTRUCTION METHODS SHALL CONFORM TO MINIMUM STANDARDS ESTABLISHED IN THE CANADIAN LANDSCAPE STANDARD (CURRENT EDITION).
- 2. THE LANDSCAPE DESIGN DESIGNATED HEREIN IS CONCEPTUAL BUT REFLECTS THE MINIMUM ACCEPTABLE QUALITY AND SIZE.
- 3. PLANT MATERIAL SELECTIONS ARE CONCEPTUAL ONLY. FINAL PLANTING SELECTIONS MAY VARY DEPENDING UPON AVAILABILITY.
- 4. ALL PLANTING BEDS SHALL HAVE APPROVED MULCH.
- 5. ALL LANDSCAPE AREAS TO BE IRRIGATED WITH AN EFFICIENT AUTOMATIC IRRIGATION
- 6. THIS DRAWING DEPICTS FORM AND CHARACTER AND IS TO BE USED FOR DEVELOPMENT PERMIT SUBMISSION ONLY. IT IS NOT INTENDED FOR USE AS A CONSTRUCTION DOCUMENT.

REPRESENTATIVE PLANT				Mature Plant
BOTANICAL NAME	COMMON NAME	SIZE	ROOT	Size (Ht.xWd.)
Trees Deciduous				
Cercidiphyllum japonicum	Katsura Tree	6cm Cal	B&B	12.0m x 8.0m
Shrubs / Grasses				
Buxus "Green Gem'	Green Gem Boxwood	#01	Potted	1.0m x 1.0m
Cornus alba 'Bailhalo'	Ivory Halo Dogwood	#01	Potted	1.50m x 1.50m
Euonymus alatus 'Compactus'	Dwarf Burning Bush	#01	Potted	2.0m x 2.0m
Miscanthus sinensis 'Gracillimus'	Maiden Hair	#01	Potted	1.0m x 1.5m
Pennisetum alopecuroides 'Red Head'	Red Head Fountain Grass	#01	Potted	1.2m x 1.2m
Perennials				
Allium 'Globemaster'	Persian Onion		bulb	
Echinacea purpurea 'Magnus'	Magnus Coneflower	#01	Potted	1.0m x 0.75m
Nepeta x fassenii 'Walker's Low'	Walker 's Low Catmint	#01	Potted	0.90m x 0.90r
Rudbeckia hirta 'Indian Summer'	Goldsturm Coneflower	#01	Potted	0.75m x 1.0m

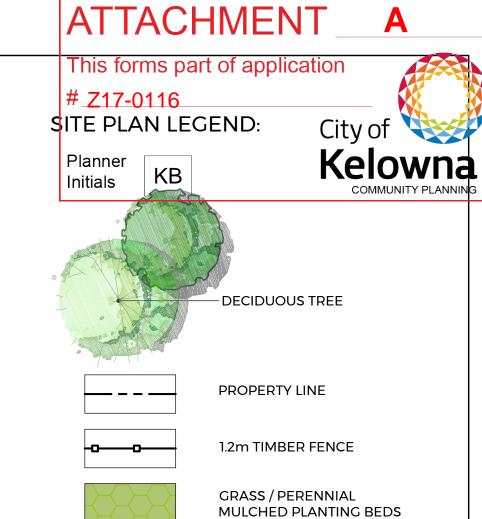

SHRUB PLANTING MULCHED PLANTING BEDS

SOD AREA

PATIO (BY OTHERS)

CONCRETE WALK

REPRESENTATIVE IMAGES

LANDSCAPE PLAN

1) SCALE: 1:100



Cercidiphyllum japonicum



LOCATION

KELOWNA, B.C.

Buxus "Green Gem' with Allium



Cornus alba 'Bailhalo'












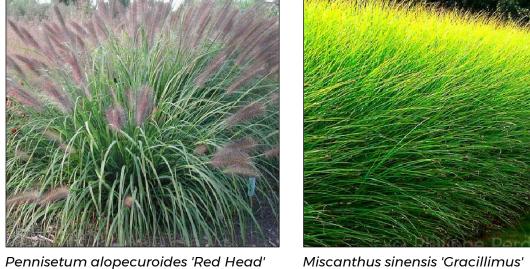





Bike Racks

REVISIONS / ISSUED


ISSUED FOR DP

DESCRIPTION

1371 BERNARD AVENUE 4-PLEX

540 Leon Avenue, Kelowna, BC V1Y6J6 t. 250.869.1334, f. 250.862.4849, www.wsp.com

DESIGN BY	BD	SHEET TITLE
DRAWN BY	YY	SITE PLAN
CHECKED BY	BD	OTTET EXT
PROJECT NO.	17M-01929	SHEET NO.
SCALE	1:100	LDP-1 1 OF 2

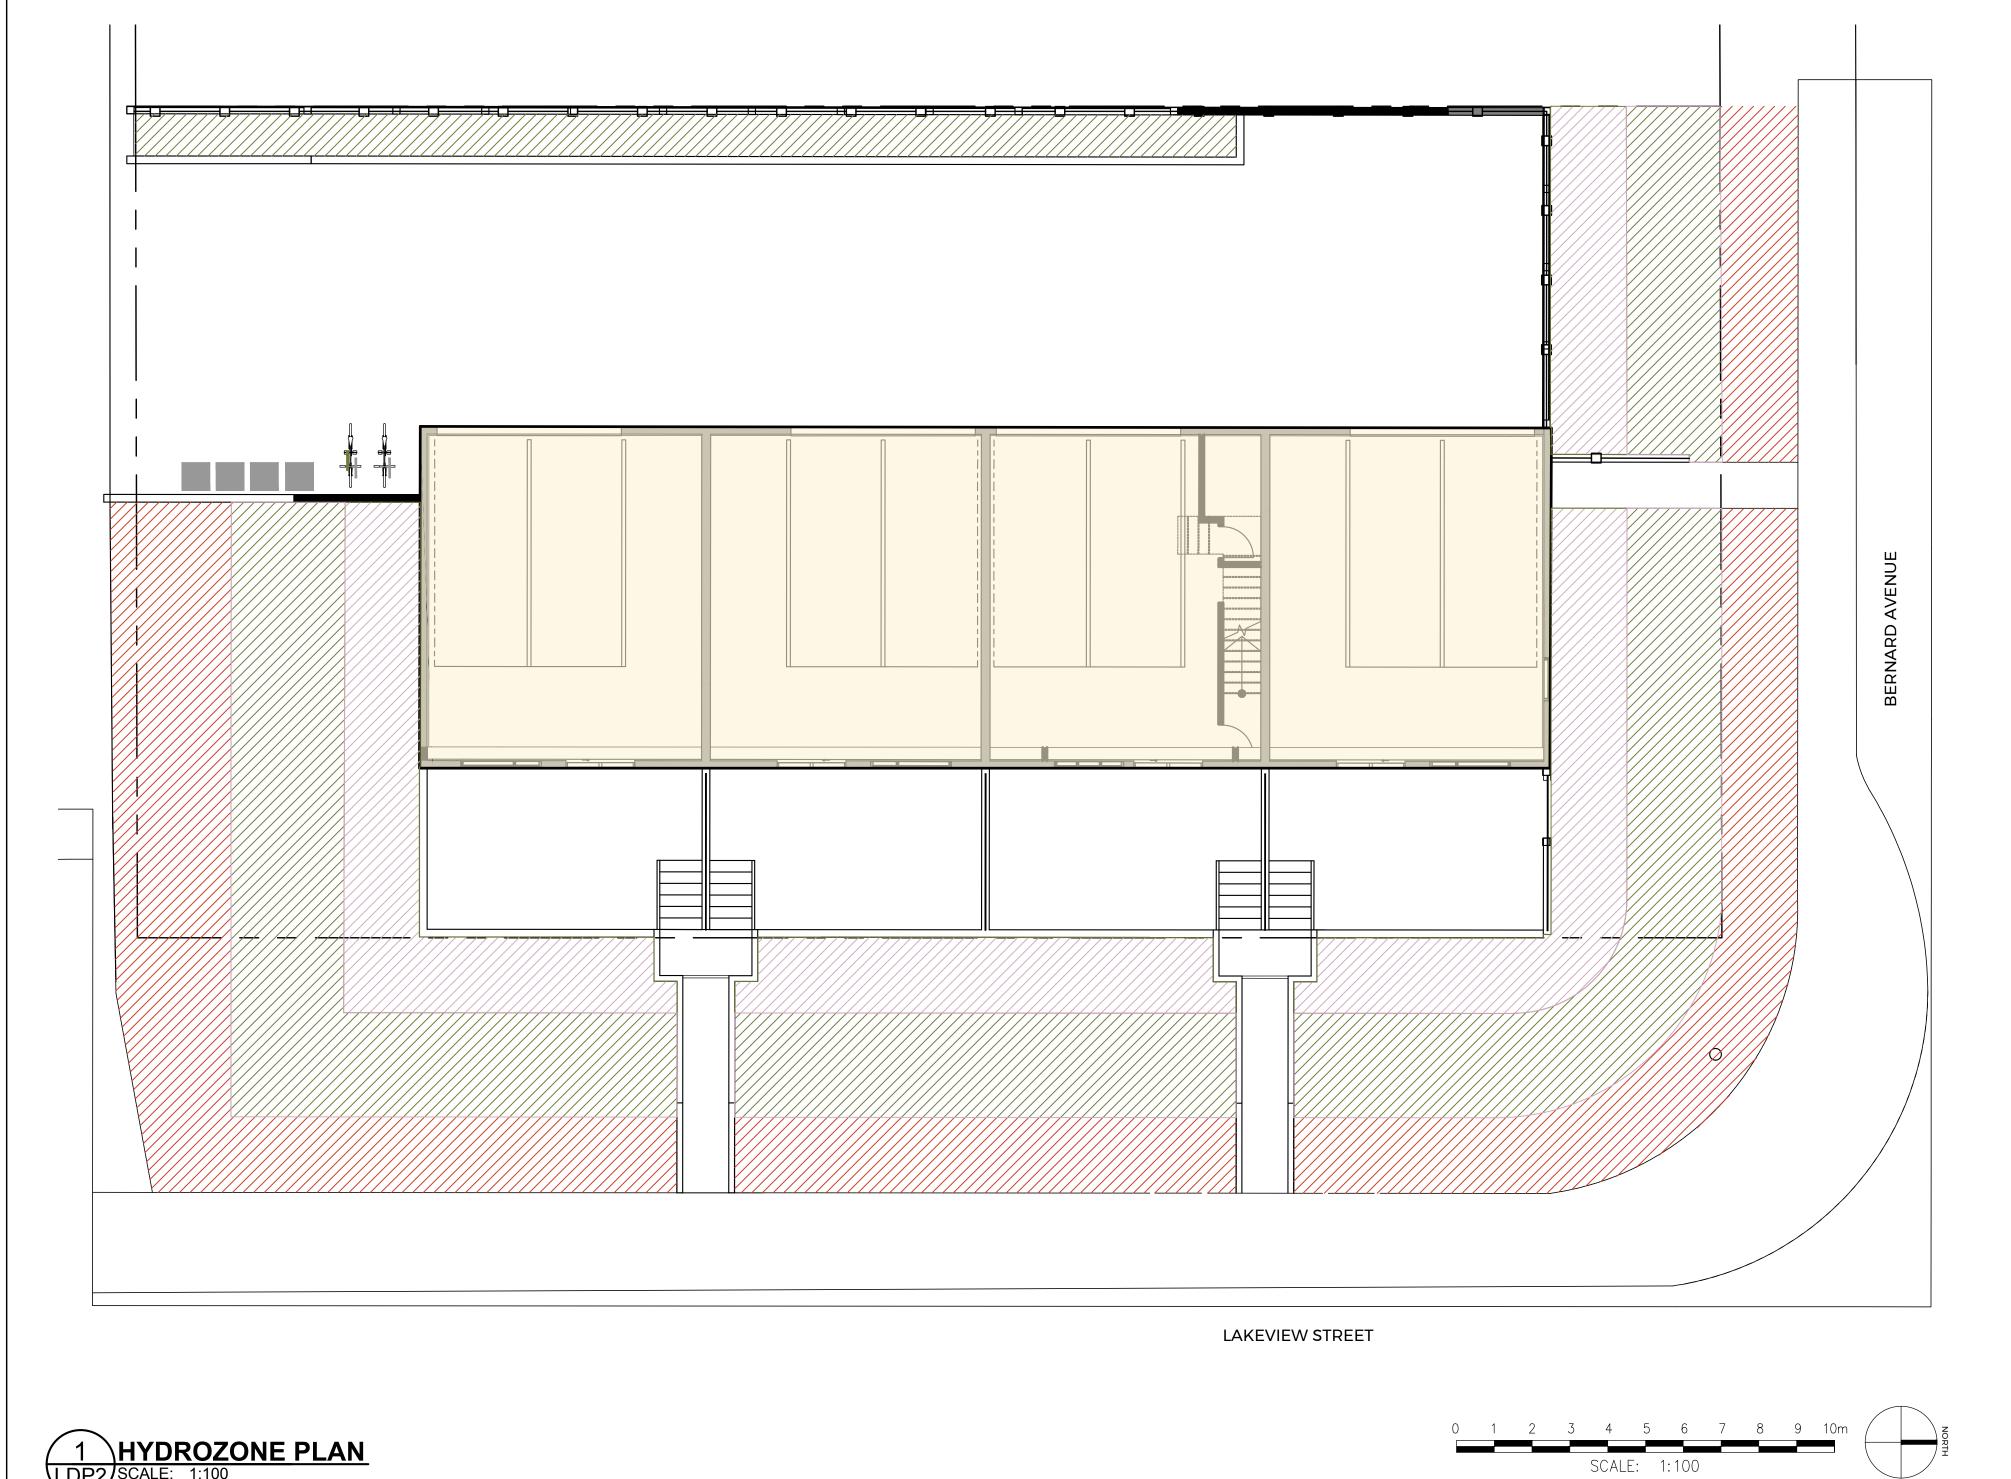

HYDROZONE LEGEND:


LOW WATER REQUIREMENTS (224.0m.sq.)

MODERATE WATER REQUIREMENTS (121.0m.sq.)


HIGH WATER REQUIREMENTS (178.0m.sq.)

ATTACHMENT_ This forms part of application # Z17-0116

Planner Initials KB

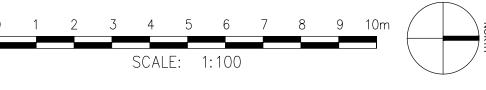


REVISIONS / IS	SSUED
1 NOV 02/17	ISSUED FOR DP
NO. DATE	DESCRIPTION

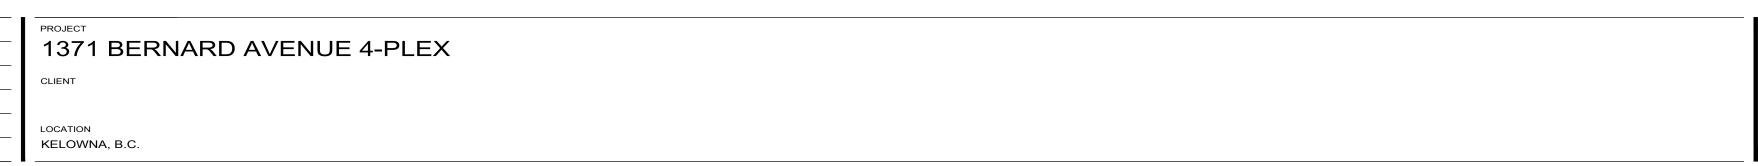



DESIGN BY	BD	SHEET TITLE
DRAWN BY	YY	HYDROZONE PLAN
CHECKED BY	BD	TITOROZONE I LAN
PROJECT NO.	17M-01929	SHEET NO.
SCALE	1:100	LDP-2 2 OF 2

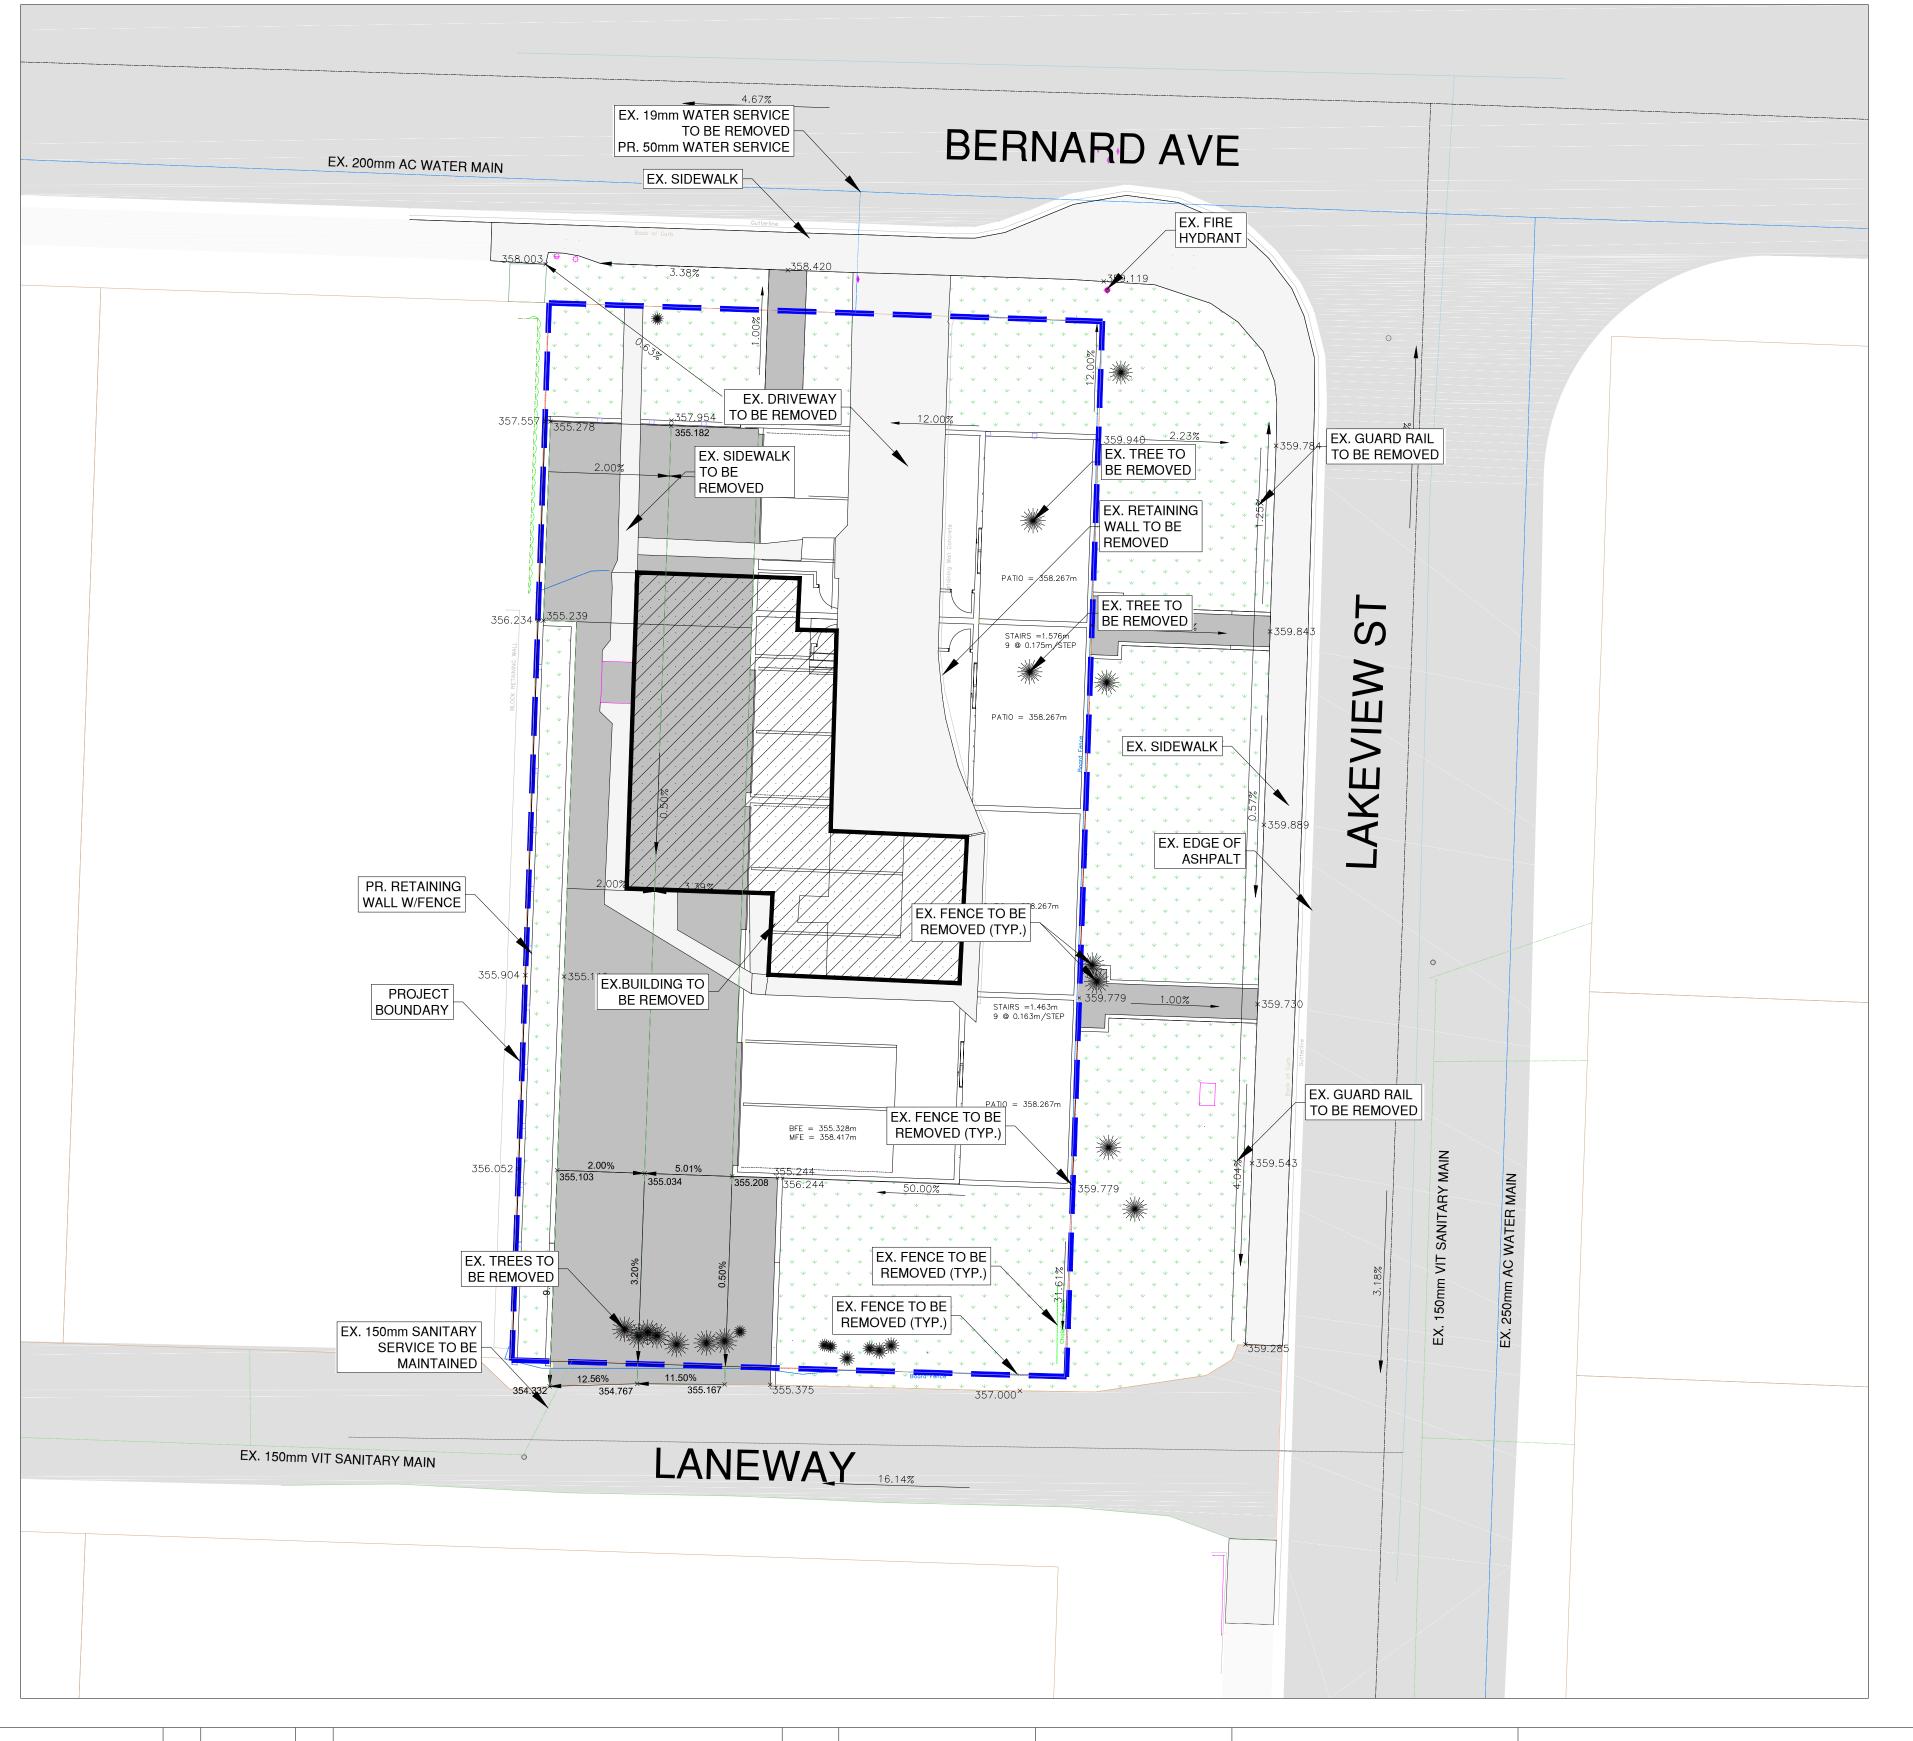

ATTACHMENT This forms part of application # Z17-0116 Planner Initials KB Ketowna


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nard 4PI										
5 Ber	<u>LEGEND</u>	MANHOLE	Ом.н.	<u>egend</u>						
403	WATER — — — — — — — — — — — — — — — — — — —	UTILITY POLE	● U.P.							
) jects	SAN. SEWER — — — — — — — —	POWER POLE LAMP STANDARD	● P.P.		PAVE WITH ASPHALT					
F: \1 Pro	STORM SEWER — — — — — — — GAS	CATCH BASIN HYDRANT			REMOVE-REGRADE-REPLACE					
OCATION:	U/G TELEPHONE — — — — — — — — — — — — — — — — — — —	TREES SURVEY MONUMEN ⁻	T O		LEVEL COURSE					
FILE L						NO.	YY/MM/DD	BY	REVISION CH'KI)

	BAS
	DES
	APP
NEW TOWN ARCHITECT URE URBAN PLANNING	DAT
CIVIL ENGINEERING www.newtownservices.ca	SCA

KELOWNA
CONSTRUCTION
ING PLAN
RD 4 PLEX
NARD AVE

The location of existing underground utilities an approximate way only & have not been iverified by the owner or its representative. I shall determine the exact location of all existence commencing work, and agrees to be responsible for any and all damages which is occasioned by the contractor's failure to exact and preserve any and all underground utilities.	independently The contracto sting utilities fully might be actly locate
DRAWING NO.	REV. NO.

1

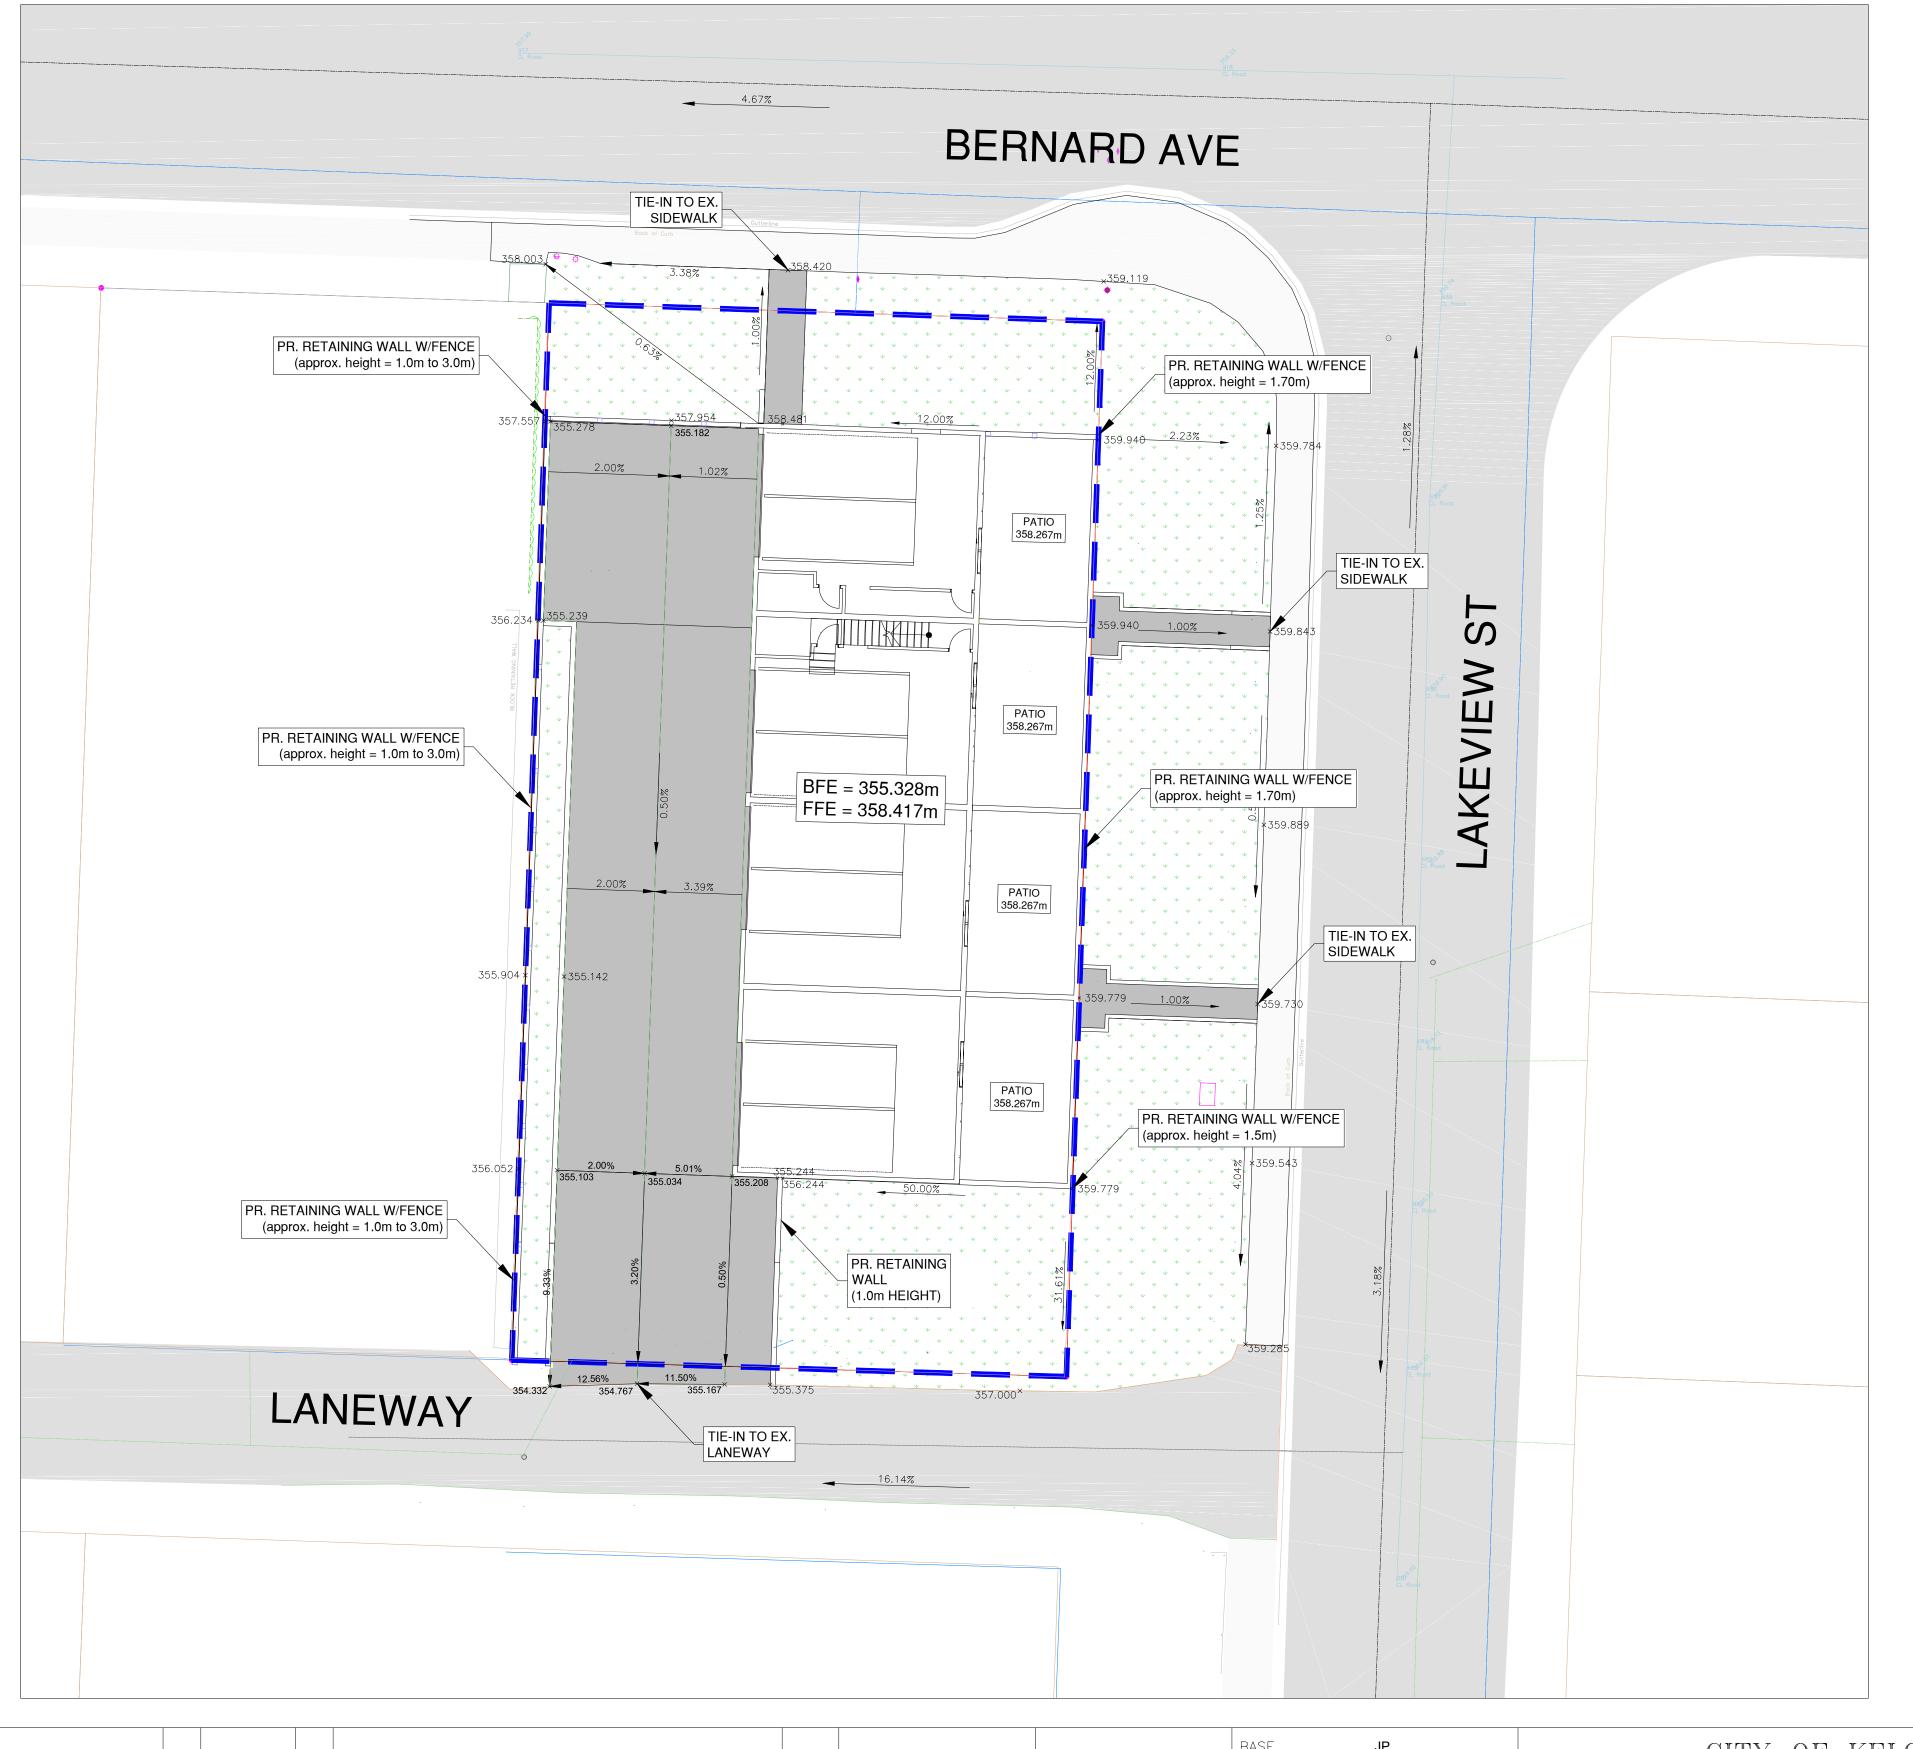

LEGEND

SAN. SEWER


STORM SEWER

MANHOLE

UTILITY POLE POWER POLE

LAMP STANDARD 🗆 L.S.

SURVEY MONUMENT 🔷

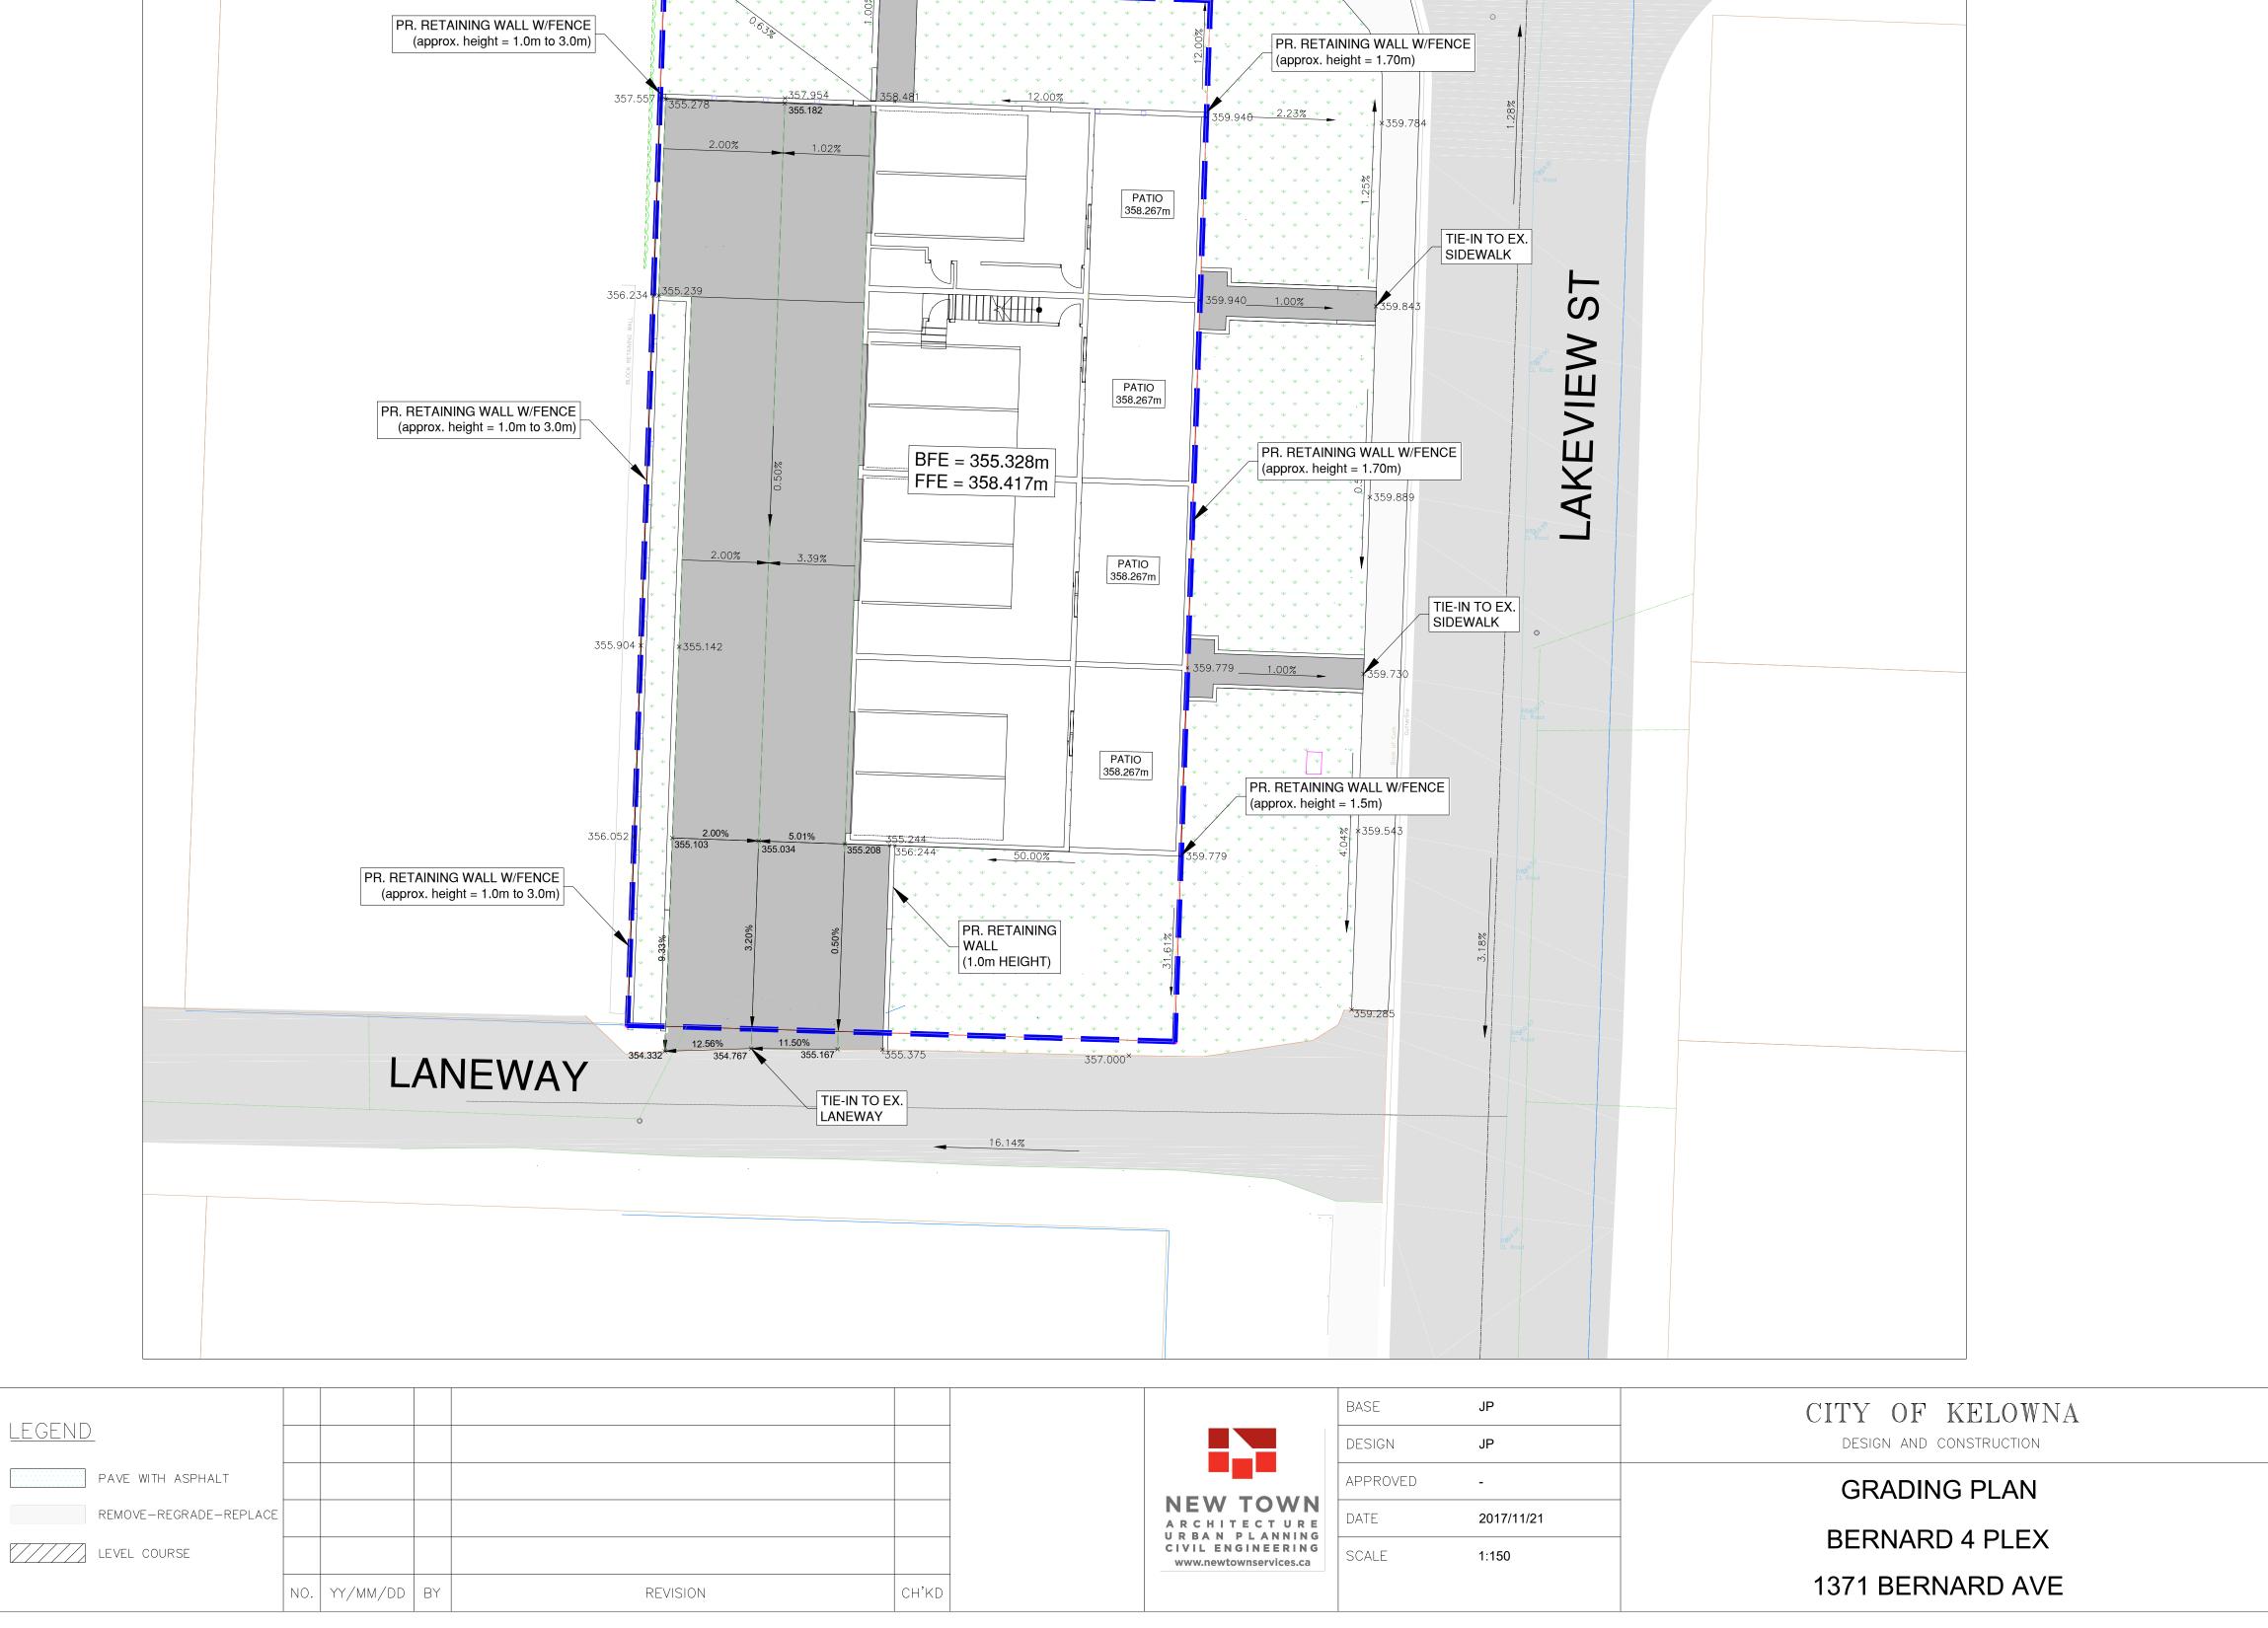

ATTACHMENT

This forms part of application # Z17-0116

Planner Initials

The location of existing underground utilities are shown in an approximate way only & have not been independently verified by the owner or its representative. The contractor shall determine the exact location of all existing utilities before commencing work, and agrees to be fully responsible for any and all damages which might be occasioned by the contractor's failure to exactly locate and preserve any and all underground utilities.

DRAWING NO.

CITY OF KELOWNA FILE NO.