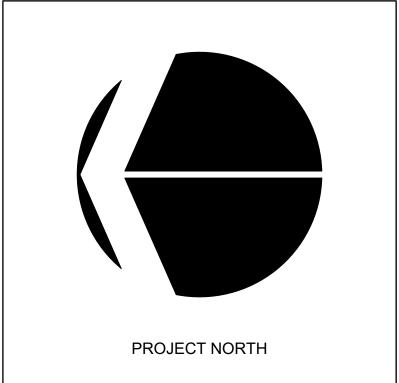


4 SOUTH ELEVATION
Scale: 1/4" = 1'-0"

IHS DESIGN 644 ARROWLEAF LANE KELOWNA, BC V1W 4Y5

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REVISION	DATE	DISCRIPTION	

PROJECT

CARRIAGE HOUSE DEVELOPMENT

4658 BARTON STREET

KELOWNA, BC V1W 2B5

LOT 5 PLAN KAP69497

DRAWING TITLE

ELEVATIONS

NO.


NOVEMBER 29, 2017

DRAWING NUMBER

1 of —

3

3 EAST ELEVATION
Scale: 1/4" = 1'-0"

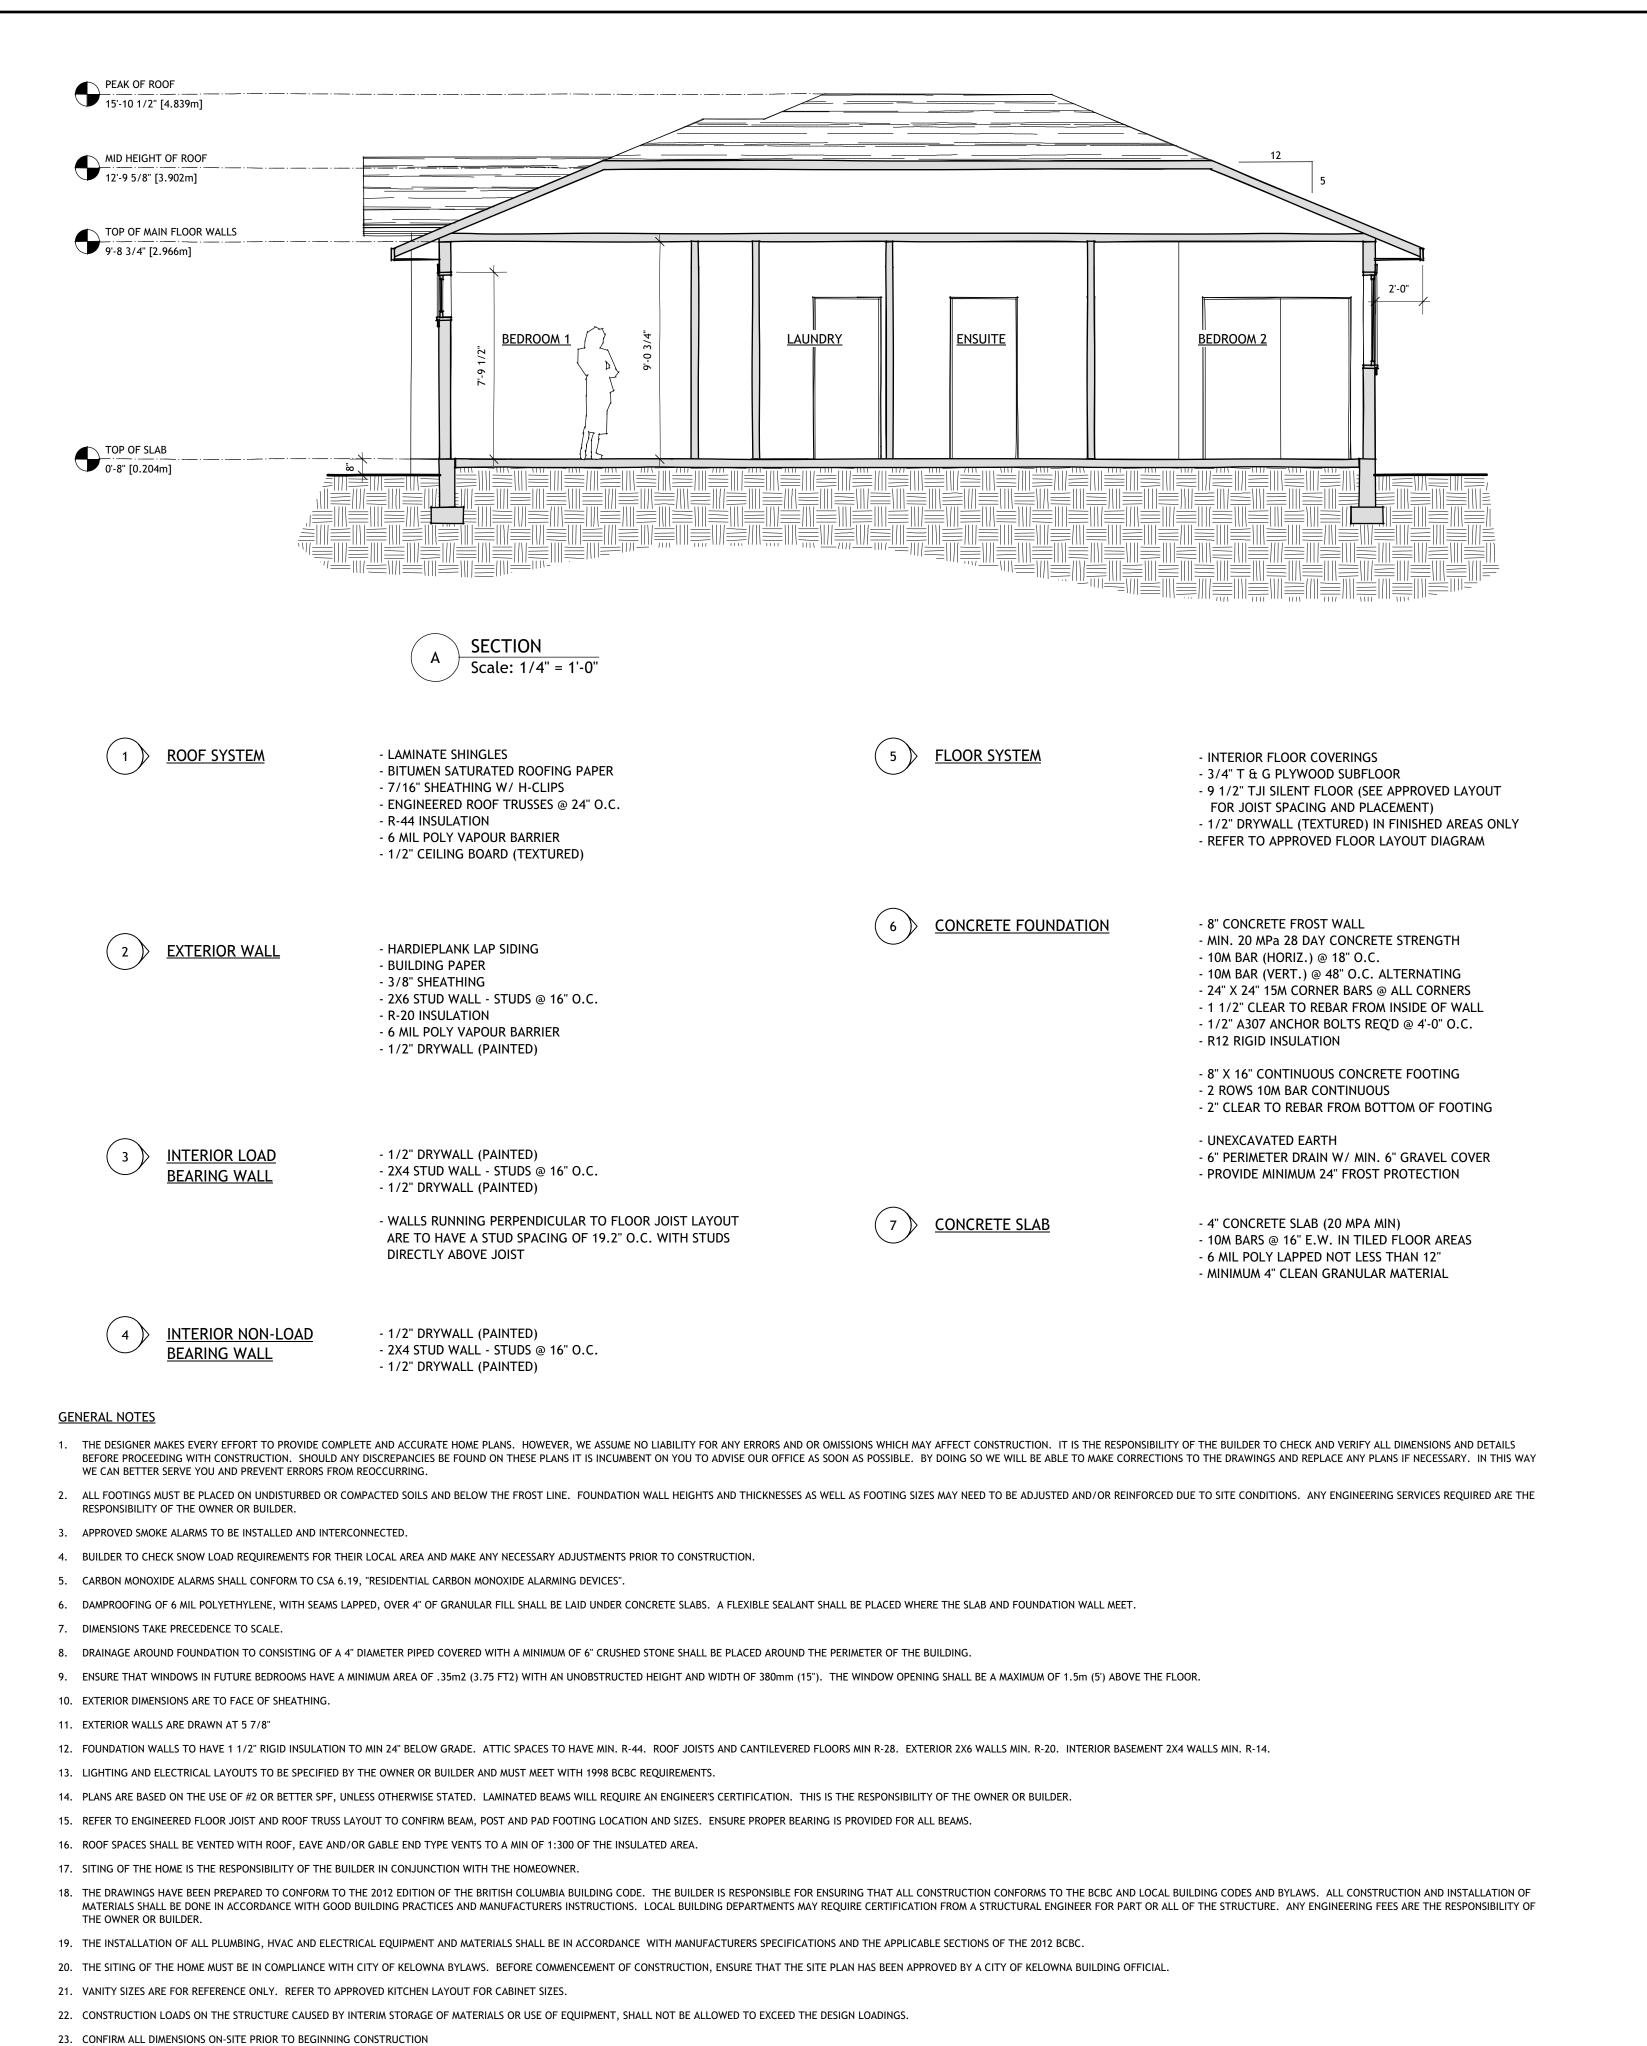

24. EXTERIOR DOORS SHALL BE SOLID CORE AND WEATHERSTRIPPED. GARAGE DOORS TO DWELLING TO BE AS ABOVE AND SELF-CLOSING.


27. PROVIDE BAFFLE FOR AIR SPACE (EQUAL TO SOFFIT VENTING) BETWEEN INSULATION AND ROOF SHEATHING AT EXTERIOR WALL LINE.

28. THE FACE OF SHEATHED EXTERIOR WALLS SHALL BE FLUSH WITH FOUNDATION WALLS.

25. GRADES SHOWN ON PLANS ARE ESTIMATED. FOUNDATION WALL HEIGHTS AND HOUSE SITING MAY REQUIRE ADJUSTMENT TO SUIT SITE CONDITIONS.


26. MIN. 25% OF UNOBSTRUCTED ROOF VENT AREA SHALL BE AT BOTH THE SOFFIT AND TOP OF ATTIC. ROOF VENTING SHALL BE IN ACCORDANCE WITH BCBC 9.19.1.2.


29. WOOD IN CONTACT WITH CONCRETE TO BE DAMP-PROOFED WITH SILL GASKET OR OTHER APPROVED METHOD. PLATES TO BE ANCHORED TO CONCRETE FOUNDATION WITH 1/2" DIA. A307 ANCHOR BOLTS AT 4'-0" O.C.

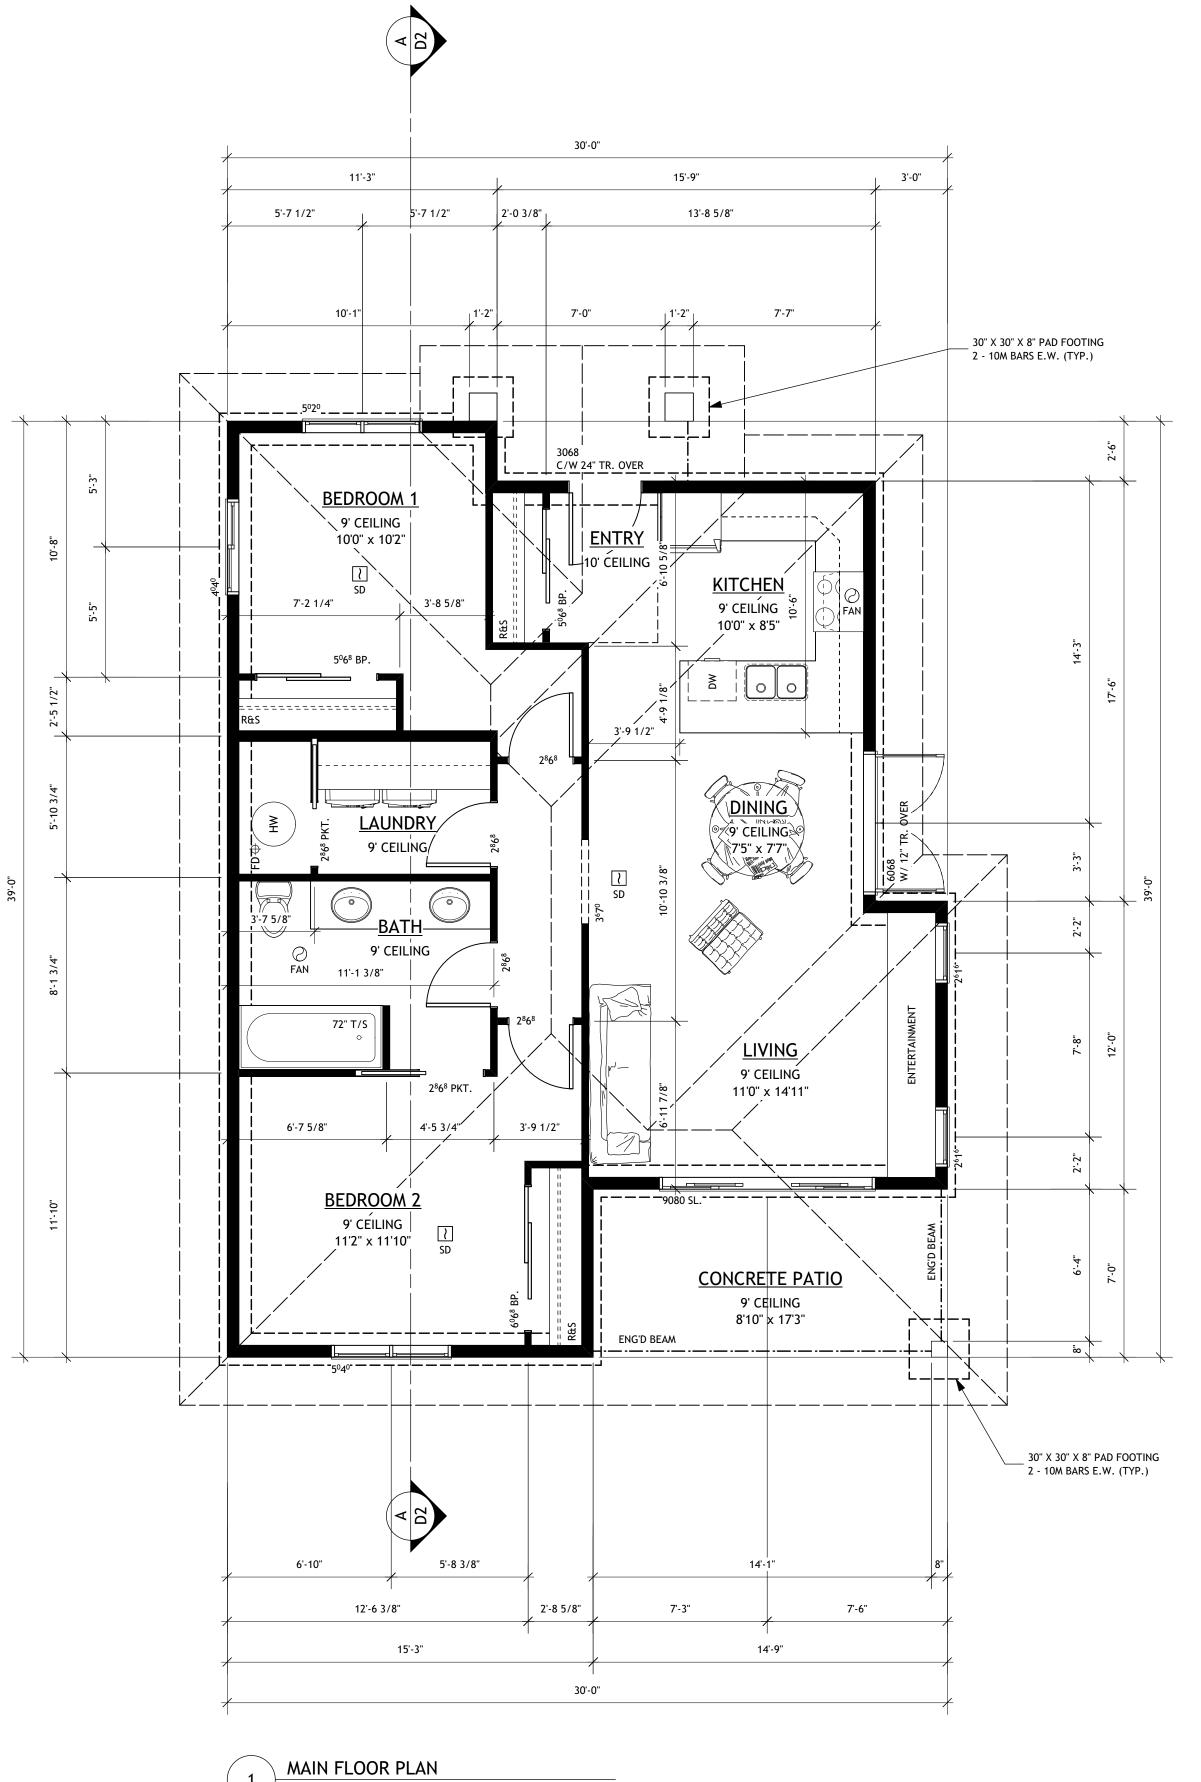

IHS DESIGN 644 ARROWLEAF LANE KELOWNA, BC V1W 4Y5

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PROJECT

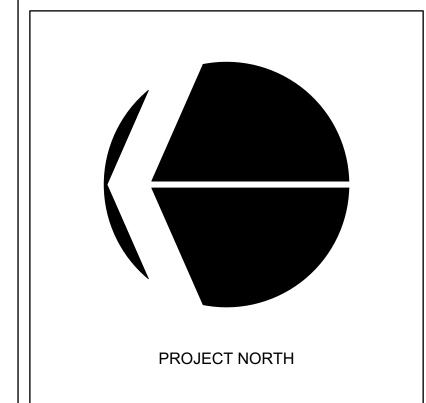CARRIAGE HOUSE DEVELOPMENT 4658 BARTON STREET KELOWNA, BC V1W 2B5 LOT 5 PLAN KAP69497

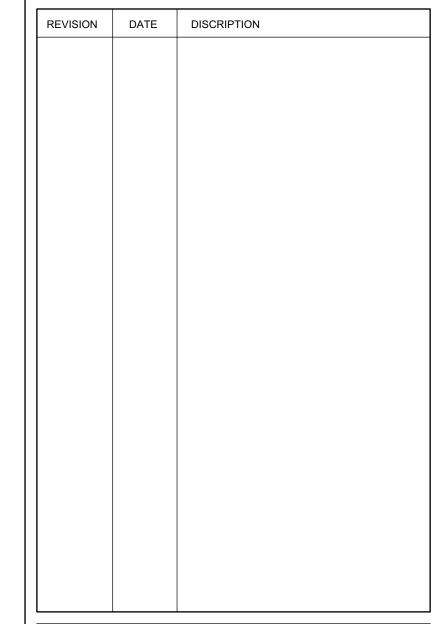DRAWING TITLE

FLOOR PLANS

NOVEMBER 29, 2017

DRAWING NUMBER

Scale: 1/4" = 1'-0" FFA = 967.4 ft² [89.9 m²]


PROJECT DATA: CIVIC ADDRESS 4658

4658 BARTON STREET KELOWNA, BC V1W 2B5 LOT 5 PLAN KAP69497


LEGAL ADDRESS LOT 5 PLAN KAP69497
CURRENT ZONING RU-1 LARGE LOT HOUSING
FUTURE LAND USE S2RES - SINGLE TWO UNIT RESIDENTIAL


ZONING ANALYSIS

	RU1 ZONE STANDARDS	PROPOSED
SITE AREA	550.00m2	1059.92m2
EXISTING BUILDING FOOTPRINT AT GRADE		146.94m2
EXISTING BUILDING TOTAL FINISHED FLOOR AREA		153.00m2
PROPOSED SUITE AREA		89.90m2
PROPOSED ACCESSORY BUILDING FOOTPRINT		89.90m2
PROPOSED DRIVEWAY AREA (CONCRETE)		0.00m2
EXISTING DRIVEWAY AREA (CONCRETE)		68.30m2
ACCESSORY BUILDING SITE COVERAGE	14%	8.5%
SUITE AREA TO MAIN DWELLING AREA	75%	58.8%
SITE COVERAGE	40.0%	22.3%
SITE COVERAGE INCLUDING HARD SURFACES	50.0%	28.8%
BUILDING HEIGHT OF EXISTING HOUSE	9.5m/2 1/2 STOREYS	
BUILDING HEIGHT OF PROPOSED SUITE	4.8m/1 1/2 STOREYS	3.990m/1 STOREY
PEAK OF EXISTING DWELLING ROOF		
PARKING STALLS PROVIDED	3	3
PRIVATE OPEN SPACE	30.00m2	95.00m2
SETBACK TO PRINCIPLE BUILDING	3.000m	23.647m
REAR (WEST) YARD SETBACK	2.000m	4.939m
SIDE (NORTH) YARD SETBACK	2.000m	6.856m
SIDE (SOUTH) YARD SETBACK	2.000m	2.000m
1 IN 200 YEAR FLOOD CONSTRUCTION LEVEL	343.660m	405.000m

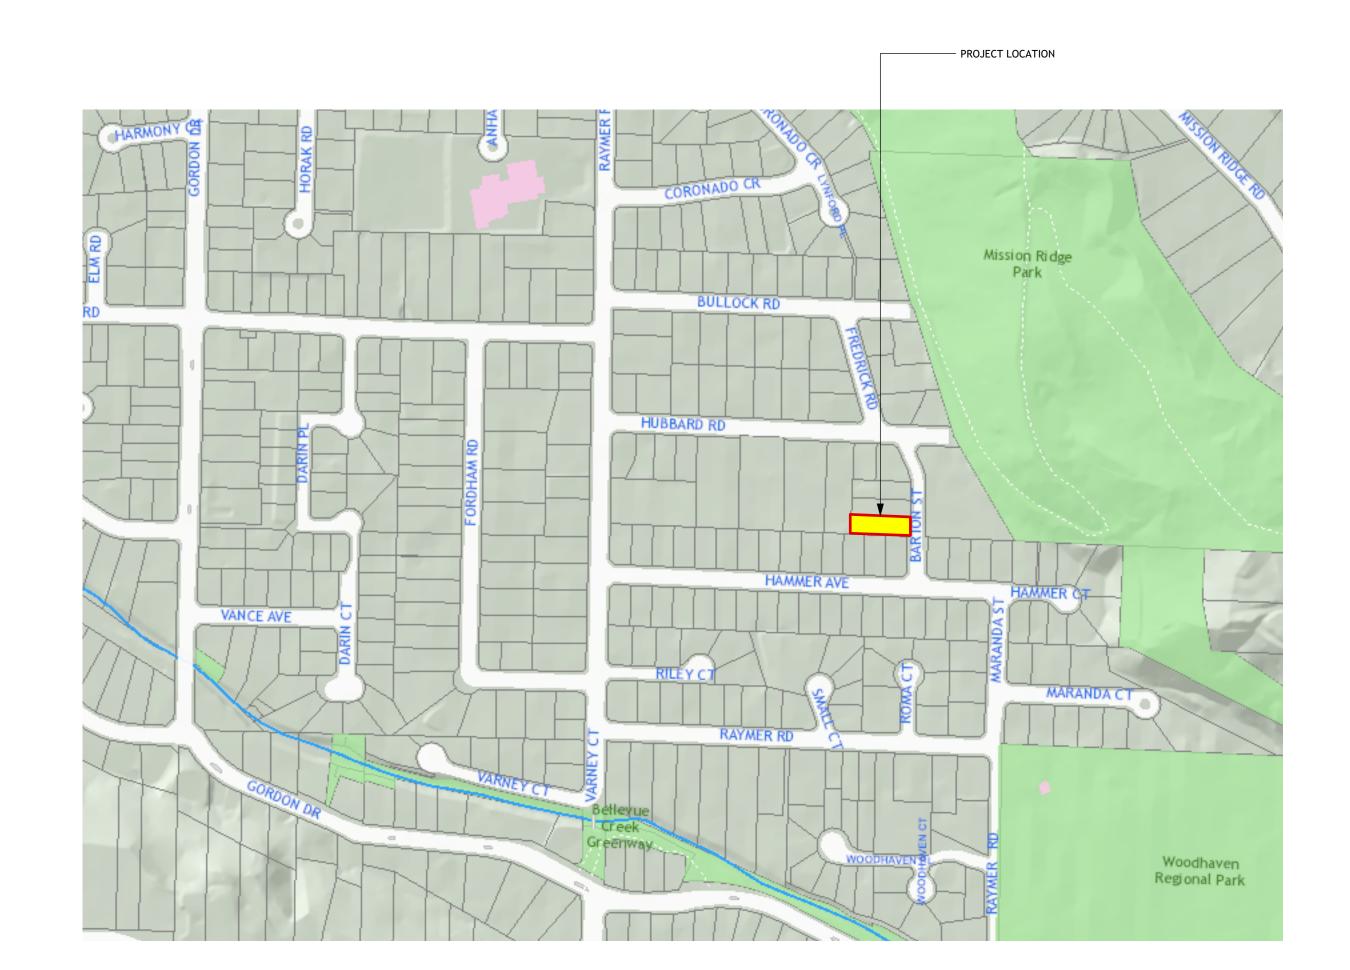




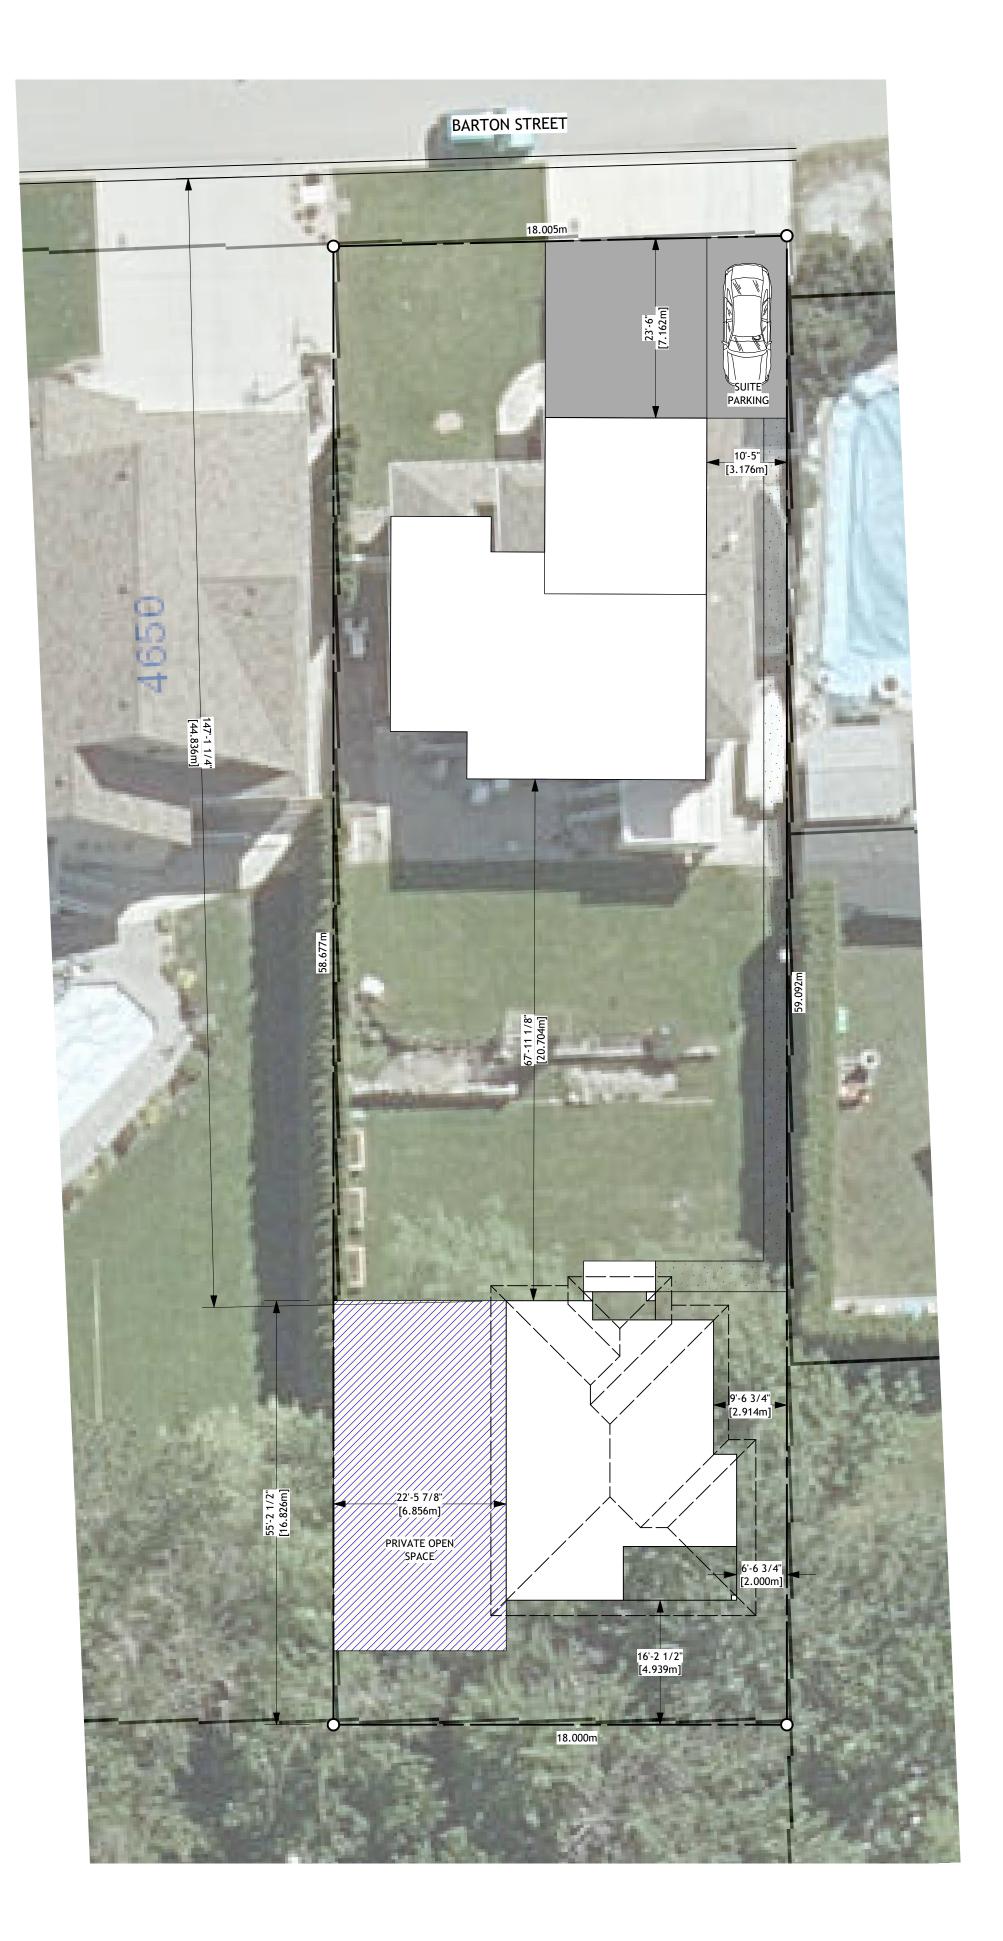

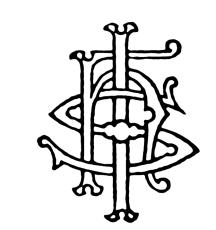

IHS DESIGN 644 ARROWLEAF LANE KELOWNA, BC V1W 4Y5

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REVISION	DATE	DISCRIPTION

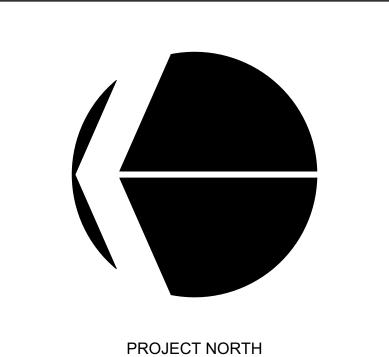PROJECT

CARRIAGE HOUSE DEVELOPMENT

4658 BARTON STREET

KELOWNA, BC V1W 2B5

LOT 5 PLAN KAP69497

DRAWING TITLE

SITE PLAN

No

NOVEMBER 29, 2017

DRAWING NUMBER

3

3

CITY OF KELOWNA

MEMORANDUM

Date:

December 15, 2017

File No.:

Z17-0115

To:

Community Planning (TB)

From:

Development Engineering Manager (JK)

Subject:

4658 Barton St.

Lot 5 Plan 69497

RU1 to RU1c

Carriage House

Development Engineering has the following comments and requirements associated with this application. The utility upgrading requirements outlined in this report will be a requirement of this development.

1. Domestic Water and Fire Protection

This property is currently serviced with a 19mm-diameter water service. The service will be adequate for this application. One metered water service will supply both the main residence and the carriage house.

2. Sanitary Sewer

Our records indicate that this property is currently serviced with a 100mm-diameter sanitary sewer service with an IC which is adequate for this application.

3. Development Permit and Site Related Issues

Direct the roof drains onto splash pads.

Driveway access permissible is one (1) per property as per bylaw

4. Electric Power and Telecommunication Services

It is the applicant's responsibility to make a servicing application with the respective electric power, telephone and cable transmission companies to arrange for service upgrades to these services which would be at the applicant's cost.

James Kay, P. Eng.

Development Engineering Manager

AS